


Email. jjdraft@tpg.com.au

www.jjdrafting.com.au

692a/19

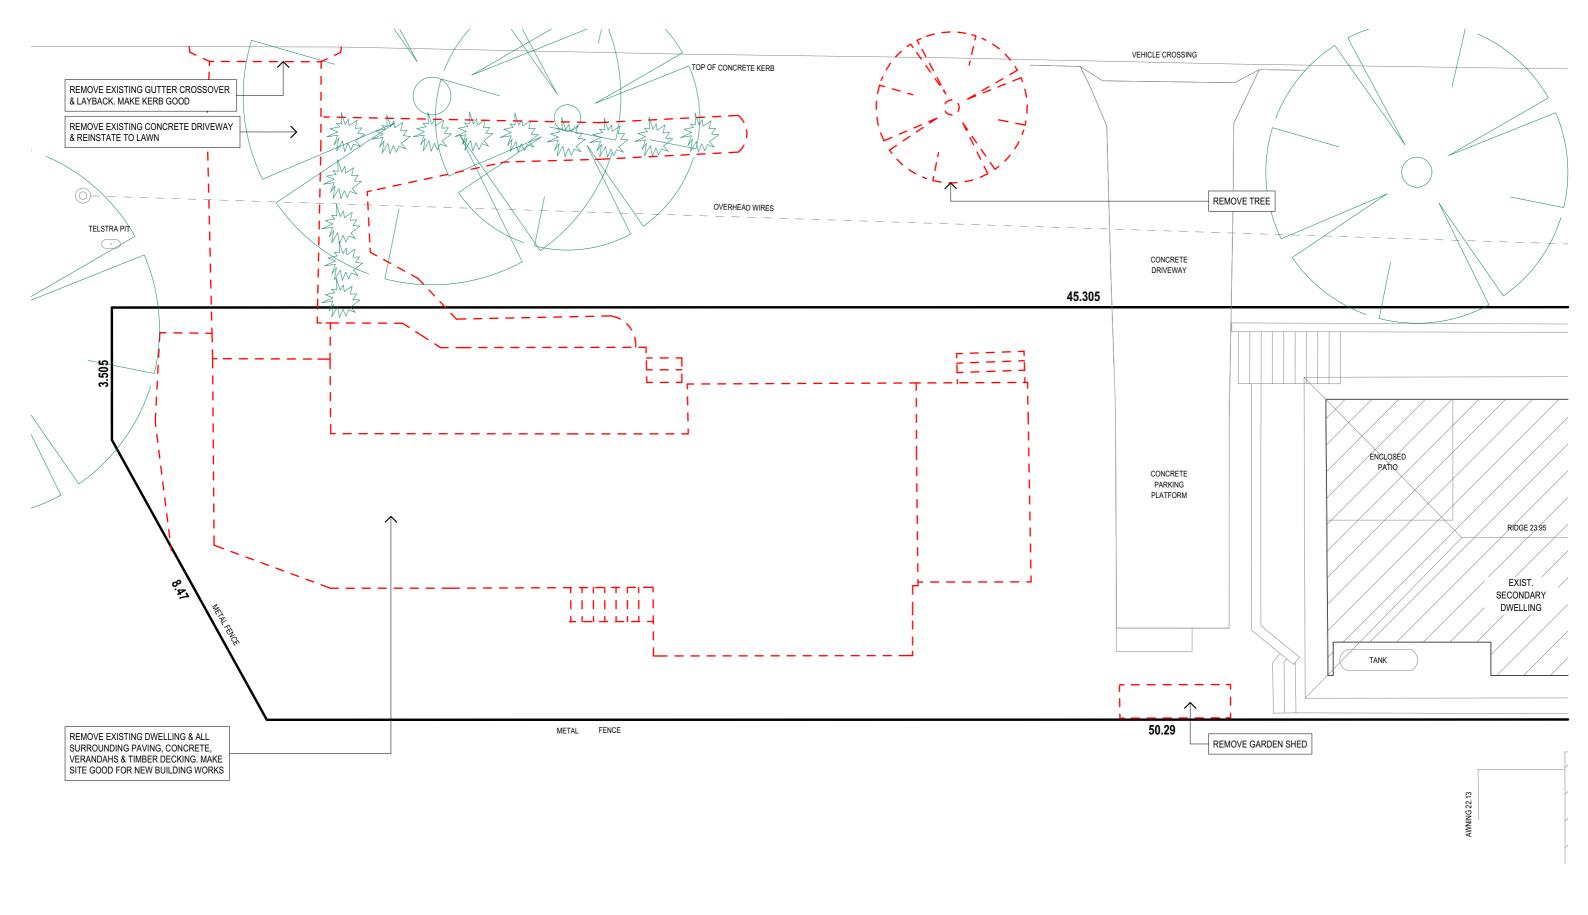



TRUE NORTH:

- NOTES:

 All structures including stormwater & drainage to engineer's details.

 Do not obtain dimensions by scaling drawings.

 All dimensions are to be checked on site prior to starting work.

 These drawings are to be read in conjunction with all other consultant's drawings and specifications.

 All workmanship & materials shall be in accordance with the requirements of current editions including amendments of the relevant SAA Codes of Practice, the Building Code of Australia and local council requirements.

 New materials are to be used throughout unless otherwise noted.


 Concrete footings, slab, structural beams or any other structural members are to be designed by a practicing engineer.

JJ Drafting

	REV:	DATE:	DESCRIPTION:	
1	Α	07.01.20	EXTRA NOTES	
B 17.02.20 [17.02.20	DRIVEWAY PROF. RAISE ENTRY/GARAGE	

PROJECT DETAILS: PROPOSED NEW HOUSE 34 WHALE BEACH ROAD, AVALON 2107	DATE: NOV/19
DRAWING TITLE: DEMOLITION PLAN	JOB No: 692a/19

DATE:	DRAWN BY:	SCALE:
NOV/19	АНВ	1:100 @ A3
JOB No:	CHECKED BY:	DRAWING No:
692a/19	JJ	DA.02

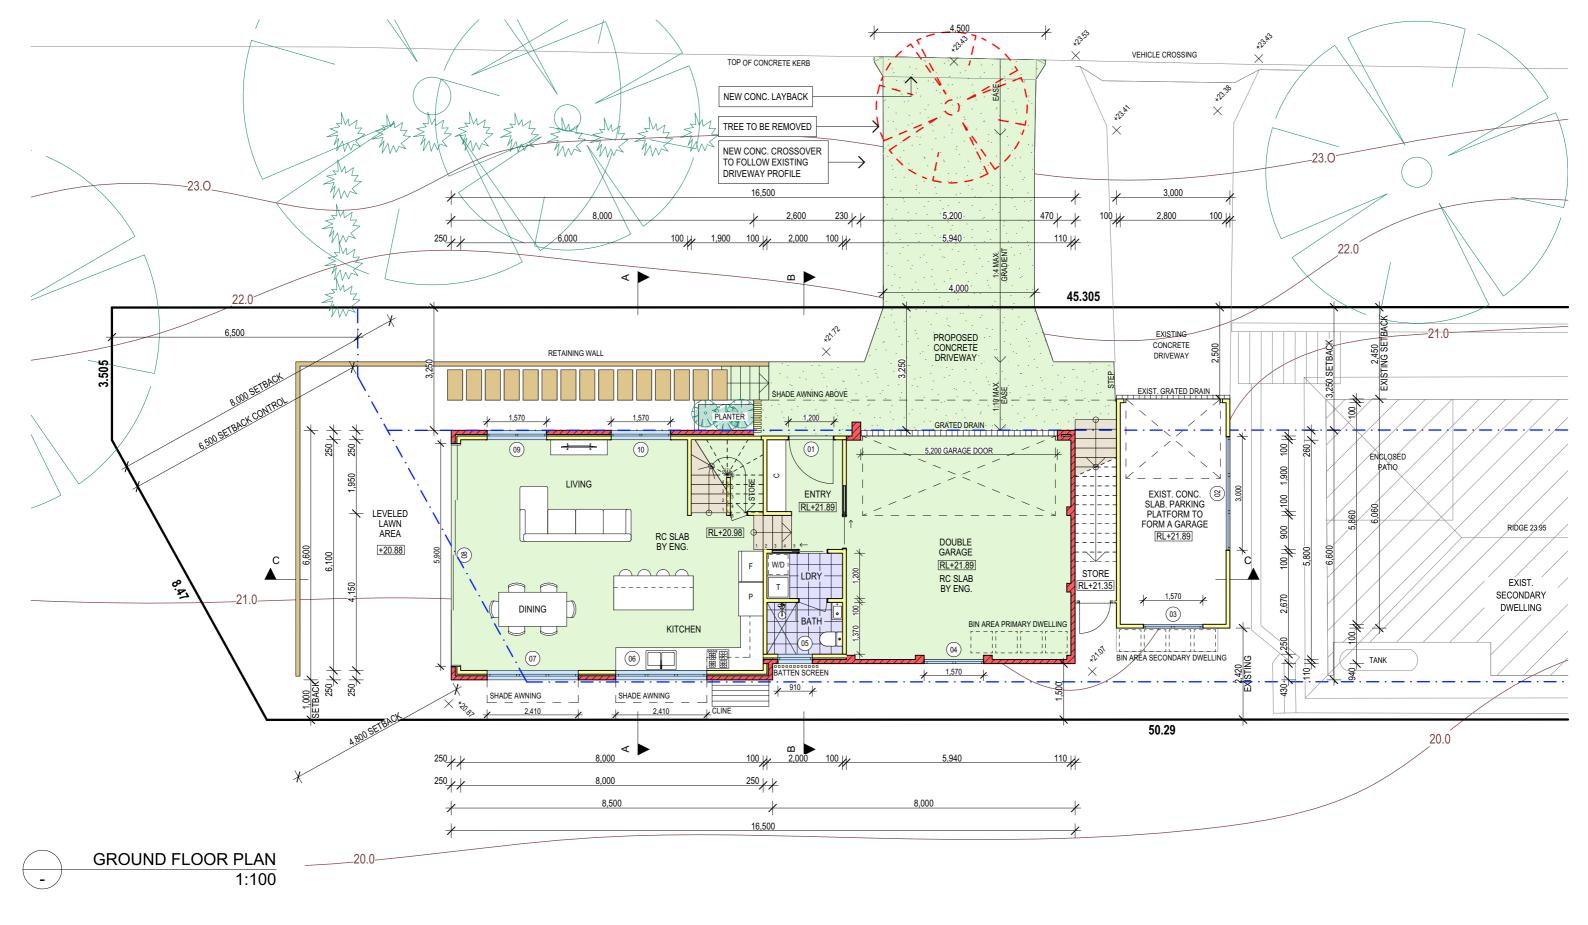

NOTE:

THE DESIGN OF ALL INTERNAL DRIVEWAYS AND RAMPS SHALL BE IN ACCORDANCE WITH THE CURRENT EDITION OF AUSTRALIAN STANDARDS 2890.1

TRUE NORTH:

NOTES:

- NOTES:

 All structures including stormwater & drainage to engineer's details.

 Do not obtain dimensions by scaling drawings.

 All dimensions are to be checked on site prior to starting work.

 These drawings are to be read in conjunction with all other consultant's drawings and specifications.

 All workmanship & materials shall be in accordance with the requirements of current editions.
- All workmanship & materials shall be in accordance with the requirements of current editions including amendments of the relevant SAA Codes of Practice, the Building Code of Australia and local council requirements.


 New materials are to be used throughout unless otherwise noted.

 Concrete footings, slab, structural beams or any other structural members are to be designed by a practicing engineer.

JJ Drafting

	REV:	DATE:	DESCRIPTION:
1	Α	07.01.20	EXTRA NOTES
101	В	17.02.20	DRIVEWAY PROF. RAISE ENTRY/GARAGE
- 1			

PROJECT DETAILS: PROPOSED NEW HOUSE 34 WHALE BEACH ROAD, AVALON 2107	DATE: NOV/19	DRAWN BY:	SCALE: 1:100 @ A3
DRAWING TITLE: GROUND FLOOR PLAN	JOB No: 692a/19	CHECKED BY:	DRAWING No: DA.03

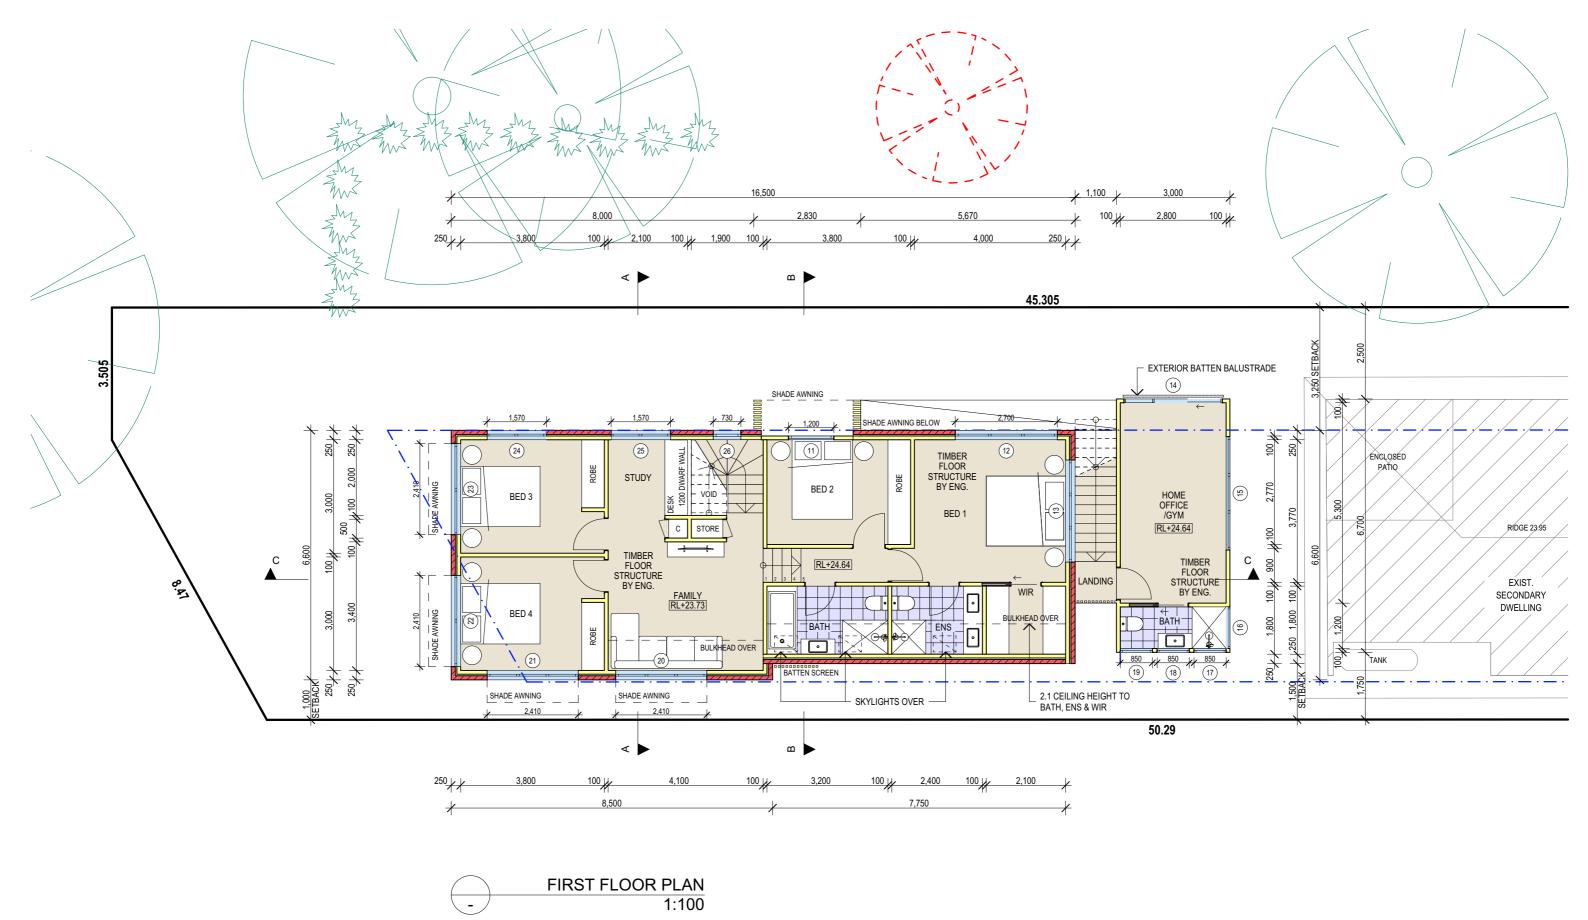



NOTES:

- NOTES:

 All structures including stormwater & drainage to engineer's details.

 Do not obtain dimensions by scaling drawings.

 All dimensions are to be checked on site prior to starting work.

 These drawings are to be read in conjunction with all other consultant's drawings and specifications.

 All workmanship & materials shall be in accordance with the requirements of current editions.

- All workmanship & materials shall be in accordance with the requirements of current editions including amendments of the relevant SAA Codes of Practice, the Building Code of Australia and local council requirements.

 New materials are to be used throughout unless otherwise noted.

 Concrete footings, slab, structural beams or any other structural members are to be designed by a practicing engineer.


JJ Drafting

174 Garden St, North Narrabeen, NSW, 2 PO Box 687, Dee Why, NSW, 2099 Mob. 0414 717 541 Email. jjdraft@tpg.com.au www.jjdrafting.com.au

	REV:	DATE:	DESCRIPTION:	
9	Α	07.01.20	EXTRA NOTES	
2101	В	17.02.20	DRIVEWAY PROF. RAISE ENTRY/GARAGE	
9				
- 1				

PROJECT DETAILS: PROPOSED NEW HOUSE 34 WHALE BEACH ROAD, AVALON 2107	DATE: NOV/19	DRAWN BY: AHB	SCALE: 1:100 @ A	
DRAWING TITLE: FIRST FLOOR PLAN	JOB No: 692a/19	CHECKED BY:	DRAWING No: DA.04	

1:100 @ A3

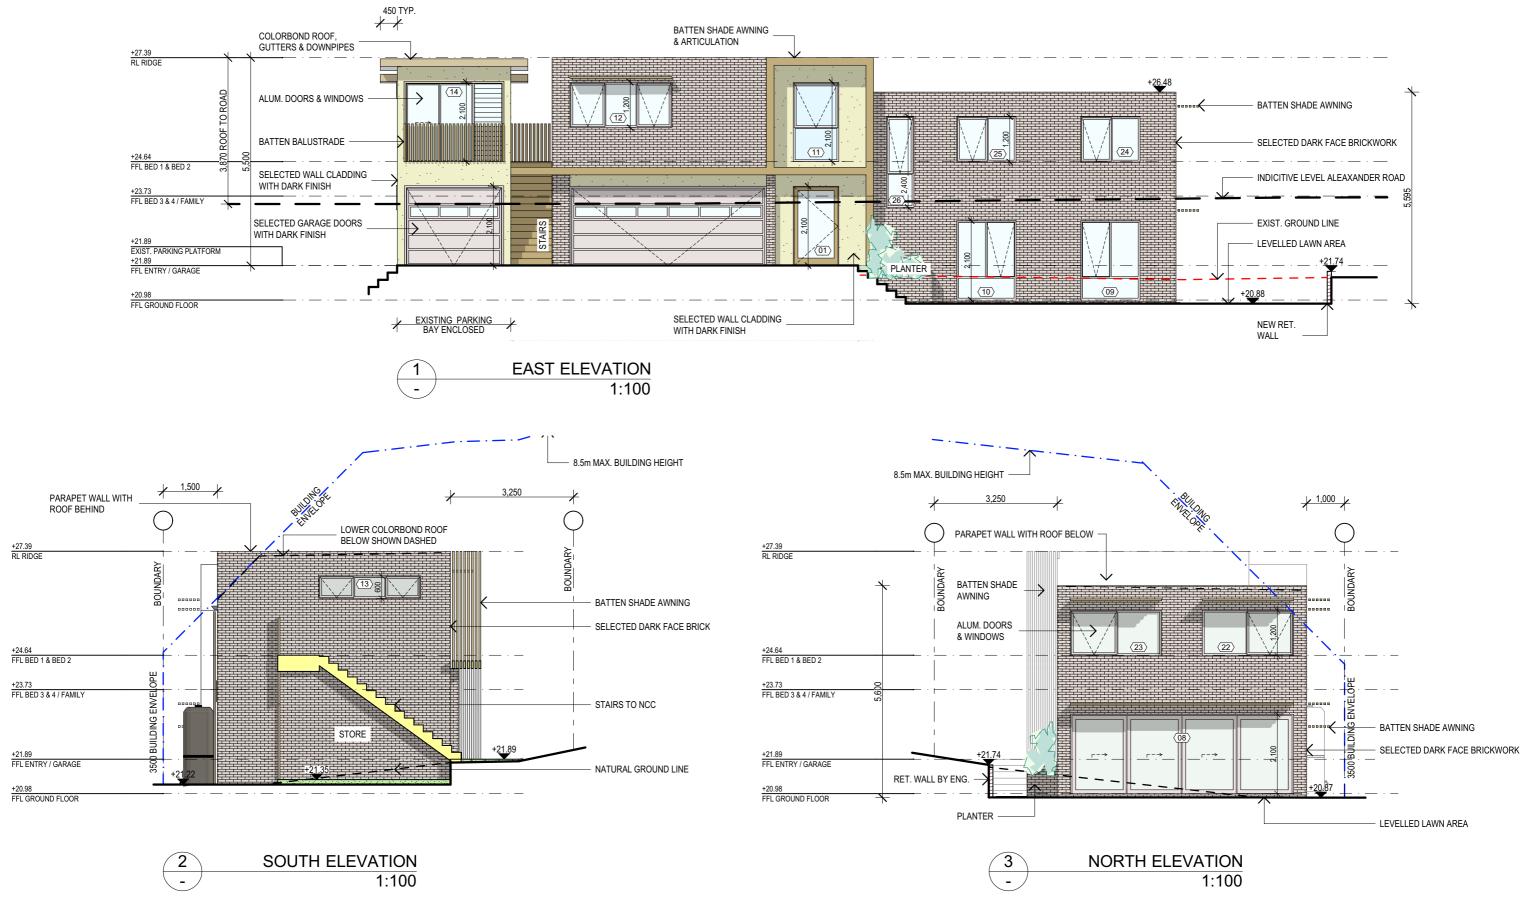

NOTES:

NOTES:

All structures including stormwater & drainage to engineer's details.

Do not obtain dimensions by scaling drawings.

All dimensions are to be checked on site prior to starting work.

These drawings are to be read in conjunction with all other consultant's drawings and specifications.

All workmanship & materials shall be in accordance with the requirements of current editions including amendments of the relevant SAA Codes of Practice, the Building Code of Australia and local council requirements.


New materials are to be used throughout unless otherwise noted.
Concrete footings, slab, structural beams or any other structural members are to be designed by a practicing engineer.


JJ Drafting


	REV:	DATE:	DESCRIPTION:	
1	Α	07.01.20	EXTRA NOTES	
2101	В	17.02.20	DRIVEWAY PROF. RAISE ENTRY/GARAGE	

PROJECT DETAILS: PROPOSED NEW HOUSE 34 WHALE BEACH ROAD, AVALON 2107	DATE:
DRAWING TITLE: ELEVATIONS - SHEET 1	JOB No

DATE:	DRAWN BY:	SCALE:	
NOV/19	AHB	1:100 @ A3	
JOB No:	CHECKED BY:	DRAWING No:	
692a/19	JJ	DA.05	

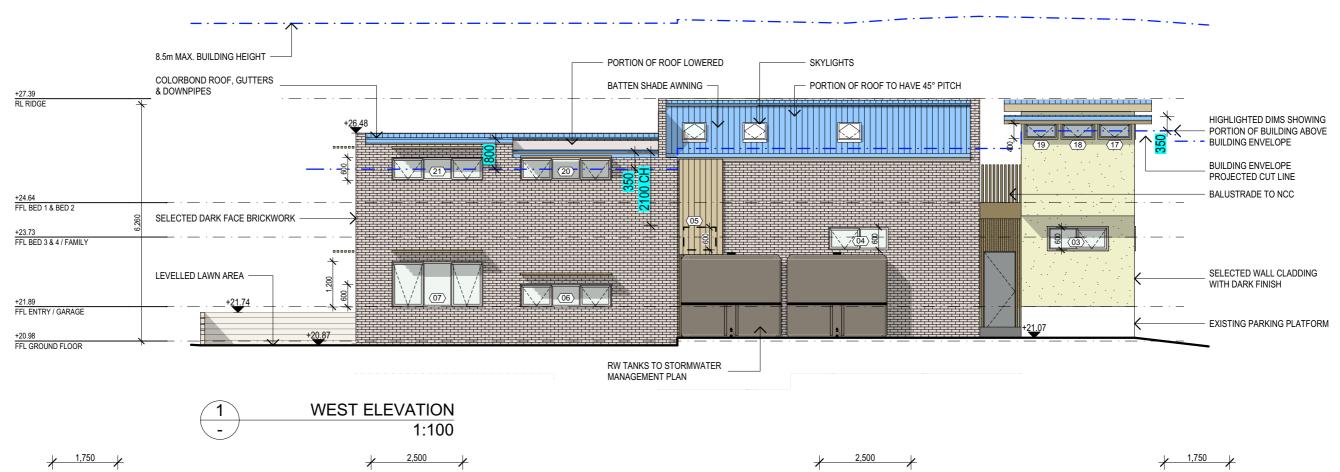

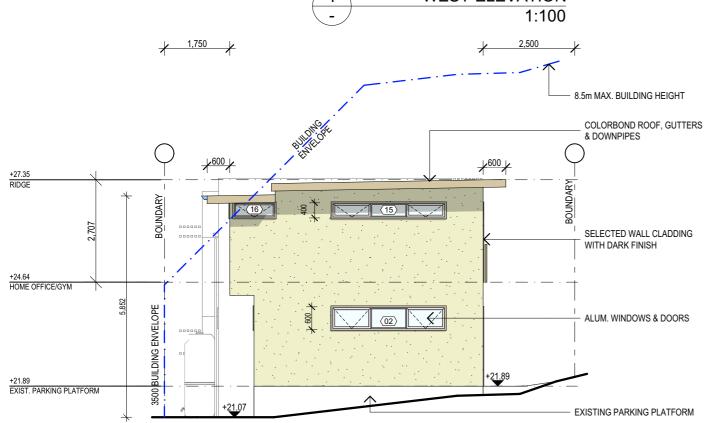

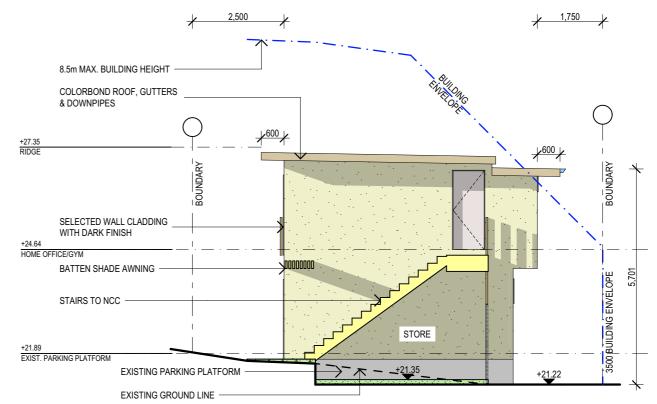

SOUTH ELEVATION 1:100

NORTH ELEVATION 1:100

NOTES:

 All structures including stormwater & drainage to engineer's details.
 Do not obtain dimensions by scaling drawings.
 All dimensions are to be checked on site prior to starting work. specifications.

• All workmanship & materials shall be in accordance with the requirements of current editions

All workmanship & materials shall be in accordance with the requirements of current editions including amendments of the relevant SAA Codes of Practice, the Building Code of Australia and local council requirements.

New materials are to be used throughout unless otherwise noted.

Concrete footings, slab, structural beams or any other structural members are to be designed by a practicing engineer.

JJ Drafting

	REV:	DATE:	DESCRIPTION:
	Α	07.01.20	EXTRA NOTES
01	В	17.02.20	DRIVEWAY PROF. RAISE ENTRY/GARAGE
01			

PROJECT DETAILS: PROPOSED NEW HOUSE 34 WHALE BEACH ROAD, AVALON 2107		D
DRAWING TITLE: FI EVATIONS - SHEET 2		J

DATE:	DRAWN BY:	SCALE:
NOV/19	AHB	1:100 @ A3
JOB No:	CHECKED BY:	DRAWING No:
692a/19	JJ	DA.06

BASIX REQUIREMENTS:

BASIX Inclusions for 34 Whale Beach Road, Avalon 2107

INSULATION

Wall Insulation; Ceiling Insulation; Min. R2.5 Min. R4.0 Floor Insulation

GLAZING

ALM-001-03 A Aluminium A SG High Solar Gain Low-E

<u>WATER</u>

- Shower Rating; - Toilet Rating; Minimum 3 Star Minimum 4 Star - Kitchen Taps Rating; - Bathroom Basin Taps Rating; Minimum 5 Star

Must install a rainwater tank of at least 3000 litres on site. Must connect at least 1 outdoor tap to the rainwater tank.

CONSTRUCTION

Floor - Concrete slab on ground - Suspended floor above garage

HOT WATER

- Gas instantaneous hot water system; Minimum 5 Stars

COOLING SYSTEM

- Living areas must not incorporate any cooling system, or any ducting which is designed to accommodate a cooling system.

- Bedrooms must not incorporate any cooling system, or any ducting which is designed to accommodate a cooling

HEATING SYSTEM

Must install a gas fixed flued heater (or similar) in at least 1 living area. Minimum 3 Star Rating.
 Must not incorporate any heating system, or ducting which is designed to accommodate a heating system in all

VENTILATION

The following exhaust systems must be installed;
- At least 1 bathroom - individual fan, not ducted, operation control: manual on/off switch.
- Kitchen - ducted to facade or roof, operation control: manual on/off switch.

- Laundry - individual fan, not ducted, operation control: manual on/off switch.

"Primary type of of artificial lighting" is fluorescent or light emitting diode (LED) lighting in each of the following rooms, and where the word "dedicated" appears, the fittings for those lights must only be capable of accepting fluorescent or light emitting diode (LED) lamps.

at least 4 of the bedrooms / study;at least 2 of the living / dining rooms; dedicated dedicated - the kitchen; - all bathrooms / toilets dedicated dedicated - the laundry; dedicated

NATURAL LIGHTING

- Must install a window and/or skylight in the kitchen of the dwelling for natural lighting.

- Must install a window and/or skylight in 3 bathroom(s)/toilet(s) in the development for natural lighting.

<u>OTHER</u>


Must install a gas cooktop & electric oven in the kitchen.
 Must install a fixed clothes drying line.

NOTES: TRUE NORTH:

- All structures including stormwater & drainage to engineer's details.
 Do not obtain dimensions by scaling drawings.
 All dimensions are to be checked on site prior to starting work.
 These drawings are to be read in conjunction with all other consultant's drawings and
- specifications.

 All workmanship & materials shall be in accordance with the requirements of current editions including amendments of the relevant SAA Codes of Practice, the Building Code of Australia and

- New materials are to be used throughout unless otherwise noted.
 Concrete footings, slab, structural beams or any other structural members are to be designed by a practicing engineer.

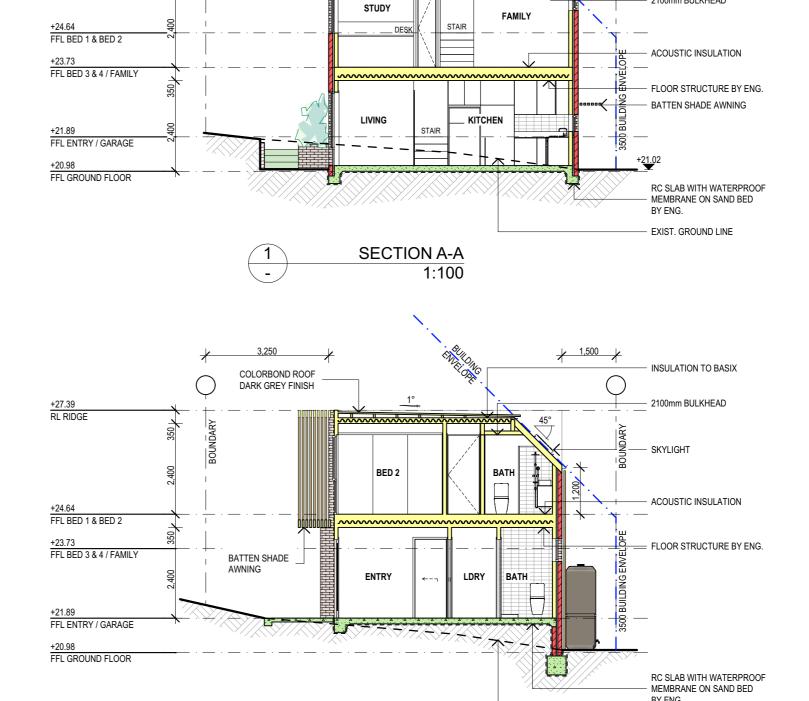

SECTION B-B

1:100

COLORBOND ROOF DARK GREY FINISH

+<u>26.4</u>8

NOTE:

HIGHLIGHTED DIMS SHOWING PORTION OF BUILDING ABOVE BUILDING ENVELOPE

+27.39 RL RIDGE

JJ Drafting

174 Garden St, North Narrabeen, NSW, 210 PO Box 687, Dee Why, NSW, 2099 Mob. 0414 717 541 Email. jjdraft@tpg.com.au www.jjdrafting.com.au

	REV:	DATE:	DESCRIPTION:
	Α	07.01.20	EXTRA NOTES
,	В	17.02.20	DRIVEWAY PROF. RAISE ENTRY/GARAGE


PROJECT DETAILS: PROPOSED NEW HOUSE 34 WHALE BEACH ROAD, AVALON 2107	DATE: NOV/19	DRAWN BY:	SCALE: 1:100 @ A3
DRAWING TITLE: SECTION A-A, SECTION B-B / BASIX	JOB No: 692a/19	CHECKED BY:	DRAWING No: DA.07

EXIST. GROUND LINE

¥ 1,000 ¥

INSULATION TO BASIX

2100mm BULKHEAD

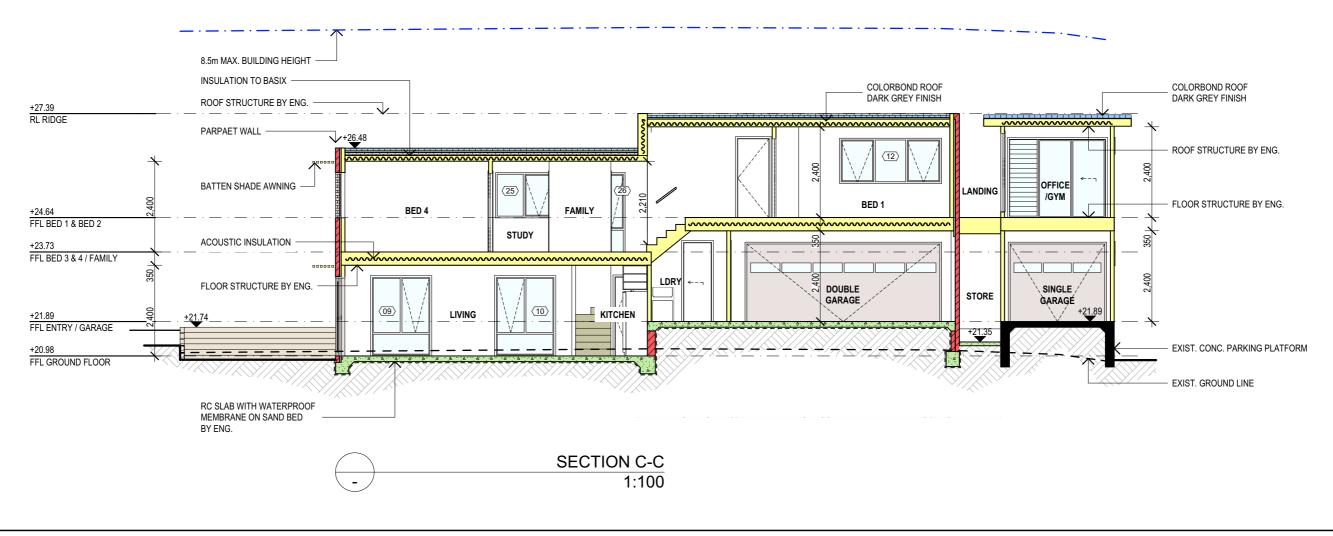

SPECIFICATION NOTES:

INTERNAL LINING:
- PROVIDE PLASTERBOARD LINING.

EXTERNAL WALLS:
- BRICK VENEER WALLS WITH SELECTED BRICKS TO DWELLING.

- LIGHTWEIGHT TIMBER CLADDING OR SIMILAR TO SINGLE GARAGE/GYM.

- GROUND FLOOR TO BE REINFORCED CONCRETE SLAB IN ACCORDANCE WITH AS2870.
 FIRST FLOOR TO BE TIMBER FRAMED FINISHED WITH T&G HARDWOOD FLOORING.

- ALL WATERPROOFING TO AS 3740 - PROVIDE A GUARANTEED FLEXIBLE WATERPROOF MEMBRANE TO ALL WET AREA FLOORS & SHOWERS WALLS TO MANUFACTURES INSTRUCTIONS

<u>BEARERS AND JOISTS:</u>
- SHALL BE INSTALLED TO COMPLY WITH AS1684 AS AMENDED FOR TIMBER COMPONENTS OR AS3620 FOR LIGTHWEIGHT STEEL FRAMING SECTIONS OR AS PER THE NASH ALTERNATIVES TO AS 3623.

ANT CAPS:
- SHALL BE INSTALLED IN ACCORDANCE WITH AS3660.

NCC VOL.2 PART 3.5.1

DESIGN AND INSTALLATION SHALL BE IN ACCORDANCE WITH AS/NZS 1562.

ROOFING:
- COLORBOND ROOF CLADDING

- SHALL BE IN ACCORDANCE WITH NCC VOL.1 PART B1.4 OR VOL.2 PART 3.2.3. ALL WORKMANSHIP AND MATERIALS SHALL BE IN ACCORDANCE WITH CURRENT EDITIONS OF THE

CONCRETE BLOCKS OR BRICKS:
- TO COMPLY WITH TO AS4455 MANSORY BUILDING BLOCKS/PAVER.

- FOOTINGS TO BE IN ACCORDANCE WITH AS1480. FOOTINGS TO BE IN ACCORDANCE WITH NCC VOL.2 PARTS 3.2.3, 3.2.4 AND 3.2.5
- ALL REINFORCEMENTS SHALL CONFORM TO AS1302, AS1303 AND AS1304.

BRICK AND BLOCKWORK:
- CONSTRUCTION OF MASONRY BUILDINGS SHALL BE AS PER AS3700 OR AS4773.

- TIMBER TO COMPLY WITH AS1170.2 OR AS4055.
- ALL WORKMANSHIP AND MATERIALS SHALL BE IN ACCORDANCE WITH AS1684 AND 1720 AS APPLICABLE.

- TO COMPLY WITH NCC VOL.2 PART 3.4 GROUND FLOOR TIMBERS SHALL BE ONLY OF HARDWOOD, CYPRESS PINE OR PRESSURE TREATED RADIATA OR CANADA PINE BELOW A HEIGHT OF 300mm ABOVE FINISHED GROUND LEVEL AND MUST NOT BE BUILT INTO BRICKWORK.
- SUBFLOOR VENTILATION SHALL CONFORM TO NCC VOL.2 PART 3.4.1.
- IN BUSHFIRE PRONE AREAS SPECIAL CONDITIONS APPLY
- WHERE TERMITE BARRIERS NEED TO BE INSPECTED, 400mm CLEARANCE IS REQUIRED BETWEEN THE UNDERSIDE OF BEARER AND GROUND SURFACE.
- USE TREATED TIMBER WHERE REQUIRED FOR DURABILITY
- DO NOT USE TIMBER UNSUITABLE FOR EXPOSURE TO MOISTURE IN EXPOSED LOCATION.
 PROVIDE STRUCTURE BRACING IN ACCORDANCE WITH AS1684
- PROVIDE STRUCTURE TIEDOWN IN ACCORDANCE WITH AS1684
- USE GALVANISED FIXINGS WHERE EXPOSED TO WEATHER.

- TERMITE CONTROL:
 TO BE IN ACCORDANCE WITH TO AS3660.1
- SHALL BE IN ACCORDANCE WITH NCC VOL.2 PART 3.1.3 OR VOL.1 PART B1.4.

- SELECTION AND INSTALLATION OF METAL RAINWATER GOODS REFER TO AS2180
- FLASH PROJECTIONS ABOVE THE ROOF WITH TWO PART FLASHINGS CONSISTING OF AN APRON FLASHING AND OVER FLASHING, WITH AT LEAST 100mm OVERLAP.
- PROVIDE FOR INDEPENDENT MOVEMENT BETWEEN ROOF AND PROJECTION.

- 40% OF NEW OR ALTERED LIGHT FIXTURES TO BE FITTED WITH FLUORESCENT, COMPACT FLUORESCENT, OR LIGHT-EMITTING-DIODE (LED) LAMPS

- ALL FRAMED WINDOWS SHALL BE INSTALLED IN ACCORDANCE WITH AS2047-48 FOR ALUMINIUM WINDOWS AND AS2047 FOR TIMBER WINDOWS.
- ALUMINIUM FRAMED WINDOWS AND DOORS
- WEATHER STRIPPING IS TO BE PROVIDED TO ALL EXTERNAL WINDOWS AND DOORS.

STAIRS, HANDRAILS AND BALUSTRADES:

- SOLID COLORBOND BALUSTRADE
- NCC VOL.2 PARTS 3.9.1 AND 3.9.2
- RELATIONSHIP OF RISER TO GOING SHALL BE BETWEEN 1:2 AND 1:1.35 UNLESS OTHERWISE DIRECTED TO GOING SHALL BE BETWEEN 1:2 AND 1:1.35 UNLESS OTHERWISE DIRECTED OR AS PERMITTED IN
- BALUSTRADES SHALL BE PROVIDED TO ALL LANDINGS, RAMPS, DECKS, ROOFS AND OTHER ELEVATED PLATFORMS WHERE THE VERTICAL DISTANCE FROM THAT LEVEL IS MORE THAN 1m ABOVE THE ADJOINING FLOOR OR FINISHED GROUND LEVEL.
- THE HEIGHT OF BALUSTRADE MUST BE A MINIMUM OF 1m HIGH ABOVE LANDING AND NOT LESS THAN 865mm ABOVE THE NOSINGS OF ANY STAIR TREADS OR FLOOR RAMP AND HAVE NO OPENING GREATER
- THE HEIGHT OF BALUSTRADE TO THE NEW STAIR CASES IS TO BE MEASURED A MINIMUM 865 mm ABOVE THE NOSING LINE AND HAVE NO OPENING GREATER NO OPENING GREATER THAN 125 mm.

- MATERIALS TO BE USED FOR SURFACES OF FLOORS, STAIR LANDING, STEPS AND NOSINGS SHALL BE IN ACCORDANCE WITH THE CLASSIFICATIONS FOR SLIP RESISTANCE AS APPLY IN AS4586 AND

EAVES GUTTERS, VALLEY GUTTERS AND DOWPIPES

- TO COMPLY WITH AS/NZS 2179 FOR METAL AND AS1273 FOR UPVC COMPONENTS.
- NEW DOWNPIPES TO BE CONNECTED INTO EXISTING STORMWATER LINE
- COLORBOND GUTTERS AND DOWNPIPES
- MINIMUM SLOPE OF EAVES AND GUTTERS 1:200

-NCC VOL.1 PARTS B 1.4, D 3.12, F1.13 OR NCC VOL.2 PART 3.6

- NCC VOL 2 PART 3.7.2, FIRE/SMOKE DETECTORS COMPLYING WITH THE REQUIREMENTS OF THE LOCAL GOVERNMENT ACT AND/OR STATE OR TERRITORY REGULATIONS MUST BE FITTED IN THE LOCATIONS REQUIRED AND APPROVED BY THE AUTHORITY AND SHALL BE INSTALLED IN ACCORDANCE WITH AS3786
- INSTALLATIONS IN BUILDINGS OTHER THAN CLASS 1 AND 10 MUST BE INSTALLED AND MANAGED TO
- COMPLY WITH NCC SPEC. E2.2a.
 MULTIPLE ALARMS WITHIN HOUSES AND SOLE OCCUPANCY UNITS MUST BE HARD WIRED AND

WASTE MANAGEMENT:

- ALL WASTE SHALL BE TAKEN AWAY BY TRUCKS TO A SUITABLE LANDFILL OR RECYCLE DEPOT. ALL WASTE SHALL BE COVERED DURING TRANSPORTATION.
- WASTE GENERATED DURING CONSTRUCTION SHALL BE PLACED IN STEEL BINS AND TAKEN AWAY BY
- AN APPROVED CONTRACTOR TO A APPROVED LANDFILL SITE.

SEDIMENT CONTROL

- A FILTER CLOTH SYSTEM SHALL BE INSTALLED TO STOP ANY SEDIMENT ENTERING COUNCILS STORMWATER SYSTEM.

ALL PLANS ARE TO BE READ IN CONJUNCTION AND COMPLY WITH THE BASIX CERTIFICATE, ANY RELEVANT REPORTS

TRUE NORTH:



NOTES:

- All structures including stormwater & drainage to engineer's details.
 Do not obtain dimensions by scaling drawings.
 All dimensions are to be checked on site prior to starting work.
 These drawings are to be read in conjunction with all other consultant's drawings and
- All workmanship & materials shall be in accordance with the requirements of current editions
- including amendments of the relevant SAA Codes of Practice, the Building Code of Australia and ordinant requirements.

 whaterials are to be used throughout unless otherwise noted.

 acrete footings, slab, structural beams or any other structural members are to be designed by
- JJ Drafting
- 174 Garden St, North Narrabeen, NSW, 2101 PO Box 687, Dee Why, NSW, 2099 Mob. 0414 717 541 Email. jjdraft@tpg.com.au www.jjdrafting.com.au
- REV: DATE: DESCRIPTION: 07.01.20 Α EXTRA NOTES В 17.02.20 DRIVEWAY PROF. RAISE ENTRY/GARAGE
 - PROJECT DETAILS: PROPOSED NEW HOUSE 34 WHALE BEACH ROAD, AVALON 2107 DRAWING TITLE:


SECTION C-C / SPECIFICATIONS

- DATE: NOV/19 JOB No:

692a/19

DRAWN BY: AHB CHECKED BY: SCALE: 1:100 @ A3

DRAWING No:

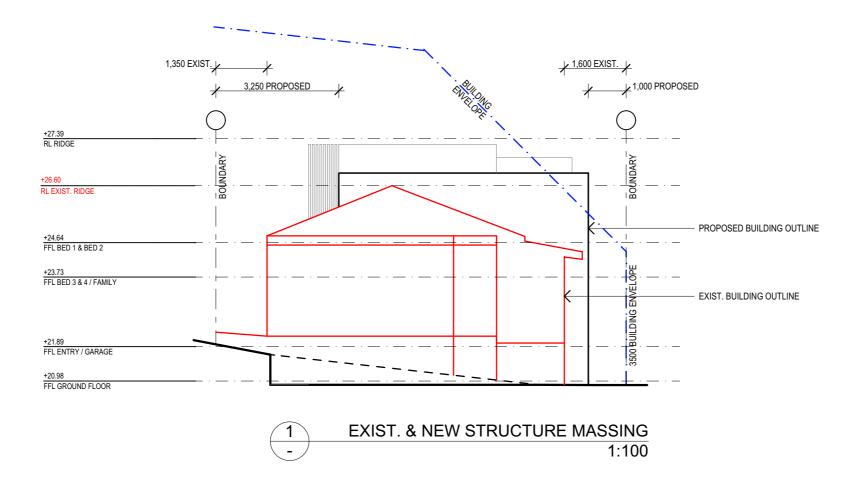


*13.₁₃ *15,05 (G) (L) (H)**(c)** (**B**) RL 23.43 < 800 EASE > RL 21.89

DRIVEWAY PROFILE - EXTRA LOW					
POINT REMARK LEVE					
G	Gutter invert	23.43			
L	Rear of layback	23.53			
Н	2000 From kerb line	23.58			
В	2800 From kerb line	23.54			
С	4800 From kerb line	23.24			

DRIVEWAY PROFILE - MAXIMUM LOW POINT REMARK LEVELS Gutter invert 23.43 Back of layback 23.53 2500 From kerb line 23.40 3500 From kerb line 23.165 Boundary

EXISTING APPROVED (2011) PROFILE THAT RELATES TO SECONDARY DWELLING

NEW DRIVEWAY PROFILE TO MATCH

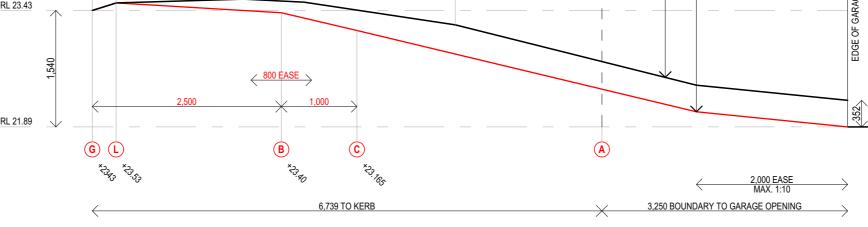

NOTE:

THE DESIGN OF ALL DRIVEWAYS SHALL BE IN ACCORDANCE WITH AUSTRALIAN STANDARD AS2890 Part 1 Off Street Car

DRIVEWAY PROFILE - EXTRA LOW 1:50

NOTES:

All structures including stormwater & drainage to engineer's details.
 Do not obtain dimensions by scaling drawings.
 All dimensions are to be checked on site prior to starting work.

- specifications.

 All workmanship & materials shall be in accordance with the requirements of current editions All workmanship & materials shall be in accordance with the requirements of current editions including amendments of the relevant SAA Codes of Practice, the Building Code of Australia and local council requirements.
 New materials are to be used throughout unless otherwise noted.
 Concrete footings, slab, structural beams or any other structural members are to be designed by a practicing engineer.

JJ Drafting

174 Garden St, North Narrabeen, NSW, 2101 PO Box 687, Dee Why, NSW, 2099 Mob. 0414 717 541 Email. jjdraft@tpg.com.au www.jjdrafting.com.au

	REV:	DATE:	DESCRIPTION:
	Α	07.01.20	EXTRA NOTES
01	В	17.02.20	DRIVEWAY PROF. RAISE ENTRY/GARAGE
٠.			

PROJECT DETAILS: PROPOSED NEW HOUSE 34 WHALE BEACH ROAD, AVALON 2107	DATE: NOV/19	DRAWN BY:	SCALE: 1:50, 1:100 @ A3
DRAWING TITLE: MASSING ELEVATION & DRIVEWAY PROFILE	JOB No: 692a/19	CHECKED BY:	DRAWING No: DA.09

PARKING FACILITY


(MAX GRADE 1V:20H) RL 21.89

COMLYING 'EXTRA LOW' DRIVEWAY PROFILE.


DWELLING APPROVED 2011. SHOWN RED

'MAXIMUM LOW' DRIVEWAY PROFILE TO SECONDARY

SHOWN BLACK.

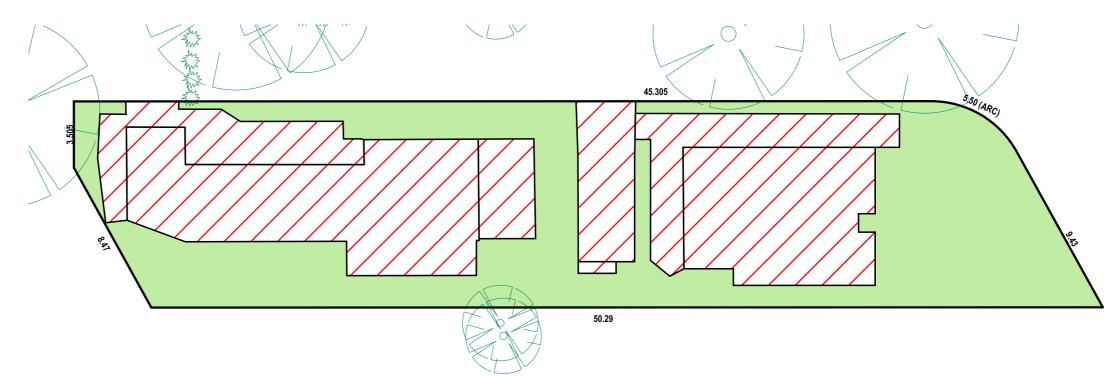

LANDSCAPED AREA CALCULATION PLAN - EXISTING

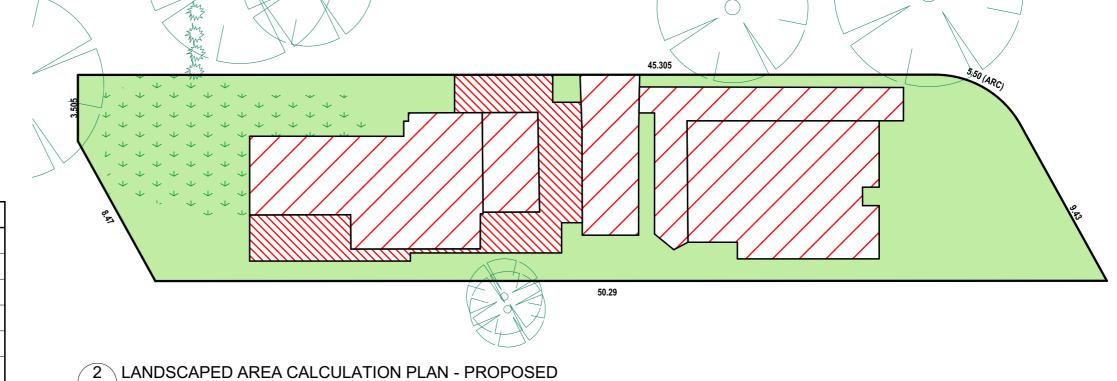

1:200

CALCULATIONS SITE AREA 544.00m² LANDSCAPE CONTROL 50% 272.00m² EXISTING LANDSCAPED AREA 47.82% 260.13m² HARD SURFACE REINSTATED TO LAWN 63.58m² TOTAL LANDSCAPED AREA 51.18% 278.42m² EXISTING HARD SURFACE AREA 283.87m² HARD SURFACE AREA TO BE RETAINED 216.64m² NEW HARD SURFACE AREA 48.94m² TOTAL HARD SURFACE AREA 265.58m²

TRUE NORTH:

NOTES:

- NOTES:

 All structures including stormwater & drainage to engineer's details.

 Do not obtain dimensions by scaling drawings.

 All dimensions are to be checked on site prior to starting work.

 These drawings are to be read in conjunction with all other consultant's drawings and specifications.

 All workmanship & materials shall be in accordance with the requirements of current editions including amendments of the relevant SAA Codes of Practice, the Building Code of Australia and local council requirements.

 New materials are to be used throughout unless otherwise noted.

 Concrete footings, slab, structural beams or any other structural members are to be designed by a practicing engineer.

JJ Drafting

	REV:	DATE:	DESCRIPTION:
1	Α	07.01.20	EXTRA NOTES
2101	В	17.02.20	DRIVEWAY PROF. RAISE ENTRY/GARAGE

PROJECT DETAILS: PROPOSED NEW HOUSE 34 WHALE BEACH ROAD, AVALON 2107	DATE: NOV/19	DRAWN BY:	SCALE: 1:200 @ A3
DRAWING TITLE: LANDSCAPED AREA CALCULATION PLAN	JOB No: 692a/19	CHECKED BY:	DRAWING No: DA.10

NOTES:

DESIGNATED SITE MANAGER/BUILDER

PRIOR TO COMMENCEMENT OF WORK A SITE MANAGER OR BUILDER MUST BE NOMINATED. THE SITE MANAGER OR BUILDER WILL BE RESPONSIBLE AND LIABLE FOR ALL WORKS CARRIED OUT ON THE SITE. THIS ASSUMES THE RESPONSIBILITY FOR THE ACTIONS OF ALL SUBCONTRACTED PARTIES AS WELL AS ADVISING THEM OF COUNCIL'S REQUIREMENTS WHEN CARRYING OUT WORKS

TOPSOIL MANAGEMENT

PRIOR TO THE STRIPPING OF TOPSOIL, THE VEGETATIVE COVER MUST BE REDUCED BY EITHER SLASHING OR MOWING. ALL TOPSOIL IS TO BE RETAINED AND PROTECTED FOR REUSE ON SITE. SOIL STOCKPILES MUST NOT BE LOCATED ON NATURE STRIPS, FOOTPATHS, ROADWAYS, KERBS, ACCESSWAYS, WITHIN DRAINAGE LINES/FLOWS/PATHS OR AROUND OR AGAINST TREE SHRUBS SEDIMENT CONTROL MEASURES MUST BE INCORPORATED WITH ANY RESULTING STOCKPILE. THE STOCKPILE CAN BE PROTECTED FROM EROSION BY COVERING T WITH AN IMPERVIOUS MATERIAL, IN CONJUNCTION WITH THE INSTALLATION OF A SEDIMENT FENCE AROUND IT. IF STOCKPILES ARE TO REMAIN FOR MORE THAN ONE MONTH THEY ARE TO BE GRASSED IMMEDIATELY AND STABILISED WITHIN FOURTEEN DAYS. SURPLUS TOPSOIL MUST BE REASONABLY REMOVED FROM

BUILDING MATERIAL STOCKPILING

SUFFICIENT AREA MUST BE ALLOCATED WITHIN THE SITE FOR SUCH STORAGE OF BUILDING MATERIALS, DEMOLITION WASTE, WASTE CONTAINERS, ETC. AS WILL

SEDIMENT FENCES

A SEDIMENT FENCE SHOULD BE LOCATED ALONG THE DOWNSLOPE BOUNDARY (S) OF THE SITE, ON THE CONSTRUCTION SIDE OF THE TURF FILTER STRIP OR NATIVE VEGETATION, AND AROUND ALL STOCKPILES OF MATERIAL ON THE SITE.

ALL TRUCKS/UTES MUST COVER THEIR LOADS AT ALL TIMES. APPROPRIATE METHODS ARE TO BE EMPLOYED TO PREVENT BLOWING DUST CREATING AN UNACCEPTABLE HAZARD OR NUISANCE ON THE SITE OR DOWN WIND. PRODUCTION OF DUST CAN BE MINIMISED BY LIMITING AREA OF EARTHWORKS, WATERING AND PROGRESSIVE VEGETATION. WHERE DUST IS CREATED AS A RESULT WORKS AND/OR SOIL EXPOSURE, THE BARE SOIL AREAS MUST BE WATERED, DURING AND/OR AT THE END OF EACH DAY TO LAY THE DUST. EARTH MOVING ACTIVITIES SHOULD BE AVOIDED WHERE WINDS ARE SUFFICIENTLY STRONG ENOUGH TO RAISE VISIBLE DUST

EROSION & SEDIMENT CONTROLS

APPROPRIATE EROSION AND SEDIMENT CONTROLS MUST BE IMPLEMENTED ON ALL SITES THAT INVOLVE SOIL DISTURBANCE. THE MEASURES MUST BE IN PLACE PRIOR TO THE COMMENCEMENT OF WORK. THOSE CONTROLS ARE TO BE MONITORED AND MAINTAINED IN ORDER TO SERVE THEIR INTENDED FUNCTION FOR THE DURATION OF THE WORKS OR UNTIL SUCH TIME AS THE SITE IS FULLY STABILISED. IF ANY CONTROLS ARE DAMAGED OR BECOME INEFFECTIVE DURING THE COURSE OF THE WORKS THEY ARE TO BE REINSTATED OR REPLACED IMMEDIATELY. SUFFICIENT ACCESS TO THESE CONTROLS MUST BE PROVIDED IN CASE OF THE NEED TO REPAIR


WHERE A SEDIMENT FENCE IS NOT USED APPROPRIATE SEDIMENT TRAPS SHOULD BE LOCATED AT ALL POINTS WHERE STORMWATER LEAVES THE CONSTRUCTION SITE OR LEAVES THE GUTTER AND ENTERS THE DRAINAGE SYSTEM. A COMMON TECHNIQUE IS THE GRAVEL SAUSAGE

DIVERSION CHANNELS


A DIVERSION CHANNEL IS AN EXCAVATED EARTH DITCH OR PATH. THESE STRUCTURES ARE USED TO INTERCEPT AND DIRECT RUN-OFF TO A DESIRED LOCATION WHERE POSSIBLE. ALL STORMWATER RUN-OFF FLOWING ONTO DISTURBED AREAS, INCLUDING STOCKPILES, MUST BE INTERCEPTED, DIVERTED AND/OR SAFELY DISPOSED OF. THIS CAN BE ACHIEVED BY CONSTRUCTING A TEMPORARY EARTH BANK AROUND THE UPSLOPE EXTENT OF THE CONSTRUCTION SITE WHERE THE DIVERSION DOES NOT AFFECT THE VEIGHBOURING PROPERTIES


VEHICLE MOVEMENTS

TO LIMIT DISTURBANCE TO THE SITE AND TRACKING OF MATERIAL ONTO THE STREET ALL VEHICLES AND PLANT EQUIPMENT ARE TO USE A SINGLE ENTRY/EXIT POINT UNLESS COUNCIL HAS APPROVED ALTERNATIVE ARRANGEMENTS. ACCESS POINTS AND PARKING AREAS ARE TO BE STABILISED WITH COMPACTED SUB-GRADE ASAP AFTER THEIR FORMATION. IF SPILLAGE DOES OCCUR IT IS TO BE CONTAINED IMMEDIATELY AND CAREFULLY REMOVED. THE AREA AFFECTED IS TO BE RESTORED TO A STANDARD EQUAL TO OR BETTER THAN ITS PREVIOUS CONDITION. ALL VEHICLES ARE TO BE WASHED PRIOR TO EXISTING THE SITE. THIS SERVES THE PURPOSE OF REMOVING SITE MATERIAL ON THE VEHICLE AND PREVENTS IT FROM BEING DEPOSITED ON THE ROAD NETWORK ADJACENT TO THE SITE AND THUS, THE STORMWATER SYSTEM. NO VEHICLE ASSOCIATED WITH THE WORK IS TO BE PARKED ON A FOOTPATH OR PUBLIC RESERVE. ALL VEHICLES /ISITING THE SITE DURING DEMOLITION, EXCAVATION AND/OR CONSTRUCTION WORKS, ARE TO COMPLY WITH THE PARKING REQUIREMENTS IN THAT AREA.

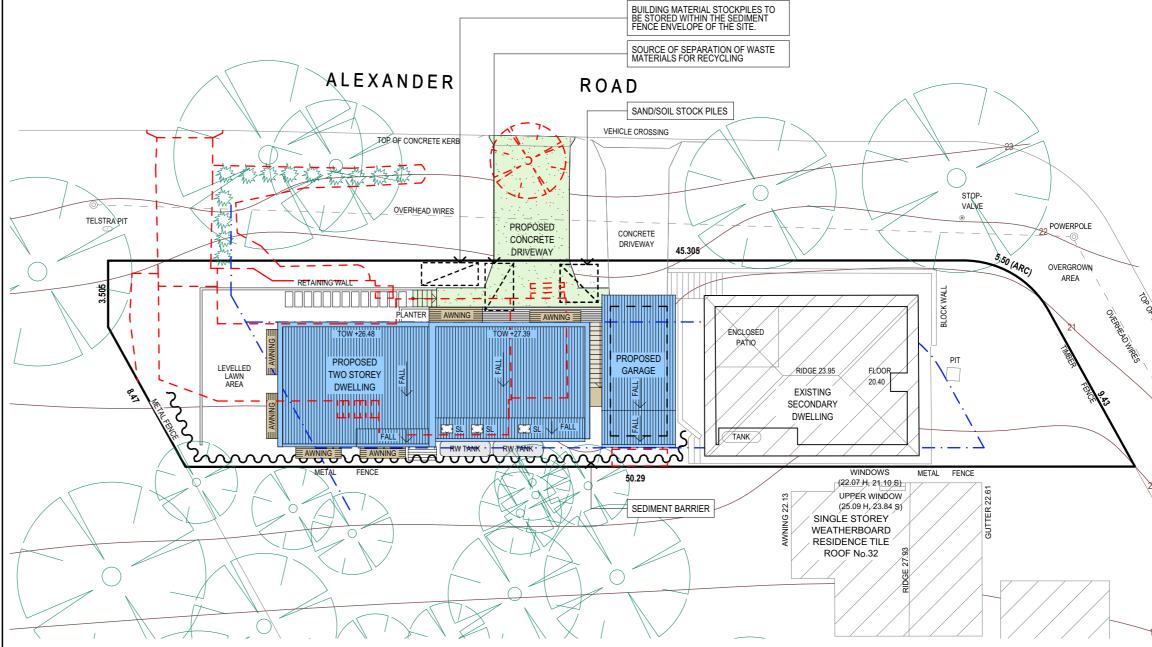

EROSION & SEDIMENT CONTROL / WASTE MANAGEMENT PLAN 1:200

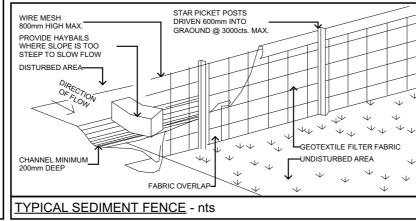

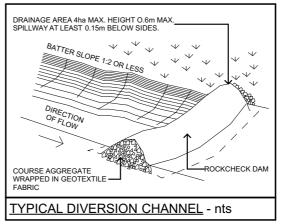

TRUE NORTH:




- All structures including stormwater & drainage to engineer's details.
 Do not obtain dimensions by scaling drawings.
 All dimensions are to be checked on site prior to starting work.
 These drawings are to be read in conjunction with all other consultant's drawings and
- All workmanship & materials shall be in accordance with the requirements of current edition including amendments of the relevant SAA Codes of Practice, the Building Code of Australia and
- romaterials are to be used throughout unless otherwise noted.

 crete footings, slab, structural beams or any other structural members are to be designed by


JJ Drafting
174 Garden St, North Narrabeen, NSW, 210
PO Box 687, Dee Why, NSW, 2099
Mob. 0414 717 541
Email. jjdraft@tpg.com.au
www.iidrafting.com.au

REV:	DATE:	DESCRIPTION:	PROJECT DETAILS:	DATE:	DRAWN BY:	SCALE:	
Α	07.01.20	EXTRA NOTES	PROPOSED NEW HOUSE	NOV/19	AHB	1:200 @ A3	
В	17.02.20	DRIVEWAY PROF. RAISE ENTRY/GARAGE	34 WHALE BEACH ROAD, AVALON 2107	1404/10	7410	1.200 @ 710	
			DRAWING TITLE:	JOB No:	CHECKED BY:	DRAWING No:	
			EROSION & SEDIMENT CONTROL / WASTE MANAGEMENT	692a/19	l LL	DA.11	
			PLAN	3324/10		JA.11	

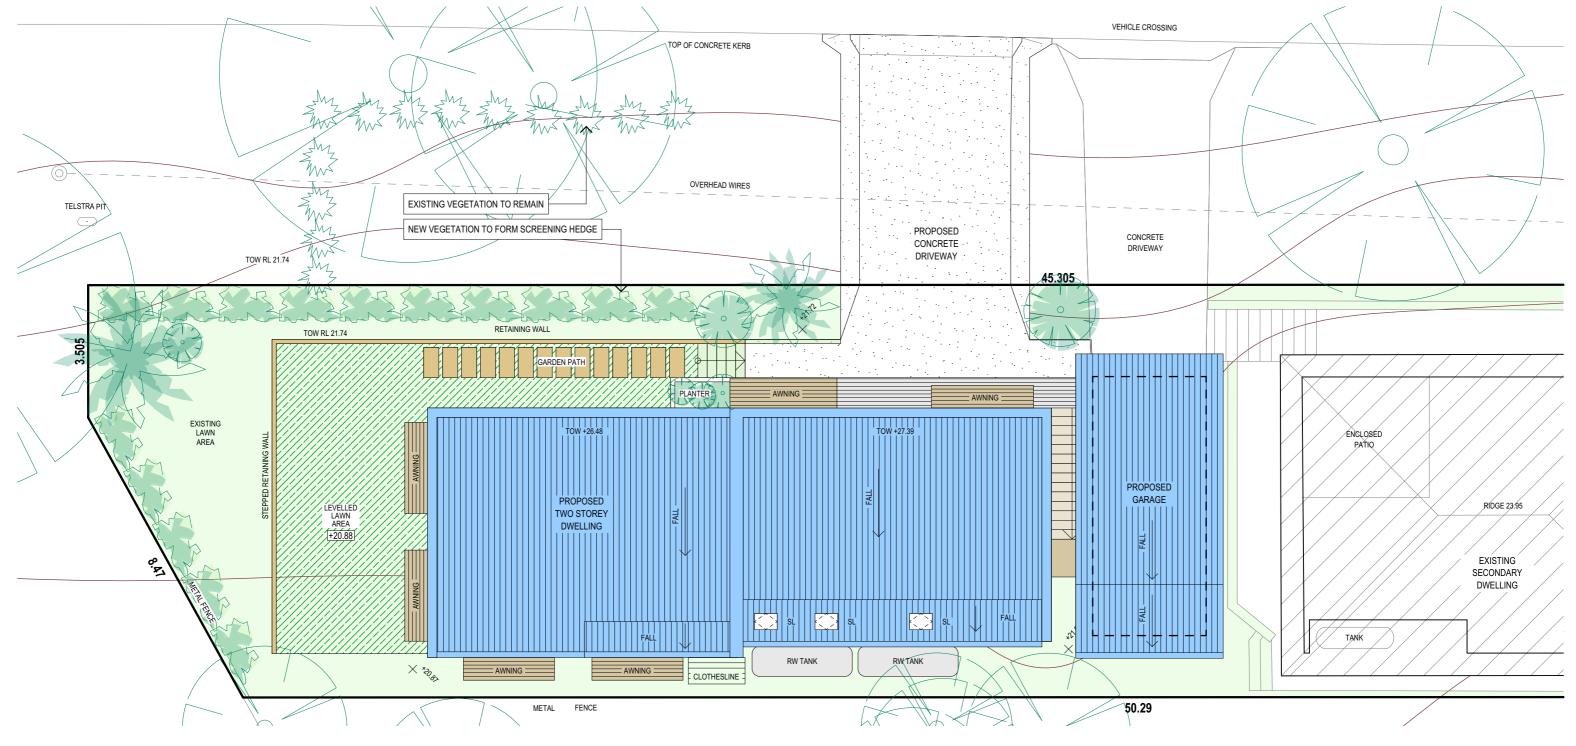

LANDSCAPE CONCEPT PLAN 1:100

SYMBOL	COMMON NAME	SCIENTIFIC NAME	HEIGHT	SPREAD	QTY
A.	Willow Bottlebrush	Callistemon salignus	7m	5m	2
E.S.	Lilly Pilly	Syzygium cascade	3m	2m	15
	Dwarf magnolia 'little gem'	Magnolia grandiflora	4m	2.5m	6
	Existing trees - varies	-	-	-	-
ZWZ WX	Existing shrubs - varies	-	-	-	-

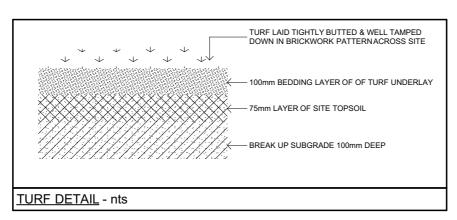

TRUE NORTH:

NOTES:

- NOTES:

 All structures including stormwater & drainage to engineer's details.

 Do not obtain dimensions by scaling drawings.

 All dimensions are to be checked on site prior to starting work.

 These drawings are to be read in conjunction with all other consultant's drawings and specifications.

 All workmanship & materials shall be in accordance with the requirements of current editions including amendments of the relevant SAA Codes of Practice, the Building Code of Australia and local council requirements.


 New materials are to be used throughout unless otherwise noted.

 Concrete footings, slab, structural beams or any other structural members are to be designed by a practicing engineer.

JJ Drafting

	REV:	DATE:	DESCRIPTION:	PROJECT
9	Α	07.01.20	EXTRA NOTES	PRO
2101	В	17.02.20	DRIVEWAY PROF. RAISE ENTRY/GARAGE	34 W
9				DRAWING
				LANI
	1			1

	PROJECT DETAILS: PROPOSED NEW HOUSE 34 WHALE BEACH ROAD, AVALON 2107	DATE: NOV/19	DRAWN BY:	SCALE: 1:100 @ A3
	DRAWING TITLE: LANDSCAPE CONCEPT PLAN	JOB No: 692a/19	CHECKED BY:	DRAWING No: DA.12

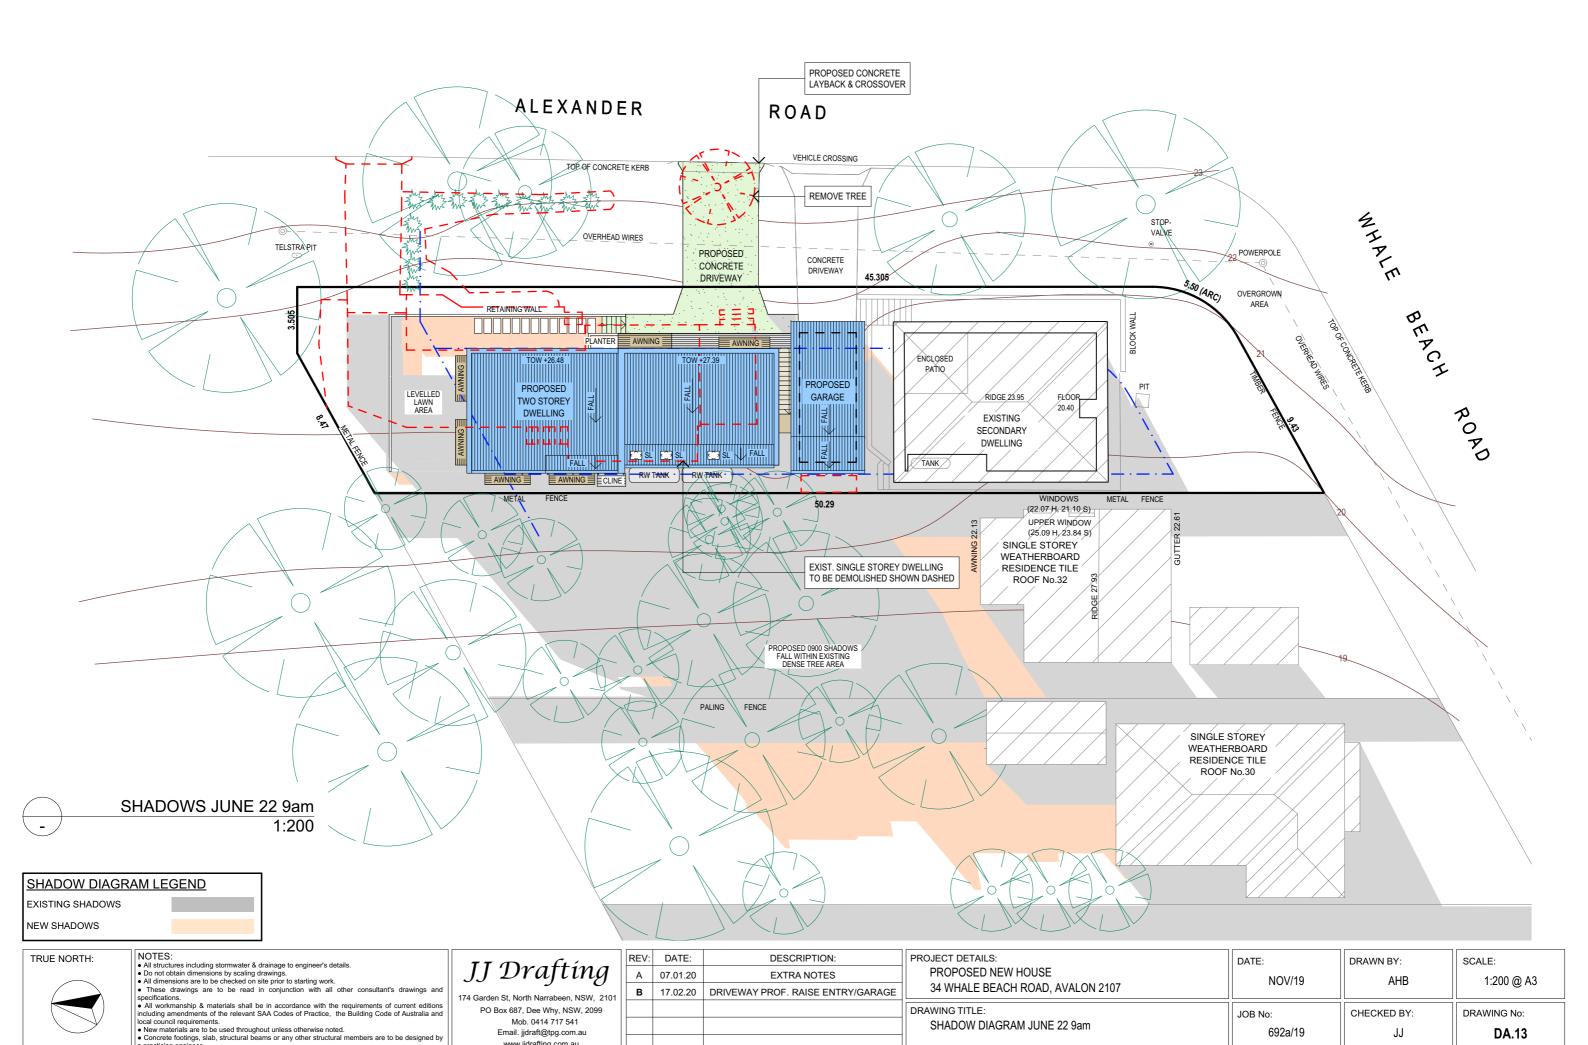


Email. jjdraft@tpg.com.au www.jjdrafting.com.au

a practicing engineer.

692a/19

JJ

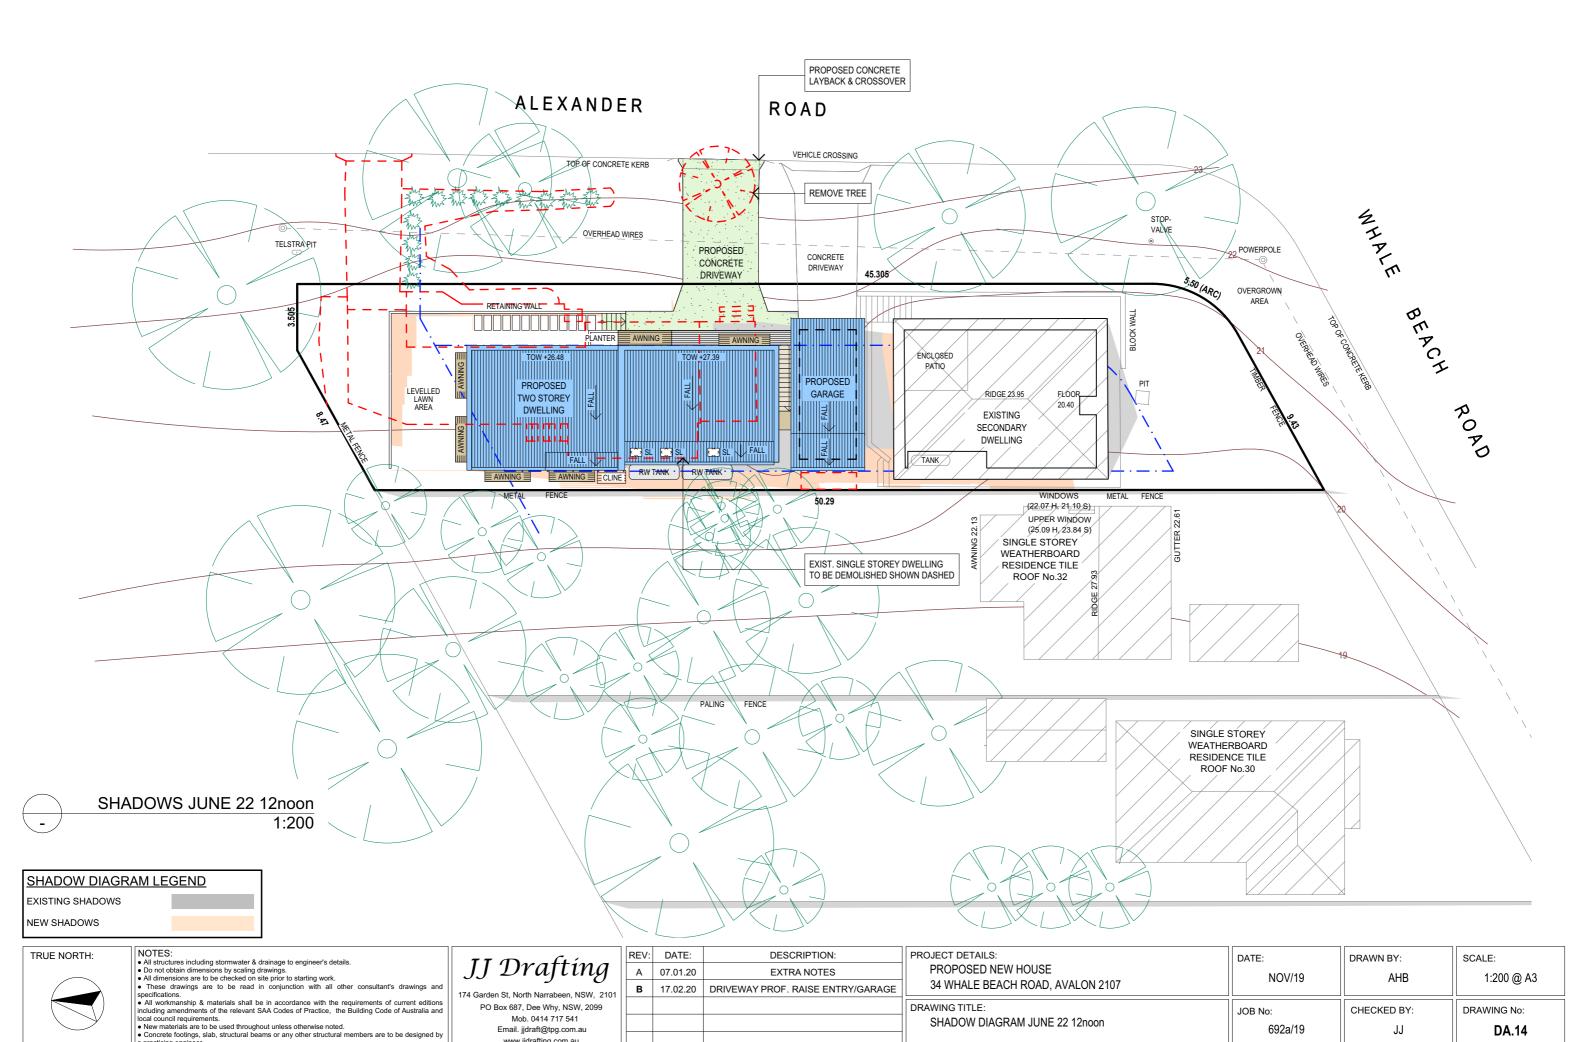

SHADOW DIAGRAM JUNE 22 12noon


692a/19

JJ

DA.14

Mob. 0414 717 541

Email. jjdraft@tpg.com.au www.jjdrafting.com.au

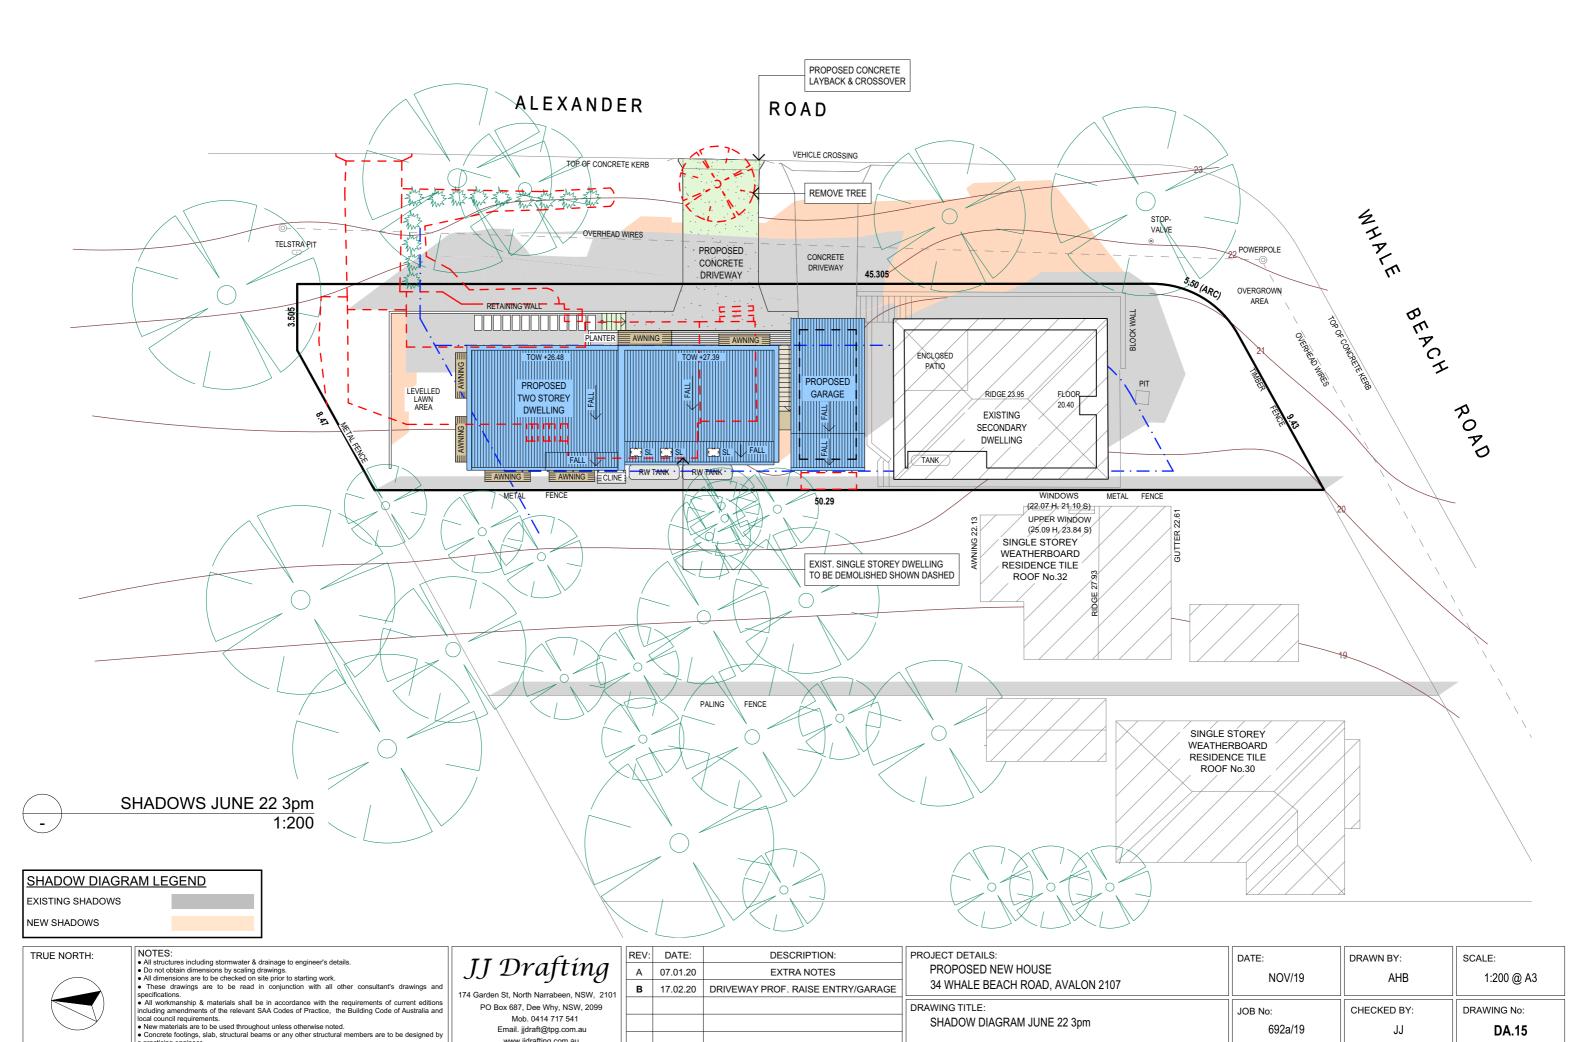

SHADOW DIAGRAM JUNE 22 3pm

692a/19

JJ

DA.15

Mob. 0414 717 541

Email. jjdraft@tpg.com.au www.jjdrafting.com.au





LOOKING SOUTH FROM ALEXANDER RD

LOOKING NORTH WEST FROM ALEXANDER RD

MATERIALS & COLOURS PALETTE



Selected, dark brick face brickwork.



Selected, dark window & door frames.



Selected dark wall cladding finish.



Timber or timber-look facade articulation feature.



Timber or timber-look batten shade awnings.

- NOTES:

 All structures including stormwater & drainage to engineer's details.

 Do not obtain dimensions by scaling drawings.

 All dimensions are to be checked on site prior to starting work.

 These drawings are to be read in conjunction with all other consultant's drawings and specifications.

 All workmanship & materials shall be in accordance with the requirements of current editions including amendments of the relevant SAA Codes of Practice, the Building Code of Australia and local council requirements.

 New materials are to be used throughout unless otherwise noted.

 Concrete footings, slab, structural beams or any other structural members are to be designed by a practicing engineer.

JJ	Draft	ting

174 Garden St, North Narrabeen, NSW, 210 PO Box 687, Dee Why, NSW, 2099 Mob. 0414 717 541 Email. jjdraft@tpg.com.au www.jjdrafting.com.au

	REV:	REV: DATE: DESCRIPTION:		F
1	Α	07.01.20	EXTRA NOTES	
101	B 17.02.20		DRIVEWAY PROF. RAISE ENTRY/GARAGE	

PROJECT DETAILS:				
PROPOSED NEW HOUSE				
34 WHALE BEACH ROAD, AVALON 2107				
DRAWING TITLE:	=			
3D PERSPECTIVES & MATERIALS PALETTE				

DATE:	DRAWN BY:	SCALE:
NOV/19	АНВ	@ A3
OB No:	CHECKED BY:	DRAWING No:
692a/19	JJ	DA.16