





STEEL ROOFING - MEDIUM / DARK



ALUMINIUM DOORS AND WINDOWS



HARDWOOD DECKING

PAGE	DRAWING	DATE	REVISION
54.4			DA IOOUE
DA 1	1:200 SITE PLAN / SITE ANALYSIS	MAY 2020	DA ISSUE
DA 2	PAGE NOT REQUIRED	MAY 2020	DA ISSUE
DA 3	1:100 GROUND FLOOR PLAN, ELEVATIONS, SECTIONS	MAY 2020	DA ISSUE
DA 4	1:200 EROSION AND SEDIMENT CONTROL PLAN	MAY 2020	DA ISSUE
DA 5	1:200 CONCEPT DRAINAGE PLAN	MAY 2020	DA ISSUE
DA 6	1:200 SITE WASTE MANAGEMENT PLAN	MAY 2020	DA ISSUE
DA 7	1:200 CONCEPT LANDSCAPE PLAN	MAY 2020	DA ISSUE

# NOTES

GENERAL:

-ALL LEVELS IN ACCORDANCE WITH AHD
- ALL WORK TO BE IN ACCORDANCE WITH DEVELOPMENT APPROVAL, CC AND ANY SUBSEQUENT AMENDMENTS.
A COPY OF APPROVALS IS TO BE KEPT ON SITE DURING CONSTRUCTION
- ALL BUILDING WORK IN ACCORDANCE WITH BCA 2015, COUNCIL CODES AND ALL RELEVANT AUSTRALIAN
STANDARDS - INCLUDING, BUT NOT LIMITED TO:
- AS 1288 - GLASS INSTALLATIONS
- AS 1288 - LIGHT TIMBER FRAMING CODE
- AS 1289 - LIGHT TIMBER FRAMING CODE
- AS 1742 - MANUAL OF UNIFORM TRAFFIC CONTROL DEVICES
- AS 2070 - 1999 - FRESIDENTIAL SLABS AND FOOTINGS
- AS 2070 - 1999 - FRESIDENTIAL SLABS AND FOOTINGS
- ASINZS 3000 - 2007 - FUNDING RULES
- ASINZS 3000 - 52007 - PUMBING AND DRAINAGE
- AS 3700 - 5000 - PUMBING AND DRAINAGE
- AS 3700 - 2007 - PUMBING AND DRAINAGE
- AS 3700 - 2007 - MIRING STRUCTURES
- AS 3700 - 2007 - MASONRY STRUCTURES
- AS 3700 - MASONRY STRUCTURES
- AS 3736 - SMOKE ALARMS
- AS 3736 - SMOKE ALARMS
- AS 4700 - 1996 - STEEL STRUCTURES
- AS 4282:1997 - CONTROL OF THE OBTRUSIVE EFFECTS OF OUTDOOR LIGHTING
- AS 4870-2009 - PROTECTION OF TREES ON DEVELOPMENT SITES'

THERMAL COMFORT OPTIONS:

BASIX SPECIFICATIONS
WATER:
- MIN 2000L Rainwater Tank

Insulation blanket (55mm + foil) to underside of metal roof.
 R4 insulation to all flat ceilings with roof above

- Roof Collection area : 50m2
- Rainwater re-used in Garden Tap (x1) and Toilets
- Showers : 3\*, Taps : 4\*, Toilets 4\*
- Min 50m2 Low Water Use Species

- R2 insulation to all framed external walls.
- R1.3 insulation to all suspended floors above open sub floor
- 'Medium' coloured roof (Solar absorptance 0.45-0.70)
- Glazing spec (NFRC: U= 5.6 SHGC=0.66) eg Aluminium framed single-glazed clear glass to all glazing

ENERGY:
- Ceiling Fans to >1 Living Room and >1 Bedroom
- Instant Gas HW Heater 4\*
- Gas Cooktop / Gas Oven


- Gas Cooktop / Gas Oven
- Bath//kitchen Exhaust Fans : Interlocked to light Laundry: Manual On/Off Switching
- Well Ventilated Fridge Space
- Indoor and Outdoor Clothes Lines
- Window or skylight in minimum 1 bathrooms
- Window or skylight in kitchen
- Dedicated LED or Fluorescent lighting to bedroom, living.





# DA ISSUE NOT FOR CONSTRUCTION

PROJECT NAME:	DRAWING NAME:	LEGENDS AND MATERIALS	SURVEYOR:	TOWN PLANNER:		CAD FILE: 191015 5 THE CRESCENTVWX		PHASE: DA		
GAINFORTH GRANNY FLAT ADDRESS:	COVER PAGE		H&S LAND SURVEYORS PTY LTD	VAUGHAN MILLIGAN DEVELOPMENT CONSULTING				DRAWING NO: DA - C	ISSUE:	SITE INFORMATION; - LOT 16 SEC 4 in D.P. 6462
5 THE CRESCENT, NTH NARRABEEN, NSW 2101			FLOOD PLANNER:	PIYLID		SCALE: NTS	N	USE FIGURED DIMENSIONS IN PREFERENCE TO	SCALE.	- SITE AREA: 663.9m2
CLIENT: WARWICK GAINFORTH			HYTEN ENGINEERING PTY LTD		DESCRIPTION:	PROJECT NUMBER: 191015	)	ALL DIMENSIONS TO BE VERIFIED ON SITE PRICE FABRICATION, SETOUT OR CONSTRUCTION. REFER AND DISCREPANCIES TO THE PROJECT A		- LOCAL GOVERNMENT : NORTHERN BEACHES (PITTWATER)

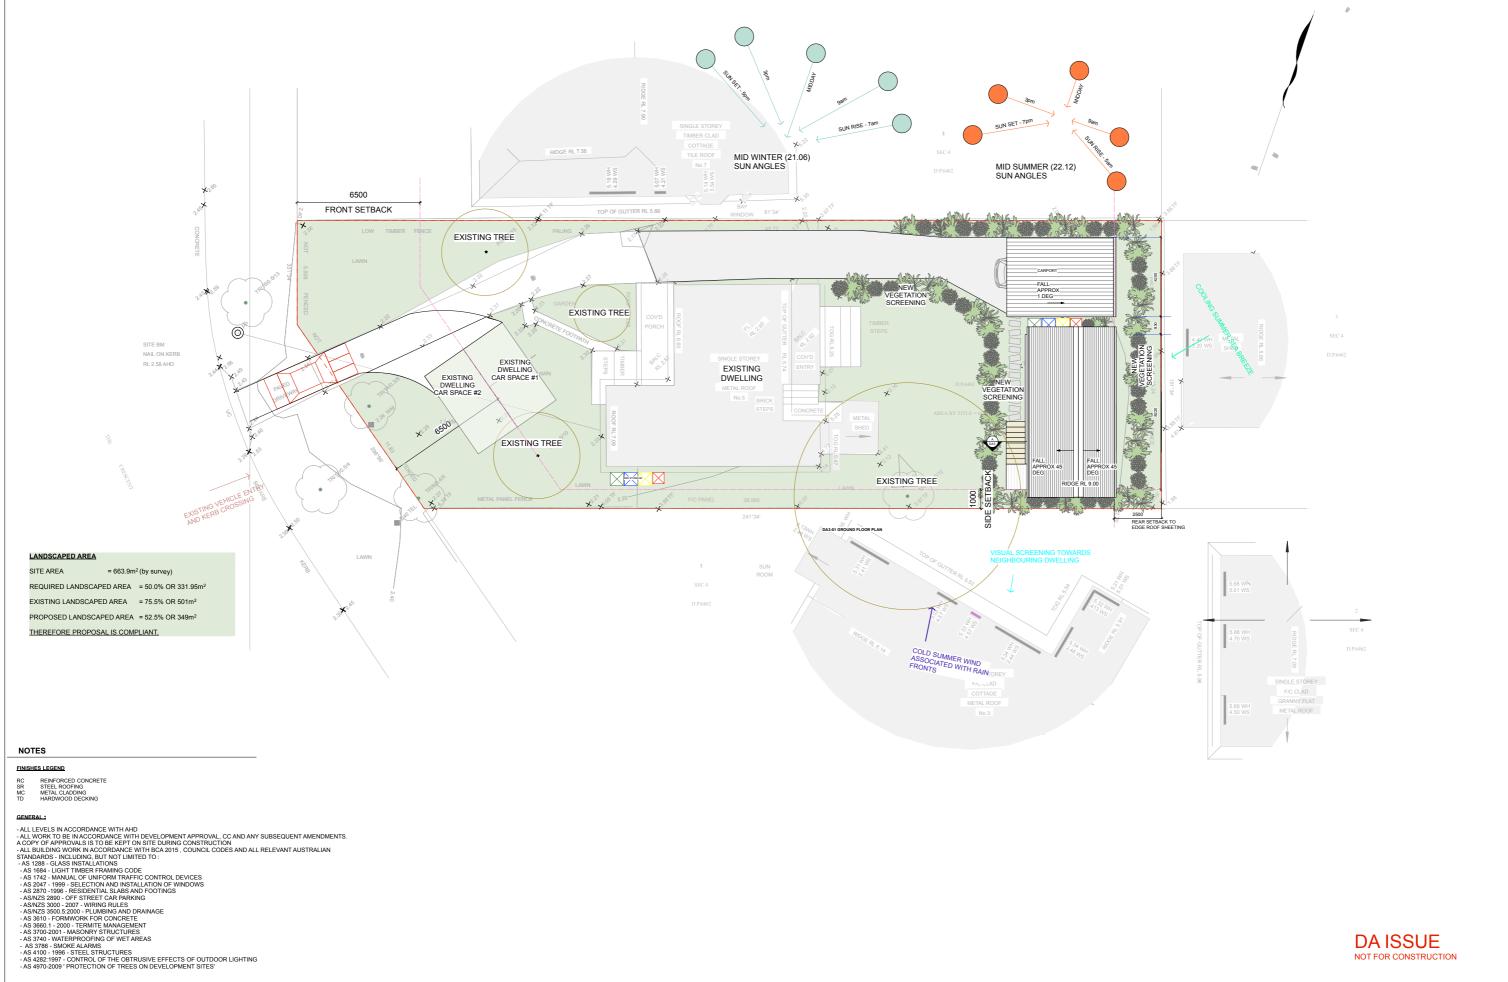


PROJECT NAME:
GAINFORTH GRANNY FLAT 5 THE CRESCENT, NTH NARRABEEN, NSW 2101


CLIENT: WARWICK GAINFORTH

	LEGENDS AND MATERIALS	SURVEYOR:	TOWN PLANNER:					CAD FILE: 191015 5 THE CRESCENTVWX		PHASE: DA	
SITE ANALYSIS		PTY LTD	VAUGHAN MILLIGAN DEVELOPMENT CONSULTING					0 1 2 3 4 5		DRAWING NO: DA - 01	ISSUE:
			PTY LTD					SCALE: 1:200 @ A3	M		
		FLOOD PLANNER:	NNER:					00AEE. 1.200 @ A0	~ / **\	USE FIGURED DIMENSIONS IN PREFERENCE TO SCA ALL DIMENSIONS TO BE VERIFIED ON SITE PRIOR TO	
		HYTEN ENGINEERING PTY LTD						PROJECT NUMBER: 191015		FABRICATION, SETOUT OR CONSTRUCTION.	'
				ISSUE:	DATE:	DESCRIPTION:	BY: CH	G: DATE: MAY 2020		REFER AND DISCREPANCIES TO THE PROJECT ARCHIF IN DOUBT ASK.	HITECT.

**DA ISSUE** NOT FOR CONSTRUCTION

SITE INFORMATION; - LOT 16 SEC 4 in D.P. 6462 - SITE AREA: 663.9m2 - LOCAL GOVERNMENT : NORTHERN BEACHES (PITTWATER)

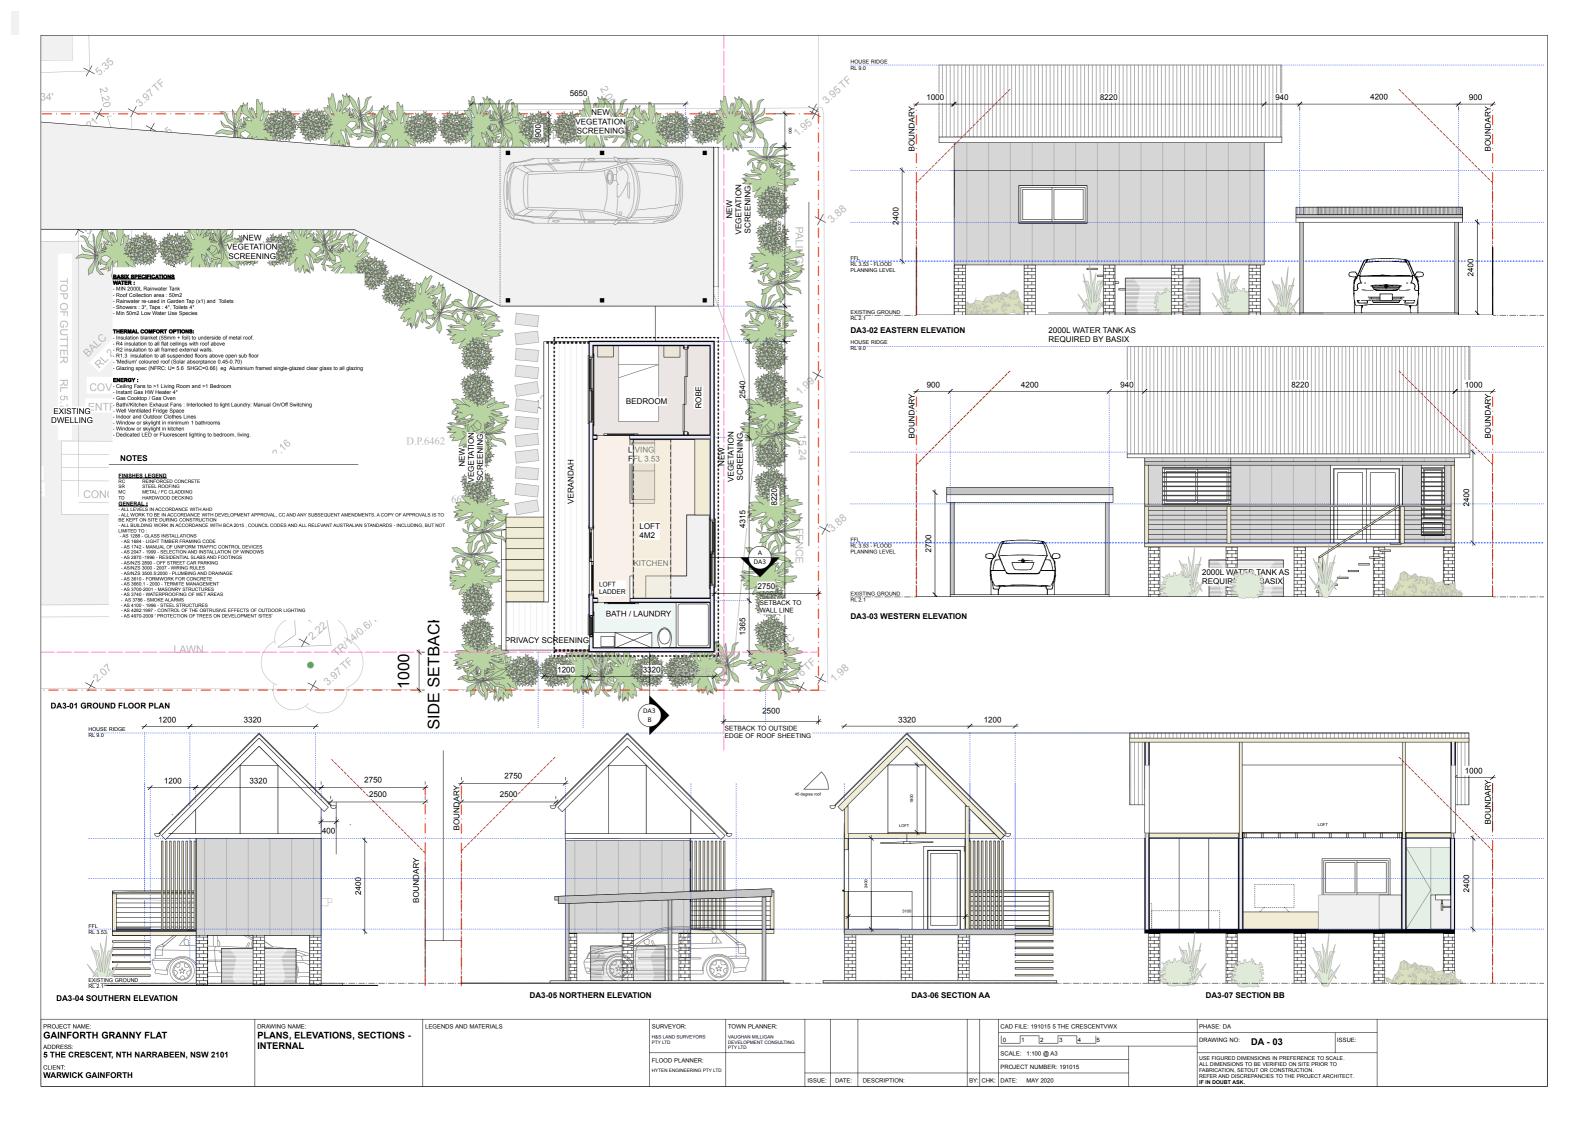

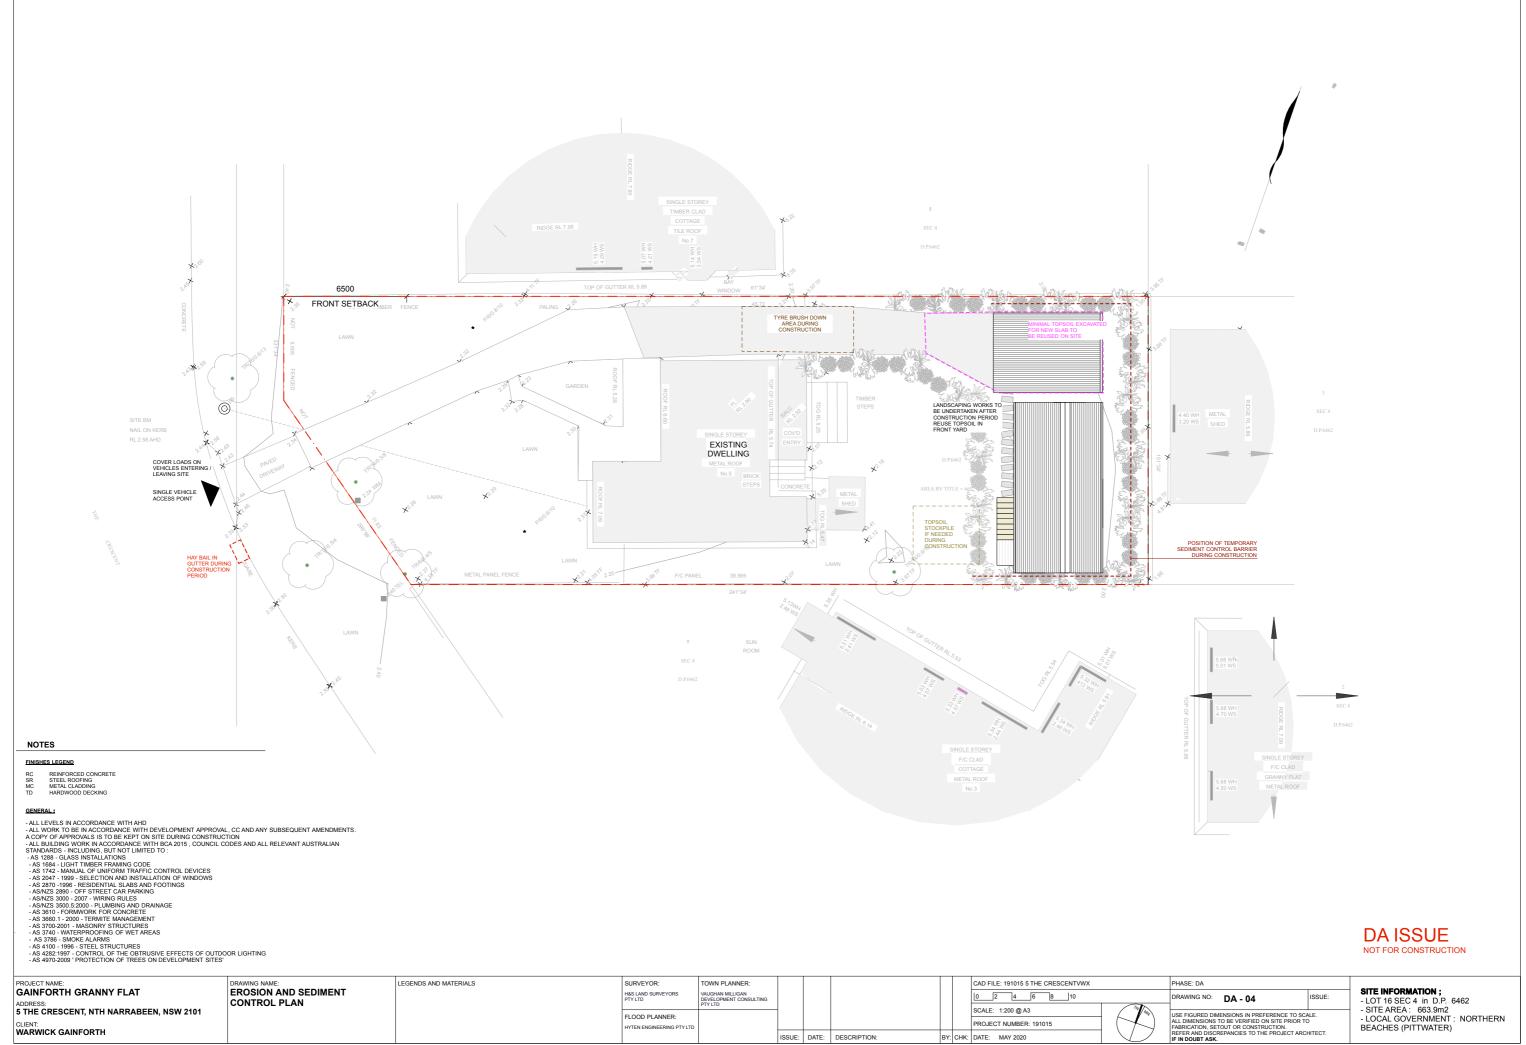

ISSUE: DATE: DESCRIPTION:


PROJECT NUMBER: 191015


BY: CHK: DATE: MAY 2020


FLOOD PLANNER:

CLIENT: WARWICK GAINFORTH

SITE INFORMATION; - LOT 16 SEC 4 in D.P. 6462 - SITE AREA: 663.9m2 - LOCAL GOVERNMENT: NORTHERN BEACHES (PITTWATER)

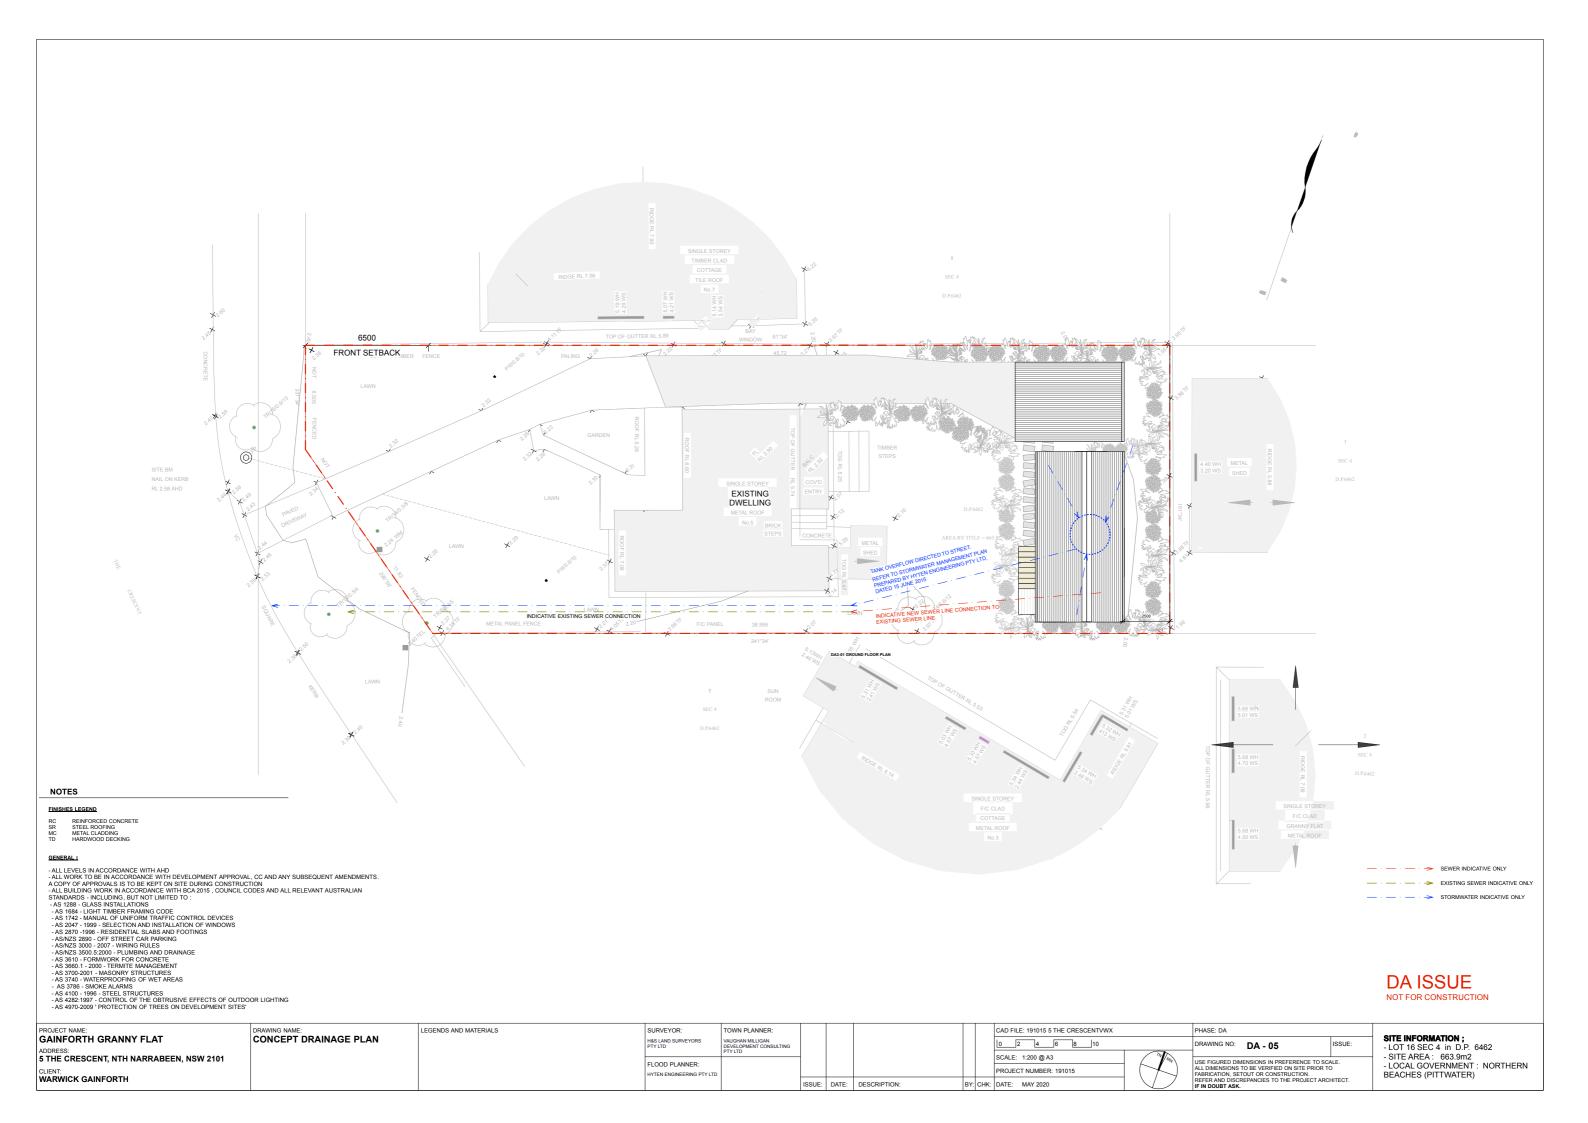

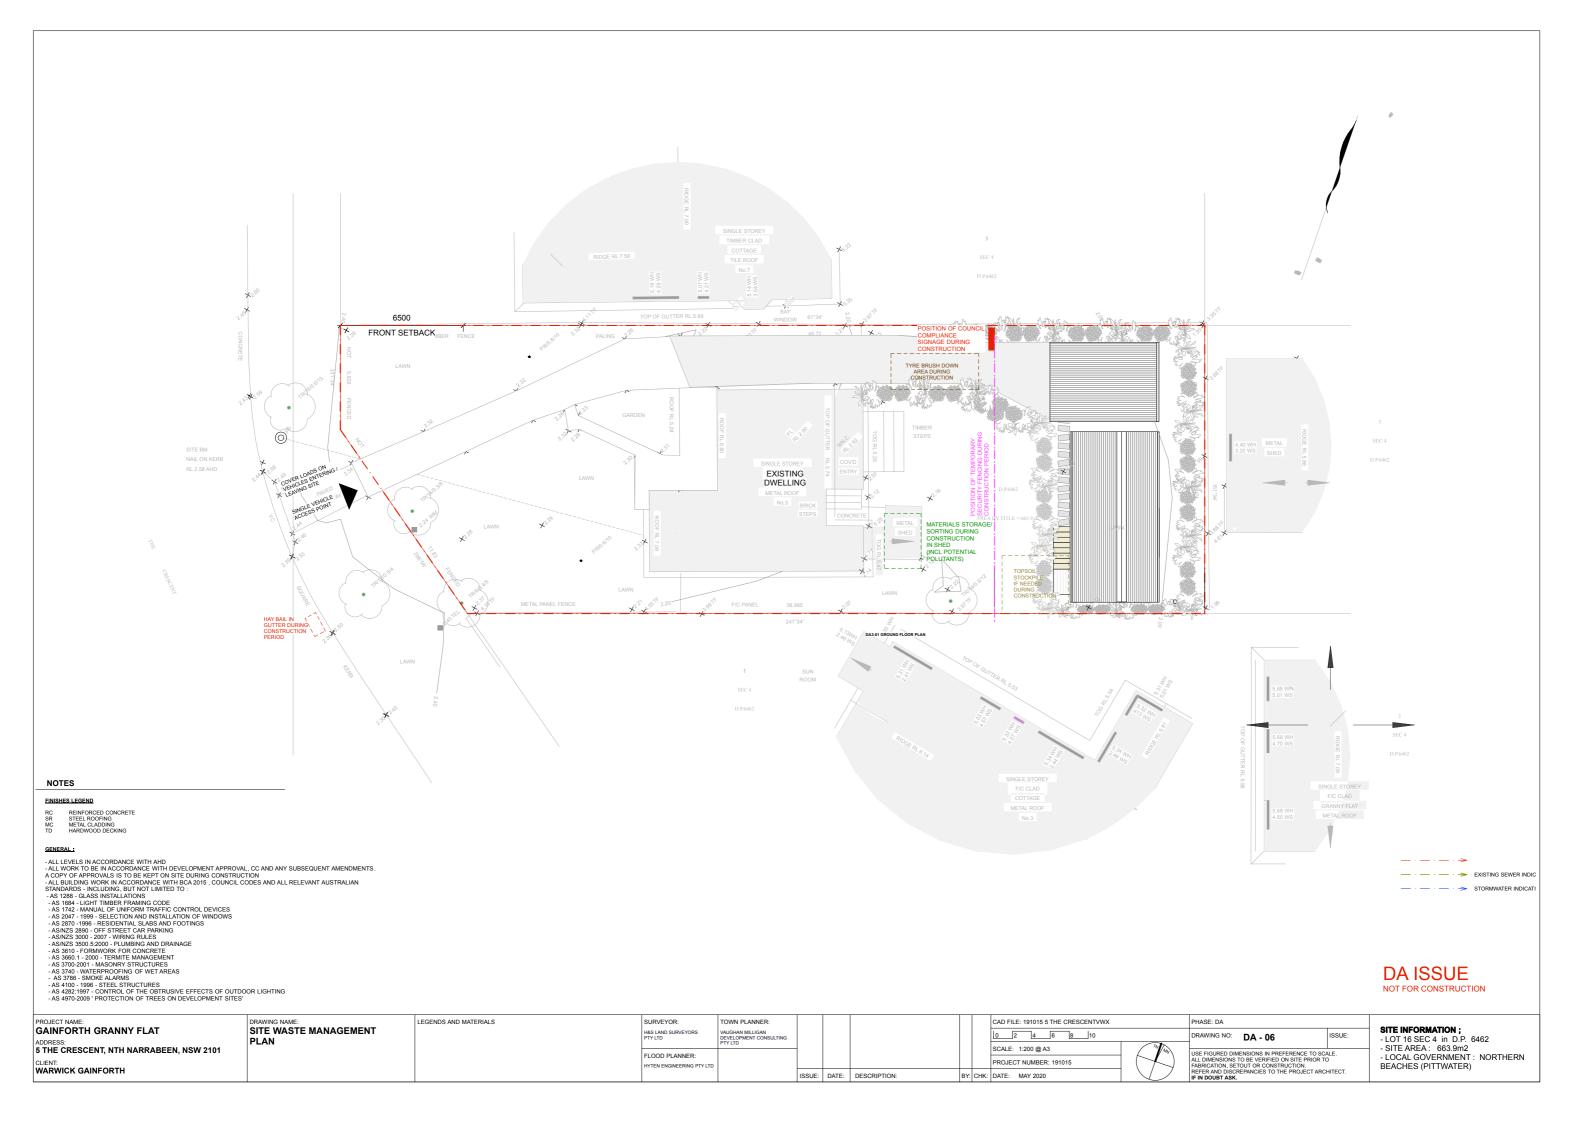

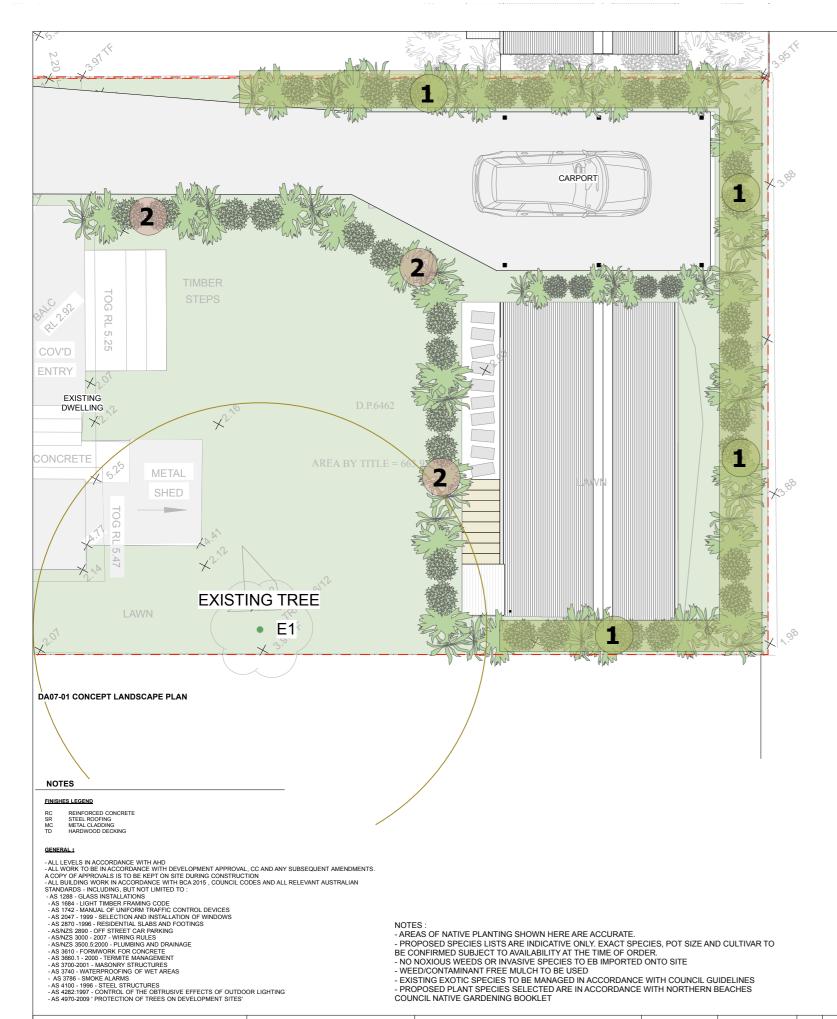

# **LEGEND**


	LAWN : S/L BUFFALO OR MICRO LAENA STIPODES & DICHONDRA REPENS (SEED)
$\odot$	EXISTING TREE / SHRUB - AS LABELLED. <b>E1,E2,E3</b> etc
•	TREE / SHRUB TO BE REMOVED

## 2 BOUNDARY SCREENING

COMMON NAME NAME POT SIZE SIZE Lomandra longfolia Tanika .65m 5L

## 2 SCREENING BED

COMMON NAME	NAME	SIZE	POT SIZ
Christmas Bush	Ceratopetalum gummiferum	2.5m	5L
Lantern Banksia	Banksia ericifolia	1.5m	5L
Coastal Rosemary	Westringia fruticosa	4m	5L
Correa Alba	Correa alba	1m	5L
Wedding Bush	Ricinocarpus pinifolius	1m	5L

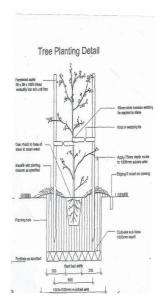

# **Existing Tree schedule**

TREE SIZE NAME COMMON NAME Existing 12m DIA Unknown Unknown

PROJECT NAME:	DRAWING NAME:	LEGENDS AND MATERIALS	SURVEYOR:	TOWN PLANNER:					CAD FILE: 191015 5 THE CRESCENTVWX		PHASE: DA		
GAINFORTH GRANNY FLAT	CONCEPT LANDSCAPE PLAN		H&S LAND SURVEYORS PTY LTD	VAUGHAN MILLIGAN DEVELOPMENT CONSULTING					0 2 4 6 8 10		DRAWING NO: DA - 07	SSUE:	
ADDRESS: 5 THE CRESCENT, NTH NARRABEEN, NSW 2101			FLOOD PLANNER:	PIYEID	-				SCALE: 1:200 @ A3	TN	USE FIGURED DIMENSIONS IN PREFERENCE TO SCALE	E.	-
CLIENT:			HYTEN ENGINEERING PTY LTD	,					PROJECT NUMBER: 191015		ALL DIMENSIONS TO BE VERIFIED ON SITE PRIOR TO FABRICATION, SETOUT OR CONSTRUCTION.		ī
WARWICK GAINFORTH					ISSUE: DAT	ATE:	DESCRIPTION:	BY: CH	K: DATE: MAY 2020		REFER AND DISCREPANCIES TO THE PROJECT ARCHITE IF IN DOUBT ASK.	TECT.	

NOTES:

- AREAS OF NATIVE PLANTING SHOWN HERE ARE ACCURATE.

- PROPOSED SPECIES LISTS ARE INDICATIVE ONLY. EXACT SPECIES, POT SIZE AND CULTIVAR TO BE CONFIRMED SUBJECT TO AVAILABILITY AT THE TIME OF ORDER.

- NO NOXIOUS WEEDS OR INVASIVE SPECIES TO EB IMPORTED ONTO SITE

- WEED/CONTAMINANT FREE MULCH TO BE USED

- EXISTING EXOTIC SPECIES TO BE MANAGED IN ACCORDANCE WITH COUNCIL GUIDELINES - PROPOSED PLANT SPECIES SELECTED ARE IN ACCORDANCE WITH NORTHERN BEACHES

COUNCIL NATIVE GARDENING BOOKLET

DA ISSUE NOT FOR CONSTRUCTION

SITE INFORMATION; - LOT 16 SEC 4 in D.P. 6462 - SITE AREA: 663.9m2

- LOCAL GOVERNMENT : NORTHERN BEACHES (PITTWATER)

