# 141 POWDERWORKS ROAD, ELANORA HEIGHTS 2101

# NEW ATTACHED TWO STOREY DUAL OCCUPANCY & ADDITIONS TO EXISTING BRICK DWELLING

DEVELOPMENT APPLICATION

APPLICANTS: MATT & NAOMI NOFFS LOT/DP: LOT101/DP842992

LGA: NORTHERN BEACHES COUNCIL
ZONE: R2 - LOW DENSITY RESIDENTIAL
FLOOD: IS NOT A FLOOD CONTROL LOT
BUSHFIRE: IS NOT A BUSHFIRE PRONE LOT

HERITAGE: NOT IN A HERITAGE CONSERVATION AREA

NOT A LOCAL HERITAGE ITEM OR DRAFT HERITAGE ITEM

# **DEVELOPMENT APPLICATION - DRAWING LIST**

ID	DRAWING
DA-00	COVER SHEET
DA-01	NOTES AND STANDARDS
DA-02	SITE STAGING AND SEDIMENTATION PLAN
DA-10	SITE PLAN AND SITE ANALYSIS
DA-11	FLOOR PLAN - DUAL OCCUPANCY GROUND FLOOR
DA-12	FLOOR PLAN - DUAL OCCUPANCY FIRST FLOOR
DA-13	FLOOR PLAN - PROPOSED ADDITIONS TO EXISTING BRICK DWELLING
DA-14	ROOF PLAN
DA-15	STORMWATER CONCEPT PLAN
DA-16	LANDSCAPING CONCEPT PLAN
DA-17	DEMOLITION PLAN
DA-20	ELEVATIONS
DA-21	ELEVATIONS
DA-22	SECTIONS
DA-23	SHADOW DIAGRAMS
DA-30	WINDOW SCHEDULE
DA-31	DOOR SCHEDULE
DA-32	FINISHES AND COLOURS
DA-33	BASIX DA REQUIREMENTS
	SURVEY - PREPARED BY GEOGRAPHIC SOLUTIONS SURVEYORS


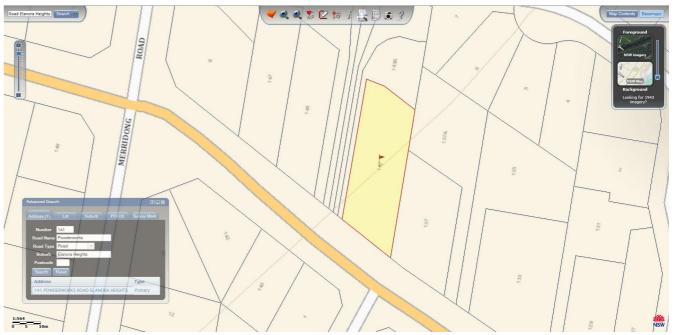


IMAGE COURTESY OF SIX MAPS



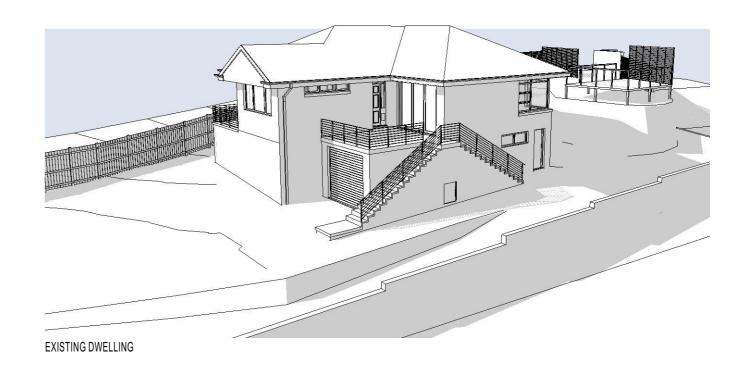

REV.	DESCRIPTION	DATE
A1	FOR APPROVALS ONLY, NOT FOR CONSTRUCTION.	25/03/201
A2	FOR APPROVALS ONLY, NOT FOR CONSTRUCTION.	11/04/201
A3	FOR APPROVALS ONLY, NOT FOR CONSTRUCTION.	02/06/2019
A4	FOR APPROVALS ONLY, NOT FOR CONSTRUCTION.	11/06/2019
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CLIENT: MATT & NAOMI NOFFS
PROJECT: NEW ATTACHED TWO STOREY DUAL OCCUPANCY

& ADDITIONS TO AN EXISTING BRICK DWELLING
SITE: 141 POWDERWORKS ROAD ELANORA HEIGHTS
NSW 2102

DRAWING: COVER SHEET

DRAWN: ALM
DRAWING ID: DA-00
REV. STATUS: APPROVALS
CREATED: 22nd JUNE 2018

SCALE: AS SHOWN @ A3

CREATED: 22NO JUNI DO NOT SCALE FROM DRAWINGS.

### **NOTES**

- 1. CONFIRM ALL DIMENSIONS ON SITE BEFORE ORDERING MATERIALS AND STARTING CONSTRUCTION.
- 2. ALL WORK IS TO BE CARRIED OUT IN ACCORDANCE WITH ALL RELEVANT AUSTRALIAN STANDARDS, THE BUILDING CODE OF AUSTRALIA, NSW WORKCOVER AND ALL RELEVANT APPROVALS/REQUIREMENTS.
- 3. ALL WORKS TO BE IN ACCORDANCE WITH BASIX CERTIFICATE A323325\_04 AND BASIX CERTIFCATE 1003317M AND ALL ASSOCIATED DOCUMENTATION.
- 4. DEMOLISH EXISTING STRUCTURES AS SHOWN. WHERE REQUIRED, ALL DEMOLITION SHALL BE CARRIED OUT IN ACCORDANCE WITH AS 2601 AND NSW WORKCOVER REGULATIONS.
- 5. IF REQUIRED, ANY ASBESTOS REMOVAL SHALL BE UNDER TAKEN BY APPROPRIATELY QUALIFIED AND LICENSED CONTRACTORS AND ALL MATERIALS TREATED AND DISPOSED OF IN ACCORDANCE WITH NSW WORKCOVER REQUIREMENTS.
- 6. PROVIDE TERMITE TREATMENT TO WHOLE OF NEW CONSTRUCTION AREA IN ACCORDANCE WITH PART 3.1 OF VOLUME TWO OF THE BUILDING CODE OF AUSTRALIA AND AS 3660.
- 7. WHERE REQUIRED, PROVIDE WATER SERVICES, STORMWATER DRAINAGE, HOT WATER SERVICES AND SANITARY SERVICES, METERS, VENTS, WASTES, Etc. AS REQUIRED IN ACCORDANCE WITH AS 3500 AND AS 1547 AND THE BUILDING CODE OF AUSTRALIA. ALL NEW WATER PIPES ARE TO BE ACCOUSTICALLY INSULATED.
- 8. WHERE REQUIRED, PROVIDE ALL ELECTRICAL SERVICES, METERS, LIGHTING, EMERGENCY LIGHTING, SWITCHBOARDS, METERS, Etc. IN ACCORDANCE WITH AS 3000 AND AS 1680.
- 9. WHERE REQUIRED, ALL WET AREAS ARE TO BE WATER PROOFED, AND THE INSTALLATION CERTIFIED, IN ACCORDANCE WITH THE BUILDING CODE OF AUSTRALIA AND AS 4200.
- 10. WHERE REQUIRED, PROVIDE ALL TIMBER FRAMING, TRUSSES, BEAMS, POSTS, Etc. AS REQUIRED, ALL IN ACCORDANCE WITH THE BUILDING CODE OF AUSTRALIA AND AS 1684 TIMBER FRAMING CODE.
- 11. WHERE REQUIRED, PROVIDE ALL STEEL FRAMING, TRUSSES, BEAMS, COLUMNS, Etc. AS REQUIRED IN ACCORDANCE WITH THE BUILDING CODE OF AUSTRALIA AND AS 4100.
- 12. WHERE REQUIRED, PROVIDE ALL ROOFING AND ASSOCIATED GUTTERS, DOWNPIPES, FLASHINGS, INSULATION, Etc. IN ACCORDANCE WITH AS 2050, AS 2728, AS 4389, AND AS 3500 AND THE THE BUILDING CODE OF AUSTRALIA,.
- 13. WHERE REQUIRED, PROVIDE SMOKE ALARMS IN ACCORDANCE WITH THE BUILDING CODE OF AUSTRALIA AND AS 3786 AND AS 2293.
- 14. WHERE REQUIRED, PROVIDE ALL DOORS AND DOOR HARDWARE AS REQUIRED IN ACCORDANCE WITH AS 2688, AS 1909, AS 3959.
- 15. WHERE REQUIRED, PROVIDE ALL WINDOWS, FRAMES, GLAZING, Etc. IN ACCORDANCE WITH AS 1288, AS 3715, AS 4667, AS 3959 AND THE REQUIREMENTS OF THE BASIX REPORT/S.
- 16. WHERE REQUIRED, ALL PREPARATION FOR PAINTING AND PAINTING SHALL BE CARRIED OUT IN ACCORDANCE WITH AS 1627, AS 2311, AS 2312.
- 17. WHERE REQUIRED, PROVIDE ALL WALL AND FLOOR TILING IN ACCORDANCE WITH AS 1884 & AS 2358

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## **SPECIFICATION**

ALL WORKS ARE TO BE CARRIED OUT IN ACCORDANCE WITH BCA REQUIREMENTS & ALL RELEVANT AUSTRALIAN STANDARDS INCLUDING BUT NOT LIMITED TO THE FOLLOWING:

TRADE	<u>STANDARD</u>	<u>TRADE</u>	<u>STANDARD</u>
SURVEYS:		DOORS & DOOR HARDWARE:	
TECHNICAL DRAWING	AS 1100.40-1984	FLUSH DOORS AND JOINERY DOORS	AS 2688 & AS 3959
		INSTALLATION	AS 1909
SAFETY:			
WORK HEALTH & SAFETY REGULATIONS 2011 & SAFE WORK AUSTF		WINDOWS & GLAZING:	
SAFETY AT WORK - PRINCIPLES AND PRACTICES	AS 1470	MATERIALS, SELECTION AND INSTALLATION	AS 2047, AS 3959 &
			AS 1288
DEMOLITION:	40.0004	CUT-TO-SIZE QUALITY	AS/NZS 4667
THE DEMOLITION OF STRUCTURES	AS 2601	LAMINATED AND TOUGHENED GLASS PROCESS	AS/NZS 4667
FARTINARIO O EVOAVATIONI.		METAL FINISHING - THERMOSET POWDER COATING FOR ARCHITEC	
EARTHWORKS & EXCAVATION: GEOTECHNICAL SITE INVESTIGATIONS	AS 1726	OF ALUMINUM AND ALUMINUM ALLOY SAFETY GLAZING MATERIALS IDENTIFY EACH PIECE OR PANEL	AS 3715-2002 AS 1288.
EARTHWORKS	AS 1726 AS 1726	SAFETT GLAZING WATERIALS IDENTIFT EACH FIECE OR PAINEL	AS 1200.
COMPACTION TESTING	AS 1720 AS 1289.5.41 &	PAINTING:	
COMPACTION LESTING	AS 1289.5.4.2	GUIDE TO THE PAINTING OF BUILDINGS	AS/NZS 2311
	AO 1203.3.4.2	GUIDE TO THE PROTECTION OF STRUCTURAL STEEL AGAINST ATM	
STORM WATER & HYDRAULICS:		BY THE USE OF PROTECTIVE COATINGS	AS/NZS 2312
WASTEWATER	AS 1547	METAL FINISHING - PREPARATION AND PRE-TREATMENT OF SURFA	
STORMWATER	AS NZS 3500.3	CLEANING OF STEEL	AS 1627.4-2005
PLUMBING & DRAINAGE - WATER SERVICES	AS/NZS 3500.1		7.0 .02 2000
PLUMBING & DRAINAGE - SANITARY PLUMBING & DRAINAGE	AS/NZS 3500.2.	TILING:	
PLUMBING & DRAINAGE - HEATED WATER SERVICES	AS/NZS 3500.4	AN INTRODUCTORY GUIDE TO THE SLIP RESISTANCE OF PEDESTRI	AN
COPPER PIPES & FITTINGS - INSTALLATION & COMMISSIONING	AS 4809	SURFACE MATERIALS	HB197:1999
		FLOOR COVERINGS - RESILIENT SHEET AND TILES - INSTALLATION	PRACTICES
ELECTRICAL:			AS 1884
DEGREES OF ELECTRICAL PROTECTION	AS 1939	ADHESIVES - FOR FIXING CERAMIC TILES	AS 2358-1990
ELECTRICAL INSTALLATIONS	AS/NZS 3000		
ELECTRICAL WORK	AS/NZS 3000	LANDSCAPING:	
INTERIOR LIGHTING	AS/NZS 1680.	SOILS FOR LANDSCAPING & GARDEN USE	AS 4419
TERMITE MANAGEMENT:		PARKING:	
TERMITE MANAGEMENT	AS 3660	PARKING FACILITIES PART 1 OFF-STREET CAR PARKING	AS/NZS 2890.1:2004
TEININ E MANOEMENT	710 0000	TARACTA OLITICS TARACT STREET SARCTARACTOR	710/1120 2000.1.2001
TIMBER FRAMING:			
TIMBER FRAMING CODE	AS1684		
CONCRETE & MASONRY:	10.0010		
FORMWORK DESIGN & CONSTRUCTION	AS 3610	•	
STEEL REINFORCING MATERIALS	AS 1302, AS 1303	č.	
CONCRETE	AS 1304		
CONCRETE MATERIALS & CONSTRUCTION	AS 1379		
CONCRETE STRUCTURES FOR RETAINING LIQUIDS	AS 3600 AS 3735		
MATERIALS & CONSTRUCTION	AS 3700		
WINTERWILL & CONCINCOTION	710 0700		
STRUCTURAL STEEL:			
MATERIALS, CONSTRUCTION, FABRICATION & ERECTION	AS 4100		
WATERPROOFING:			
PLIABLE BUILDING MEMBRANES & UNDERLAYS -	A C/NIZO 4000 4		
MATERIALS/INSTALLATION	AS/NZS 4200.1,		
ROOFING:	AS/NZS 4200.2		
NOUL ING.	A O 4 F O O 4		



PRE-PAINTED AND ORGANIC FILM/METAL LAMINATE PRODUCTS

**DESIGN AND INSTALLATION** 

**ROOF PLUMBING** 

CLIENT: MATT & NAOMI NOFFS

AS 1562.1

AS 2728

AS/NZS 3500.3.2


PROJECT: NEW ATTACHED TWO STOREY DUAL OCCUPANCY

& ADDITIONS TO AN EXISTING BRICK DWELLING 141 POWDERWORKS ROAD ELANORA HEIGHTS DRAWING: NOTES AND STANDARDS

DRAWN: ALM
DRAWING ID: DA-01
REV. STATUS: APPROVALS
CREATED: 22nd JUNE 2018

NSW 2102 SCALE: AS SHOWN @ A3

CREATED: 22nd JUI
SHOWN @ A3 DO NOT SCALE FROM DRAWINGS

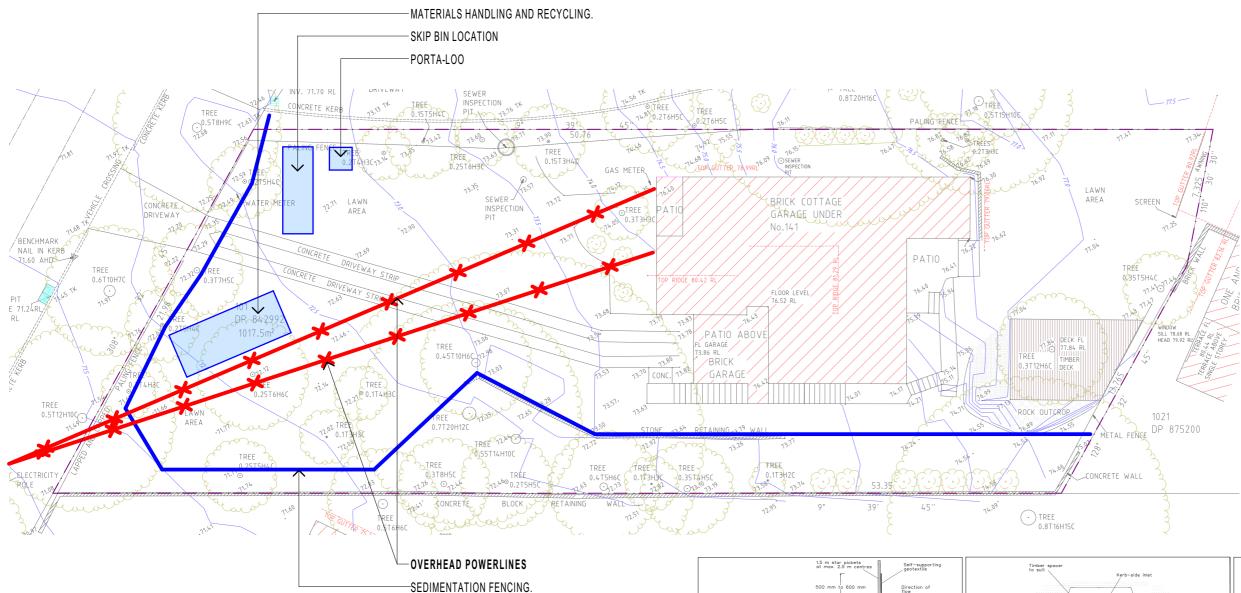

## **NOTES**


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1. ENSURE ALL WORKS ARE CARRIED OUT BY SUITABLY QUALIFIED INDIVIDUALS IN ACCORDANCE WITH ALL RELEVANT SAFEWORK AUSTRALIA LAWS AND REGULATIONS.


SITE STAGING

1:200

- 2. IF REQUIRED, ANY ASBESTOS REMOVAL SHALL BE UNDER TAKEN BY APPROPRIATELY QUALIFIED AND LICENSED CONTRACTORS AND ALL MATERIALS TREATED AND DISPOSED OF IN ACCORDANCE WITH NSW WORKCOVER REQUIREMENTS.
- 3. EXACT LOCATION OF AREAS TO BE DETERMINED ONSITE TO MEET REQUIREMENTS DURING DEMOLITION AND CONSTRUCTION.
- 4. ALL AREAS TO BE LOCATED ONSITE WITH IN SITE BOUNDARIES.

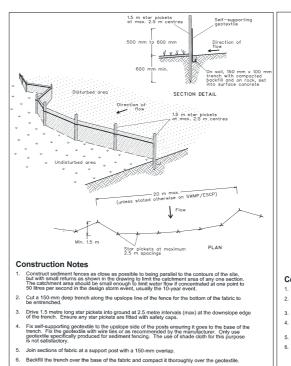

SOURCE: Managing Urban Stormwater: Soils and Construction - © New South Wales Government, 2004

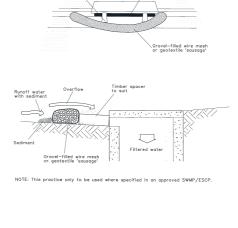



- . Form an elliptical cross-section about 150 mm high x 400 mm wide
- Place the filter at the opening leaving at least a 100-mm space between it and the kerb inlet.
   Maintain the opening with spacer blocks.
- Form a seal with the kerb to prevent sediment bypassing the filter
- Sandbags filled with gravel can substitute for the mesh or geote that they firmly abut each other and sediment-laden waters can

SD 6-8 MESH AND GRAVEL INLET FILTER

Star picket fitted with safety cap T 🖙 🖸 🗆 🗆 D0000 §. Do not cover the inlet with geotextile unless the design is adequate to allow for all waters to bypass it.

DIAL BEFORE YOU DIG
www.1100.com.au

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JENT:	MATT & NAOMI NOFFS
ROJECT:	NEW ATTACHED TWO STOREY DUAL OCCUPANCY
	& ADDITIONS TO AN EXISTING BRICK DWELLING
TF:	141 POWDERWORKS ROAD FLANORA HEIGHTS


DRAWING: SITE STAGING PLAN AND SEDIMENTATION CONTROL


GEOTEXTILE INLET FILTER


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SD 6-12

SCALE: AS SHOWN @ A3 NSW 2102



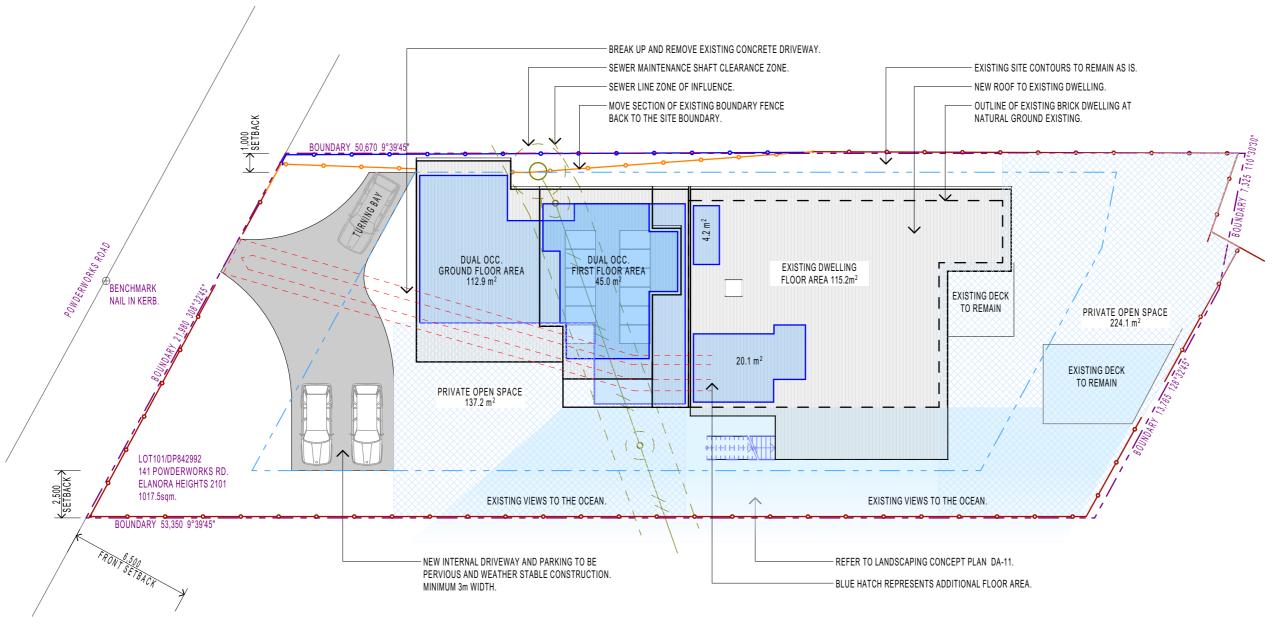

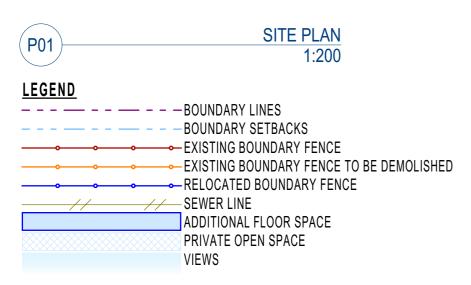
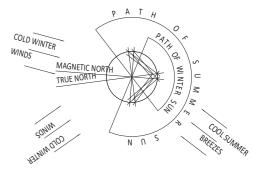
## SITE ANALYSIS

 SITE AREA
 1017.5sqm

 FSR
 0.3:1

 MAX. GFA
 305.25sqm

 EXIST. GFA
 115.2sqm

 PROP. GFA
 297.4sqm

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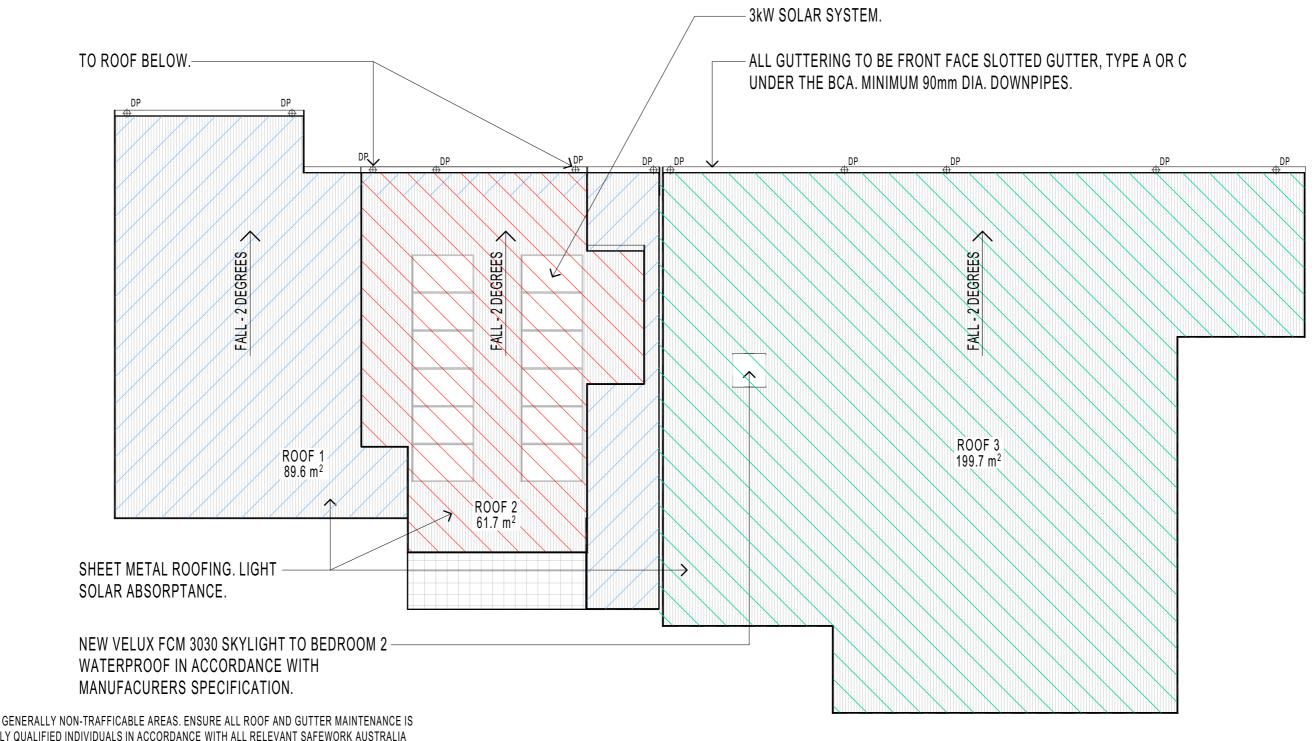
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& ADDITIONS TO AN EXISTING BRICK DWELLING
SITE: 141 POWDERWORKS ROAD ELANORA HEIGHTS
NSW 2102

DRAWING:	SITE PLAN	AND SITE	ANALYSIS

SCALE: AS SHOWN @ A3

DRAWN:	ALM
DRAWING ID:	DA-10
REV. STATUS:	APPROVALS
CREATED:	22nd JUNE 2018
DO NOT SCALE FRO	OM DRAWINGS



NOTES

1. ALL ROOF AREAS ARE GENERALLY NON-TRAFFICABLE AREAS. ENSURE ALL ROOF AND GUTTER MAINTENANCE IS CARRIED OUT BY SUITABLY QUALIFIED INDIVIDUALS IN ACCORDANCE WITH ALL RELEVANT SAFEWORK AUSTRALIA LAWS AND REGULATIONS.

P06 ROOF PLAN 1:100

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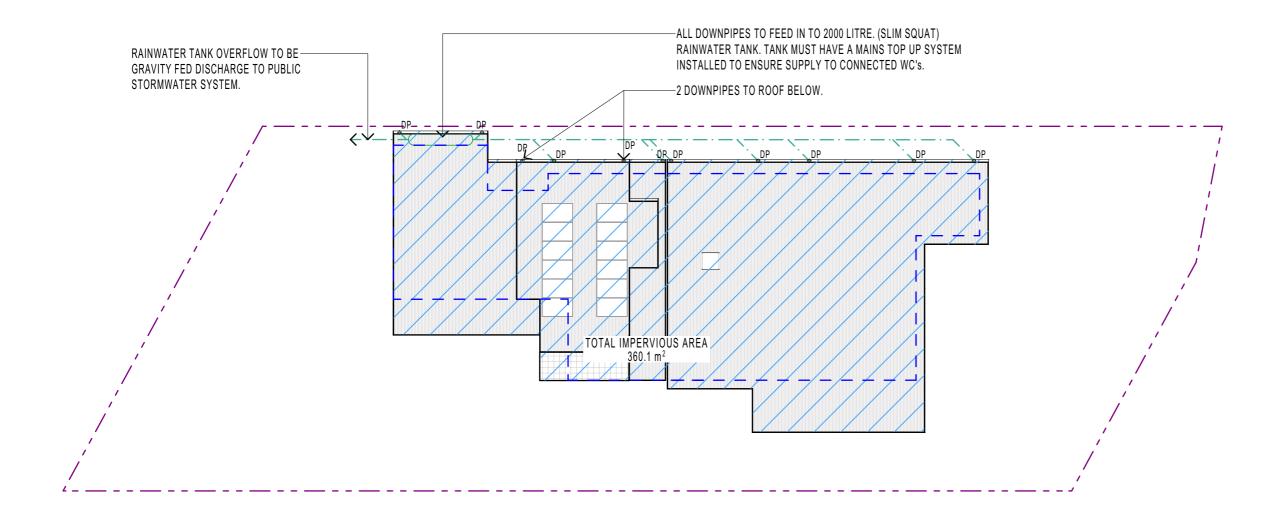
CLIENT: MATT & NAOMI NOFFS
PROJECT: NEW ATTACHED TWO STOREY DUAL OCCUPANCY
& ADDITIONS TO AN EXISTING BRICK DWELLING

DRAWING: ROOF PLAN

DRAWN: ALM
DRAWING ID: DA-14
REV. STATUS: APPROVALS
CREATED: 22nd JUNE 2018
DO NOT SCALE FROM DRAWINGS.

TE: 141 POWDERWORKS ROAD ELANORA HEIGHTS
NSW 2102 SC

SCALE: AS SHOWN @ A3





#### <u>NOTE</u>

- 1. HYDRAULIC LAYOUT TO BE IN ACCORDANCE WITH THE BUILDING CODE OF AUSTRALIA, RELEVANT AUSTRALIAN STANDARDS, STATE AND LOCAL REGULATIONS, REQUIREMENTS AND APPROVALS.
- 2. ALL ROOF AREAS ARE GENERALLY NON-TRAFFICABLE AREAS. ENSURE ALL ROOF AND GUTTER MAINTENANCE IS CARRIED OUT BY SUITABLY QUALIFIED INDIVIDUALS IN ACCORDANCE WITH ALL RELEVANT SAFEWORK AUSTRALIA LAWS AND REGULATIONS.
- 3. GUTTERING TO BE TYPE A OR TYPE C FRONT FACE SLOTTED GUTTER.
- 4. DOWNPIPE LOCATIONS ARE TO BE AS SHOWN ABOVE. MINIMUM 75mm DIA. OR 100X50mm RECTANGULAR.

## OSD CHECKLIST

PART 1: SITE FALLS TOWARD STREET.
PART 2: SITE IS GREATER THAN 450sqm.

PART 3: SITE DOES NOT DISCHARGE TO OCEAN.

PART 4: SITE IS NOT LOCATED WITHIN FLOOD PRONE LAND.

PART 5: a) 1017.5sqm x 0.40 = 407sqm.

b) PROPOSED REMAINING IMPERVIOUS AREA = 360.1sqm.

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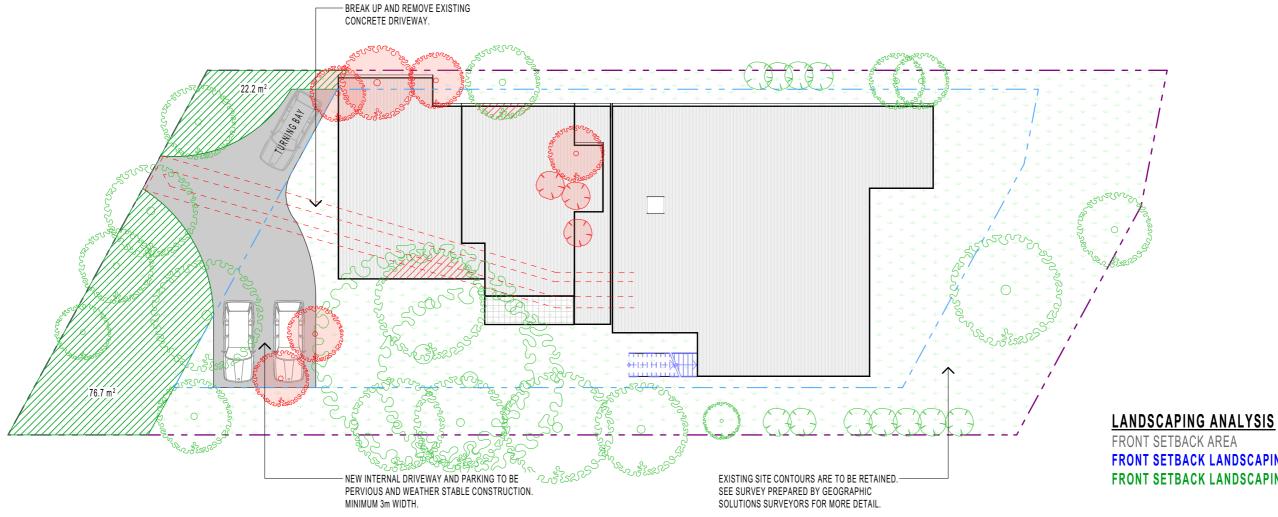
& ADDITIONS TO AN EXISTING BRICK DWELLING
SITE: 141 POWDERWORKS ROAD ELANORA HEIGHTS

DRAWING:	STORMWATER CONCEPT PLAN	

DRAWN:	ALM
DRAWING ID:	DA-15
REV. STATUS:	APPROVALS
CREATED:	22nd JUNE 201
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/ 2102 SCALE: AS SHOWN @ A3

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LANDSCAPING CONCEPT PLAN 1:200

NOTES
1. ONLY TREES MARKED FOR REMOVAL ARE TO BE REMOVED.

FRONT SETBACK LANDSCAPING MIN. (60%) FRONT SETBACK LANDSCAPING PROVIDED

143sqm 86sqm 98sqm

## **LEGEND**



EXISTING TREE TO BE RETAINED



EXISTING TREE TO BE REMOVED



AREA OF EXISTING TREE TO BE PRUNED



EXISTING SHRUBS TO BE RETAINED



EXISTING SHRUBS TO BE REMOVED



PERVIOUS GROUND COVER/LAWN

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FRONT SETBACK LANDSCAPE AREA 98.9sqm

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CLIENT: MATT & NAOMI NOFFS PROJECT: NEW ATTACHED TWO STOREY DUAL OCCUPANCY & ADDITIONS TO AN EXISTING BRICK DWELLING 141 POWDERWORKS ROAD ELANORA HEIGHTS


NSW 2102

DRAWING: LANDSCAPING CONCEPT PLAN

ALM DRAWN: DRAWING ID: DA-16 REV. STATUS: APPROVALS CREATED: 22nd JUNE 2018 DO NOT SCALE FROM DRAWINGS.

SCALE: AS SHOWN @ A3



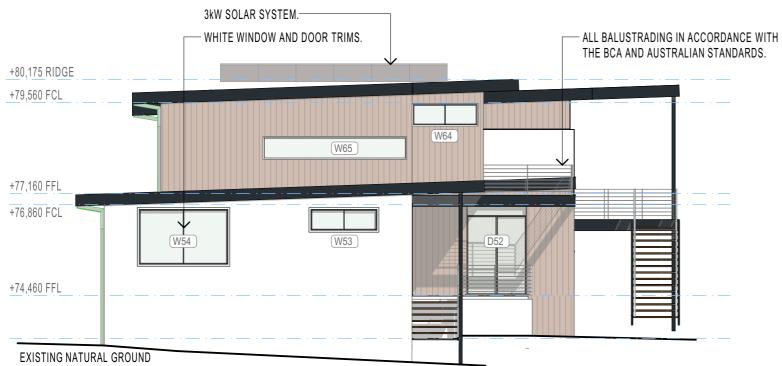

E02 SOUTHERN ELEVATION 1:100

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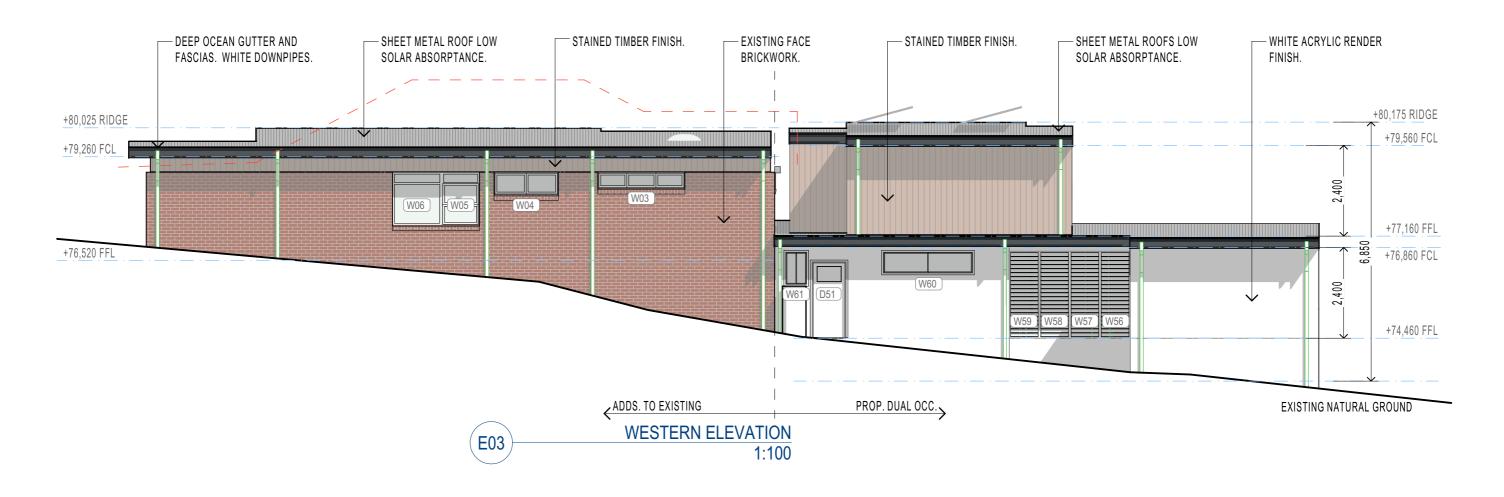
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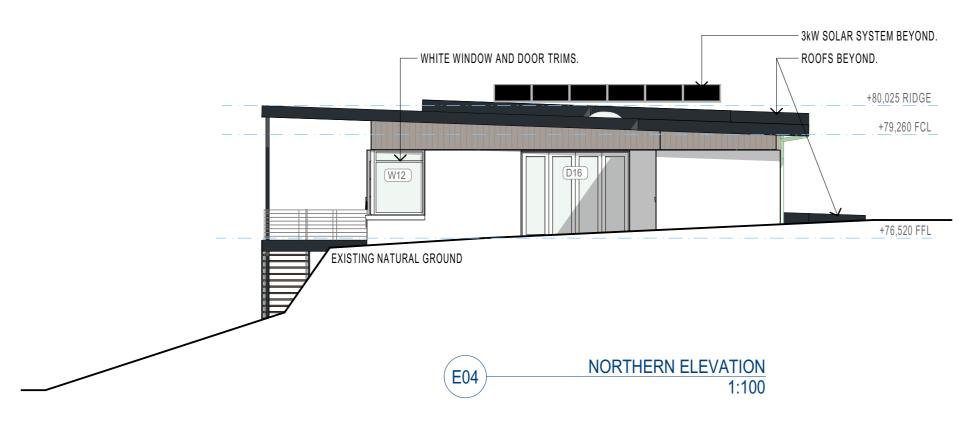
141 POWDERWORKS ROAD ELANORA HEIGHTS

DRAWING: ELEVATIONS


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DRAWING ID: DA-20
REV. STATUS: APPROVALS
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NSW 2102 SCALE: AS SHOWN @ A3





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A4 FUR APPROVALS UNLY, NOT FOR CONSTRUCTION. 11/Ub/2019 0419 988 653 - mail@4plan.com.au - 36 EAST PARADE EASTWOOD / NSW 2102 50-ALE. AS STOWN & AS STORY 100 IN STALE FROM DRAWING STORY 2019 - 4Plan - ABN: 64159346504 - BDAA Accreditation No. 6329 - Copyright of the design and drawing are vested with 4Plan. The design and details shown on this drawing are explicable to this project only and may not be reproduced in any part or whole, with out written and the second part of the design and drawing are vested with 4Plan. The design and details shown on this drawing are vested with 4Plan. The design and details shown on this drawing are vested with 4Plan. The design and 4Plan. The design and 4Plan. The design and 4Plan. The design and 4Plan. The de	A4 S:IOneDrivelIni	FOR APPROVALS ONLY, NOT FOR CONSTRUCTION.	11/06/2019	0419 988 653 - mail@4plan.com.au - http://4plan.com.au - 36 EAST PARADE EASTWOOD		NSW 2102  6: 2019 LABler LABN-RA150346504 LRD&& Accorditation No. 6329 . Convisible of the design and draw		

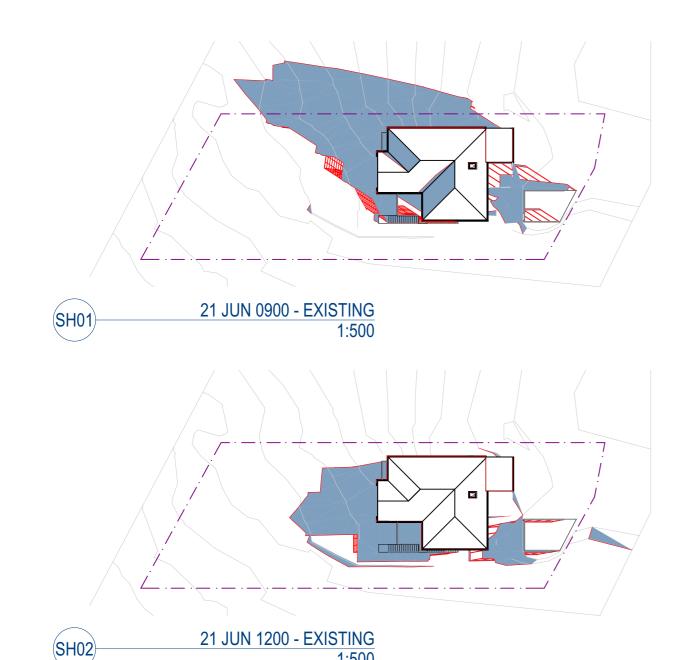


1:500

21 JUN 1500 - EXISTING

1:500




21 JUN 1500 - PROPOSED SH06 1:500 DRAWING: SHADOW DIAGRAMS PROJECT: NEW ATTACHED TWO STOREY DUAL OCCUPANCY & ADDITIONS TO AN EXISTING BRICK DWELLING 141 POWDERWORKS ROAD ELANORA HEIGHTS SCALE: AS SHOWN @ A3 NSW 2102

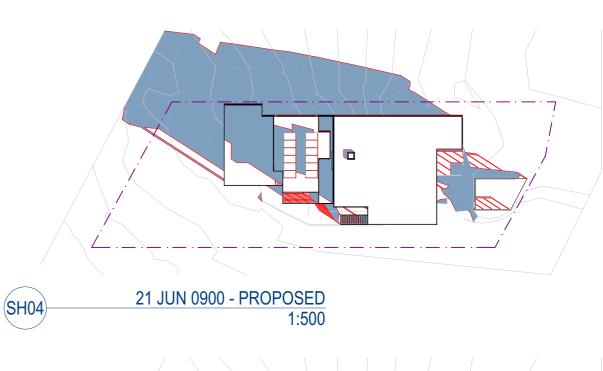



21 JUN 1200 - PROPOSED (SH05) 1:500

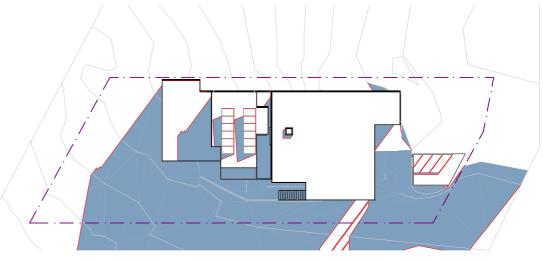

CLIENT: MATT & NAOMI NOFFS

DRAWN: ALM DRAWING ID: DA-23 REV. STATUS: APPROVALS
CREATED: 22nd JUNE 2018 DO NOT SCALE FROM DRAWINGS.

DESCRIPTION 25/03/2019 11/04/2019 FOR APPROVALS ONLY, NOT FOR CONSTRUCTION. A2 FOR APPROVALS ONLY, NOT FOR CONSTRUCTION. A3 02/06/2019 FOR APPROVALS ONLY, NOT FOR CONSTRUCTION. 11/06/2019 FOR APPROVALS ONLY, NOT FOR CONSTRUCTION.

SH03

WINDOW SCHEDULE	- ALL NEW WINDOWS	IN ACCORDANCE W	VITH BASIX AND AS20	47								
ID	W03	W04		W06	W11	W12	W13	W14	W15	W20	W21	W50
RENO STATUS	Existing	Existing	Existing	Existing	New	Existing	Existing	Existing	New	Existing	New	Nev
DESCRIPTION	AWNING	AWNING	AWNING	FIXED	SLIDING	FIXED	FIXED	AWNING	SLIDING	FIXED	SLIDING	CASEMENT
GLAZING	SINGLE CLEAR	SINGLE CLEAR	SINGLE CLEAR	SINGLE CLEAR	SINGLE LOW-E	SINGLE CLEAR	SINGLE CLEAR	SINGLE CLEAR	SINGLE LOW-E	SINGLE CLEAR	DBL GLAZE	DBL GLAZE
FRAME	TIMBER	TIMBER	TIMBER	TIMBER	TIMBER	TIMBER	TIMBER	TIMBER	TIMBER	TIMBER	METAL	METAL
LOCATION	ALTS. BEDROOM 3	ALTS. BATHROOM	ALTS. BEDROOM 4	ALTS. BEDROOM 4	ALTS. KITCHEN	ALTS. DINING	ALTS. DINING	ALTS. DINING	ALTS. BEDROOM 1	ALTS. UNDERCROFT	ALTS. BEDROOM 2	DUAL OCC. BEDROOM 2
WxH	2,300×430	1,700×600	1,000×1,400	1,300×1,400	2,400×1,200	1,340×1,700	1,340×1,700	1,000×1,700	2,400×1,200	1,900×600	2,300×430	600×1,800
AREA (sqm)	0.99	1.02	1.40	1.82	2.88	2.53	2.53	1.70	2.88	1.14	0.99	1.08
SILL HEIGHT	1,900	1,730	930	930	1,100	630	630	630	1,100	1,740	1,900	500
HEAD HEIGHT	2,330	2,330	2,330	2,330	2,300	2,330	2,330	2,330	2,300	2,340	2,330	2,300
ORIENTATION	W	W	W	W	Е	N	Е	E	Е	Е	S	E
EAVES	600mm	600mm	600mm	600mm	450mm	450mm	2750mm	2750mm	450mm	2750mm	0mm	1900mn
OVERSHADOWING	N	N	N	N	N	N	N	N	N	N	N	N
COMMENTS											FIRE SHUTTER FRL -/60/-	
ELEVATION												
ID	W51	W52	W53	W54	W55	W56	W57	W58	W59	W60	W61	W62
RENO STATUS	New	New	New	New	New	New	New	New	New	New	New	New
DESCRIPTION	CASEMENT	CASEMENT	SLIDING	SLIDING	SLIDING	LOUVRE	LOUVRE	LOUVRE	LOUVRE	SLIDING	SLIDING	SLIDING
GLAZING	DBL GLAZE	DBL GLAZED	DBL GLAZED	DBL GLAZE	DBL GLAZE	SINGLE CLEAR	SINGLE CLEAR	SINGLE CLEAR	SINGLE CLEAR	DBL GLAZE	SINGLE CLEAR	DBL GLAZE
FRAME	METAL	METAL	METAL	METAL	METAL	METAL	METAL	METAL	METAL	METAL	METAL	METAL
LOCATION	DUAL OCC. BEDROOM 2	DUAL OCC. ESUITE 1	DUAL OCC. ESUITE 1	DUAL OCC. BEDROOM 1	DUAL OCC. BEDROOM 1	DUAL OCC. BREEZEWAY	DUAL OCC. BREEZEWAY	DUAL OCC. BREEZEWAY	DUAL OCC. BREEZEWAY	DUAL OCC. RETREAT	DUAL OCC. LAUNDRY	DUAL OCC. BEDROOM 3
WxH	600×1,800	600×1,800	1,800×600	2,400×1,500	1,800×600	800×2,300	800×2,300	800×2,300	800×2,300	2,400×600	600×900	1,500×600
AREA (sqm)	1.08	1.08	1.08	3.60	1.08	1.84	1.84	1.84	1.84	1.44	0.54	0.90
SILL HEIGHT	500	500	1,700	800	1,700	0	0	0	0	1,700	1,400	1,700
HEAD HEIGHT	2,300	2,300	2,300	2,300	2,300	2,300	2,300	2,300	2,300	2,300	2,300	2,300
ORIENTATION	E	E	S	S	N	W	W	W	W	W	W	E
EAVES	1900mm	1900mm	0mm	0mm	PART	1450mm	1450mm	1450mm	1450mm	600mm	600mm	0mm
OVERSHADOWING	N	N	N	N	N	N	N	N	N	N	N	N
COMMENTS		FROSTED										
ELEVATION												
ID	W63	W64	W65	W66	W67	WS01						
RENO STATUS	New	New	New	New	New	New						
DESCRIPTION	SLIDING	SLIDING	FIXED	SLIDING	SLIDING	SKYLIGHT				NOTE: WINDOWS TO	O BE DEMOLISHED DO NO	T APPEAR IN SCHEDULE
GLAZING	DBL GLAZE	DBL GLAZE	DBL GLAZE	SINGLE CLEAR	DBL GLAZE	DBL GLAZE						
FRAME	METAL	METAL	METAL	METAL	METAL	METAL						
LOCATION	DUAL OCC. BEDROOM 3	DUAL OCC. LIVING		DUAL OCC. WC	DUAL OCC. LIVING	ALTS. BEDROOM 2						
WxH	1,500×600	1,750×600	3,800×600	1,200×600	2,400×600							
AREA (sqm)	0.90	1.05		0.72	1.44							
SILL HEIGHT	1,700	2,080	1,200	2,080	2,080							
HEAD HEIGHT	2,300	2,680	1,800	2,680	2,680							
ORIENTATION	Е	S	S	E	N	N/A						
L E A \ /E O		^	_	A	0	NI/A	I					

N/A

N/A

REV.	DESCRIPTION	DATE
A1	FOR APPROVALS ONLY, NOT FOR CONSTRUCTION.	25/03/2019
A2	FOR APPROVALS ONLY, NOT FOR CONSTRUCTION.	11/04/2019
A3	FOR APPROVALS ONLY, NOT FOR CONSTRUCTION.	02/06/2019
L <sub>A4</sub>	FOR APPROVALS ONLY, NOT FOR CONSTRUCTION.	11/06/2019
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0mm

0mm

0mm

FIRE SHUTTER FRL -/60/-

EAVES

COMMENTS

ELEVATION

OVERSHADOWING



0mm

CLIENT: MATT & NAOMI NOFFS
PROJECT: NEW ATTACHED TWO STOREY DUAL OCCUPANCY
& ADDITIONS TO AN EXISTING BRICK DWELLING
SITE: 141 POWDERWORKS ROAD ELANORA HEIGHTS NSW 2102

DRAWING: WINDOW SCHEDULE

DRAWN: ALM DRAWING ID: DA-30 REV. STATUS: APPROVALS
CREATED: 22nd JUNE 2018 SCALE: AS SHOWN @ A3

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DOOR SCHEDULE - A	ALL NEW DOORS WITH	I GLAZING IN ACCOR	RDANCE WITH BASIX	AND AS2047								
ID	D06	D09	D10	D14	D16	D17	D18	D19	D50	D51	D52	D53
RENO STATUS	Existing	Existing	Existing	New	New	New	New	New	New	New	New	
DESCRIPTION	HINGED INTERNAL	HINGED INTERNAL	HINGED INTERNAL	HINGED ENTRY	BIFOLD	BIFOLD	HINGED INTERNAL	HINGED INTERNAL	SOLID HINGE w. HIGH	HINGED ENTRY	SINGLE SLIDING	HINGED INTERNAL
GLAZING	NO	NO	NO	SINGLE CLEAR	SINGLE LOW-E	SINGLE LOW-E	NO	NO	SINGLE CLEAR	SINGLE CLEAR	DBL GLAZE	NO
MATERIAL	TIMBER	TIMBER	TIMBER	TIMBER	IMPROVED ALUMINIUM	IMPROVED ALUMINIUM	TIMBER	TIMBER	TIMBER	TIMBER	METAL	TIMBER
LOCATION	ALTS. BEDROOM 2	ALTS. BATHROOM	ALTS. BEDROOM 4	ALTS. ENTRY	ALTS. DINING	ALTS. LIVING	ALTS. BEDROOM 1	ALTS. BEDROOM 3	DUAL OCC. ENTRY	DUAL OCC. LAUNDRY	DUAL OCC. BEDROOM 3	
WxH	830×2,030	830×2,030	830×2,030	1,165×2,330	2,870×2,300	3,200×2,300	830×2,030	830×2,030	1,600×2,400	920×2,030	1,600×2,400	820×2,030
AREA (sqm)	1.68	1.68	1.68	2.71	6.60	7.36	1.68	1.68	3.84	1.87	3.84	
ORIENTATION	N/A	N/A	N/A	E	N	E	N/A	N/A	Е	W	S	N/A
EAVES	N/A	N/A	N/A	3750mm	450mm	2750mm	N/A	N/A	4200mm	600mm	1400mm	N/A
OVERSHADOWING	N/A	N/A	N/A	N	N	N	N/A	N/A	N	N	N	N/A
COMMENTS							TO MATCH EXISTING	TO MATCH EXISTING				
ELEVATION												
ID	D54	D55	D56	D57	D58	D59	D60	D61	D62	D63	D64	D65
RENO STATUS	New	New	New	New	New	New	New	New	New	New	New	New
DESCRIPTION	HINGED INTERNAL	CAVITY SLIDER	CAVITY SLIDER	HINGED INTERNAL	CAVITY SLIDER	HINGED INTERNAL	CAVITY SLIDER	HINGED INTERNAL	BIFOLD	CAVITY SLIDER	CAVITY SLIDER	HINGED INTERNAL
GLAZING	NO	NO	NO	NO	NO	NO	NO	NO	DBL GLAZE	NO	NO	NO
MATERIAL	TIMBER	TIMBER	TIMBER	TIMBER	TIMBER	TIMBER	TIMBER	TIMBER	METAL	TIMBER	TIMBER	TIMBER
LOCATION	DUAL OCC. BEDROOM 2	DUAL OCC. ENSUITE 1	DUAL OCC. ENSUITE 1	DUAL OCC. BEDROOM 1	DUAL OCC. UTILITY	DUAL OCC. LAUNDRY	DUAL OCC. ENSUITE 2	DUAL OCC. BEDROOM 3	DUAL OCC. LIVING	DUAL OCC. PANTRY	DUAL OCC. UTILITY 2	DUAL OCC. WC
WxH	920×2,030	900×2,030	900×2,030	920×2,030	900×2,030	920×2,030	900×2,030	920×2,030	4,420×2,400	820×2,030	920×2,030	920×2,030
AREA (sqm)	1.87	1.83	1.83	1.87	1.83	1.87	1.83	1.87	10.61	1.66	1.87	1.87
ORIENTATION	N/A	N/A	N/A	N/A	N/A	N/A	N/A	N/A	Е	N/A	N/A	-
EAVES	N/A	N/A	N/A	N/A	N/A	N/A	N/A	N/A	900mm	N/A	N/A	N/A
OVERSHADOWING	N/A	N/A	N/A	N/A	N/A	N/A	N/A	N/A	N	N/A	N/A	N/A
COMMENTS												
ELEVATION												
ID	D66	D67	D68									
RENO STATUS	Existing	Existing	New									
DESCRIPTION	HINGED ENTRY	ROLLER	ROLLER									
GLAZING	NO	NO	NO							NOTE: DOORS TO	BE DEMOLISHED DO NO	T APPEAR IN SCHEDULE
MATERIAL	TIMBER	METAL	METAL									
LOCATION	ALTS. UNDERCROFT	ALTS. UNDERCROFT	ALTS. UNDERCROFT									
WxH	820×2,040	2,690×2,300	1,500×2,300									
AREA (sqm)	1.67	6.19	3.45									
ORIENTATION	E	N/A	E									
EAVES	N/A	N/A	N/A									
OVEDSHYDOWING	NI/A	NI/A	NI/A									

DESCRIPTION	DATE
FOR APPROVALS ONLY, NOT FOR CONSTRUCTION.	25/03/2019
FOR APPROVALS ONLY, NOT FOR CONSTRUCTION.	11/04/2019
FOR APPROVALS ONLY, NOT FOR CONSTRUCTION.	02/06/2019
FOR APPROVALS ONLY, NOT FOR CONSTRUCTION.	11/06/2019
	FOR APPROVALS ONLY, NOT FOR CONSTRUCTION. FOR APPROVALS ONLY, NOT FOR CONSTRUCTION.

OVERSHADOWING COMMENTS

ELEVATION

N/A



CLIENT: MATT & NAOMI NOFFS
PROJECT: NEW ATTACHED TWO STOREY DUAL OCCUPANCY
& ADDITIONS TO AN EXISTING BRICK DWELLING
SITE: 141 POWDERWORKS ROAD ELANORA HEIGHTS

NSW 2102

DRAWING: DOOR SCHEDULE

DRAWN: ALM DRAWING ID: DA-31
REV. STATUS: APPROVALS
CREATED: 22nd JUNE 2018
DO NOT SCALE FROM DRAWINGS.

SCALE: AS SHOWN @ A3 wing are vested with 4Plan. The design and details shown on this drawing are applicable to this project



REV.	DESCRIPTION	DATE
A1	FOR APPROVALS ONLY, NOT FOR CONSTRUCTION.	25/03/2019
A2	FOR APPROVALS ONLY, NOT FOR CONSTRUCTION.	11/04/2019
A3	FOR APPROVALS ONLY, NOT FOR CONSTRUCTION.	02/06/2019
A4	FOR APPROVALS ONLY, NOT FOR CONSTRUCTION.	11/06/2019
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CLIENT: MATT & NAOMI NOFFS
PROJECT: NEW ATTACHED TWO STOREY DUAL OCCUPANCY
& ADDITIONS TO AN EXISTING BRICK DWELLING
SITE: 141 POWDERWORKS ROAD ELANORA HEIGHTS

DRAWING: FINISHES AND COLOURS

DRAWN: ALM
DRAWING ID: DA-32
REV. STATUS: APPROVALS
CREATED: 22nd JUNE 2018

SCALE: AS SHOWN @ A3

DO NOT SCALE FROM DRAWINGS.

## BASIX DA SUMMARY TABLE – PROPOSED DUAL OCCUPANCY

The following schedule lists the DA requirements of BASIX certificate No. 1003317M. All items listed in the BASIX certificate, are to be incorporated into the construction of the residence.

#### WATER REQUIREMENT

**Fixtures** Shower Heads 4 Star (> 4.5 but  $\leq$  6 L/minute)

4 Star Toilets Kitchen Taps 4 Star Bathroom Taps 4 Star

Individual water tank 2000 litres (min.) collecting run off from Alternative Water Connected to landscaping and toilets.

at least 100sqm of roof area. **ENERGY** 

REQUIREMENT Hot Water System Electric heat pump – air sourced 36 to 40 STCs Bathroom ventilation Individual fan ducted to façade or roof. Manually switched Kitchen ventilation Individual fan ducted to façade or roof. Manually switched. Laundry ventilation Individual fan ducted to façade or roof. Manually switched. Ceiling fans and single-phase air-conditioning (2star). Cooling living areas Ceiling fans and single-phase air-conditioning (2star). Cooling bedrooms

Heating living areas Single-phase air-conditioning (2star). Single-phase air-conditioning (2star). Heating bedrooms

Artificial lighting All rooms. Primarily fluorescent lighting or light emitting diode

(LED) lighting

THERMAL COMFORT REQUIREMENT

FC clad (medium – light colour) Anti-glare foil & bulk insul. R2.5 External Walls

Double stud with plaster & bulk insul. R2.5

Bulk insul. R1.0 Suspended floor Ceilings Bulk insul, R4.0

Roof (light solar absorptance) No air gap above, foil reflective side down, bulk insul. R1.3

**GLAZING** REQUIREMENT

Windows & Glazed Windows, glazed doors and shading devices must be installed in accordance with the specification listed in BASIX certificate No.

Doors

Window General


Louvres, laundry & upstairs WC

Party wall

Frame & Glass

Thermally broken aluminium, double glazed clear-clear

U-Value 3.60, SHGC 0.47 and 0.54 Standard aluminium, single clear U-Value 6.70, SHGC 0.70

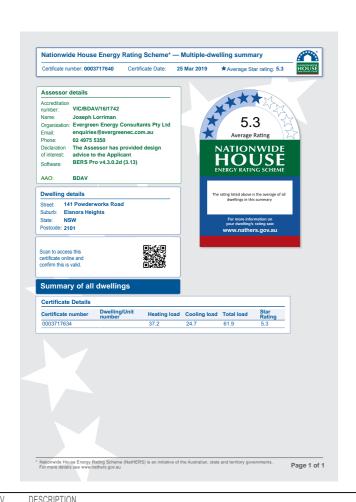

A2

A3

DATE
25/03/2019
11/04/2019
02/06/2019
11/06/2019



BASIX DA SUMMARY TABLE – ALTERATION & ADDITIONS TO EXISTING DWELLING

The following schedule lists the DA requirements of BASIX certificate No. A323325 04. All items listed in the BASIX certificate, are to be incorporated into the construction of the residence.

CONSTRUCTION REQUIREMENT

Suspended floor with enclosed subfloor: framed (R0.7) Additional: R0.60 (down) (or R1.30 including construction) Insulation

R1.16 (or R1.70 including construction) External wall: brick veneer Flat ceiling, flat roof: framed Ceiling: R2.32 (up), roof: foil/sarking (light solar absorptance < 0.475)

**GLAZING** REQUIREMENT

Skylights

Windows & Glazed Windows, glazed doors and shading devices must be installed in accordance with the specification listed in BASIX certificate No. Doors

AJZJJZJ.							
Tag	Orientation	Area (sqm)	Overshadow height x distance (m)	Shading Device	Frame & Glass		
W15	Е	2.8	nil	Eaves ≥ 450mm	Timber or uPVC, single pyrolytic low-e, (U-value: 3.99, SHGC: 0.4)		
D14	Е	0.5	nil	Eaves ≥ 900mm	Timber or uPVC, single clear (U-value: 5.71, SHGC: 0.66)		
D16	N	6.6	nil	Eaves ≥ 450mm	Improved aluminium, single pyrolytic low-e, (U-value: 4.48, SHGC: 0.46)		
D17	E	7.3	nil	Eaves ≥ 900mm	Improved aluminium, single pyrolytic low-e, (U-value: 4.48, SHGC: 0.46)		
W21	S	1.0	nil	none	Standard aluminium, clear/air gap/clear, (U-value: 5.34, SHGC: 0.67)		
W11	Е	2.9	nil	Eaves ≥ 450mm	Timber or uPVC, single pyrolytic low-e, (U-value: 3.99, SHGC: 0.4)		
Skylights must be installed in accordance with the specification listed in BASIX certificate No. A323325.							
Tag	Area (sqm)		Shading Device	•	Frame & Glass		
WS01	0.77		No shading devi	ce	Aluminium moulded plastic single clear		

No shading device

(or U-value: 6.21, SHGC: 0.808)

MATT & NAOMI NOFFS DRAWING: BASIX DA REQUIREMENTS ALMDRAWN: PROJECT: NEW ATTACHED TWO STOREY DUAL OCCUPANCY DRAWING ID: DA-33 & ADDITIONS TO AN EXISTING BRICK DWELLING REV. STATUS: APPROVALS 141 POWDERWORKS ROAD ELANORA HEIGHTS CREATED: 22nd JUNE 2018 SCALE: AS SHOWN @ A3 NSW 2102 DO NOT SCALE FROM DRAWINGS.