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# **DEVELOPMENT APPLICATION**

# THESE PLANS ARE FOR DEVELOPMENT APPROVAL ONLY.

ITEM DETAILS	DEVELOPMENT APPLICATION					
ADDRESS	39 PRINCE EDWARD ROAD, SEAFORTH, NSW, 2092					
LOT & DP/SP	LOT 141 DP 11162					
COUNCIL	NORTHERN BEACHS COUNCIL (MANLY)					
SITE AREA	518.50m²					
FRONTAGE	12.19m					
CONTROLS	PERMISSIBLE / REQUIRED	EXISTING	PROPOSED	COMPLIANCE		
CONTROLS	m / m² / %	m / m² / %	m / m² / %			
<u>LEP</u>						
LAND ZONING	R2 – LOW DENSITY RESIDENTIAL	R2	R2	YES		
MINIMUM LOT SIZE	500m²	518.50m <sup>2</sup>	UNCHANGED	YES		
FLOOR SPACE RATIO	0:45 : 1 (233.325m²)	0.31 : 1 (162.96m²)	0.37 : 1 (191.96m²)	YES		
MAXIMUM BUILDING HEIGHT	8.5m	9.6m	UNCHANGED	NO		
<u>HAZARDS</u>						
ACID SULFATE SOILS	NOT IDENTIFIED	N/A	N/A	N/A		
FLOOD PLANNING	NOT IDENTIFIED	N/A	N/A	N/A		
TERRESTRIAL BIODIVERSITY	NOT IDENTIFIED	N/A	N/A	N/A		
RIPARIAN LAND & WATERCOURSE	NOT IDENTIFIED	N/A	N/A	N/A		
WETLANDS	NOT IDENTIFIED	N/A	N/A	N/A		
LANDSLIP RISK	NOT IDENTIFIED	N/A	N/A	N/A		
TERRESTRIAL BIODIVERSITY	NOT IDENTIFIED	N/A	N/A	N/A		
FORESHORE SCENIC PRO. AREA	NOT IDENTIFIED	N/A	N/A	N/A		
BUSHFIRE	NOT IDENTIFIED	N/A	N/A	N/A		
DCP						
RESIDENTIAL OPEN SPACE	AREA OS3					
TOTAL OPEN SPACE (TOS)	55% (285.175m²)	392.52m² (75%)	334.5m <sup>2</sup> (64%)	YES		
LANDSCAPE AREA	35% OF TOS (55%) : 99.81m <sup>2</sup>	280.34m²	314.93m²	YES		
OPEN SPACE ABOVE GROUND	MAX. 40% OF TOS (55%) : 114.07m <sup>2</sup>	13.40m²	31.72m <sup>2</sup>	YES		
PRINCIPAL PRIVATE OPEN SPACE	18m²	0m²	21.84m²	YES		
FRONT SETBACK	PREVALING BULDING LINE: 6m	10.9m	8.93m	YES		
REAR SETBACK	8.0m	16.6m	UNCHANGED	YES		
SIDE SETBACKS	1/3 WALL HEIGHT	N:0.994m	N:UNCHANGED	NO		
SIDE SETBACKS	3.050m	S:1.016m	S:UNCHANGED	NO		
CAR PARKING SPACES	Required: 1	1	UNCHANGED	YES		

SHEET NUMBER	SHEET NAME	DATE PUBLISHED
DA00	COVER	17/11/2020
DA01	NOTATION	17/11/2020
DA02	SITE ANALYSIS	17/11/2020
DA03	${\tt SITE/ROOF/SEDIMENT\ EROSION/WASTE\ MANAGEMENT/STORMWATER\ CONCEPT\ PLAN}$	17/11/2020
DA04	EXISTING GARAGE FLOOR PLAN	17/11/2020
DA05	EXISTING GROUND FLOOR PLAN	17/11/2020
DA06	EXISTING FIRST FLOOR PLAN	17/11/2020
DA07	PROPOSED GARAGE FLOOR PLAN	17/11/2020
DA08	PROPOSED GROUND FLOOR PLAN	17/11/2020
DA09	PROPOSED FIRST FLOOR PLAN	17/11/2020
DA10	NORTH / EAST ELEVATION	17/11/2020
DA11	SOUTH / WEST ELEVATION	17/11/2020
DA12	PROPOSED DRIVEWAY PLAN	17/11/2020
DA13	LONG / CROSS SECTION	17/11/2020
DA14	AREA CALCULATIONS / SAMPLE BOARD	17/11/2020
DA15	WINTER SOLSTICE 9 AM	17/11/2020
DA16	WINTER SOLSTICE 12 PM	17/11/2020
DA17	WINTER SOLSTICE 3 PM	17/11/2020
DA18	BASIX COMMITMENTS	17/11/2020

# **39 PRINCE EDWARD ROAD**, SEAFORTH NSW 2092





# NCC & AS COMPLIANCES SPECIFICATIONS

- EARTHWORKS PART 3.1.1 OF NCC
- EARTH RETAINING STRUCTURES PART 3.1.2 OF NCC
- DRAINAGE PART 3.1.3 OF NCC
- TERMITE-RISK MANAGEMENT PART 3.1.4 OF NCC
- FOOTINGS & SLAB PART 3.2 OF NCC INCLUDING AS2870
- MASONRY PART 3.3 OF NCC INCLUDING AS3700
- FRAMING PART 3.4 OF NCC
- SUB FLOOR VENTILATION PART 3.4.1 OF NCC
- ROOF CLADDING AND WALL-CLADDING PART 3.5 OF NCC
- GLAZING PART 3.6 OF NCC INCLUDING AS1288
- FIRE SAFETY PART 3.7 OF NCC
- FIRE SEPERATION PART 3.7.2 OF NCC
- FIRE PROTECTION OF SEPERATING WALLS AND FLOORS- PART 3.7.3 OF NCC
- SMOKE ALARMS PART 3.7.5 OF NCC
- WET AREAS AND EXTERNAL WATERPROOFING PART 3.8.1 OF NCC
- ROOM HEIGHTS PART 3.8.2 OF NCC
- FACILITIES PART 3.8.3 OF NCC
- LIGHT PART 3.8.4 OF NCC
- VENTILATION PART 3.8.5 OF NCC
- SOUND INSULATION PART 3.8.6 OF NCC
- STAIRWAYAND RAMP CONSTRUCTION PART 3.9.1 OF NCC
- BARRIERS AND HANDRAILS PART 3.9.2 OF NCC
- SWIMMING POOLS PART 3.10.1 OF NCC
- CONSTRUCTION IN BUSHFIRE PRONE AREAS PART 3.10.5 OF NCC
- FENCING & OTHER PROVISIONS REGS & AS1926
- DEMOLITION WORKS AS2601-1991 THE DEMOLITION OF STRUCTURES.
- ALL WATERPROOF MEMBRANES TO COMPLY WITH WITH AS 3740-2010
- ALL PLUMBING & DRAINAGE WORK TO COMPLY WITH AS 3500
- SITE CLASSIFICATION AS TO AS 2870
- ALL PLASTERBOARD WORK TO COMPLY WITH AS 2588-1998
- ALL STRUCTURAL STEEL WORK TO COMPLY WITH AS 4100 & AS 1554
- ALL CONCRETE WORK TO COMPLY WITH AS 3600
- ALL ROOF SHEETING WORK TO COMPLY WITH AS 1562-1992
- ALL SKYLIGHTS TO COMPLY WITH WITH AS 4285-2007
- ALL CERAMIC TILING TO COMPLY WITH AS 3958.1-2007 & 3958.2-1992
- ALL GLAZING ASSEMBLIES TO COMPLY WITH AS2047 & 1288
   ALL TIMBER RETAINING WALLS ARE TO COMPLY WITH AS 1720.1-2010,
- AS 1720.2-2006, AS 1720.4-2006, AS 1170.1-1989 & AS 1170.4-2007 ALL RETAINING WALLS ARE TO COMPLY WITH 3700 2011 & AS 3600 -2009
- ALL CONSTRUCTION TO COMPLY TO AS3959- 2009

# **NOTES**

- APPROVED MEANS BY THE 'RELEVANT LOCAL AUTHORITY' OR COUNCIL
- THE OWNER WILL DIRECTLY PAYTHE FEES ASSOCIATED WITH THE FOLLOWING:
- BUILDING APPROVAL FROM COUNCIL, FOOTPATH AND KERB DEPOSITS WITH THE LOCAL COUNCIL, INSURANCE FEE TO BUILDING SERVICES CORPORATION, LONG SERVICE LEAVE SERVICE LEVY FEE AND APPROVAL FEE BY WATER AND SEWERAGE AUTHORITY. ALL OTHER FEES ARE TO BE PAID BY THE BUILDER. THE AMOUNT OF ANY LOCAL AUTHORITY DEPOSITS WHICH ARE FORFEITED DUE TO DAMAGE OR OTHER CAUSE WILL BE DEDUCTED FROM THE PAYMENTS DUE TO THE BUILDER.
- THE BUILDER IS TO PROVIDE AT HIS/HER OWN EXPENSE ADEQUATE PUBLIC RISK INSURANCE AND ARRANGE INDEMNIFICATION UNDER THE WORKERS COMPENSATION ACT. WORKS INSURANCE TO BE STATED IN THE CONTRACT CONDITIONS.
- ALL WORK TO BE CARRIED OUT IN A TRADESMEN LIKE MANNER AND IN ACCORDANCE WITH THE STANDARDS CODES AND REGULATIONS OF THE STANDARDS ASSOCIATION OF AUSTRALIA, BUILDING CODE OF AUSTRALIA AND ANY STATUTORY AUTHORITY HAVING JURISDICTION OVER THE WORK.
- ALL TENDERERS ARE TO VISIT THE SITE TO SATISFY THEMSELVES AS TO THE NATURE AND EXTENT OF THE WORKS, FACILITIES AVAILABLE AND DIFFICULTIES ENTAILED IN THE WORKS AS VARIATIONS WILL NOT BE ALLOWED DUE TO WORK ARISING OWING TO NEGLECT OF THIS CLAUSE.
- ALL WORK AND MATERIALS TO COMPLY WITH THE CURRENT AUSTRALIAN STANDARDS AT THE TIME OF COMMENCEMENT WERE APPLICABLE.
- THESE DRAWINGS SHALL BE READ IN CONJUNCTION WITH ALL STRUCTURAL AND OTHER CONSULTANTS DRAWINGS AND SPECIFICATIONS AND WITH ANY SUCH WRITTEN INSTRUCTIONS AS MAY BE ISSUED DURING THE COURSE OF THE CONTRACT.
- SET OUT DIMENSIONS SHOWN ON THIS DRAWING SHALL BE VARIFIED BY THE BUILDER ON SITE BEFORE COMMENCEMENT OF ANY WORK. DIMENSIONS SHOULD NOT BE OBTAINED BY SCALING THE DRAWINGS. USE ONLY FIGURED DIMENSIONS, ALL DIMENSIONS ARE IN MILLIMETRES.
- THE BUILDER IS TO ENSURE ALL CONSTRUCTION. LEVELS AND OTHER ITEMS COMPLY WITH THE CONDITIONS OF THE BUILDING APPROVAL.
- THE BUILDER IS TO COMPLY WITH ALL ORDINANCES, LOCAL AUTHORITY REGULATIONS AND THE REQUIREMENTS OF ALL SERVICES SUPPLY AUTHORITIES HAVING JURISDICTION OVER THE WORKS.
- ALL PLUMBING AND DRAINAGE WORK TO BE INSTALLED AND COMPLETED BY A LICENCED TRADESMAN AND IN ACCORDANCE WITH THE STATUTORY BODY HAVING AUTHORITY OVER THE WORKS. CONNECT ALL WASTE TO SYDNEY WATER SEWER LINE
- ALL NEW DOWNPIPES ARE TO BE CONNECTED TO THE EXISTING STORM WATER SYSTEM.
- ALL POWER AND STORMWATER OUTLET LOCATIONS SHALL BE DETERMINED ONSITE BY THE OWNER.
- SMOKE DETECTOR ALARM TO BE INSTALLED IN ACCORDANCE WITH AS3786 AND THE BUILDING CODE OF AUSTRALIA.
- ELECTRICAL WORK TO BE IN ACCORDANCE WITH SAA WIRING RULES AND BE DONE BY A LICENCED TRADESMAN
- ANY DETAILING IN ADDITION TO WHAT IS SUPPLIED SHALL BE RESOLVED BETWEEN THE OWNER AND THE BUILDER TO THE OWNERS APPROVAL, EXCEPT FOR ANY STRUCTURAL DETAILS OR DESIGN WHICH IS SUPPLIED BY THE ENGINEER.
- ALL TIMBER SIZES AND CONCRETE DETAILS TO BE CONFIRMED BY THE BUILDER PRIOR TO COMMENCEMENT OF ANY WORK.
- ALL STRUCTURAL WORK IS TO BE IN ACCORDANCE WITH THE STRUCTURAL DETAILS PREPARED BY A STRUCTURAL ENGINEER (i.e.) PIERS, FOOTINGS, CONCRETE SLABS, RETAINING WALLS, STEELWORK, FORMWORK, UNDERPINNING, ADDITIONAL STRUCTURAL LOADS, TIMBER FRAMING, WIND BRACING AND ASSOCIATED CONNECTIONS. BUILDER TO OBTAIN PRIOR TO FINALISING TENDER.
- ANY WORK INDICATED ON THE PLANS BUT NOT SPECIFIED, AND ANY ITEM NOT SHOWN ON THE PLAN WHICH IS OBVIOUSLY NECESSARY AS A PART OF CONSTRUCTION AND/OR FINISH IS TO BE CONSIDERED AS SHOWN AND SPECIFIED, AND IS TO BE DONE AS PART OF THE CONTRACT. VARIATIONS WILL NOT BE PERMITTED WITHOUT THE WRITTEN CONSENT OF THE OWNER.
- THE BUILDER SHALL PROVIDE SEDIMENT AND SILTRATION CONTROL MEASURES AS REQUIRED BY COUNCIL AND MAINTAIN THEM THROUGH THE DURATION OF THE WORKS.
- A LEGIBLE COPY OF THE PLANS BEARING APPROVAL STAMPS MUST BE MAINTAINED ON THE JOB AT ALL TIMES. HOURS OF CONSTRUCTION WILL BE RESTRICTED TO THE TIMES AS REQUIRED BY THE BUILDING APPROVAL.
- THE BUILDER IS TO ARRANGE FOR ALL INSPECTIONS REQUIRED BY THE AUTHORITIES AND LENDING INSTITUTIONS TO THEIR REQUIREMENTS.
- THE BUILDER IS TO OBTAIN APPROVAL FOR INTERUPTIONS TO EXISTING SERVICES AND MINIMISE THE DURATION AND NUMBER OF INTERUPTIONS. ANY INTERRUPTIONS WITH EXISTING SERVICES AND EQUIPMENT TO BE ATTENDED TO BY THE APPROPRIATELY SKILLED TRADESMEN.
- THE BUILDER SHALL RESTORE, REINSTATE OR REPLACE ANY DAMAGE CAUSED TO EXISTING STRUCTURES OR LANDSCAPING BY CONSTRUCTION WORK OR WORKMEN. PROVIDE PROTECTION TO EXISTING TREES TO REMAIN AS REQUIRED BY APPROVAL CONDITIONS.
- ALL BRICKWORK IS TO BE SELECTED BY OWNER AND IS TO COMPLY WITH AS1640
- ALL MASONRY TO COMPLY WITH AS3700
- ALL METALWORK AND FLASHING ITEMS NECESSARY TO SATISFACTORY COMLPETE WORK SHALL BE PROVIDED.
- ALL GUTTERS, DOWNPIPES TO BE COLORBOND.
- ALL TIMBER CONSTRUCTION TO BE IN ACCORDANCE WITH THE AUSTRALIAN STANDARD 1684 "TIMBER FRAMING CODE"
- ALL GLAZING INSTALLED TO COMPLY WITH AS1288, 2047 AND IN ACCORDANCE WITH MANUFACTURERS RECOMMENDATION
- ALL WALL AND CEILING LININGS TO BE PLASTERBOARD OR CEMENT RENDER AS SELECTED AND VILLA BOARD IN WET AREAS, TO COMPLY WITH THE RELEVANT AUSTRALIAN STANDARDS OR INSTALLED IN ACCORDANCE WITH MANUFACTURERS SPECIFICATION.
- ALL BATHROOMS AND WET AREAS TO BE ADEQUATELY WATERPROOFED TO MANUFACTURERS SPECIFATION AND AS3740 AND PART 3.8.1 OF THE BUILDING CODE OF AUSTRALIA HOUSING PROVISIONS
- STAIRS AND BALUSTRADES TO COMPLYWITH PART 3.9.1 & 3.9.2 OF THE BUILDING CODE OF AUSTRALIA HOUSING PROVISION.
- TERMITE PROTECTION MEASURES TO COMPLY WITH AS 3660 AND BE INSTALLED TO MANUFACTURERS SPECIFICATION.
- ANY DETAILING ADDITIONAL TO THAT SUPPLIED, SHALL BE RESOLVED BETWEEN THE OWNER AND THE BUILDER TO THE OWNERS APPROVAL. EXCEPT FOR ANY STRUCTURAL DETAILS OR DESIGN WHICH IS TO BE SUPPLIED BY THE STRUCTURAL ENGINEER.

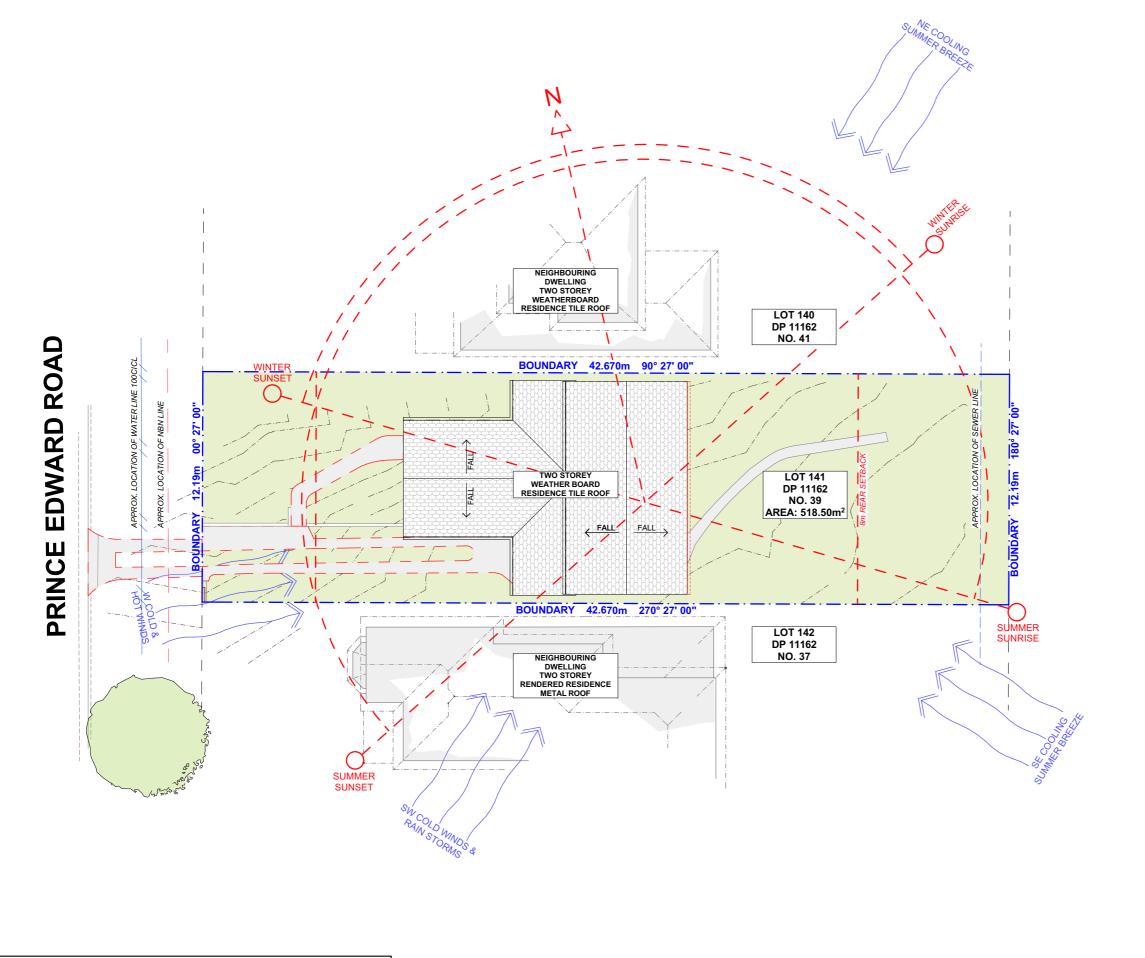


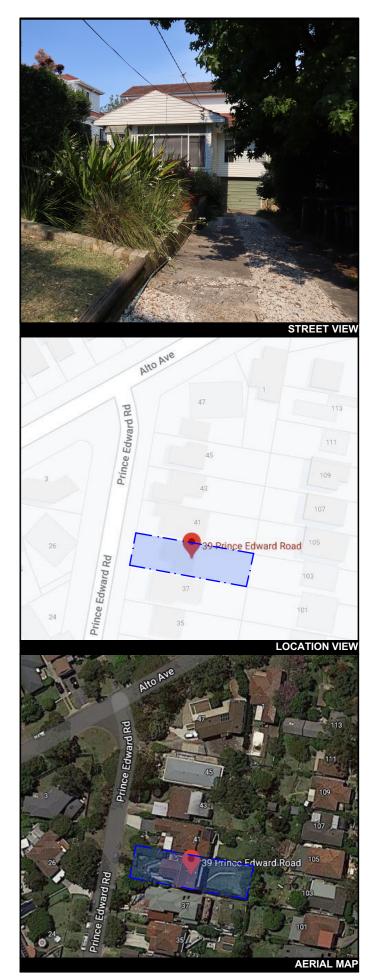

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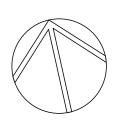
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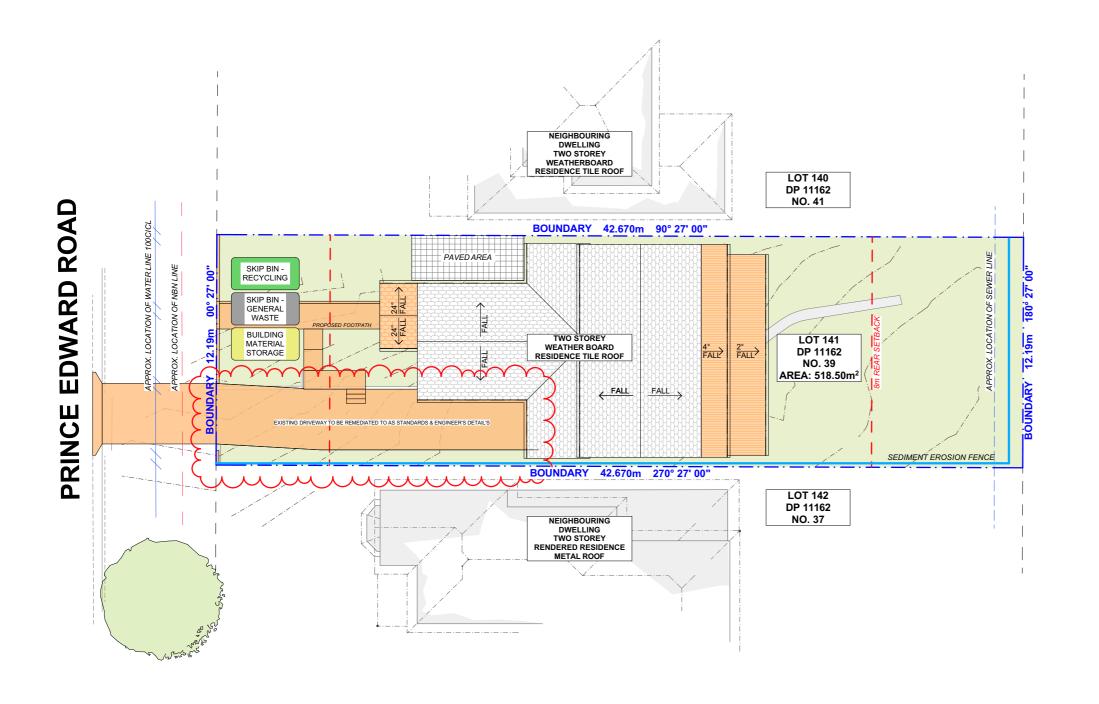
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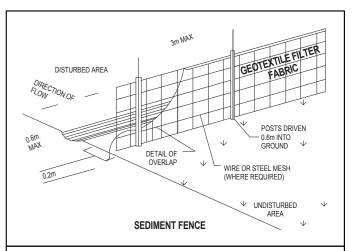
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DRAWING NAME SITE ANALYSIS

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## **DUST CONTROL:**

TO REDUCE DUST GENERATED BY WIND ACTION, THE REMOVAL OF THE TOP SOIL IS TO BE MINIMISED. TO PREVENT DUST GENERATION, WATERING DOWN OF THE SITE, ESPECIALLY DURING THE MOVEMENT OF MACHINERY IS REQUIRED. WHERE EXCAVATING INTO ROCK, KEEP THE SURFACE MOIST TO MINIMISE DUST. CONSTRUCT A GRAVEL ENTRY/EXIT POINT USING BLUE METAL AND RESTRICT ALL VEHICLE MOVEMENTS WITHIN THE SITE TO A MINIMUM. ENSURE WIND BREAKS, SUCH AS EXISTING FENCES ARE MAINTAINED DURING THE CONSTRUCTION PHASE UNTIL NEW LANDSCAPING IS PROVIDED OR REINSTATED. PREVENT DUST BY COVERING STOCKPILES
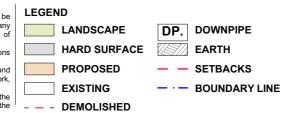
## **SEDIMENT NOTE:**

- 1. ALL EROSION AND SEDIMENT CONTROL MEASURES TO BE INSPECTED AND MAINTAINED DAILY BY THE SITE MANAGER.
- 2. MINIMISE DISTURBED AREAS, REMOVE EXCESS SOIL FROM EXCAVATEDAREA AS SOON AS POSSIBLE. 3. ALL MATERIAL STOCKPILE TO BE CLEAR FROM DRAINS, GUTTERS AND FOOTPATHS, OR WITHIN SEDIMENT FENCE AREA
- 4. DRAINAGE TO BE CONNECTED TO STORMWATER AS SOON AS POSSIBLE. IF STORED ON SITE, IT MUST BE FILTERED BEFORE RELEASING INTO STORMWATER SYSTEM OR WATERWAYS.
- 5. ROADS AND FOOTPATHS TO BE SWEPT DAILY.

# STOCKPILES:

ALL STOCKPILES ARE TO BE KEPT ON-SITE WHERE POSSIBLE. ANY MATERIALS PLACED ON THE FOOTPATHS OR NATURE STRIPS REQUIRE COUNCIL'S PERMISSION.

ALL STOCKPILES ARE TO BE PLACED AWAY FROM THE DRAINAGE LINES AND STREET GUTTERS. IT IS BEST TO LOCATE THESE ON THE HIGHEST PART OF THE SITE IF POSSIBLE. PLACE WATERPROOF COVERING OVER STOCKPILES.

IF REQUIRED PROVIDE DIVERSION DRAIN & BANK AROUND STOCKPILES.

# **GUTTER PROTECTION:**

PROVIDE PROTECTION TO DOWNHILL GRATE IN GUTTER BY MEANS OF SAND BAGS OR BLUE METAL WRAPPED IN GEOTEXTILE FABRIC. WHEN SOIL OR SAND BUILDS UP AROUND THIS SEDIMENT BARRIER, THE MATERIAL SHOULD BE RELOCATED BACK TO THE SITE FOR DISPOSAL.

NOTE: ALL PROPOSED STORMWATER TO CONNECT WITH EXISTING



# **ACTION PLANS**


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# DRAWING NO.

**DA03** 

# DATE


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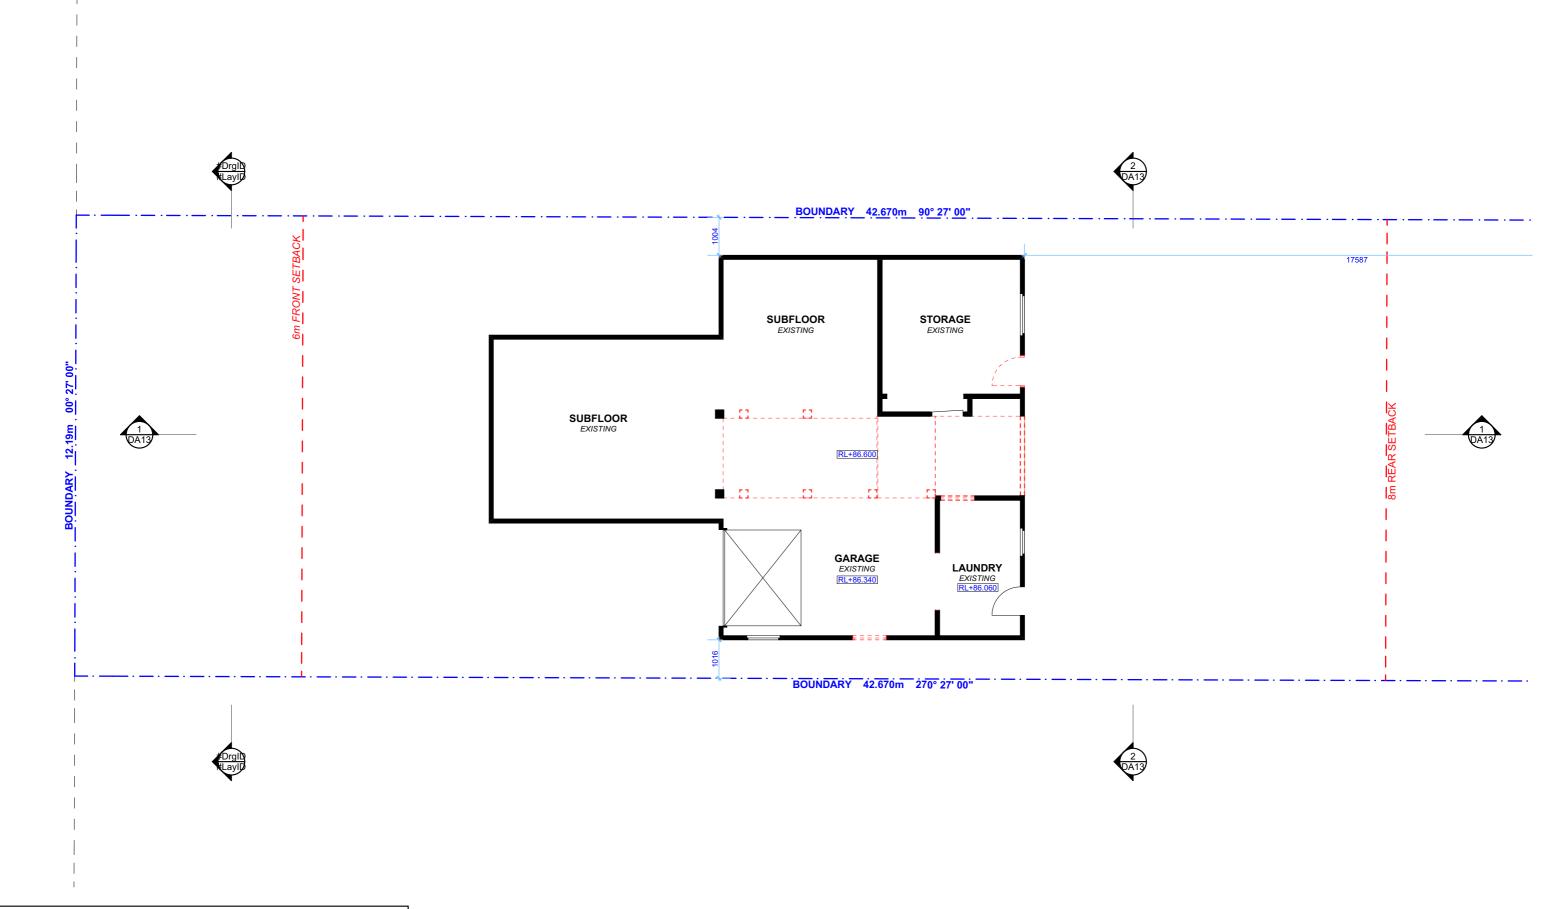
## DRAWING NAME

SITE / ROOF / SEDIMENT **EROSION / WASTE** MANAGEMENT / STORMWATER CONCEPT PLAN

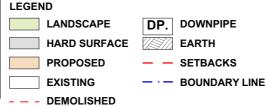

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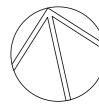
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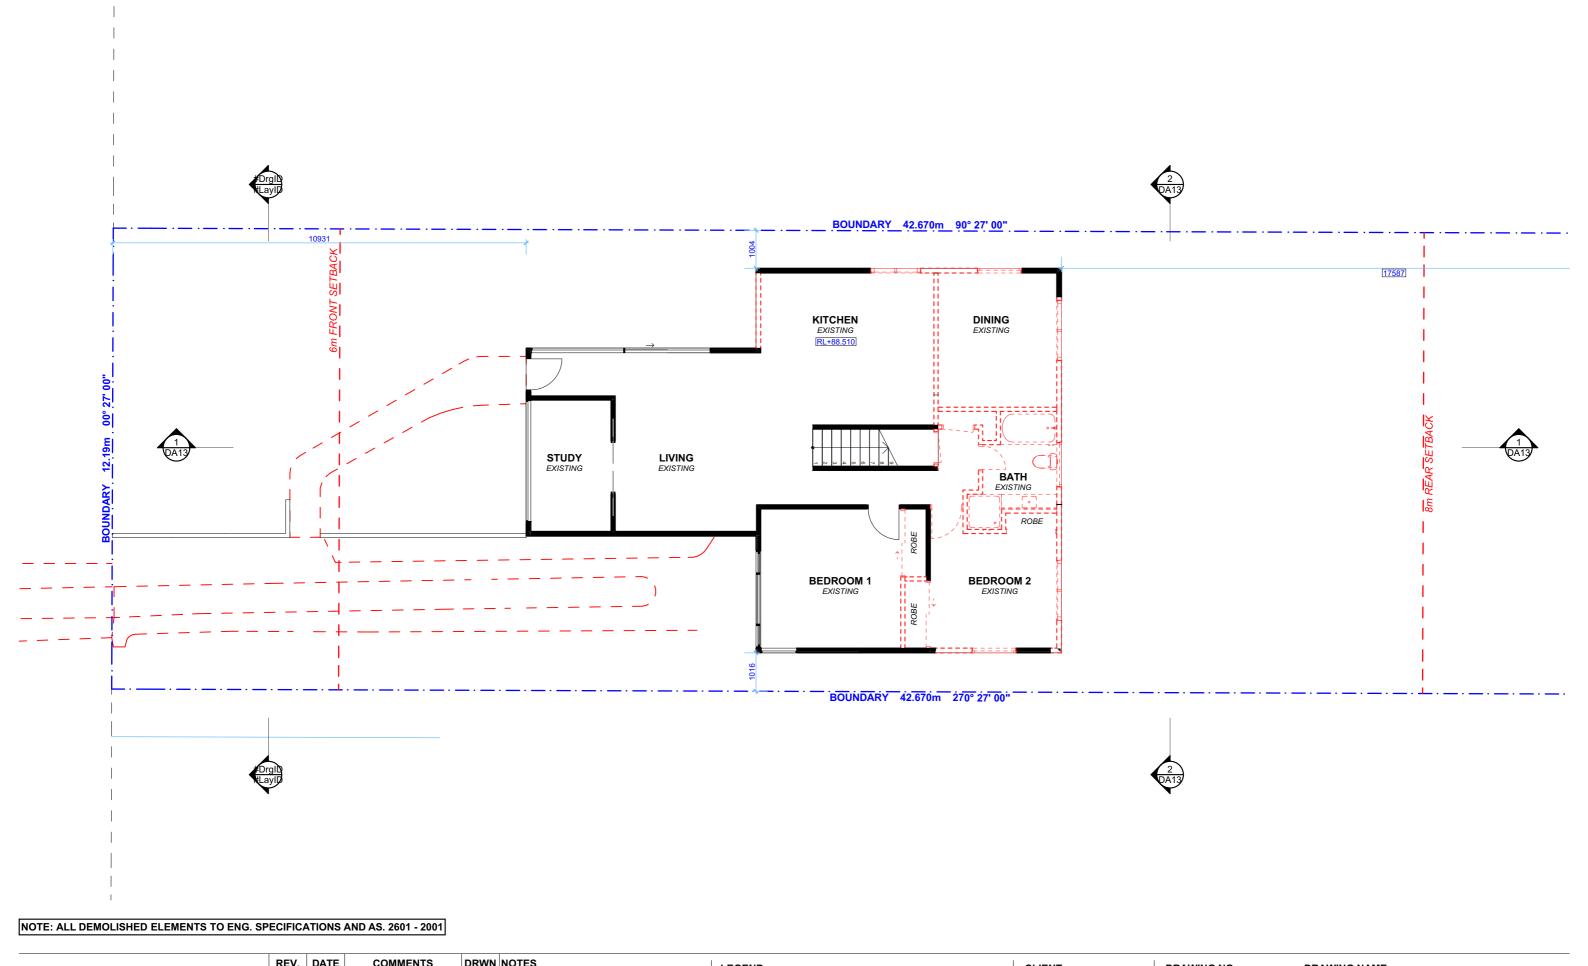
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EXISTING GARAGE FLOOR

PLAN
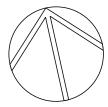
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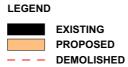


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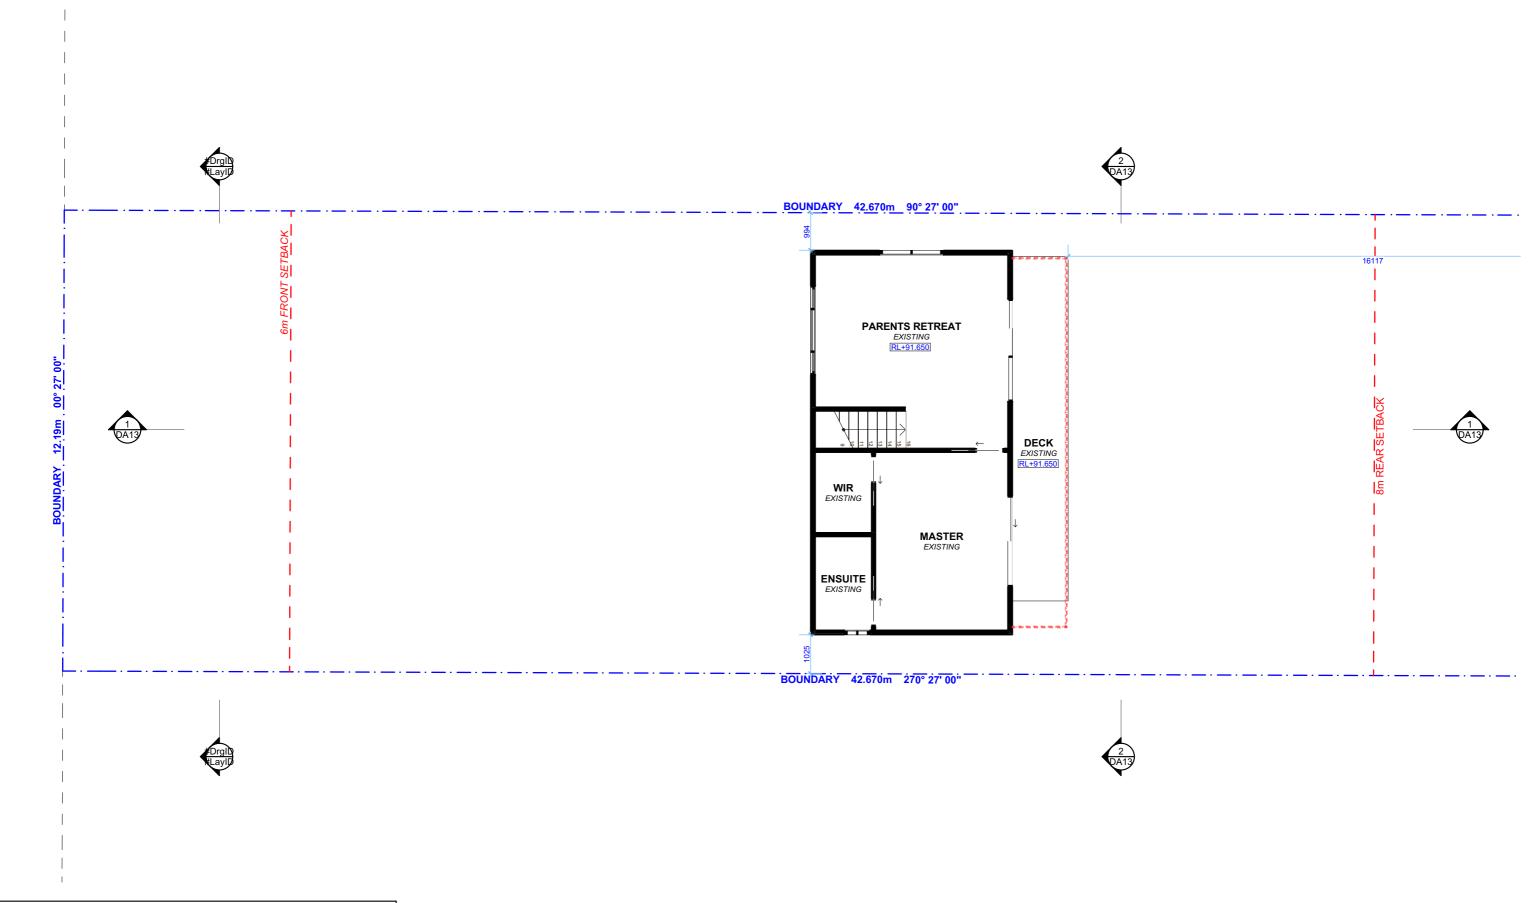
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EXISTING GROUND FLOOR PLAN

# SCALE

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# LEGEND

**EXISTING** PROPOSED --- DEMOLISHED

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39 PRINCE EDWARD ROAD, SEAFORTH NSW 2092

# DRAWING NO.

**DA06** 

SCALE


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DRAWING NAME EXISTING FIRST FLOOR PLAN







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# **EXISTING** PROPOSED --- DEMOLISHED
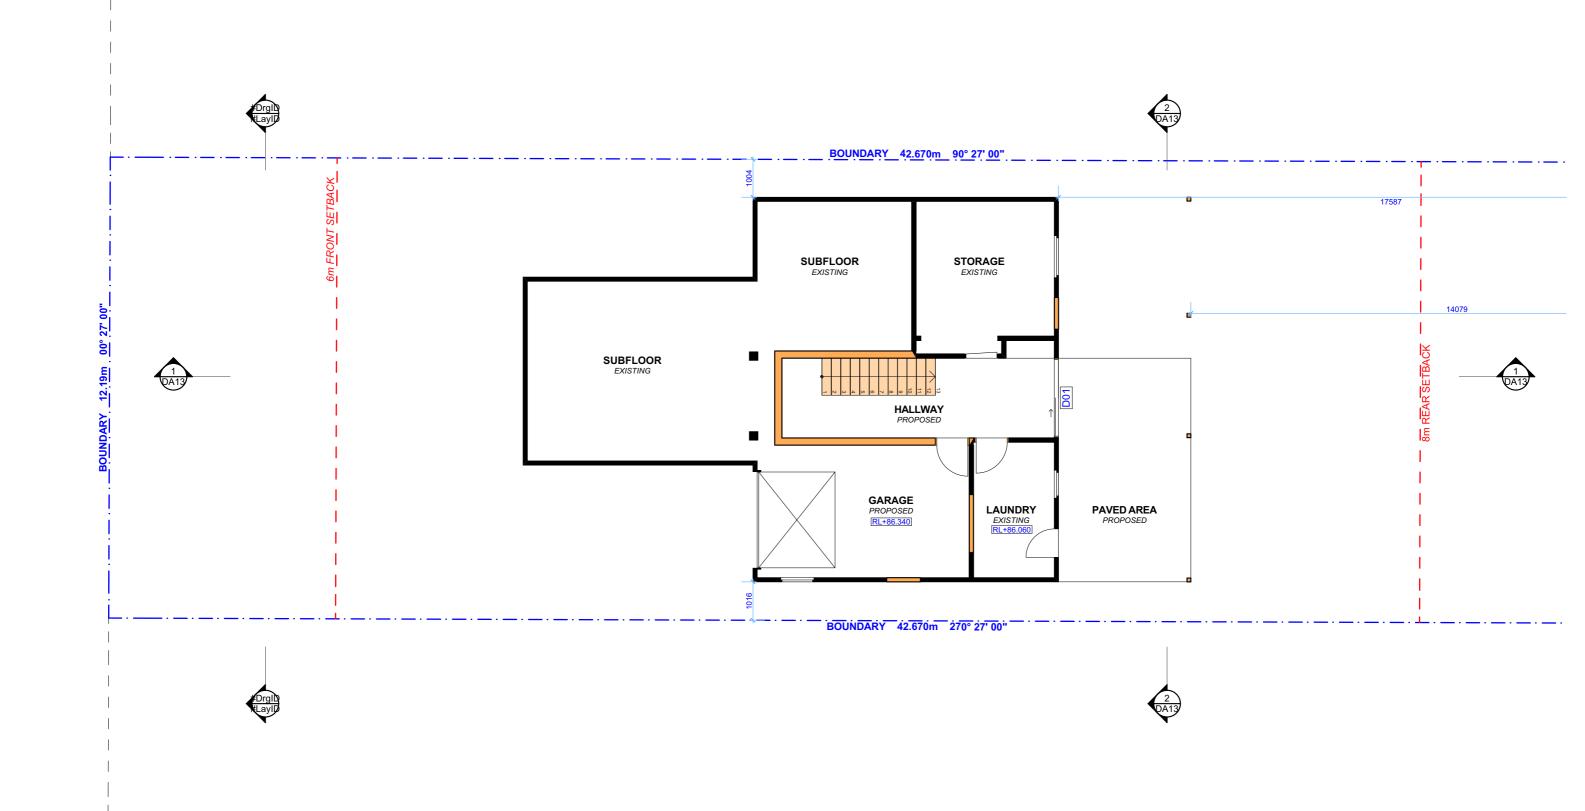
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# DRAWING NO.

**DA07** 

# DATE

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# DRAWING NAME

PROPOSED GARAGE FLOOR PLAN

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# CLIENT

CHRIS & SUSIE McCALL

# PROJECT ADDRESS 39 PRINCE EDWARD

ROAD, SEAFORTH NSW 2092

# DRAWING NO.

**DA08** 

# DATE


Tuesday, 17 November 2020

# DRAWING NAME

PROPOSED GROUND FLOOR

PLAN

SCALE 1:100 @A3

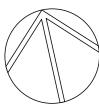





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REV.	DATE	COMMENTS	DRWN	NO This
А	31/01/2020	INITIAL DESIGN PLAN	AL	alte
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# CLIENT

CHRIS & SUSIE McCALL

# PROJECT ADDRESS 39 PRINCE EDWARD ROAD, SEAFORTH NSW 2092

**DA09** DATE


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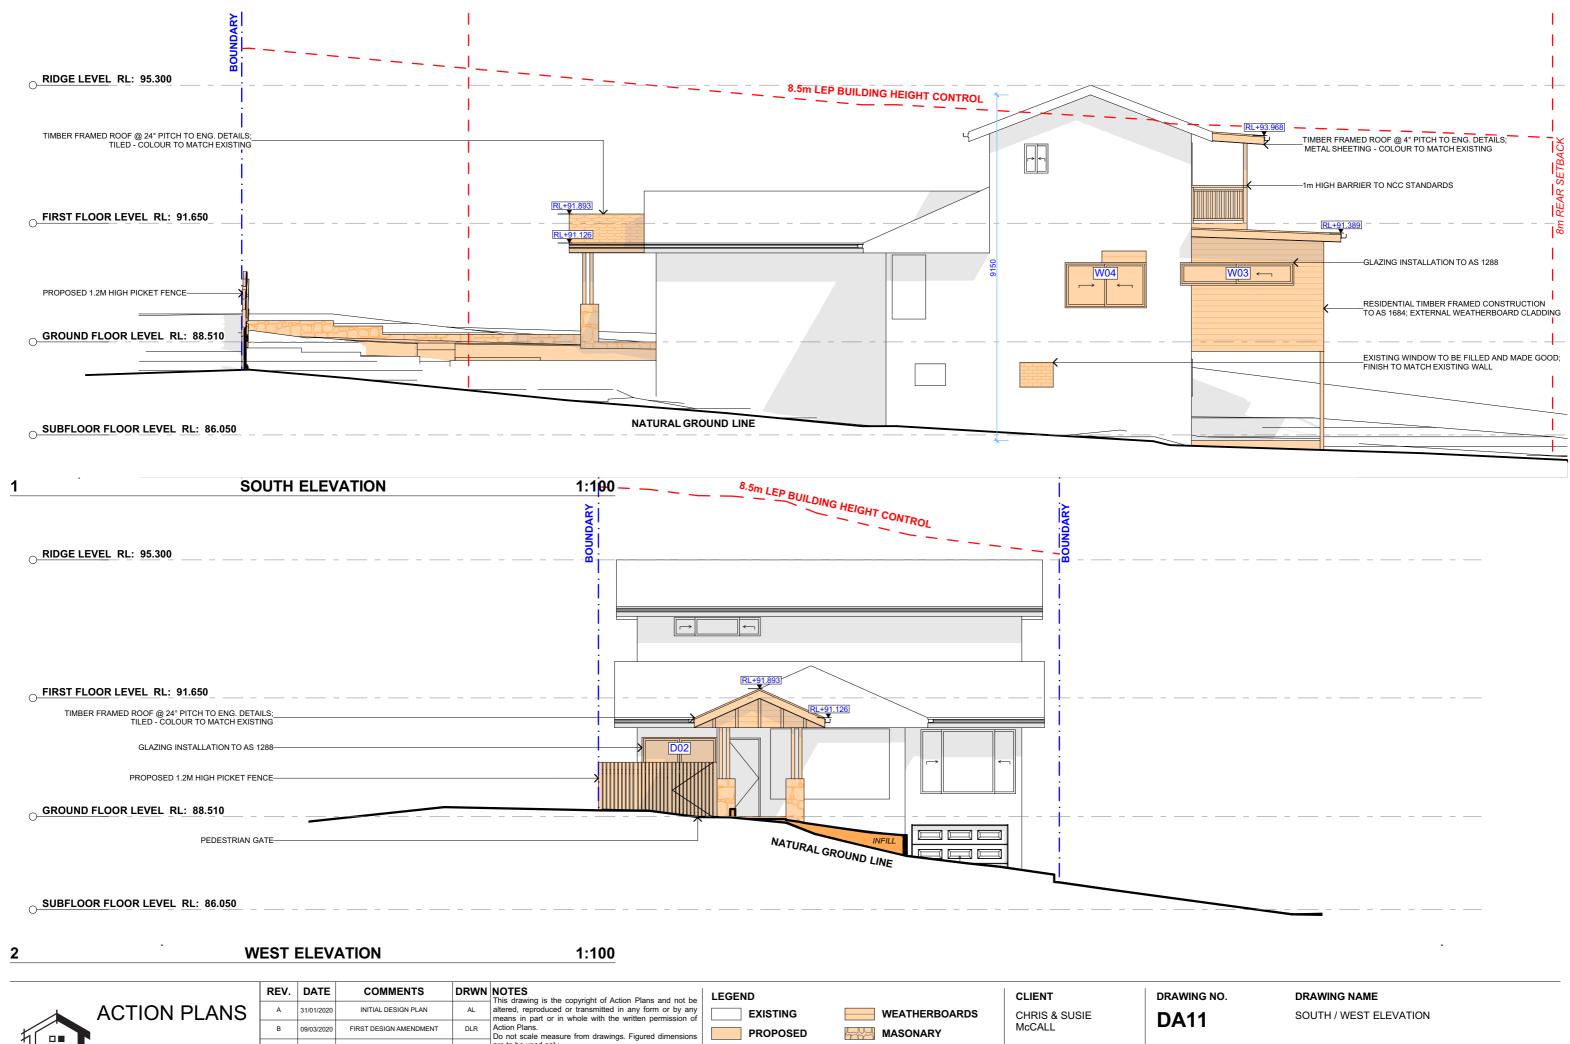
Tuesday, 17 November 2020

DRAWING NAME PROPOSED FIRST FLOOR PLAN








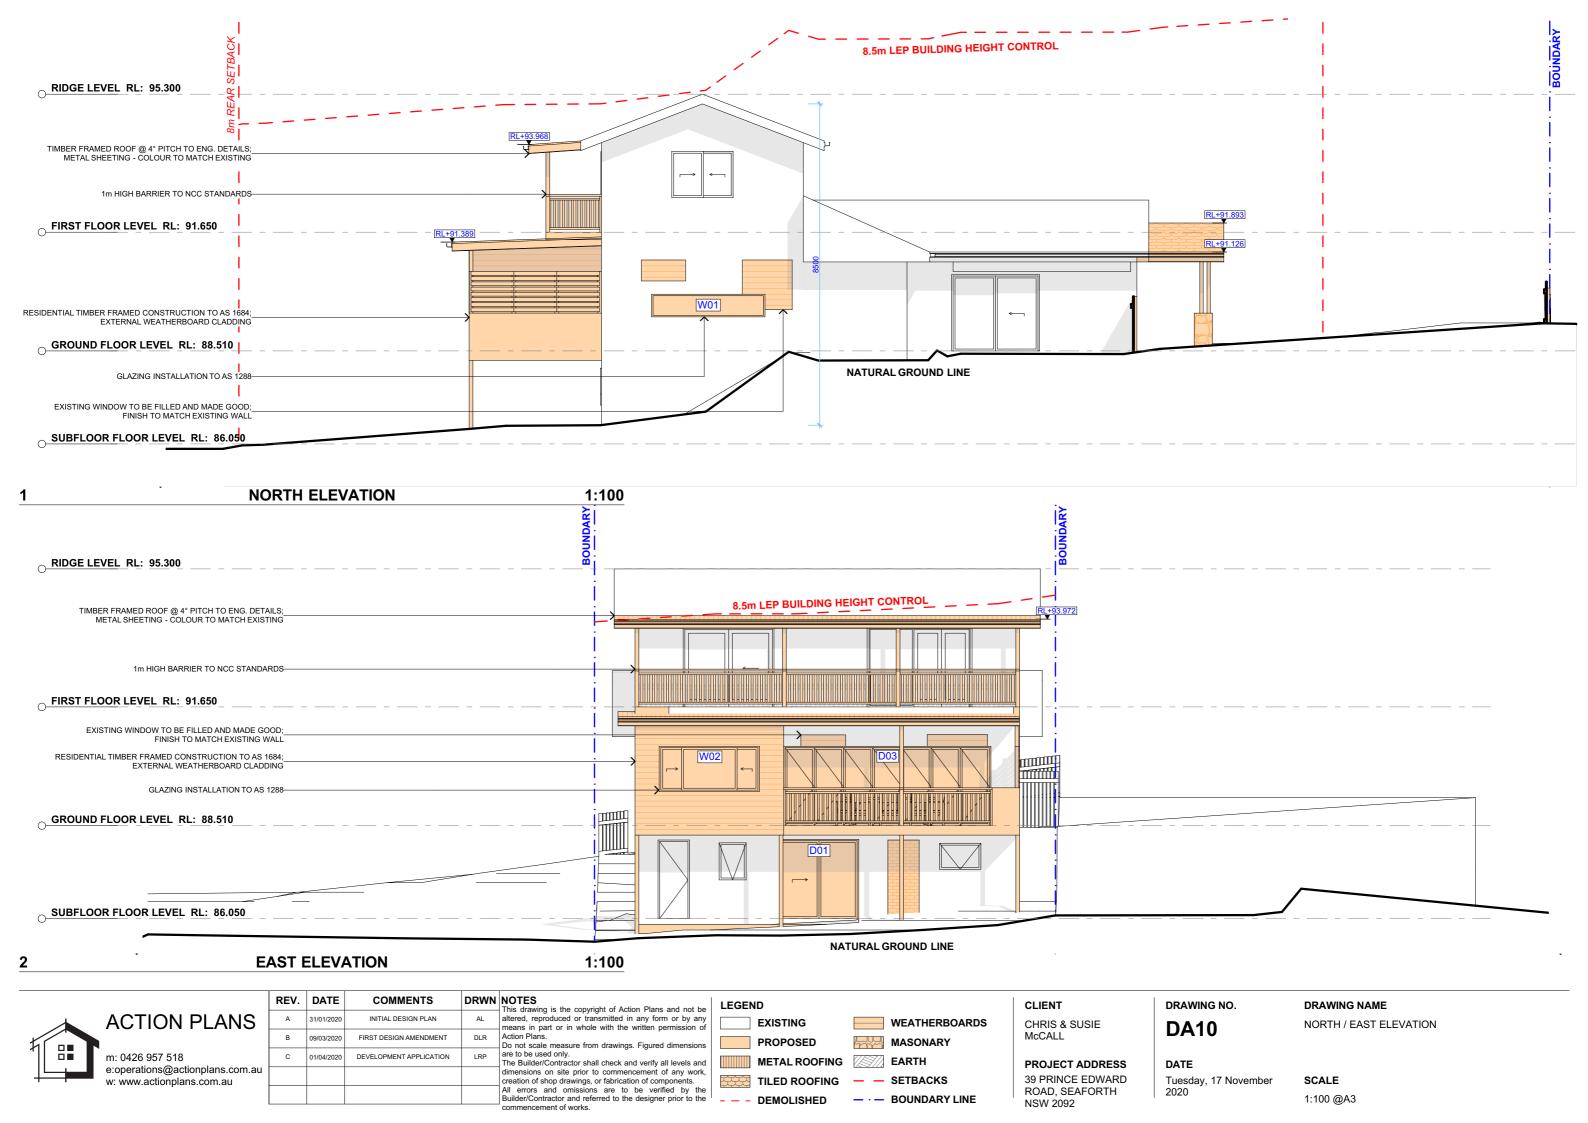





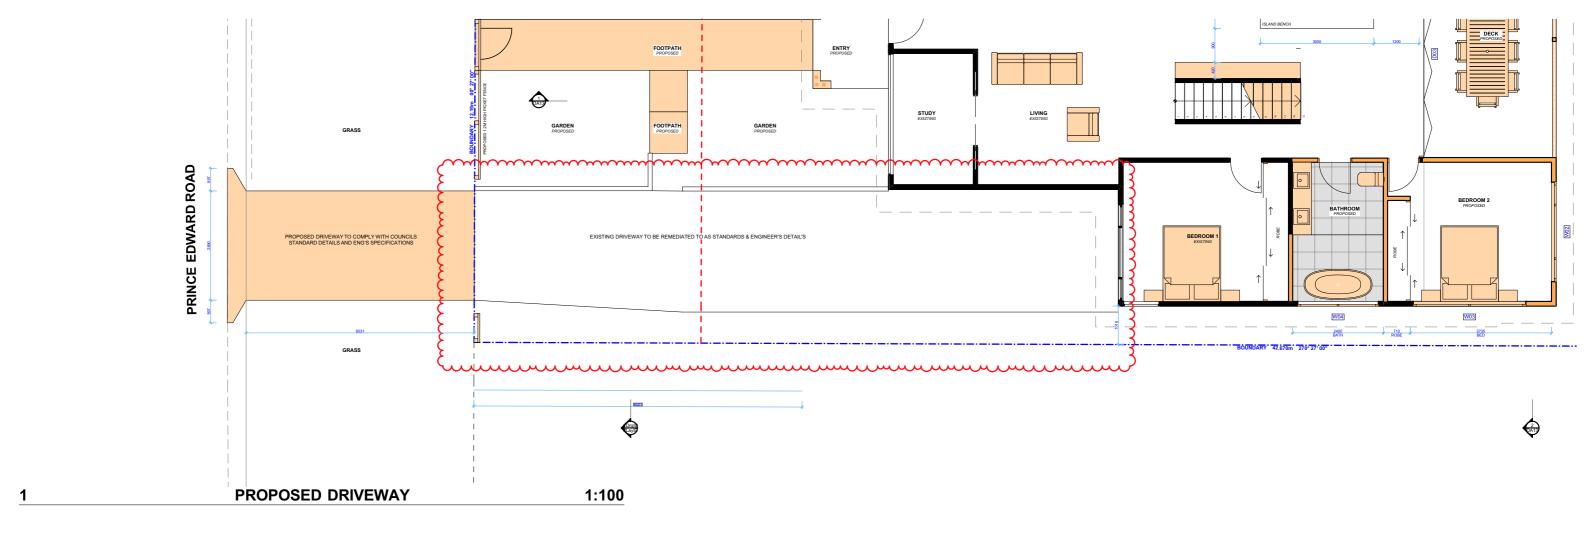



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С	01/04/2020	DEVELOPMENT APPLICATION	LRP	are to be used only. The Builder/Contractor shall
				dimensions on site prior to creation of shop drawings, of All errors and omissions
				Builder/Contractor and refer commencement of works.

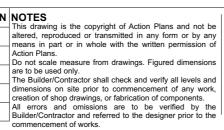

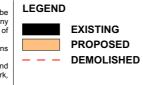

CLIENT CHRIS & SUSIE McCALL

PROJECT ADDRESS 39 PRINCE EDWARD ROAD, SEAFORTH NSW 2092 DA12

**12** PF

DATE

Tuesday, 17 November 2020


DRAWING NAME


SCALE

1:100 @A3

PROPOSED DRIVEWAY PLAN



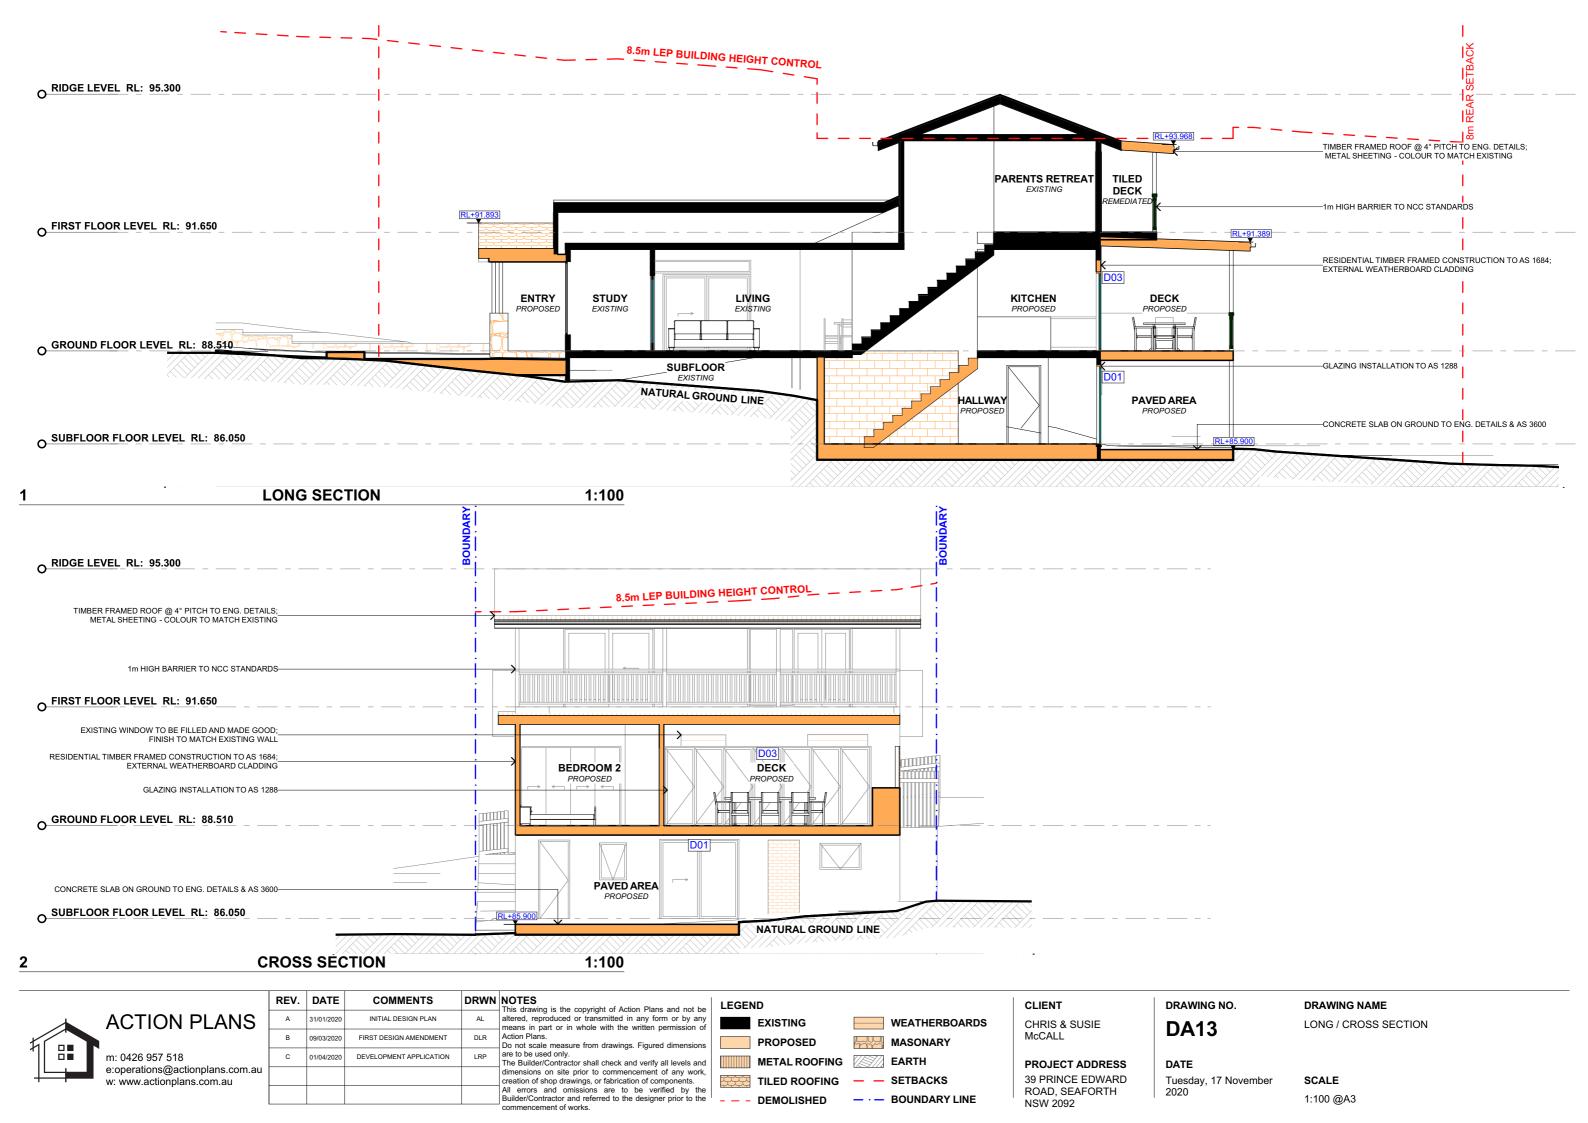

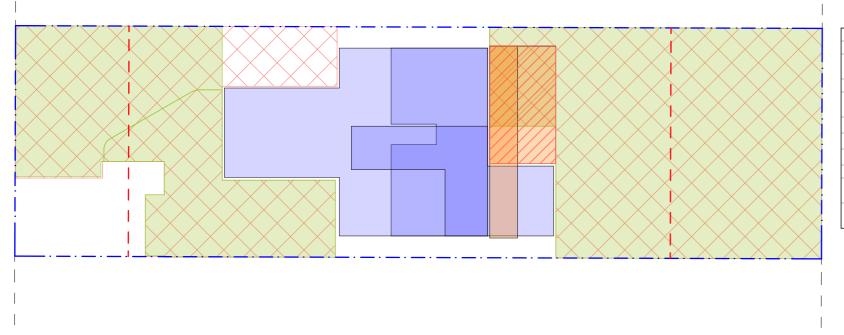

SITE AREA	518.50m <sup>2</sup>			
FRONTAGE	12.19m			
CONTROLO	PERMISSIBLE / REQUIRED	EXISTING	PROPOSED	COMPLIANCE
CONTROLS	m / m² / %	m / m² / %	m / m² / %	
MINIMUM LOT SIZE	500m²	518.50m <sup>2</sup>	UNCHANGED	YES
FLOOR SPACE RATIO	0:45 : 1 (233.325m²)	0.31 : 1 (162.03m²)	0.37 : 1 (191.96m²)	YES
DCP				
RESIDENTIAL OPEN SPACE	AREA OS3			
TOTAL OPEN SPACE (TOS)	55% (285.175m²)	392.52m² (75%)	334.5m² (64%)	YES
LANDSCAPE AREA	35% OF TOS (55%) : 99.81m <sup>2</sup>	280.34m²	314.93m <sup>2</sup>	YES
OPEN SPACE ABOVE GROUND	MAX. 40% OF TOS (55%) : 114.07m <sup>2</sup>	13.40m²	31.72m <sup>2</sup>	YES
PRINCIPAL PRIVATE OPEN SPACE	18m²	0m²	21.84m²	YES

PROPOSED AREA CALCULATIONS

1:200

MT-01 COLOURBOND METAL ROOF SHEETING POWDERCOAT FINISH 'IRONSTONE' OR SIMILAR WHERE MARKED ON ELEVATION.



ALUMINIUM BIFOLD DOOR FRAME POWDERCOAT FINISH 'BLACK' OR SIMILAR WHERE MARKED ON ELEVATION.

POWDERCOAT FINISH 'BLACK' OR SIMILAR WHERE MARKED ON ELEVATION.

ALUMINIUM WINDOW FRAME

**SAMPLE BOARD** 

**ACTION PLANS** 

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DRAWING NO.

**DA14** 


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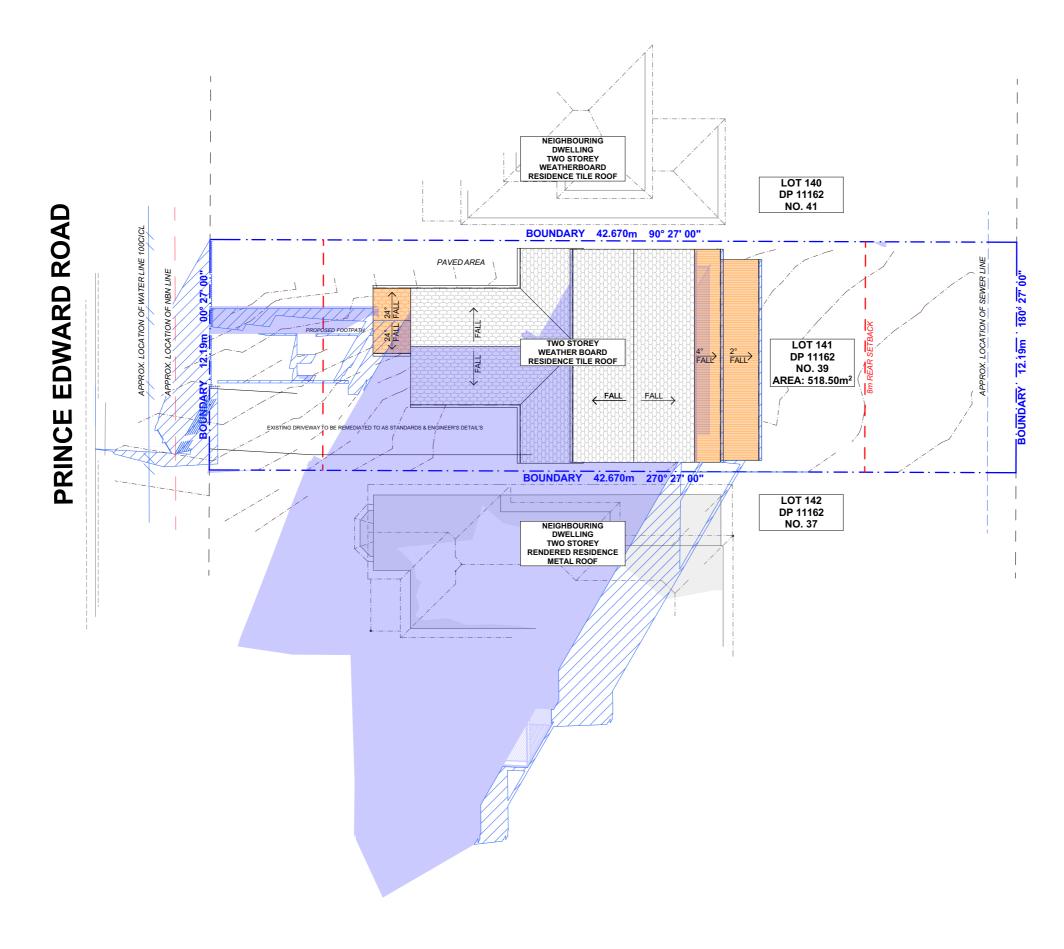
Tuesday, 17 November 2020

DRAWING NAME

AREA CALCULATIONS / SAMPLE BOARD


SCALE 1:200 @A3



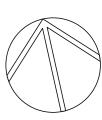



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С	01/04/2020	DEVELOPMENT APPLICATION	LRP	are to be used only. The Builder/Contractor shall check and verify all levels and
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DA15
DATE

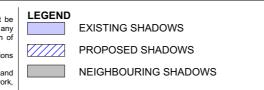
15 WINTER SOLSTICE 9 AM


DRAWING NAME

Tuesday, 17 November 2020

November SCALE


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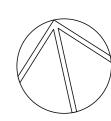
PROJECT ADDRESS 39 PRINCE EDWARD ROAD, SEAFORTH NSW 2092 DRAWING NO.

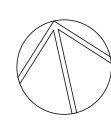
**DA16** 

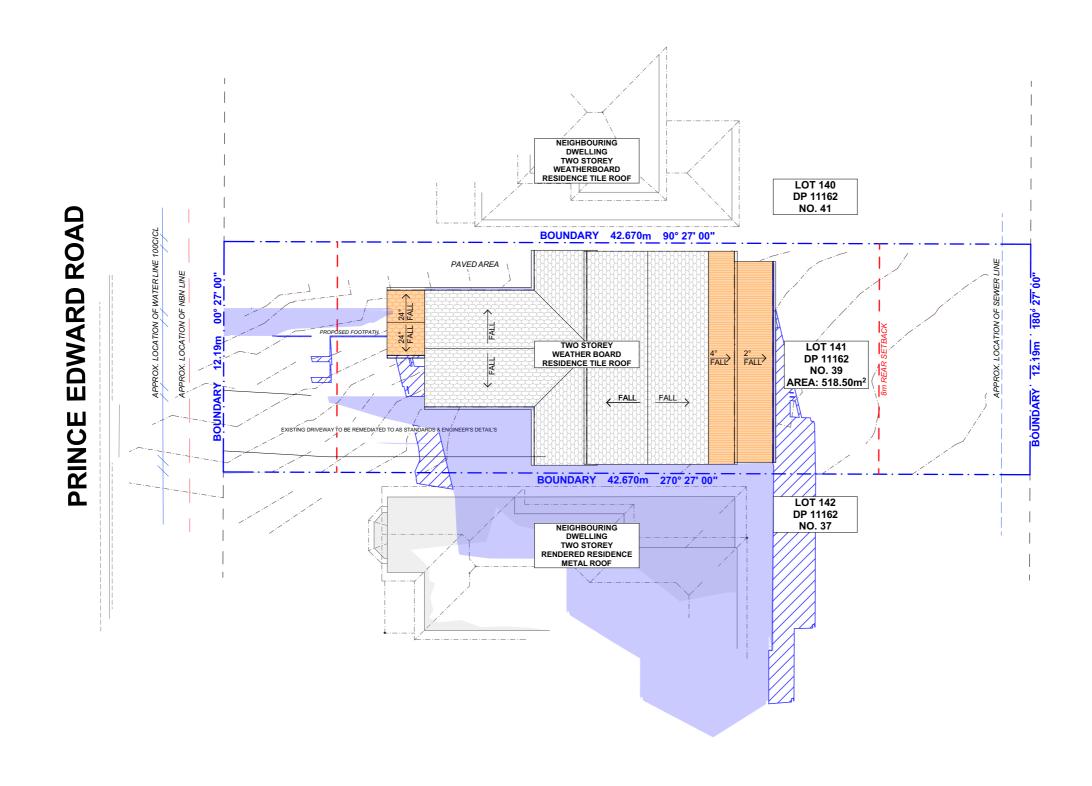WINTER SOLSTICE 12 PM DATE

DRAWING NAME

Tuesday, 17 November 2020 SCALE 1:200 @A3

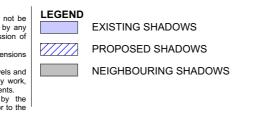

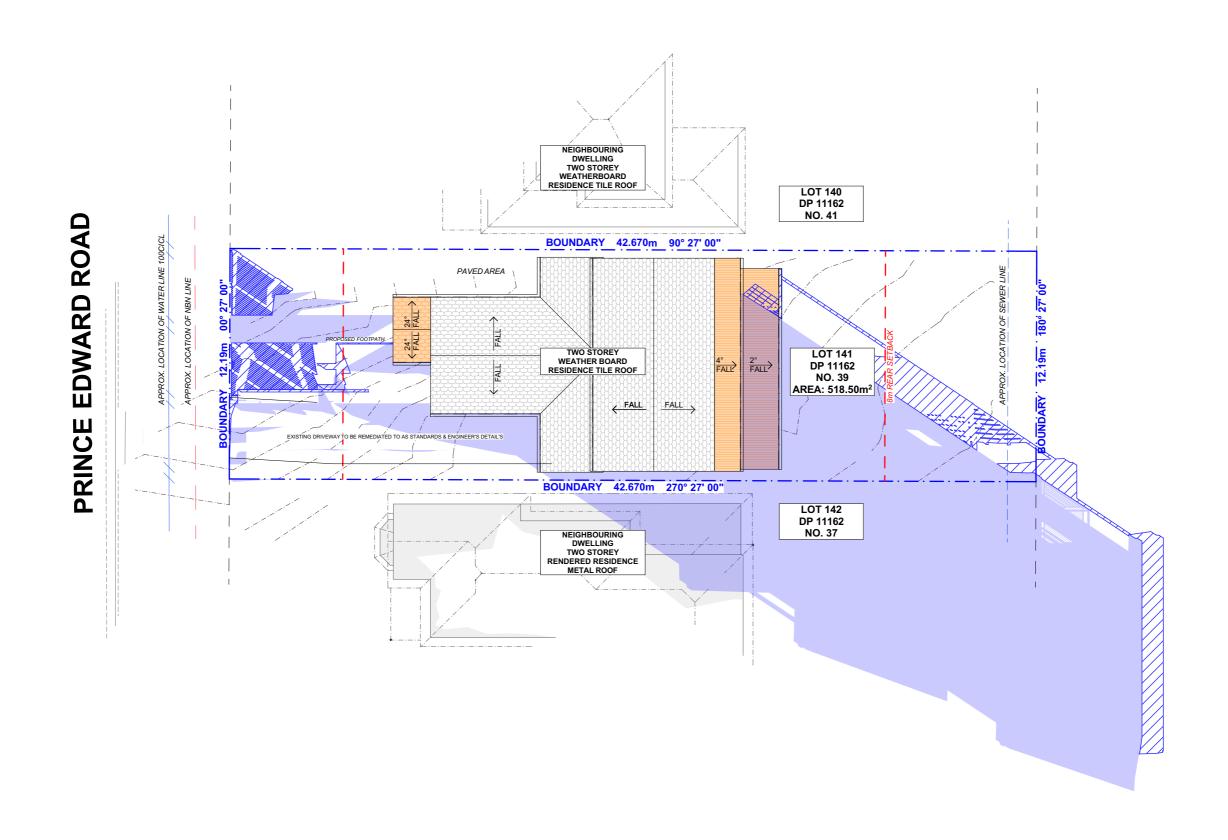




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				dimensions on site prior to con creation of shop drawings, or fab
				All errors and omissions are Builder/Contractor and referred t

commencement of works.

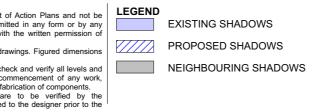

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39 PRINCE EDWARD ROAD, SEAFORTH NSW 2092 DRAWING NO.


DA17

**DATE**Tuesday, 17 November 2020

DRAWING NAME
WINTER SOLSTICE 3 PM

SCALE

1:200 @A3

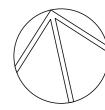



39 PRINCE EDWARD ROAD, SEAFORTH\_02 39 PRINCE EDWARD Road SEAFORTH 2092



Building Sustainability Index www.basix.nsw.gov.au

## **Alterations and Additions**

Certificate number: A373780\_02

Certificate number: A373780_02		Project type	
This certificate confirms that the proposed development will meet the NSW	음	Dwelling type	Separate dwelling house
government's requirements for sustainability, if it is built in accordance with the commitments set out below. Terms used in this certificate, or in the commitments, have the meaning given by the document entitled "BASIX Alterations and Additions	ä	Type of alteration and addition	My renovation work is valued at \$50,000 or more and does not include a pool (and/or spa).
Definitions" dated 06/10/2017 published by the Department. This document is available at www.basix.nsw.gov.au	SCI		
Secretary Date of issue: Tuesday, 27, October 2020 To be valid, this certificate must be lodged within 3 months of the date of issue.	De		
Planning, Industry & Environment			
		Certificate Prepared	by (please complete before submitting to Council or PCA)

project

of

Project name

Lot number

Section numbe

Street address

Plan type and number

Name / Company Name: Action Plans ABN (if applicable): 17118297587

Local Government Area Northern Beaches Council

141

Deposited Plan 11162

BASIX Certificate number: A373780\_02 page 2 / 6

Fixtures and systems	Show on DA Plans	Show on CC/CDC Plans & specs	Certifier Check
Lighting			
The applicant must ensure a minimum of 40% of new or altered light fixtures are fitted with fluorescent, compact fluorescent, or light-emitting-diode (LED) lamps.		<b>✓</b>	<b>~</b>
Fixtures	'	'	'
The applicant must ensure new or altered showerheads have a flow rate no greater than 9 litres per minute or a 3 star water rating.		✓	✓
The applicant must ensure new or altered toilets have a flow rate no greater than 4 litres per average flush or a minimum 3 star water rating.		✓	<b>✓</b>
The applicant must ensure new or altered taps have a flow rate no greater than 9 litres per minute or minimum 3 star water rating.		<b>✓</b>	

BASIX Certificate number: A373780 02 page 3 / 6

Construction			Show on DA Plans	Show on CC/CDC Plans & specs	Certifier Check
nsulation requirements					
		s) in accordance with the specifications listed in struction is less than 2m2, b) insulation specified	✓	✓	~
is not required for parts of altered construction	where insulation already exists.	., .			
is not required for parts of altered construction  Construction		Other specifications			
is not required for parts of altered construction	where insulation already exists.	., .	<u> </u> 		
is not required for parts of altered construction  Construction	where insulation already exists.  Additional insulation required (R-value)	., .	_		

BASIX Certificate number: A373780\_02 page 6 / 6

		1
ea	rai	etel

In these commitments, "applicant" means the person carrying out the development.

Commitments identified with a "\sqrt{"} in the "Show on DA plans" column must be shown on the plans accompanying the development application for the proposed development (if a development application is to be lodged for the proposed development).

Commitments identified with a "\sqrt{"}" in the "Show on CC/CDC plans & specs" column must be shown in the plans and specifications accompanying the application for a construction certificate / complying development certificate for the proposed development.

Commitments identified with a "🗸" in the "Certifier check" column must be certified by a certifying authority as having been fulfilled, before a final occupation certificate for the evelopment may be issued.

./	ACTION PLANS
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	С	01/04/2020	DEVELOPMENT APPLICATION	LRP	All errors and omissions are to be verified by the Builder/Contractor and referred to the designer prior to the comme All window & door dimensions, orientation, glazing materials, opening types, frame types are to be confirmed by a si
					person prior to the ordering of any such materials are to take place. U value takes precedence over glazing type/colour in all cases.
					all new glazing must meet the BASIX specified frame and glass type, <u>QR</u> meet the ecified U value and SHGC value.

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ngs. Figured dimensions are to be used only.

ck and verify all levels and dimensions on site prior to commencement of any work, creation of shop nents.

verified by the Builder/Contractor and referred to the designer prior to the commencement of works. rientation, glazing materials, opening types, frame types are to be confirmed by a suitably qualified y such materials are to take place.

BASIX Certificate number: A373780\_02

	uirements						Show on DA Plans	Show on CC/CDC Plans & specs	Certifier Check
Vindows and	d glazed do	ors							
					nading devices, in accordance with reach window and glazed door.	the specifications listed in the table below.	<b>✓</b>	<b>✓</b>	<b>~</b>
The following r	equirements r	must also	be satisfi	ed in relation	to each window and glazed door:			<b>~</b>	<b>V</b>
have a U-value must be calcula	and a Solar ated in accord	Heat Gair Iance with	Coefficie National	ent (SHGC) r Fenestration	no greater than that listed in the tabl	ar glazing, or toned/air gap/clear glazing must e below. Total system U-values and SHGCs . The description is provided for information		~	<b>~</b>
					each eave, pergola, verandah, baldhan 2400 mm above the sill.	cony or awning must be no more than 500 mm	✓	✓	<b>✓</b>
Pergolas with p	oolycarbonate	roof or si	milar tran	slucent mate	erial must have a shading coefficien	t of less than 0.35.		✓	<b>~</b>
					e window or glazed door above which ens must not be more than 50 mm.	ch they are situated, unless the pergola also		<b>✓</b>	<b>V</b>
				_			-		
					-	Frame and along type	_		
Windows ar Window / door no.			Oversha Height (m)		nts Shading device	Frame and glass type			
Window / door		Area of glass inc. frame	Oversha Height	dowing Distance	-	Frame and glass type standard aluminium, single pyrolytic low-e, (U-value: 5.7, SHGC: 0.47)			
Window / door no.	Orientation	Area of glass inc. frame (m2)	Oversha Height (m)	Distance (m)	Shading device eave/verandah/pergola/balcony	standard aluminium, single pyrolytic low-e,			
Window / door no. W01	Orientation  N	Area of glass inc. frame (m2)	Oversha Height (m)	dowing Distance (m)	eave/verandah/pergola/balcony >=600 mm eave/verandah/pergola/balcony	standard aluminium, single pyrolytic low-e, (U-value: 5.7, SHGC: 0.47) standard aluminium, single pyrolytic low-e,			
Window / door no. W01 W02	Orientation  N  E	Area of glass inc. frame (m2) 1.8 3.18	Oversha Height (m)  0	dowing Distance (m)  0	eave/verandah/pergola/balcony >=600 mm eave/verandah/pergola/balcony >=600 mm eave/verandah/pergola/balcony	standard aluminium, single pyrolytic low-e, (U-value: 5.7, SHGC: 0.47) standard aluminium, single pyrolytic low-e, (U-value: 5.7, SHGC: 0.47) standard aluminium, single pyrolytic low-e,			

BASIX Certificate number: A373780 02 page 5 / 6

Glazing requirements							Show on DA Plans	Show on CC/CDC Plans & specs	Certifier Check
Window / door no.	Orientation	Area of glass inc. frame (m2)	Oversha Height (m)	Distance (m)	Shading device	Frame and glass type			
D02	W	4.17	0	0	eave/verandah/pergola/balcony >=600 mm	standard aluminium, single pyrolytic low-e, (U-value: 5.7, SHGC: 0.47)			
D03	E	11.51	0	0	eave/verandah/pergola/balcony >=900 mm	standard aluminium, single pyrolytic low-e, (U-value: 5.7, SHGC: 0.47)			

DRAWING NO.

CHRIS & SUSIE McCALL

CLIENT

PROJECT ADDRESS 39 PRINCE EDWARD ROAD, SEAFORTH NSW 2092

**DA18** 

DRAWING NAME BASIX COMMITMENTS

DATE 2020

Tuesday, 17 November