

MAY 2018 - A - CHIMNEY ADDED

All structure including stormwater & drainage to engineers details Do not obtain dimensions by scaling drawings All dimensions are to be checked on site prior to starting work. These drawings are to be read in conjunction with all other consultants drawings & specifications

drawings & specifications

All workmanship &materials shall be in accordance with the requirements of current editions including amendments of the relevant SAA Codes of Practice, the Building Code of Australia & locments

 New materials are to be used throughout unless otherwise noted
 Concrete footings slab, structural beams or any other structural members are to be designed & endorsed by a practising engineer

JJDrafting

PO Box 687 Dee Why 2099 M - 0414 717 541

Email - jjdraft a tpg com au

174 Garden St. North Narrabeen 2101


Project: MOD FICATION SEC 4.55
PROPOSED ALTERATIONS AND ADDITIONS
TO AN EXISTING DWELING AT
17 MINKARA RD. BAYVIEW

Title: ELEVATIONS

Scale: 1:100, 1:200 Date: September 2015

Job No. : 489/15

Dwg No. DA 4A

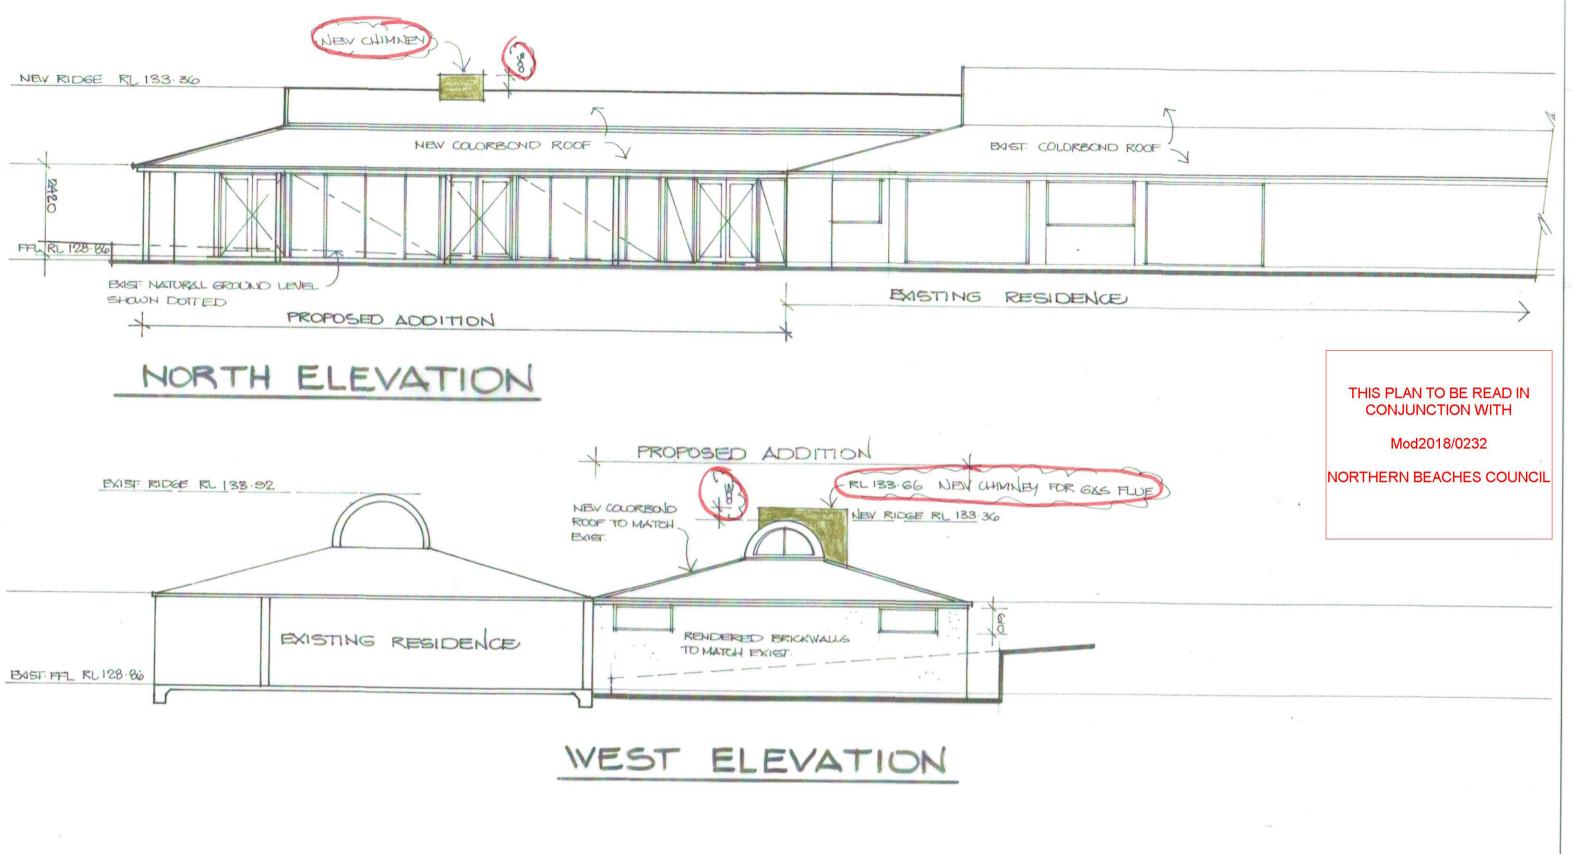

AMENDMENT

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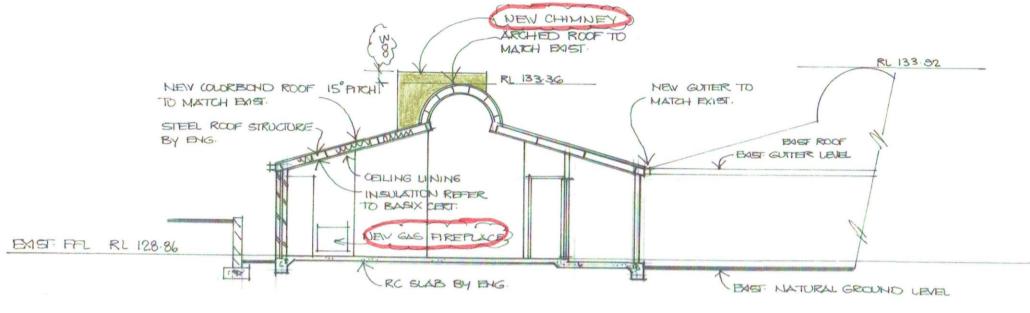
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SECTION A - A

NOTE

Additions and alterations are to be read in conjunction and comply with the BASIX certificate, bushfire and geo tech report

BASIX COMMITMENTS

WATER

SHOWER RATING - Minimum 3 STAR
TAP RATING - Minimum 3 STAR
WC'S RATING - Minimum 3 STAR

INSULATION REQUIREMENTS

- External wall Double Brick -----Nil
- Concrete slab on ground -----Nil
- · Ceiling and roof -

flat ceiling/ pitched roof - ceiling R1.75(up)

Roof - foil/sarking

Raked ceiling, pitched/skillion roof: framed - Ceiling R1.76 (up), Roof-foil/sarking

LIGHTING REQUIREMENTS

40% of new or altered light fixtures to be fitted with fluorescent, compact fluorescent, or light-emitting-diode(LED) lamps

WINDOE AND DOOR SCHEDULE - REFER TO BASIX CERTIFICATE

1-----1570 x 610h- low E

2-----1570 x 610h- low E

3, 4, 5, 7 --- 4000 x 1040h-single clear

6-----1200 x 610h-single clear

8-----5400 x 2400h-single clear

9, 11-----1810 x 2400h-single clear

10, 12-----4000 x 2400h- single clear

13----3300 x 2400h-single clear

14-----1570 x 2400h-single clear

All window and door sizes are to be verified on site before ordering

MAY 2018- A - CHIMNEY AND
FREPLACE ADDED

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THIS PLAN TO BE READ IN CONJUNCTION WITH

Mod2018/0232

NORTHERN BEACHES COUNCIL

SPECIFICATION NOTES

EXTERNAL WALLS

- Double brick walls finished off with render to match existing DOORS AND WINDOWS
- · Alum. frame windows & doors
- Weather stripping is to be provided to all external windows & doors.

FLOORS

- Concrete slab
- Tiles on a waterproof membrane to bathrooms and ensuites ROOFING

Colorbond roof to match existing

- BATHROOMS and ENSUITES

 All waterproofing to AS 3740
- Provide a guaranteed flexible waterproof membrane to all wet area floors &shower walls to manufacturers instructions

STORMWATER

New downpipes to be connected into existing rainwater tanks

GUTTERS AND DOWNPIPES

- Colorbond gutters and downpipes
- Minimum slope of eaves and gutters 1:200

FLASHING AND CAPPINGS

- Selection and installation of metal rainwater goods refer to AS 2180
- Flash projections above the roof with two part flashings consisting of an apron flashing & over flashing, with at least 100mm overlap.

 Provide for independent movement between roof and projection.

TERMITE CONTROL

To AS 3660.1

TIMBER FRAMING

- Use treated timber where required for durability
- Do not use timber unsuitable for exposure to moisture in exposed location
- All workmanship & materials shall be in accordance with AS 1684 and 1720 as applicable
- Provide structure bracing in accordance with AS 1684
- Provide structure tie down in accordance with AS 1684 use galvanised fixings where exposed to weather.

CONCRETE

- All workmanship &materials shall be in accordance with current editions of the AS 3600
- Footings to be in accordance with AS 1480
- All reinforcement shall conform to AS 1302, AS 1303 & AS 1304

INTERNAL LININGS

Provide plasterboard lining

SMOKE ALARMS

Connect to consumer mains power & install to AS 1670.6. 1997
 (Fire detection, warning control & intercom systems- systems design, installation & commissioning- Smoke Alarms) & AS 3786- 1996 (Smoke Alarms)

LIGHTING

- Provide fluorescent, compact fluorescent, or light-emitting-diode(LED) lamps
 WASTE MANAGEMENT
- All waste shall be taken away by trucks to a suitable landfill or recycle depot.
- All waste shall be covered during transportation.
- Waste generated during construction shall be placed in steel bins & taken away by an approved contractor to an approved land fill site

ERVICES

- All services are existing and shall be connected to the proposed new additions.
 SEDIMENT CONTROL
- A filter cloth system shall be installed to stop any sediment entering councils stormwater system

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