





RK DESIGNS

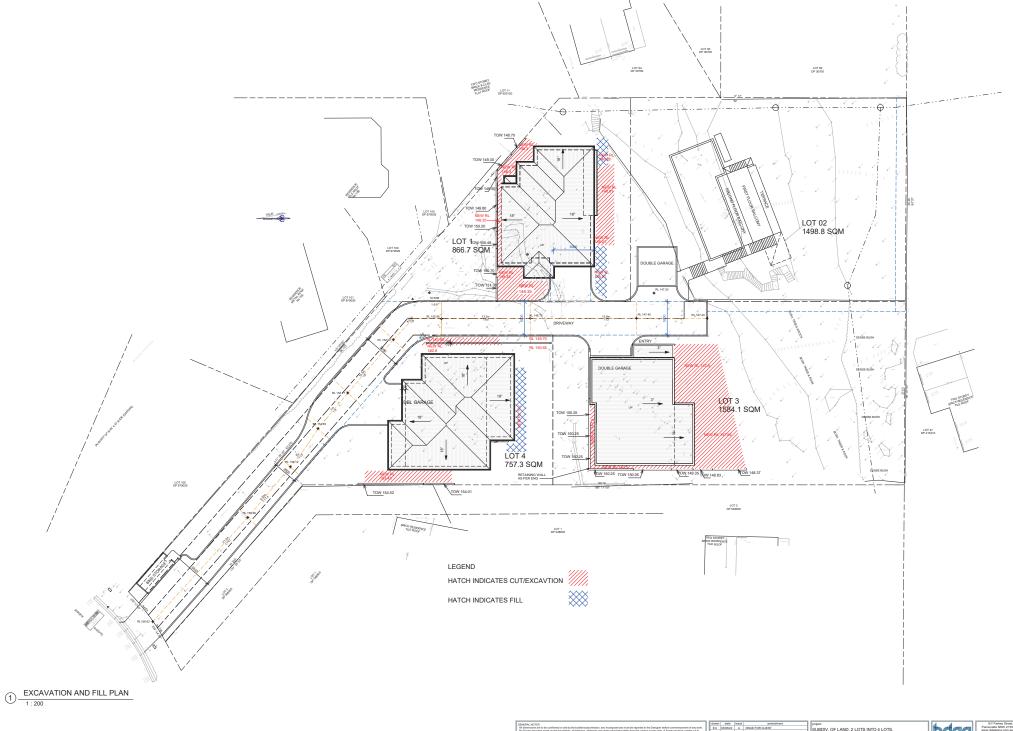

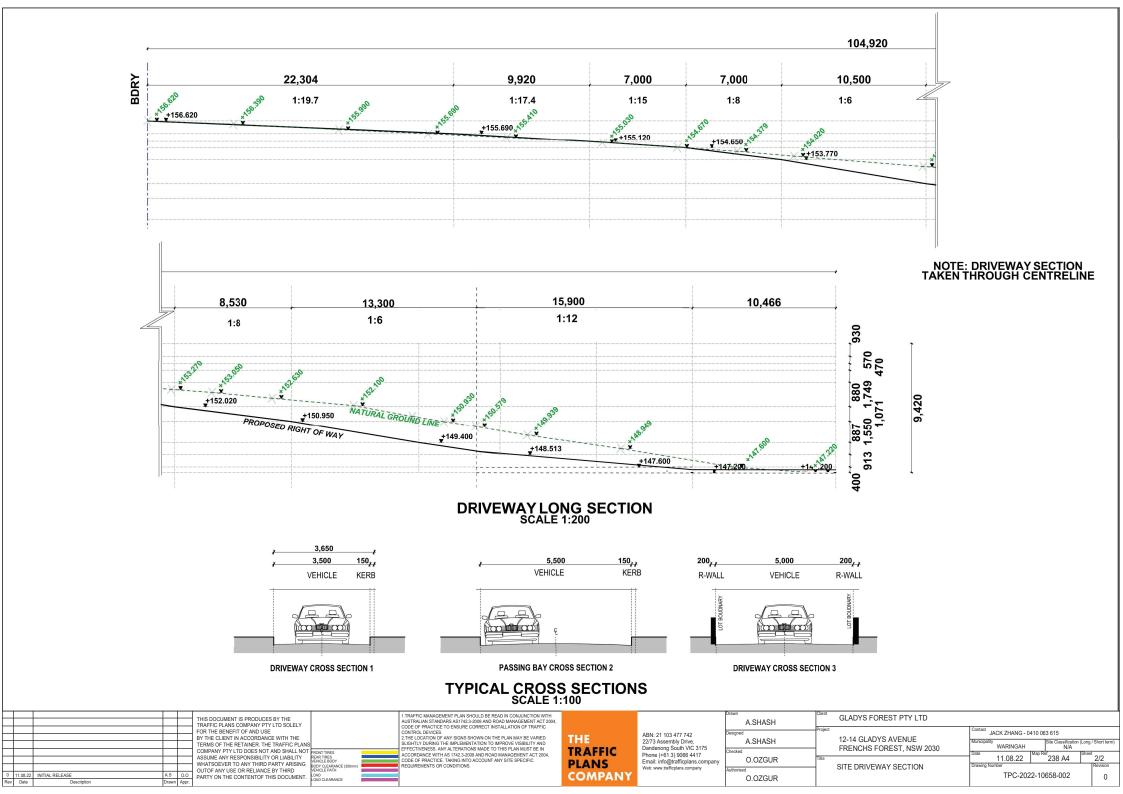

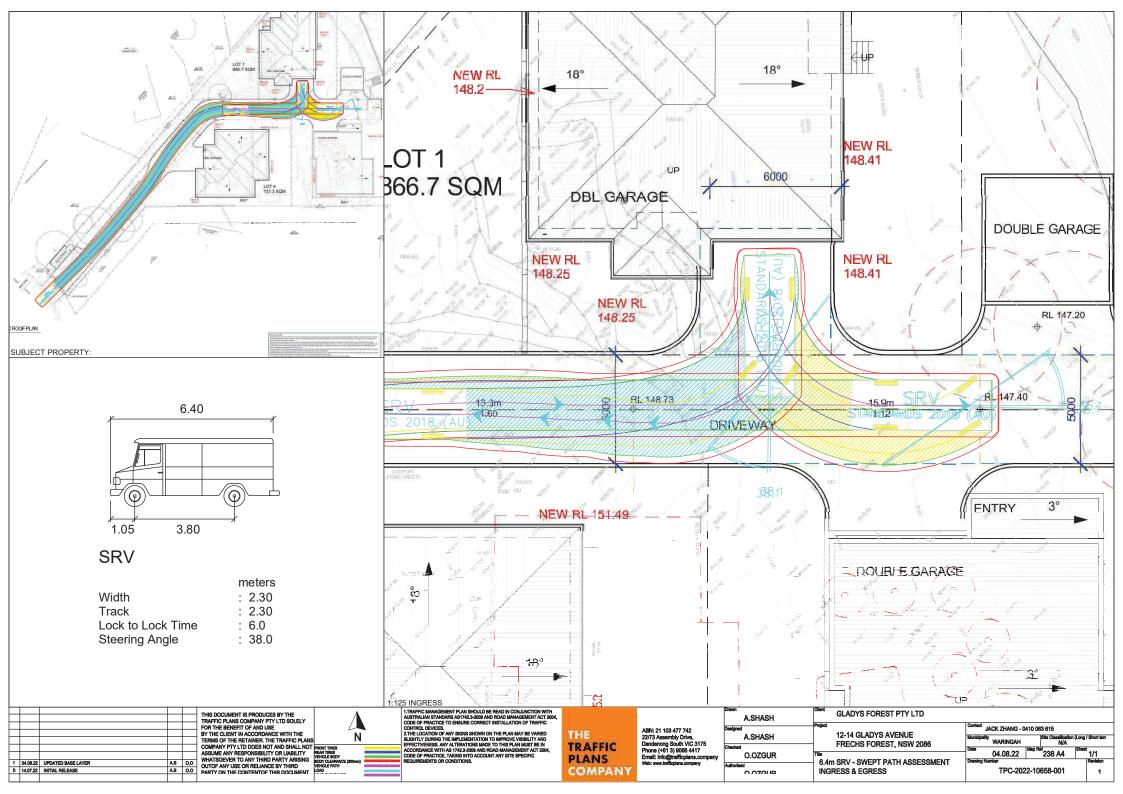



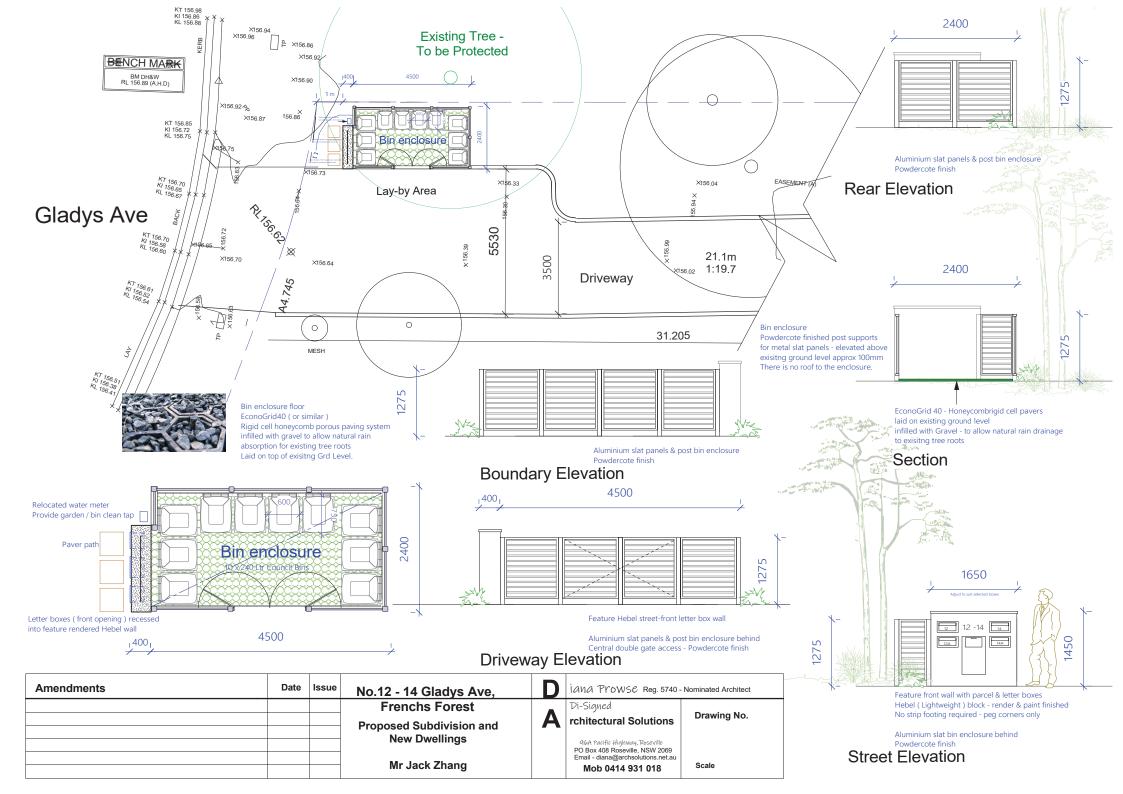




ECONOGRID 40TM
POROUS PAVER GRAVEL FINISH


to meet the demands and loadings imposed across a wide range of end requirements and site conditions path. EconoGrid 40 plastic paving grids have been designed using carefully selected recycled plastics, especially in providing a stable, free draining pavement surface that retains gravel in situ. The application might be a gravel car park, an emergency access route or wheel chair / disabled access EconoGrid 40 is a porous paver that can provide a solution to a wide range of trafficking needs,

Applications:

- Gravel car parking
- Overflow car parks
- Wheelchair / disabled access paths
- Free draining pedestrian paths
- Fire access roads / lanes
- Cycle paths
- Access routes and roads
- Drives and driveways

EconoGrid 40 porous plastic pavers can be filled with a 5mm to 20mm mixed sharp angular aggregate/ gravel to give a very stable, hardworking and free draining working surface. The design of EconoGrid 40 plastic porous pavers allows excellent interlock with the gravel resisting and negating dynamic and lateral loadings so the gravel and paver remains in situ with little or no maintenance requirements.

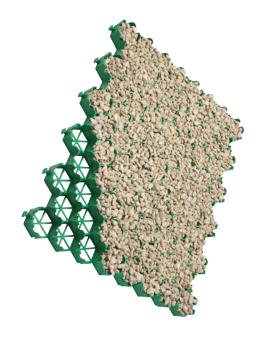

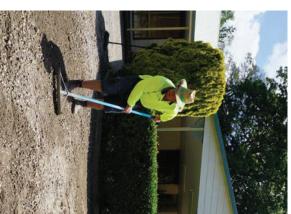







For technical and installation information visit: www.grassreinforcement.com.au/econogrid-40




The retained gravel finish, when installed correctly, will provide a hard-wearing, robust and permeable free draining surface that would have an expected lifetime of many years. Please see our installation and design guidance documents for further information.

EconoGrid 40 porous pavers are supplied in easy to handle square grids which interlock with adjacent paving grids to create a stable and robust surface. The plastic pavers have a 40mm deep open honeycomb structure which promotes and allows excellent interlock between angular stone/gravel particles where a gravel pavement is required.

EconoGrid 40 paving grids have been manufactured using specially selected 100% recycled plastics that have the qualities that are required for a strong, long-lasting, stable product suitable for the designed traffic load. These include:

- UV stabilisation to stop degradation by sunlight.
- Tested to 150T/m², capable of withstanding cars, vans, trucks and lorries
- Paver profile allows expansion on warmer days or in direct sunlight when required to stop lifting
- Plastic selection to allow use in cold temperatures – some plastic will become fragile when cold
- Open structure to allow unhindered water permeability
- Paver design maximises support and stability from either a gravel or a grass root structure
- All plastics used are stable, chemically inert and are not toxic so are suitable for normal soil conditions

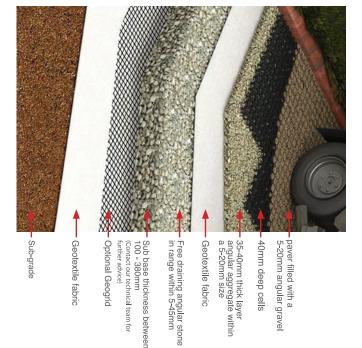

EconoGrid 40 porous plastic paving grids have been designed to meet the demands laid down by local government regarding flood alleviation and WSUD requirements (Water Sensitive Urban Design). EconoGrid 40 pavers provide a porous / permeable pavement surface that allows rainwater / flood water to infiltrate through the paver surface and fill material into the subgrade below. EconoGrid 40 can be used as part of a source control layer within a WSUD design.



Product Range

Laid size for 4 grids cover 1m²

Econogrid 40	Product
638mmx532mm	Size (outer)
ω	Grid per m² laid
40mm	Paver Cell Depth
150T/m²	Load bearing Strength Capacity
100% Recycled PP/PE	Material
Green	Colour





1 SITE LOCATION PLAN

NOTE SITE ANALYSIS PLAN IS TO BE READ IN CONJUNCTION WITH THE ARCHITECTURAL DRAWINGS. THE SHADOW DIAGRAM PLANS AND THE STATEMENT OF ENVIRONMENTAL EFFECTS. INCLUSIVE OF THE PHOTOGRAPHS & THE STREETSCAPE ELEVATION.


GENERAL NOTES
. All dimensions are to be confirmed on site by the builderhubcontractor, any incongruencies must be reported to the Designer before commencement of any wor. No Survey has been made on the boundaries, all bearings, distances and areas have been taken from the contour survey plan. A Survey must be carried out to confirm the exact boundary locations.
. No construction work shall commence until a site survey confirming the site boundaries has been completed. The contractor is to ensure that the boundary setbacks are confirmed and used, the boundary setbacks take precedence over all other dimensions. The Survey work must be performed by a registered Survey. In the wester of encountering and discrepancies on these drawners, excellentaries to subsequent instructions issued. The subsection should be suited.
designer before proceeding further with any work.
. All construction, control joints and expansion joints in the wall, floors, other locations shall be in strict accordance with the Structural Engineering details. No join
or breaks other than specified, are allowed without written permission from the Engineer. Measurements for the fabrication of secondary components such as, windows, doors, internal frames, structural steel components and the like, are not to be tak
from these documents. Measurements must be taken on site to suit the work as constructed.

2 2 2 2	A B C D	armadeneré ISSUE FOR CLEHT PREVISION B ISSUE FOR DA ISSUE FOR DA	SUBDIV. OF LAND, 2 LOTS INTO 4 LOTS, PROP. CONSTRUCT. OF 3 X 2 STRY DWELLING: 12-14 GLADYS AVENUE, FRENCHS FOREST, NO	ACCREDITED BUILDING DESIGNER		
			JACK ZHANG		drawing SITE LOCATION PLAN project no date sheet no. sc	

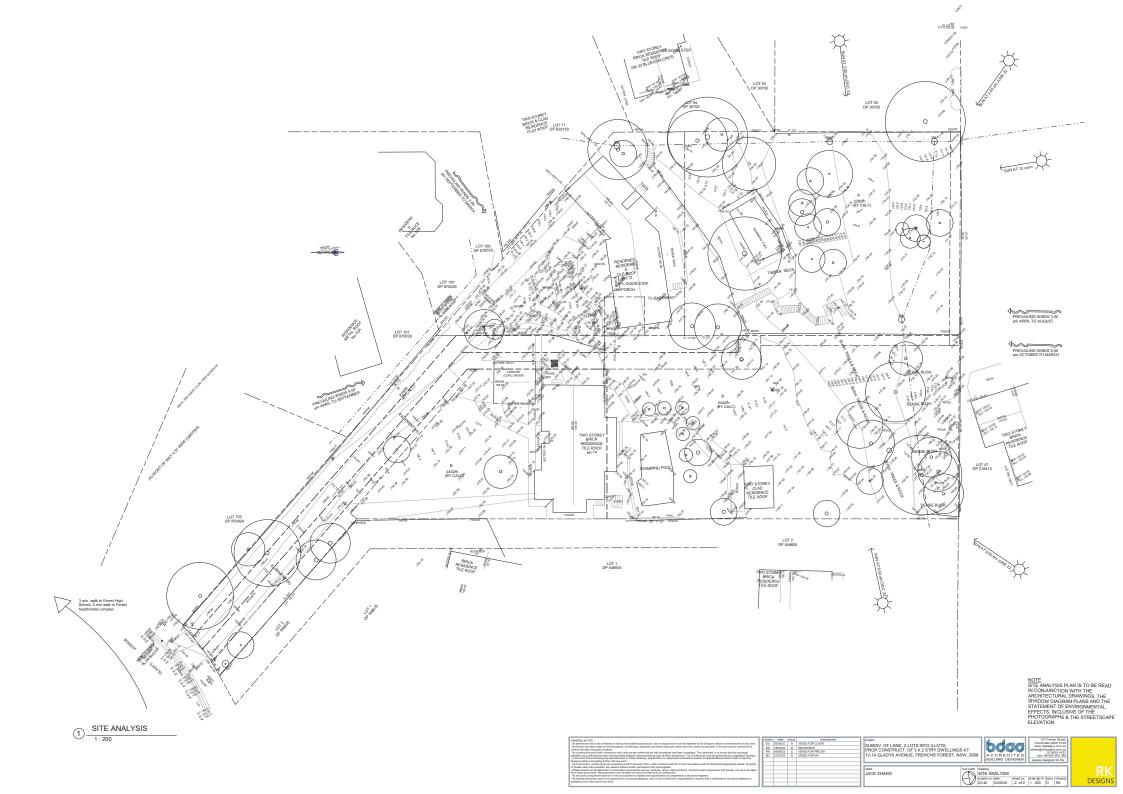


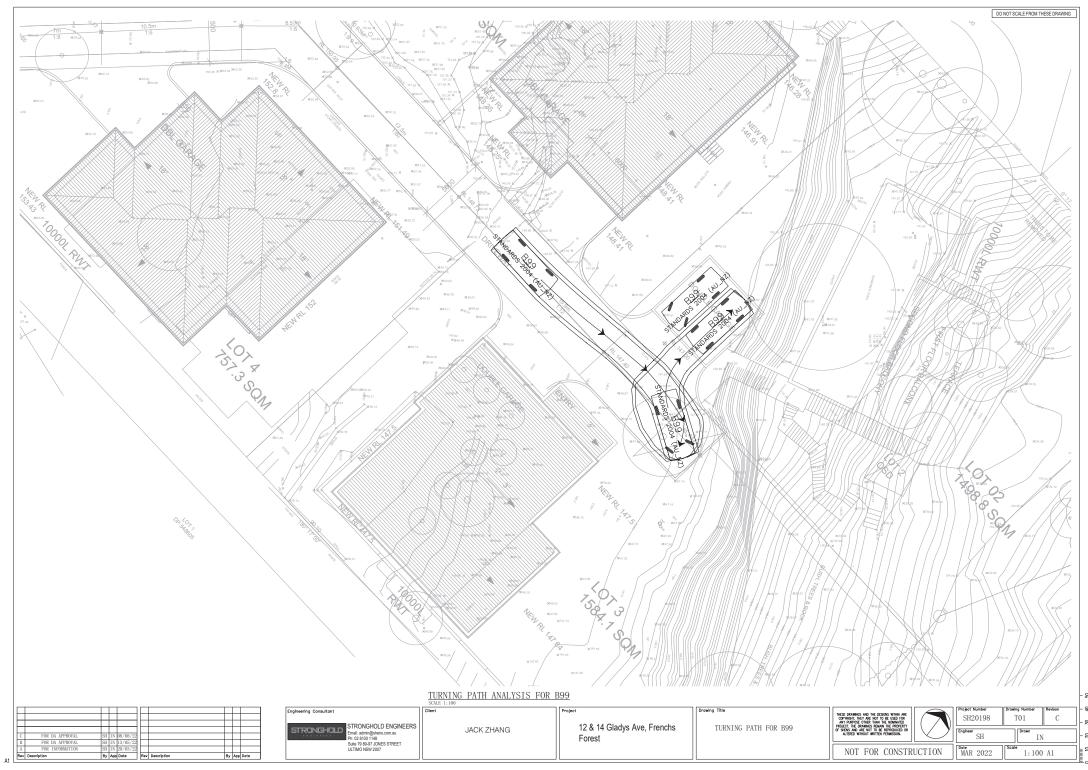


.

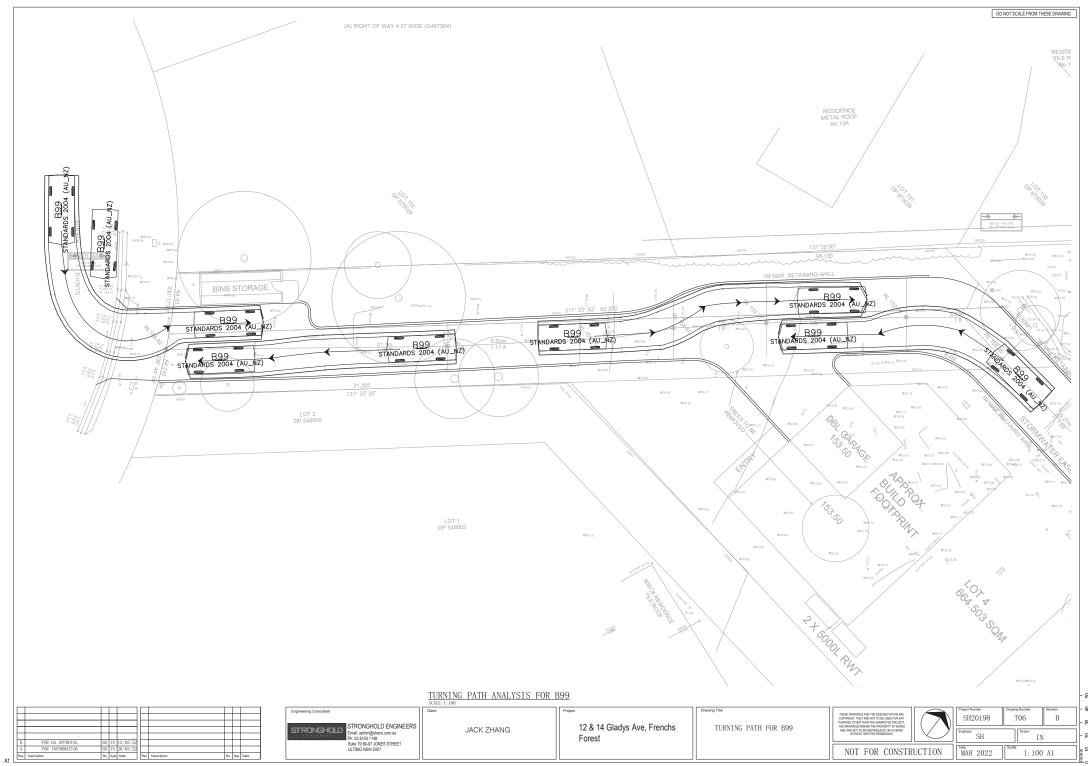


L

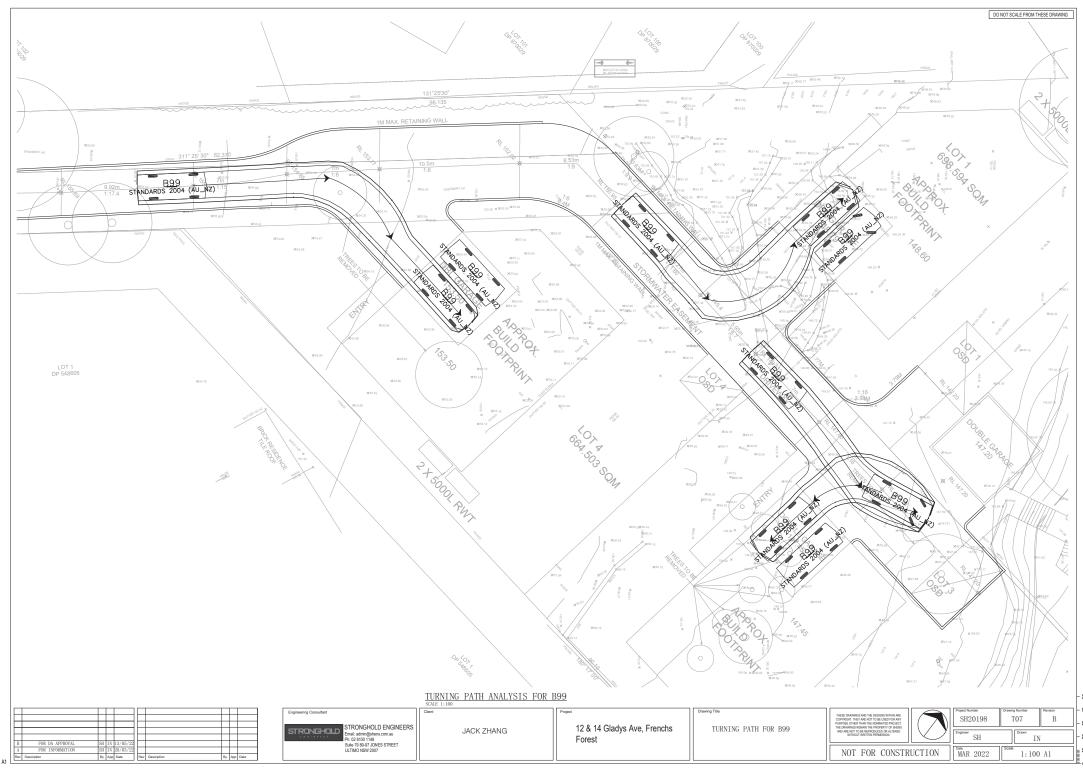


ı

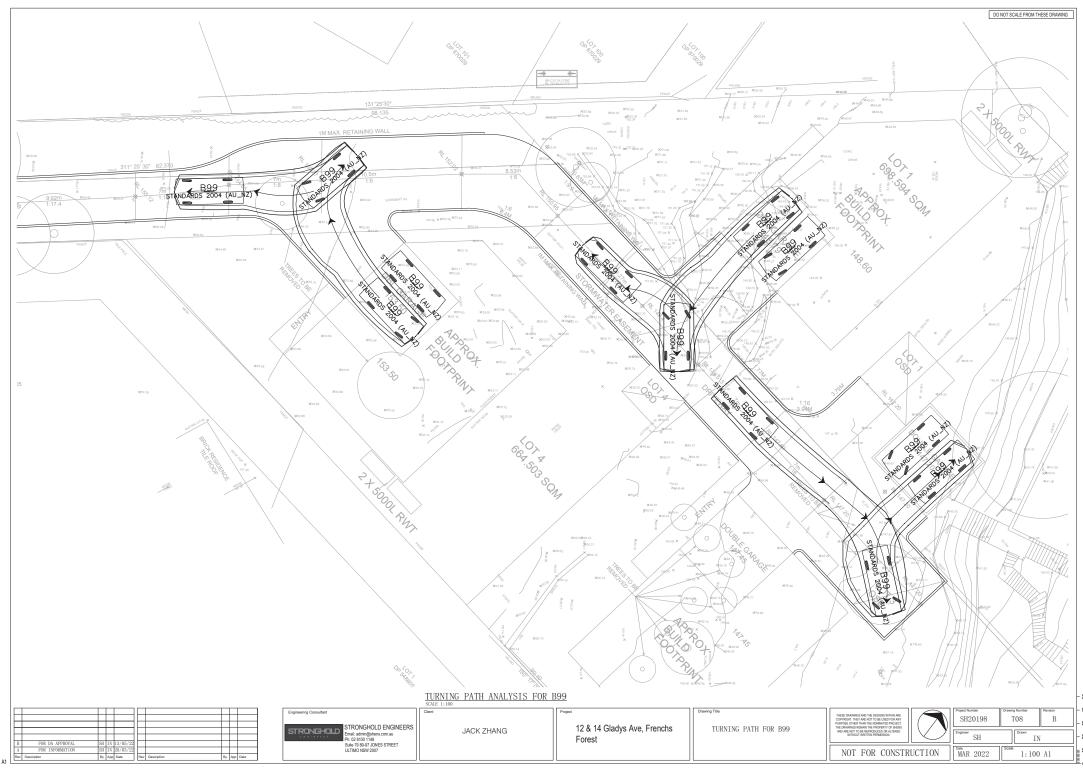

ı

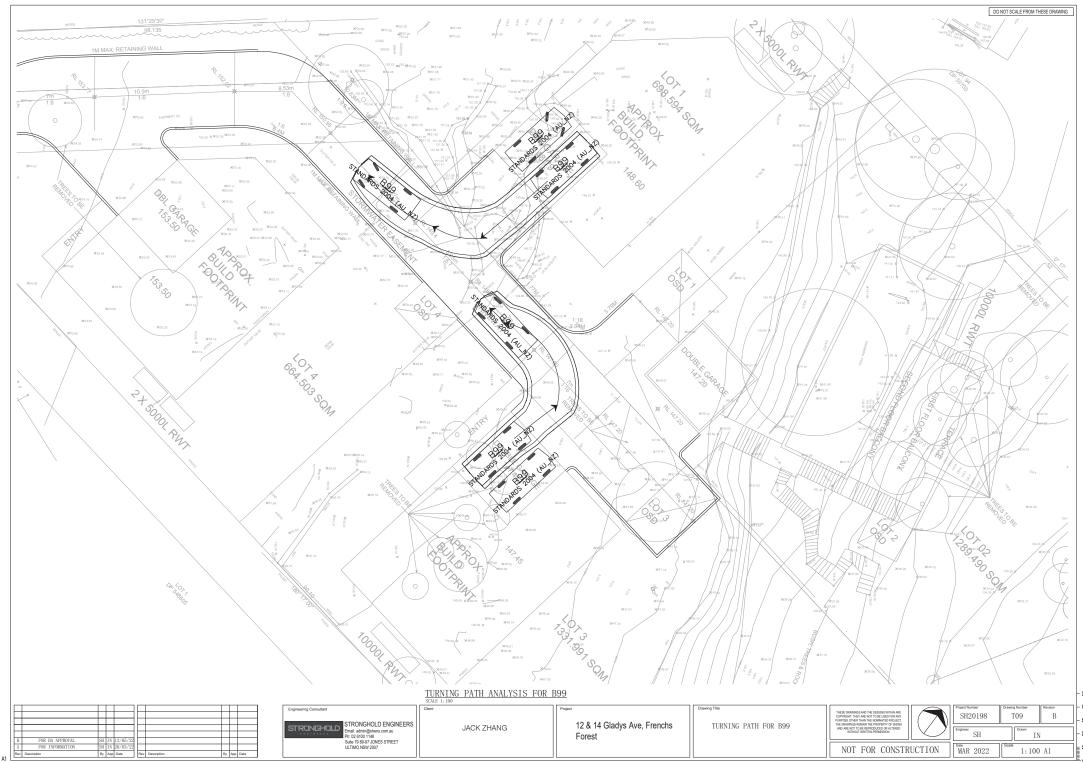



ı

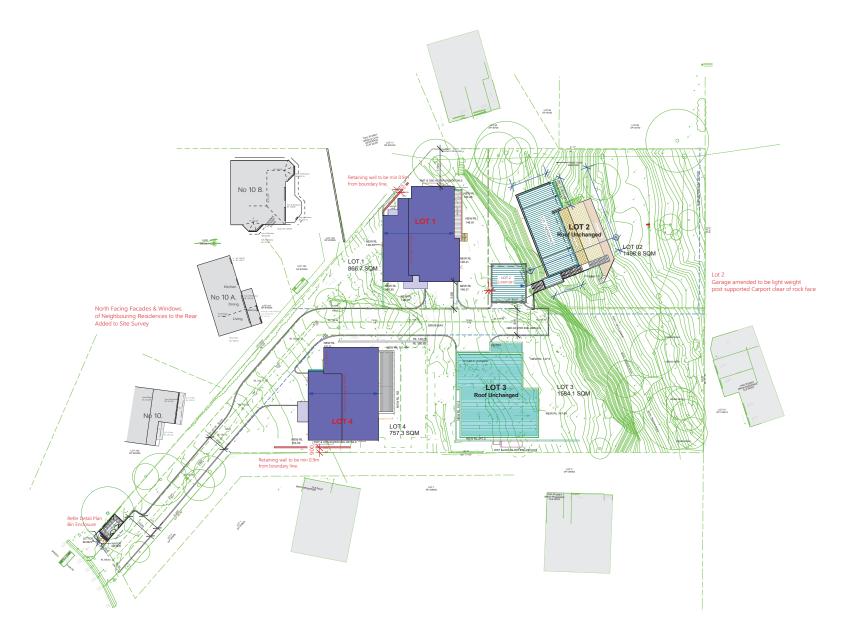



Site & Roof Plan

Controller, COTS (In controller, COTS) (In	RK RK	date 0305/22 1805/22 08/05/22 21/07/22	B C	amendment SSUE FOR CLEINT REVISION B SSUE FOR PRE DA SSUE FOR PRE DA SSUE FOR PA Lot 1 8.4 - MEIGHT REDUCED- Light FOOT Lowers and Rich Form Alberts - Res backory Lick of entered and	SUBDIV. OF LAND, 2 LOTS INTO 4 LOTS, SUBDIV. OF LAND, 2 LOTS INTO 4 LOTS, PROP. CONSTRUCT. OF 3 X 2 STRY DWELLINGS AT 12-14 GLADYS AVENUE, FRENCHS FOREST, NSW, 2086 dent JACK ZHANG	RK
Measurements for the facilitation of accordancy components such as, windows, doors, interned formers, included sind components and the siles, are not to be based. All extended components shall the inflact condexions of shall and applications an appearance by a shockast interpretation. All extended to the condexions of shall and applications are subjected by a shockast interpretation. All exactles productions seed to be exercised for shockand adequacy, and it is the Contribation's responsibility to ensure that a certification of shockard independent and applications are produced by the shall of any execution.			F		JACK ZHANG	KK DESIGNS

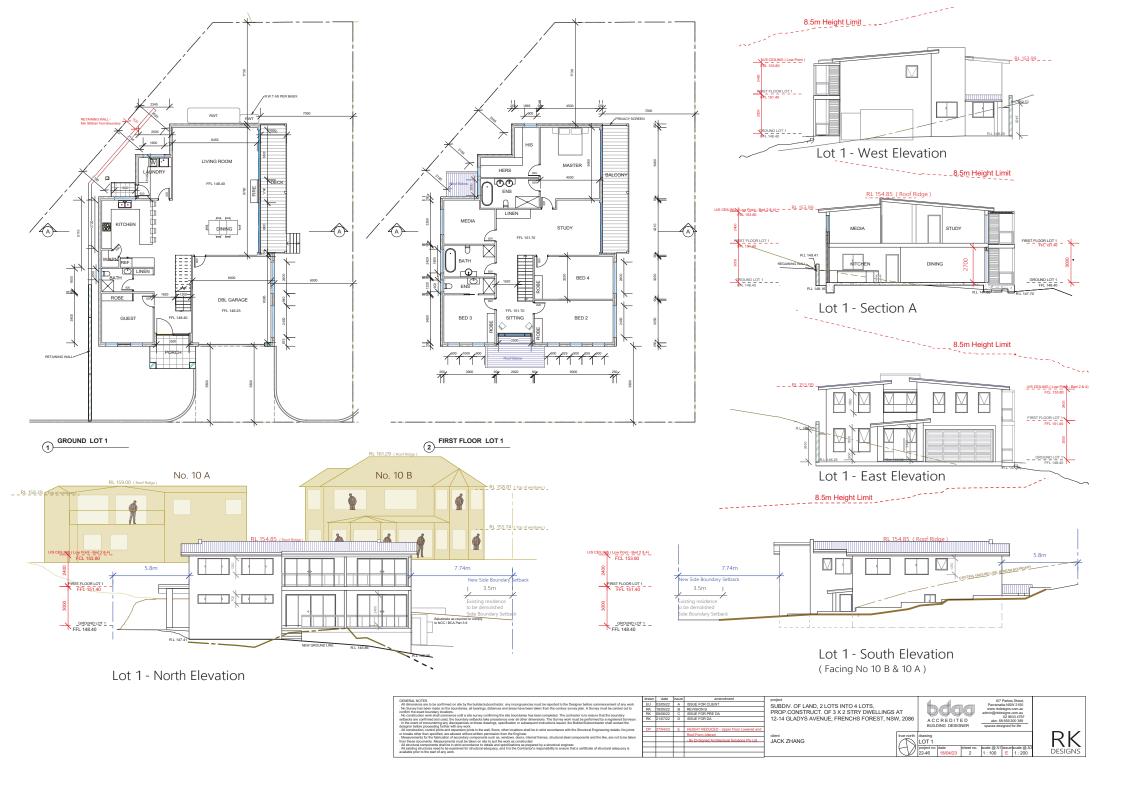


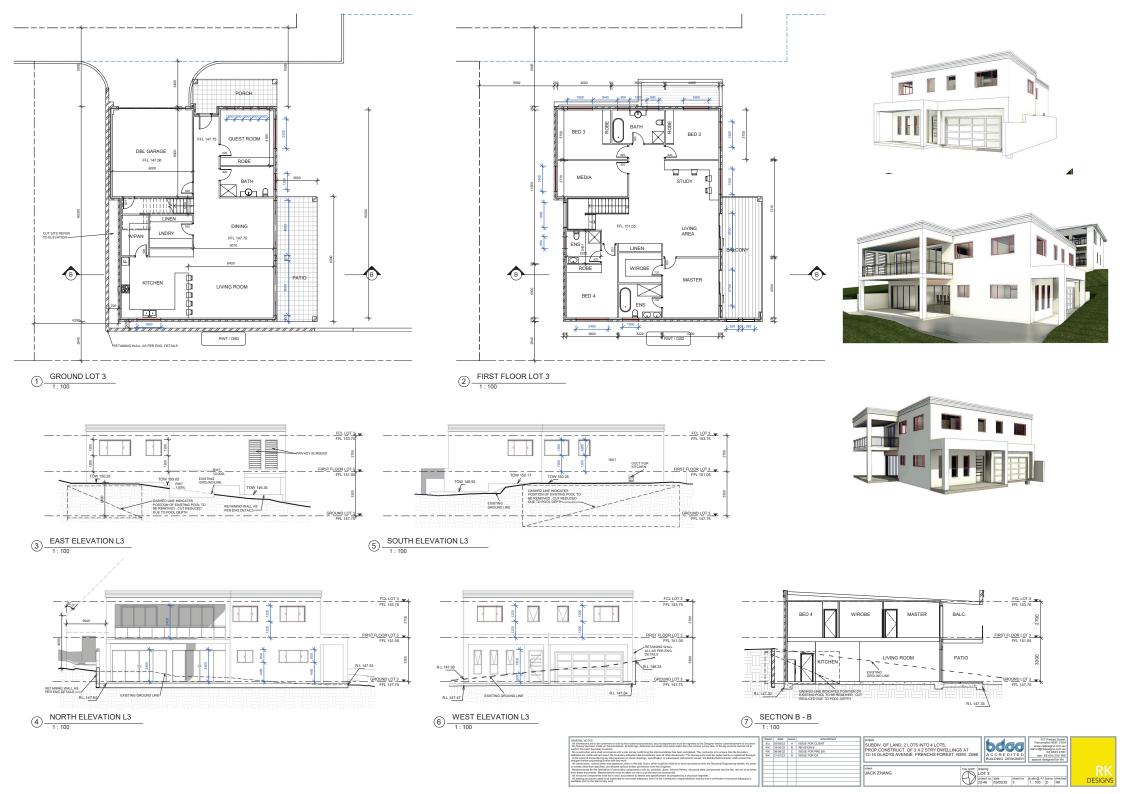

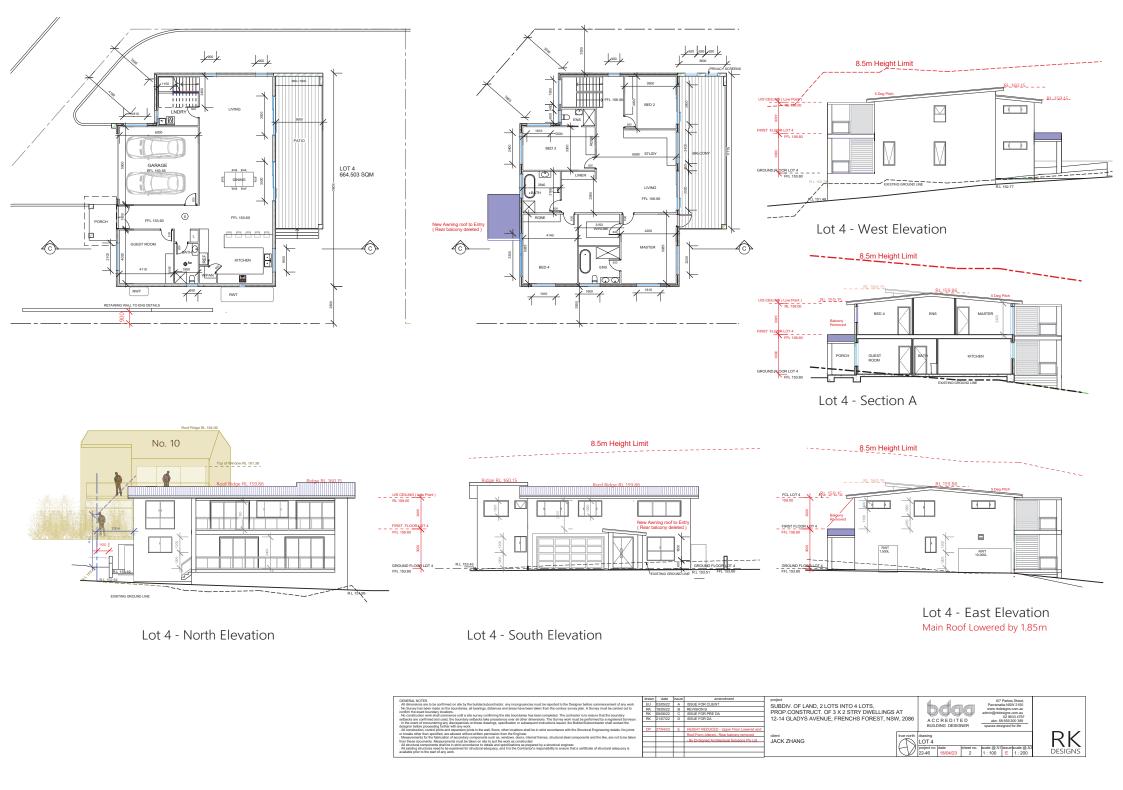

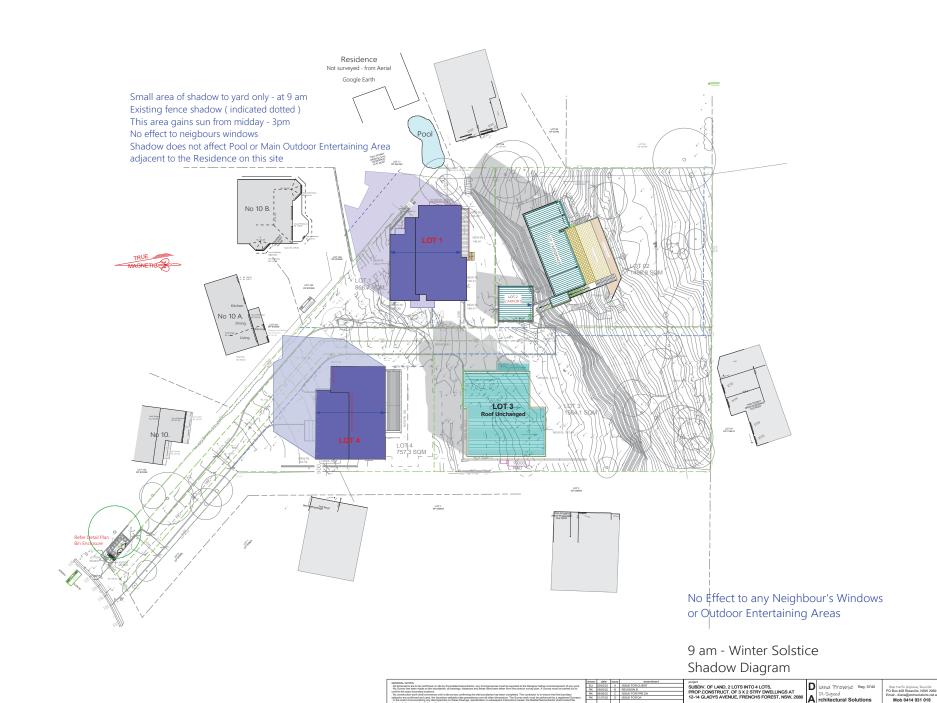


dient JACK ZHANG

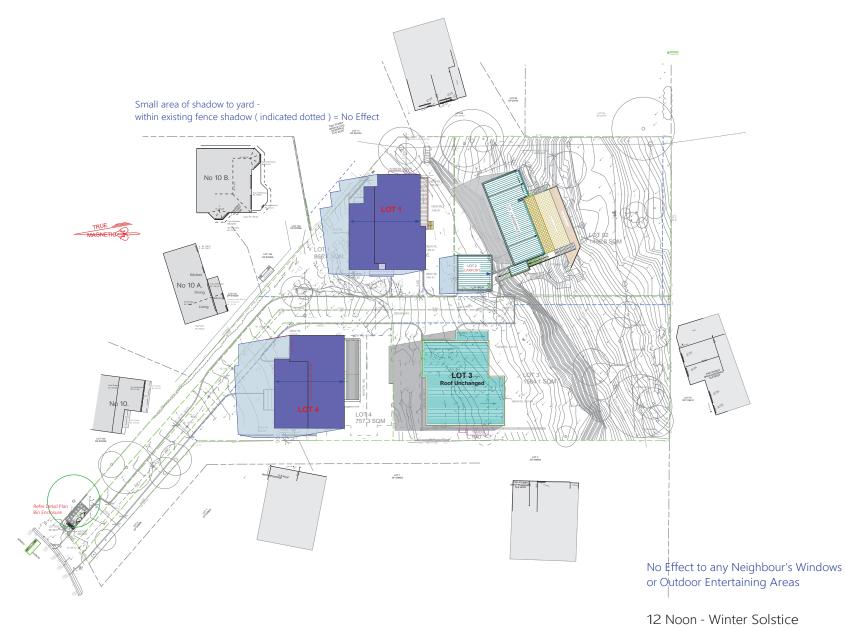

Shadow Diagram

CENEDA NOTES	drawn	clate	issue	amendment	project		1	
All directains are in he confirmed on alle by the hulldarks brooks for any inconsumular as must be sepreted to the Designer before commencement of any work	EU	03/05/22	A	ISSUE FOR CLIENT	SUBDIV. OF LAND, 2 LOTS INTO 4 LOTS.	חו	iana Prowse Reg. 5740	96A Tacific Highway Reseville
. No Survey has been made on the boundaries, all bearings, distances and areas have been taken from the contour survey plan. A Survey must be carried out to confirm the exact boundary locations.	RK	18/05/22		REVISION B		$\mathbf{\nu}$		PO Box 408 Roseville, NSW 2069
contrin the stact countary occasions. No construction work shall commence until a site survey confirming the site boundaries has been completed. The contractor is to ensure that the boundary	RK	08/05/22	0	ISSUE FOR PRE DA	PROP.CONSTRUCT. OF 3 X 2 STRY DWELLINGS AT		Di-Sianed	Email - diana@archsolutions.net.au
selbacks are confirmed and used, the boundary selbacks take precedence over all other dimensions. The Survey work must be performed by a registered Surveyor. In the event of encountering any discrepancies on these drawings, specification or subsequent instructions issued, the Builder/Subcontractor shall contact the	RK	21/07/22	D	ISSUE FOR DA	12-14 GLADYS AVENUE, FRENCHS FOREST, NSW, 2086	Λ	rchitectural Solutions	Mob 0414 931 018
 If the event of encouranting any oscrepancies on these crawings, specification of subsequent instructions issued, the subserbuticontractor shall contact the designer before proposition father with any work. 						_	runtectural solutions	MOD 0414 931 016
	DP	27/04/22		Lot 1 & 4 - HEIGHT REDUCED -				
or breaks other than specified, are allowed without written permission from the Engineer. Measurements for the fabrication of secondary components such as, windows, doors, internal frames, structural steel components and the like, are not to be taken				Upper Floor Lowered and Roof Form Altered -	client true north	Aranie	20	
 seasurements for the fabrication of secondary components such as, windows, coors, internal traines, structural steel components and the size, are not to be taken from these diversions. 				Rear balcony Lot 4 removed	JACK ZHANG			
All structural components shall be in strict accordance to details and specifications as prepared by a structural engineer.				Retaining walls min 0.9m from boundaries	1/1/			
All existing structures need to be examined for structural adequacy, and it is the Contractor's responsibility to ensure that a certificate of structural adequacy is available order to the start of any vect.			-	Lot 2 - Carport - replaces prev. Garage	1 17/	projec		icale @ A3
areason price to any more.			\neg	- By CR-Signed Architectural Solutions Pty Ltd		22-40	5 18/04/23 1 1:100 E	1:200

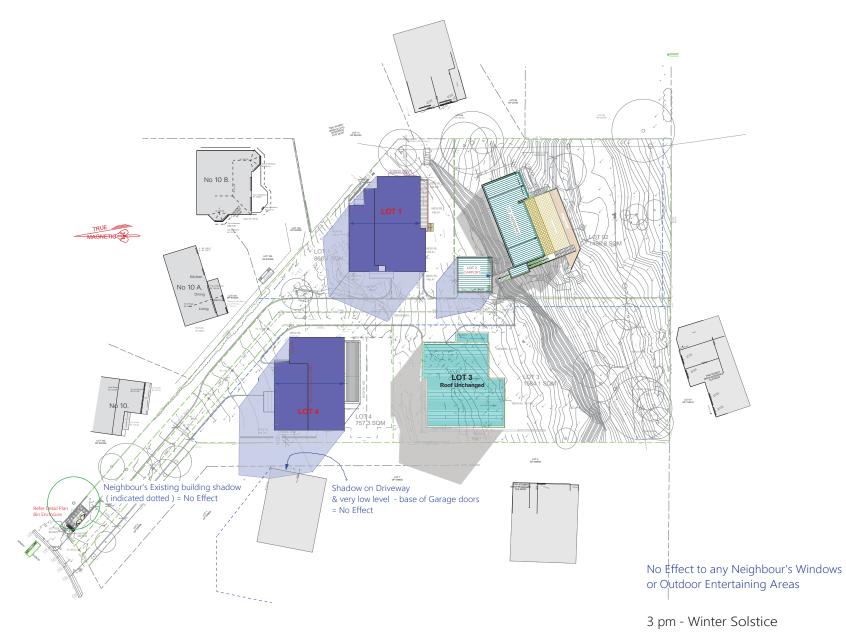

Shadow Diagram

GENERAL MYTES	drawn	clate	issa	amendment	project	1_	1	l
All directains are in he coefficient on alle by the hulidacts december any incommunities must be reported in the Designer before communities of any work	EU	03/05/22	A 3	ISSUE FOR CLIENT	SUBDIV. OF LAND, 2 LOTS INTO 4 LOTS.	IП	iana Prowse Reg. 5740	96A Tacific Highway, Roseville
No Survey has been made on the boundaries, all bearings, distances and areas have been taken from the contour survey plan. A Survey must be carried out to	RK	1805/22	0 0	REVISION B			INVINITIONSE Mag. 5140	PO Box 408 Roseville, NSW 2069
confirm the exact boundary locations. No construction work shall commence until a site survey confirming the site boundaries has been completed. The contractor is to ensure that the boundary		08/05/22		ISSUE FOR PRE DA	PROP.CONSTRUCT. OF 3 X 2 STRY DWELLINGS AT	Ι.	Di-Sianed	Email - diana@archsolutions.net.au
selbacks are confirmed and used, the boundary selbacks take precidence over all other offerentions. The Survey work must be performed by a registered Surveyor. In the event of excountering any discrepanication of these developes, secretication or subsequent instruction issued. The Subderf Subcontractor shall contact the	RK	21/07/22	2 D	ISSUE FOR DA	12-14 GLADYS AVENUE, FRENCHS FOREST, NSW, 2086	10	rchitectural Solutions	Mob 0414 931 018
 If the event or encountering any oscrepancies on these crawings, specification or supersquerit instructions issued, the business-becommiscor shall contact the designer before proceeding further with any work. 					1		remitectural solutions	MIOD 0414 931 016
	DP	27/04/22	3 E	Lot 1 & 4 - HEIGHT REDUCED -				
or breaks other than specified, are allowed without written permission from the Engineer. Measurements for the fabrication of secondary components such as, windows, doors, internal frames, structural steel components and the like, are not to be taken				Upper Floor Lowered and Roof Form Altered -	client true north	- Marri	ina	
 seasurements for the tabrication of secondary components such as, windows, doors, internal frames, structural steel components and the sea, are not to be taken from these documents. Measurements the most be taken on all all the work as constructed. 				Rear balcony Lot 4 removed	JACK ZHANG			
All structural components shall be in strict accordance to details and specifications as prepared by a structural engineer.			\neg	Retaining walls min 0.9m from boundaries				
All existing structures need to be examined for structural adequacy, and it is the Contractor's responsibility to ensure that a certificate of structural adequacy is available order to the start of any vericl.			\neg	Lot 2 - Carport - replaces prev. Garage	1 14/	proje	et no date sheet no. scale @ A1 issue 16 18/04/23 1 1:100 E	
avanace prior to the start or any work.			\top	- By Cit-Signed Architectural Sciulona Pty Ltd	1 1 1 1 1 1	22-4	6 18/04/23 1 1:100 E	1:200
1								



admin@rkdesigns.com.au www.rkdesigns.com.au

1/08/2022

PROPOSED EXTERNAL MATERIAL AND COLOUR FINISHES SCHEDULE FOR THE CONSTRUCTION OF 2 STOREY DWELLING AT LOT 1, 12-14 GLADYS AVENUE, FRENCHS FOREST, NSW, 2086

EXTERNAL WALLS

Finish

Paint Finish

Colour Manufacturer Puppy Dulux

ROOF

Type

Manufacturer

Pitched Roof

Tiles Monier concrete

Caraway

Finish Colour

GUTTERS, DOWNPIPES AND FASCIA

Finish Colour **Paint Finish** Dulux

Colour Dark Metal

ALUMINIUM FRAME WINDOWS & SLIDING DOOR

Paint Finish

Paint manufacturer Dulux

Colour **Dark Metal**

Finish **Paint Finish** POST AND RAILING

Manufacturer Dulux

Dark Metal

Colour









admin@rkdesigns.com.au www.rkdesigns.com.au

1/08/2022

PROPOSED EXTERNAL MATERIAL AND COLOUR FINISHES SCHEDULE FOR THE CONSTRUCTION OF 2 STOREY DWELLING AT LOT 3, 12-14 GLADYS AVENUE, FRENCHS FOREST, NSW, 2086

16.5	
Щ	
Ĩ	
₽	
5	
≥	
Е	
လ	

Finish

Paint Finish

Colour Manufacturer Dulux **Charter Grey**

ROOF

Colour Type Manufacturer Bablyon Colorbond Flat roof

Finish Metal

GUTTERS, DOWNPIPES AND FASCIA

Finish Colour Dulux **Paint Finish**

Colour Dark Metal

ALUMINIUM FRAME WINDOWS & SLIDING DOOR

Paint manufacturer Dulux **Paint Finish**

Colour **Dark Metal**

POST AND RAILING

Finish **Paint Finish**

Colour Manufacturer Dulux

Dark Metal

spaces designed for life



admin@rkdesigns.com.au www.rkdesigns.com.au

1/08/2022

PROPOSED EXTERNAL MATERIAL AND COLOUR FINISHES SCHEDULE FOR THE CONSTRUCTION OF 2 STOREY DWELLING AT LOT 4, 12-14 GLADYS AVENUE, FRENCHS FOREST, NSW, 2086

EXTERNAL WALLS

Colour Finish Manufacturer Dulux **Paint Finish** Subdue

ROOF

Colour Type Manufacturer Tiles Monier concrete **Pitched Roof**

Finish Bablyon

BABLYON

GUTTERS, DOWNPIPES AND FASCIA

Finish Colour Colour ALUMINIUM FRAME WINDOWS & SLIDING DOOR **Paint Finish** Dark Metal Dulux

Colour Paint manufacturer Dulux **Paint Finish**


Dark Metal


Finish Manufacturer Dulux **Paint Finish** POST AND RAILING


Colour


Dark Metal


spaces designed for life

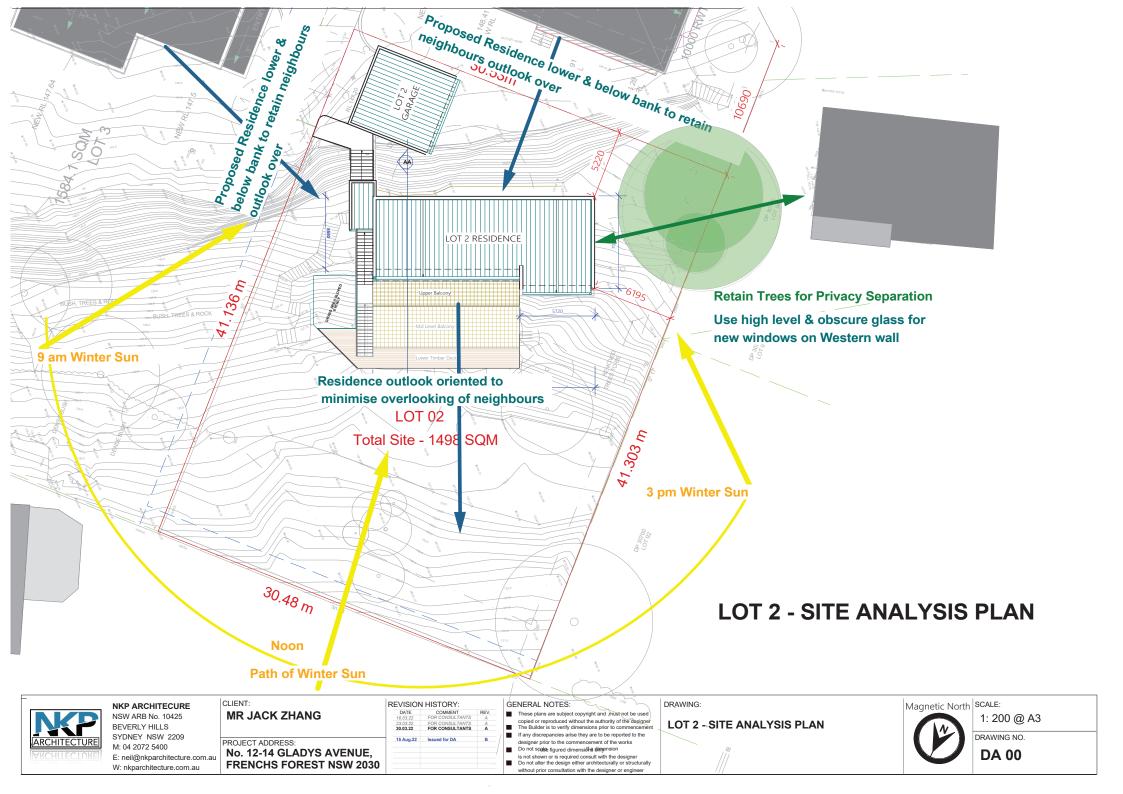


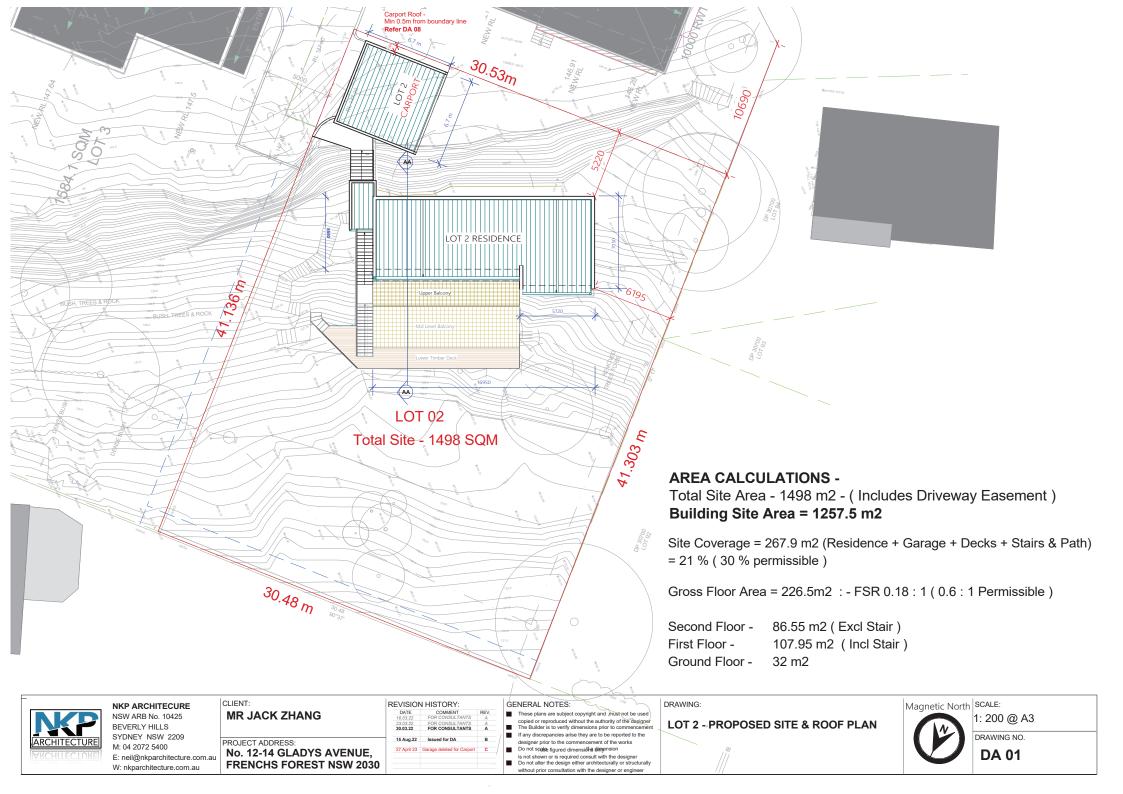

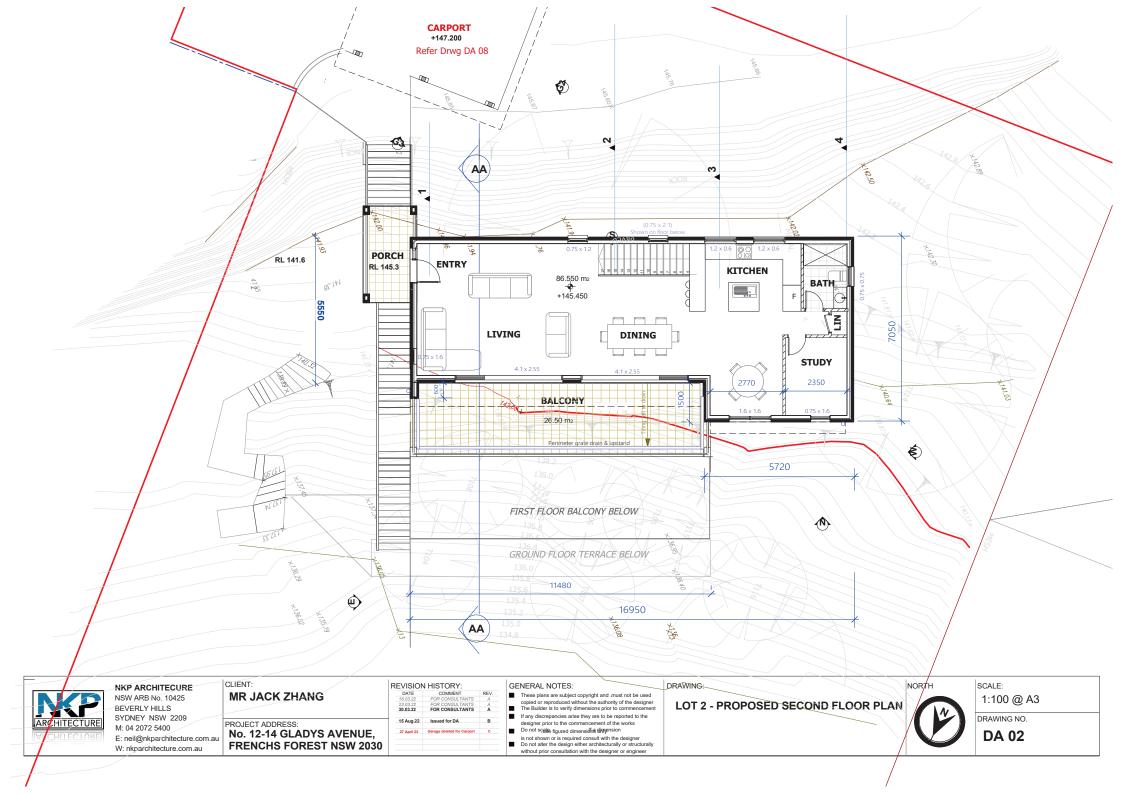

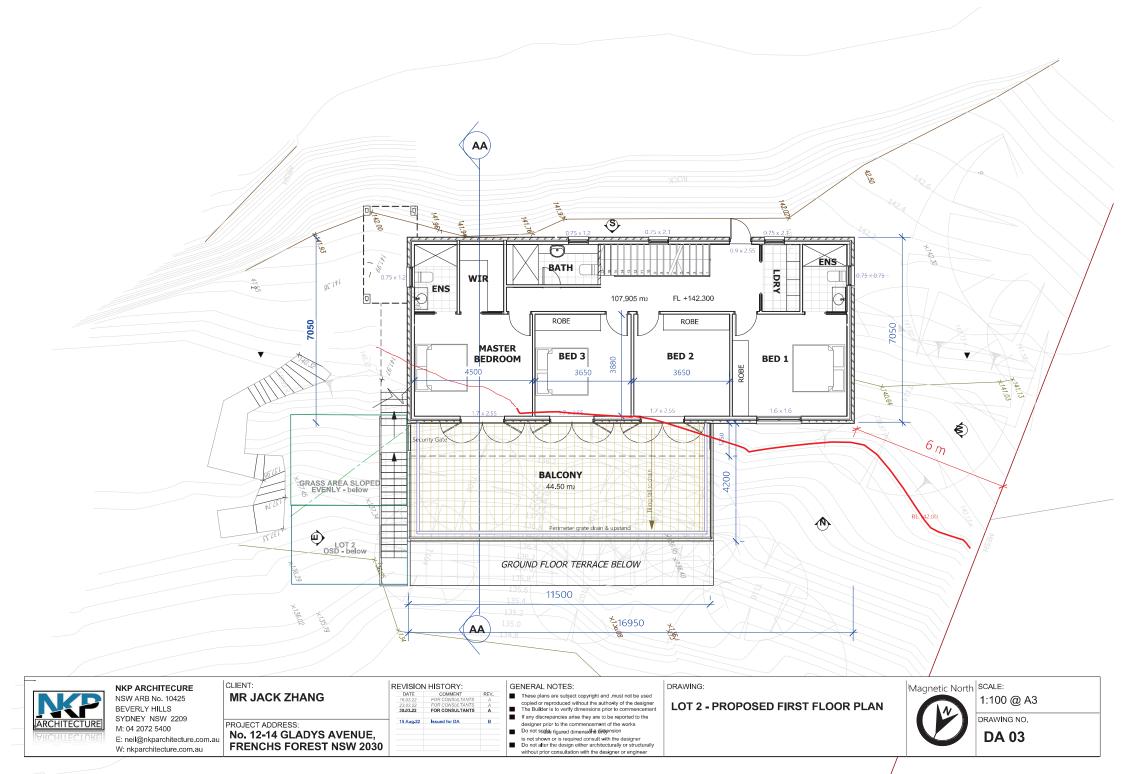

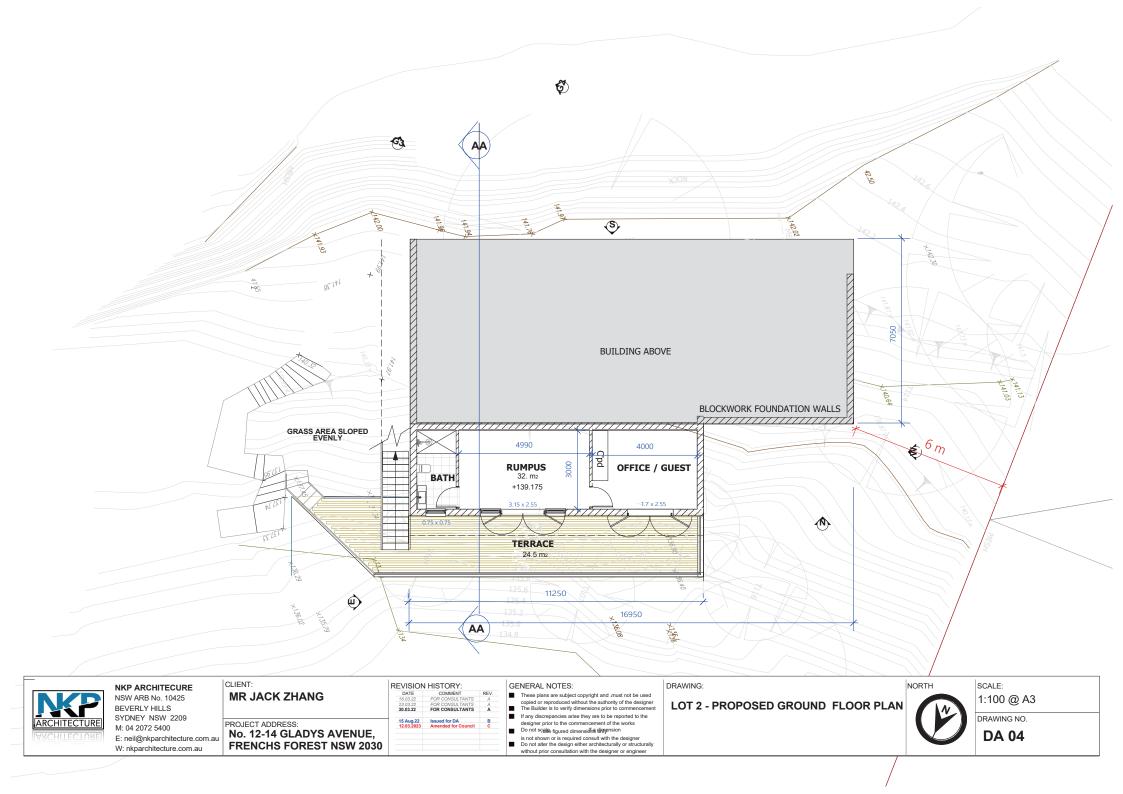

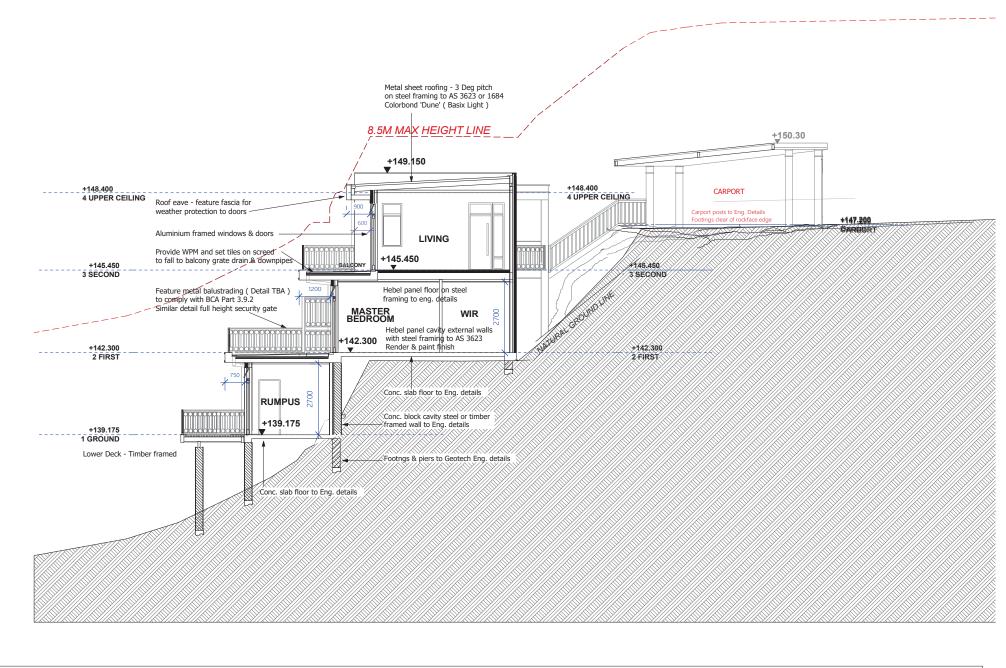



NKP ARCHITECURE NSW ARB No. 10425 BEVERLY HILLS SYDNEY NSW 2209 M: 04 2072 5400 E: neil@nkparchitecture.com.au

W: nkparchitecture.com.au

CLIENT:

MR JACK ZHANG

PROJECT ADDRESS:

No. 12-14 GLADYS AVENUE,
FRENCHS FOREST NSW 2030

REVISION

DATE
16:03:22
22:03:22
16:09:22
17:April 23: (27.April 23: (27.April

GENERAL NOTES:

These plans are subject copyright and must not be used copied or reproduced without the authority of the designer

■ The Builder is to verify dimensions prior to commencement
If any discrepancies arise they are to be reported to the
designer prior to the commencement of the works
Do not sraßs figured dimensions discontinuous discontinuous

is not shown or is required consult with the designer

Do not alter the design either architecturally or structurally without prior consultation with the designer or engineer


DRAWING:


LOT 2 - PROPOSED SECTION A-A

SCALE: 1:100 @ A3

DRAWING NO.

DA 05

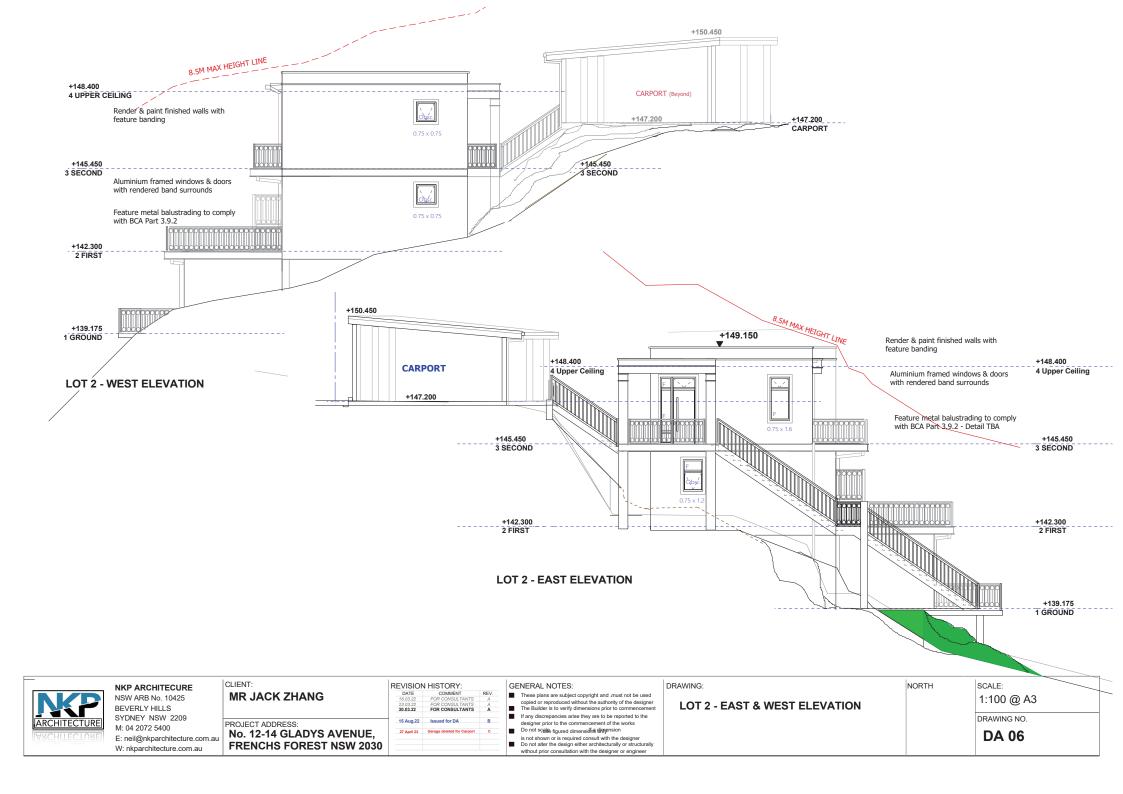

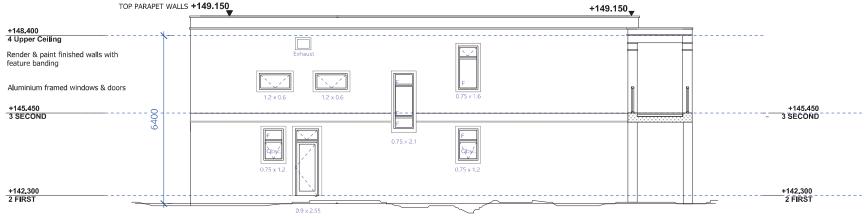

LOT 2 - SOUTH ELEVATION





NSW ARB No. 10425 BEVERLY HILLS SYDNEY NSW 2209 M: 04 2072 5400 E: neil@nkparchitecture.com.au | CLIENT: | | REVISION HISTORY: | DATE | | COMMENT | REVISION HISTORY: | DATE | COMMENT | REVISION HISTORY: | DATE | COMMENT | REVISION HISTORY: | REVISION

GENERAL NOTES:

These plans are subject copyright and must not be used copied or reproduced without the authority of the designer.

The Builder is to verify dimensions prior to commencement

The Builder is to verify dimensions prior to commencement

If any discrepancies arise they are to be reported to the
designer prior to the commencement of the works

Do not scales figured dimensions dispersion

is not shown or is required consult with the designer


Do not alter the design either architecturally or structurally without prior consultation with the designer or engineer

LOT 2 - NORTH & SOUTH ELEVATION


SCALE: 1:100 @ A3

DRAWING NO.

DA 07

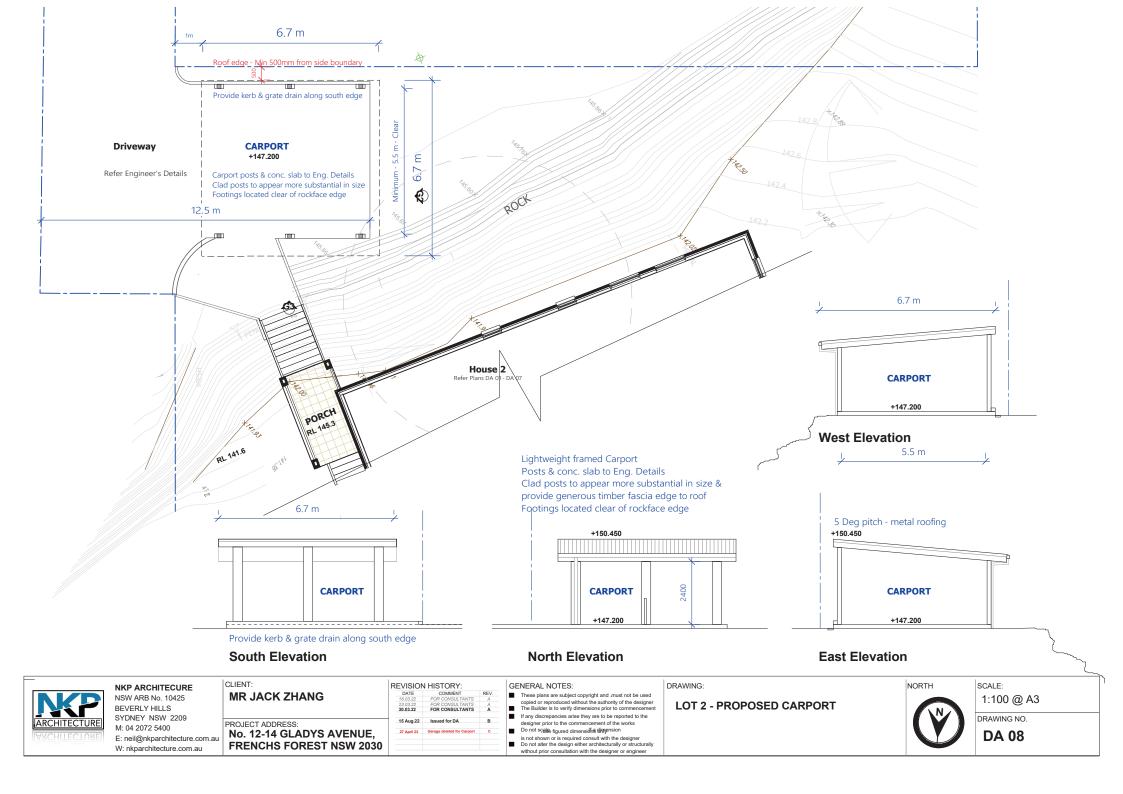

LOT 2 - PROPOSED FINISHES - DARK EARTH COLOURS

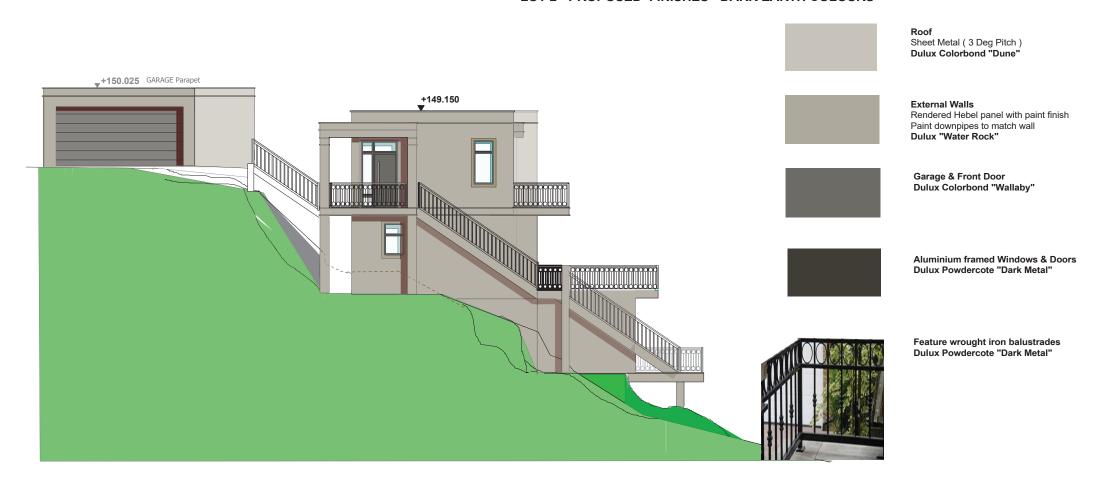



NKP ARCHITECURE NSW ARB No. 10425 BEVERLY HILLS SYDNEY NSW 2209 M: 04 2072 5400 E: neil@nkparchitecture.com.au

W: nkparchitecture.com.au

CLIENT: REVISION HISTORY: MR JACK ZHANG PROJECT ADDRESS: No. 12-14 GLADYS AVENUE, **FRENCHS FOREST NSW 2030**

GENERAL NOTES:

These plans are subject copyright and must not be used copied or reproduced without the authority of the designer

The Builder is to verify dimensions prior to commencement If any discrepancies arise they are to be reported to the designer prior to the commencement of the works

Do not scale figured dimensional dimension

is not shown or is required consult with the designer

Do not alter the design either architecturally or structurally without prior consultation with the designer or engineer


DRAWING:


LOT 2 - PROPOSED COLOURS & FINISHES


SCALE: 1:100 @ A3


DRAWING NO.

Colours & Finishes Schedule

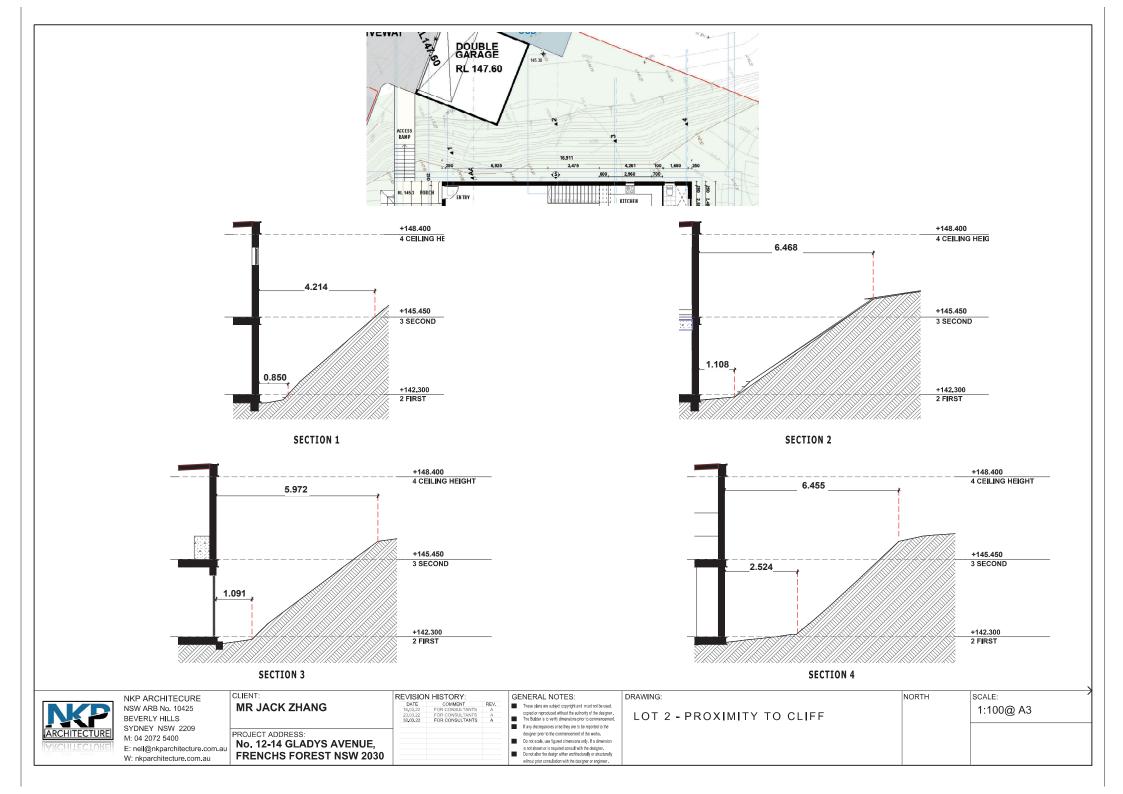


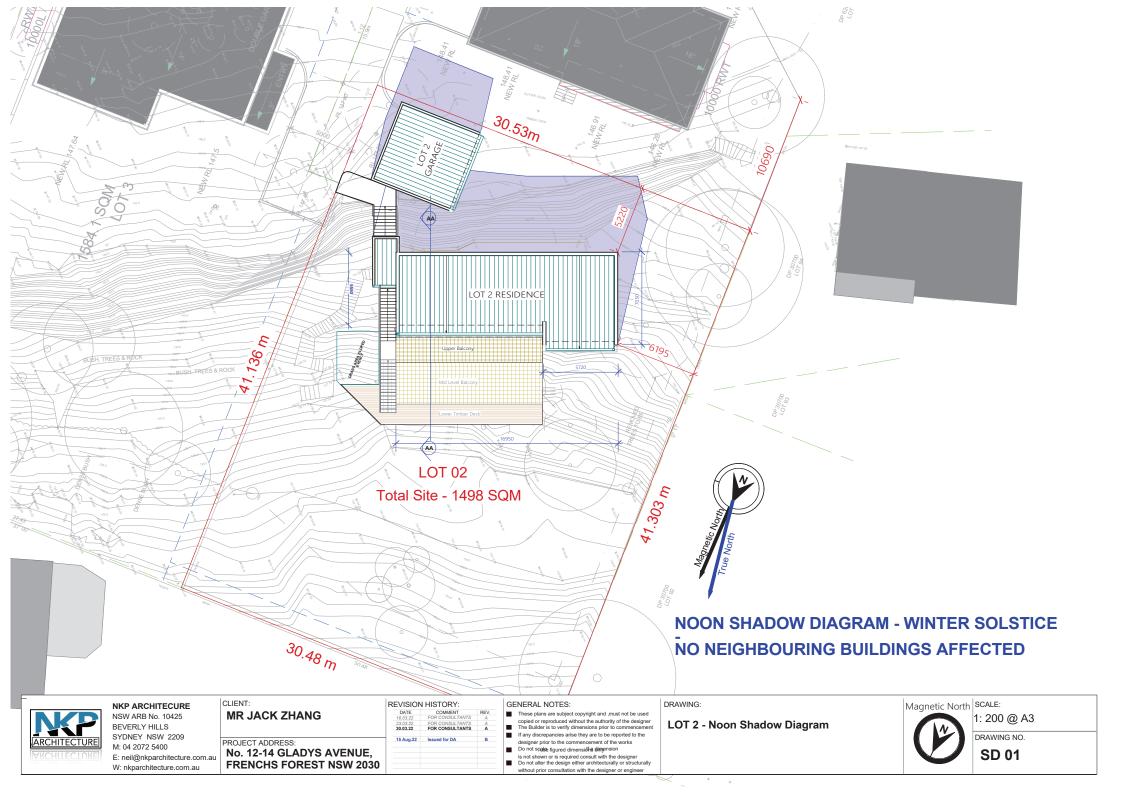

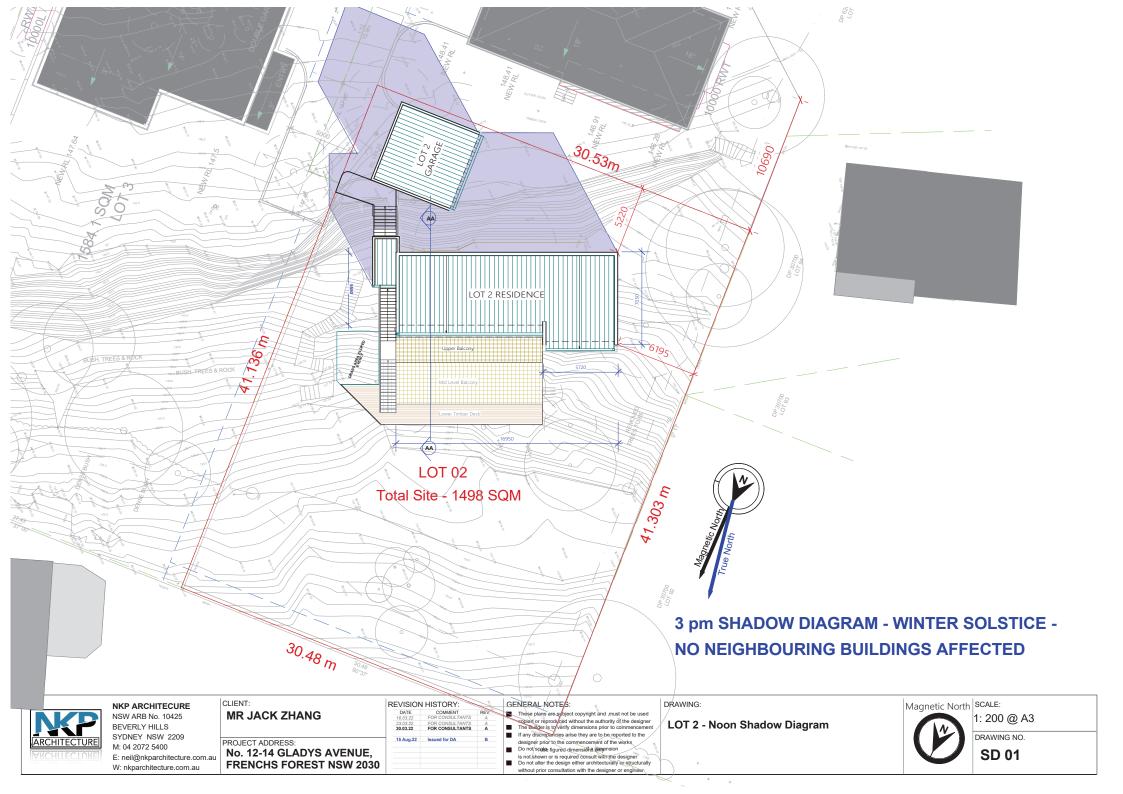


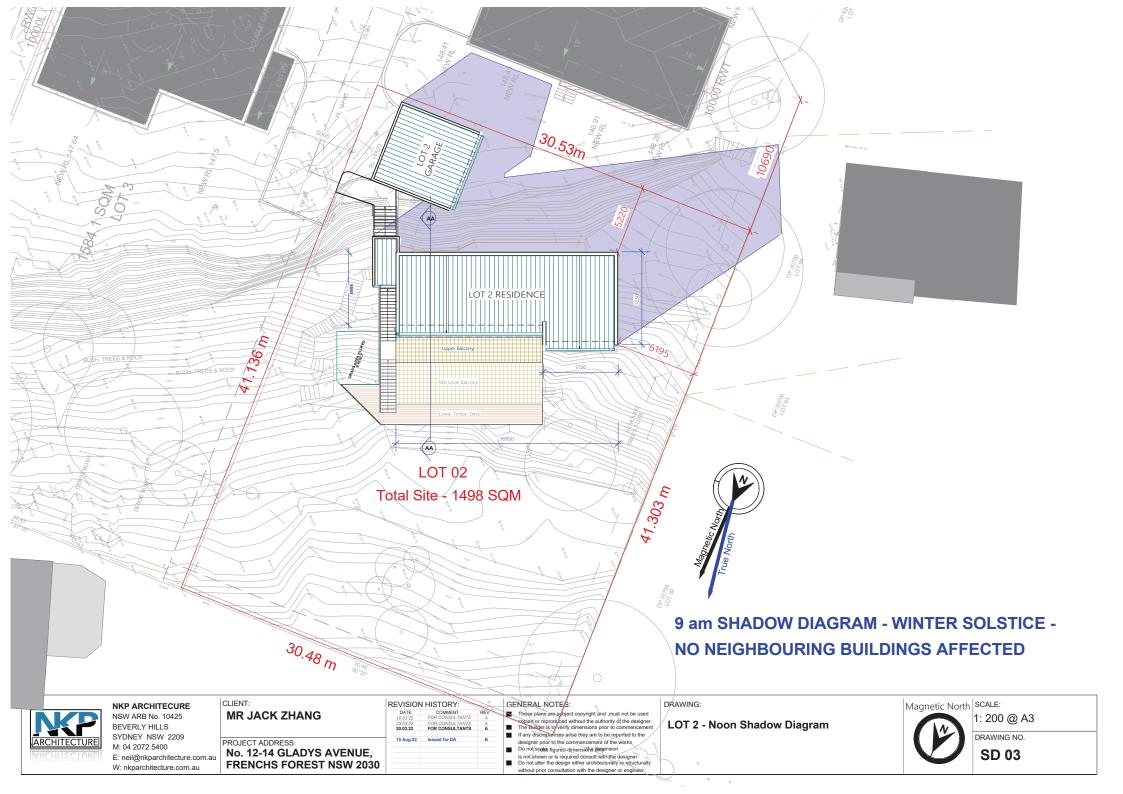




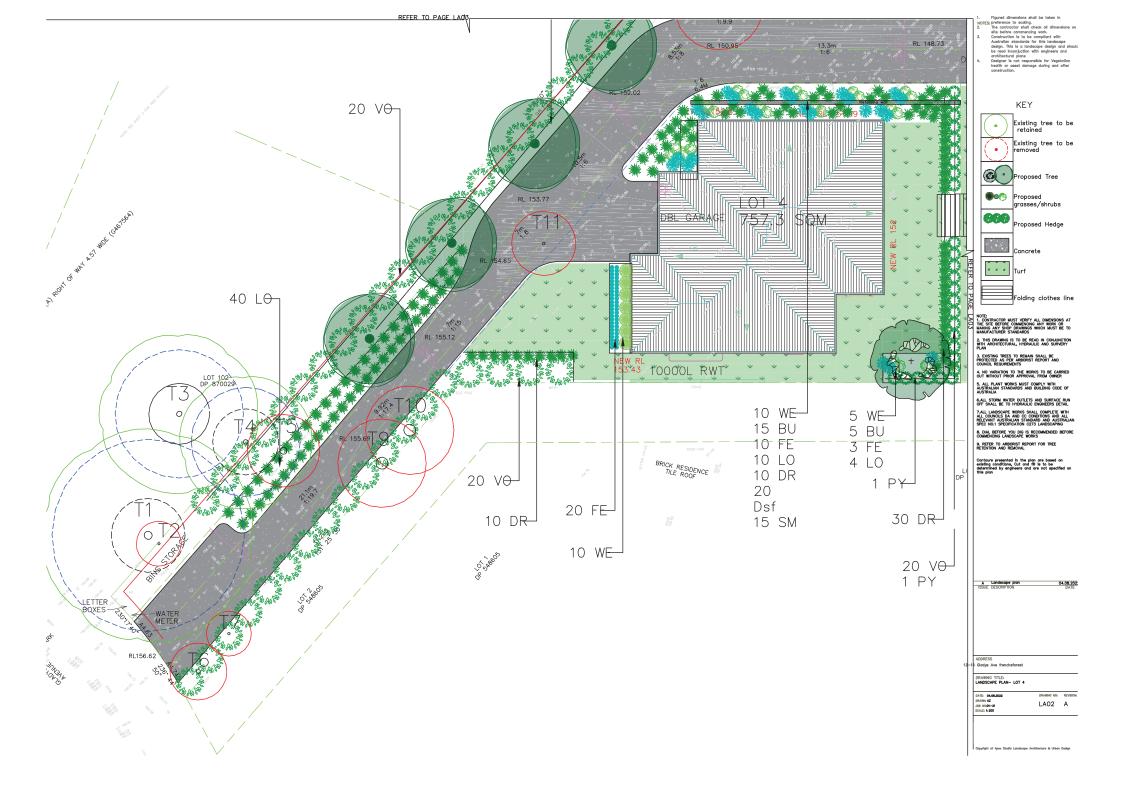



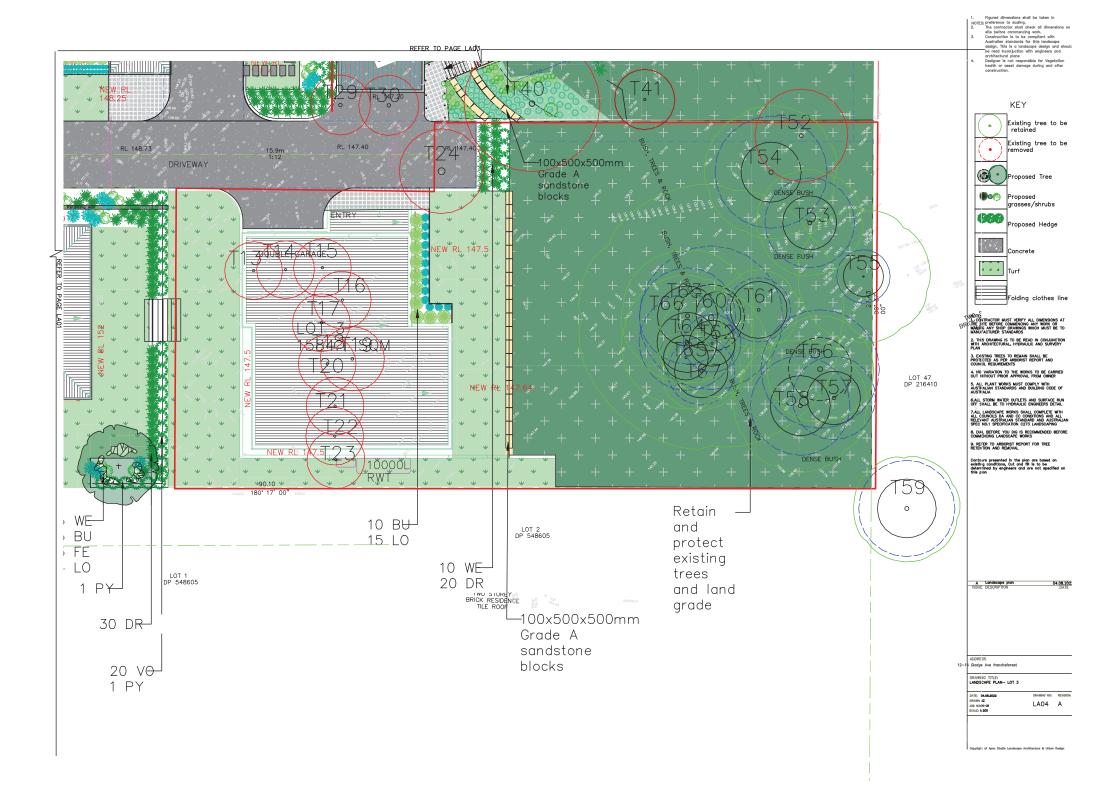

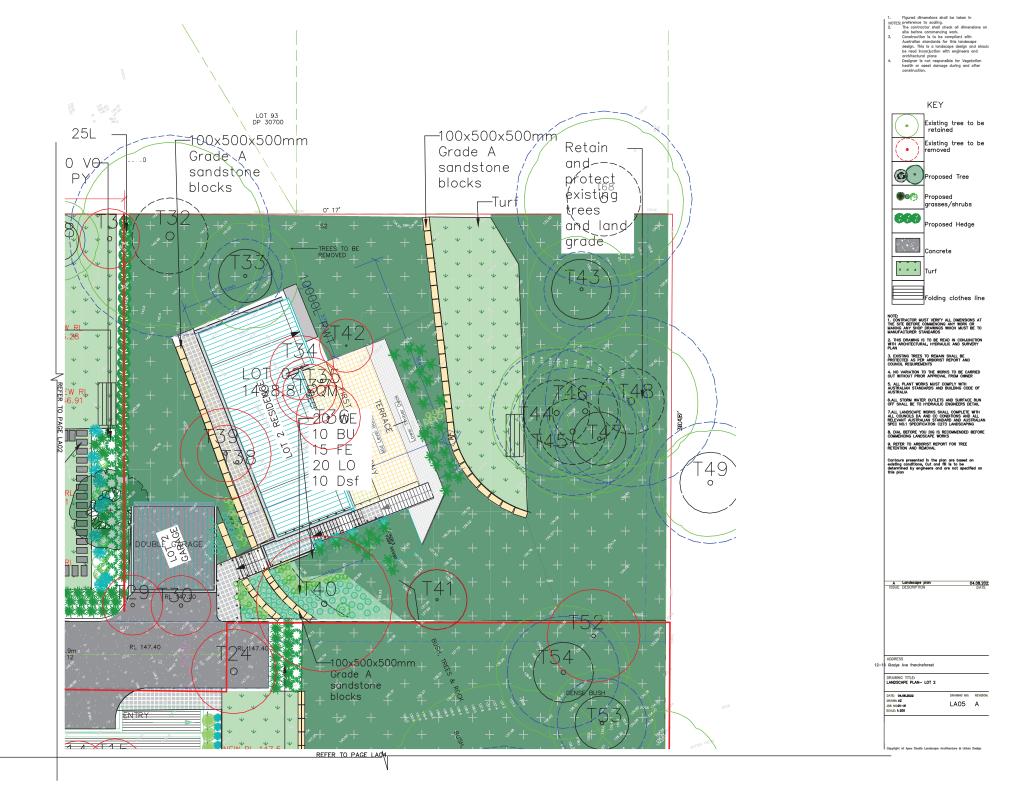

ALL SARTHMORK DRAINING WORKS, RETAINING WALLS, CONCRETE WORKS AND GRADING TO BE CONSTRUCTED IN ACCORDANCE WITH THE ENGINEERING PLANS, DETAILS AND SPECIFICATION REFER TO BOMBEERING DRAININGS FOR ALL FRISHED LEVELS.
ALL SET OUT TO BE APPROVED ON SITE BY LIPPRINTEDIDENT PRIOR TO THE COMMENCEMENT OF GROUND WORKS.

VECETATION TO BE REMOVED.
REMOVE ONLY THOSE TRESS AND VECETATION MARKED FOR REMOVAL ALL TREES AND NATIVE VECETATION REQUIRED TO BE REMOVED AS PART OF THESE WORKS ARE TO BE MULCHED ON SITE AND AND STOCKPLED FOR REUSE IN PLANTING AREAS

VEGETATION TO BE RETAINED:

WHERE TREES ARE MARKED FOR RETENTION THE FOLLOWING PROTECTION MEASURES ARE TO BE UNDERTAKEN;

- A THEE PROTECTION OF A RANGE OF O'S THOROUGH AND THE A CLUSTORY REPORT OF THE ADDRESS OF THE ADD

WEED ERADICATION

CONSTRUCTION OF A CONTROL THE PROPERTY OF CONTROL THE FEW FOUNDAMEN IN FREE PASKS, USE HAND RETIRED ON ALT.

ON CONTROL THE STRUCTURE OF PROPERTY OF CONTROL THE FOUNDAMEN IN FREE PASKS, USE HAND RETIRED ON ALT.

ON LITERACY OF HE THE COLL RESIDENCE TO DETERMINE ANY MEMORIES HE REQUIRED TO THE ENTIRE OF THE AREA OF THE SERVICE OF THE S

NO CONTAINANTED SOL IS TO BE USED ON SITE. SHOULD BOL BECOME CONTAINANTED BY DESEL OL, PAINT, CEMENT OR ANY OTHER CONTAINANTS, DICAVATE THE CONTAINANTED SOL AND DISPOSE OF IT OFF SITE AND REPLACE IT WIT FINISHED LIVES.

SPECIAL TEXT OFFICIAL OLD THE PREPARED SIZE SOL AND GRACE EVENLY, ALLOWING THE FOLLOWING TO OCCUR.

RACE SOL IN MAXIMUM LAYER DEPTHS OF 158MM, LIBERTY COMPACT AT EACH LAYER.

RACE SOUR DEPTH OF SOL MIN HAL LITTORAL FERSESTIRM, RE-VEGETATION AND NATIVE CARGEN MIX PLANTING ZONES.

PLACE STORM DEPTH OF SOLAND HALL ARREST DIE TRIPSET.

ON COMPLETION OF SOUR PLACEMENT THE SURFACE SHALL BE;

PLANTING

PART METERS, PAREA BY RESOURCES, 4 MEMBER PROFT IN ARCHITECTURAL DISCUSSION TO BROWNED COS., STOCK SHALABLE.

HE CORRECTION SHALAR PART TO THE CLORADISC DISTRICTURAL DISCUSSION OF BROWNING IN FER ANY TO WHAT IN THE PART TO WHAT IN THE PART OF THE

DELIVER PLANT MATERIAL TO SITE ON A DAY TO DUY ASSIS, AND PLANT IMMEDIATELY AFTER DELIVERY PROTECT FLANTS AT ALL TIMES FROM SUN OF DRYING WINDS, PLANTS THAT CAN NOT BE PLANTED IMMEDIATELY ON DELIVERY SHALL BE KEPT IN THE SHADE, WELL PROTECTED AND DECENTABLE PLANTED SHADE AND ADMINISTRATION OF PLANT.

PLANTING CONDITIONS

DO NOT FLANT IN LINSUITABLE WEATHER CONDITIONS SUCH AS EXTREME HEAT, COLD, WIND OR RIVAN IN OTHER THAN SANDY SOLES, SUSPEND EXCAVATION WHEN THE SOIL IS WET, OR DURING PROST PERCOS, NOTIFY SUPERINTENDENT OF ALL SOIL OR DRAINAGE CONDITIONS ENCOUNTERED DURING PLANTING OPERATIONS THAT THE LANDSCAPE CONTRACTOR CONSIDERS TO BE DETRIBUTING TO PLANT GROWTH.

THOROUGHLY WATER THE PLANTS IMMEDIATELY AFTER PLANTING, AND AS REQUIRED TO MAINTAIN GROWTH RATES FREE FROM STRESS, LESS FREQUENT HEAVY WATERING IS PREFERABLE TO LIGHT WATERING, THE SOLL MOISTURE NEEDS TO BE ASSESSED DALY AND

THROUGHER THORS IN THE CHAIR SHEEDINGS A COMMAND.

THE CHAIR SHEET OF THE CHAIR SHEEDINGS AND COMMAND.

THE CHAIR SHEET OF THE MANTENANCE PERSON. THE CHAIR SHEET OF REAL FLAT MATERIAL FOR THE QUARTER OF THE MANTENANCE PERSON. AT COMPLETION OF THE MANTENANCE PERSON. THE CONTRACTOR IS REPORTED FOR THE CONTRACTOR IS REPORTED FOR THE CONTRACTOR IS THE MANTENANCE PERSON. THE CONTRACTOR IS REPORTED FOR THE CONTRACTOR IS THE MANTENANCE PERSON. THE CONTRACTOR IS REPORTED FOR THE CONTRACTOR IS THE MANTENANCE PERSON. THE CONTRACTOR IS REPORTED FOR THE CONTRACTOR IS THE MANTENANCE PERSON. THE CONTRACTOR IS THE MANTENANCE PERSON. THE CONTRACTOR IS THE MANTENANCE PERSON. THE MANTENANCE PERSON.

PLACING

DECURITY OF A SHOULTD IN HARMO STARS SHEEN NOTIFIED AND MERRO MATERIALS AND MERRO MADE AND STAR SHEEN THE PROPERTY OF THE SHAPE OF SALE COMPLETE AND THAT NO ARE GAME DEST. ARREST UP SHOULD BE RESERT AND THE RESERVATION OF THE SHAPE OF THE

REPLACEMENT


REPLACE DAMAGED OR FAIL PLANTS WITH PLANTS OF THE SAME TYPE AND SIZE.


TURFING

THE CONTRICTOR SHALL REFALL SHELL SHELL SHELL SHELL SHE FOLLS TO BE LOCATION AND DETERM SHOWN ON tHE SHEMMED AND TALL APREA DAMAGED CHANGE THE CONSISTENCE OF THE SHEME CHANGE THE CONTRICT OF THE SHEME CHANGE THE CONTRICT OF THE SHEME CHANGE THE CONTRICT OF THE SHEME CHANGE THE SHEME THE SHEME CHANGE THE SHEME THE SHEME

- MEDIAL, MATERIAL PRIVATION OF PERTILEER, PET AND DESIGNAT CONTING, I STANKING AND THING, MISSIONAL OF LITTLE FROM PLANTING AND GRASES AND SEPLICITIES OF EACH AND OPINIOR PLANTING.

 CONTINES TO SEPLICATE AND CONTINUES OF SECURITY AND SERVICE DESIGNATIONS SHALL ON IT BUILDING THE PERFORMANCE OF THE SEPREMENTIONS HERE A PROCESS OF CONTINUES AND THE SEPREMENTION OF THE SEPREMENTIONS HERE A PROCESS OF CONTINUES AND THE SEPREMENTIAL OF THE SEPREMENT ASSOCIATED AND THE SEPREMENTIAL OF THE SEPREMENT ASSOCIATED AND THE SEPREMENT ASSOCIATED ASSOCIATED AND THE SEPREMENT ASSOCIATED ASSOCIAT

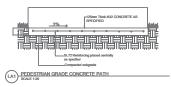


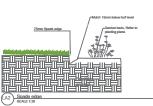


Plant Schedule


Symbol	Botanical Name	Common Name	Height at Maturity	Size	Qty
Trees					
PY	Pyrus calleryana	Callery pear	12m	45L	2
TL	Tristaniopsis laurina	Water gum	15m	25L	4
Shrubs					
Dsf	Dichondra argentea	Silver falls	200mm	140mm	30
LO	Lomandra confertifolia ssp rubiginosa	Mat Rush	0.7m	140mm	112
WE	Westringia fruticosa	Native Rosemary	1m	400mm	50
BU	Buxus microphylla	Littleleaf Box	1m	400mm	40
SM	Senecio Mandraliscae	Blue chalk sticks	0.2m	140mm	25
DR	Dianella revoluta	blue flax-lily	0.5m	140mm	80
VO	Viburnum odoratissimum	Sweet Viburnum	2m	400mm	80



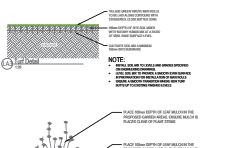

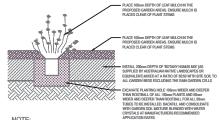

ADJUST PLANTING POSITIONS TO AVOID ROOT DAMAGE TO SURROUNDING TREE ROOTS MASS PLANTING - 150mm POTS & 50mm TUBES IN MULCHED GARDEN AREAS

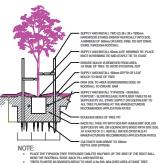

TREE PLANTING- SPADE EDGING

A Landscape plan 2-14 Gladys Ave frenchsfores PLANT SCHEDULE & DETAILS ATE: 04.08.2022 DRAWN: AZ LA06

The contractor shall check all dimensions on sit