



EROSION + SEDIMENT CONTROL

- CONNECT DRAINAGE TO STORMWATER SYSTEM AS SOON AS PRACTICABLE
- PRACTICABLE
 2. DISPOSE OF SOIL, SAND AND SILT BUILD UP ON SITE
 3. CONSTRUCTION AREA IS TO REMAIN FULLY ENCLOSED AND ANY
- BREAKS RECTIFIED IMMEDIATELY BREARS RECLIFIED IMMEDIATELY 4. FILL TRENCHES IMMEDIATELY AFTER SERVICES ARE LAID 5. MATERIALS ARE NOT TO BE WASHED INTO THE STORMWATER SYSTEM
- 6. MATERIALS AND WASTE ARE TO BE STORED AS INDICATED. CREATE DIVERSION DRAINS AROUND STOCKPILES AND COVER STORED
- MATERIALS WITH WATERPROOF COVERS.
 7. ALL PERSONNEL ON SITE MUST BE FAMILIAR WITH COUNCILS SOIL
- AND WATER MANAGEMENT GUIDELINES
- 8. MINIMISE DUST DURING CONSTRUCTION WITH WATER SPRAY, SCREENING OR COVERING AS APPROPRIATE
- 9. ANY MATERIALS FOUND TO BE PRESENT ON COUNCILS FOOTPATH, KERB, GUTTER OR ROAD MUST BE CLEANED IMMEDIATELY AFTER BEING IDENTIFIED. NO MATERIALS ARE TO BE WASHED INTO COUNCIL'S STORMWATER DRAINAGE SYSTEM

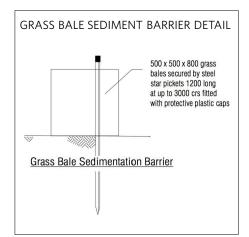

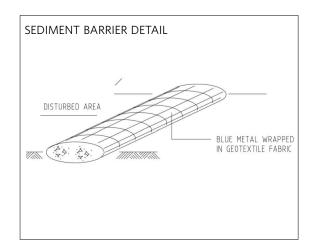


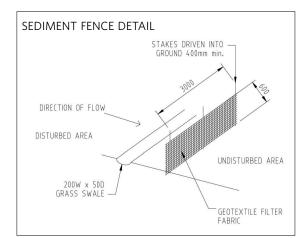

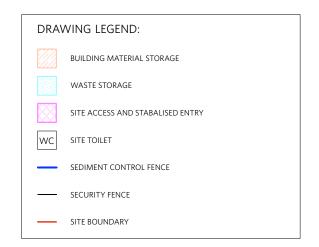

STORMWATER CONCEPT PLAN

THIS DRAWING IS A DRAINAGE CONCEPT DRAWING ONLY. FURTHER DETAIL IF REQUIRED TO BE PREPARED BY A QUALIFIED HYDRAULIC ENGINEER OR LICENSED PLUMBER. ALL STORMWATER DRAINAGE TO BE INSTALLED IN ACCORDANCE WITH AS 3500.3. CONTRACTOR TO VERIFY LOCATION AND RELOCATE AS NECCESSARY ALL SERVICES ONSITE, GAS, SEWER, ELECTRICITY EAVES GUTTER TO HAVE MINIMUM FALL OF 1 IN 200. INSTALLATION OF GUTTERS & DOWNPIPES IS TO BE IN ACCORDANCE WITH AS2179 & AS2180. THE PLUMBING CONTRACTOR SHALL UNDERTAKE AN AUTHORITIES SERVICES SEARCH & OBTAIN ALL AVAILABLE INFORMATION ON AUTHORITES SERVICES WITHIN THE STREET & SITE AREA. DIAL BEFORE YOU DIG (PHONE 1100)

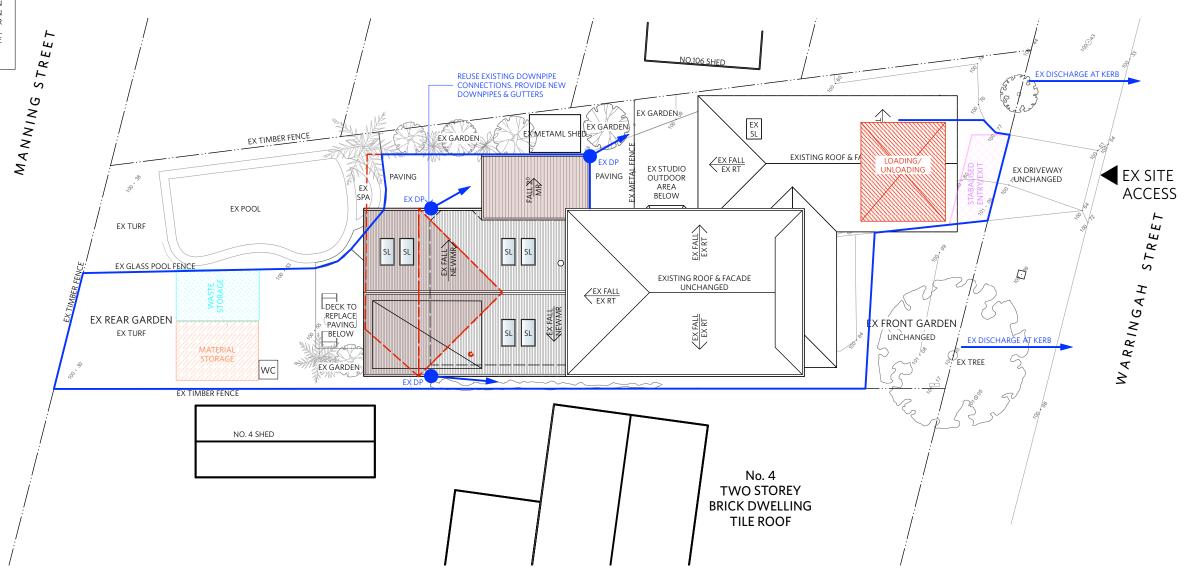





DRAFT FOR CLIENT REVIEW ISSUED FOR DA

I ISSUE No.

LEGEND: PROPOSED STRUCTURE TO BE DEMOLISHED

SETBACKS

LINE OF STRUCTURE
OVER / UNDER

COLUMN CHECK ONSITE DOOR DOOR
DOWNPIPE
EXISTING
FIBRE CEMENT
FACE BRICK
METAL ROOFING
PLASTERBOARD
POLYCARBONATE ROOF
PAINTED BRICKWORK
ROOF TILE
SCREEN
WINDOW

FOR DEVELOPMENT APPLICATION (NOT FOR CONSTRUCTION)

These drawings are to be read in conjunction with all other relevant drawings, specifications and documentation, including consultants documentation. Any diserror or omission found between this document and other relevant documentatio immediately referred to PASSER Architects for clarification prior to any action.

All design, materials and workmanship must be in accordance with all relevant Australian Standards and building codes.

Figure dimensions take precedence over those scaled from the drawing: This drawings has been produced for its agreed intended use only.

DRAWING TITLE

STORMWATER CONCEPT PLAN & **SEDIMENT & EROSION CONTROL**

PROJECT

WARRINGAH HOUSE

2 WARRINGAH STREET, NORTH BALGOWLAH, NSW 2093 for WILLIAM + LYNETTE KENNEDY

DRAWING No: **DA08**

ISSUE: PROJECT: 1903 SCALE: 1:200 @ A3 DATE: FEB 2019