# CIVIL DESIGN PLAN FOR PROPOSED RESIDENTIAL DEVELOPMENT AT 54 BARDO ROAD, NEWPORT, NSW

### GENERAL NOTES.

- 1. ALL WORKS TO BE CARRIED OUT IN ACCORDANCE WITH COUNCIL'S STANDARDS AND SPECIFICATIONS AS DIRECTED BY THE ENGINEER
- 2. THE CONTRACTOR IS NOT TO ENTER UPON NOR DO ANY WORKS WITHIN ADJACENT LANDS WITHOUT THE WRITTEN PERMISSION OF THE LAND OWNER.
- 3. ALL FILLING TO BE COMPACTED TO A MINIMUM 95% OF THE STANDARD MAXIMUM DRY DENSITY AS TESTED IN ACCORDANCE WITH E1.1 OF AS1289-1977
- FILL MATERIAL TO BE APPROVED BY THE CONSTRUCTION ENGINEER.
- SURPLUS EXCAVATED MATERIAL TO BE PLACED WHERE DIRECTED BY THE ENGINEER.
- 6 ALL NEW WORKS TO MAKE SMOOTH JUNCTION WITH EXISTING CONDITIONS.
- 7. A MINIMUM 50mm APPROVED GRANULAR BEDDING TO BE PROVIDED BENEATH ALL CONCRETE.
- 8 ALL CONCRETE WORKS TO BE CONSTRUCTED TO GRADE 32MPa CONCRETE U.N.O.
- ALL DISTURBED TURFED AREAS AND BATTERS TO BE TOPSOILED, TURFED OR SPRAY GRASSED. 9
- 10 ALL MEASUREMENTS IN METRES UNLESS OTHERWISE NOTED.
- 11 MEASUREMENTS SHALL BE TAKEN FROM THE FIGURED DIMENSIONS AND ARE NOT TO BE SCALED FROM THE DRAWINGS.
- 12 PROVISION FOR TRAFFIC CONTROL DURING CONSTRUCTION TO BE IN ACCORDANCE WITH AS 1742.3 - 2009.
- 13 DRAINAGE LINES ON PLANS ARE DIAGRAMMATIC ONLY AND PIPE CENTRELINES SHALL ENTER AND EXIT PITS AT THE CENTRE OF THE RESPECTIVE PIT WALLS.
- 14 EROSION AND SEDIMENT CONTROLS ARE TO BE IMPLEMENTED IN ACCORDANCE WITH E.P.A. REQUIREMENTS.
- 15 CONTRACTOR IS TO CLEAR SITE BY REMOVING ALL SURPLUS SPOIL, RUBBISH, ETC.
- 16 UTILITY INFORMATION SHOWN ON THE DRAWINGS IS INTENDED TO DEPICT THE PRESENCE OF SERVICES ONLY. ACTUAL LOCATION SHOULD BE VERIFIED ON SITE PRIOR TO CONSTRUCTION.

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DRAWING SCHEDULE										
SHEET No.	DESCRIPTION	REV.								
C00	COVER SHEET, GENERAL NOTES, LOCALITY SKETCH & DRAWING SCHEDULE	А								
C01	BASEMENT & GROUND FLOOR PLAN	А								
C02	SECTION 1-1 DRIVEWAY LONGITUDINAL SECTIONS	А								
C03	STANDARD DRAWINGS	А								



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Nominated Architects:

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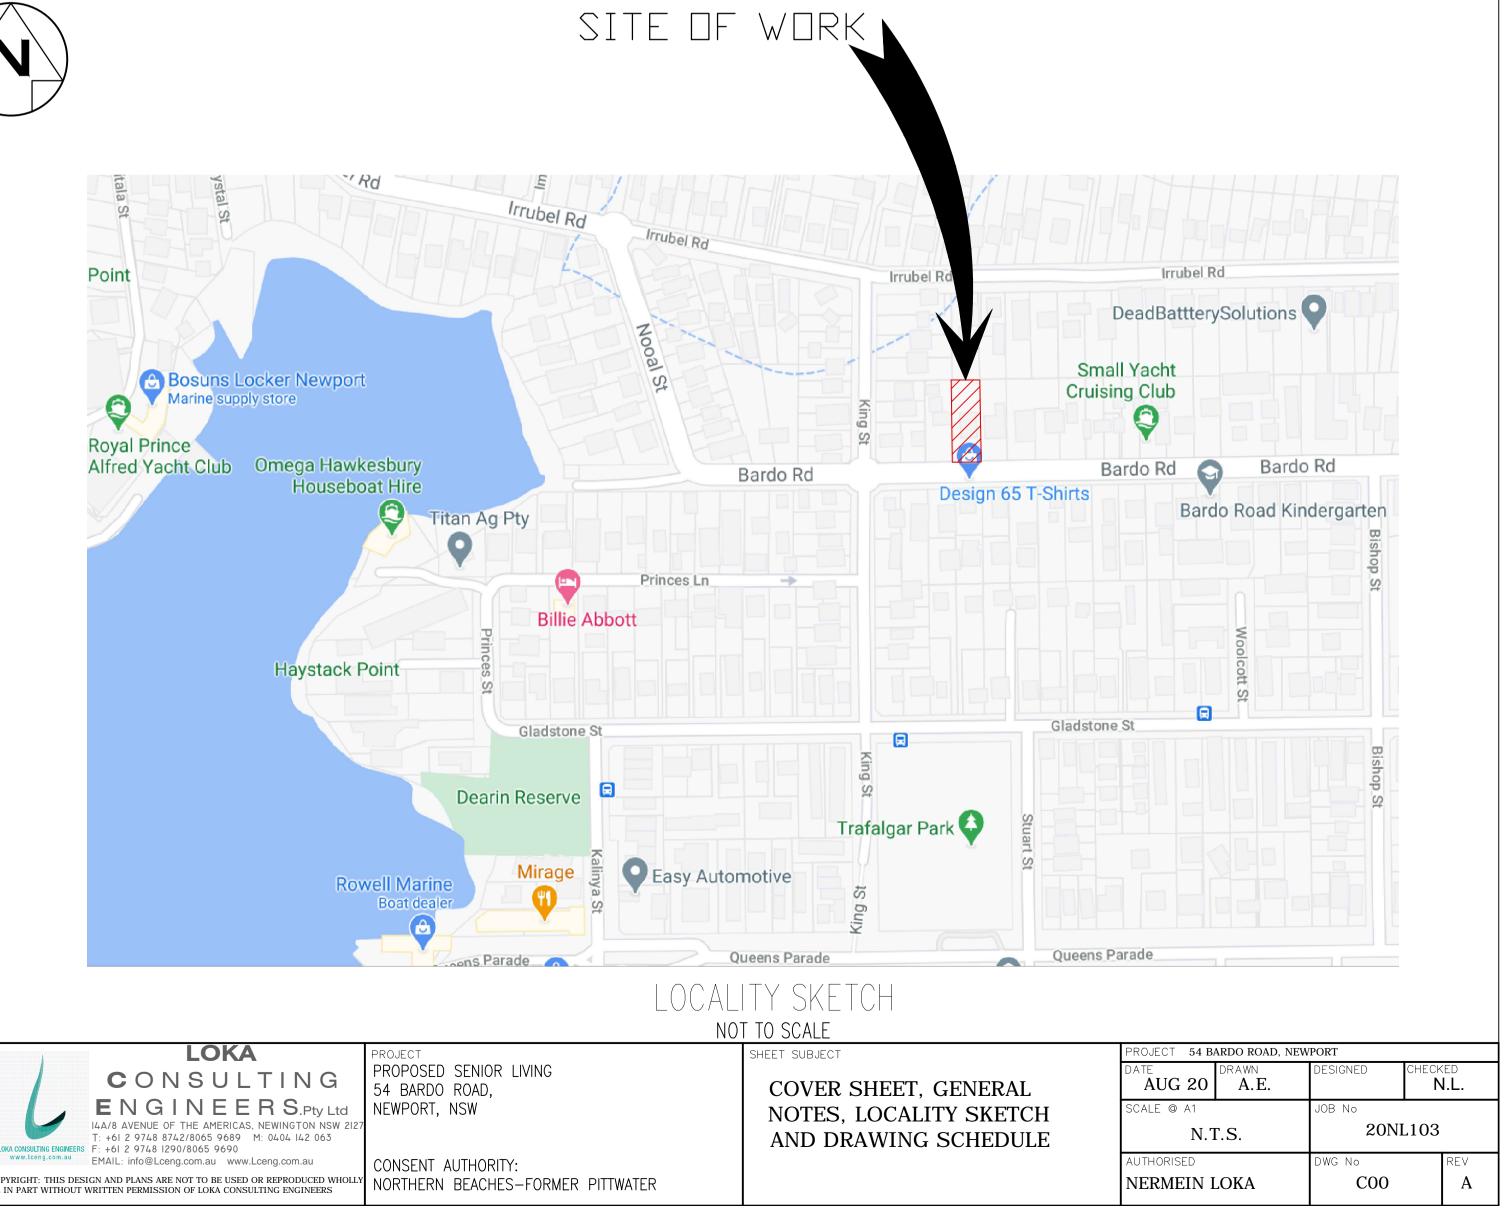
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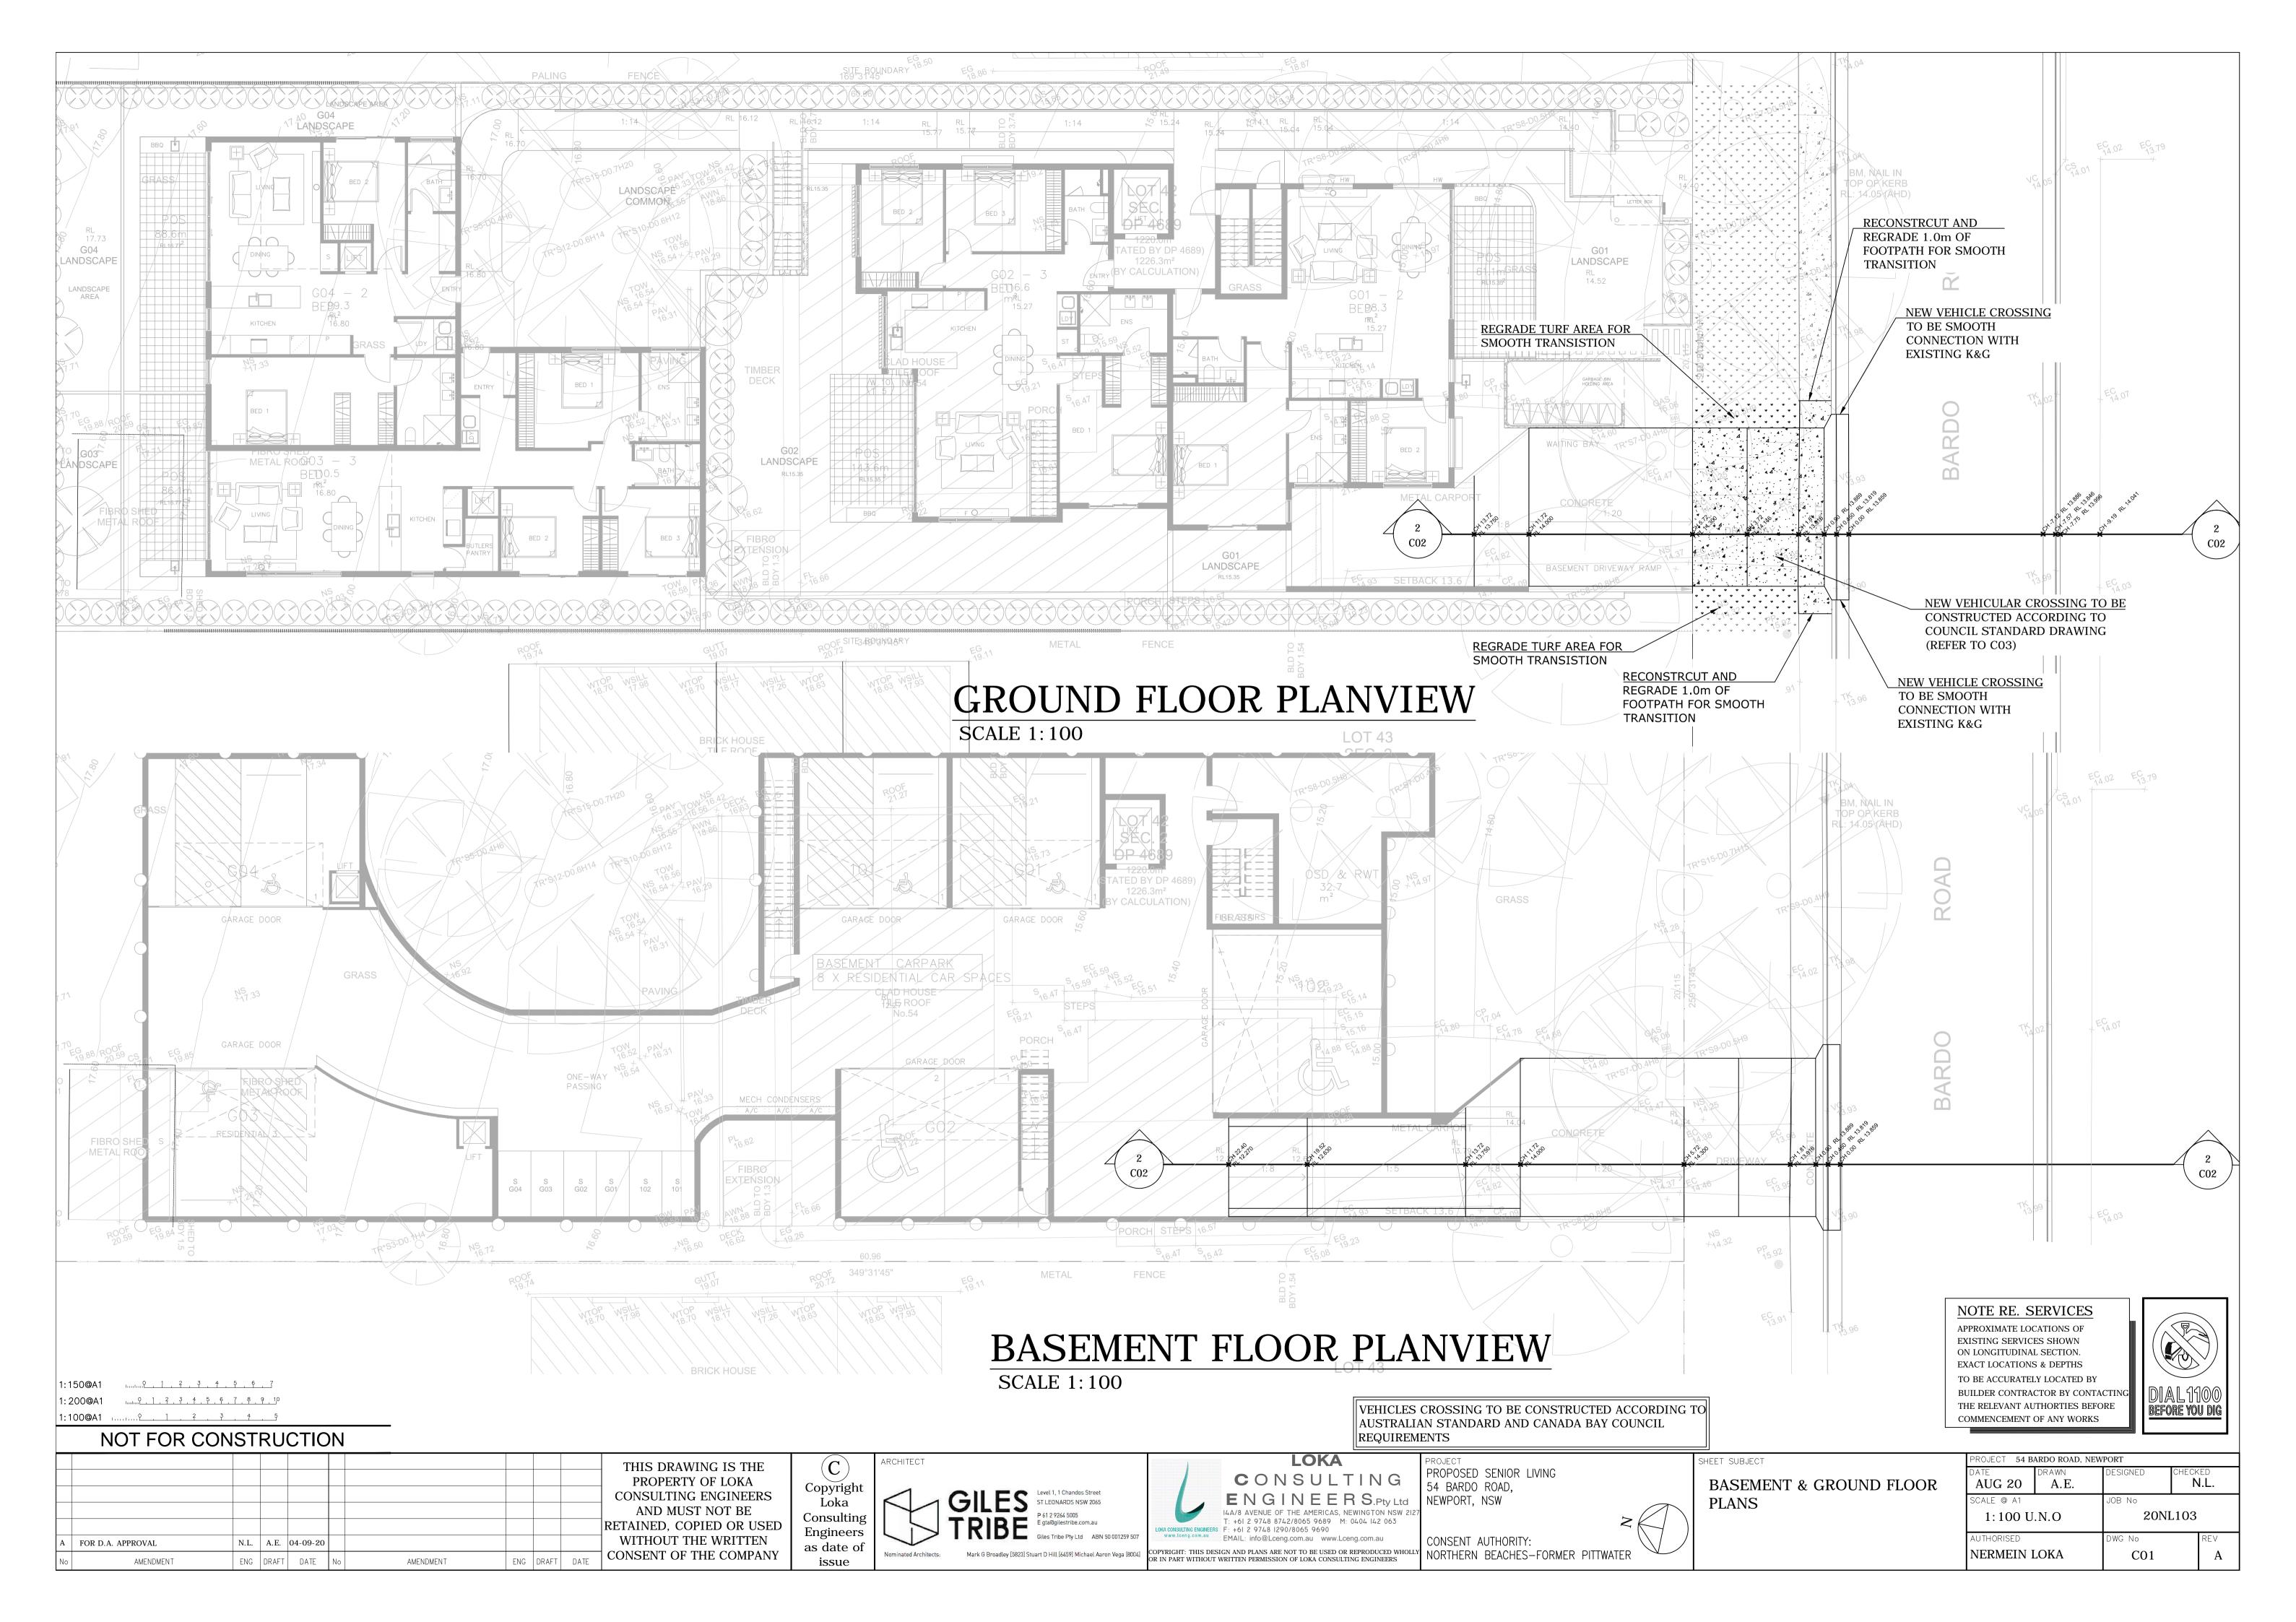
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P 61 2 9264 5005

Mark G Broadley [5823] Stuart D Hill [6459] Michael Aaron Vega [80



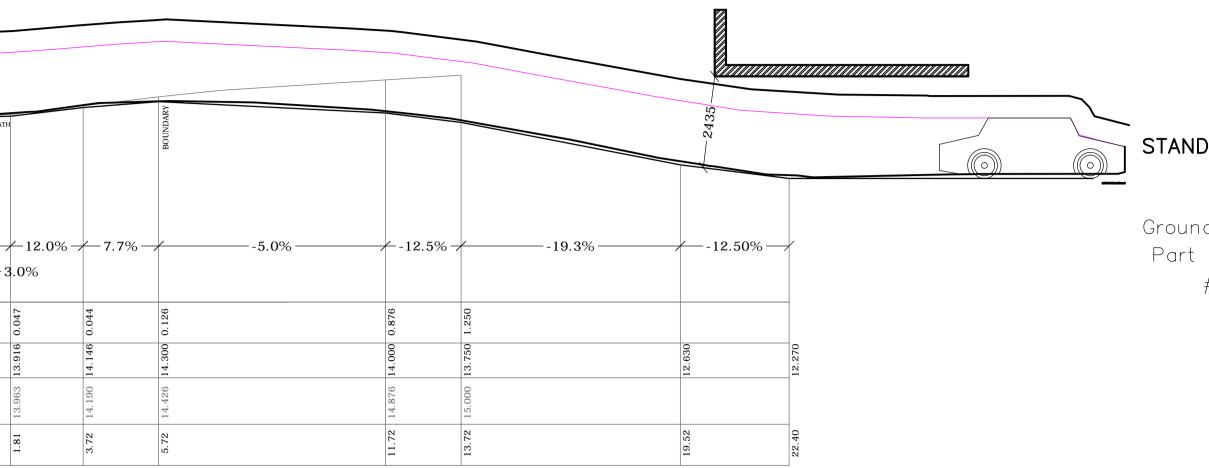




B85 STANDARDS 2004	(AU_	_NZ)												_
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	LEVEL DIFFERENCE							(D)		0.000	0.000	0.000	0.030	
	DESIGN LEVEL							(ASSUMED)		13.859			13.889	4
	NATURAL 	14.041	13.996	13.996	13.846	13.886		13.957		13.859			13.919	
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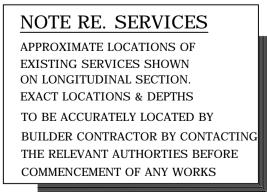
## SECTION 1-1

SCALE 1:100



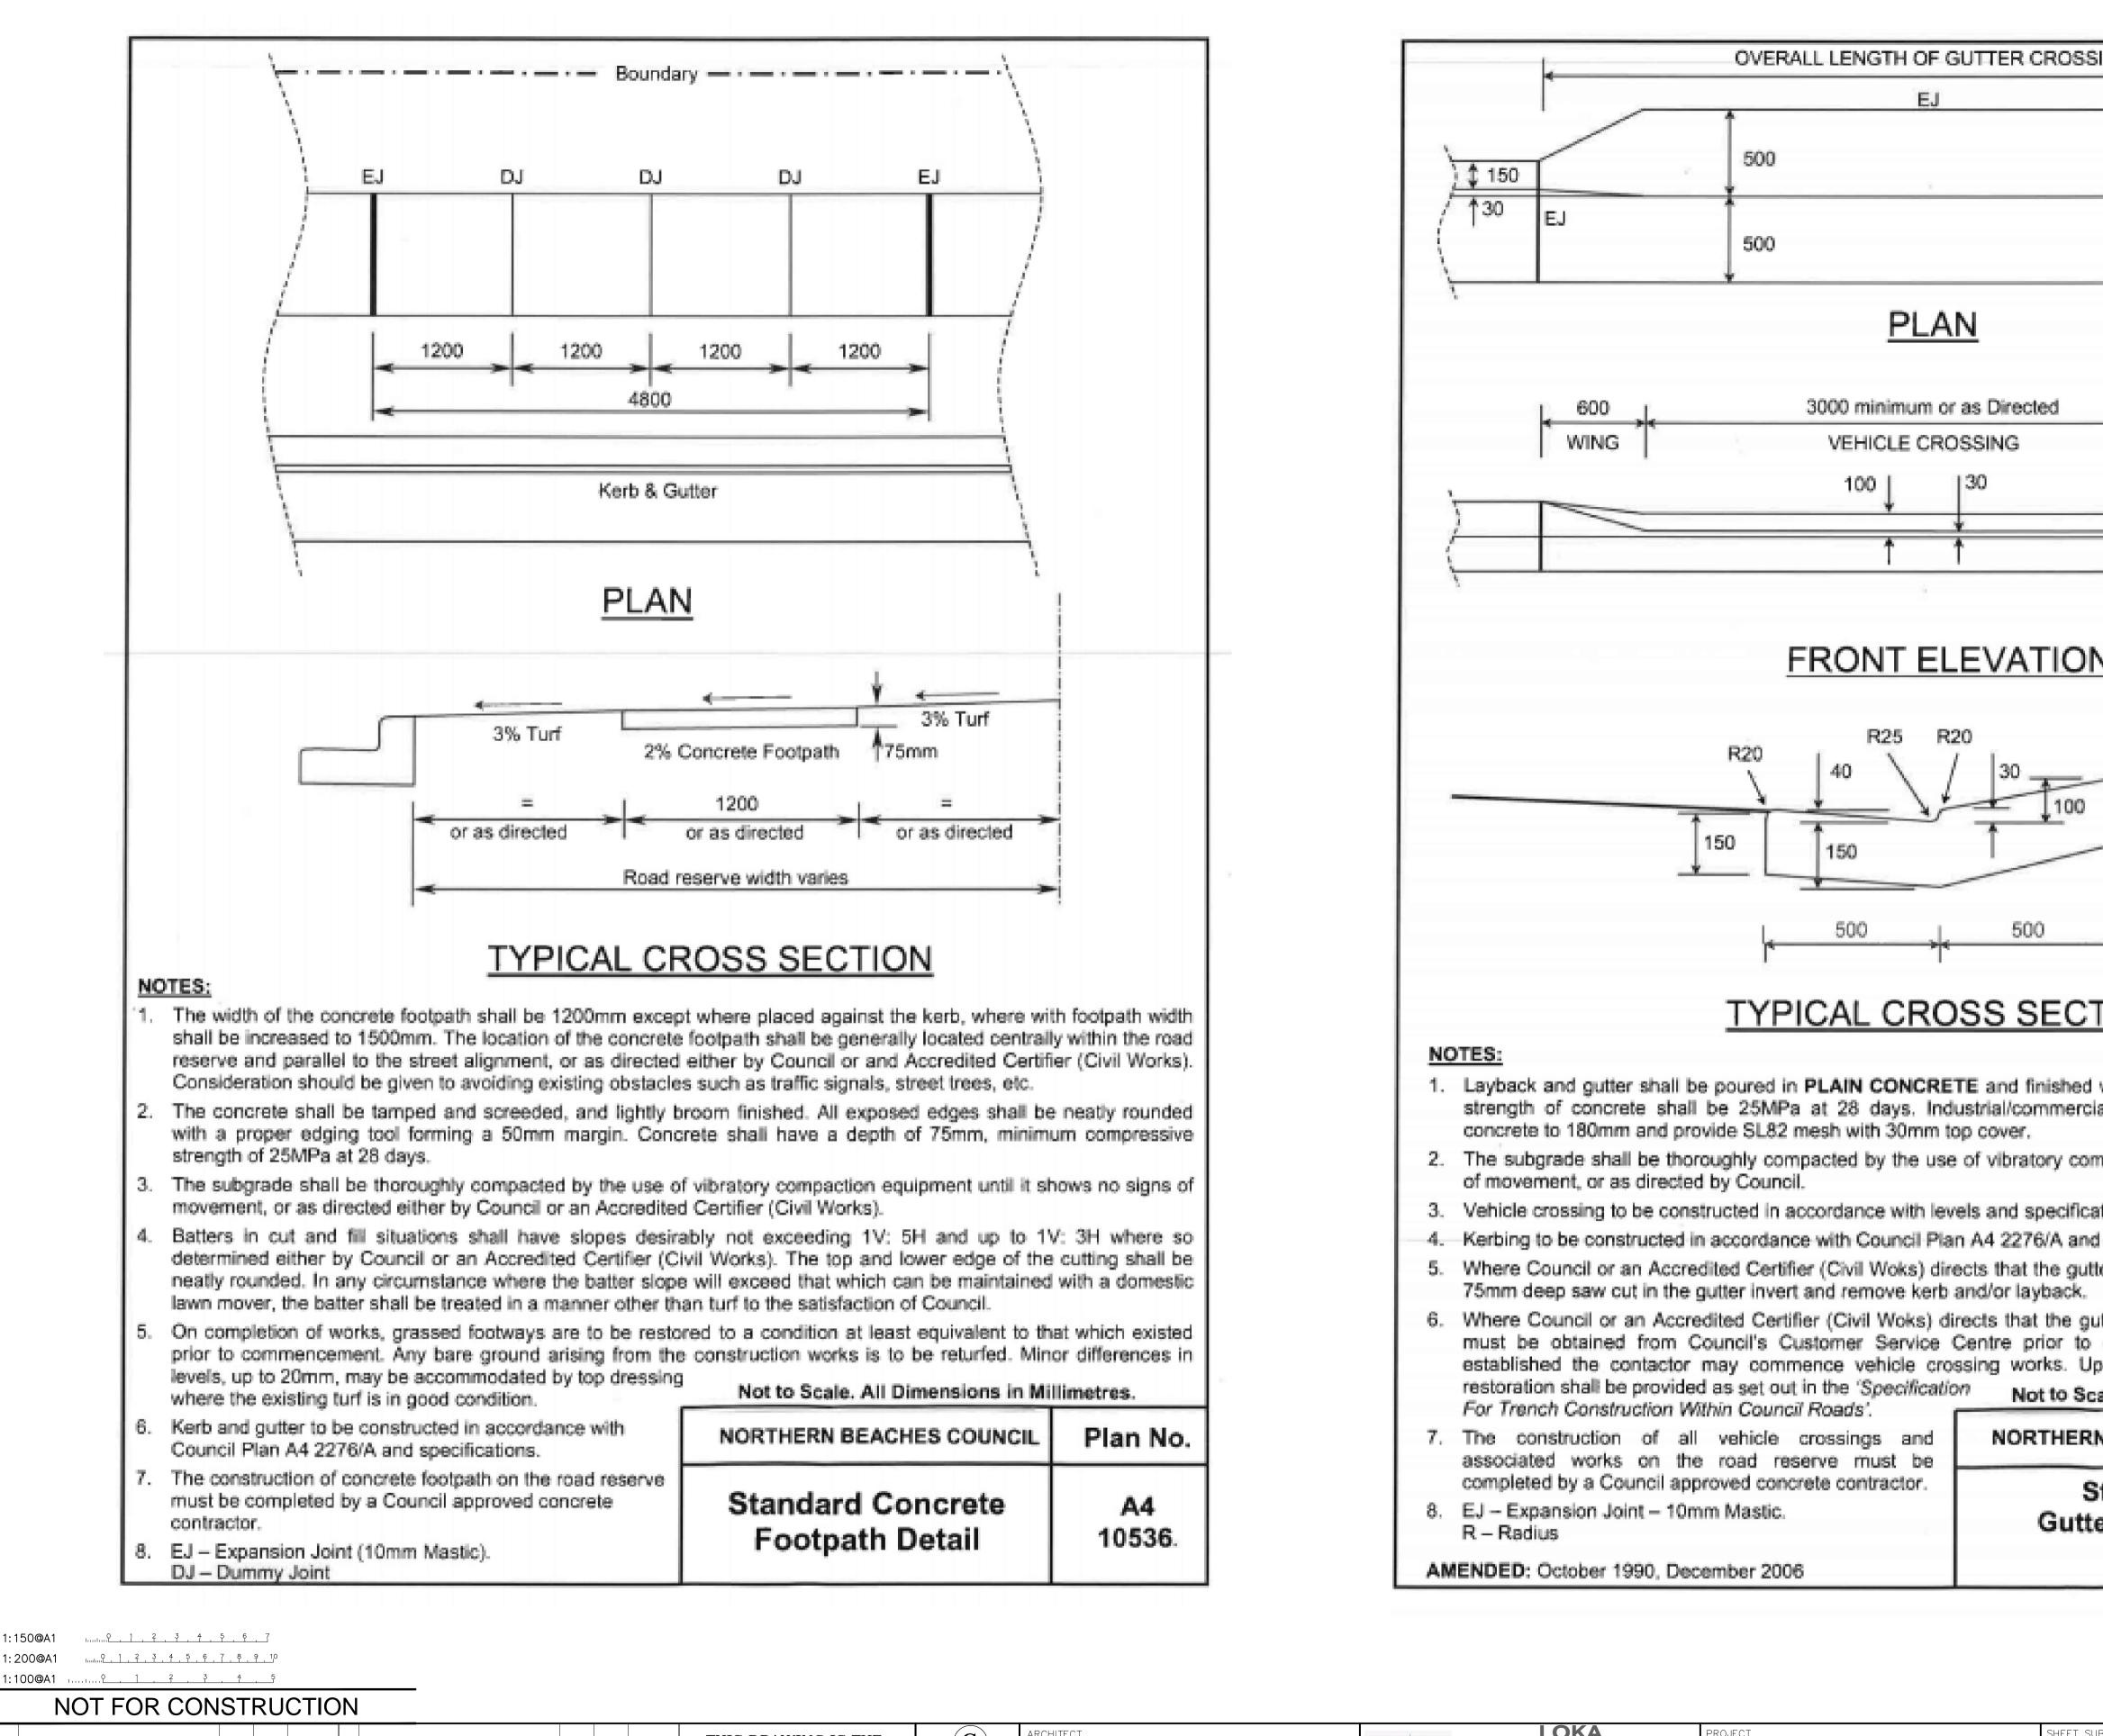
## B85 STANDARDS 2004 (AU\_NZ)

Ground Clearance (units: mm) Part # Front Wheelbase Rear #1 120 120 120





SUBJECT	PROJECT 54 BARDO ROAD, NEWPORT							
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Standard ter Crossing Detail	A4 2276/B				
SUBJECT	DATE DRA	A.E.	PORT DESIGNED JOB No 20NI	снеске <b>N</b> . 2103	
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