

04/12/24 A

DATE REV

14/11/24

DA ISSUE

CONSULTANT ISSUE

AMENDMENTS

C COPYRIGHT BUILDING DESIGN & TECHNOLOGY.

APPLICATION PREPARED BY: MARK MAKHOUL Shop 2,15 Bransgrove St Wentworthville 2145, PO Box 795 Kings Langley NSW 2147 Ph: 02 9687 0814 Moh: 0412 109 759 E-mail: mark@build-design.com.au

PROPOSED DUPLEX LOCATED AT 41 FERGUSON ST FORESTVILLE **DEMOLITION PLAN** SCALE: 1:100 @ A1 DRAWN: MM PROJECT DATE: OCT 2024 CHECKED: REV: A PROJECT No. 202426 DWG No. DA 0.02

HOT WATER UNIT ELECTRIC BOOSTED SOLAR HOT WATER UNIT TO BEST LOCATION BY OTHERS WITH 15 STCs CREDITS.

<u>WATER SAVING FITTINGS</u> 4 STAR (4.5-6L/M) SHOWER HEAD & WATER SAVING FITTINGS ARE TO BE INSTALLED

TO ALL KITCHEN & BASIN TAPS. DUAL FLUSH 4 STAR TOILETS ARE ALSO TO BE INSTALLED.

INSULATION- WALLS
R2.5 XPS FOIL BOARD TO EXTERNAL LOWER GROUND CONC WALLS. 10mm FOILBOARD INSULTATION TO EXTERNAL CAVITY BRICK WALLS TO GROUND FLOOR.

R2.5 BULK INSULTATION TO STUD WALL WITH FC CLADDING WITH FOIL SARKING. R2.5 TO STUD WALL WITH TIMBER CLADDING WITH FOIL SARKING. R2.5 XPS FOIL BOARD TO INTERNAL WALLS TO GARAGE FOYER.

INSULATION- FLOORS
R3.0 XPS FOIL BOARD TO EXPOSED OUTDOOR SLAB WITH AIR BELOW.

INSULATION- ROOF/CEILINGS R1.5 ANTICON FOIL BACKET BLANKET TO UNDER METAL ROOFING. R3.0 BATT INSULATION TO CEILINGS BELOW COLORBOND ROOF. R3.0 XPS FOIL BOARD TO CONC ROOF AREA.

EXTERNAL WALLS/ROOFING- SOLAR ABSORPTANCE
LOWER GROUND FLOOR CONC WALLS- SOLAR ABSORPTANCE MEDIUM 0.475-0.7

GROUND FLOOR WALLS- SOLAR ABSORPTANCE LIGHT 0.475

FIRST FLOOR FC CLADDING WALLS- SOLAR ABSORPTANCE DARK 0.70

COLORBOND ROOFING & CONC SLAB - SOLAR ABSORPTANCE LIGHT <0.475-0.70

HEATING & COOLING
1 PHASE DUCTED A/C WITH A 4 STAR RATING FOR COOLING & HEATING WITH ZONING TO LIVING & BEDROOM AREAS.

RAINWATER TANK
NEW 1,500L RAINWATER TANK TO EACH UNIT IS TO BE INSTALLED & CONNECTED TO LAUNDRY TAPS,
LANDSCAPED AREA & ONE OUTDOOR TAP WITHIN 10M OF POOL FOR BOTH UNITS.
A MIN 68sqm OF EACH ROOF AREA IS TO BE COLLECTED.

OVERFLOW IS TO BE CONNECTED TO DRAINAGE SYSTEM.

<u>POOL</u>
MAX 9 KL OUTDOOR POOL WITH A TIMER INSTALLED TO THE 4 STAR POOL PUMP. THE POOL MUST
HAVE A COVER & LOCATED OUTDOORS. ELECTRIC HEAT PUMP HEATING IS TO BE INSTALLED TO EACH POOL.

KITCHEN APPLIANCES
INDUCTION COOKTOP WITH ELECTRIC OVEN TO BE INSTALLED IN KITCHEN.

<u>VENTILATION</u>
ALL BATHROOMS, ENSUITES, LAUNDRY & KITCHEN ARE TO HAVE INDIVIDUAL DUCTED MECHANICAL VENTILATION WITH MANUAL ON/OFF SWITCH DUCTED TO ROOF OR FACADE.

ALL FRIDGE SPACES TO BE WELL VENTILATED.

 $\frac{\text{ARTIFICIAL LIGHTING}}{\text{THE PRIMARY TYPE OF LIGHTING TO BE LED OR FLUORESCENT TO ALL ALL AREAS}.}$


WINDOWS & SKYLIGHTS
WINDOWS TO BE ALUMINIUM FRAMED WITH A UW VALUE 3.6/5.4 & SHGCW 0.47/0.58. IN ACCORDANCE WITH BASIX/NatHERS CERTIFICATE.

NATURAL LIGHTING OR SKYLIGHTS TO AT LEAST 4 BATHROOMS.

SKYLIGHTS IF REQUIRED TO BE ALUMINIUM FRAMED DOUBLE GLAZED LOW E ARGON FILLED WITH A Uw VALUE 2.7 & SHGCw 0.24 IN ACCORDANCE WITH BASIX/NatHERS CERTIFICATE

ALTERNATIVE ENERGY
DEVELOPMENT MUST INCLUDE A PHOTOVOLTAIC SYSTEM WITH THE CAPACITY TO GENERATE 1.0KW OF ELECTRICITY INSTALLED AT AN ANGLE OF BETWEEN 0-10 DEG FACING NORTH EAST.

CLOTHES DRYING AREA
1 OUT DOOR CLOTHES DRYING AREA TO BE INSTALLED TO TO LOCATION AS DIRECTED

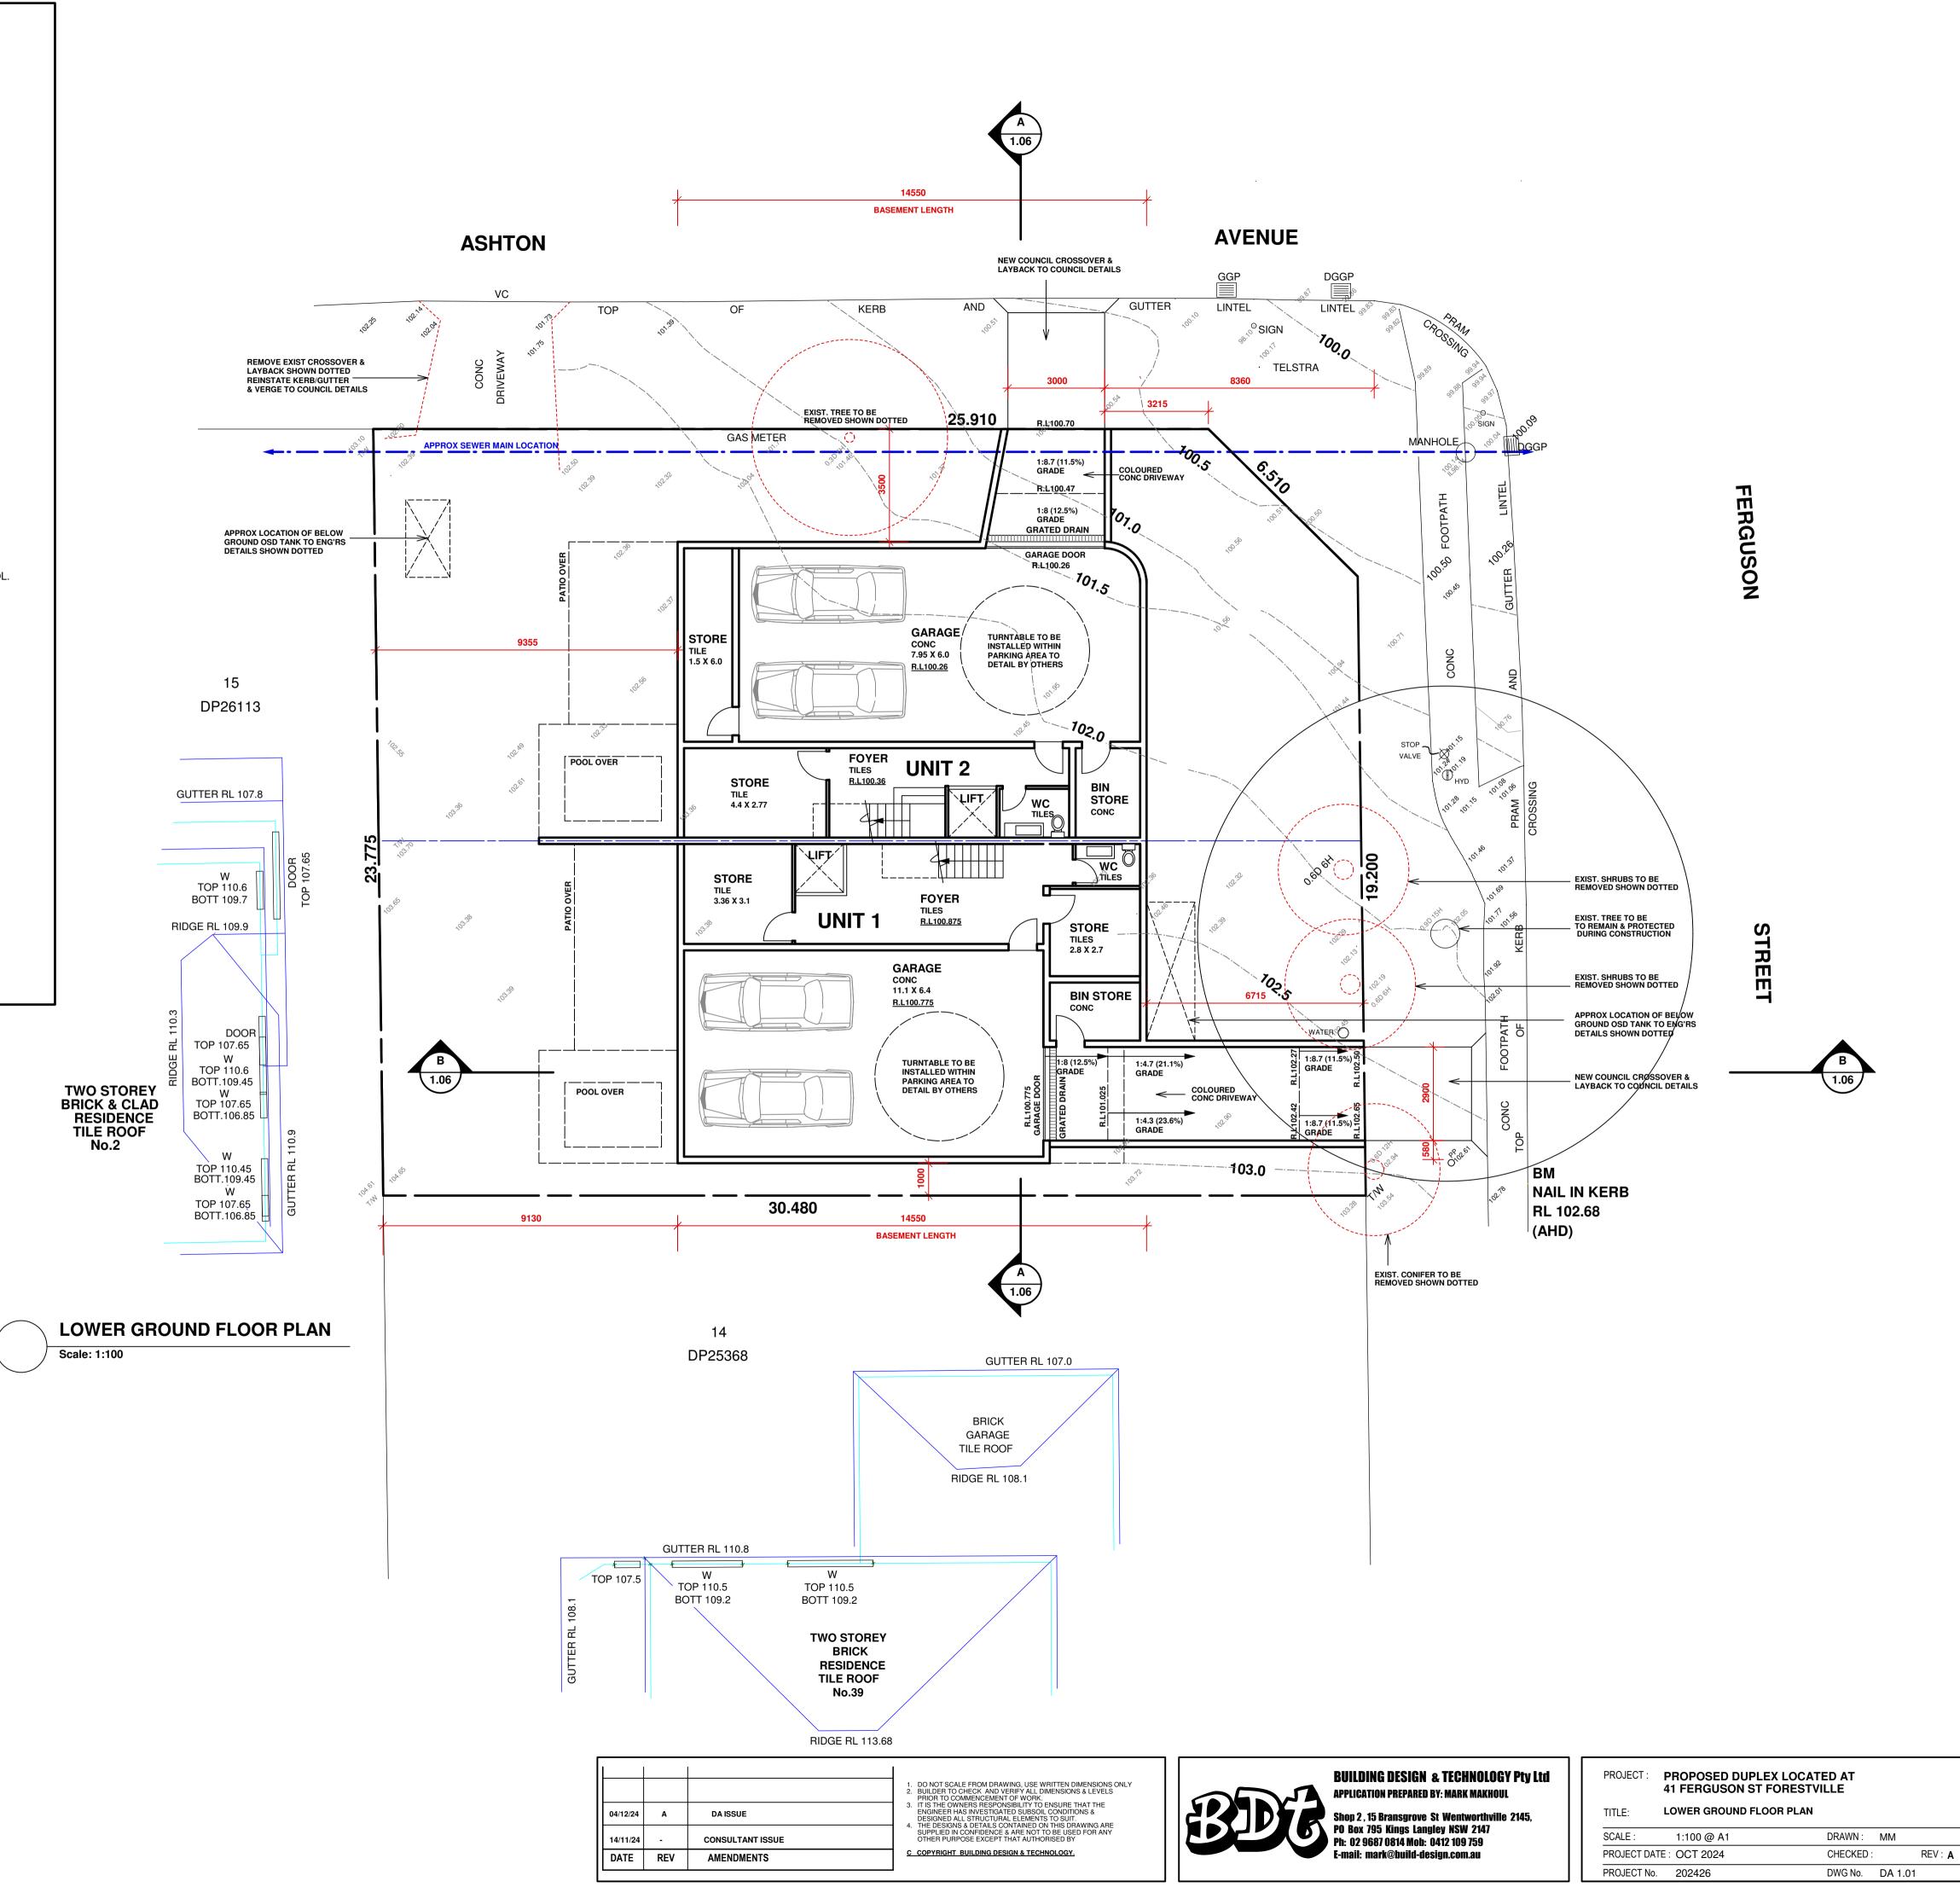

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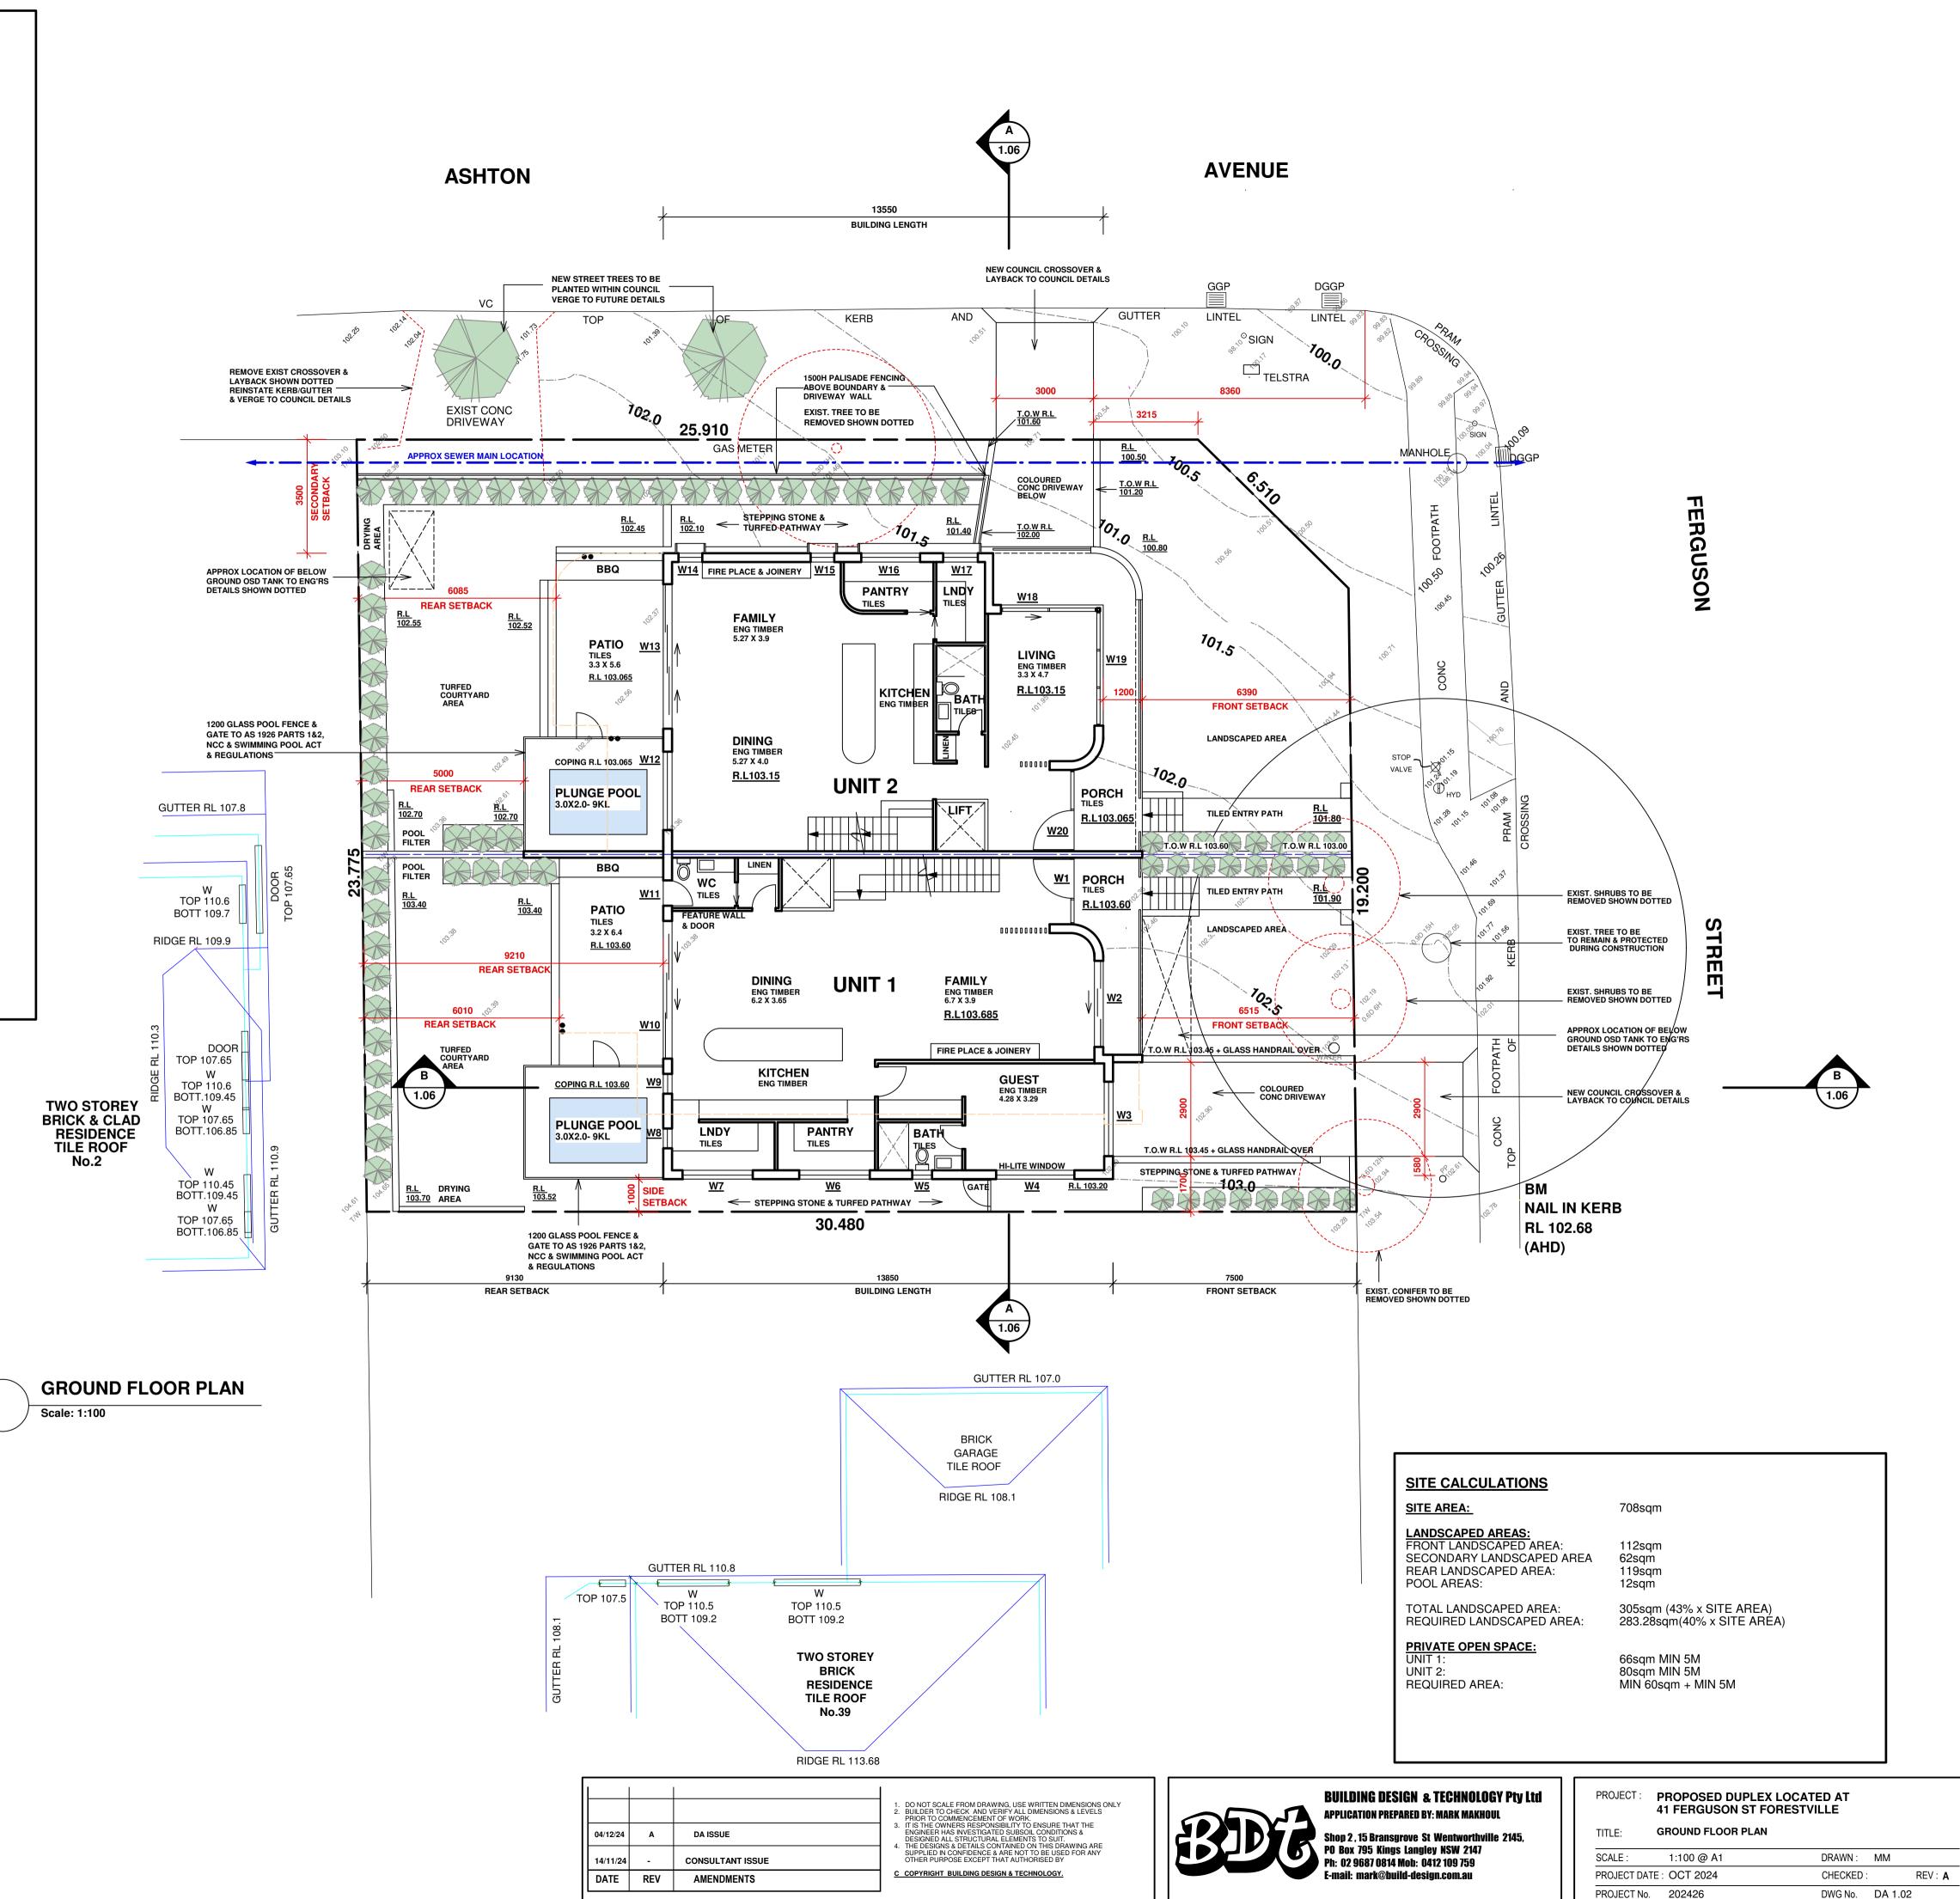
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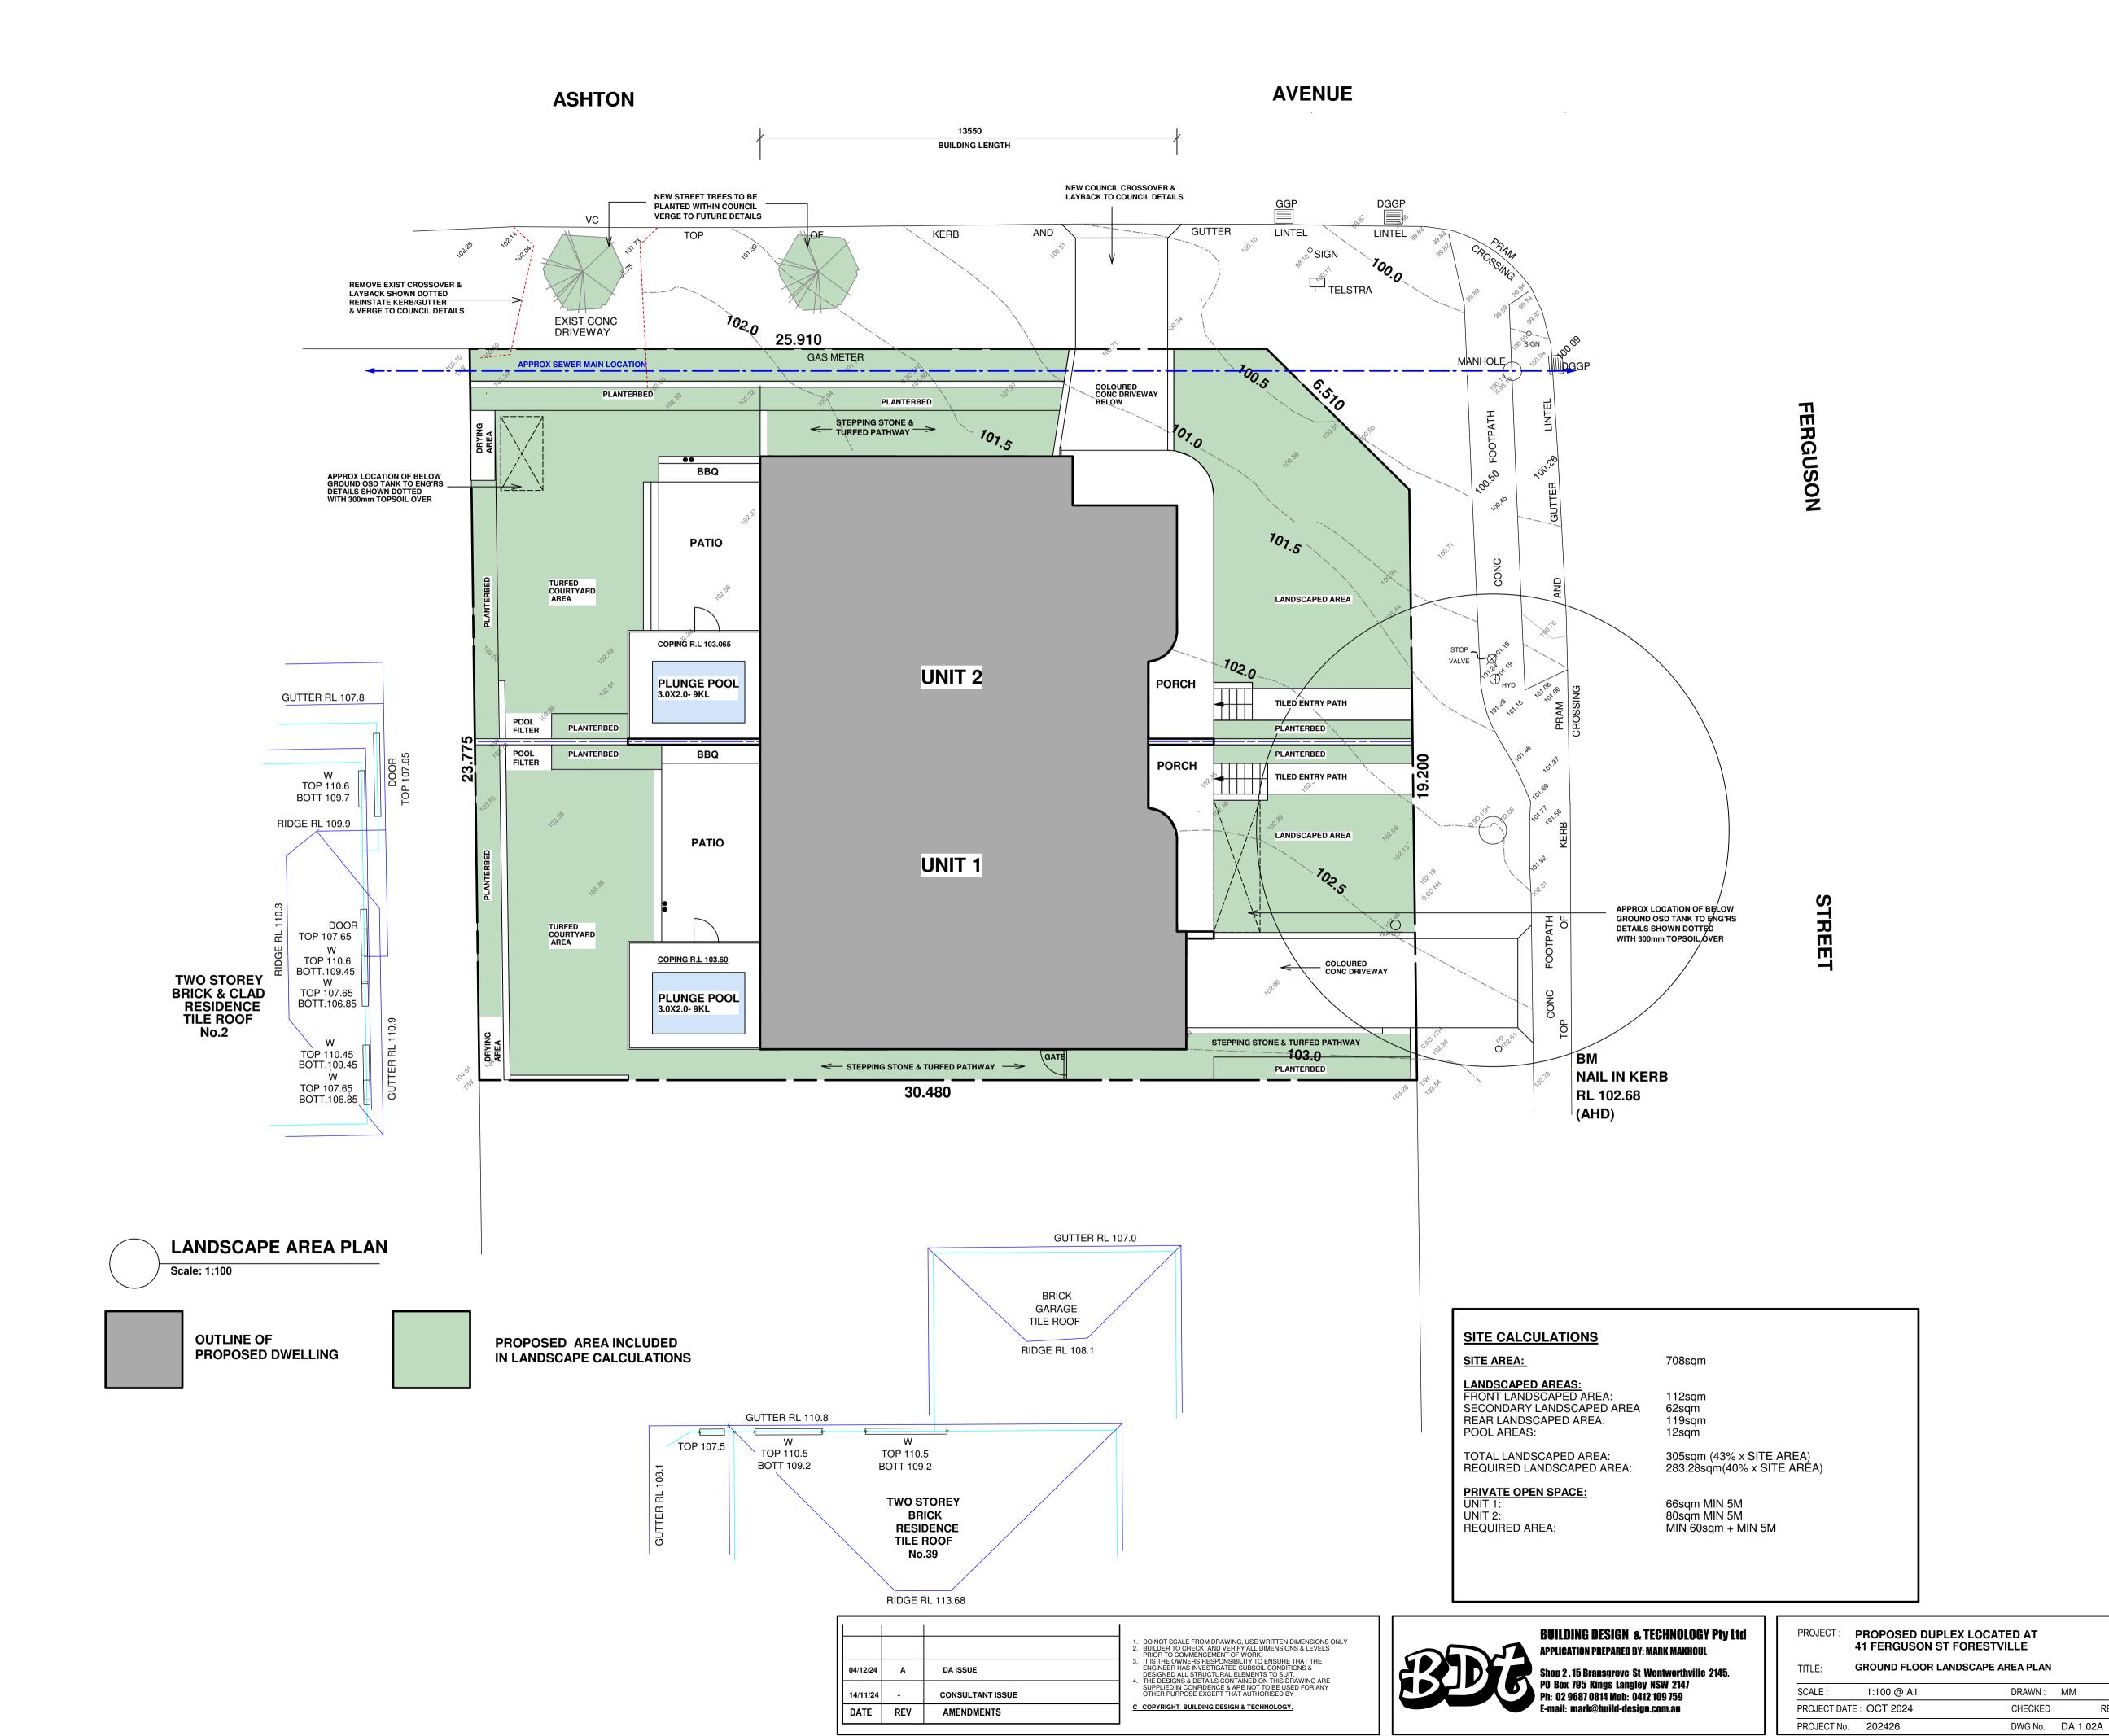
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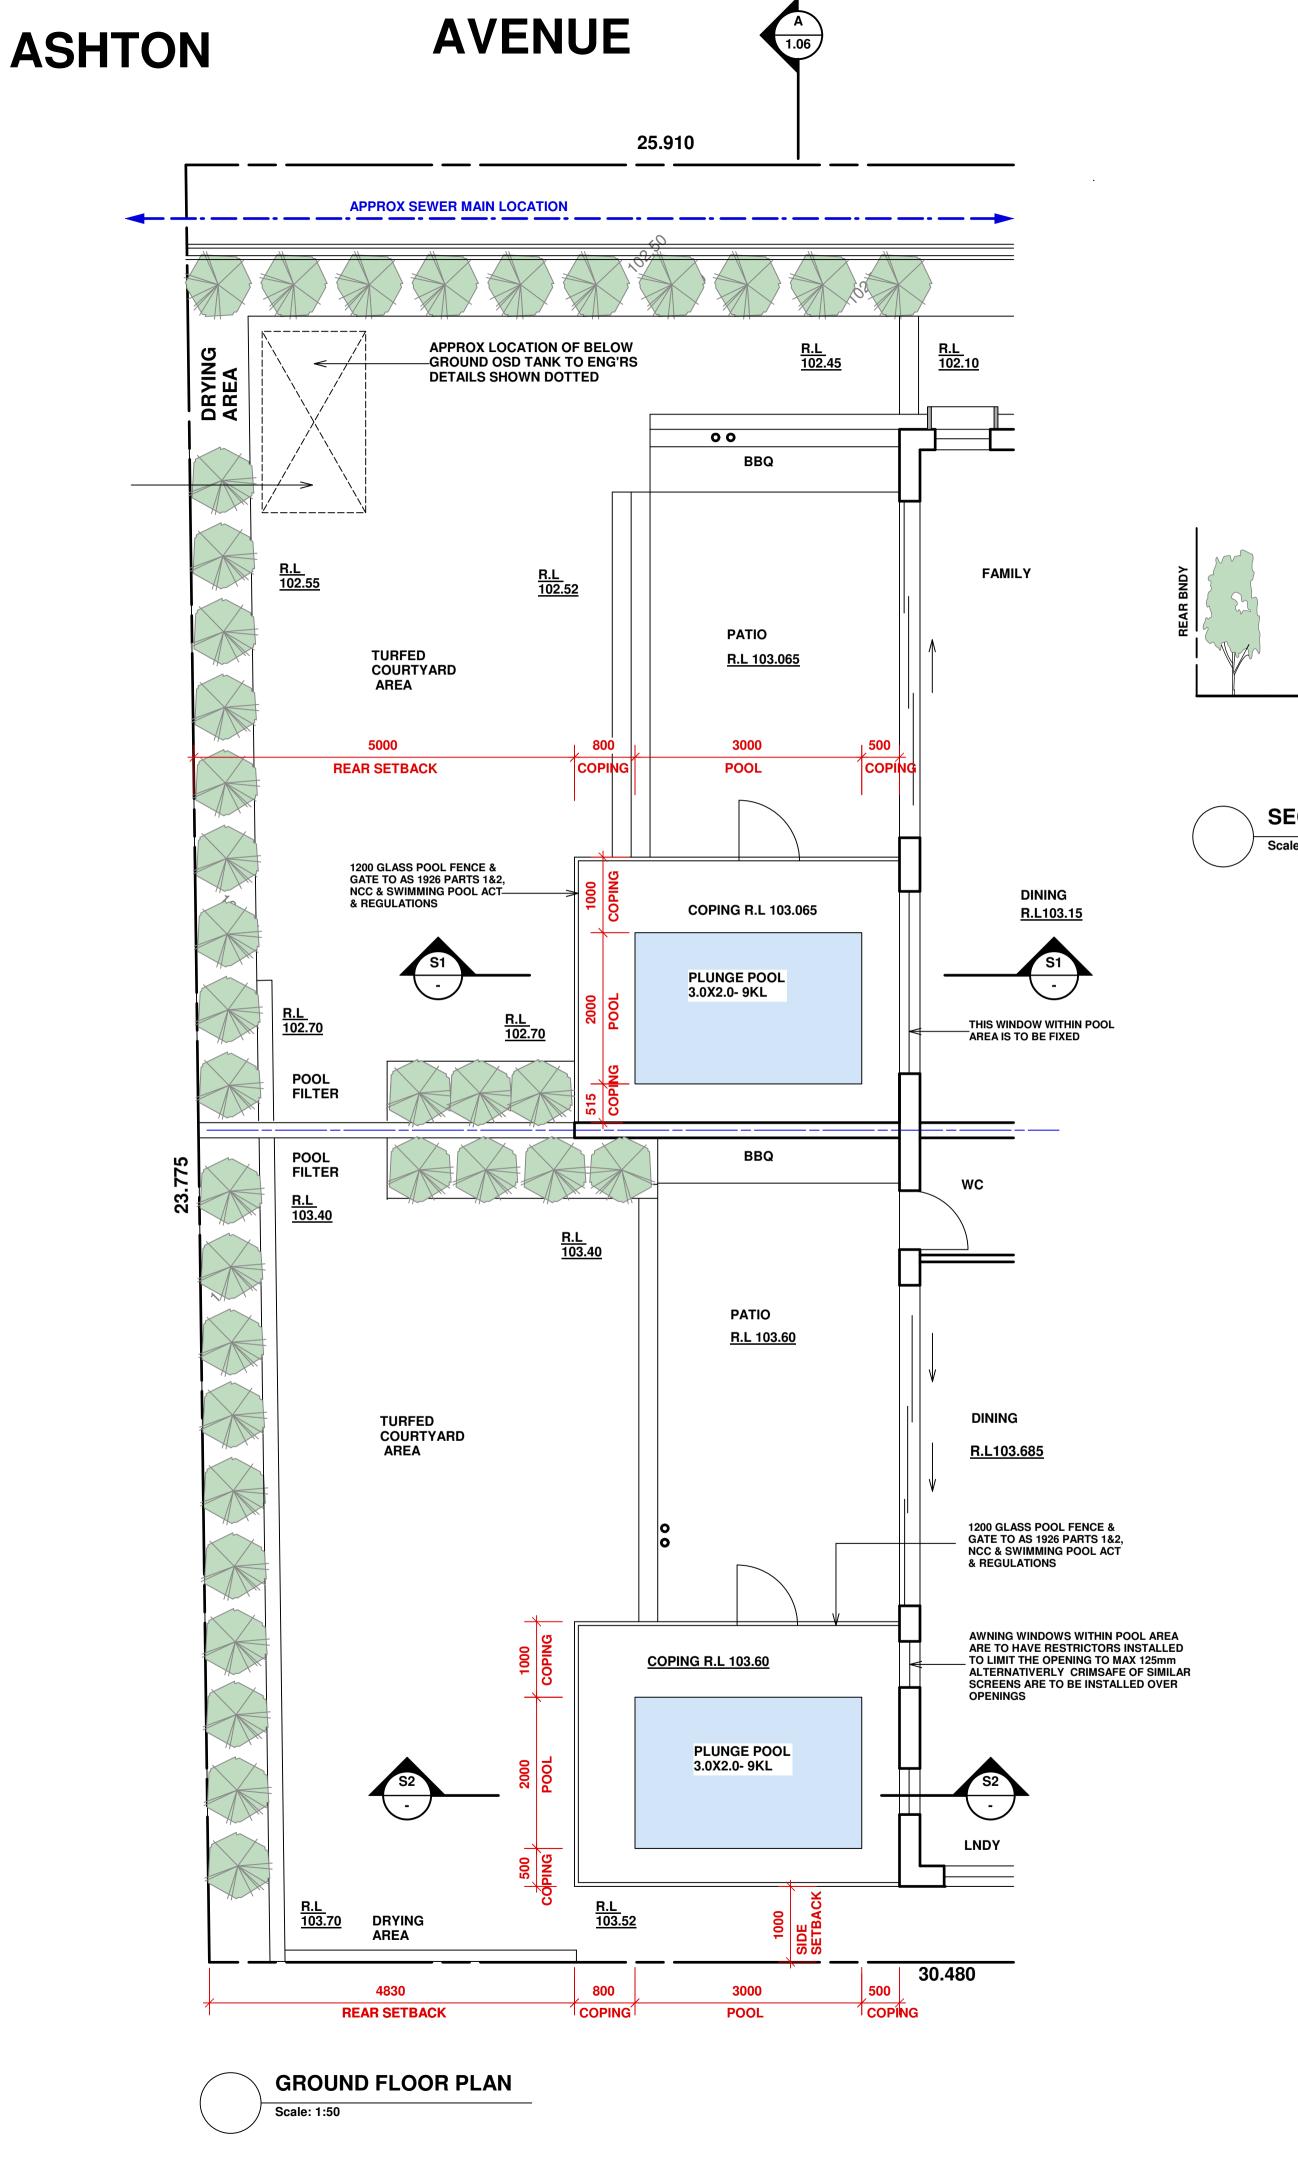
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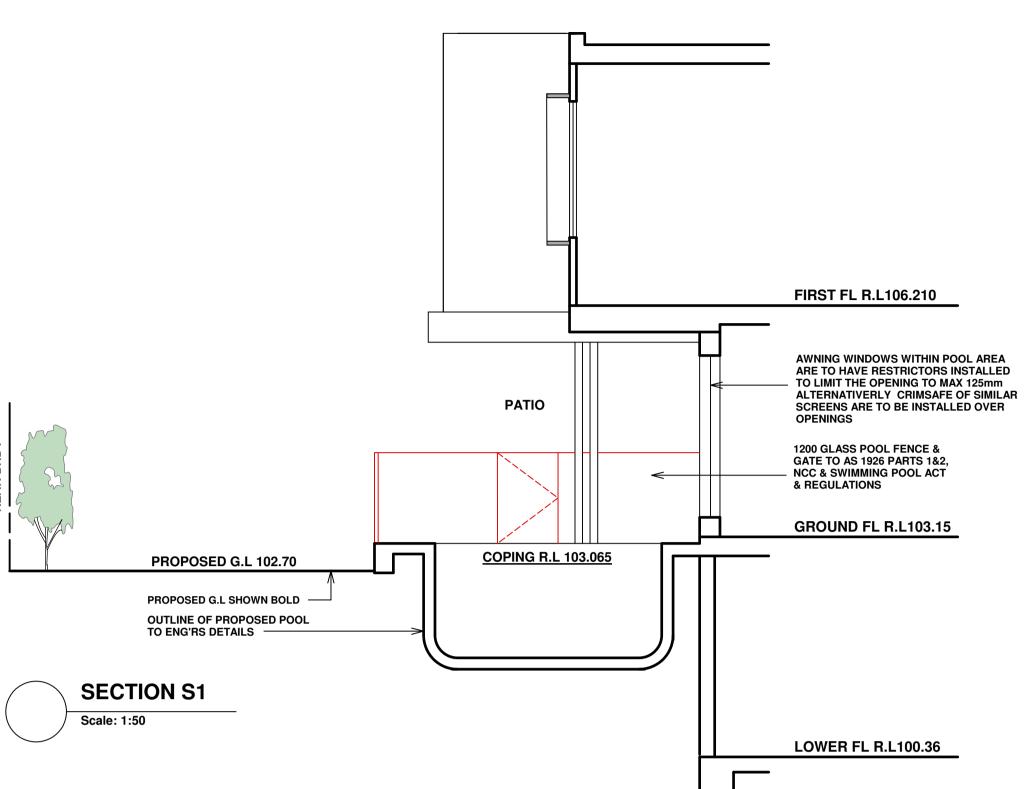
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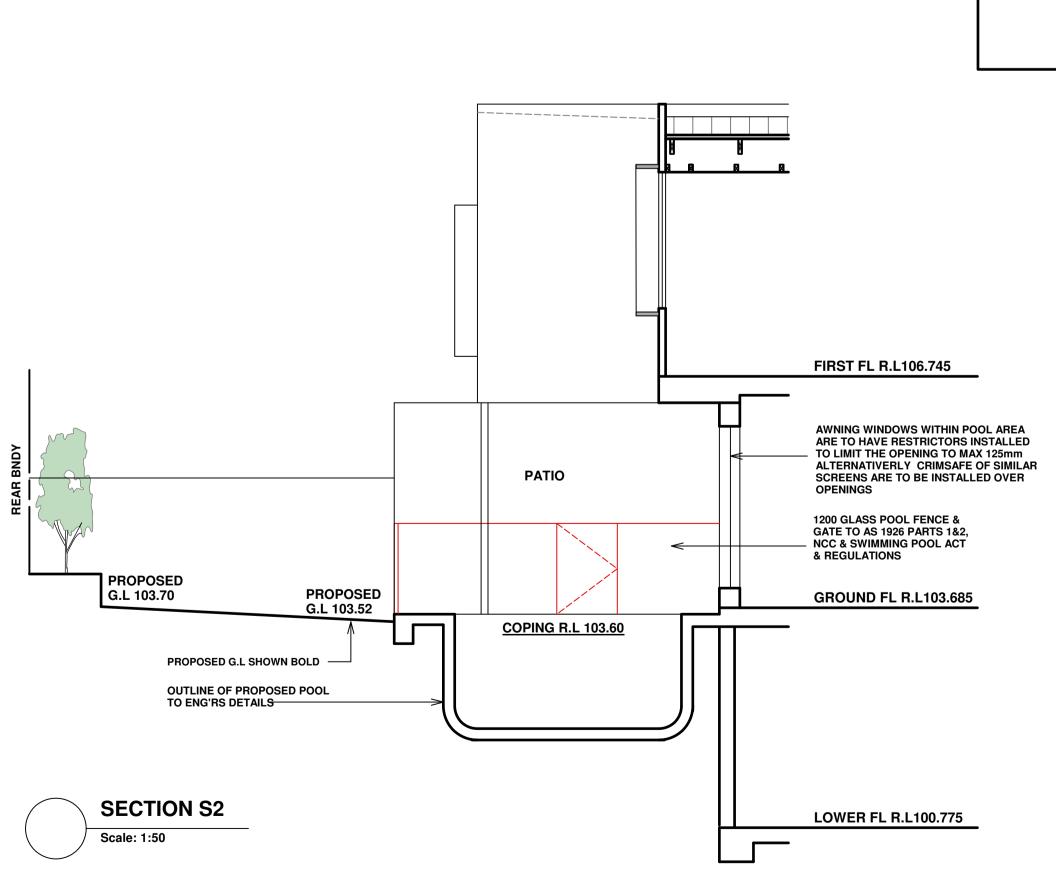




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PROPOSED DUPLEX LOCATED AT 41 FERGUSON ST FORESTVILLE **DETAILED POOL PLAN & SECTIONS**

BASIX INCLUSIONS SUMMARY CERT- 1776049M:

NatHERS CERT: U1- 0011596459 & U2- 0011596491

R2.5 XPS FOIL BOARD TO INTERNAL WALLS TO GARAGE FOYER.

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INSULATION- ROOF/CEILINGS R1.5 ANTICON FOIL BACKET BLANKET TO UNDER METAL ROOFING.

FIRST FLOOR FC CLADDING WALLS- SOLAR ABSORPTANCE DARK 0.70

A MIN 68sqm OF EACH ROOF AREA IS TO BE COLLECTED.

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SCALE: 1:50 @ A1 DRAWN: MM PROJECT DATE: OCT 2024 CHECKED: REV: A PROJECT No. 202426 DWG No. DA 1.02B

BUILDING DESIGN & TECHNOLOGY Pty Ltd PLICATION PREPARED BY: MARK MAKHOUL op 2 , 15 Bransgrove St Wentworthville 2145,

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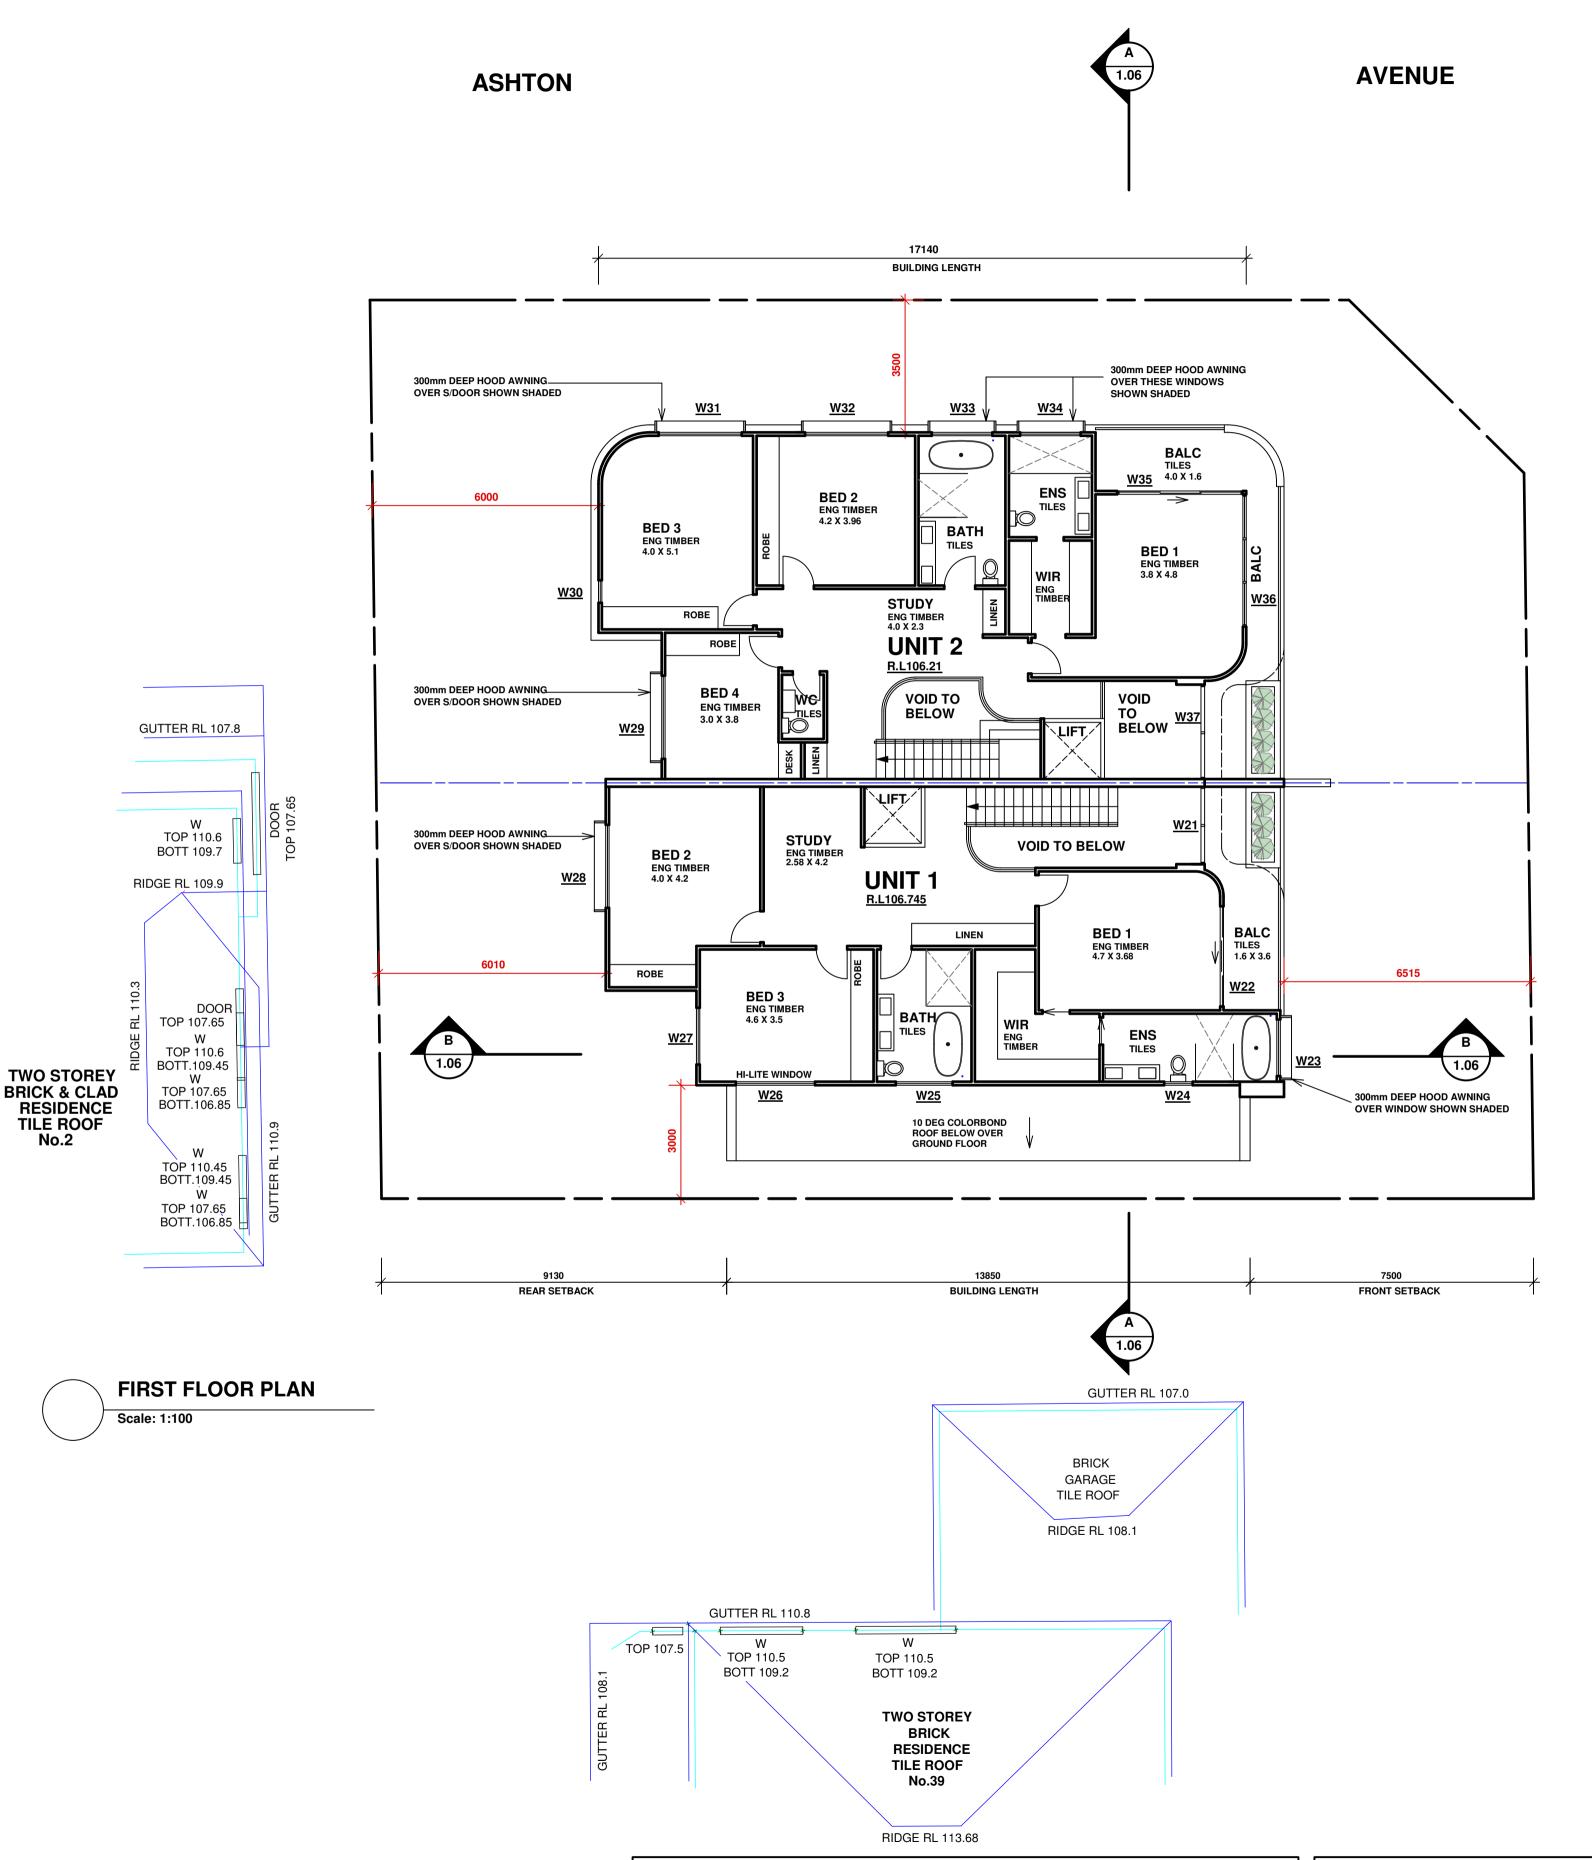
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ERGUSON

PROPOSED DUPLEX LOCATED AT 41 FERGUSON ST FORESTVILLE FIRST FLOOR PLAN SCALE: 1:100 @ A1 DRAWN: MM PROJECT DATE: OCT 2024 CHECKED: REV: A

DWG No. DA 1.03

PROJECT No. 202426

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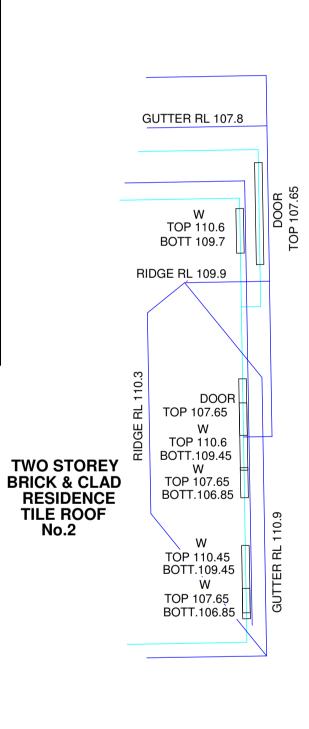
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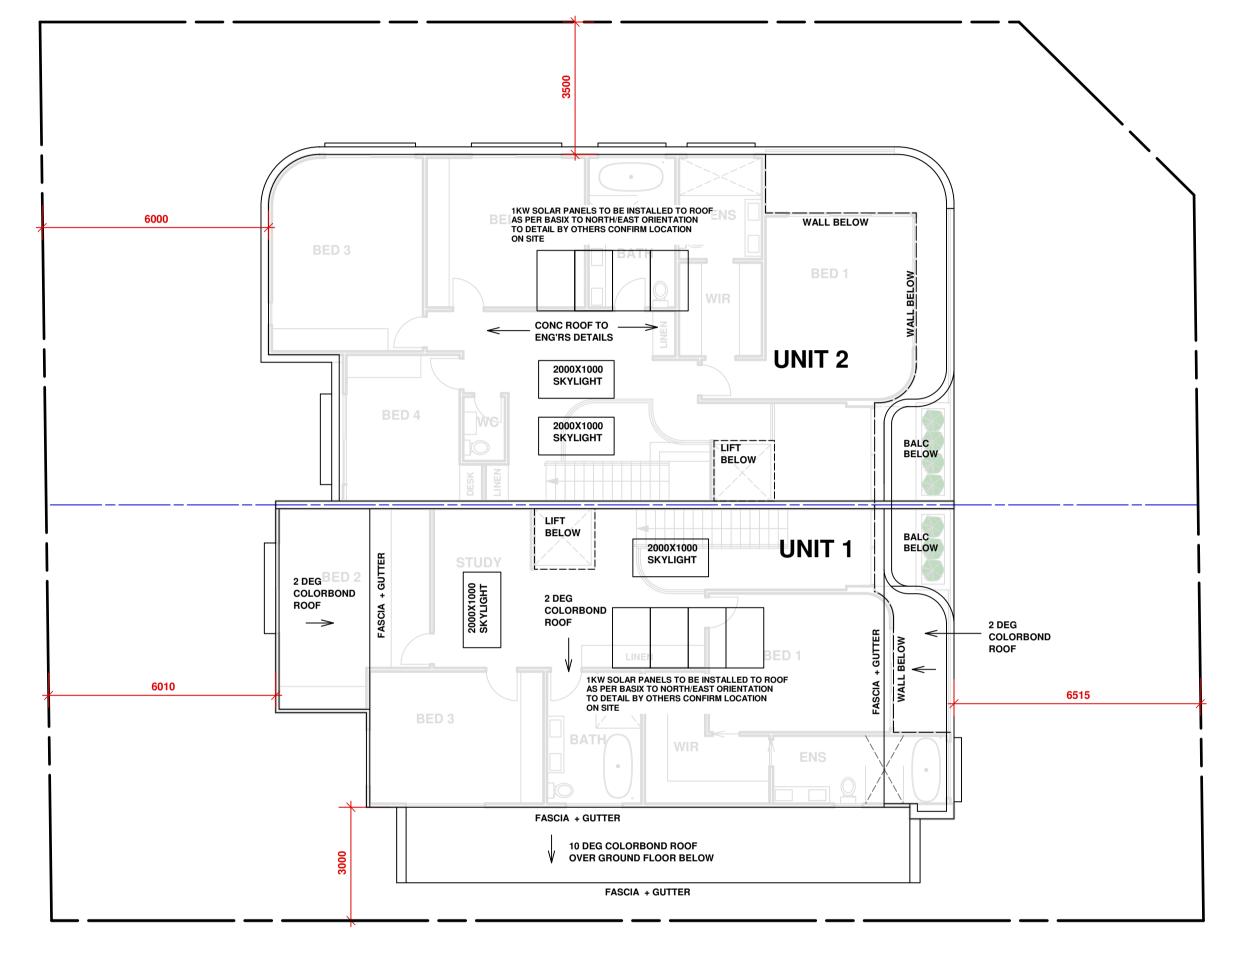
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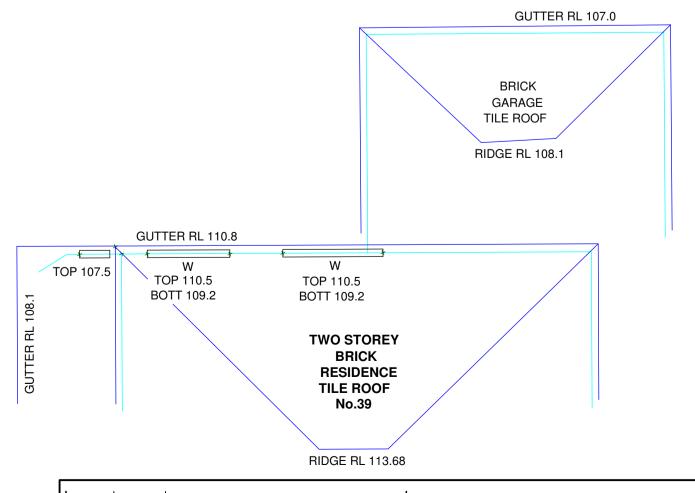
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TITLE:	ROOF PLAN		


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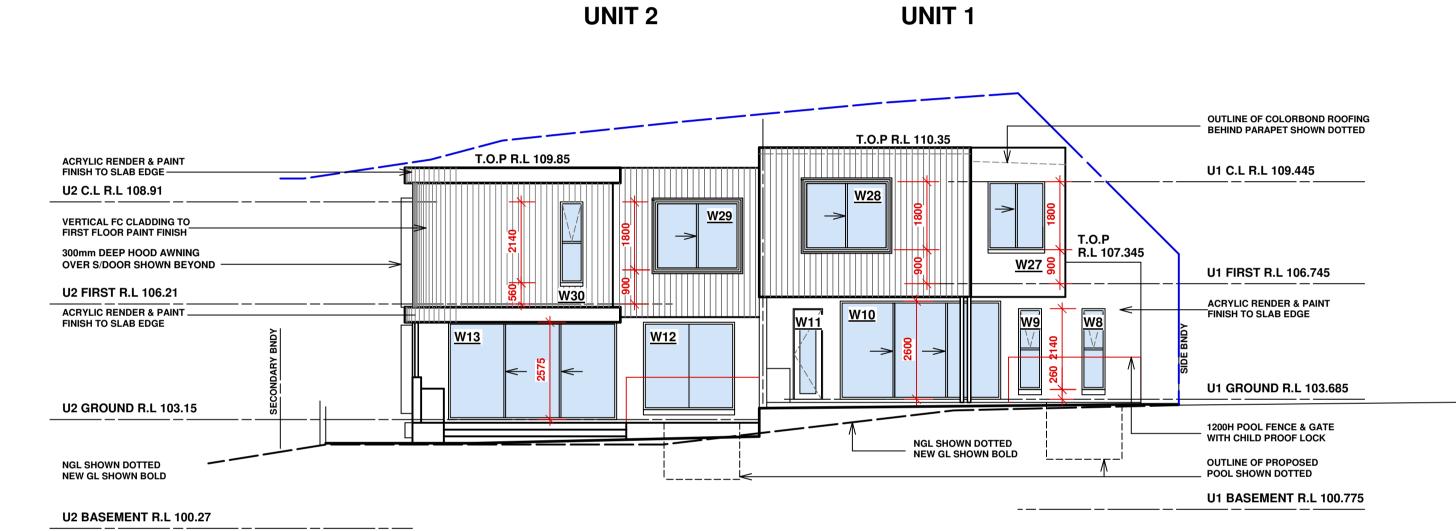
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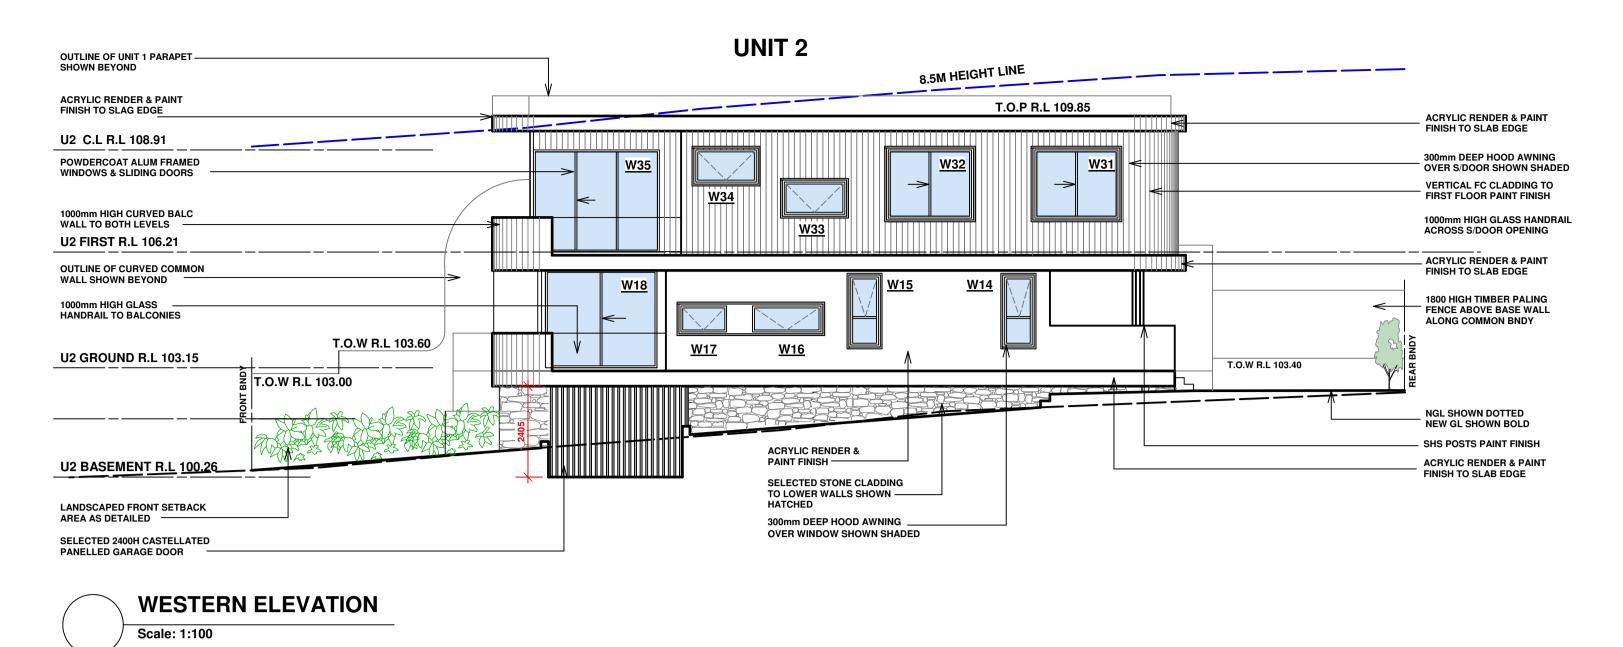
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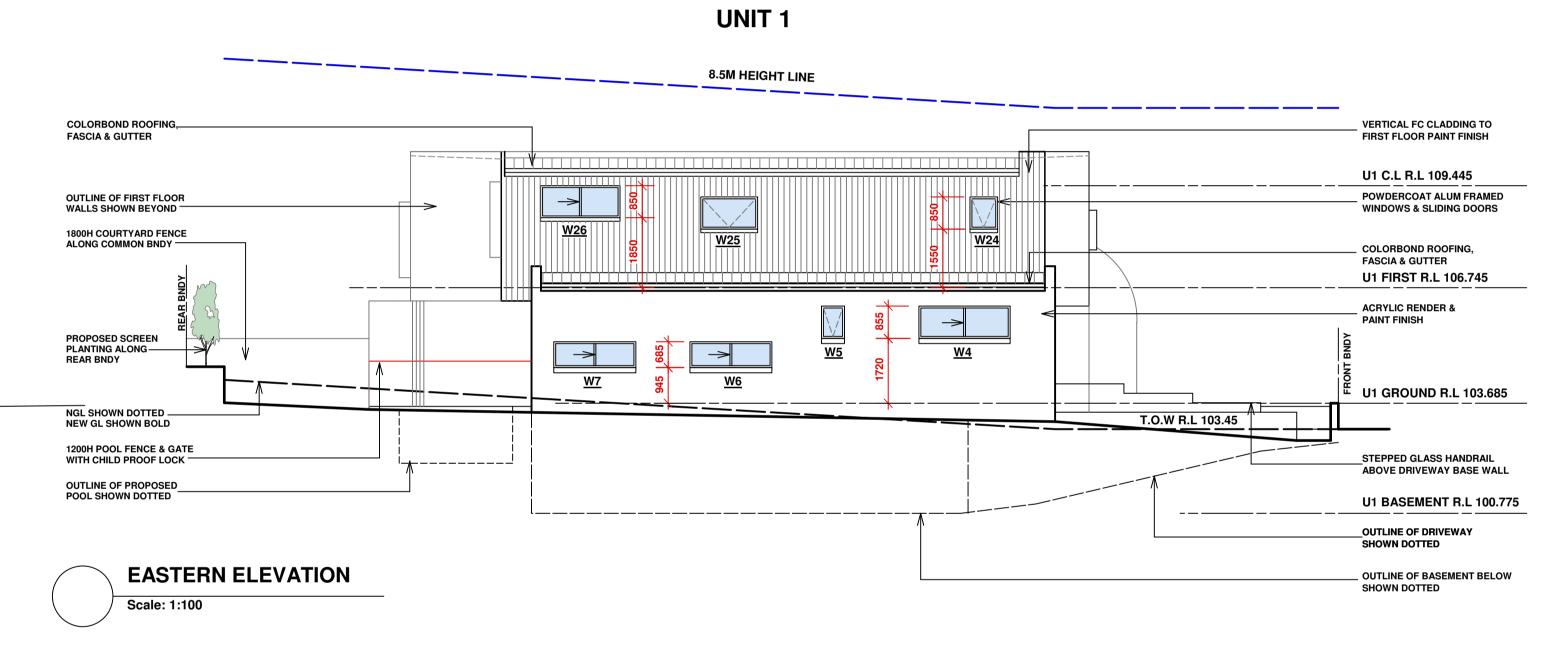




SOUTHERN ELEVATION Scale: 1:100

WINDOW	SCHEDU	ЦE		
WINDOW NO	WIDTH	HEIGHT	TOTAL	TYPE
1	800	2575	1	GLAZED SIDELIGHT TO TIMBER ENTRY DOOR
2	2650	2575	1	ALUM FRAMED SLIDING DOOR
3	2290	1975	1	ALUM FRAMED FIXED WINDOW
4	2400	850	1	ALUM FRAMED SLIDING WINDOW
5	610	850	1	ALUM FRAMED AWNING WINDOW
6	2170	685	1	ALUM FRAMED SLIDING WINDOW
7	2170	685	1	ALUM FRAMED SLIDING WINDOW
8	610	2140	1	ALUM FRAMED AWNING WINDOW
9	610	2140	1	ALUM FRAMED AWNING DOOR
10	4250	2600	1	ALUM FRAMED SLIDING DOOR
11	720	2400	1	TIMBER FRAMED GLAZED DOOR
12	2410	2315	1	ALUM FRAMED FIXED WINDOW
13	4450	2575	1	ALUM FRAMED SLIDING DOOR
14	730	1800	1	ALUM FRAMED AWNING WINDOW
15	730	1800	1	ALUM FRAMED AWNING WINDOW
16	1810	685	1	ALUM FRAMED AWNING WINDOW
17	1210	685	1	ALUM FRAMED AWNING WINDOW
18	2950	2575	1	ALUM FRAMED SLIDING DOOR
19	3520	2400	1	ALUM FRAMED FIXED WINDOW
20	1225	2575	1	GLAZED SIDELIGHT TO TIMBER ENTRY DOOR
21	2050	2400	1	ALUM FRAMED FIXED WINDOW
22	2650	2700	1	ALUM FRAMED SLIDING DOOR
23	1500	850	1	ALUM FRAMED AWNING WINDOW
24	730	850	1	ALUM FRAMED AWNING WINDOW
25	1500	850	1	ALUM FRAMED AWNING WINDOW
26	2100	850	1	ALUM FRAMED AWNINGWINDOW
27	1500	1800	1	ALUM FRAMED SLIDING WINDOW
28	2200	1800	1	ALUM FRAMED SLIDING DOOR
29	2200	1800	1	ALUM FRAMED AWNING DOOR
30	600	2140	1	ALUM FRAMED AWNING WINDOW
31	2200	1800	1	ALUM FRAMED SLIDING DOOR
32	2200	1800	1	ALUM FRAMED SLIDING DOOR
33	1600	850	1	ALUM FRAMED AWNING WINDOW
34	1600	850	1	ALUM FRAMED AWNING WINDOW
35	3330	2700	1	ALUM FRAMED SLIDING DOOR
36	3500	2400	1	ALUM FRAMED FIXED WINDOW
37	2500	2400	1	ALUM FRAMED FIXED WINDOW
TOTAL			37	




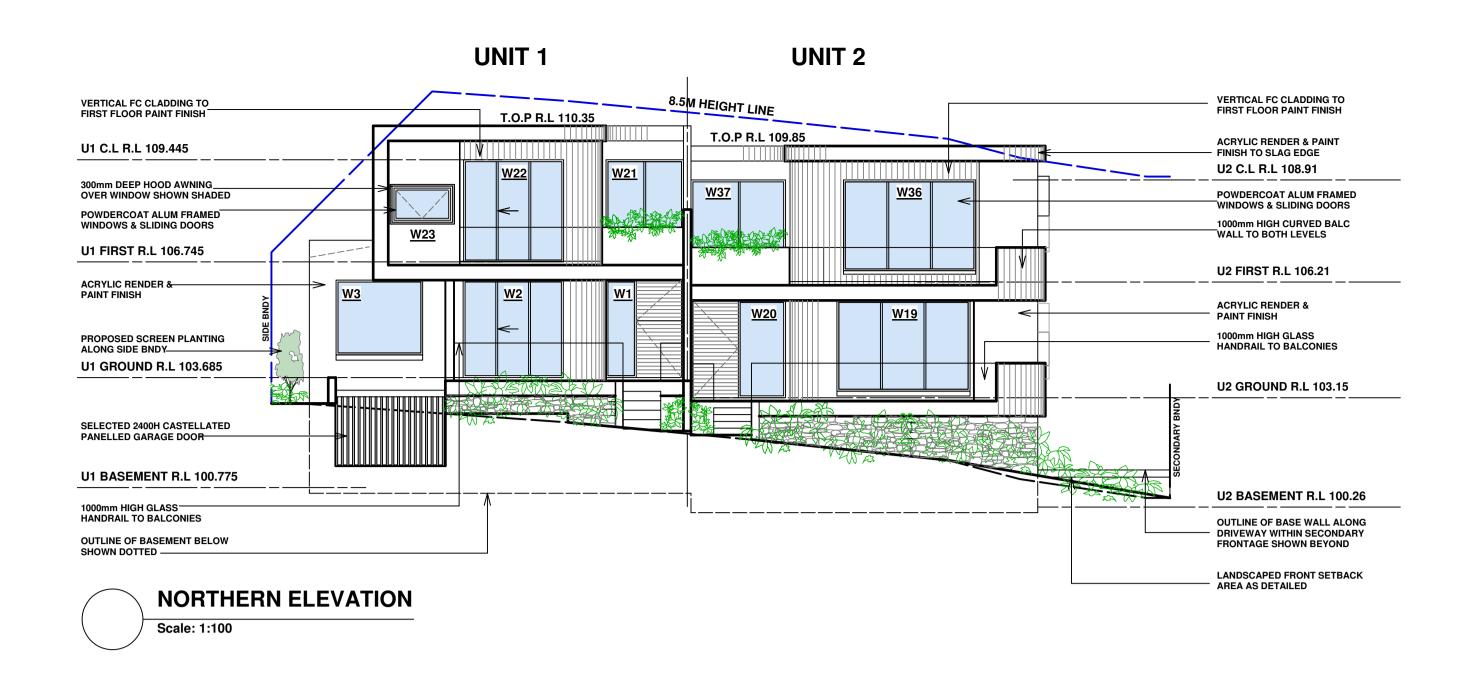



04/12/24 A DA ISSUE ENGINEER HAS INVESTIGATED SUBSOIL CONDITIONS & DESIGNED ALL STRUCTURAL ELEMENTS TO SUIT.	14/11/24	-	CONSULTANT ISSUE	SUPPLIED IN CONFIDENCE & ARE NOT TO BE USED FOR ANY OTHER PURPOSE EXCEPT THAT AUTHORISED BY C COPYRIGHT BUILDING DESIGN & TECHNOLOGY.
	04/12/24	A	DA ISSUE	




PROJECT:	PROPOSED DUPLEX 41 FERGUSON ST FO			
TITLE:	ELEVATIONS 1			
SCALE :	1:100 @ A1	DRAWN: MM		
PROJECT DA	TE: OCT 2024	CHECKED:	REV: A	
PROJECT No.	202426	DWG No. DA 1.0	5	

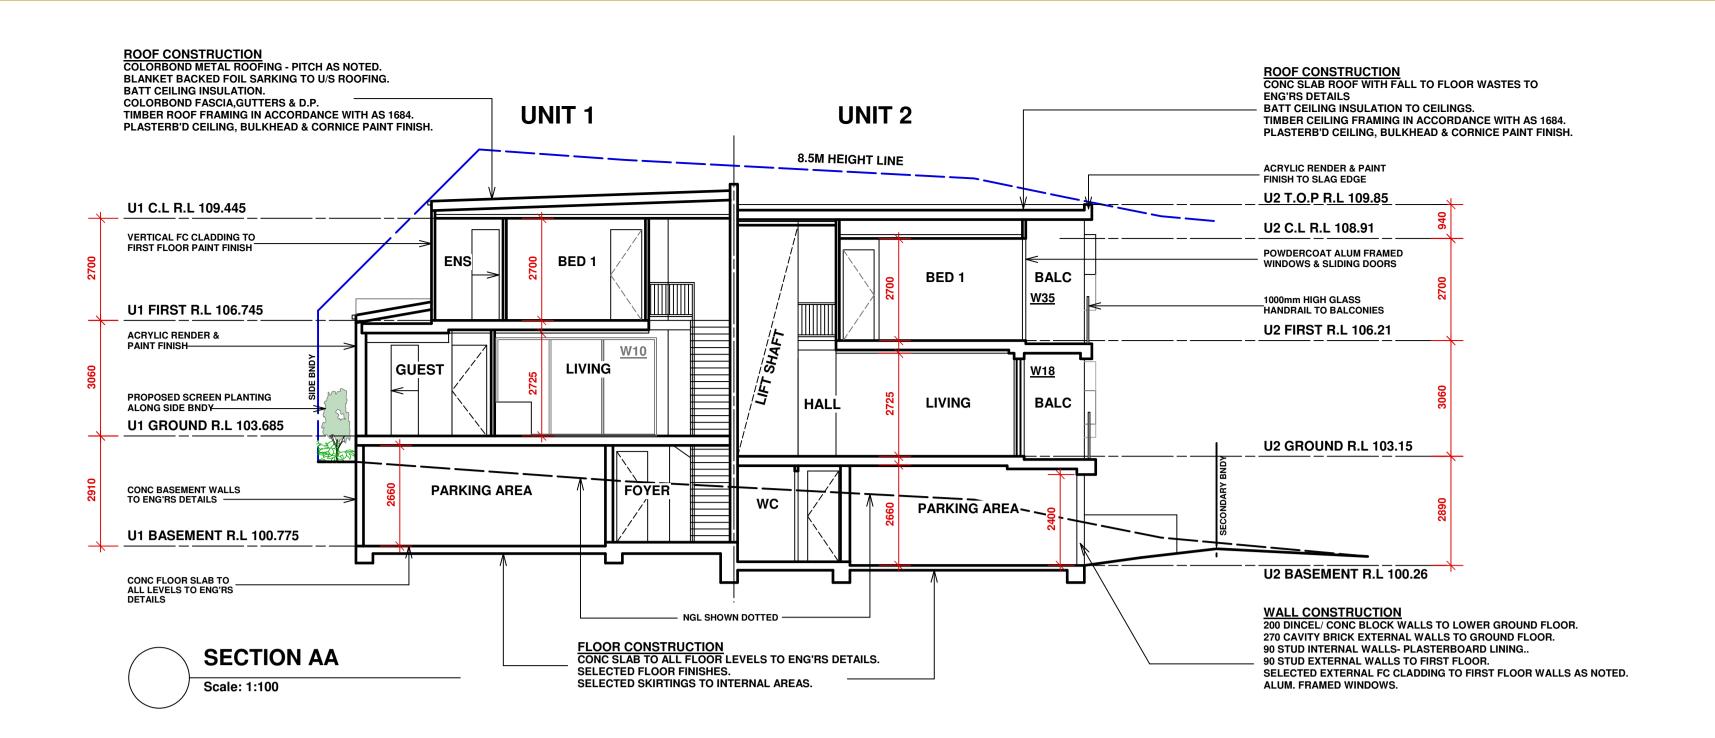

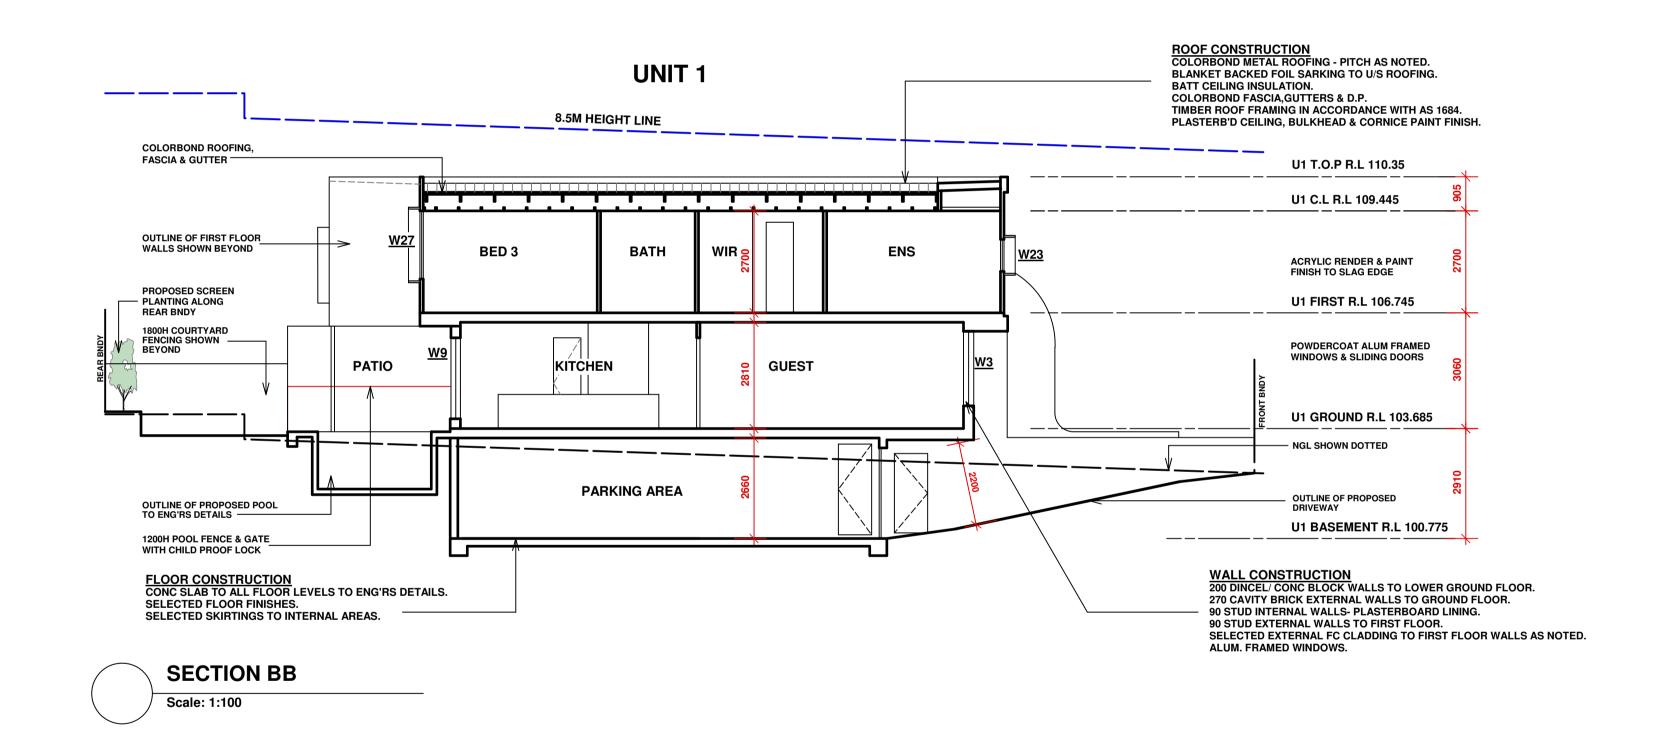

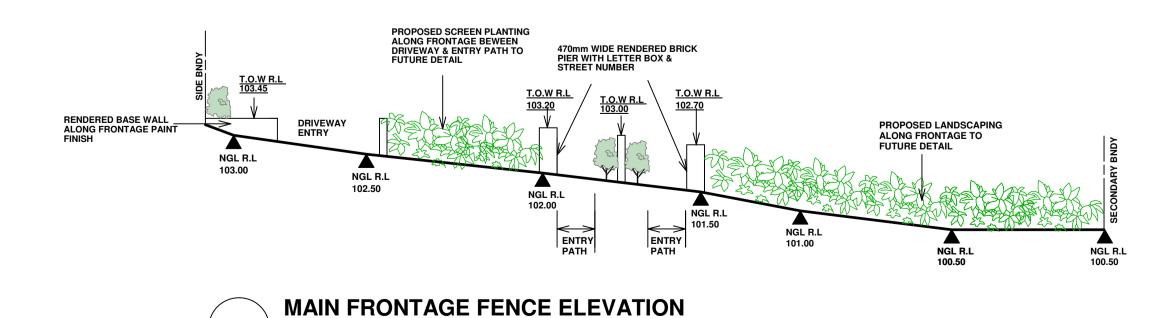


Scale: 1:100

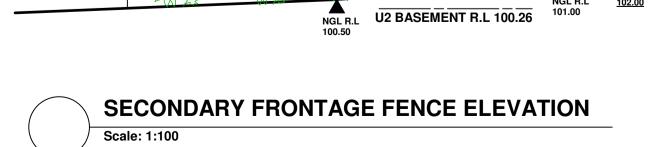

04/12/24	A	DA ISSUE	1. DO NOT SCALE FROM DRAWING, USE WRITTEN DIMENSIONS ONLY 2. BUILDER TO CHECK AND VERIFY ALL DIMENSIONS & LEVELS PRIOR TO COMMENCEMENT OF WORK. 3. IT IS THE OWNERS RESPONSIBILITY TO ENSURE THAT THE ENGINEER HAS INVESTIGATED SUBSOIL CONDITIONS & DESIGNED ALL STRUCTURAL ELEMENTS TO SUIT. 4. THE DESIGNS & DETAILS CONTAINED ON THIS DRAWING ARE SUPPLIED IN CONFIDENCE & ARE NOT TO BE USED FOR ANY OTHER PURPOSE EXCEPT THAT AUTHORISED BY
DATE	REV	AMENDMENTS	C COPYRIGHT BUILDING DESIGN & TECHNOLOGY.

PROPOSED LANDSCAPING ALONG FRONTAGE TO



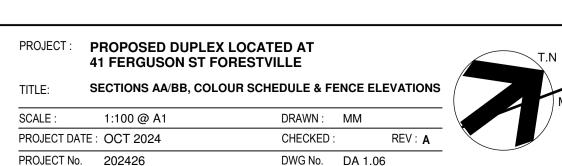

PROPOSED SCREEN PLANTING BEHIND COURTYARD FENCING

_1500H VERTICAL PALISADE COURTYARD FENCING

RENDERED BASE WALL ALONG SECONDARY FRONTAGE STEPPED

PROPOSED LOW LEVEL SHRUB

- PLANTING ALONG FRONTAGE

WITHIN PROPERTY

TO FOLLOW INTERNAL COURTYARD



MAIN EXTERNAL FACADE = ACRYLIC RENDER & PAINT FINISH DULUX SHALE GREY

ALTERNATIVE OPTION- FACE BRICK = PGH LIFESTYLE NATURALS FROST - OR SIMILAR

EXPOSED SLAB EDGE/ PARAPET = ACRYLIC RENDER & PAINT FINISH DULUX NATURAL WHITE

SELECTED STONE CLADDING TO FRONT FACADE WALL

COLORBOND ROOFING = COLORBOND BASALT

COLORBOND GUTTER = COLORBOND BASALT


COLORBOND FASCIA = COLORBOND BASALT

EAVES LINING PAINT FINISH = DULUX NATURAL WHITE OR SIMILAR

PAINTED POSTS = COLORBOND MONUMENT


ALUM FRAMED WINDOWS = COLORBOND MONUMENT


GARAGE DOOR= B&D CASTELLATED 35 VERTICAL FACADE IN BLACK

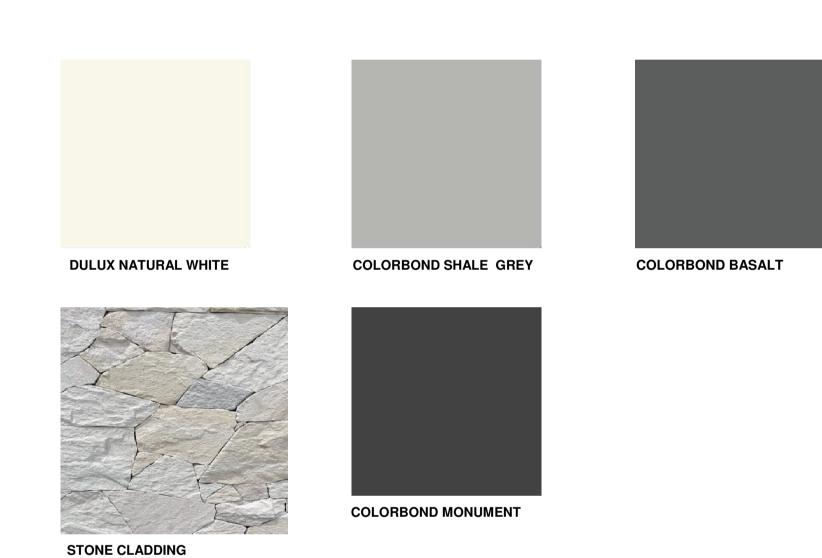




B&D CASTELLATED 35 VERTICAL CLADDING TO GARAGE FACADE OR SIMILAR

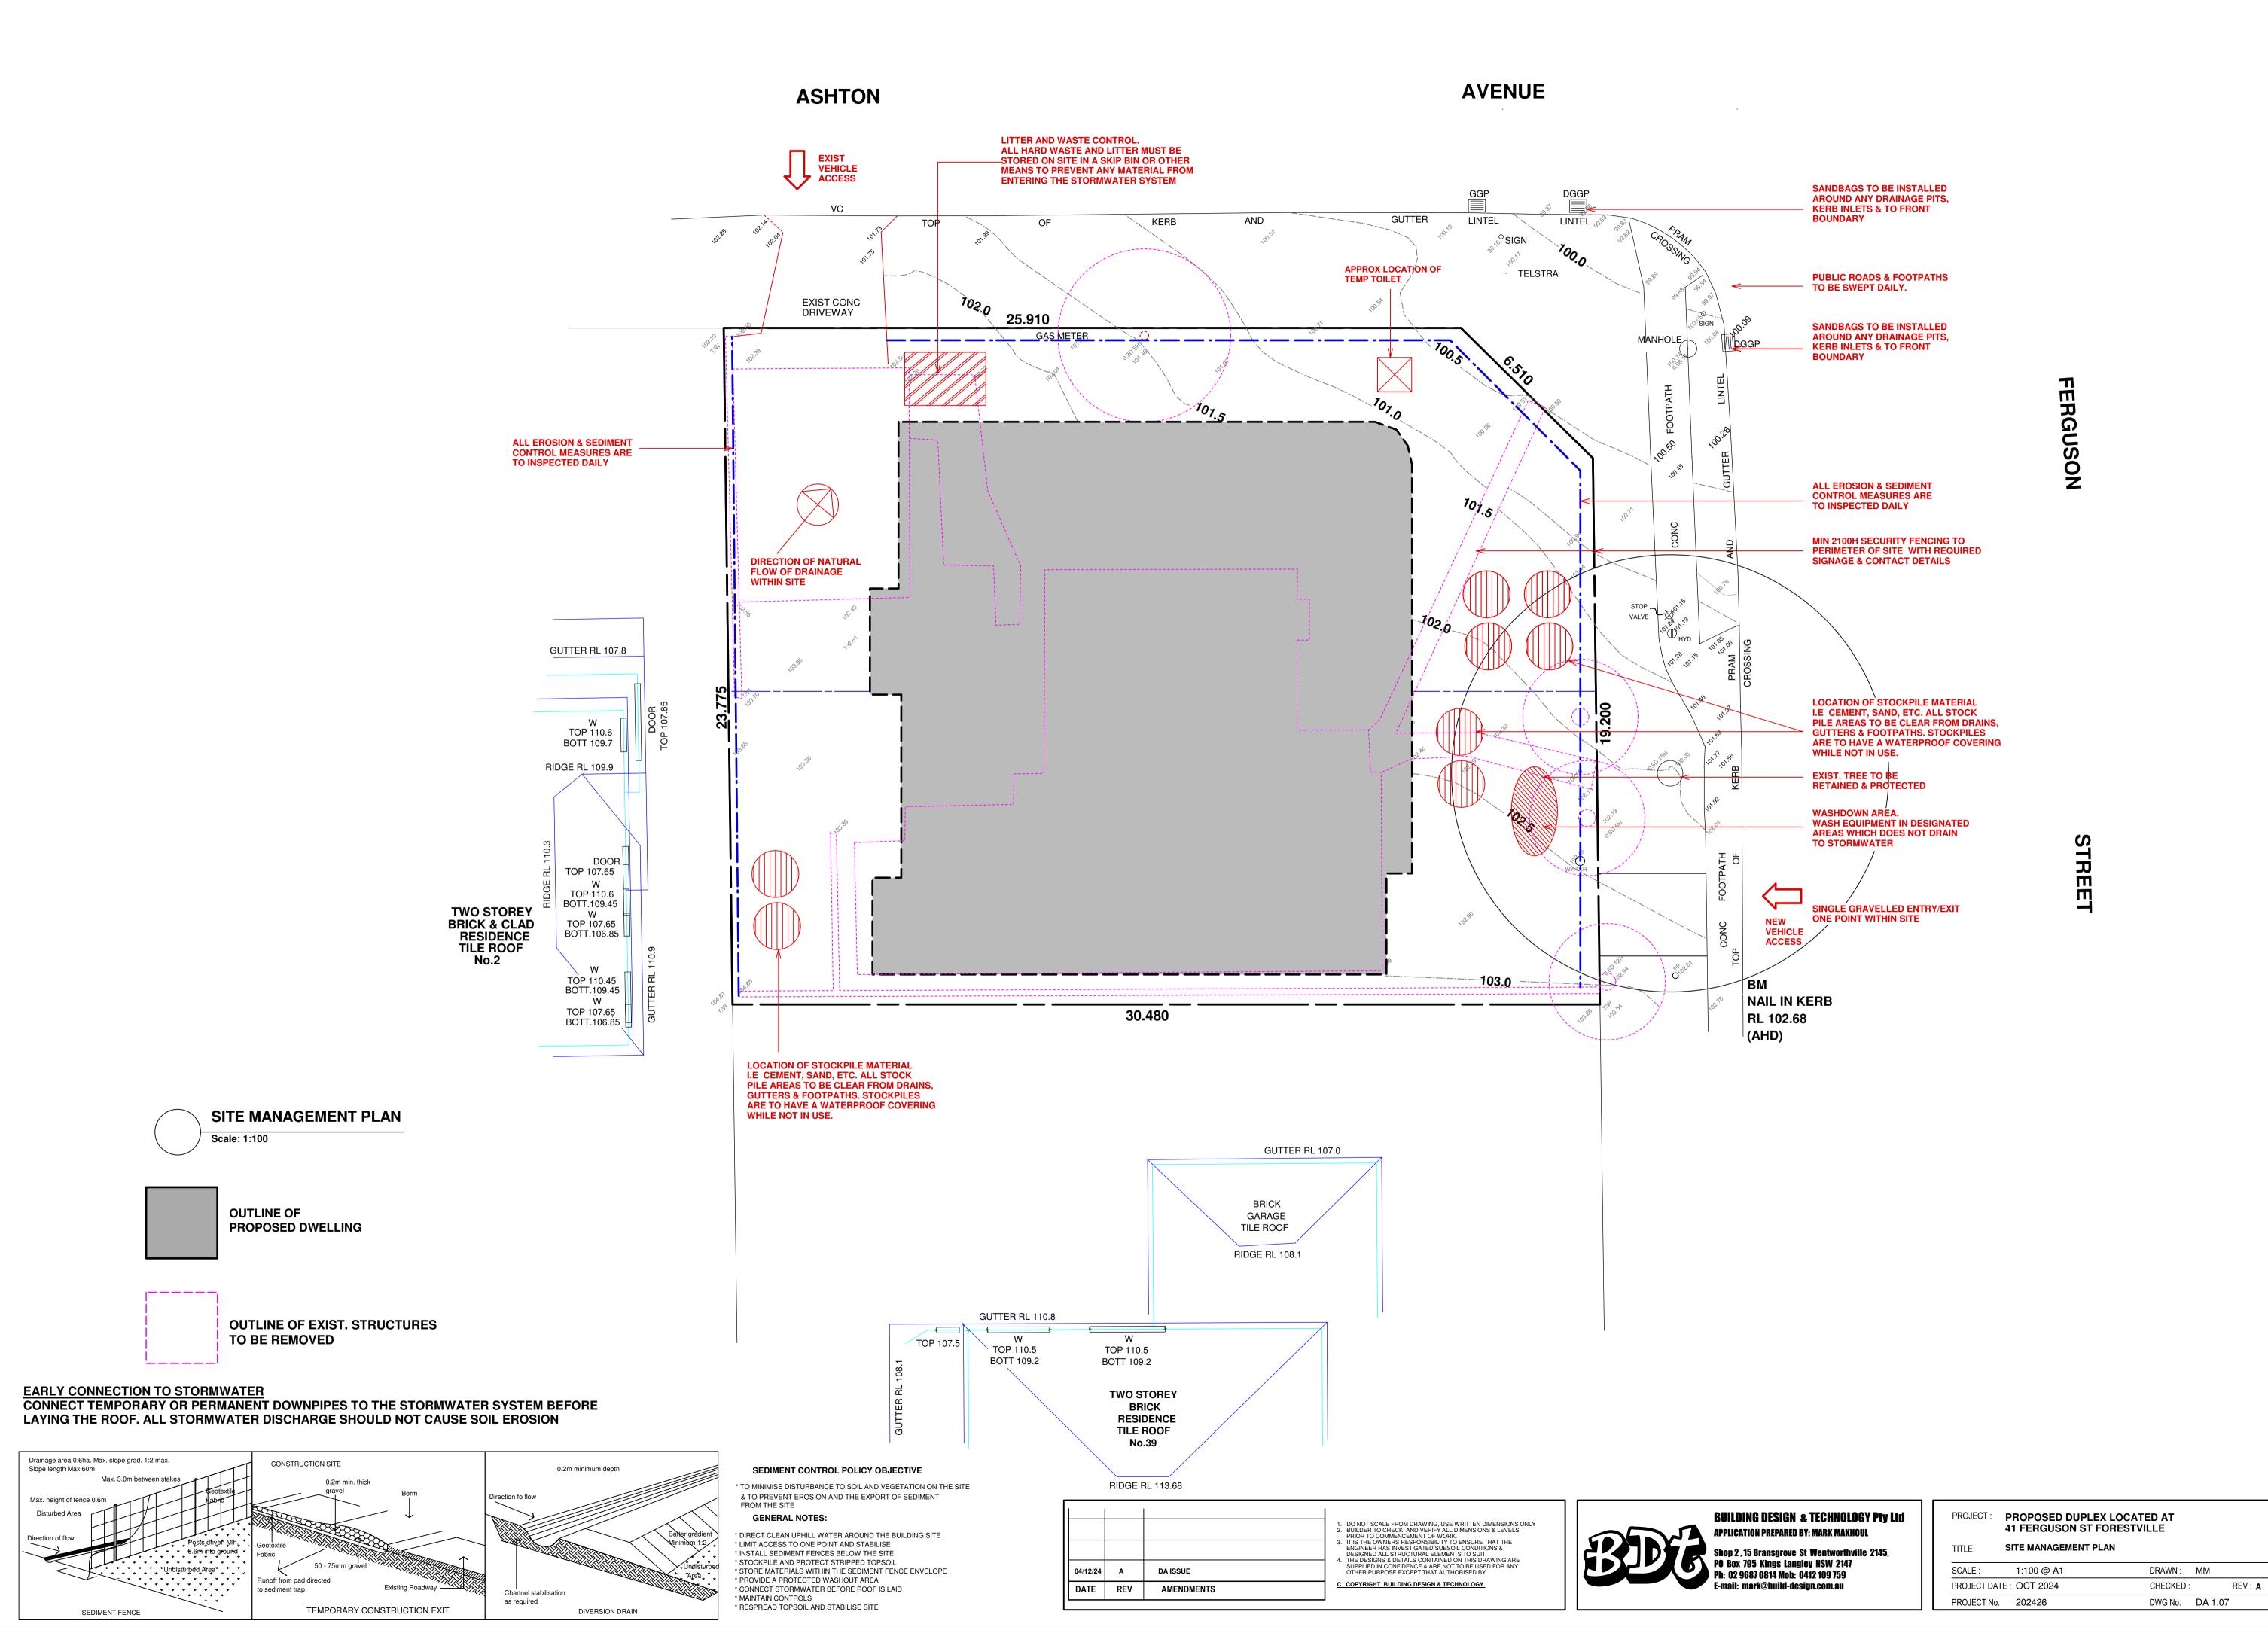


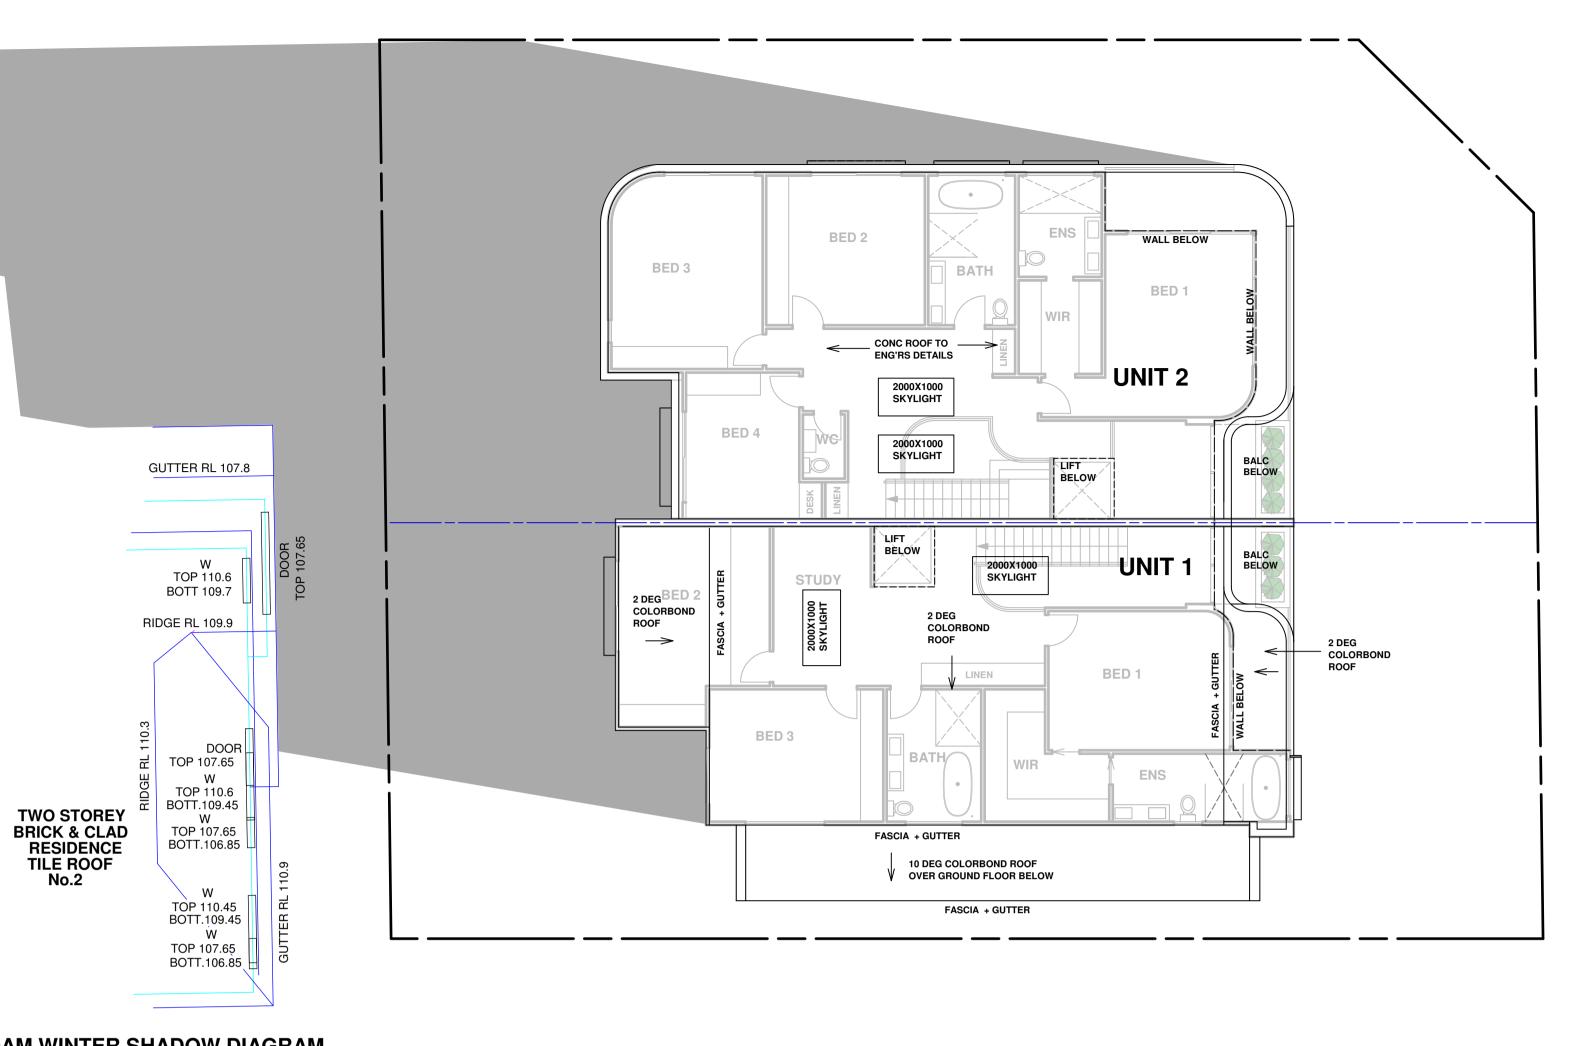

9AM WINTER SHADOW DIAGRAM


Scale: 1:100

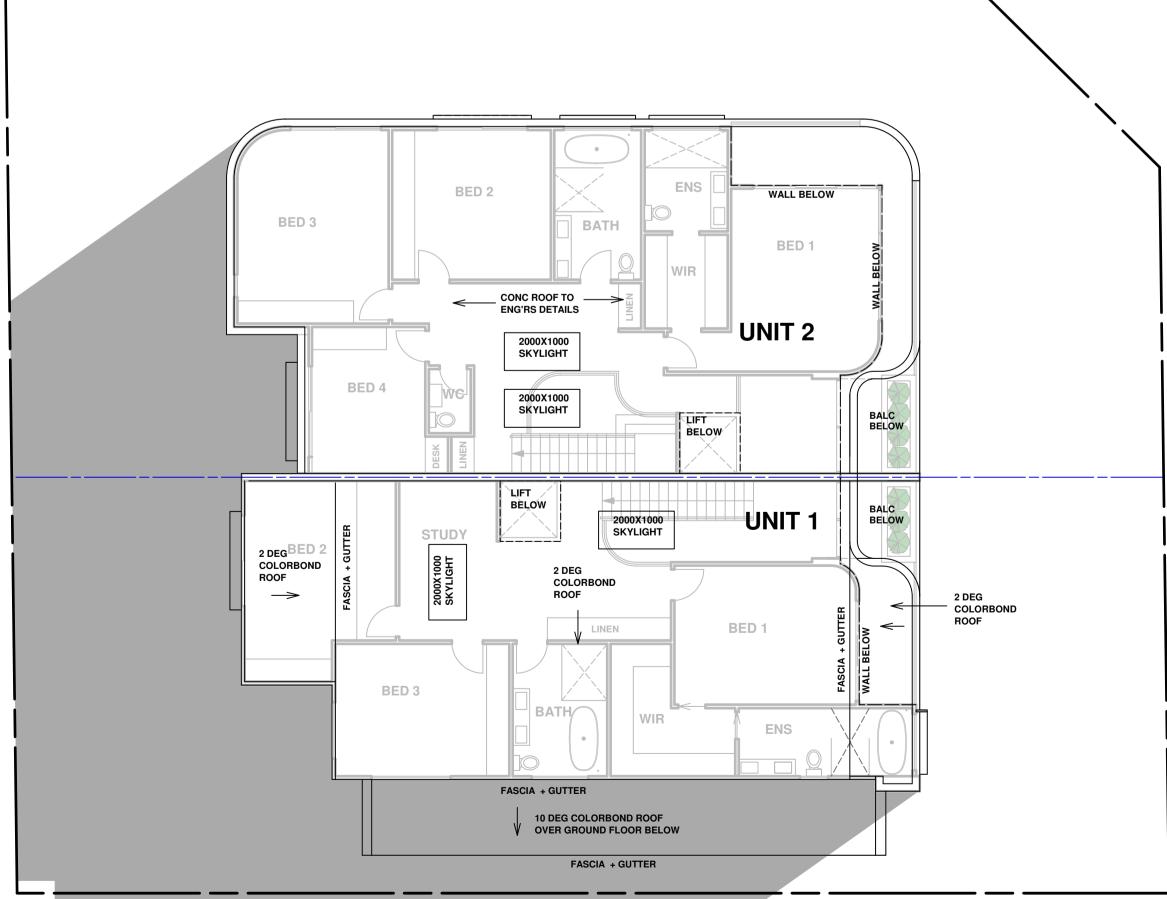

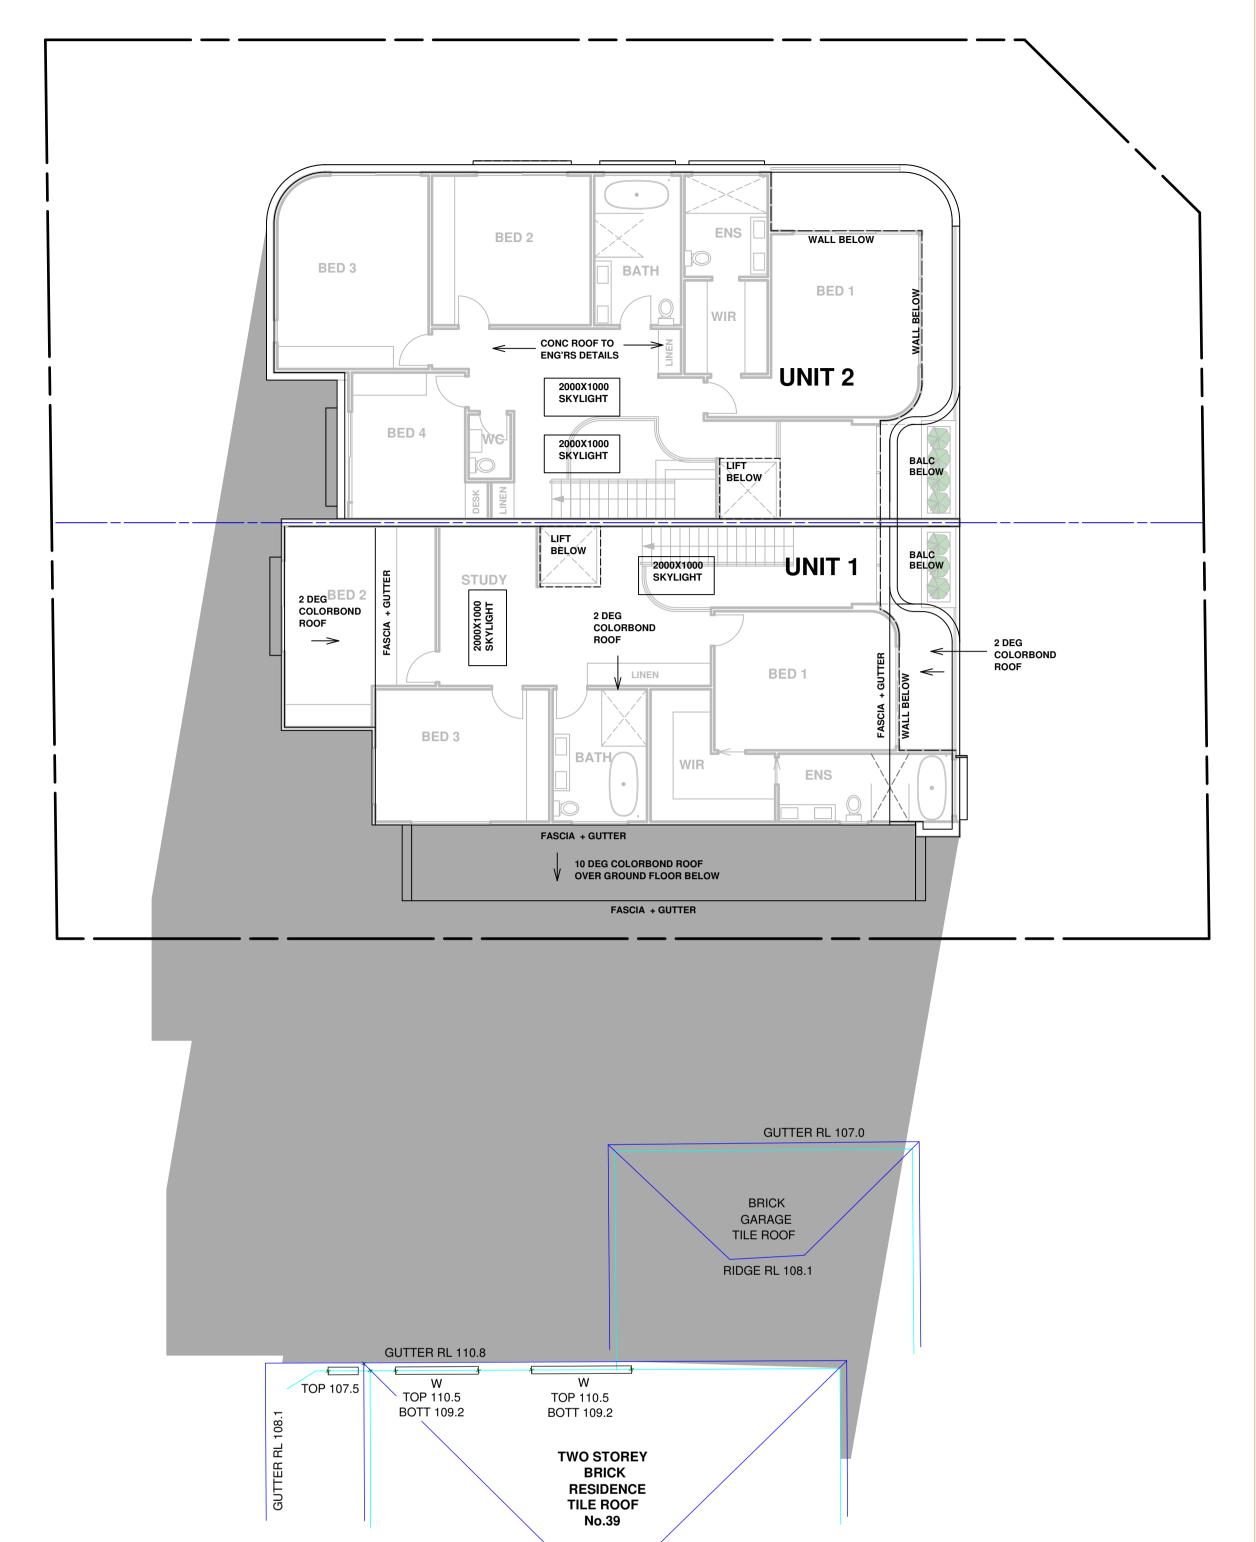

RIDGE RL 113.68

3PM WINTER SHADOW DIAGRAM Scale: 1:100

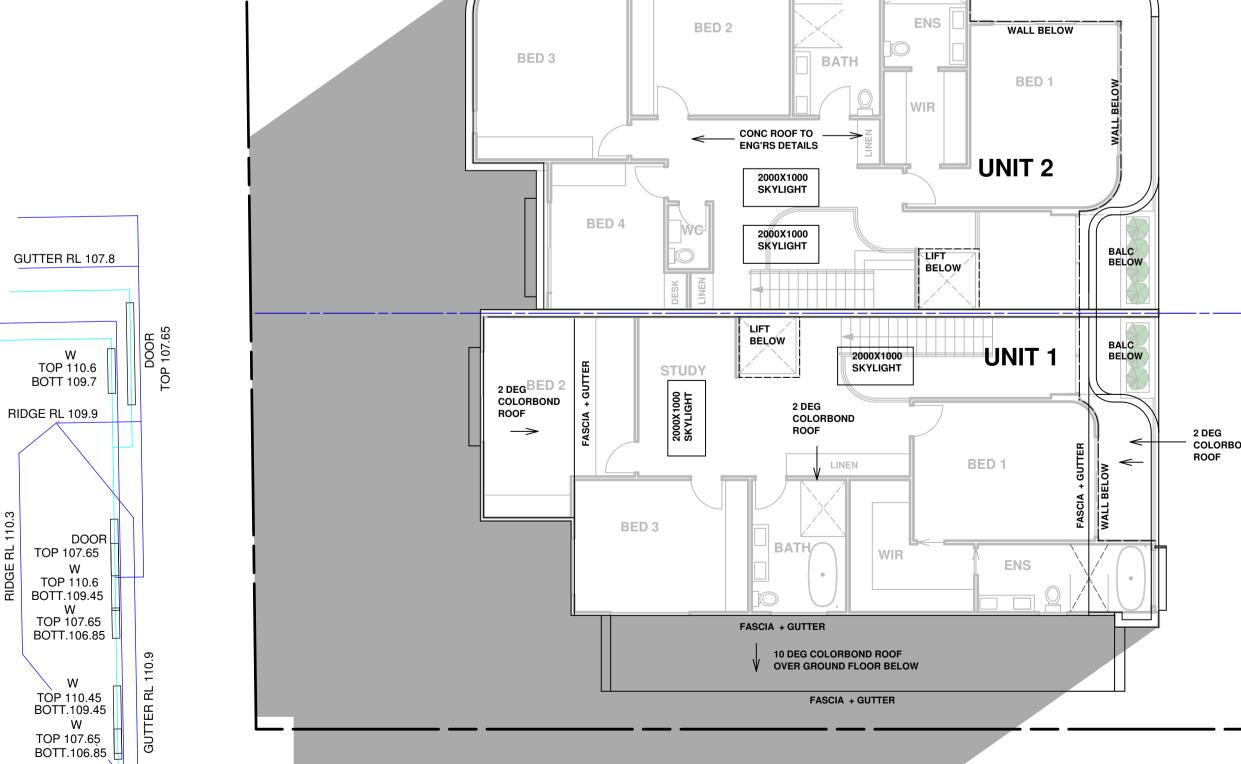

BUILDING DESIGN & TECHNOLOGY Pty Ltd APPLICATION PREPARED BY: MARK MAKHOUL Shop 2, 15 Bransgrove St Wentworthville 2145, PO Box 795 Kings Langley NSW 2147 Ph: 02 9687 0814 Mob: 0412 109 759 E-mail: mark@build-design.com.au

PROPOSED DUPLEX LOCATED AT 41 FERGUSON ST FORESTVILLE 9AM, NOON & 3PM WINTER SHADOW PLANS

SCALE: DRAWN: MM 1:100 @ A1 PROJECT DATE: OCT 2024 CHECKED: REV: A DWG No. DA 1.08 PROJECT No. 202426

NOON WINTER SHADOW DIAGRAM Scale: 1:100

TWO STOREY

BRICK & CLAD RESIDENCE TILE ROOF No.2

GUTTER RL 107.0

DATE REV

04/12/24 A

DA ISSUE

AMENDMENTS

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