

SITE PLAN WITH EXISTING HOUSE

Scale: 1:500

SITE AREA 1745.5msq



Inlet Design Studio

Newport, NSW, 2106, P 0415647351 E robyn@inletdesign.com.au

ABN: 26 075 061 335 Copyright © JACARANDA TRADING COMM

GENERAL NOTES
All dimensions are to be confirmed on site, any incongru
No Survey has been made on boundaries, all bearings, o



	Somers Isles Pty Ltd
_	ADDRESS: 64 POWDERWORKS RD, NTH NARRABEEN

RAWING:		DRAWN:	SHEET NO:
Site Plan with	AE	A1	
ROJECT:		CHKD:	SCALE @ A3:
1EM DMELLIN	1G	RJ	1:500
ROJECT NO:	ISSUE TYPE:	ISSUE DATE:	REVISION:
PWD001	1	15/01/2	5






Newport, NSW, 2106, P 0415647351 E robyn@inletdesign.com.au

ABN: 26 075 061 335
Copyright © JACARANDA TRADING COMPANY PTY LTD



	CLIENT:
7	Somers Isles Pty Ltd
_	ADDRESS: 64 POWDERWORKS RD, NTH NARRABEEN

emolition P	lan	DRAWN: AE	SHEET NO:
oject: IEW DWELLII	NG	CHKD:	SCALE @ A3: 1:500
OJECT NO:	ISSUE TYPE:	ISSUE DATE:	REVISION:
WD001	1	15/01/25	

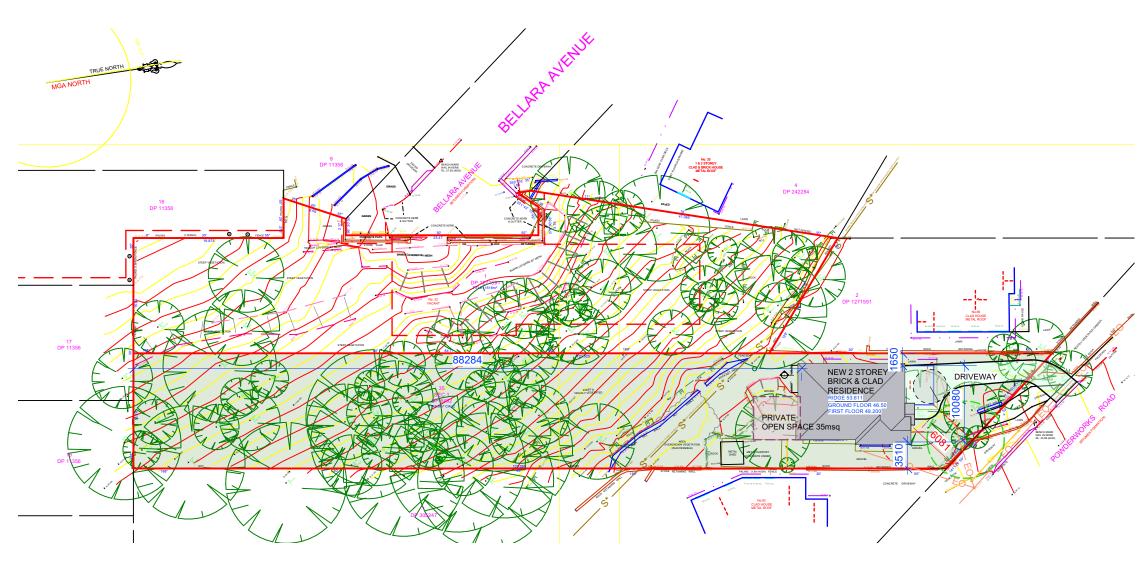



1

REVISION: DATE:

SITE PLAN WITH NEW HOUSE

Scale: 1:500

SITE AREA 1745.5msq



Inlet Design Studio

Newport, NSW, 2106, P 0415647351 E robyn@inletdesign.com.au

ABN: 26 075 061 335

GENERAL NOTES

o Survey has been made on boundaries, all bearings, disistances and areas have been taken from the cotour suvey plan. A survey must be carried ut to confirm the exact boundary locations. He contractor is to ensure that the boundary setbacks are confirmed and used, the boundary stetbacks are to take precedence over all other dimensions. he survey work must be performed by a repistered Surveyor.

The survey work must be performed by a registered Surveyor.

Measurements for fabrication of secondary components such as windows,doors, internal frames, structural steel components and the like, are not to be taken fron these documents. Measurements must be taken on site to suit the work as constructed.

Z

Somers Isles Pty Ltd

ADDRESS:
64 POWDERWORKS RD, NTH NARRABEEN

DRAWING:

Site Plan with New House & Site Calcs

PROJECT:

NEW DWELLING

PROJECT NO:

SSUE TYPE:

PWD001

DRAWN:

AE

A3

CHKD:


SCALE @ A3:

RJ

1:500

RSUE DATE:

15/01/25

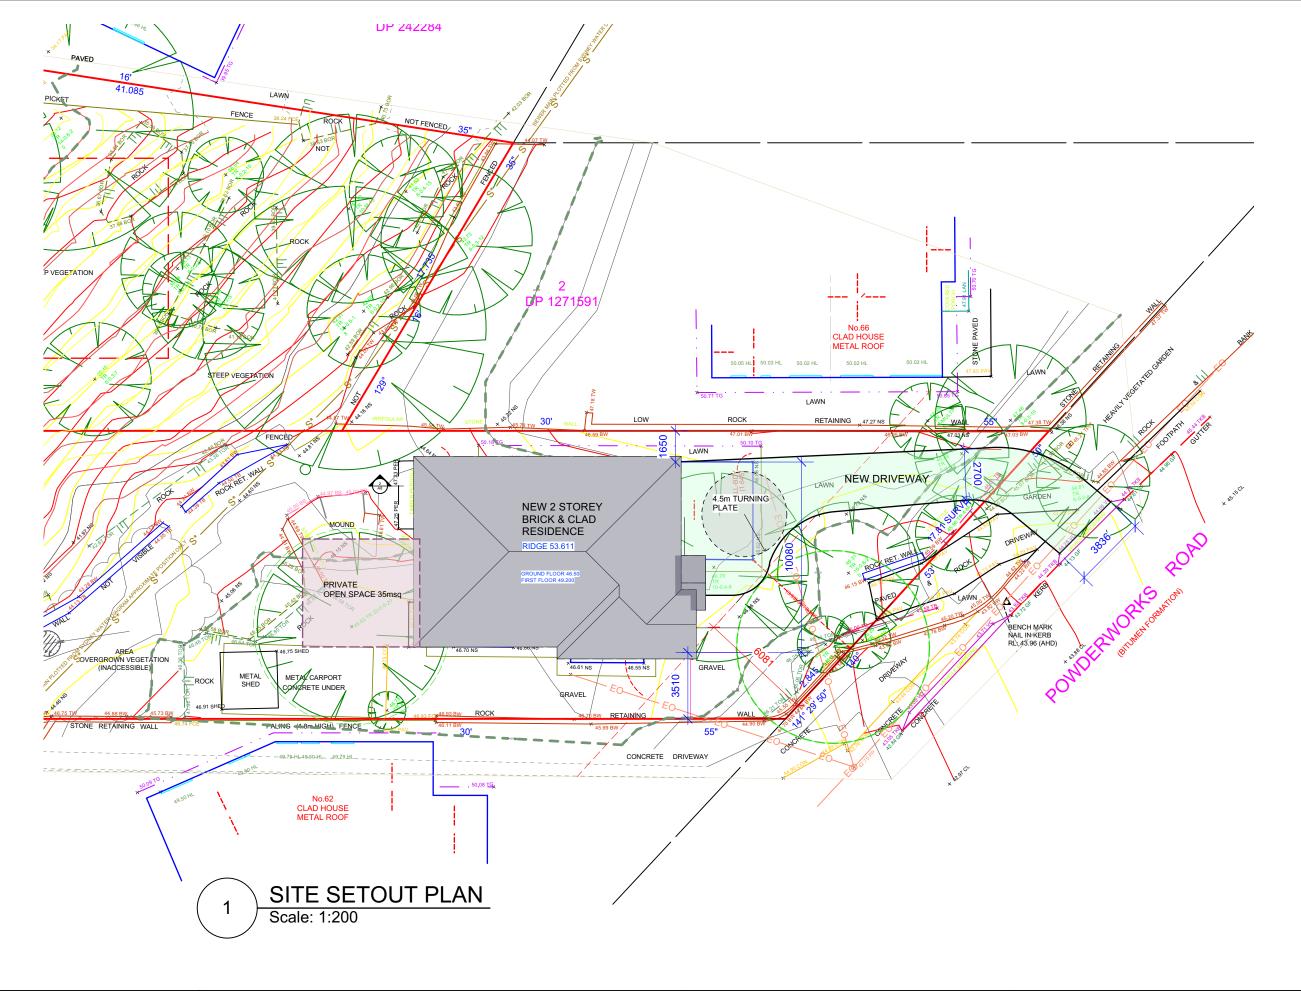



Newport, NSW, 2106, E robyn@inletdesign.com.au

ABN: 26 075 061 335 Copyright © JACARANDA TRADING COM


REVISION: DATE:


GENERAL NOTES


64 POWDERWORKS RD, NTH NARRABEEN

Somers Isles Pty Ltd	
1 D D D C C C	

SHEET NO: ΑE Site Setout Plan A4 CHKD: SCALE @ A3: RJ **NEW DWELLING** 1:200 PROJECT NO: ISSUE TYPE: ISSUE DATE: PWD001 15/01/25

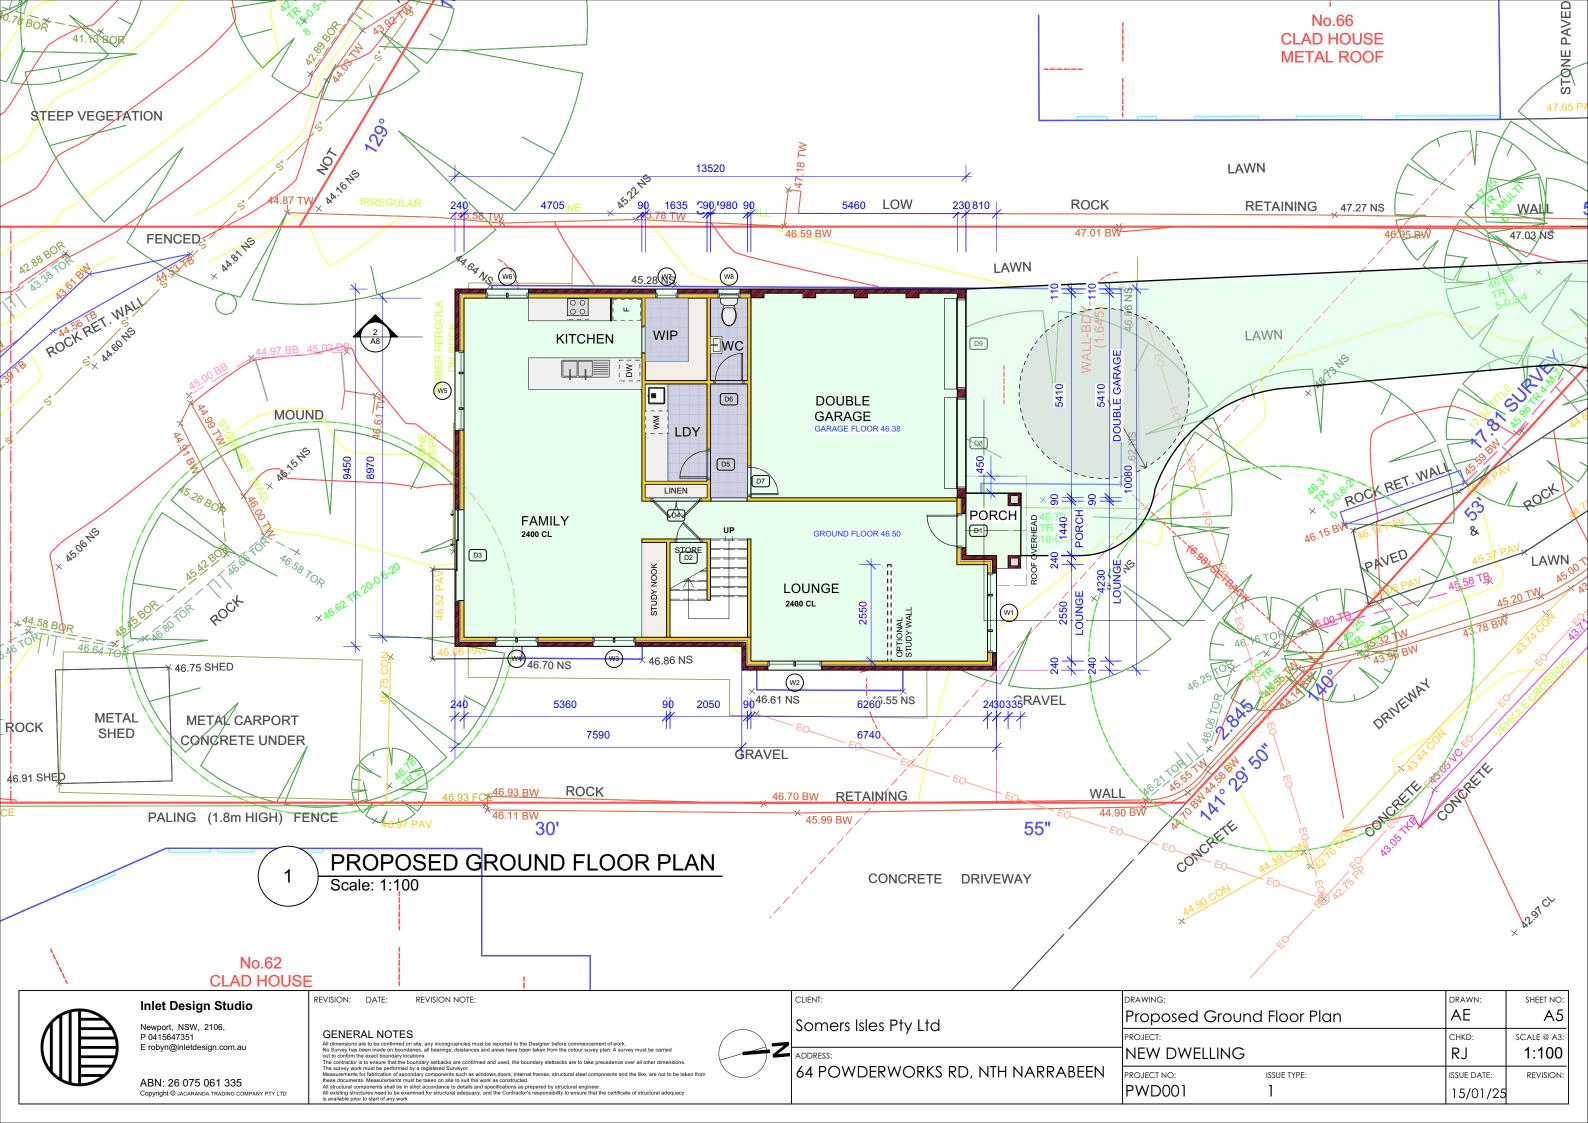

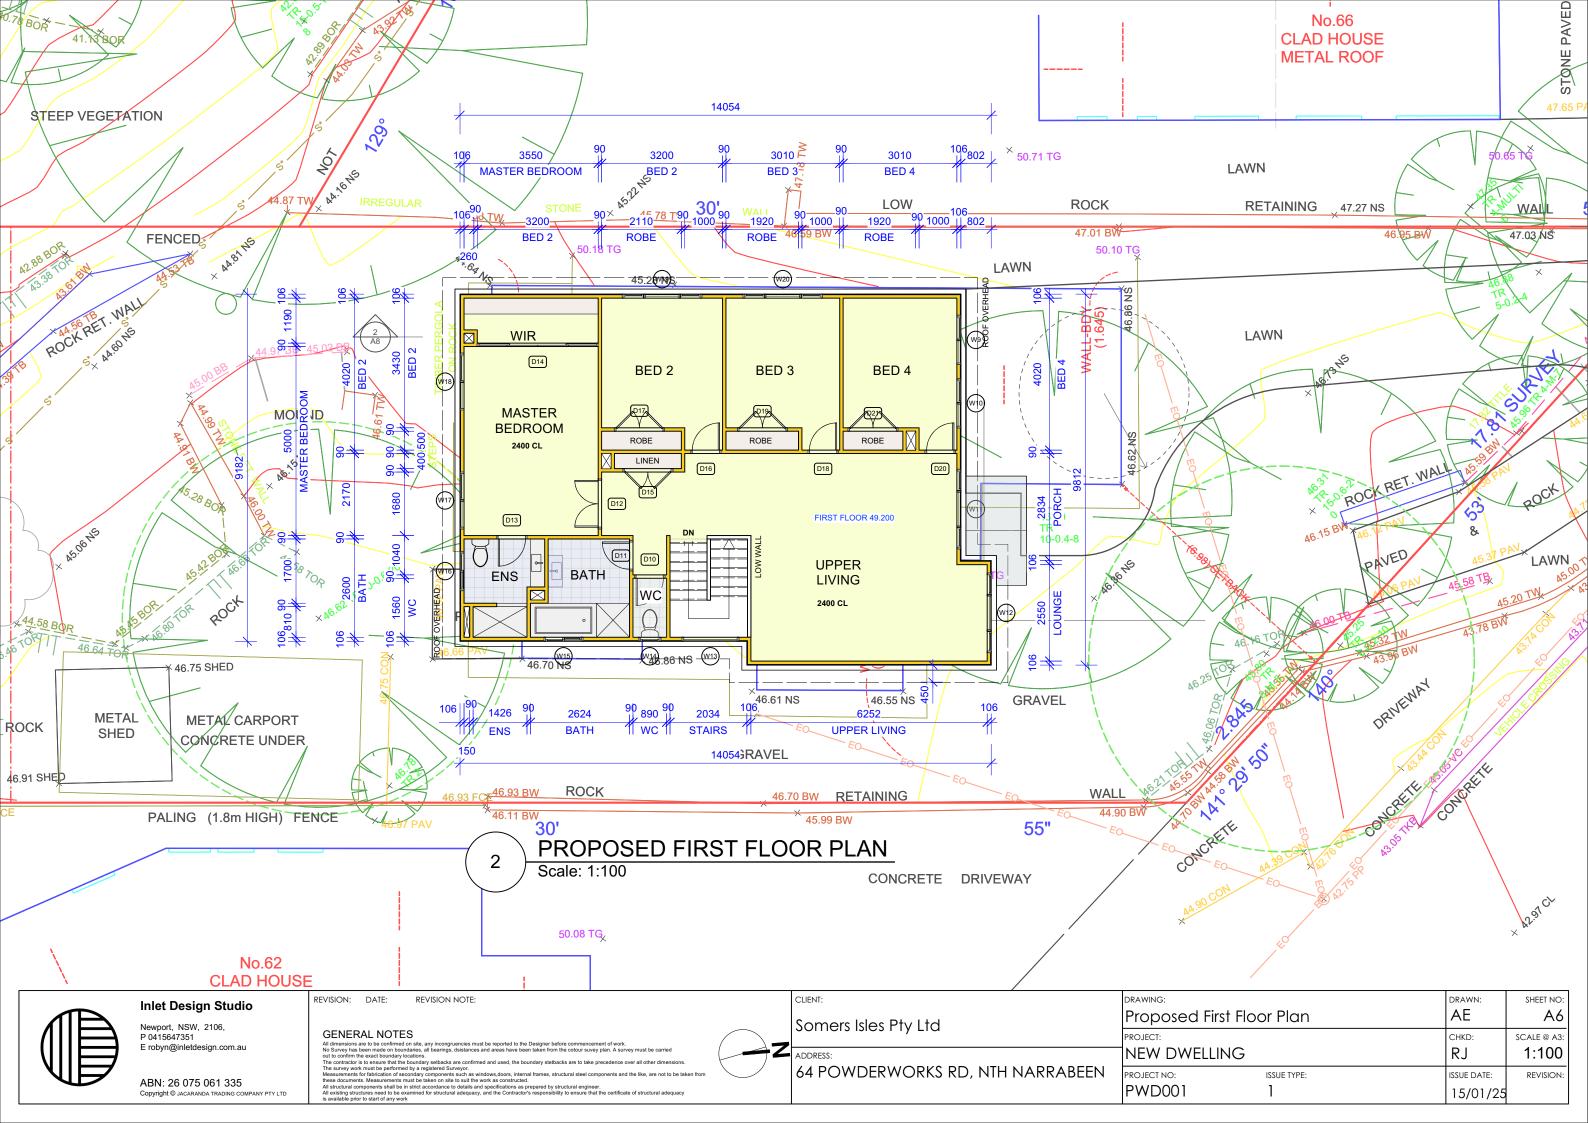

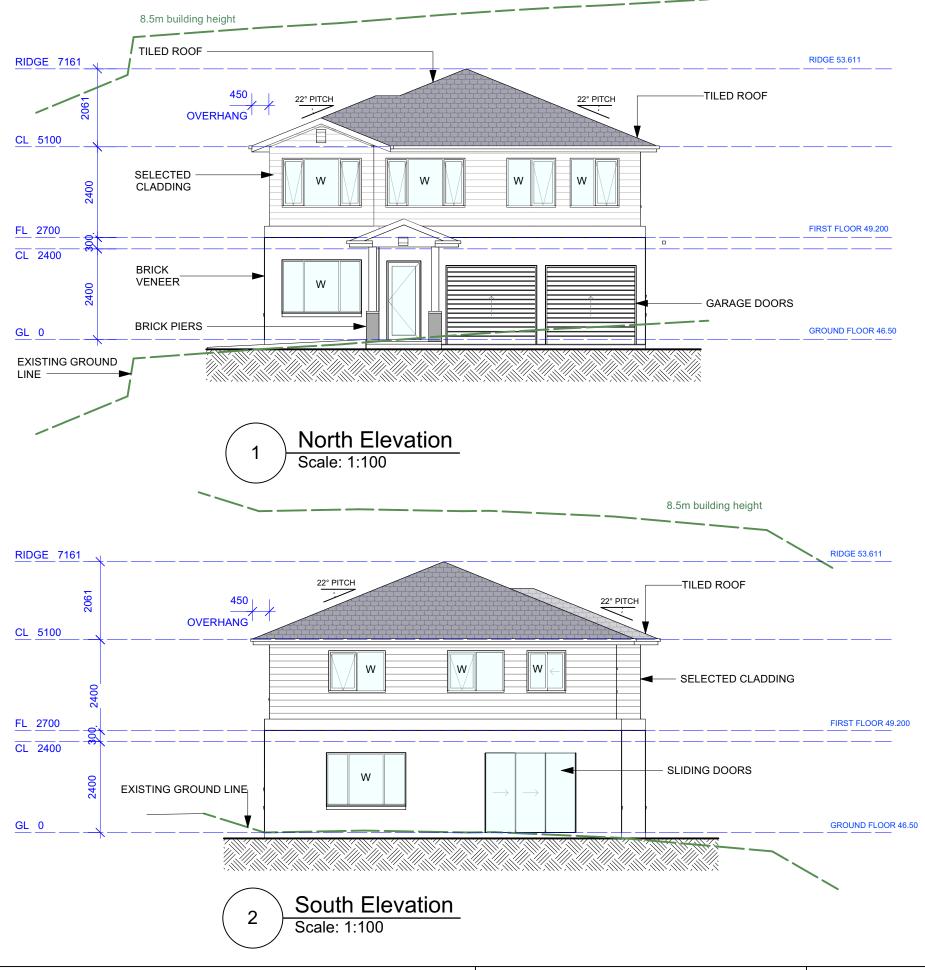



Newport, NSW, 2106, P 0415647351 E robyn@inletdesign.com.au


ABN: 26 075 061 335 Copyright © JACARANDA TRADING COMPANY PTY LTD


REVISION:	DATE:	REVISION NOTE:	
All dimensions a No Survey has l out to confirm th The contractor i The survey work Measurements l	been made on bour ne exact boundary k s to ensure that the k must be performe for fabrication of se	on site, any incongruencies must be reported to the Designer before commencement of work. daries, all bearings, dsistances and areas have been taken from the cotour suvey plan. A survey must be carried	


CLIENT:
Somers Isles Pty Ltd


ADDRESS:
64 POWDERWORKS RD, NTH NARRABEEN

PRAWING:		DRAWN:	SHEET NO:
North and South I	Elevations	AE	A7
ROJECT:		CHKD:	SCALE @ A3:
NEW DWELLING		RJ	1:100
ROJECT NO:	ISSUE TYPE:	ISSUE DATE:	REVISION:
PWD001	1	15/01/25	

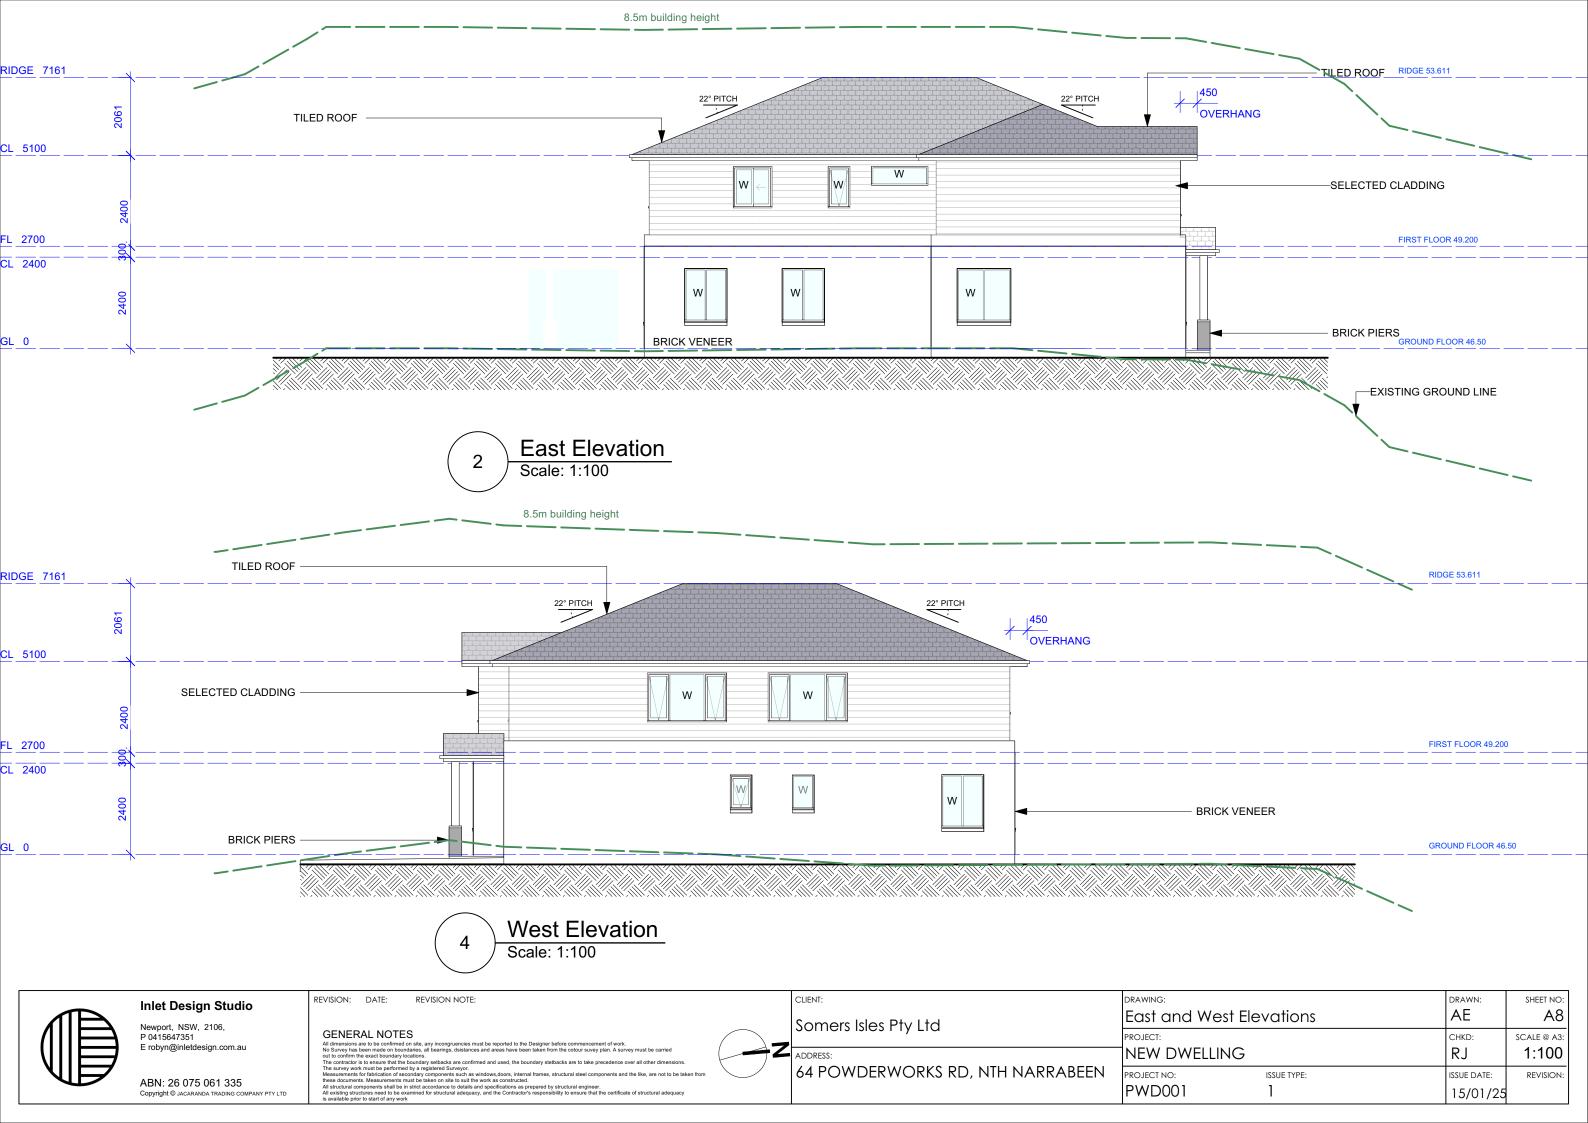


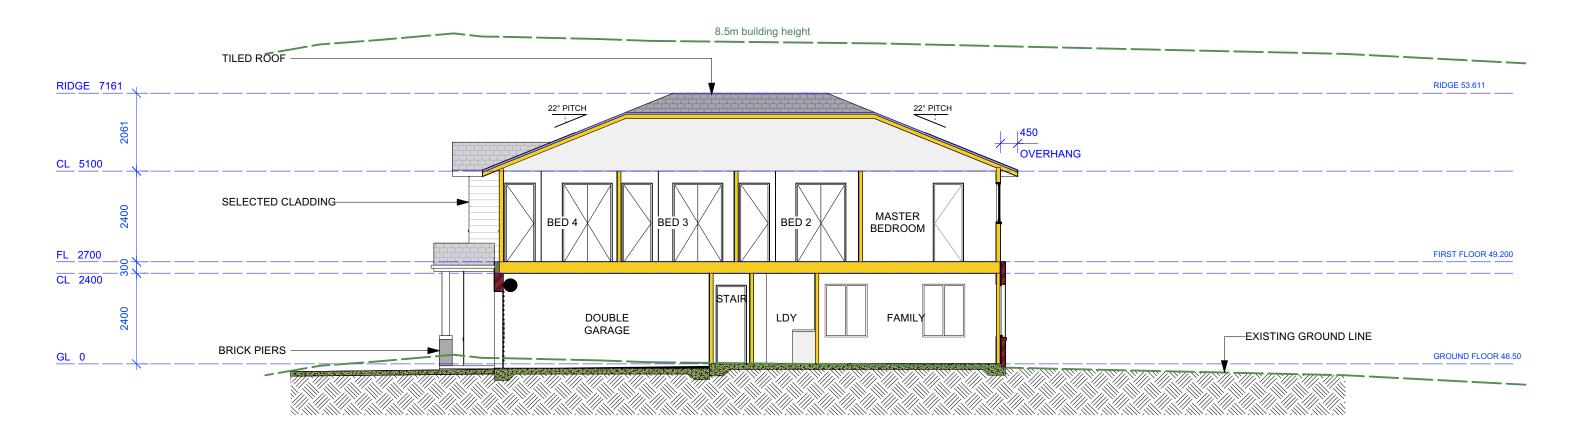

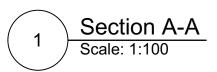

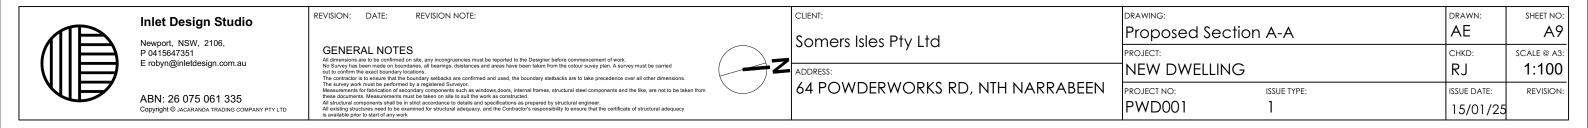

Vindows						_			I					T
Image	ID	Туре	Frame Height	Frame Width	RO Height	RO Width	Glazed Area	Hardware	Manufacturer	Model	Screen	Egress	Glazing	Comments
	W1	Fixed Glass Window	1400	2100	1400	2100	2.56		кз					
	W2	Fixed Glass Window	1400	1420	1400	1420	1.72		КЗ					
	W3	Fixed Glass Window	1400	1120	1400	1120	1.32		КЗ					
	W4	Fixed Glass Window	1400	1120	1400	1120	1.32		КЗ					
	W5	Fixed Glass Window	1400	2100	1400	2100	2.56		К3					
	W6	Fixed Glass Window	1400	1120	1400	1120	1.32		K3					
	W7	Fixed Glass Window	900	580	900	580	0.41		КЗ					
	W8	Awning Hung Window	900	580	900	580	0.28		К3					
	W9	Fixed Glass Window	1300	1300	1300	1300	1.26		К3					
	W10	Fixed Glass Window	1300	1300	1300	1300	1.26		КЗ					
	W11	Fixed Glass Window	1300	2100	1300	2100	2.02		К3					
	W12	Fixed Glass Window	1300	2100	1300	2100	2.02		КЗ					
	W13	Fixed Glass Window	500	1500	500	1500	0.60		К3					
	W14	Awning Hung Window	1100	580	1100	580	0.36		КЗ					
	W15	Sliding Left Window	1100	1030	1100	1030	0.72		К3					
	W16	Sliding Left Window	1100	1030	1100	1030	0.72		КЗ					
	W17	Fixed Glass Window	1100	1500	1100	1500	1.23		КЗ					
	W18	Fixed Glass Window	1100	1500	1100	1500	1.23		К3					
	W19	Fixed Glass Window	1300	2100	1300	2100	2.02		КЗ					
	W20	Fixed Glass Window	1300	2100	1300	2100	2.02		КЗ					
Doors														
Image	ID	Туре	Leaf Height	Leaf Width	Thickne ss	RO Height	RO Width	Glazed Area	Hardware	Manuf.	Model	Screen	Glazing	Comments
	D1	Glazed				2080	900	1.13						
	D2	Flush				2080	700	0.00						
← ←	D3	Glazed				2100	2400	4.86						

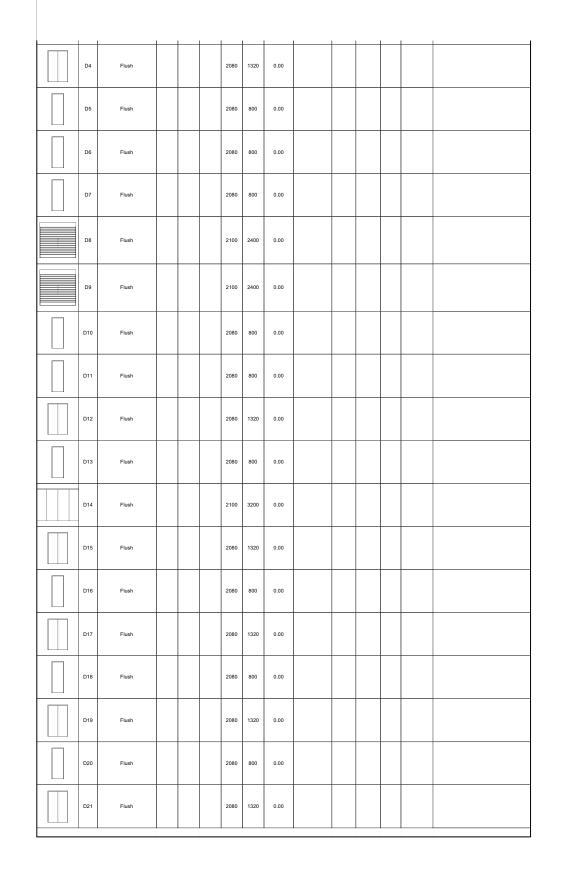



Newport, NSW, 2106, P 0415647351 E robyn@inletdesign.com.au

ABN: 26 075 061 335 Copyright © JACARANDA TRADING COMPANY PTY LTD REVISION: DATE: REVISION NOTE:

GENERAL NOTES

GENERAL NOTES

All dimensions are to be confirmed on site, any incongruencies must be reported to the Designer before commencement of work.

No Survey has been made on boundaries, all bearings, disistances and areas have been taken from the cotour survey plan. A survey must be carried out to confirm the exact boundary locations.

The contractor is to ensure that the boundary setbacks are confirmed and used, the boundary stetbacks are to take precedence over all other dimensions. The survey work must be performed by a registered Surveyor.


Measurements for fabrication of secondary components such as windows doors, internal frames, structural steel components and the like, are not to be taken from these documents. Measurements must be taken on site to sult the work as constructed.

All structural components shall be in strict accordance to details and specifications as prepared by structural engineer.

All existing structures need to be examined for structural adequacy, and the Contractor's responsibility to ensure that the certificate of structural adequacy is available prior to start of any work.



LIENT:	DRAWING:		DRAWN:	SHEET NO:
omers Isles Pty Ltd	Illustrated Windo	AE	A10	
officia isles i Ty Lia	PROJECT:		CHKD:	SCALE @ A3:
DDRESS:	NEW DWELLING		RJ	NTS
54 POWDERWORKS RD, NTH NARRABEEN	PROJECT NO:	ISSUE TYPE:	ISSUE DATE:	REVISION:
	PWD001	1	15/01/25	

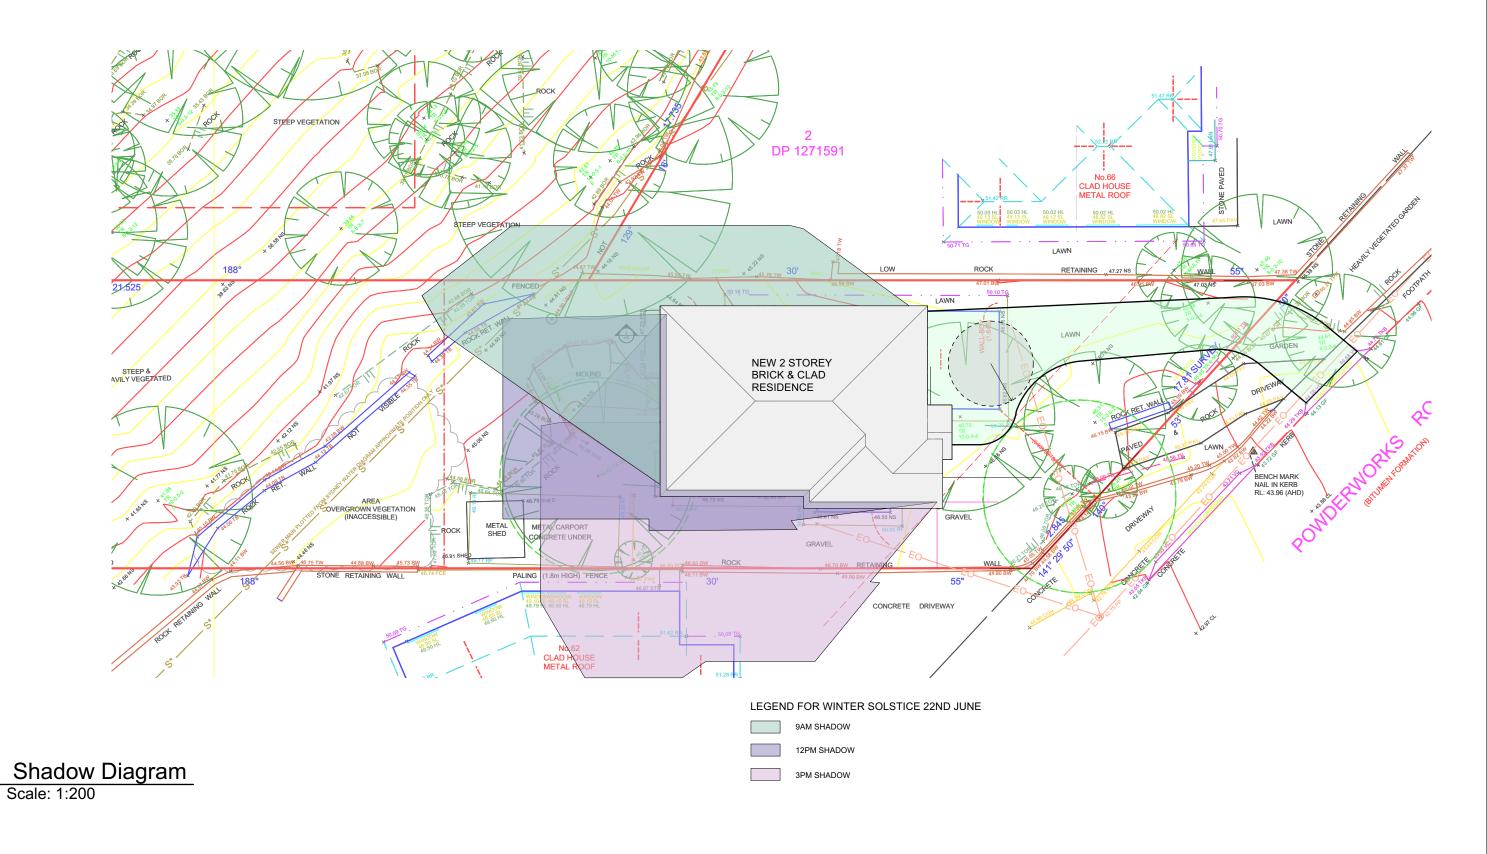



Newport, NSW, 2106, P 0415647351 E robyn@inletdesign.com.au

ABN: 26 075 061 335 Copyright © JACARANDA TRADING COMPANY PTY LTD

revision: date:

GENERAL NOTES

All dimensions are to be confirmed on site, any incongruencies must be reported to the Designer before commencement of work.


No Survey has been made on hourdries, all headings, destances and sees have been been taken from the control survey must be carried.

out to confirm the exact boundary locations.

The contractor is to ensure that the boundary setbacks are confirmed and used, the boundary stetbacks are to take precedence over all other dimensions.

The survey work must be performed by a registered Surveyor.

Measurements for fabrication of secondary components such as windows,doors, internal frames, structural steel components and the like, are not to be taken from

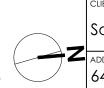

	CLIENT:
_	Somers Isles Pty Ltd
	ADDRESS: 64 POWDERWORKS RD, NTH NARRABEEN

DRAWING:		DRAWN:	SHEET NO:
Shadow Diagram		AE	A11
PROJECT:		CHKD:	SCALE @ A3:
NEW DWELLING		RJ	1:200
PROJECT NO:	ISSUE TYPE:	ISSUE DATE:	REVISION:
PROJECT NO:	ISSUE TYPE:	ISSUE DATE: 15/01/25	