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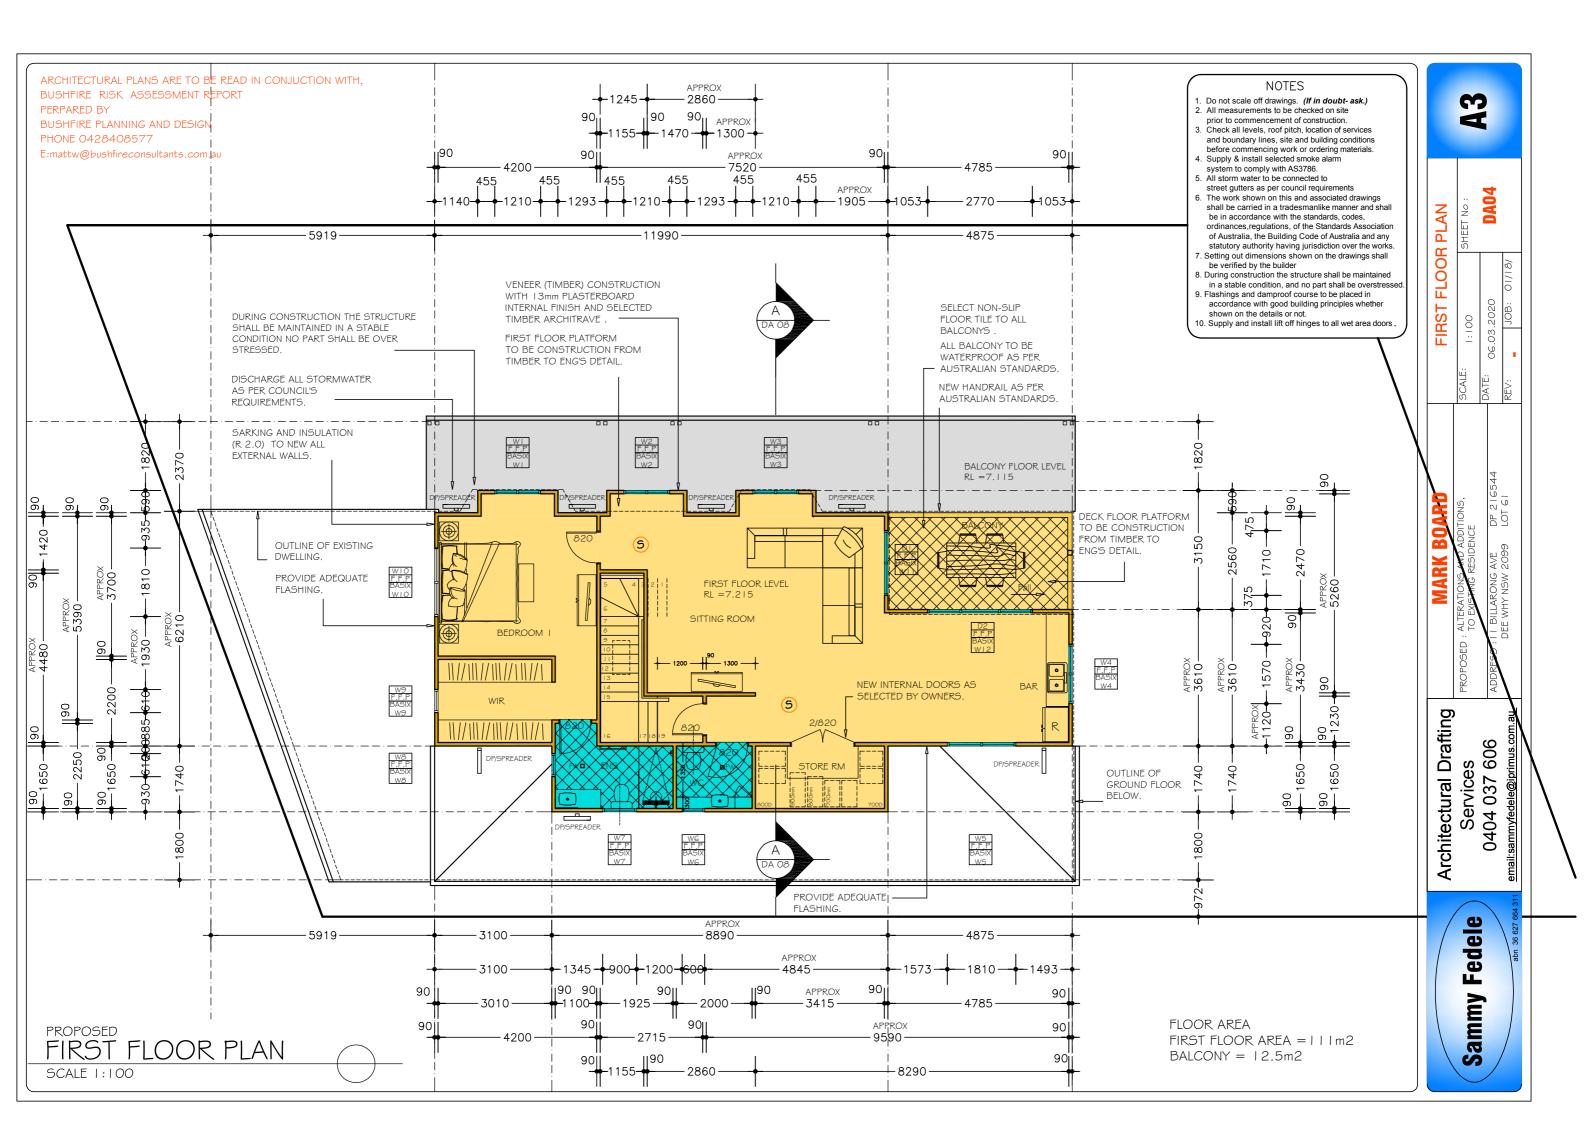
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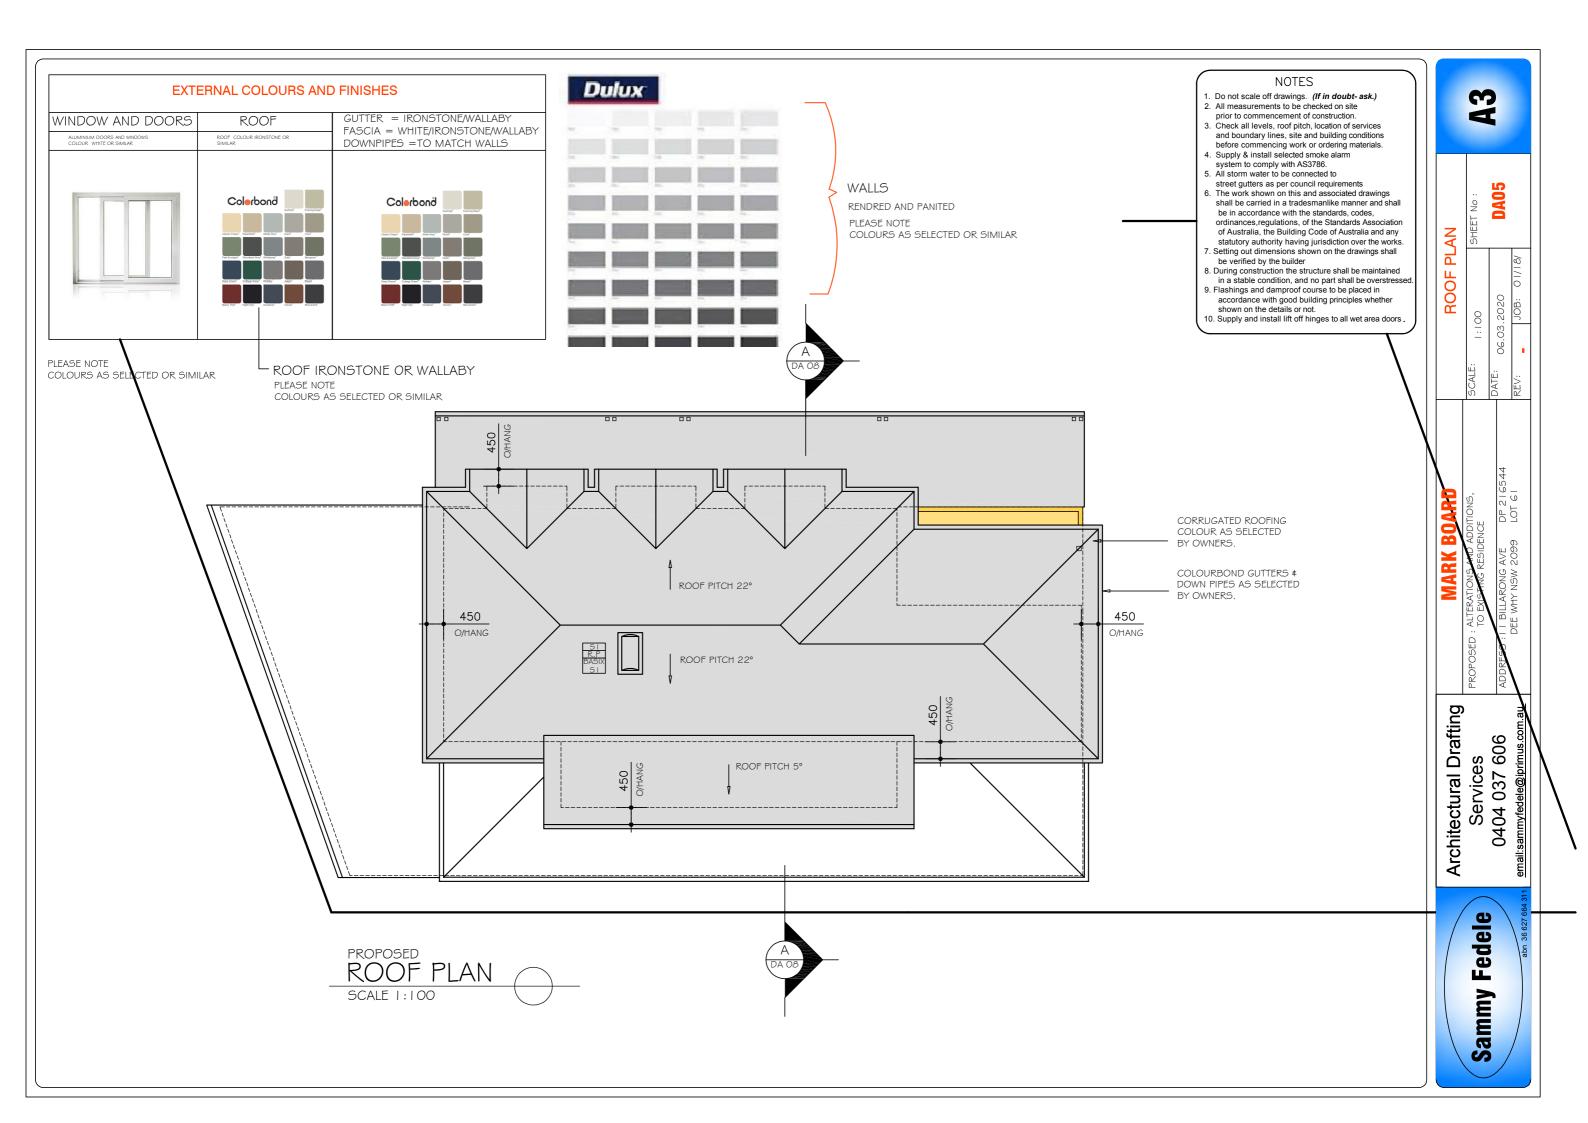
06.03.2020 JOB: 001:1

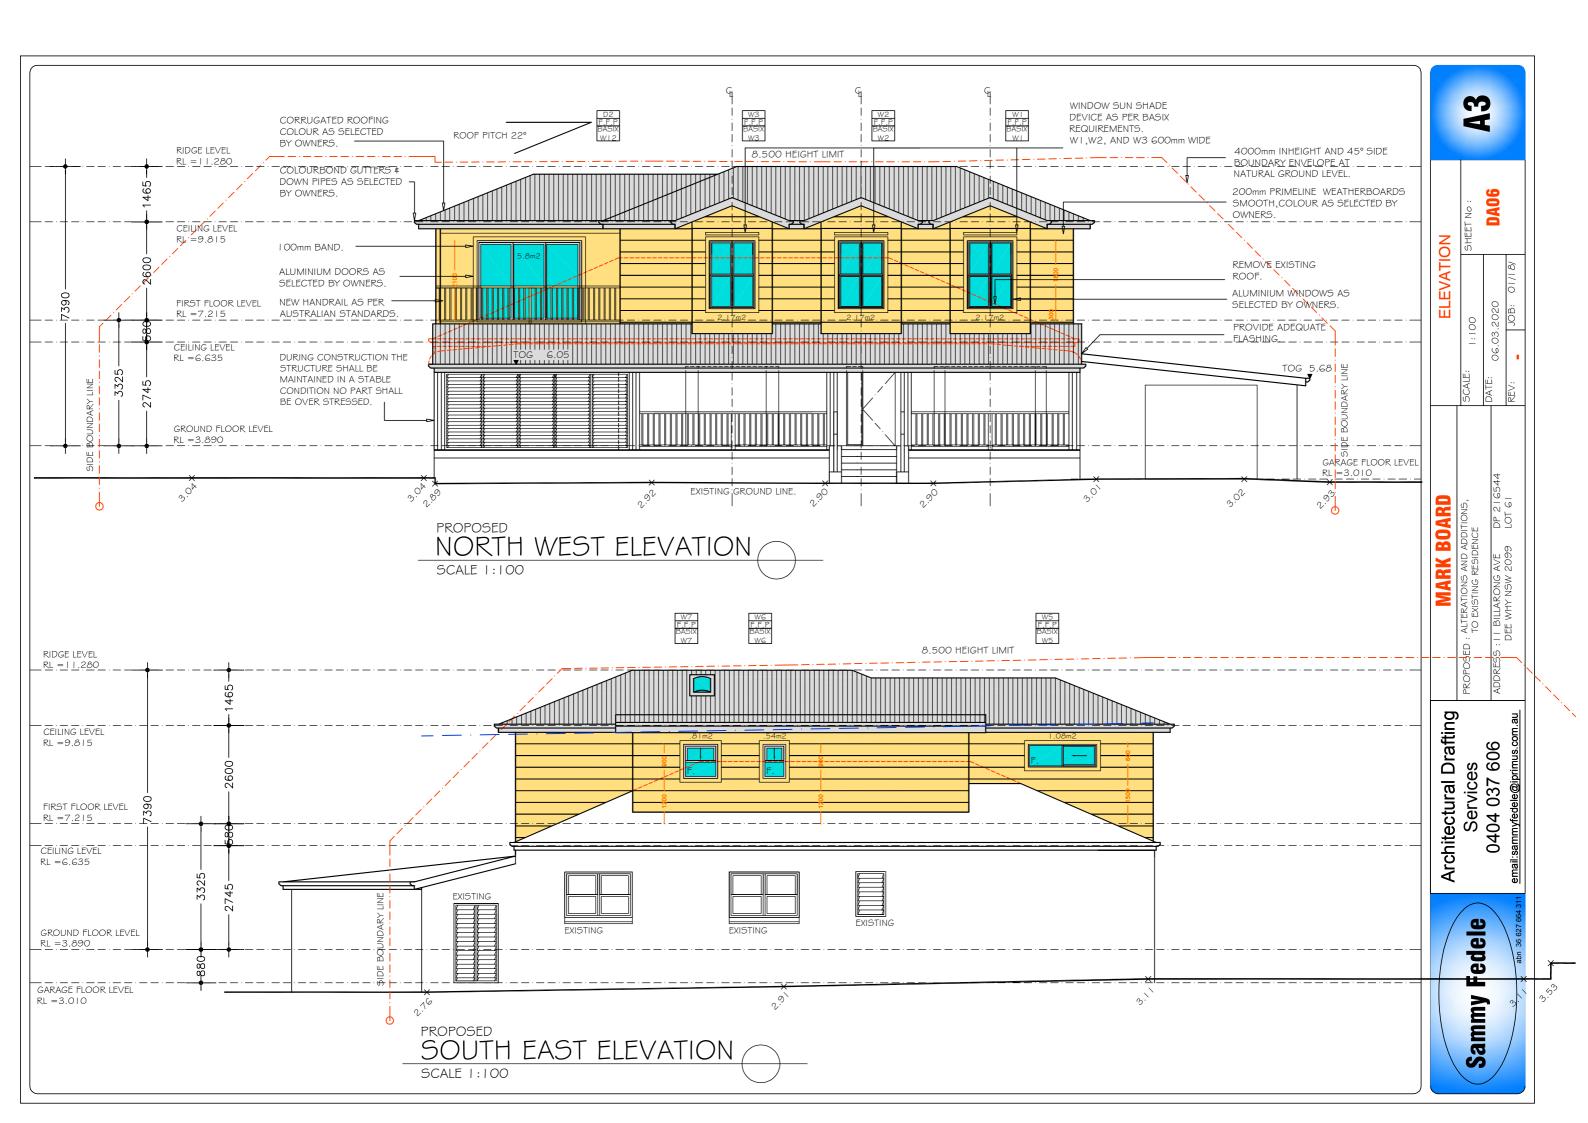
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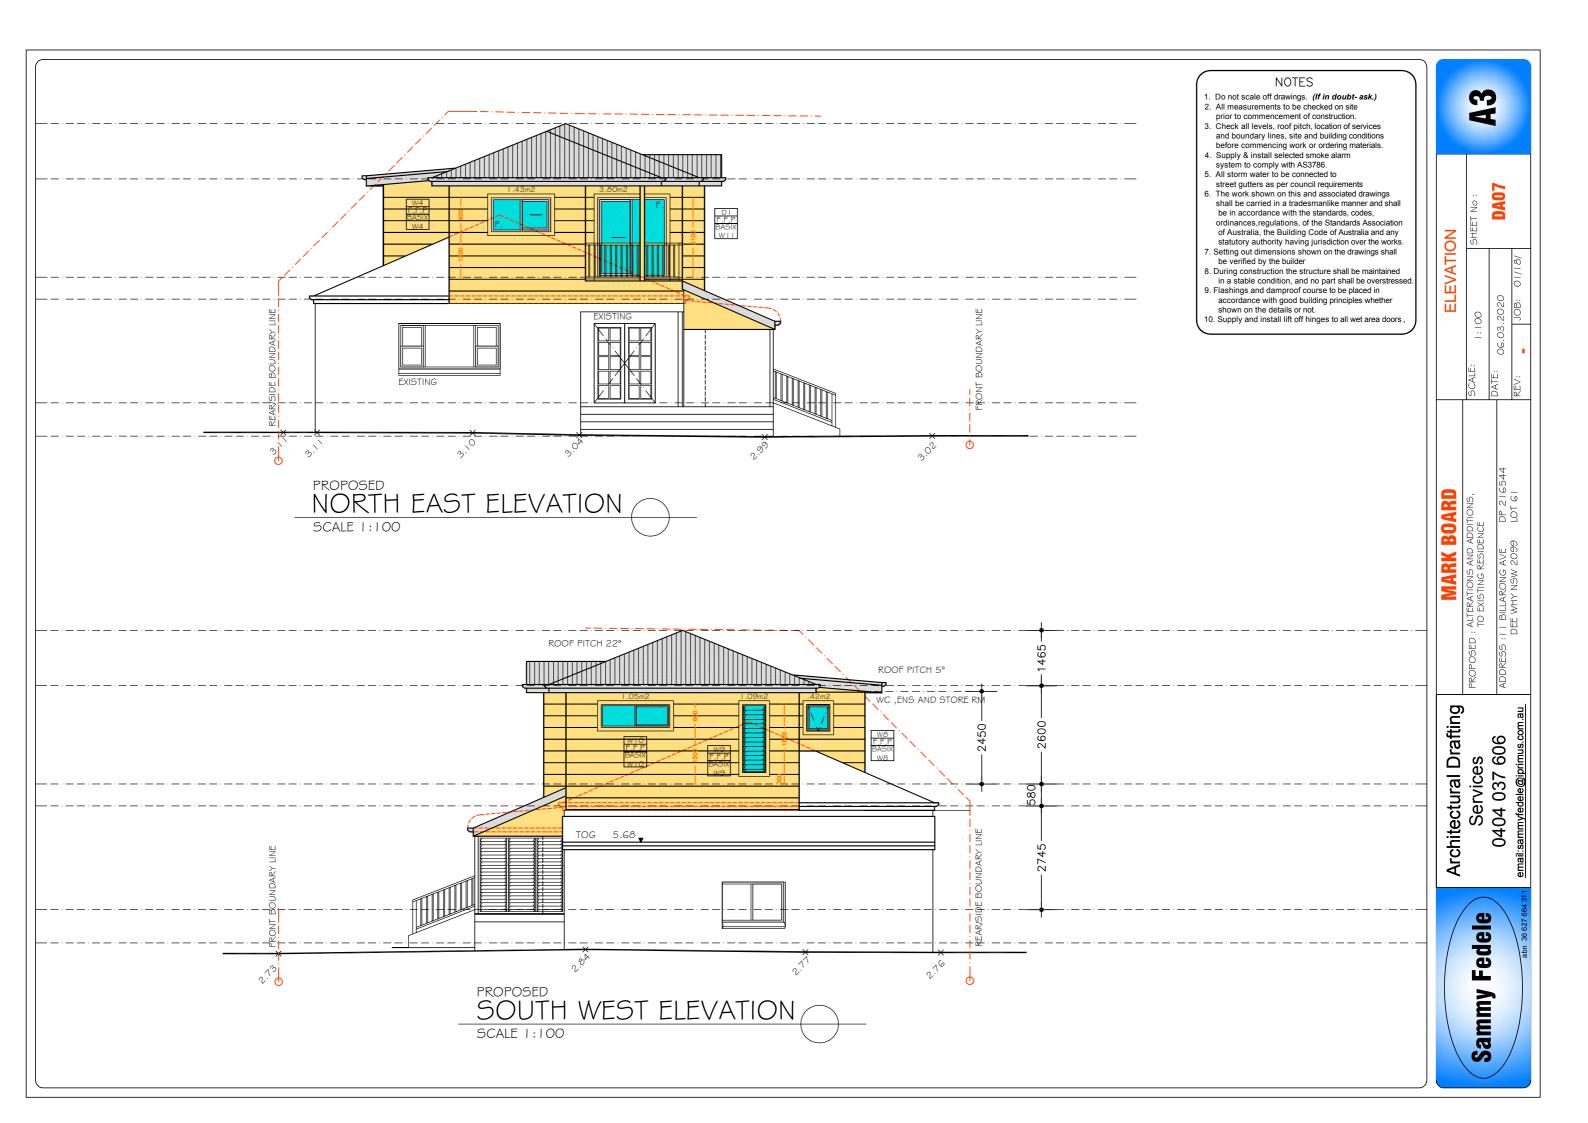
ALTERATIONS AND ADDIT TO EXISTING RESIDENCE

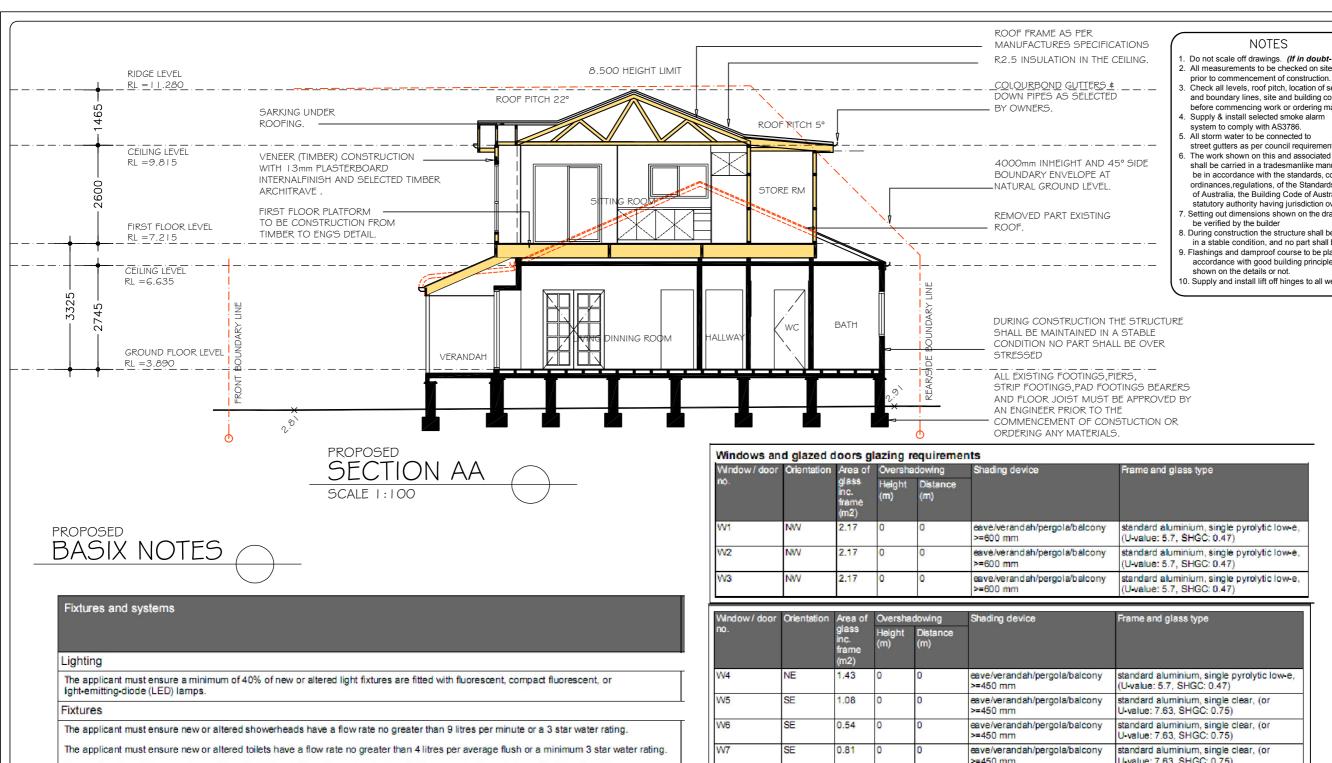
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The applicant must ensure new or altered taps have a flow rate no greater than 9 litres per minute or minimum 3 star water rating.

Construction

Insulation requirements

The applicant must construct the new or altered construction (floor(s), walls, and ceilings/roofs) in accordance with the specifications listed in the table below, except that a) additional insulation is not required where the area of new construction is less than 2m2, b) insulation specified is not required for parts of altered construction where insulation already exists

Construction	Additional insulation required (R-value)	Other specifications
external wall: framed (weatherboard, fibro, metal dad)	R1.30 (or R1.70 including construction)	
external wall: other/undecided	R1.70 (including construction)	
flat ceiling, pitched roof	œiling: R2.50 (up), roof: foil/sarking	medium (solar absorptance 0.475 - 0.70)
flat ceiling, flat roof: framed	œiling: R2.50 (up), roof: foil/sarking	medium (solar absorptance 0.475 - 0.70)

- . Do not scale off drawings. (If in doubt-ask.)
- prior to commencement of construction.
- Check all levels, roof pitch, location of services and boundary lines, site and building conditions before commencing work or ordering materials.
- Supply & install selected smoke alarm system to comply with AS3786.
- street gutters as per council requirements
- 6. The work shown on this and associated drawings shall be carried in a tradesmanlike manner and shall be in accordance with the standards, codes, ordinances, regulations, of the Standards Association of Australia, the Building Code of Australia and any statutory authority having jurisdiction over the works.
- 7. Setting out dimensions shown on the drawings shall be verified by the builder
- 8. During construction the structure shall be maintained in a stable condition, and no part shall be overstressed
- Flashings and damproof course to be placed in accordance with good building principles whether
- 10. Supply and install lift off hinges to all wet area doors

Windows and glazed doors glazing requirements								
٧	indow/door	door Orientation Area of Overshadowing		dowing	Shading device	Frame and glass type		
n) .		glass inc. frame (m2)	Height (m)	Distance (m)			
V	/1	NW	2.17	0	0	eave/verandah/pergola/balcony >=600 mm	standard aluminium, single pyrolytic low-e, (U-value: 5.7, SHGC: 0.47)	
V	/2	NW	2.17	0	0	eave/verandah/pergola/balcony >=600 mm	standard aluminium, single pyrolytic low-e, (U-value: 5.7, SHGC: 0.47)	
W	/3	NW	2.17	0	0	eave/verandah/pergola/balcony >=600 mm	standard aluminium, single pyrolytic low-e, (U-value: 5.7, SHGC: 0.47)	

Window / door Orientation Area of Overshall			Oversha	dowing Shading device		Frame and glass type	
no.		glass inc. frame (m2)	Height (m)	Distance (m)			
W4	NE	1.43	0	0	eave/verandah/pergola/balcony >=450 mm	standard aluminium, single pyrolytic low-e, (U-value: 5.7, SHGC: 0.47)	
W5	SE	1.08	0	0	eave/verandah/pergola/balcony >=450 mm	standard aluminium, single clear, (or U-value: 7.63, SHGC: 0.75)	
W6	SE	0.54	0	0	eave/verandah/pergola/balcony >=450 mm	standard aluminium, single clear, (or U-value: 7.63, SHGC: 0.75)	
W7	SE	0.81	0	0	eave/verandah/pergola/balcony >=450 mm	standard aluminium, single clear, (or U-value: 7.63, SHGC: 0.75)	
W8	SW	0.42	0	0	eave/verandah/pergola/balcony >=450 mm	standard aluminium, single clear, (or U-value: 7.63, SHGC: 0.75)	
W9	SW	1.09	0	0	eave/verandah/pergola/balcony >=450 mm	standard aluminium, single clear, (or U-value: 7.63, SHGC: 0.75)	
W10	SW	1.05	0	0	eave/verandah/pergola/balcony >=450 mm	standard aluminium, single clear, (or U-value: 7.63, SHGC: 0.75)	
W11	NE	3.8	0	0	eave/verandah/pergola/balcony >=900 mm	standard aluminium, single clear, (or U-value: 7.63, SHGC: 0.75)	
W12	NW	5.8	0	0	eave/verandah/pergola/balcony >=900 mm	standard aluminium, single clear, (or U-value: 7.63, SHGC: 0.75)	

Glazing requirements

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	Area of glazing inc. frame (m2)	Shading device	Frame and glass type
S1	0.5		aluminium, moulded plastic single clear, (or U-value: 6.21, SHGC: 0.808)

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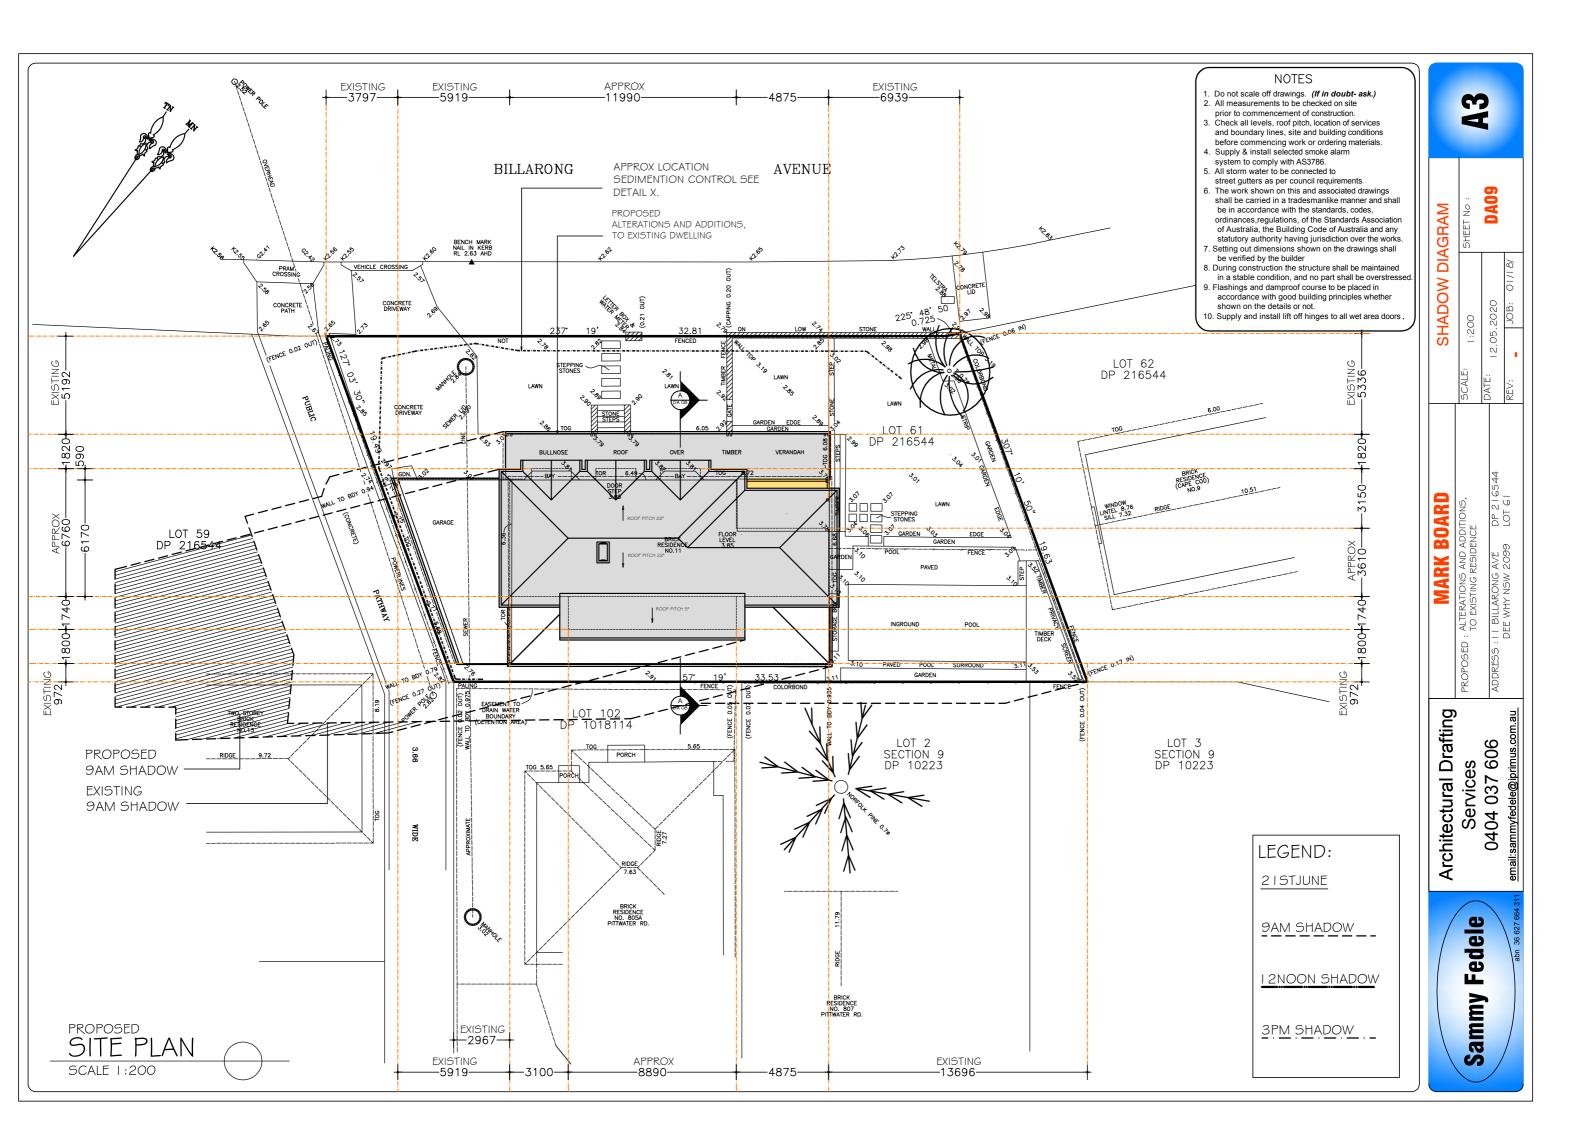
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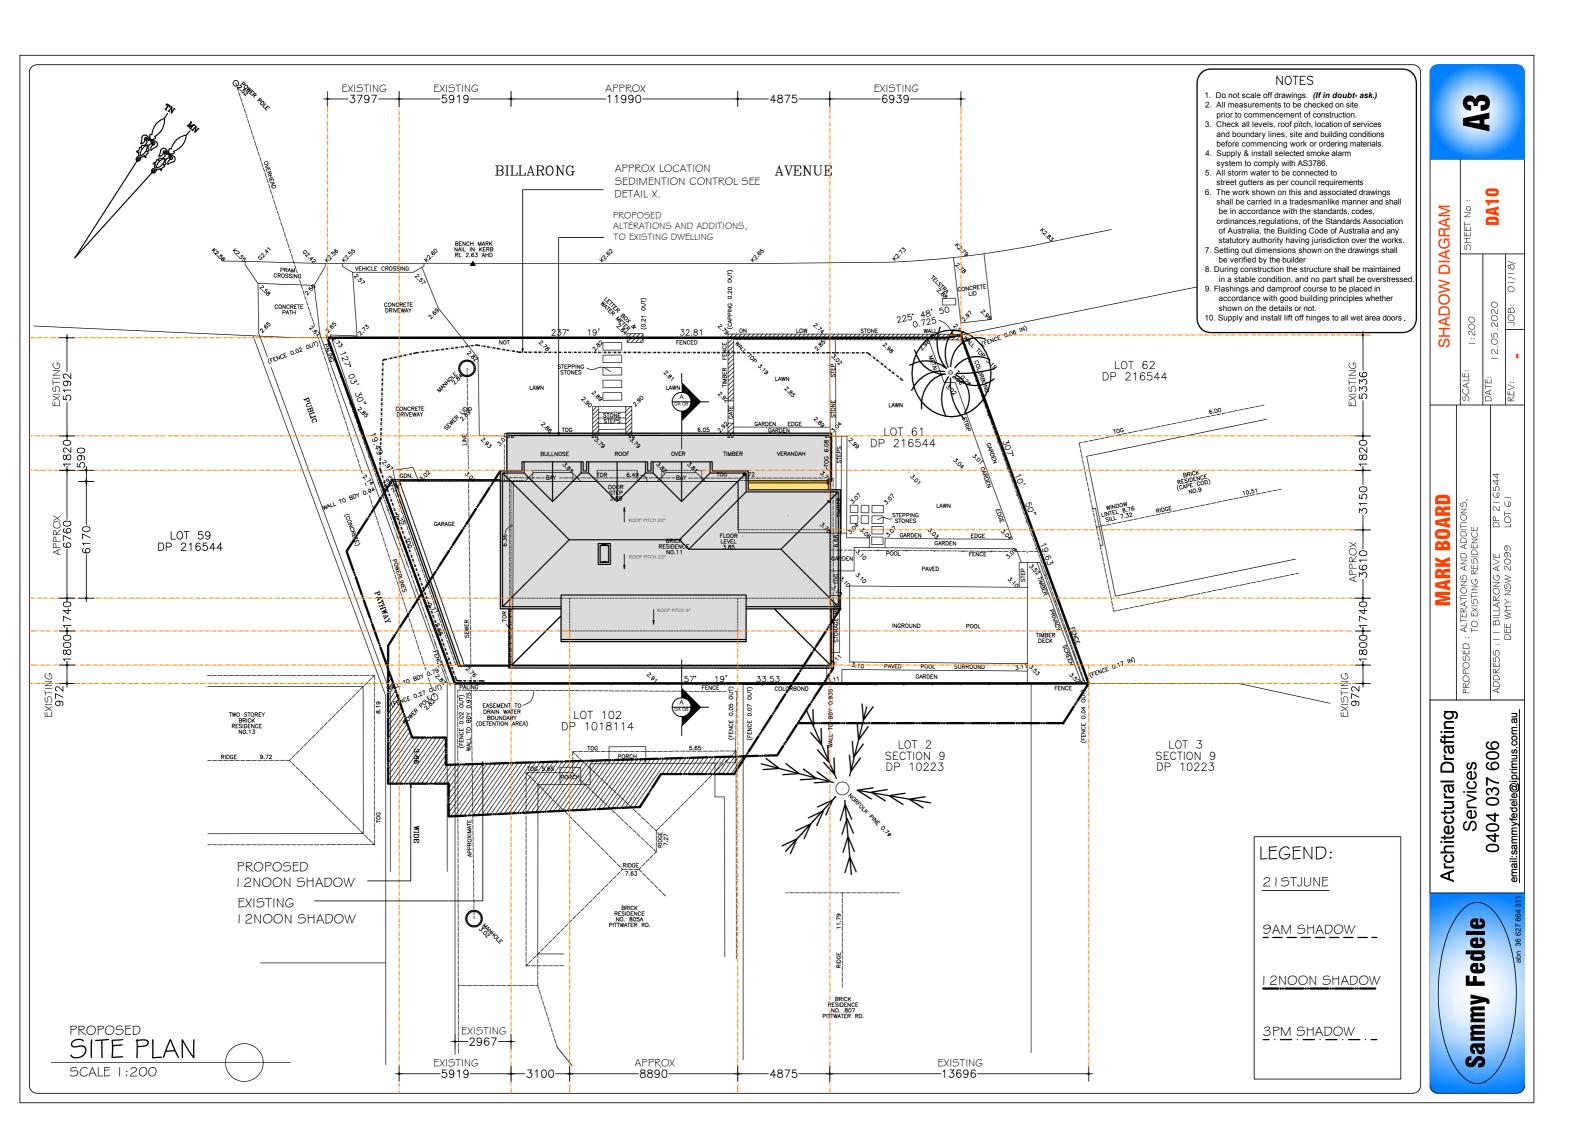
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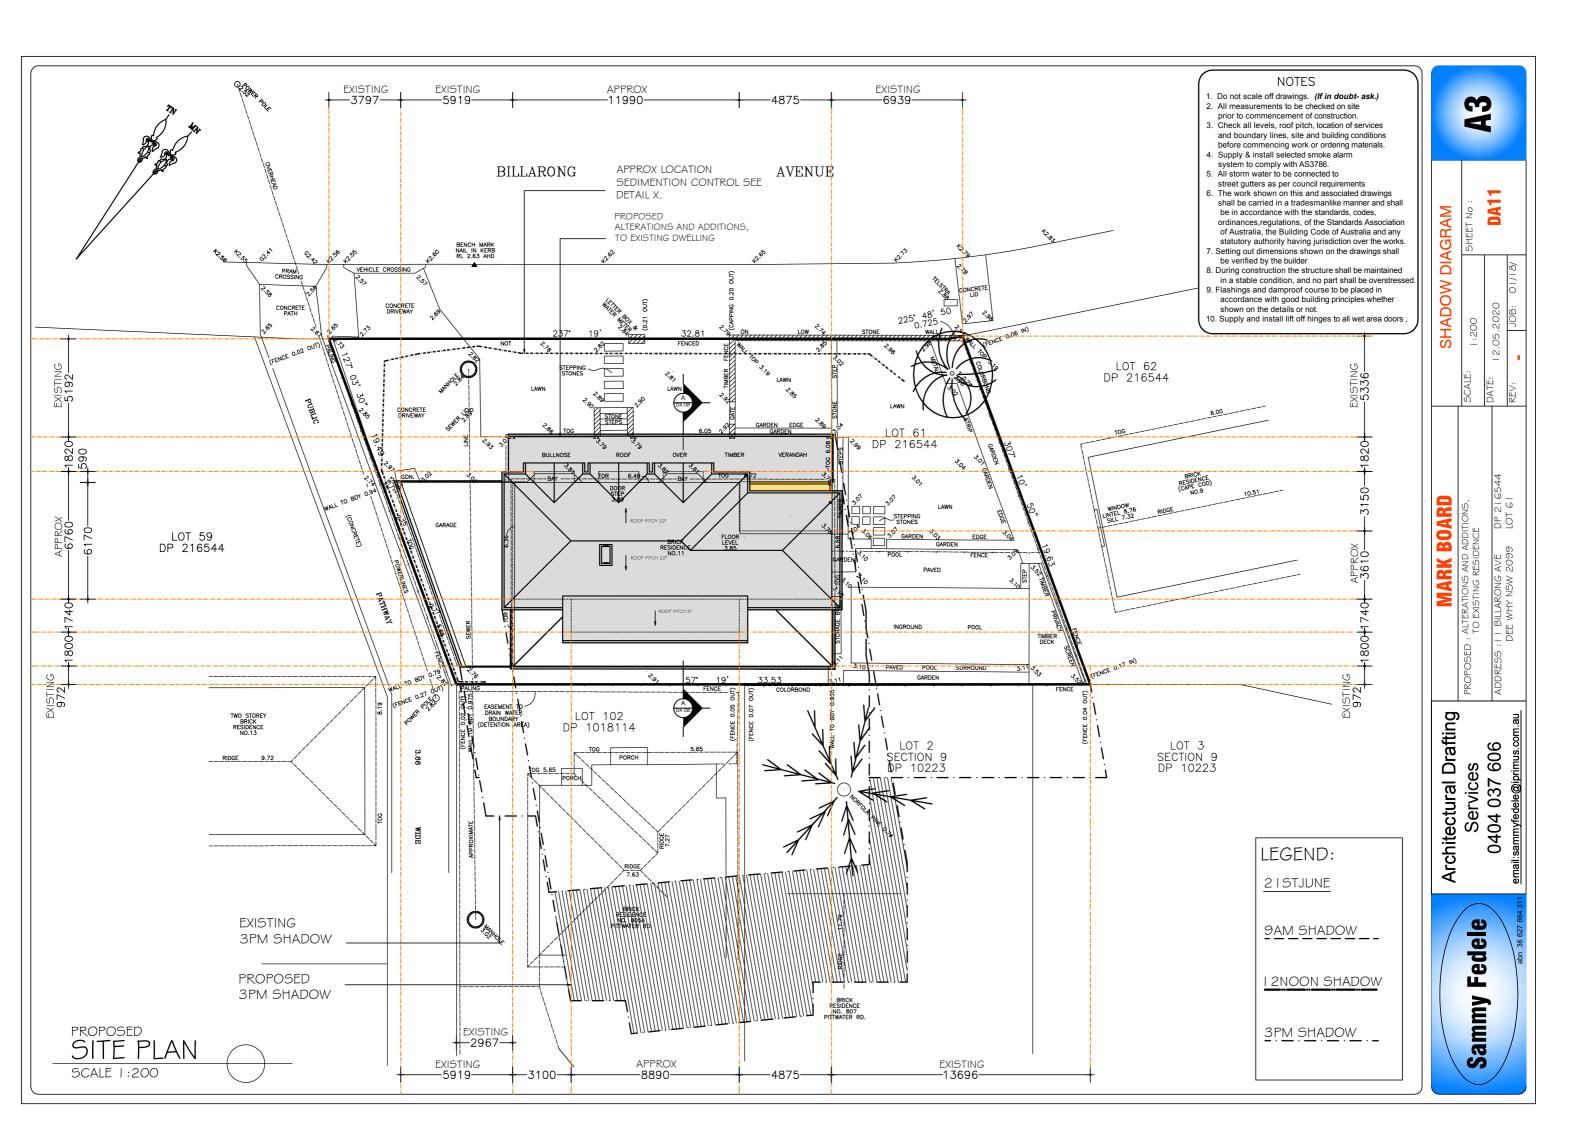
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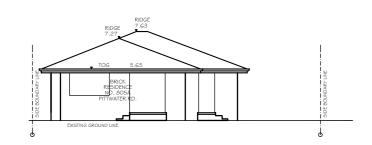
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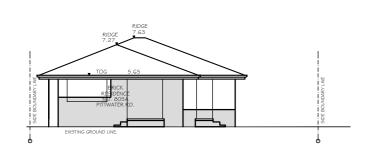






NORTH WEST ELEVATION 9AM

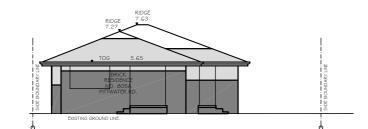
SCALE 1:200



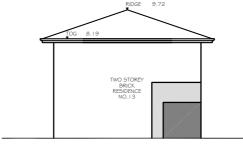
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PROPOSED NORTH WEST ELEVATION 12NOON SCALE 1:200

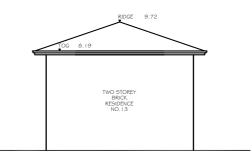
PROPOSED
NORTH WEST ELEVATION 9AM
SCALE 1:200



EXISTING/PROPOSED
NORTH WEST ELEVATION 3PM
SCALE 1:200



PROPOSED NORTH EAST ELEVATION 9AM SCALE 1:200

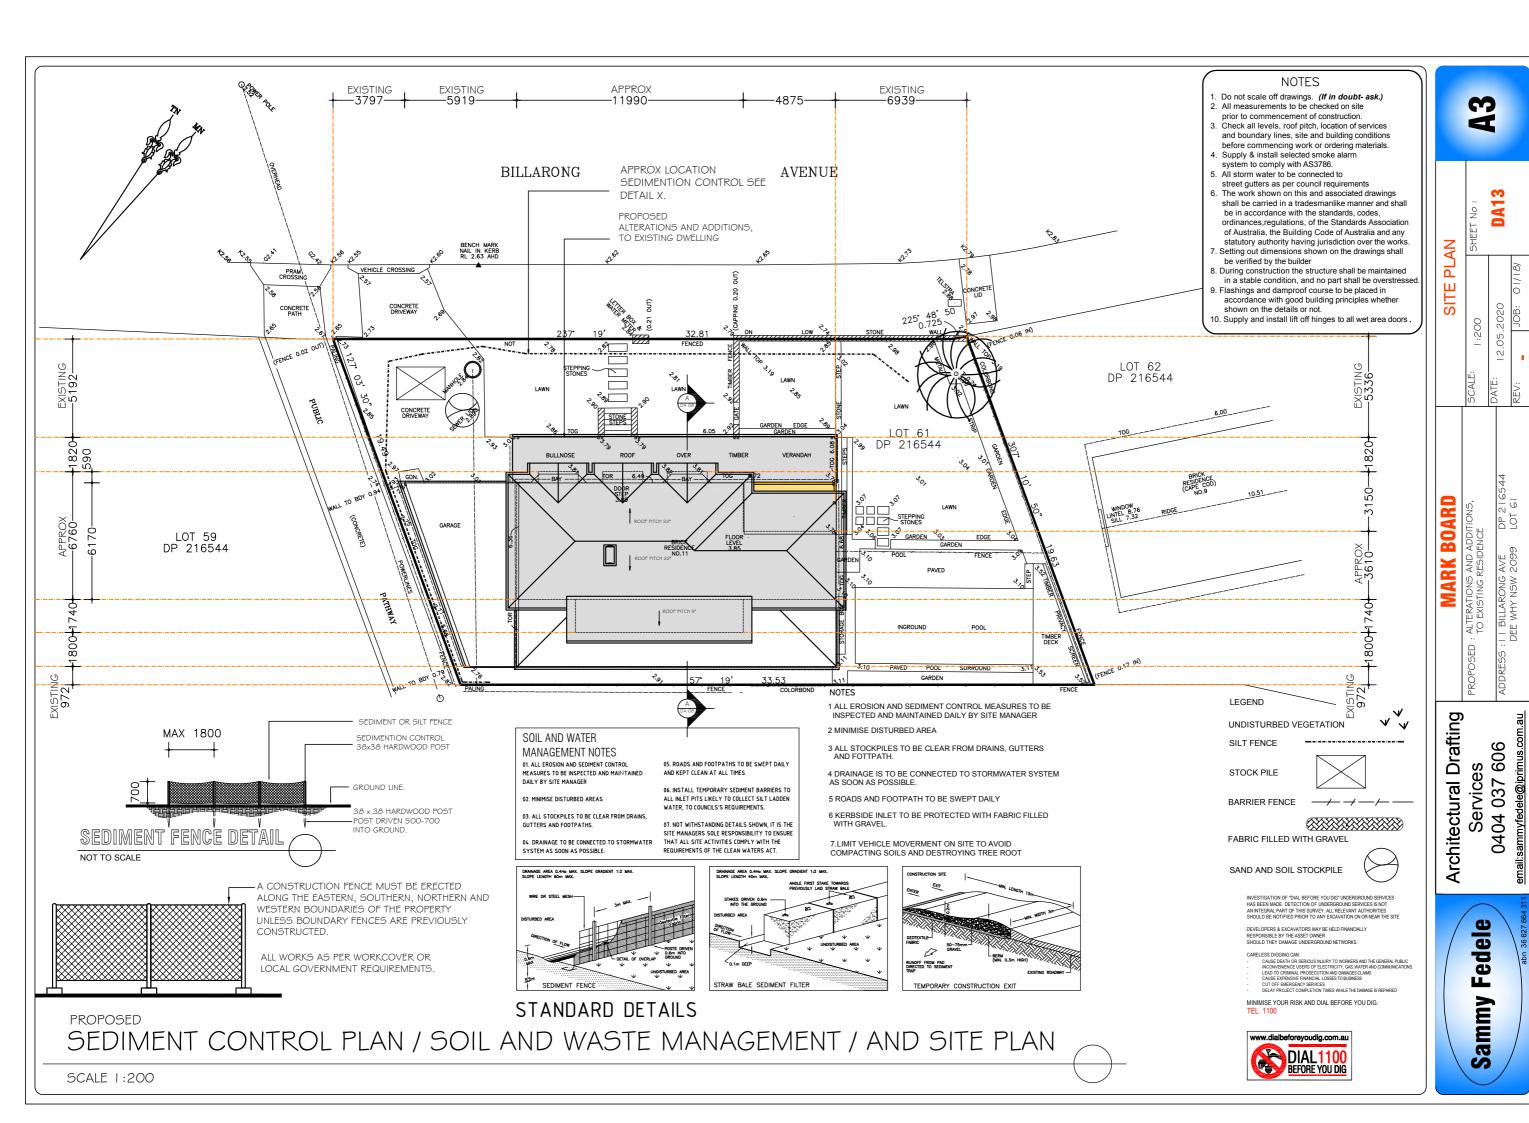


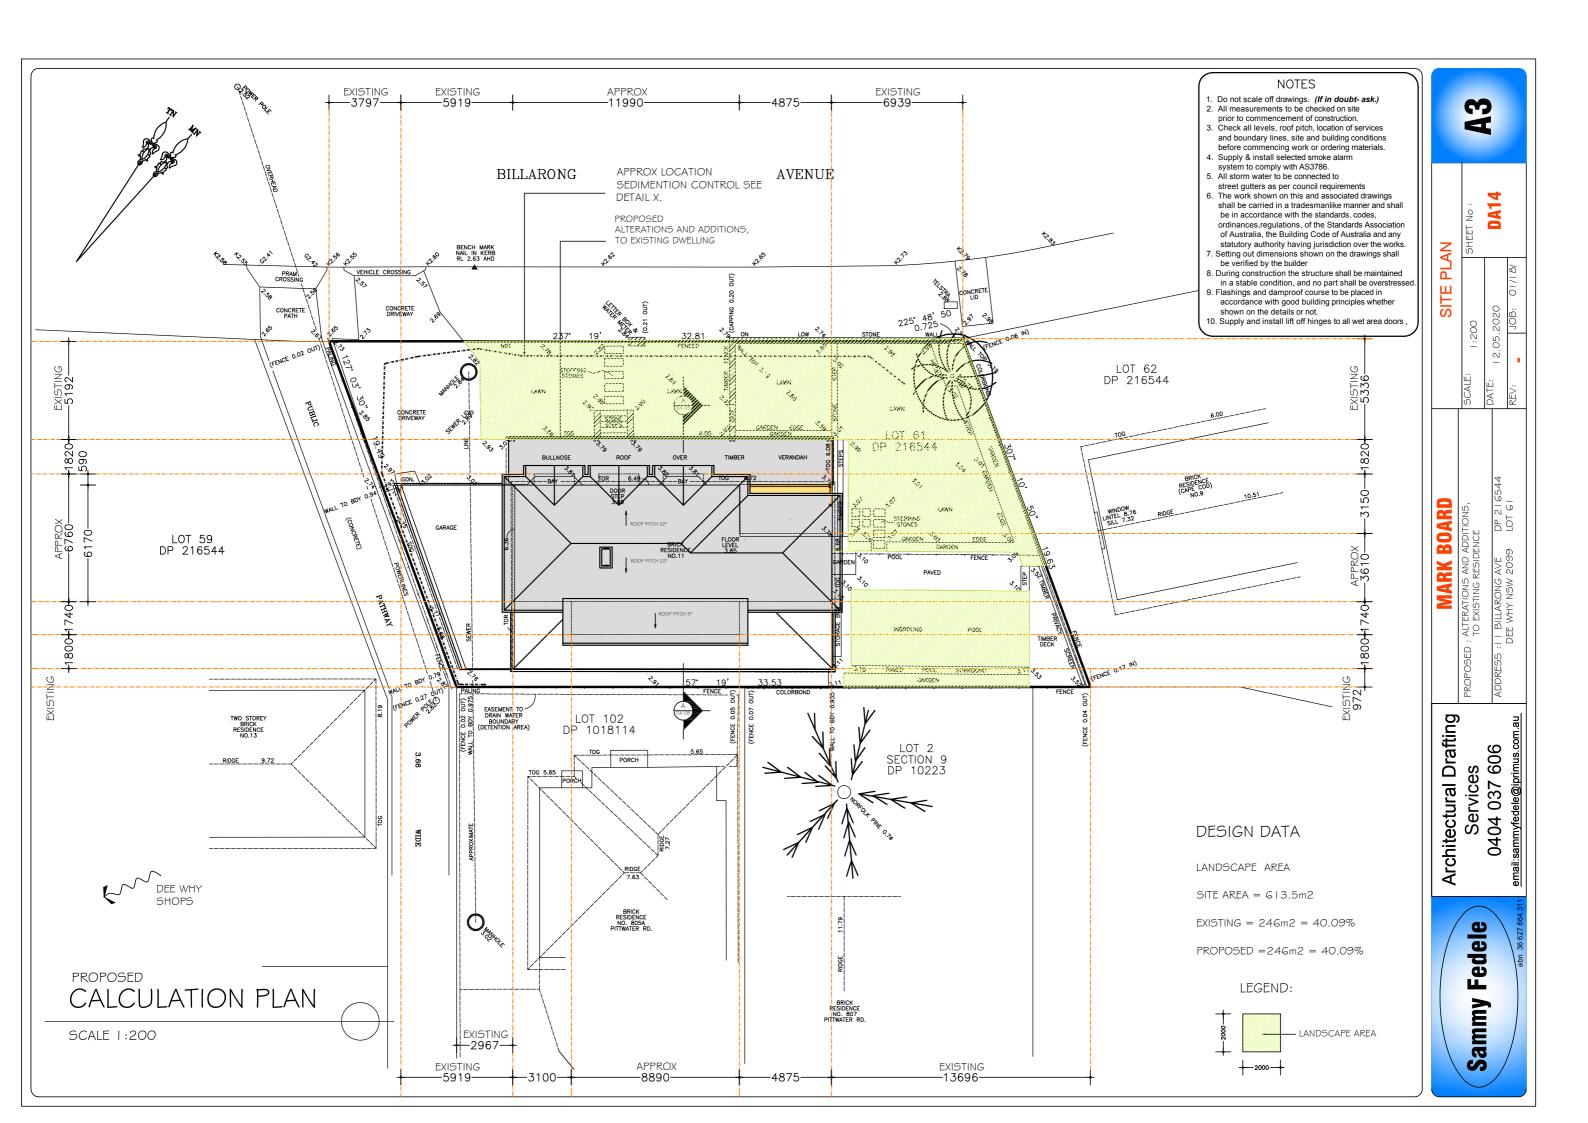
EXISTING/PROPOSED
NORTH EAST ELEVATION
1 2 NOON AND 3 PM
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SECTION ONE - DEMOLITION STAGE

MATERIALS ON SITE		DESTINATION		
		REUSE AND RECYCLING		DISPOSAL
TYPE OF MATERIAL	ESTIMATED VOLUME (m3)	ON-SITE *Specify proposed reuse or on-site recycling methods	OFF-SITE *Specify contractor and recycling outlet	*Specify contractor and landfill site
Excavation Material	-			
Green Waste	-			
Bricks	-			
Concrete	-			
Timber — Please specify:	6.0m3 APPROX		SKIP BINS "DATS" OR BULDERS PERFERRED OPTION (RECYCLING PLANT)	
Plasterboard	2.0m3 APPROX		SKIP BINS "DATS" OR BULDERS PERFERRED OPTION (RECYCLING PLANT)	
Metals - Please specify:	I.Om3 APPROX		SKIP BINS "DATS" OR BULDERS PERFERRED OPTION (RECYCLING PLANT)	
Other — Please specify:	6.0m3 APPROX		SKIP BINS "DATS" OR BULDERS PERFERRED OPTION (RECYCLING PLANT)	

SECTION TWO - CONSTRUCTION STAGE

MATERIALS ON SITE		DESTINATION		
		REUSE AND RECYCLING		DISPOSAL
TYPE OF MATERIAL	ESTIMATED VOLUME (m3)	ON-SITE *Specify proposed reuse or on-site recycling methods	OFF-SITE *Specify contractor and recycling outlet	*Specify contractor and landfill site
Excavation Material	-			
Green Waste	-			
Bricks	-			
Concrete	1			
Timber – Please specify:	6.0m3 APPROX		SKIP BINS "DATS" OR BULDERS PERFERRED OPTION (RECYCLING PLANT)	
Plasterboard	G.Om3 APPROX		SKIP BINS "DATS" OR BULDERS PERFERRED OPTION (RECYCLING PLANT)	
Metals – Please specify:	6.0m3 APPROX		SKIP BINS "DATS" OR BULDERS PERFERRED OPTION (RECYCLING PLANT)	
Other — Please specify:	6.0m3 APPROX		SKIP BINS "DATS" OR BULDERS PERFERRED OPTION (RECYCLING PLANT)	

A3 WASTE MANAGEMENT

1:200 SHEET No: MARK BOARD

PROPOSED: ALTERATIONS AND ADDITIONS,
TO EXISTING RESIDENCE Architectural Drafting Services 0404 037 606 Sammy Fedele

WASTE MANAGEMENT