

EROSION NOTES

Arborist Recommendations

be at existing ground levels.

is crucial in this vicinity.

T5 if

remain in situ.


Arborist

on Page 14.


- 01. ALL EROSION AND SEDIMENT CONTROL MEASURES TO BE INSPECTED AND MAINTAINED DAILY BY SITE MANAGER.
- MINIMISE DISTURBED AREAS
- ALL STOCKPILES TO BE CLEAR FROM DRAINS, GUTTERS AND FOOTPATHS. 03.
- DRAINAGE TO BE CONNECTED TO STORMWATER SYSTEM AS SOON AS POSSIBLE. 04.
- ROADS AND FOOTPATH TO BE SWEPT DAILY.
- NO MATERIAL TO BE STORED ON FOOTPATH.
- SILTFENCE TO BE CONSTRUCTED AS PER DETAIL SHOWN OR BY USING AN APPROVED EQUIVALENT MEASURE. THE SILTFENCE IS TO BE CONSTRUCTED PRIOR TO ANY OTHER CONSTRUCTION ACTIVITIES. IT IS TO BE KEPT IN GOOD WORKING ORDER AT ALL TIMES. WHEN APPROXIMATELY 30% FULL OR AS DIRECTED BY COUNCIL'S REPRESENTATIVE


- DEMOLITION IS TO BE CARRIED OUT IN ACCORDANCE WITH AUSTRALIAN STANDARD 2601-1991 THE DEMOLITION IS TO BE CARRIED OUT IN ACCORDANCE WITH AUSTRALIAN STANDARD 2001-199
 DEMOLITION OF STRUCTURES.
 DEMOLITION IS TO BE CARRIED OUT BY A QUALIFIED AND LICENCED DEMOLITION COMPANY.
 AS3.1.1 AT ALL TIMES DEMOLITION WORK SHALL BE SUPERVISED BY A COMPETENT PERSON.
 DEMOLISHED HOUSE TO BE RECYCLED AS PER WASTE MANAGEMENT PLAN.
 OBTAIN ALL NECESSARY PERMITS AND APPROVALS.

- ALL EXISTING SERVICES TO BE DISCONNECTED AND SEALED BEFORE DEMOLITION.
 REMOVAL OF HAZARDOUS SUBSTANCES SHALL BE CARRIED OUT BY A CONPETENT AND QUALIFIED PERSON.
- REMOVAL OF ASBESTOS SHALL BE IN ACCORDANCE WITH THE NOHSC (WORK SAFE AUSTRALIA).
- STRUCTURES SHALL BE DEMOLISHED PROGRESSIVELY, STOREY BY STOREY (SEQUENTIAL METHOD)
- DEMOLISHED MATERIALS SHALL BE REMOVED PROGRESSIVELY AND NOT BE ALLOWED TO ACCUMLATE ON
- DEMOLISHED MATERIALS SHALL NOT BE ALLOWED TO FALL FREELY. AS3.1.8 THE SITE SHALL BE SECURED AT ALL TIMES AGAINST THE UNAUTHORIZED ENTRY OF PERSONS OR

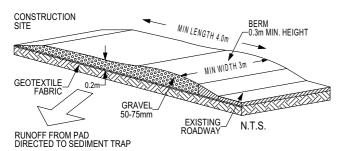

TEMPORARY CONSTRUCTION EXIT / ENTRANCE

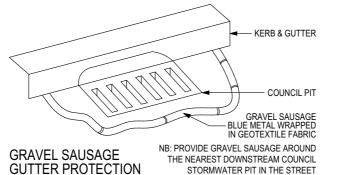

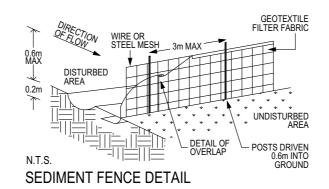

WASTE MANAGEMENT PLAN				
Dest	ination of Ma	terials during (Construction S	tage
	On - Site Materials		Re - Use & Recycling	Disposal
Material	Estimated volume	Re-use & Recycling On-Site	Recycling Off-Site	Disposal Off-Site
Excavation	540 m ³	N/A	N/A	N/A
Green Waste	NIL	N/A	N/A	N/A
Bricks	16 m³	separate adjacent to geotextile waste bin	'Brandown' - Kemps Creek 'Eco Cycle Materials' - Wetherill Park 'Benedicts' - Chipping Norton	
Concrete	12 m³	on - site as all weather access	N/A	N/A
Timber	10 m³	stored separately in geotextile waste bin	'Brandown' - Kemps Creek 'Eco Cycle Materials' - Wetherill Park 'Benedicts' - Chipping Norton	
Plaster board and fibro	15 m³	stored seperately	recycled by 'CSR'	'CSR'
Metals	2 m³	stored separately in geotextile waste bin	'Smorgon Steel'	'Smorgon Steel'
Other(eg. Tiles paints, plastics, PVC tubing, cardboard)	1.0 m³	stored separately in geotextile waste bin	'Brandown' - Kemps 'Eco Cycle Materials 'Benedicts' - Chippin	s' - Wetherill Park

ISSUE	DATE	DESCRIPTION	APP BY
A	15/11/2022	ISSUE FOR APPROVAL	RM
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DEVELOPMENT APPLICATION

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Mr Kevin Xue

1. M.Y.XU & CO SURVEYORS
2. SDS ENGINEERING
3. PLAN ZONE 4. NSW TREES 5. CONZEPT LANDSCAPE ARCHITECTS 6. ESWNMAN

NEW SINGLE DWELLING 2 STOREY HOUSE

PROJECT LOCATION 206 Hudson Parade CLAREVILLE NSW 2107 Australia LOT 38 DP 13760

PROJECT	NUMBER
22009	

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l	DRAWING NUMBER	SCALE	ISSUE

DA 15 DRAWING STATUS

NOT FOR CONSTRUCTION

1:200

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CALCULATIONS: SITE AREA = 632.3m²

GROUND FLOOR = 144.50m² FIRST FLOOR = 76.32m² BEDROOMS FLOOR = 110.42m² $VOID = 17.54m^2$ PRIVATE OPEN SPACE LEVEL= 86.64m² POOL AND DECK = 51.11m²
MASTER BED BALCONY = 9.21m² BEDROOMS BALCONY = 12.27m² LIVING BALCONY = 21.34m²

TOTAL FLOOR AREA: $144.50m^2 + 76.32m^2 + 110.42m^2 =$ 331.24m²

GROSS FLOOR AREA EXCLUDES BALCONIES, ALFRESCO, STAIRWELL (FIRST FLOOR) AND VOIDS, AREA MEASURED FROM INSIDE SKIN OF EXTERNAL

LANDSCAPE AREAS BACKYARD = 200.81m² FRONTYARD = $62.11m^2$ COURTYARD AND SIDEYARD = 73.14m² POS: POS LEVEL + POOL AND DECK + BACKYARD= 338.38m² OPEN SPACE AREA (HARD LANDSCAPING + SOFT LANDSCAPING) = 396.57 = 62.72% OVERALL LANDSCAPED AREA =336.06m² = 53.15%

BASIX NOTES

ALTERNATIVE WATER

RAINWATER TANK

The applicant must install a rainwater tank of at least 4000 litres on the site. This rainwater tank must meet, and be installed in accordance with, the requirements of all applicable regulatory authorities.

SWIMMING POOL

The swimming pool must not have a volume greater than 51 kilolitres.

The swimming pool must be outdoors.

THERMAL COMFORT COMMITMENTS

SIMULATION METHOD

The applicant must show on the plans accompanying the development application for the proposed development, all matters which the Assessor Certificate requires to be shown on those plans. Those plans must bear a stamp of endorsement from the Accredited Assessor to certify that this is the case. The applicant must show on the plans accompanying the application for a construction certificate (or complying development certificate, if applicable), all thermal performance specifications set out in the Assessor Certificate, and all aspects of the proposed development which were used to calculate those specifications.

BRICK DWFI LING

The applicant must construct the floors and walls of the dwelling in accordance with the specifications listed in the table below.

floor - concrete slab on ground 88.0 square metres floor - suspended floor/open subfloor 11.0 square metres floor - suspended floor/enclosed subfloor 68.0 square metres floor - suspended floor above garage All or part of floor area

ENERGY COMMITMENTS

The applicant must install the following hot water system in the development, or a system with a higher energy rating: gas instantaneous with a performance of 4 stars.

NATURAL LIGHTING


The applicant must install a window and/or skylight in the kitchen of the dwelling for natural lighting.

The applicant must install a window and/or skylight in 5 bathroom(s)/toilet(s) in the development for natural lighting.

ALTERNATIVE ENERGY

The applicant must install a photovoltaic system with the capacity to generate at least 1.5 peak kilowatts of electricity as part of the

development. The applicant must connect this system to the development's electrical system.

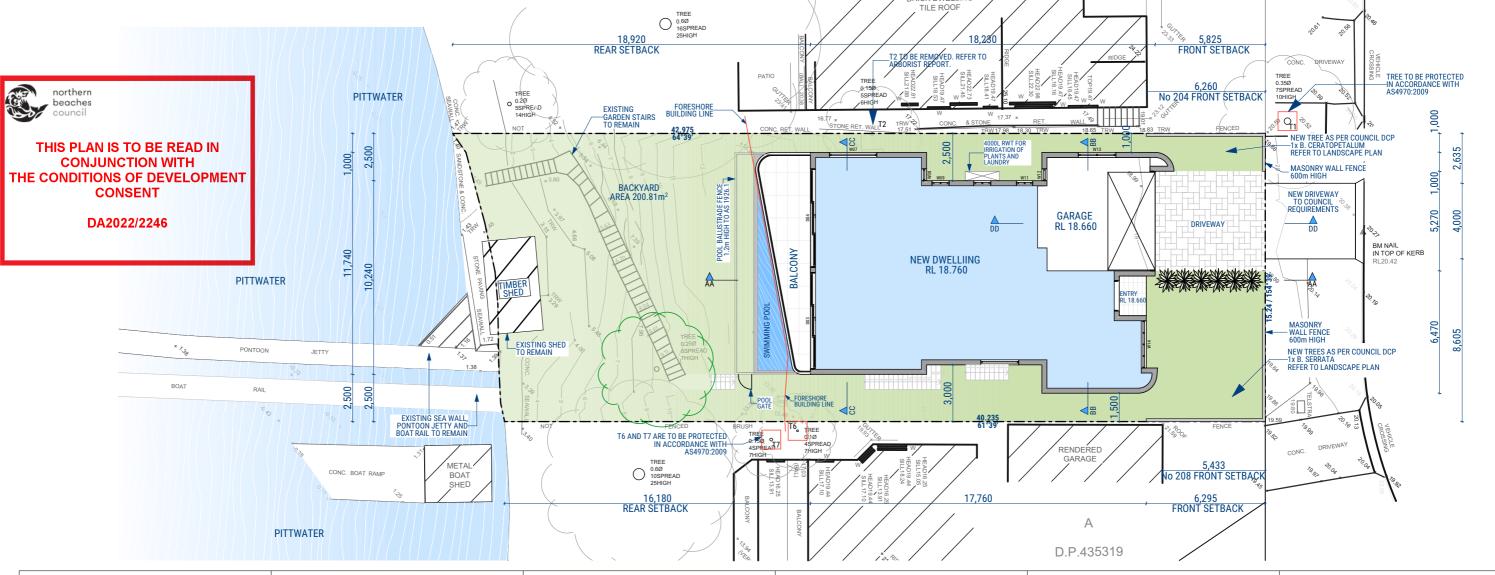

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NEW SINGLE DWELLING 2 STOREY HOUSE PPO IECT I OCATION

206 Hudson Parade CLAREVILLE NSW 2107 Australia LOT 38 DP 13760

22009

SITE PLAN DA 16

SCALE 1:200

DRAWING STATUS

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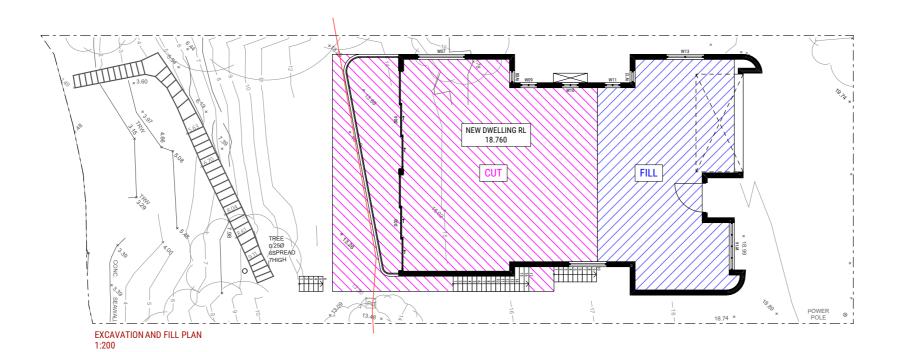
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THIS PLAN IS TO BE READ IN **CONJUNCTION WITH** THE CONDITIONS OF DEVELOPMENT CONSENT

DA2022/2246

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PROJECT	NUMBER

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EXCAVATION AND FILL PLAN DRAWING NUMBER ISSUE


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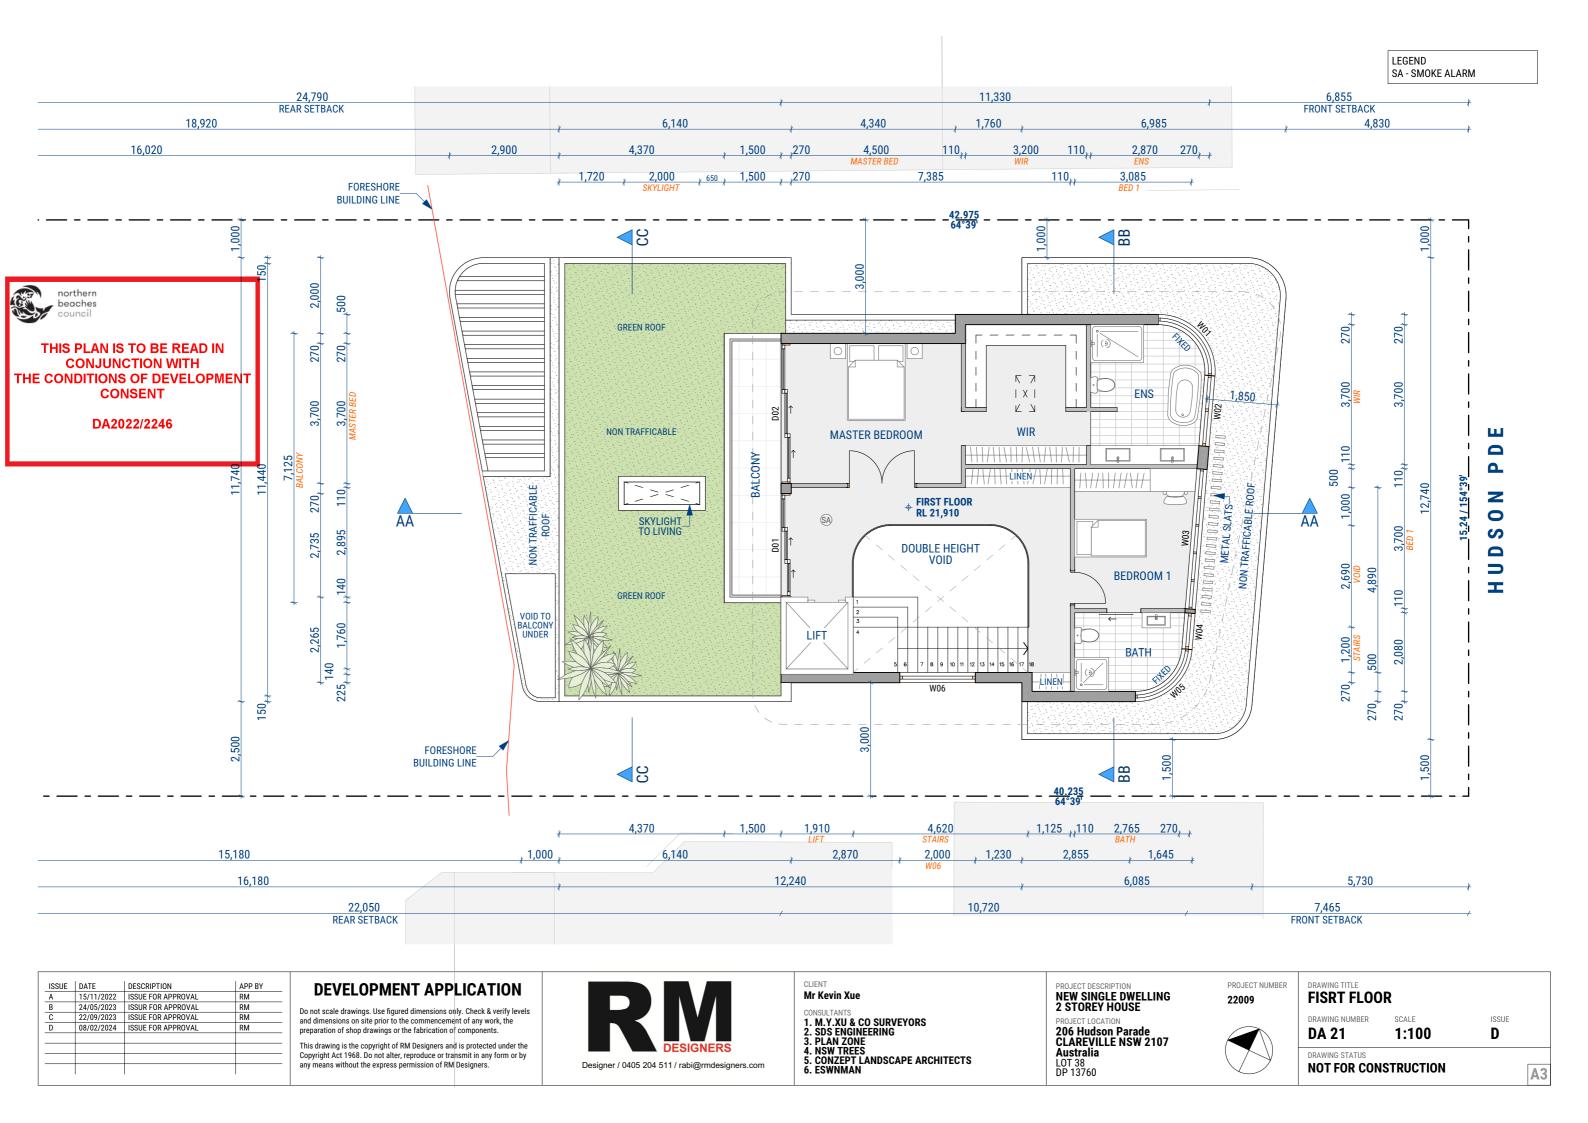
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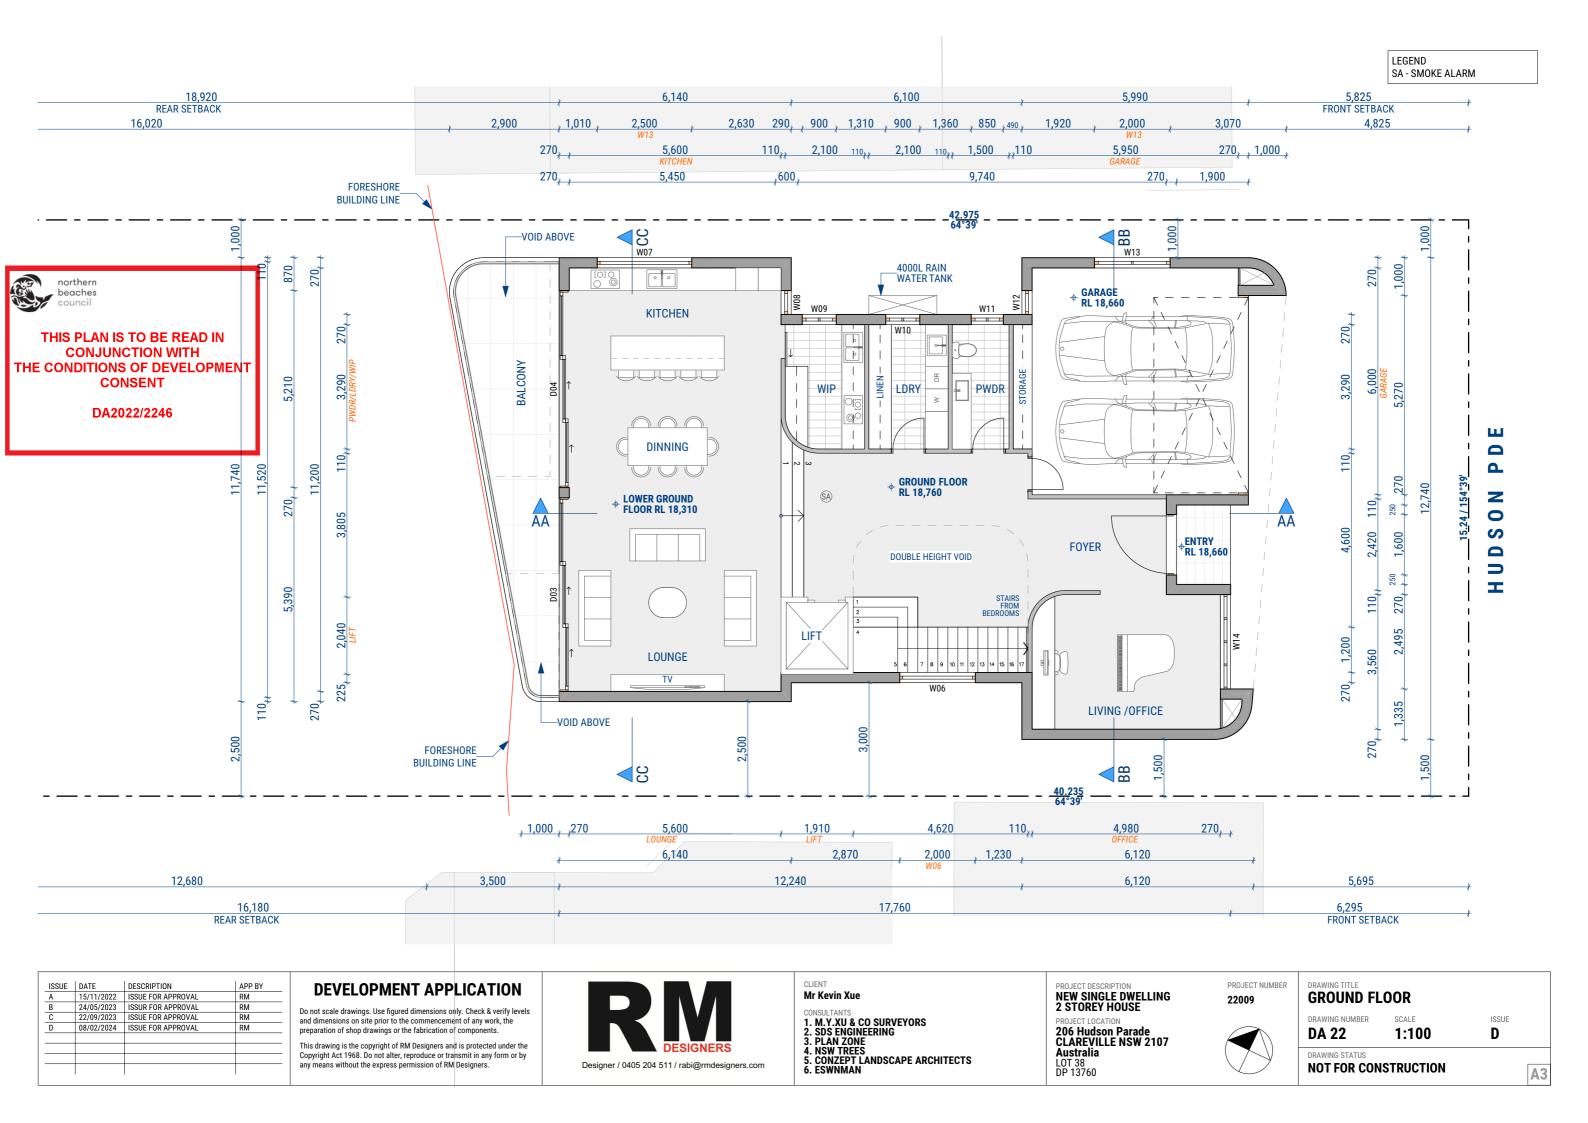
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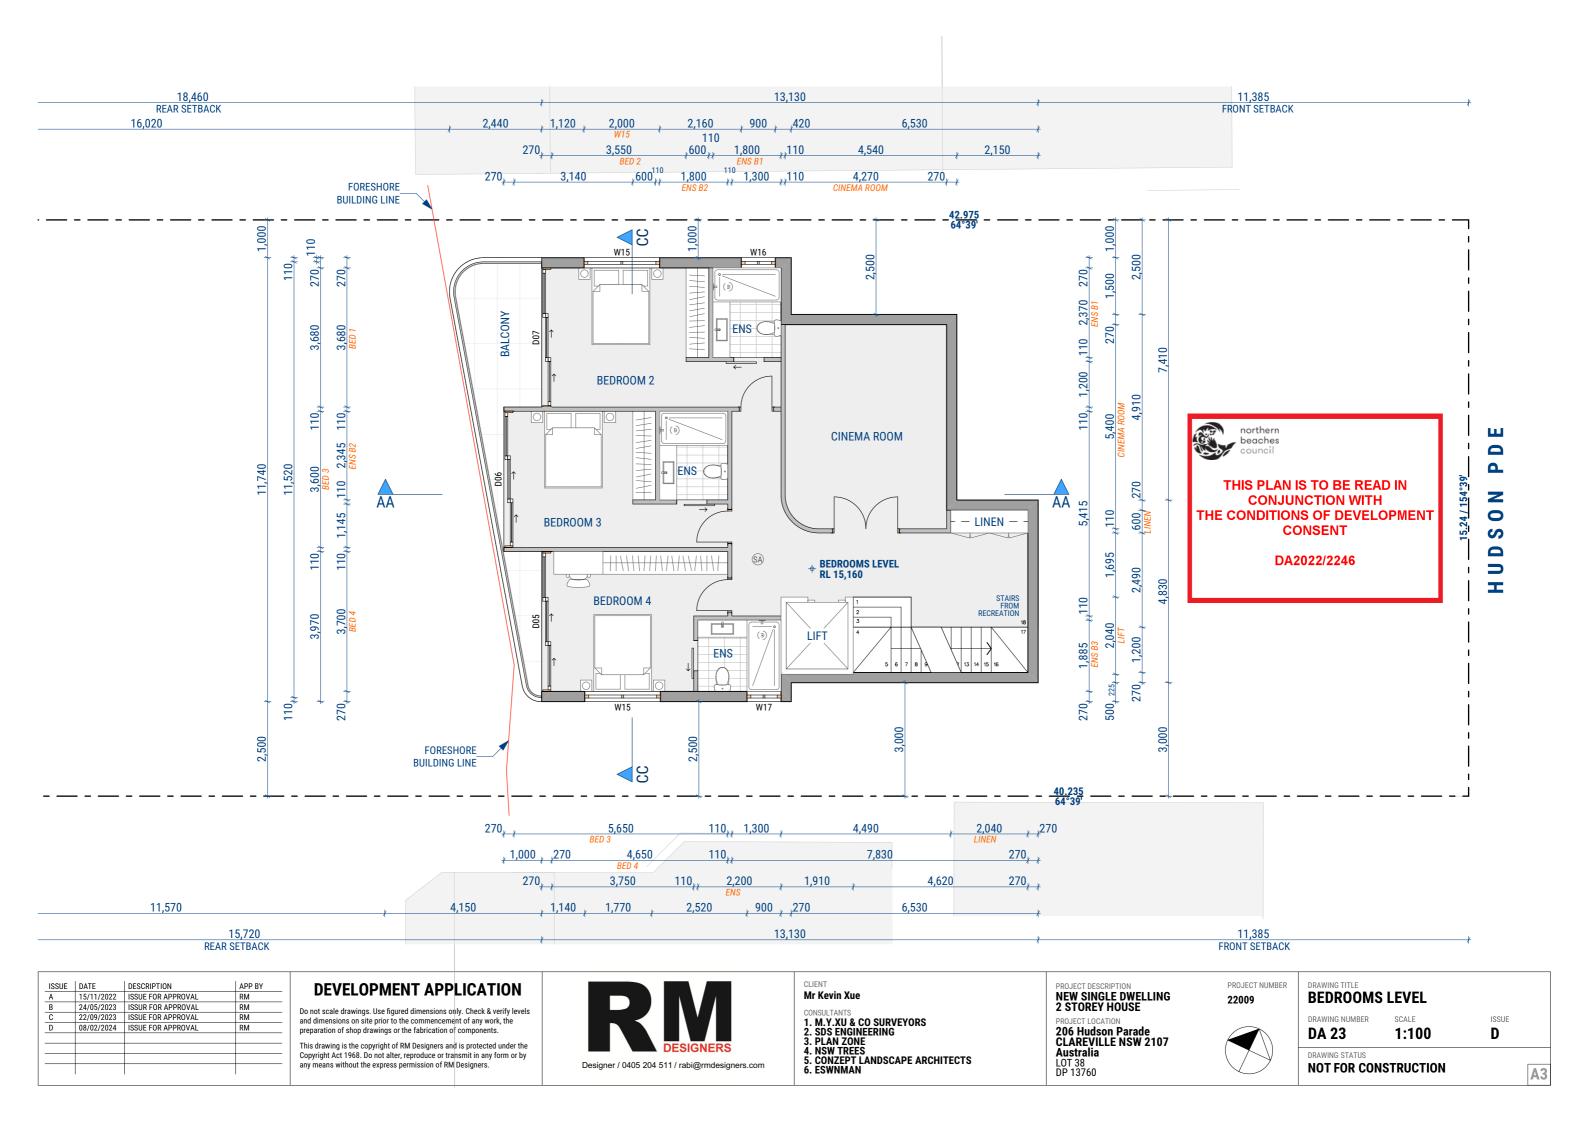
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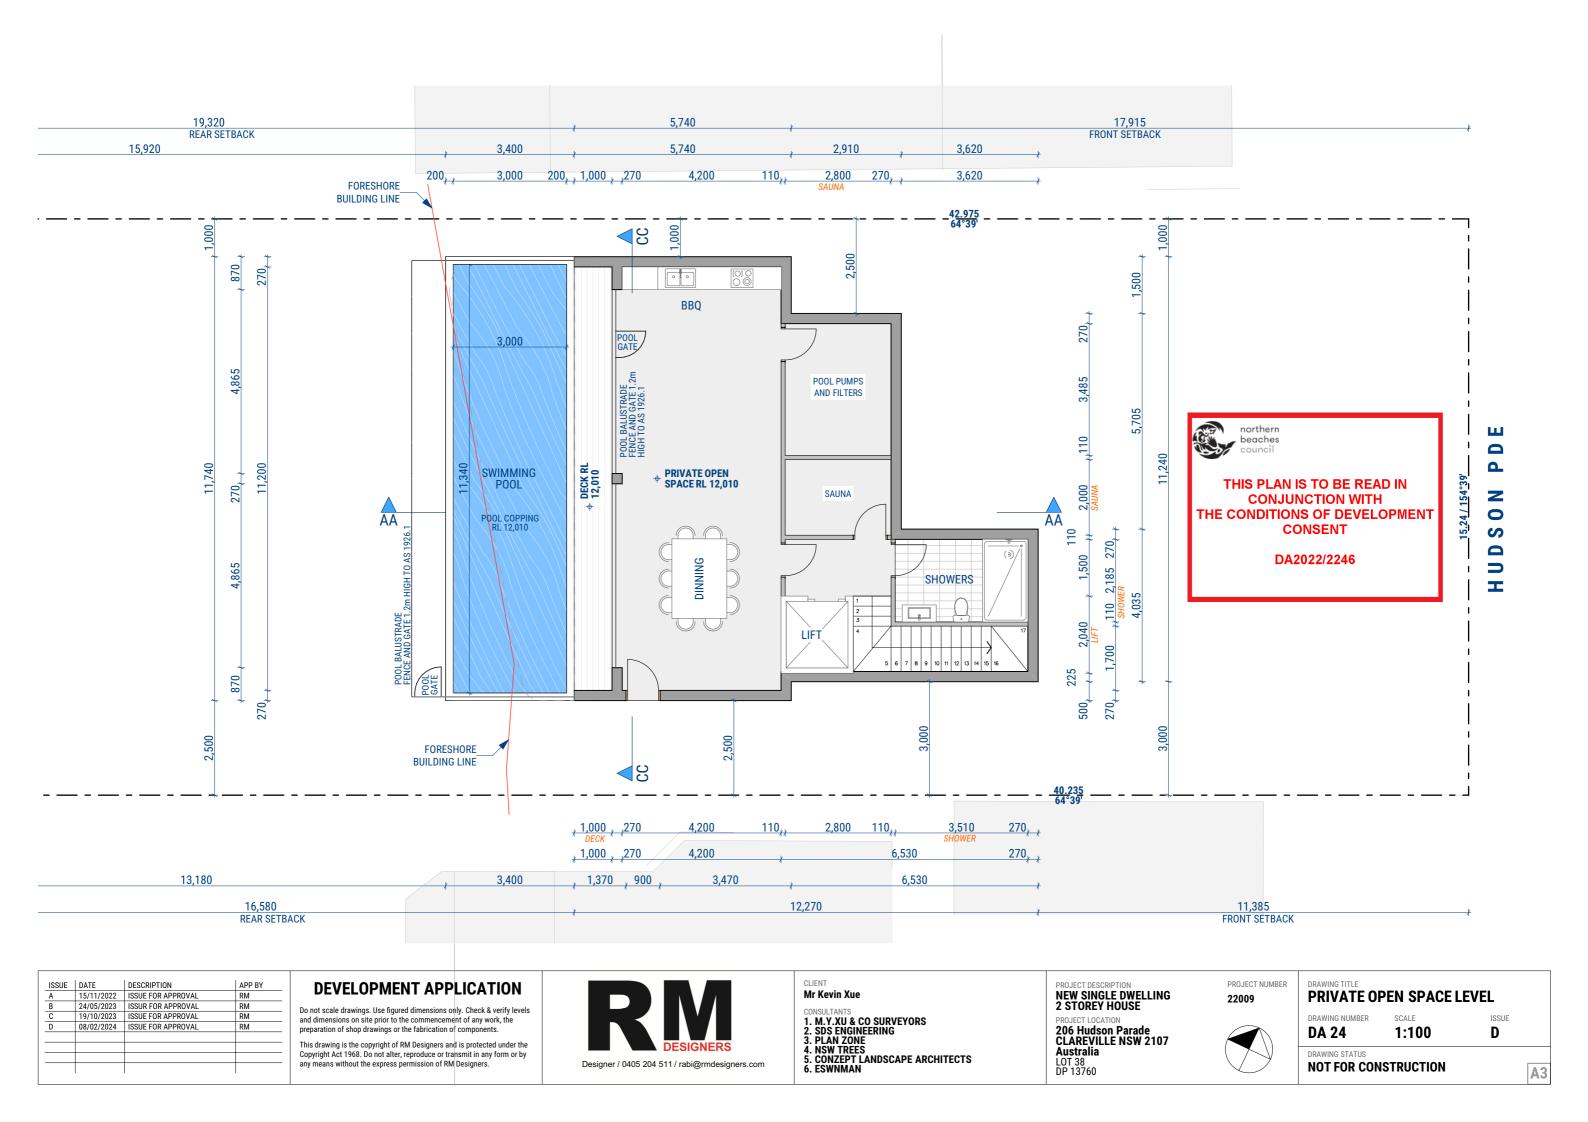
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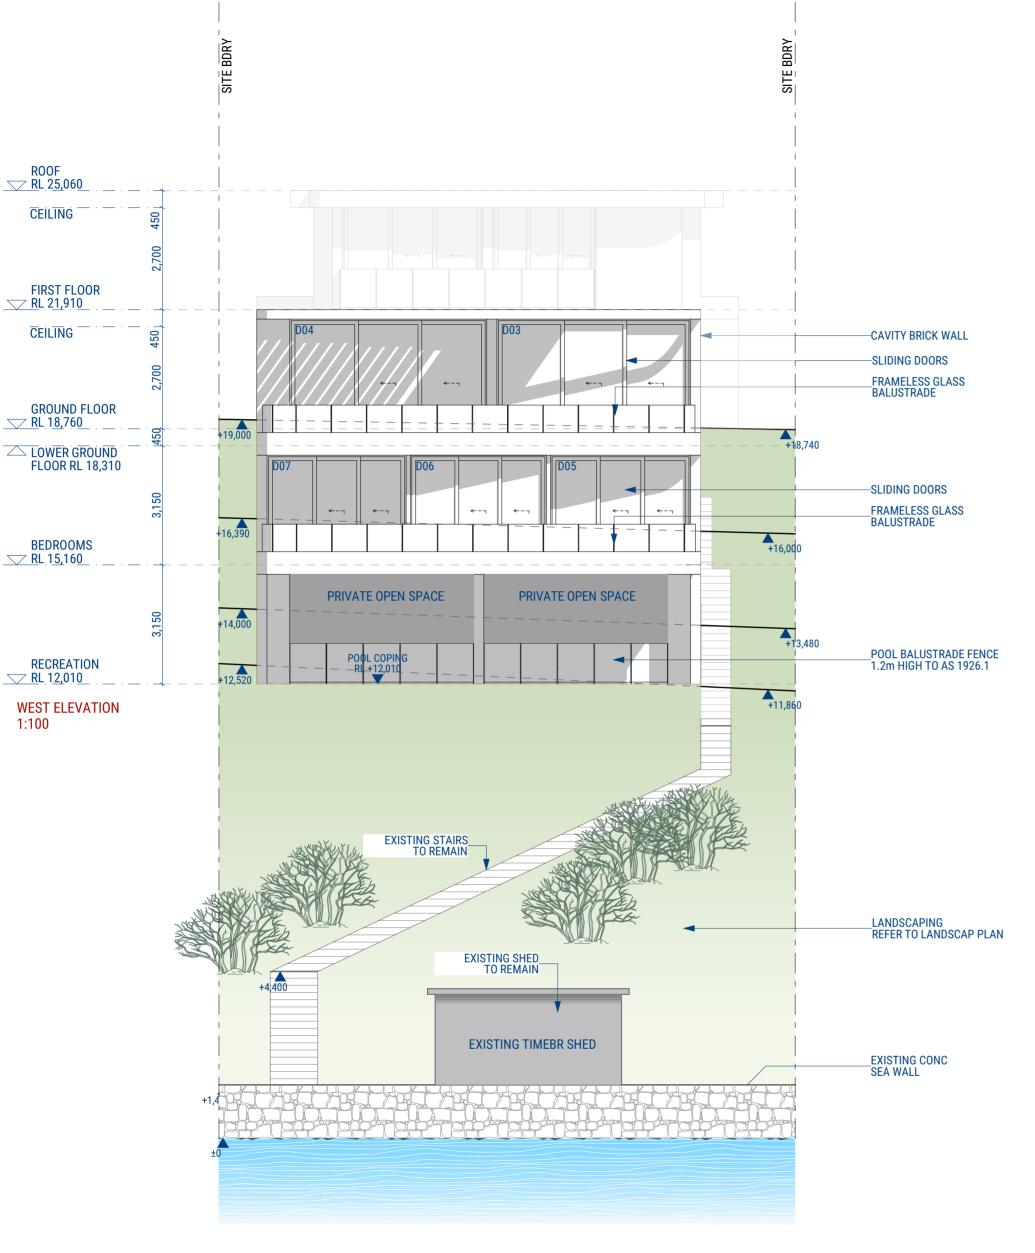











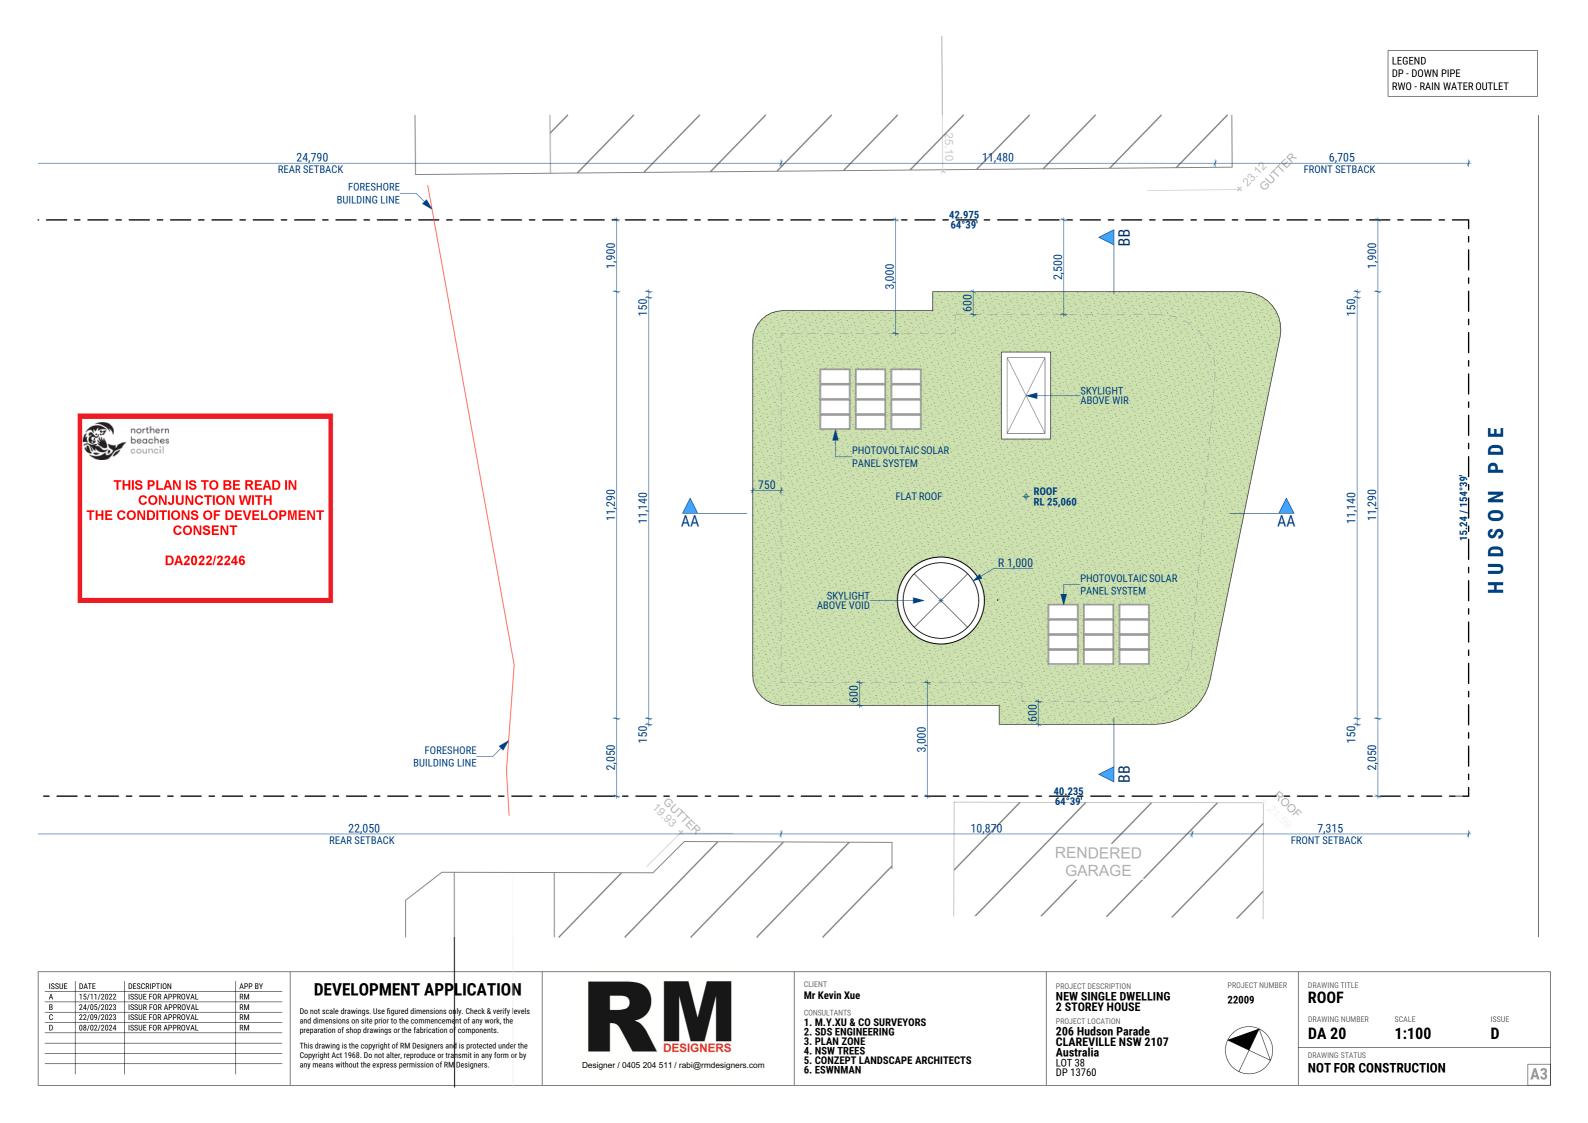

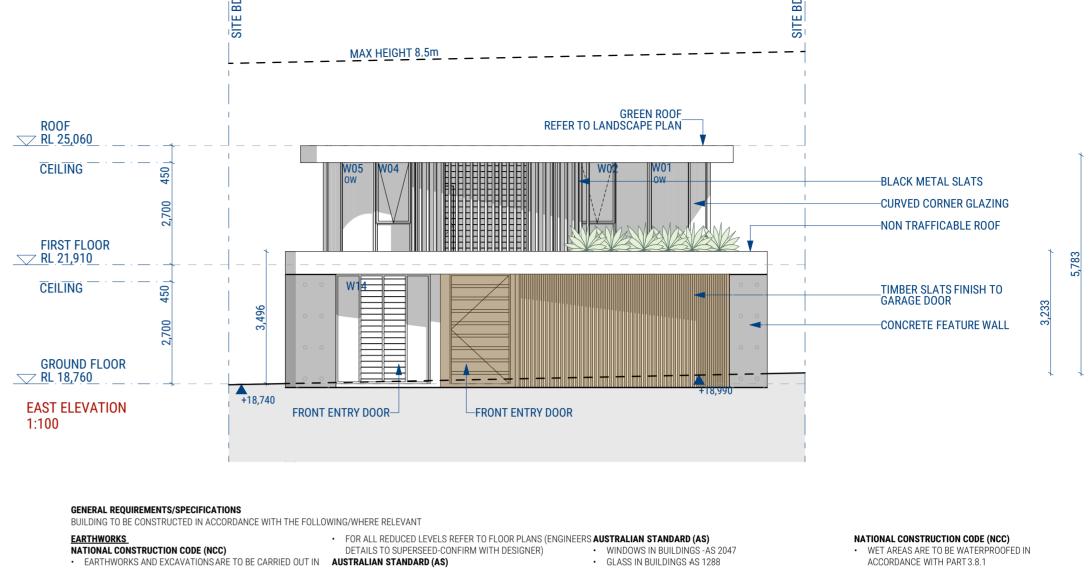

ACCORDANCE WITH THE REQUIREMENTS OF PART 3.1.1

STORM WATERPOWDER COATED ALUMINIUM GUTTERS & DOWNPIPES.

REFER TO STORMWATER PLAN FOR ALL SITE DRAINAGE

NATIONAL CONSTRUCTION CODE (NCC) DRAINAGE IS TO BE IN ACCORDANCE WITH PART 3.1.3

ROOF, WALL CLADDING, GUTTERS & DOWNPIPES ARE TO COMPLY WITH PART 3.5 AUSTRALIAN STANDARD (AS)

PLUMBING & DRAINAGE -AS 3500

TERMITE PROTECTION NATIONAL CONSTRUCTION CODE (NCC) PROTECTION MUST BE IN ACCORDANCE WITH PART 3.1.4

AUSTRALIAN STANDARD (AS)

TERMITE PROTECTION AS 3660.1

FOOTINGS

- PROPOSED FOOTINGS TO THE SPECIFICATIONS OF A QUALIFIED PRACTISING ENGINEER

NATIONAL CONSTRUCTION CODE (NCC) • FOOTINGS AND SLABS ARE TO BE DESIGNED AND

CONSTRUCTED IN ACCORDANCE WITH PART 3.2

AUSTRALIAN STANDARD (AS) RESIDENTIAL SLABS & FOOTINGSAS 2870

FLOORING
PROPOSED FLOOR CONSTRUCTION TO THE SPECIFICATIONS OF A QUALIFIED PRACTISING ENGINEER.

GLAZING
POWDER COATED ALUMINIUM FRAMED GLASS WINDOWS & DOORS UNLESS NOTED OTHERWISE.

ALL PORCHES, VERANDAHS & THE LIKE TO HAVE A 85mm STEPDOWN FROM INTERNAL AREAS UNLESS NOTED OTHERWISE.

NATIONAL CONSTRUCTION CODE (NCC) WET AREAS ARE TO BE WATERPROOFED IN

ACCORDANCE WITH PART 3.8.1 AREAS REQUIRING VENTILATION, WHICH ARE NOT. NATURALLY VENTILATED, ARE TO BE PROVIDED WITH MECHANICAL VENTILATION IN ACCORDANCE WITH PART 3.8.5

AUSTRALIAN STANDARD (AS)

- BUILDINGS -AS 3740
- ELECTRICAL & LIGHTINGAS/NZS 3000-2007 AND AS1680.0-2009
- · THE USE OF MECHANICAL VENTILATION AND AIR-CONDITIONING IN BUILDINGS AS 1668

SAFE MOVEMENT & ACCESS NATIONAL CONSTRUCTION CODE (NCC)

- STAIRS SHALL BE CONSTRUCTED SO AS TO COMPLY WITH
- PART 3.9.1 ALL BALUSTRADES TO BE A MINIMUM 1000mm ABOVE
- FINISHED FLOOR LEVEL AND RAILS TO BE SPACED SO AS TO PREVENT A 125mm SPHERE PENETRATING THROUGH AND TO COMPLY WITH PART 3.9.2

 RESIDENTIAL SLABS & FOOTINGSAS 2870 CONCRETE STRUCTURESAS 3600

- NATIONAL CONSTRUCTION CODE (NCC) ALL FRAMING IS TO BE IN ACCORDANCE WITH PART 3.4
- ALL MASONRY IS TO COMPLY WITH PART 3.3 SOUND INSULATION IS TO BE IN ACCORDANCE WITH PART

- AUSTRALIAN STANDARD (AS)
 MASONRY CONSTRUCTION AS3700
- RESIDENTIAL TIMBER FRAMED CONSTRUCTIONS 1684 • TIMBER STRUCTURESAS 1720
- DOMESTIC METAL FRAMING AS 3623

STRUCTURE
NATIONAL CONSTRUCTION CODE (NCC)

 STAIR CONSTRUCTION IS TO COMPLY WITH PART 3.9.1 · STRUCTURAL DESIGN TO BE IN ACCORDANCE WITH ACCEPTABLE CONSTRUCTION MANUALS AS LISTED IN PART

- AUSTRALIAN STANDARD (AS) SAA LOADING CODE -AS 1170
- DAMP PROOF COURSES AND FLASHINGSAS/NZS 2904 STEEL STRUCTURESAS 410
- ALUMINIUM STRUCTURES AS 1664

SAA MASONRY CODE -AS 3700

TO MEET BCA 3.9.2.6

ABOVE THE FLOOR LEVEL

AUSTRALIAN STANDARD (AS)

BALUSTRADES -AS 1170.1

CLEANED)

AS 1657

NATIONAL CONSTRUCTION CODE (NCC)

• ALL GLAZING IS TO BE IN ACCORDANCE WITH PART 3.6

IN EARLY CHILDHOOD CENTRES AND IN BEDROOMS OF

THE WINDOW IS TO BE FITTED WITH EITHER A DEVICE TO

THE DEVICE OR SCREEN TO BE REMOVED. UNLOCKED OR

SLIP RESISTANCE OF PEDESTRIAN SURFACESS/NZS 3661.2

FIXED PLATFORMS, WALKWAYS, STAIRWAYS AND LADDERS

OVERRIDDEN. (SO FOR EXAMPLE, THE WINDOW CAN BE

A 125mm SPHERE CANNOT PASS THROUGH.

RESIDENTIAL BUILDINGS, WHERE THE FLOOR BELOW THE

WINDOW IS MORE THAN 2m ABOVE THE SURFACE BENEATH

WINDOW BARRIERS ARE REQUIRED FOR OPENABLE WINDOWS EXTERNAL FINISHES

FINISHES FOR MORE DETAILS.

NATIONAL CONSTRUCTION CODE (NCC) ROOF, WALL CLADDING, GUTTERS & DOWNPIPES ARE TO COMPLY WITH PART 3.5

RESTRICT THE WINDOW OPENING, OR A SUITABLE SCREEN, SO AUSTRALIAN STANDARD (AS) GUIDE TO THE PAINTING OF BUILDINGSAS 2311

NATIONAL CONSTRUCTION CODE (NCC)

INSTALLATION OF ROOF TILESAS 2050

NATIONAL CONSTRUCTION CODE (NCC)

FIRE SAFETY IN ACCORDANCE WITH PART 3.7

INSTALLED IN ACCORDANCE WITH PART 3.7.5

WITH PART 3.5.1

AS 1562.1

AUSTRALIAN STANDARD (AS)

AUSTRALIAN STANDARD (AS)

• SMOKE ALARMS -AS 3786

ROOF CLADDING SHALL BE CARRIED OUT IN ACCORDANCE

DESIGN & INSTALLATION OF SHEET ROOF & WALL CLADDING -

• FIRE SEPARATION IS TO BE IN ACCORDANCE WITH PART 3.7.2

HARD WIRED PHOTO-ELECTRIC SMOKE ALARMS ARE TO BE

HEALTH & AMENITY

• ALL BATHROOM, ENSUITES AND LAUNDRIES TO HAVE FLOOR

WASTES AND BE SETDOWN AND WATERPROOFED.

RELEASE MECHANISM (E.G. A KEY LOCK) WHICH CAN ENABLE INTERNAL FINISHES

NATIONAL CONSTRUCTION CODE (NCC) HEATING APPLIANCES ARE TO BE INSTALLED IN ACCORDANCE

AUSTRALIAN STANDARD (AS)

CERAMIC TILES AS 3958

A BARRIER IS NOT REQUIRED FOR WINDOWS 1.7m OR MORE • INTERIOR LIGHTING AS 1680

LANDSCAPE

REFER TO LANDSCAPE PLAN FOR ALL PLANTING AND

OUTDOOR SURFACE TREATMENTS **BUSHFIRE**

THE RECOMMENDATIONS PROVIDED WITHIN THE BUSHFIRE ASSESSMENT REPORT ARE TO BE ADHERED TO. IN THE EVENT MINOR CHANGES TO BUILDING FORM AND THAT THERE ARE INCONSISTENCIES. THE BUSHFIRE REPORT RECOMMENDATIONS ARE TO TAKE PRECEDENCE

ACCORDANCE WITH PART 3.8.1

 AREAS REQUIRING VENTILATION, WHICH ARE NOT NATURALLY VENTILATED, ARE TO BE PROVIDED WITH MECHANICAL VENTILATION IN ACCORDANCE

WITH PART 3.8.5 AUSTRALIAN STANDARD (AS)

WATERPROOFING OF WET AREAS WITHIN RESIDENTIAL

- BUILDINGS -AS 3740
- ELECTRICAL & LIGHTINGAS/NZS 3000-2007 AND
- AS1680.0-2009
- THE USE OF MECHANICAL VENTILATION AND AIR-CONDITIONING IN BUILDINGS AS 1668

SAFE MOVEMENT & ACCESS NATIONAL CONSTRUCTION CODE (NCC)

STAIRS SHALL BE CONSTRUCTED SO AS TO COMPLY WITH

PART 3.9.1

ALL BALUSTRADES TO BE A MINIMUM 1000mm ABOVE FINISHED FLOOR LEVEL AND RAILS TO BE SPACED SO AS TO

PREVENT A 125mm SPHERE PENETRATING THROUGH AND TO COMPLY WITH PART 3.9.2

NATIONAL CONSTRUCTION CODE (NCC)

REFER TO SCHEDULE OF EXTERNAL MATERIALS, COLOURS AND BUSHFIRE AREAS ARE TO BE IN ACCORDANCE WITH PART

AUSTRALIAN STANDARD (AS)

 CONSTRUCTION OF BUILDINGS IN BUSH-FIRE PRONE AREAS -AS 3959

GENERAL TERMITE PROTECTION IS TO BE IN ACCORDANCE WITH PART 3.1.4

AUSTRALIAN STANDARD (AS)

ELECTRICAL SERVICESAS/NZS 3000 GAS INSTALLATIONS -AS 5601

OFF STREET CAR PARKINGAS 2890.1

PLIABLE BUILDING MEMBRANES & UNDERLAYSAS/NZS

THE DEVELOPMENT HAS BEEN DESIGNED TO BEST MEET THE GUIDELINES OF COUNCIL & THE NATIONAL

CONSTRUCTION CODE (ALL WORK ON SITE SHALL BE CARRIED OUT IN A SIMILAR MANNER TO ADHERE TO THE REQUIREMENTS OF COUNCIL

CONFIGURATION MAY BE REQUIRED WHEN DRAWINGS ARE SUBSEQUENTLY PREPARED FOR CONSTRUCTION PURPOSES AFTER THE GRANT OF DEVELOPMENT CONSENT



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NEW SINGLE DWELLING 2 STOREY HOUSE

206 Hudson Parade CLAREVILLE NSW 2107 Australia LOT 38 DP 13760


22009

PROJECT NUMBER **EAST AND WEST ELEVATION**

> **DA 30** 1:100 **NOT FOR CONSTRUCTION**

A2

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Α	15/11/2022	ISSUE FOR APPROVAL	RM
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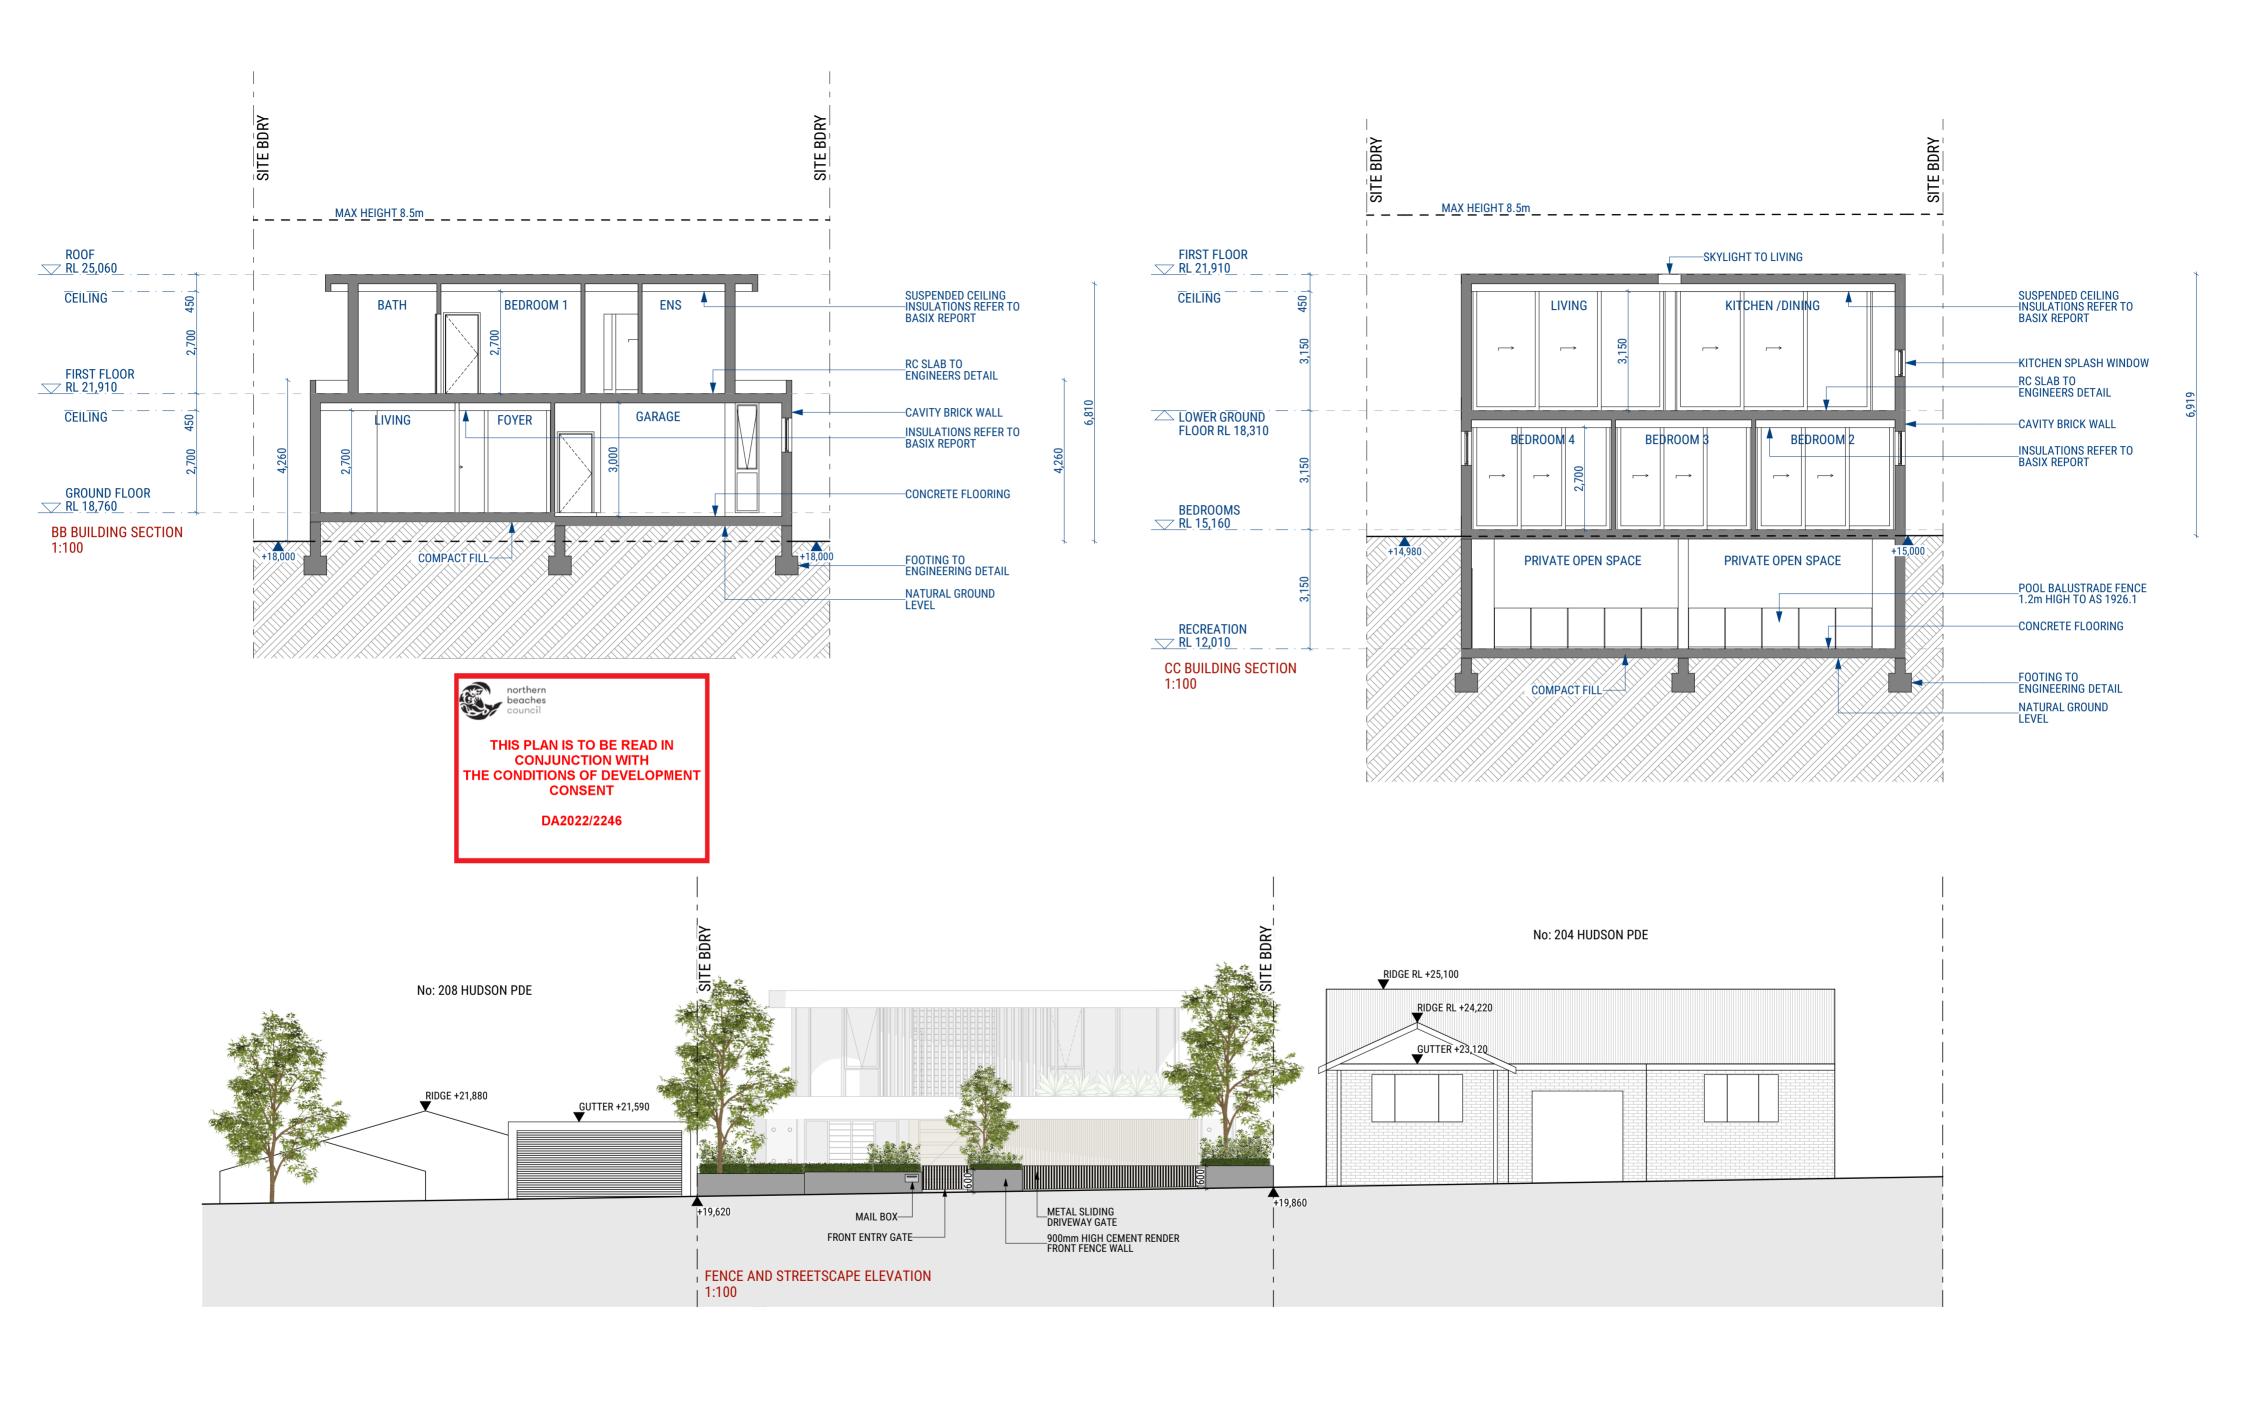
R	SIGNERS
Designer / 0405 204 511 /	rabi@rmdesigners.com
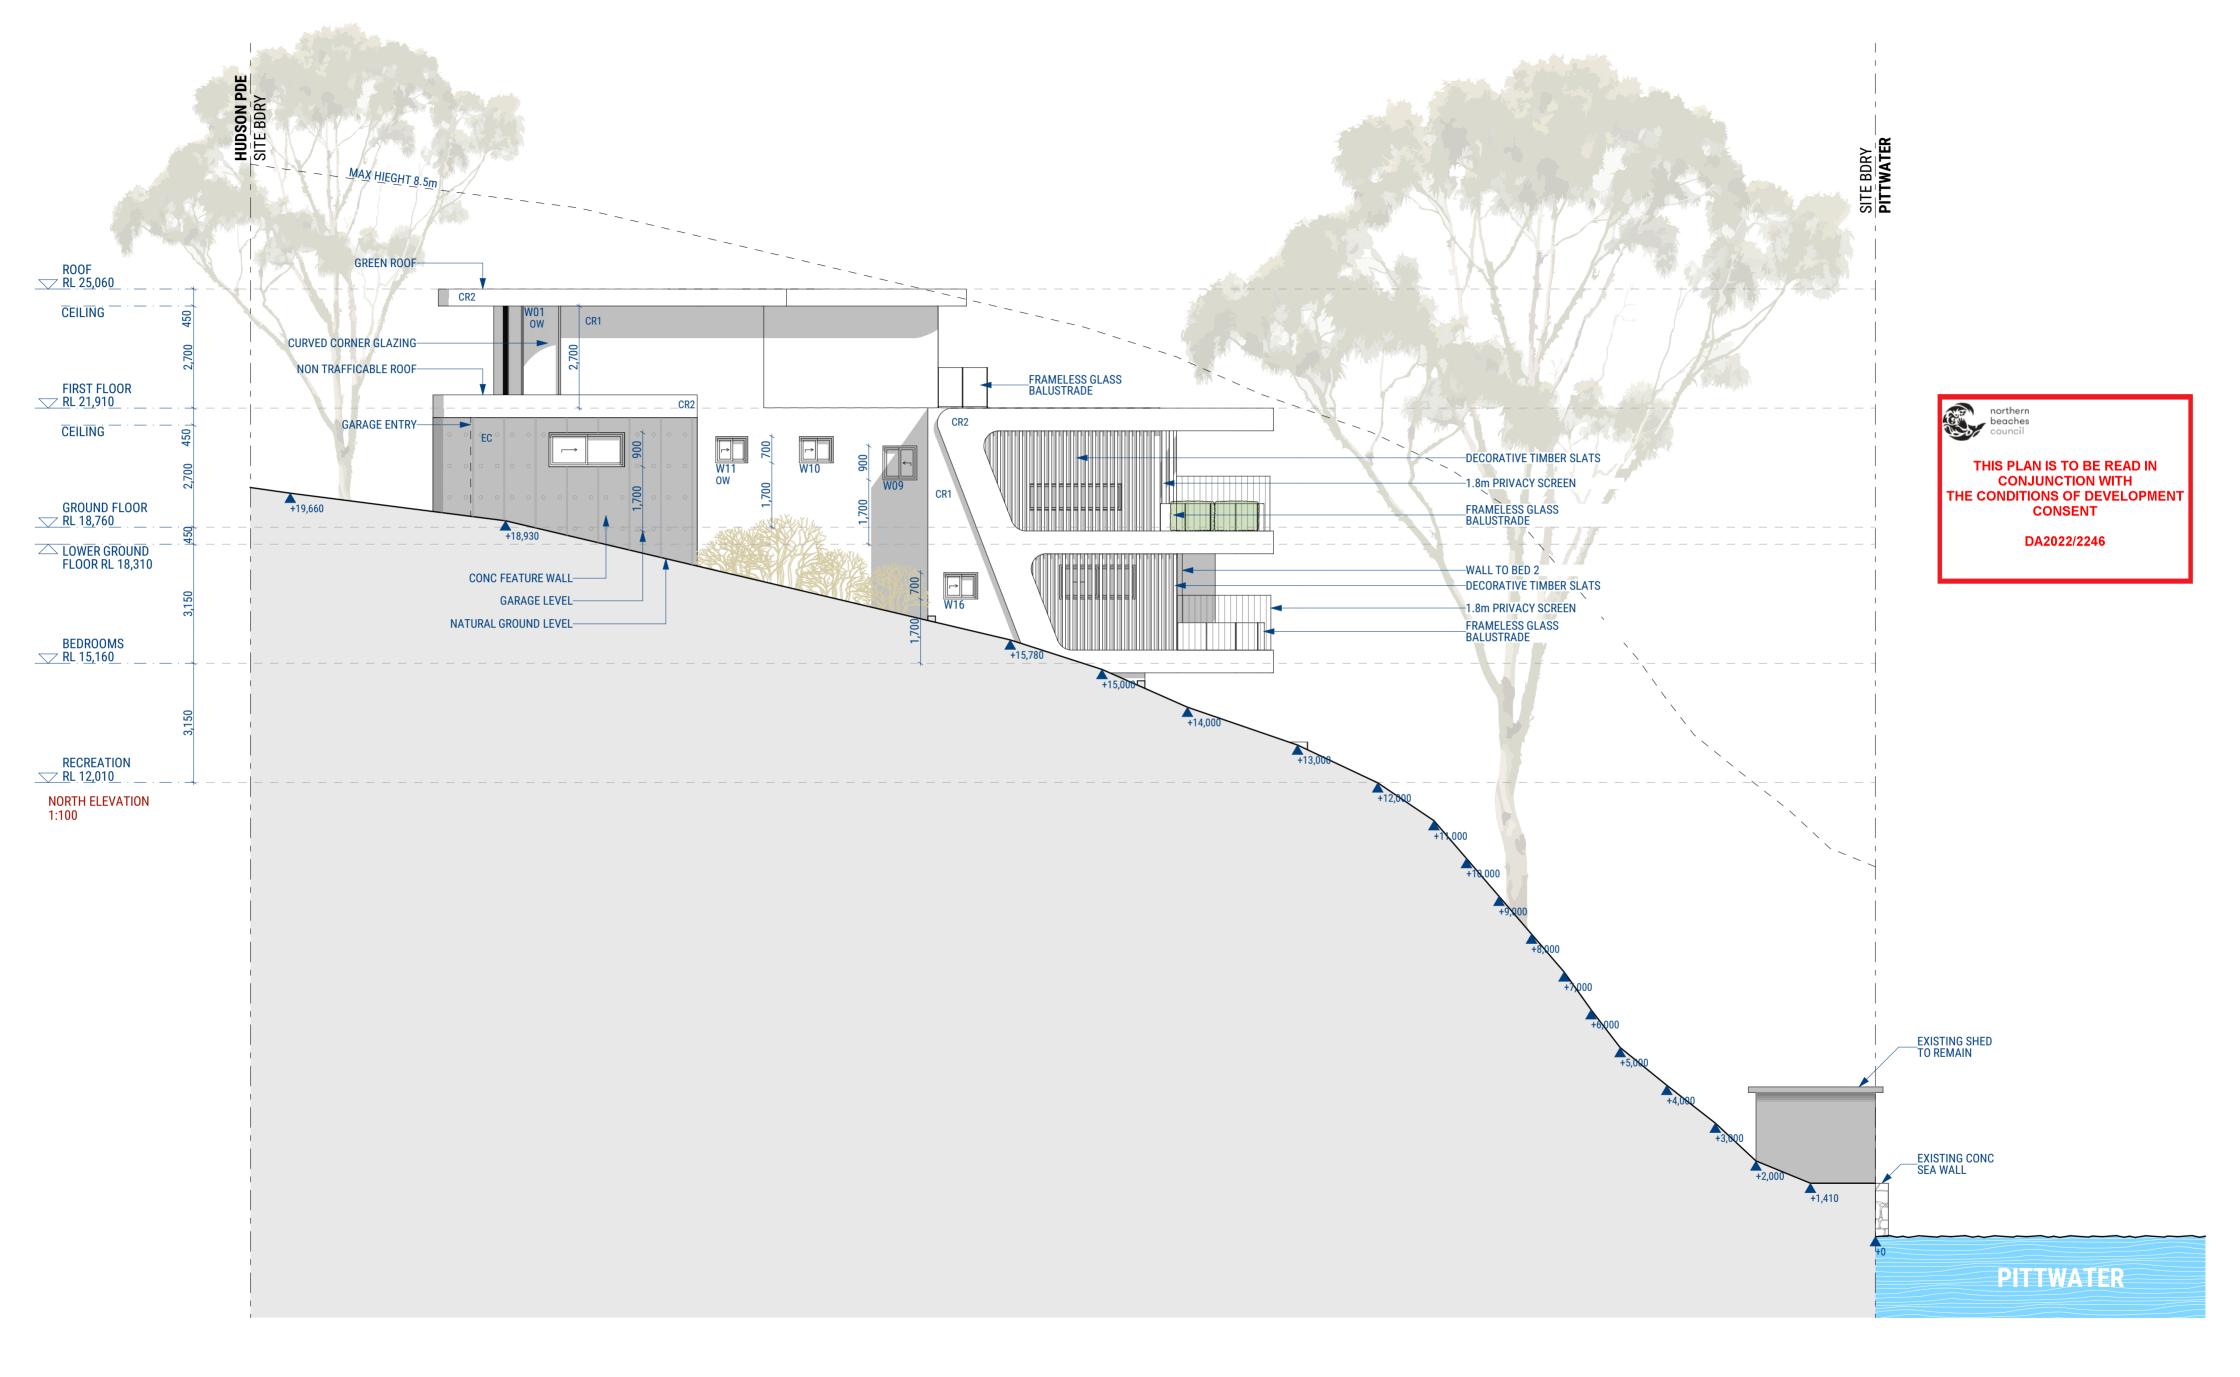
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5. CONZEPT LANDSCAPE ARCHITECTS 6. ESWNMAN

PROJECT DESCRIPTION NEW SINGLE DWELLING 2 STOREY HOUSE
PROJECT LOCATION 206 Hudson Parade CLAREVILLE NSW 2107 Australia LOT 38 DP 13760

PROJECT NUMBER	DRAWING TITLE
22009	NORTH EI
	DRAWING NUMBER

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Designer	/ 0405 204 51	I1 / rabi@r	mdesigners.com

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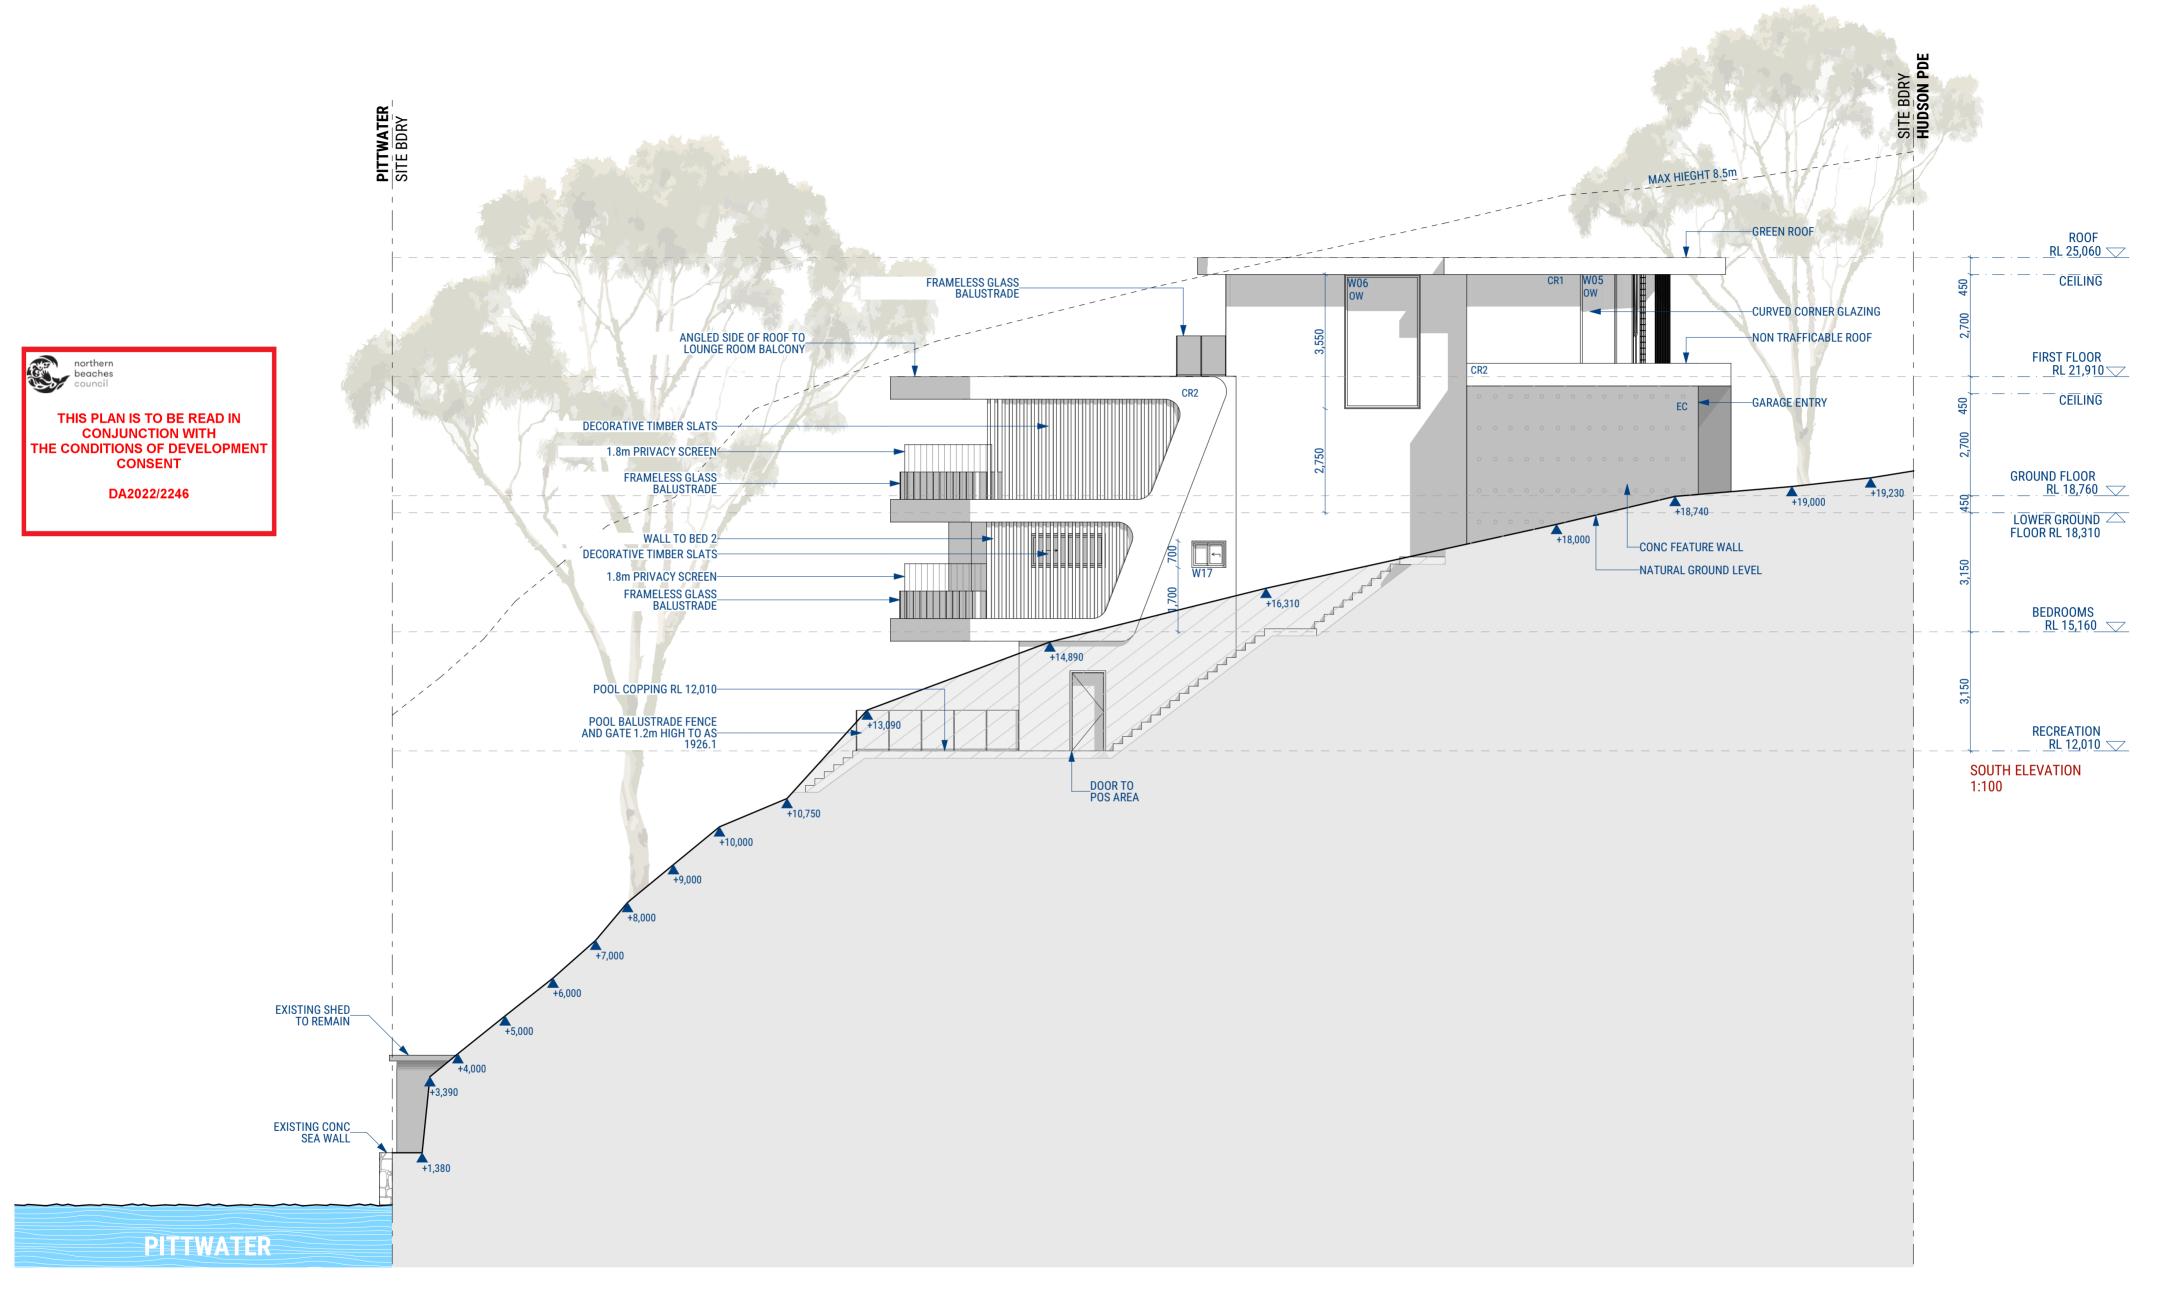
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PROJECT DESCRIPTION NEW SINGLE DWELLING 2 STOREY HOUSE	
PROJECT LOCATION 206 Hudson Parade CLAREVILLE NSW 2107 Australia LOT 38 DP 13760	

PROJECT NUMBER 22009	FENCE + ST BB AND CC		ELEVATION +
	DRAWING NUMBER	SCALE	ISSUE
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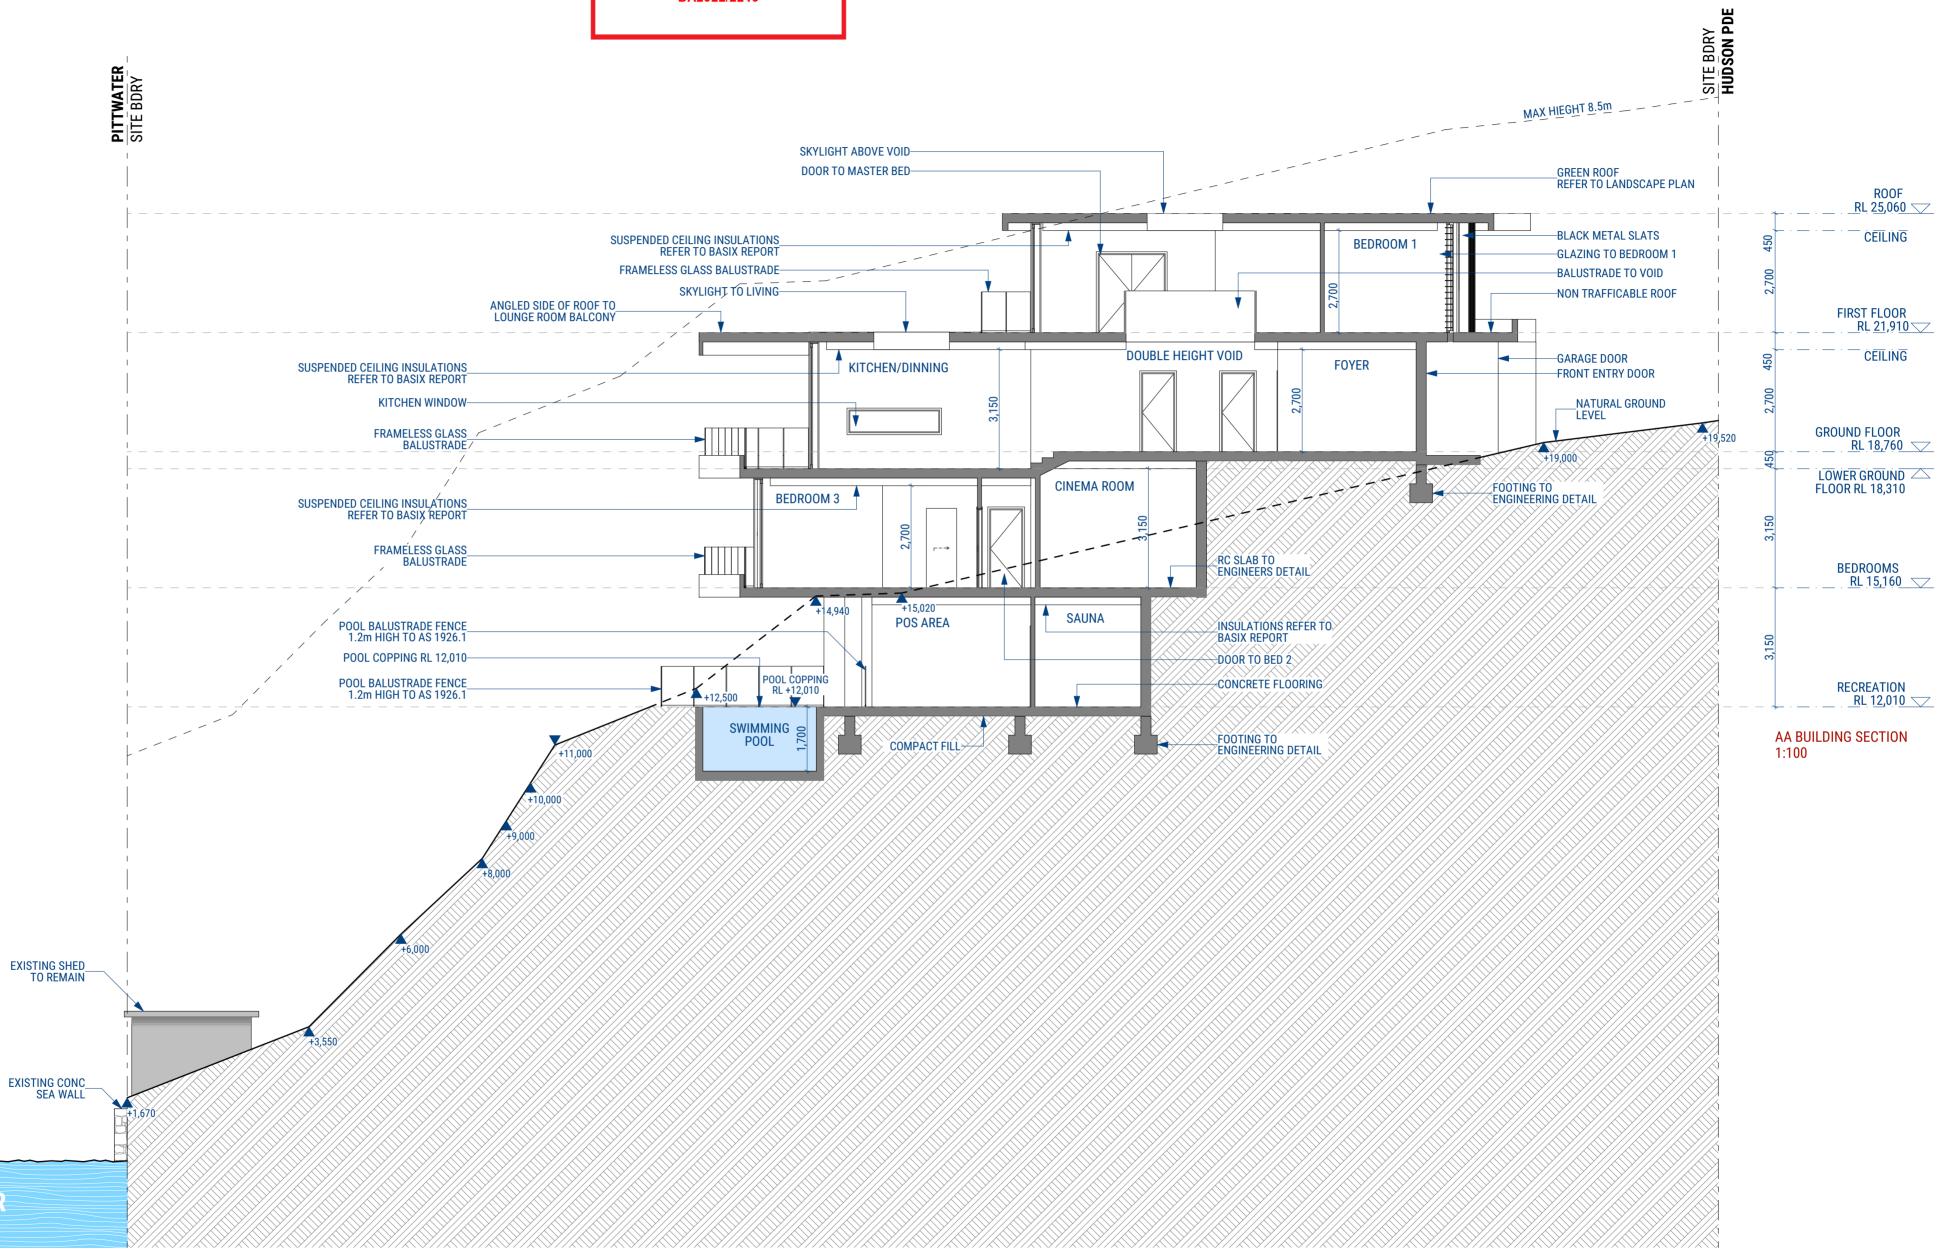
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PITTWATER

DEVELOPMENT APPLICATION

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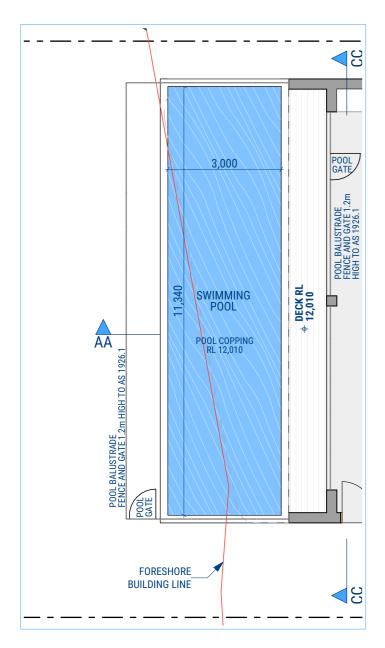
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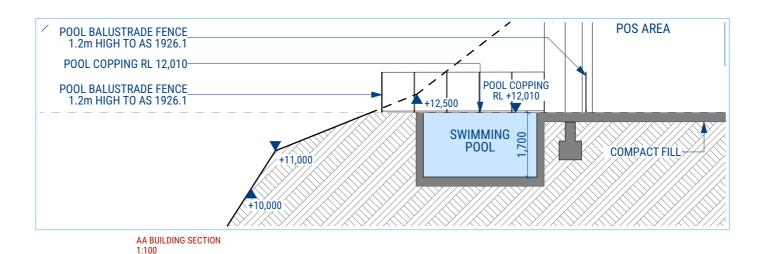
PROJECT DESCRIPTION NEW SINGLE DWELLING 2 STOREY HOUSE
PROJECT LOCATION
206 Hudson Parade
CLAREVILLE NSW 2107
Australia
LOT 38
DP 13760

PROJECT NUMBER 22009

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	DA 34	1:100	ISSUE E	
2	SECTION A	A		



POOL PLAN 1:100



SWIMMING POOL REQUIREMENTS

GENERAL REQUIREMENTS

- · ALL POOLS MUST BE SEPARATED FROM RESIDENTIAL BUILDINGS AND ADJOINING PUBLIC OR PRIVATE PROPERTIES BY A COMPLYING CHILD -RESISTANT BARRIER (MUST BE IN ACCORDANCE WITH THE REGULATIONS AND AS 1926.1-2012 SWIMMING POOL SAFETY).
- NO DOOR ACCESS FROM A RESIDENTIAL BUILDING INTO AN OUTDOOR POOL IS PERMITTED
- · ONLY STRUCTURES ASSOCIATED WITH THE POOL (FILTER HOUSING, ETC.) ARE PERMITTED WITHIN THE ENCLOSED POOL AREA
- STRUCTURES SUCH AS CLOTHES LINES , BARBEQUE , SHEDS , ENTERTAINMENT STRUCTURE, OUTSIDE TOILETS, ETC, MUST ALL BE LOCATED OUTSIDE THE CHILD RESISTANT BARRIER POOL FENCING
- SWIMMING POOL FENCING AND OTHER BARRIERS TO BE PROVIDED TO THE POOL AREA IN ACCORDANCE WITH THE SWIMMING POOLS ACT 1992.
- BOUNDARY FENCE TO BE 1.8m IN HEIGHT , MEASURED FROM INSIDE OF THE FENCING • SWIMMING POOL FENCING TO BE AT LEAST 1.2m HIGH, MEASURED ON THE OUTSIDE
- · MINIMUM 900mm SEPARATION BETWEEN THE UPPER AND LOWER HORIZONTAL MEMBERS TO MAINTAIN NON -CLIMBABLE ZONE
- HORIZONTAL MEMBERS OF THE FENCE SHOULD BE PLACED ON THE INSIDE OF THE FENCE AND BE AT LEAST 900 mm APART.

- THE LATCHING DEVICE TO THE POOL GATE IS TO BE LOCATED A MINIMUM 1.5m ABOVE GROUND LEVEL AND 1.4m FROM THE HIGHEST LOWER HORIZONTAL BARRIER MEMBER OR , ALTERNATIVELY , THE DEVICE IS TO BE LOCATED INSIDE THE GATE AND THE LATCHING DEVICE IS TO BE APPROPRIATELY SHIELDED FROM THE OUTSIDE IN ACCORDANCE WITH AS 1926.1-2012 (EXCLUDING CLAUSE 2.8 OF THE STANDARD) TO ENSURE THE LATCHING DEVICE IS ONLY ACCESSIBLE BY REACHING OVER THE GATE
- GATE WIDTH IS TO BE KEPT TO A MINIMUM (NO MORE THAN 1 METRE) TO MINIMISE THE POSSIBILITY OF THE WEIGHT OF THE GATE CAUSING THE GATE TO DROP WITH THE SELF -LATCHING MECHANISM FAILING SPA POOLS
- · SPA POOLS ARE ALSO COVERED BY THE LEGISLATION AND SHOULD BE SEPARATED BY A CHILD -RESISTANT POOL SAFETY BARRIER IN ACCORDANCE WITH AUSTRALIAN STANDARD AS 1926.1-2012.
- ALTERNATIVELY , THE SPA POOL MUST BE COVERED AND SECURED BY A LOCKABLE CHILD -SAFE STRUCTURE (SUCH AS A DOOR, LID, GRILLE OR MESH). SUCH LOCKABLE STRUCTURE MUST BE ABLE TO BE REMOVED /INSTALLED AND LOCKED BY A SINGLE PERSON RESUSCITATION WARNING SIGN
- AN APPROPRIATE RESUSCITATION WARNING SIGN (AVAILABLE FROM COUNCIL OR THE ROYAL LIFE SAVING SOCIETY) IS DISPLAYED IN A PROMINANT POSITION IN THE IMMEDIATE VICINITY OF THE POOL AREA
- THE SPACING OF VERTICAL MEMBERS OF THE FENCE SHALL NOT EXCEED 100mm
- THE HEIGHT OF ANY OPENING BETWEEN THE BOTTOM OF THE FENCE AND FINISHED GROUND LEVEL SHALL NOT EXCEED 100 mm
- ALL SWIMMING POOL FENCING TO BE MAINTAINED IN A GOOD CONDITION (ie. WITH NO HOLES, BROKEN OR LOOSE PALINGS).
- NON-CLIMBABLE ZONE EXTENDS FROM THE POOL FENCE 300mm INTO THE POOL AREA AND 900mm OUTSIDE THE POOL AREA . TO PREVENT A CHILD TO CLIMB OVER THE FENCE, CLIMBABLE OBJECTS SUCH AS BARBEQUES, FURNITURE, PLANTER BOXES, TREES OR SHRUB ARE NOT PERMITTED WITHIN THIS NON
- IF THE WALL OF THE HOUSE FORMS PART OF THE APPROVED CHILD -RESISTANT BARRIER TO THE POOL AREA (ie. IN RELATION TO POOLS INSTALLED BEFORE 1 AUGUST 1990), ALL DOOR AND WINDOW OPENINGS IN THE WALL /S MUST BE CHILD-RESISTANT IN ACCORDANCE WITH THE REGULATIONS TO PREVENT CHILDREN ACCESSING THE POOL AREA
- GATES TO THE SWIMMING POOL AREA ARE TO OPEN OUTWARDS AND ARE TO BE FULLY SELF -CLOSING AND SELF -LATCHING FROM ANY OPEN POSITION.
- NO DOUBLE GATES ARE PERMITTED GATES ARE NOT TO BE PROPPED OPEN AT ANY TIME

• THE FOLLOWING WARNING STATEMENTS MUST BE CONTAINED WITHIN THE RESUSCITATION SIGN

THIS PLAN IS TO BE READ IN

CONJUNCTION WITH THE CONDITIONS OF DEVELOPMENT

CONSENT

DA2022/2246

- YOUNG CHILDREN SHOULD BE SUPERVISED WHEN USING
- THIS SWIMMING POOL
- POOL GATES MUST BE KEPT CLOSED AT ALL TIMES

northern beaches

- KEEP ARTICLES, OBJECTS AND STRUCTURES AT LEAST 900 MM CLEAR OF THE POOL FENCE AT ALL TIMES
- THE RESUSCITATION SIGN MUST BE
- LEGIBLE FROM A DISTANCE OF AT LEAST THREE METRES
- MAINTAINED IN A CLEARLY LEGIBLE CONDITION REFER TO THE SWIMMING POOLS ACT 1992. THE SWIMMING POOLS REGULATION 2018 AND AUSTRALIAN STANDARD AS 1926.1-2012 (EXCLUDING CLAUSE 2.8 OF THE STANDARD) FOR A

COMPLETE LIST OF REQUIREMENTS

ISSUE	DATE	DESCRIPTION	APP BY
A	15/11/2022	ISSUE FOR APPROVAL	RM
В	24/05/2023	ISSUR FOR APPROVAL	RM
С	19/10/2023	ISSUE FOR APPROVAL	RM
D	08/02/2024	ISSUE FOR APPROVAL	RM

DEVELOPMENT APPLICATION

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4. NSW TREES
5. CONZEPT LANDSCAPE ARCHITECTS 6. ESWNMAN

NEW SINGLE DWELLING 2 STOREY HOUSE PPO IECT I OCATION

206 Hudson Parade CLAREVILLE NSW 2107 Australia LOT 38 DP 13760


POOL PLAN AND SECTION

DRAWING NUMBER

ISSUE 1:100 D DA 35

DRAWING STATUS **NOT FOR CONSTRUCTION**



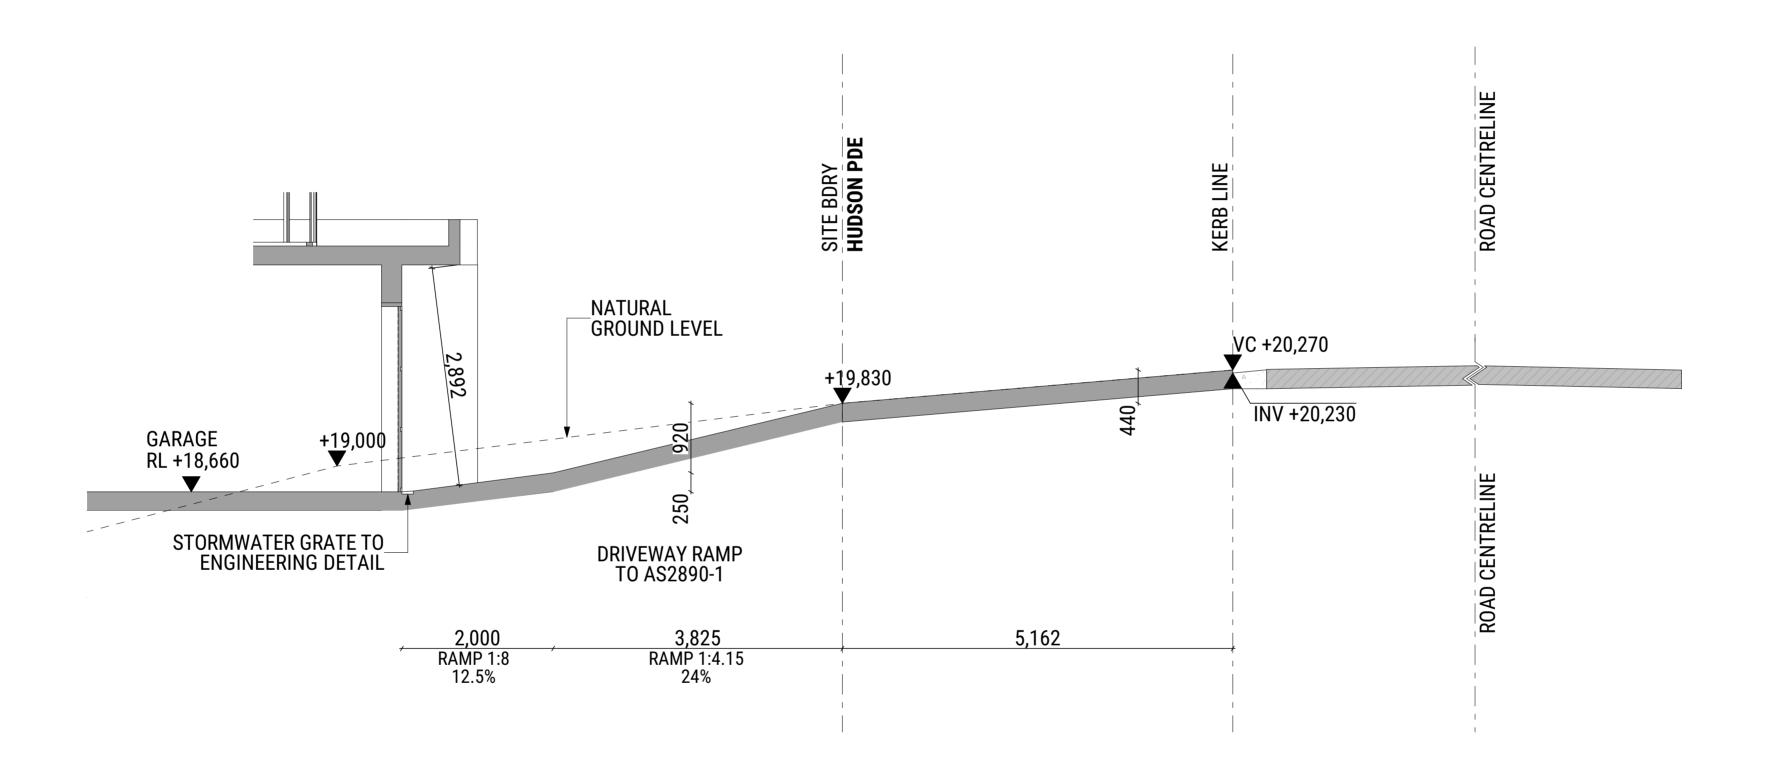

ISSUE	DATE	DESCRIPTION	APP BY
Α	15/11/2022	ISSUE FOR APPROVAL	RM



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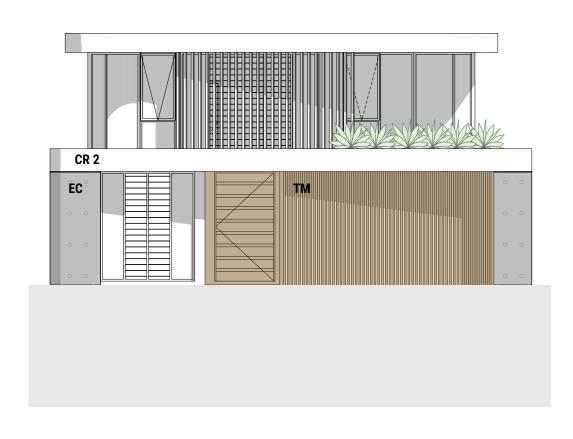



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NEW	ET DESCRIPTION SINGLE DWELLING DREY HOUSE	
PROJE	CT LOCATION	
	Hudson Parade REVILLE NSW 2107	

22009	DRAWING NUMBER DA 36	SCALE 1:50
PROJECT NUMBER	DD RAMP S	SECTION

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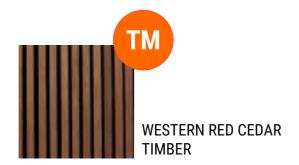




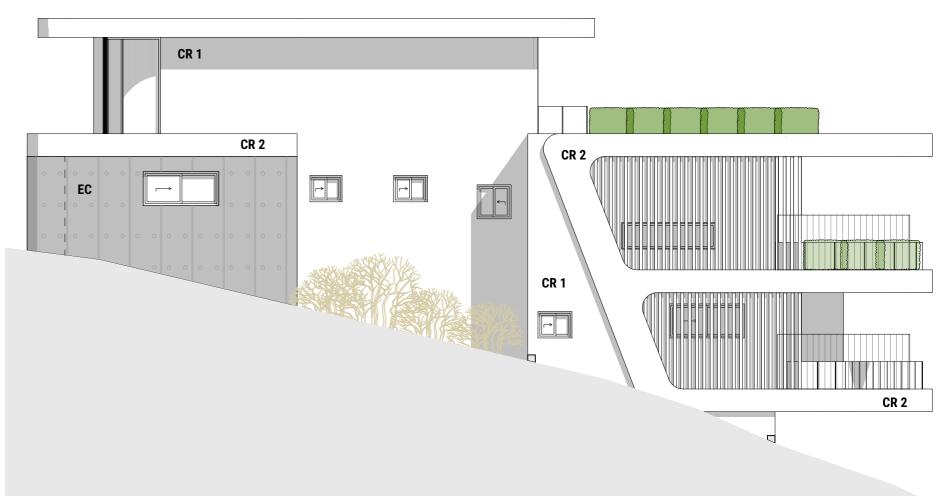

CR2

CEMENT RENDER
DULUX
SILVER TEA SET





DULUX_POWDER COATING ZEUS BLACK MATT TO WINDOW FRAMES AND METAL SLATS



DATE	DESCRIPTION	APP BY
15/11/2022	ISSUE FOR APPROVAL	RM

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ı	CLIENT
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CLAREVILLE NSW 2107
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LOT 38
DP 13760

PROJECT NUMBER
22009

DRAWING TITLE
FINISHES SCHEDULE

DRAWING NUMBER SCALE ISSUE
DA 40

DRAWING STATUS

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