

# **ACTION PLANS**

# 22 ALKIRA CIRCUIT, NARRAWEENA NSW 2099

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# DEVELOPMENT APPLICATION: REV A

SHEET NUMBER	SHEET NAME	DATE PUBLISHED
DA00	COVER	23/05/2022
DA01	NOTATION	23/05/2022
DA02	SAFETY NOTES	23/05/2022
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DA04	SITE / ROOF / SEDIMENT EROSION / WASTE MANAGEMENT / STORMWATER CONCEPT PLAN	23/05/2022
DA05	EXISTING LOWER GROUND FLOOR PLAN	23/05/2022
DA06	EXISTING GROUND FLOOR PLAN	23/05/2022
DA07	PROPOSED LOWER GROUND FLOOR PLAN	23/05/2022
DA08	PROPOSED GROUND FLOOR PLAN	23/05/2022
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DA10	NORTH ELEVATION	23/05/2022
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DA13	WEST ELEVATION	23/05/2022
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DA17	WINTER SOLSTICE 0900	23/05/2022
DA18	WINTER SOLSTICE 1200	23/05/2022
DA19	WINTER SOLSTICE 1500	23/05/2022
DA20	BASIX COMMITMENTS	23/05/2022

ITEM DETAILS	DEVELOPMENT APPLICATION					
ADDRESS	22 ALKIRA CIRCUIT, NARRAWEENA 2099					
LOT & DP/SP	LOT 37 DP 226052					
COUNCIL	NORTHERN BEACHS COUNCIL (WAR	RINGAH)				
SITE AREA	557.3m²					
FRONTAGE	15.24m					
CONTROLS	PERMISSIBLE / REQUIRED	EXISTING	PROPOSED	COMPLIANCE		
CONTROLS	m / m² / %	m / m <sup>2</sup> / %	m / m² / %			
<u>LEP</u>						
LAND ZONING	R2 – LOW DENSITY RESIDENTIAL	R2	R2	YES		
MINIMUM LOT SIZE	600m²	557.3m <sup>2</sup>	UNCHANGED	N/A		
MAXIMUM BUILDING HEIGHT	8.5m	6.696m	8.900m	NO		
HAZARDS						
DEVELOPMENT ON SLOPING LAND	LANDSLIP RISK AREA B	N/A	N/A	N/A		
HIGH/MED/LOW FLOOD RISK PRECINCT	LOW FLOOD RISK	N/A	N/A	N/A		
WILDLIFRE CORRIDORS	IDENTIFIED	N/A	N/A	N/A		
WATERWAYS AND RIPARIAN LAND	IDENTIFIED	N/A	N/A	N/A		
LAND ADJOINING PUBLIC OPEN SPACE	IDENTIFIED	N/A	N/A	N/A		
STORMWATER ASSET	IDENTIFIED	N/A	N/A	N/A		
DCP						
WALL HEIGHT	7.2m	5.038m	8.206m	NO		
NUMBER OF STOREYS	2	2	3	NO		
SIDE BOUNDARY ENVELOPE	4m	-	-	NO		
SIDE BOUNDARY SETBACKS	0.9m	E: 0.788m W: 5.937m	E: UNCHANGED W: UNCHANGED	YES		
FRONT BOUNDARY SETBACK	6.5m	6.155m	UNCHANGED	YES		
REAR BOUNDARY SETBACK	6.0m	12.45m	11.25m	YES		
LANDSCAPE OPEN SPACE	40% (222.92m²)	241.97m <sup>2</sup>	231.80m²	YES		
PRIVATE OPEN SPACE	60m²	0m²	UNCHANGED	YES		



## **NCC & AS COMPLIANCES SPECIFICATIONS**

- EARTHWORKS PART 3.1.1 OF NCC
- EARTH RETAINING STRUCTURES PART 3.1.2 OF NCC
- DRAINAGE PART 3.1.3 OF NCC
- TERMITE-RISK MANAGEMENT PART 3.1.4 OF NCC
- FOOTINGS & SLAB PART 3.2 OF NCC INCLUDING AS 2870-2011
- MASONRY PART 3.3 OF NCC INCLUDING AS 3700:2018
- FRAMING PART 3.4 OF NCC
- SUB FLOOR VENTILATION PART 3.4.1 OF NCC
- ROOF CLADDING AND WALL-CLADDING PART 3.5 OF NCC
- GLAZING PART 3.6 OF NCC INCLUDING AS 1288
- FIRE SAFETY PART 3.7 OF NCC
- FIRE SEPARATION OF EXTERNAL WALLS PART 3.7.2 OF NCC
- FIRE PROTECTION OF SEPARATING WALLS AND FLOORS- PART 3.7.3 OF NCC
- SMOKE ALARMS PART 3.7.5 OF NCC
- WET AREAS AND EXTERNAL WATERPROOFING PART 3.8.1 OF NCC
- ROOM HEIGHTS PART 3.8.2 OF NCC
- FACILITIES PART 3.8.3 OF NCC
- LIGHT PART 3.8.4 OF NCC
- VENTILATION PART 3.8.5 OF NCC
- SOUND INSULATION PART 3.8.6 OF NCC
- STAIRWAYAND RAMP CONSTRUCTION PART 3.9.1 OF NCC
- BARRIERS AND HANDRAILS PART 3.9.2 OF NCC
- SWIMMING POOLS PART 3.10.1 OF NCC
- CONSTRUCTION IN BUSHFIRE PRONE AREAS PART 3.10.5 OF NCC
- FENCING & OTHER PROVISIONS REGS & AS1926.1 2012
- DEMOLITION WORKS AS2601-2001 THE DEMOLITION OF STRUCTURES.
- WATERPROOFING OF WET AREAS TO COMPLY WITH AS 3740-2010
- ALL PLUMBING & DRAINAGE WORK TO COMPLY WITH AS 3500:2018
- ALL PLASTERBOARD WORK TO COMPLY WITH AS 2588:2018
- ALL STRUCTURAL STEEL WORK TO COMPLY WITH AS 4100-1992 & AS 1554
- ALL CONCRETE WORK TO COMPLY WITH AS 3600:2018
- ALL ROOF SHEETING WORK TO COMPLY WITH AS 1562.1-2018
- ALL SKYLIGHTS TO COMPLY WITH AS 4285-2019
- ALL CERAMIC TILING TO COMPLY WITH AS 3958.1-2007 & 3958.2-1992
- ALL GLAZING ASSEMBLIES TO COMPLY WITH AS 2047-2014 & 1288
- ALL TIMBER RETAINING WALLS ARE TO COMPLY WITH AS 1720.1-2010,
- AS 1720.2-2006, AS 1720.4-2006, AS 1170.1-2002 & AS 1170.4-2007
- ALL RETAINING WALLS ARE TO COMPLY WITH 3700:2018 & AS 3600:2018
- ALL CONSTRUCTION TO COMPLY WITH AS 3959:2018

# NOTES

- APPROVED MEANS BY THE 'RELEVANT LOCAL AUTHORITY' OR COUNCIL
- THE OWNER WILL DIRECTLY PAYTHE FEES ASSOCIATED WITH THE FOLLOWING:

BUILDING APPROVAL FROM COUNCIL, FOOTPATH AND KERB DEPOSITS WITH THE LOCAL COUNCIL, INSURANCE FEE TO BUILDING SERVICES CORPORATION, LONG SERVICE LEAVE SERVICE LEVY FEE AND APPROVAL FEE BY WATER AND SEWERAGE AUTHORITY. ALL OTHER FEES ARE TO BE PAID BY THE BUILDER. THE AMOUNT OF ANY LOCAL AUTHORITY DEPOSITS WHICH ARE FORFEITED DUE TO DAMAGE OR OTHER CAUSE WILL BE DEDUCTED FROM THE PAYMENTS DUE TO THE BUILDER.

- THE BUILDER IS TO PROVIDE AT HIS/HER OWN EXPENSE ADEQUATE PUBLIC RISK INSURANCE AND ARRANGE INDEMNIFICATION UNDER THE WORKERS COMPENSATION ACT. WORKS INSURANCE TO BE STATED IN THE CONTRACT CONDITIONS.
- ALL WORK TO BE CARRIED OUT IN A TRADESMEN LIKE MANNER AND IN ACCORDANCE WITH THE STANDARDS CODES AND REGULATIONS OF THE STANDARDS ASSOCIATION OF AUSTRALIA, BUILDING CODE OF AUSTRALIA AND ANY STATUTORY AUTHORITY HAVING JURISDICTION OVER THE WORK.
- ALL TENDERERS ARE TO VISIT THE SITE TO SATISFY THEMSELVES AS TO THE NATURE AND EXTENT OF THE WORKS, FACILITIES AVAILABLE AND DIFFICULTIES ENTAILED IN THE WORKS AS VARIATIONS WILL NOT BE ALLOWED DUE TO WORK ARISING OWING TO NEGLECT OF THIS CLAUSE.
- ALL WORK AND MATERIALS TO COMPLY WITH THE CURRENT AUSTRALIAN STANDARDS AT THE TIME OF COMMENCEMENT WERE APPLICABLE.
- THESE DRAWINGS SHALL BE READ IN CONJUNCTION WITH ALL STRUCTURAL AND OTHER CONSULTANTS DRAWINGS AND SPECIFICATIONS AND WITH ANY SUCH WRITTEN INSTRUCTIONS AS MAY BE ISSUED DURING THE COURSE OF THE CONTRACT.
- SET OUT DIMENSIONS SHOWN ON THIS DRAWING SHALL BE VARIFIED BY THE BUILDER ON SITE BEFORE COMMENCEMENT OF ANY WORK. DIMENSIONS SHOULD NOT BE OBTAINED BY SCALING THE DRAWINGS. USE ONLY FIGURED DIMENSIONS. ALL DIMENSIONS ARE IN MILLIMETRES.
- THE BUILDER IS TO ENSURE ALL CONSTRUCTION, LEVELS AND OTHER ITEMS COMPLY WITH THE CONDITIONS OF THE BUILDING APPROVAL.
- THE BUILDER IS TO COMPLY WITH ALL ORDINANCES, LOCAL AUTHORITY REGULATIONS AND THE REQUIREMENTS OF ALL SERVICES SUPPLY AUTHORITIES HAVING JURISDICTION OVER THE WORKS.
- ALL PLUMBING AND DRAINAGE WORK TO BE INSTALLED AND COMPLETED BY A LICENCED TRADESMAN AND IN ACCORDANCE WITH THE STATUTORY BODY HAVING AUTHORITY OVER THE WORKS. CONNECT ALL WASTE TO SYDNEY WATER SEWER LINE
- ALL NEW DOWNPIPES ARE TO BE CONNECTED TO THE EXISTING STORM WATER SYSTEM.
- ALL POWER AND STORMWATER OUTLET LOCATIONS SHALL BE DETERMINED ONSITE BY THE OWNER.
- SMOKE DETECTOR ALARM TO BE INSTALLED IN ACCORDANCE WITH AS3786 AND THE BUILDING CODE OF AUSTRALIA.
- ELECTRICAL WORK TO BE IN ACCORDANCE WITH SAA WIRING RULES AND BE DONE BY A LICENCED TRADESMAN
- ANY DETAILING IN ADDITION TO WHAT IS SUPPLIED SHALL BE RESOLVED BETWEEN THE OWNER AND THE BUILDER TO THE OWNERS APPROVAL, EXCEPT FOR ANY STRUCTURAL DETAILS OR DESIGN WHICH IS SUPPLIED BY THE ENGINEER.
- ALL TIMBER SIZES AND CONCRETE DETAILS TO BE CONFIRMED BY THE BUILDER PRIOR TO COMMENCEMENT OF ANY WORK.
- ALL STRUCTURAL WORK IS TO BE IN ACCORDANCE WITH THE STRUCTURAL DETAILS PREPARED BY A STRUCTURAL ENGINEER (i.e.) PIERS, FOOTINGS, CONCRETE SLABS, RETAINING WALLS, STEELWORK, FORMWORK, UNDERPINNING, ADDITIONAL STRUCTURAL LOADS, TIMBER FRAMING, WIND BRACING AND ASSOCIATED CONNECTIONS. BUILDER TO OBTAIN PRIOR TO FINALISING TENDER.
- ANY WORK INDICATED ON THE PLANS BUT NOT SPECIFIED, AND ANY ITEM NOT SHOWN ON THE PLAN WHICH IS OBVIOUSLY NECESSARY AS A PART OF CONSTRUCTION AND/OR FINISH IS TO BE CONSIDERED AS SHOWN AND SPECIFIED, AND IS TO BE DONE AS PART OF THE CONTRACT. VARIATIONS WILL NOT BE PERMITTED WITHOUT THE WRITTEN CONSENT OF THE OWNER.
- THE BUILDER SHALL PROVIDE SEDIMENT AND SILTRATION CONTROL MEASURES AS REQUIRED BY COUNCIL AND MAINTAIN THEM THROUGH THE DURATION OF THE WORKS.
- A LEGIBLE COPY OF THE PLANS BEARING APPROVAL STAMPS MUST BE MAINTAINED ON THE JOB AT ALL TIMES. HOURS OF CONSTRUCTION WILL BE RESTRICTED TO THE TIMES AS REQUIRED BY THE BUILDING APPROVAL
- THE BUILDER IS TO ARRANGE FOR ALL INSPECTIONS REQUIRED BY THE AUTHORITIES AND LENDING INSTITUTIONS TO THEIR REQUIREMENTS.
- THE BUILDER IS TO OBTAIN APPROVAL FOR INTERUPTIONS TO EXISTING SERVICES AND MINIMISE THE DURATION AND NUMBER OF INTERUPTIONS. ANY INTERRUPTIONS WITH EXISTING SERVICES AND EQUIPMENT TO BE ATTENDED TO BY THE APPROPRIATELY SKILLED TRADESMEN.
- THE BUILDER SHALL RESTORE, REINSTATE OR REPLACE ANY DAMAGE CAUSED TO EXISTING STRUCTURES OR LANDSCAPING BY CONSTRUCTION WORK OR WORKMEN. PROVIDE PROTECTION TO EXISTING TREES TO REMAIN AS REQUIRED BY APPROVAL CONDITIONS.
- ALL BRICKWORK IS TO BE SELECTED BY OWNER AND IS TO COMPLY WITH AS1640
- ALL MASONRY TO COMPLY WITH AS3700
- ALL METALWORK AND FLASHING ITEMS NECESSARY TO SATISFACTORY COMLPETE WORK SHALL BE PROVIDED.
- ALL GUTTERS, DOWNPIPES TO BE COLORBOND.
- ALL TIMBER CONSTRUCTION TO BE IN ACCORDANCE WITH THE AUSTRALIAN STANDARD 1684 "TIMBER FRAMING CODE"
- ALL GLAZING INSTALLED TO COMPLY WITH AS1288, 2047 AND IN ACCORDANCE WITH MANUFACTURERS RECOMMENDATION
- ALL WALLAND CEILING LININGS TO BE PLASTERBOARD OR CEMENT RENDER AS SELECTED AND VILLA BOARD IN WET AREAS, TO COMPLY WITH THE RELEVANT AUSTRALIAN STANDARDS OR INSTALLED IN ACCORDANCE WITH MANUFACTURERS SPECIFICATION.
- ALL BATHROOMS AND WET AREAS TO BE ADEQUATELY WATERPROOFED TO MANUFACTURERS SPECIFATION AND AS3740 AND PART 3.8.1 OF THE BUILDING CODE OF AUSTRALIA HOUSING PROVISIONS
- STAIRS AND BALUSTRADES TO COMPLYWITH PART 3.9.1 & 3.9.2 OF THE BUILDING CODE OF AUSTRALIA HOUSING PROVISION.
- TERMITE PROTECTION MEASURES TO COMPLY WITH AS 3660 AND BE INSTALLED TO MANUFACTURERS SPECIFICATION.
- ANY DETAILING ADDITIONAL TO THAT SUPPLIED, SHALL BE RESOLVED BETWEEN THE OWNER AND THE BUILDER TO THE OWNERS APPROVAL. EXCEPT FOR ANY STRUCTURAL DETAILS OR DESIGN WHICH IS TO BE SUPPLIED BY THE STRUCTURAL ENGINEER.

#### **SAFTEY NOTES**

THESE NOTES MUST BE READ AND UNDERSTOOD BY ALL INVOLVED IN THE PROJECT. THIS INCLUDES (but is not excluded to): OWNER, BUILDER, SUB-CONTRACTORS, CONSULT ANTS, RENOVATORS, OPERATORS, MAINTENORS, DEMOLISHERS.

#### 1. FALLS, SLIPS, TRIPS

#### a) WORKING AT HEIGHTS

#### DURING CONSTRUCTION

Wherever possible, components for this building should be prefabricated off-site or at ground level to minimise the risk of workers falling more than two metres. However, construction of this building will require workers to be working at heights where a fall in excess of two metres is possible and injury is likely to result from such a fall. The builder should provide a suitable barrier wherever a person is required to work in a situation where falling more than two metres is a possibility.

#### DURING OPERATION OR MAINTENANCE

For houses or other low-rise buildings where scaffolding is appropriate: Cleaning and maintenance of windows, walls, roof or other components of this building will require persons to be situated where a fall from a height in excess of two metres is possible. Where this type of activity is required, scaffolding, ladders or trestles should be used in accordance with relevant codes of practice, regulations or legislation. For buildings where scaffold, ladders, trestles are not appropriate: Cleaning and maintenance of windows, walls, roof or other components of this building will require persons to be situated where a fall from a height in excess of two metres is possible. Where this type of activity is required, scaffolding, fall barriers or Personal Protective Equipment (PPE) should be used in accordance with relevant codes of practice, regulations or legislation.

#### b) SLIPPERY OR UNEVEN SURFACES

#### FLOOR FINISHES Specified

If finishes have been specified by designer, these have been selected to minimise the risk of floors and paved areas becoming slippery when wet or when walked on with wet shoes/ feet. Any changes to the specified finish should be made in consultation with the designer or, if this is not practical, surfaces with an equivalent or better slip resistance should be chosen.

#### FLOOR FINISHES By Owner

If designer has not been involved in the selection of surface finishes. the owner is responsible for the selection of surface finishes in the pedestrian trafficable areas of this building. Surfaces should be selected in accordance with AS HB 197:1999 and AS/ NZ 4586:2004.

#### STEPS, LOOSE OBJECTS AND UNEVEN SURFACES

Due to design restrictions for this building, steps and/ or ramps are included in the building which may be a hazard to workers carrying objects or otherwise occupied. Steps should be clearly marked with both visual and tactile warning during construction, maintenance, demolition and at all times when the building operates as a workplace. Building owners and occupiers should monitor the pedestrian access ways and in particular access to areas where maintenance is routinely carried out to ensure that surfaces have not moved or cracked so that they become uneven and present a trip hazard. Spills, loose material, stray objects or any other matter that may cause a slip or trip hazard should be cleaned or removed from access ways. Contractors should be required to maintain a tidy work site during construction, maintenance or demolition to reduce the risk of trips and falls in the workplace. Materials for construction or maintenance should be stored in designated areas away from access ways and work areas.

## 2. FALLING OBJECTS

#### LOOSE MATERIALS OR SMALL OBJECTS

Construction, maintenance or demolition work on or around this building is likely to involve persons working above ground level or above floor levels. Where this occurs one or more of the following measures should be token to ovoid objects falling from the area where the work is being carried out onto persons below.

- 1. Prevent or restrict access to areas below where the work is being carried out.
- 2. Provide toeboards to scaffolding or work platforms.
- 3. Provide protective structure below the work area.
- 4. Ensure that all persons below the work area have Personal

Protective Equipment (PPE).

## **BUILDING COMPONENTS**

During construction, renovation or demolition of this building, parts of the structure including fabricated steelwork, heavy panels and many other components will remain standing prior to or after supporting parts are in place. Contractors should ensure that temporary bracing or other required support is in place at all times when collapse which may injure persons in the area is a possibility. Mechanical lifting of materials and components during construction, maintenance or demolition presents a risk of falling objects. Contractors should ensure that appropriate lifting devices are used, that loads are properly secured and that access to areas below the load is prevented or restricted.

# 3. TRAFFIC MANAGEMENT

For building on a major road, narrow road or steeply sloping road: Parking of vehicles or loading/ unloading of vehicles on this roadway may cause a traffic hazard. During construction, maintenance or demolition of this building designated parking for workers and loading areas should be provided. Trained traffic management personnel should be responsible for the supervision of these areas. For building where onsite loading/ unloading is restricted: Construction of this building will require loading and unloading of materials on the roadway. Deliveries should be well planned to ovoid congestion of loading areas and trained traffic management personnel should be used to supervise loading/ unloading areas. For all buildings: Busy construction and demolition sites present a risk of collision where deliveries and other traffic are moving within the site. A traffic management plan supervised by trained traffic management personnel should be adopted for the work site.

#### 4. SERVICES

#### GENERAL

Rupture of services during excavation or other activity creates a variety of risks including release of hazardous material. Existing services are located on or around this site. Where known, these ore identified on the plans but the excel location and extent of services may vary from that indicated. Services should be located using on appropriate service (such as Dial Before You Dig), appropriate excavation practice should be used and, where necessary, specialist contractors should be used. Locations with underground power: Underground power lines MAY be located in or around this site. All underground power lines must be disconnected or carefully located and adequate warning signs used prior to any construction, maintenance or demolition commencing. Locations with overhead power lines: Overhead power lines MAY be near or on this site. These pose a risk of electrocution if struck or approached by lifting devices or other plant and persons working above ground level. Where there is a danger of this occurring, power lines should be, where practical, disconnected or relocated. Where this is not practical adequate warning in the form of bright coloured tape or signage should be used or a protective barrier provided.

#### 5. MANUAL TASKS

Components within this design with a moss in excess of 25kg should be lifted by two or more workers or by mechanical lifting device. Where this is not practical, suppliers or fabricators should be required to limit the component mass. All material packaging, building and maintenance components should clearly show the total moss of packages and where practical all items should be stored on site in a way which minimises bending before lifting. Advice should be provided on safe lifting methods in all areas where lifting may occur. Construction, maintenance and demolition of this building will require the use of portable tools and equipment. These should be fully maintained in accordance with manufacturer's specifications and not used where faulty or (in the case of electrical equipment) not carrying a current electrical safety tag. All safety guards or devices should be regularly checked and Personal Protective Equipment should be used in accordance with manufacturer's specification.

#### 6. HAZARDOUS SUBSTANCES

#### ASBESTOS

For alterations to a building constructed prior to 1990:

If this existing building was constructed prior to: 1990 - it therefore may contain asbestos

1990 - It therefore may contain aspestos

1986 - it therefore is likely to contain asbestos

either in cladding material or in fire retardant insulation material. In either case, the builder should check and, if necessary, take appropriate action before demolishing, culling, sanding, drilling or otherwise disturbing the existing structure.

#### POWDERED MATERIALS

Many materials used in the construction of this building con cause harm if inhaled in powdered form. Persons working on or in the building during construction, operational maintenance or demolition should ensure good ventilation and wear Personal Protective Equipment including protection against inhalation while using powdered material or when sanding, drilling, cutting or otherwise disturbing or creating powdered material.

#### TREATED TIMBER

The design of this building may include provision for the inclusion of treated limber within the structure. Dust or fumes from this material can be harmful. Persons working on or in the building during construction, operational maintenance or demolition should ensure good ventilation and wear Personal Protective Equipment including protection against inhalation of harmful material when sanding, drilling, cutting or using treated timber in any way that may cause harmful material lo be released. Do not burn treated timber.

#### VOLATILE ORGANIC COMPOUNDS

Many types of glue, solvents, spray packs, paints, varnishes and some cleaning materials and disinfectants have dangerous emissions. Areas where these are used should be kept well ventilated while the material is being used and for a period after installation. Personal Protective Equipment may also be required. The manufacturer's recommendations for use must be carefully considered at all times.

#### SYNTHETIC MINERAL FIBRE

Fibreglass, rockwool, ceramic and other material used for thermal or sound insulation may contain synthetic mineral fibre which may be harmful if inhaled or if it comes in contact with the skin, eyes or other sensitive parts or the body. Personal Protective Equipment including protection against inhalation of harmful material should be used when installing, removing or working near bulk insulation material.

#### TIMBER FLOORS

This building may contain timber floors which have an applied finish. Areas where finishes are applied should be kept well ventilated during sanding and application and for a period after installation. Personal Protective Equipment may also be required. The manufacturer's recommendations for use must be carefully considered at all times.

#### 7. CONFINED SPACES

#### **EXCAVATION**

Construction of this building and some maintenance on the building will require excavation and installation of items within excavations. Where practical, installation should be carried out using methods which do not require workers to enter the excavation. Where this is not practical, adequate support for the excavated area should be provided to prevent collapse. Warning signs and barriers to prevent accidental or unauthorised access to all excavations should be provided.

#### **ENCLOSED SPACES**

For buildings with enclosed spaces where maintenance or other access may be required: Enclosed spaces within this building may present a risk to persons

entering for construction, maintenance or any other purpose. The design documentation calls for warning signs and barriers to unauthorised access. These should be maintained throughout the life of the building. Where workers are required to enter enclosed spaces, air testing equipment and Personal Protective Equipment should be provided.

#### SMALL SPACES

For buildings with small spaces where maintenance or other access may be required: Some small spaces within this building will require access by construction or maintenance workers. The design documentation calls for warning signs and barriers to unauthorised access. These should be maintained throughout the life of the building. Where workers are required to enter small spaces they should be scheduled so that access is for short periods. Manual lifting and other manual activity should be restricted in small spaces.

#### 8. PUBLIC ACCESS

Public access to construction and demolition sites and lo areas under maintenance causes risk to workers and public. Warning signs and secure barriers to unauthorised access should be provided. Where electrical installations, excavations, plant or loose materials are present they should be secured when not fully supervised.

#### 9. OPERATIONAL USE OF BUILDING RESIDENTIAL BUILDINGS


This building has been designed as a residential building. If it, at a later date, it is used or intended to be used as a workplace, the provisions of the Work Health and Safely Act 2011 or subsequent replacement Act should be applied to the new use.

#### NON-RESIDENTIAL BUILDINGS

For non-residential buildings where the end-use has not been identified: This building has been designed to requirements of the classification identified on the drawings. The specific, use of the building is not known at the time of the design and a further assessment of the workplace health and safety issues should be undertaken at the time of fit-out for the end-user. For non-residential buildings where the end-use is known: This building has been designed for the specific use as identified on the drawings. Where a change of use occurs at a later dale a further assessment of the workplace health and safety issues should be undertaken.

### 10. OTHER HIGH RISK ACTIVITY

All electrical work should be carried out in accordance with Code of Practice: Managing Electrical Risks at the Workplace, AS/ NZ 3012 and all licensing requirements. All work using Plant should be carried out in accordance with Code of Practice: Managing Risks of Plant at the Workplace. All work should be carried out in accordance with Code of Practice: Managing Noise and Preventing Hearing Loss at Work. Due to the history of serious incidents it is recommended that particular care be exercised when undertaking work involving steel construction and concrete placement. All the above applies.

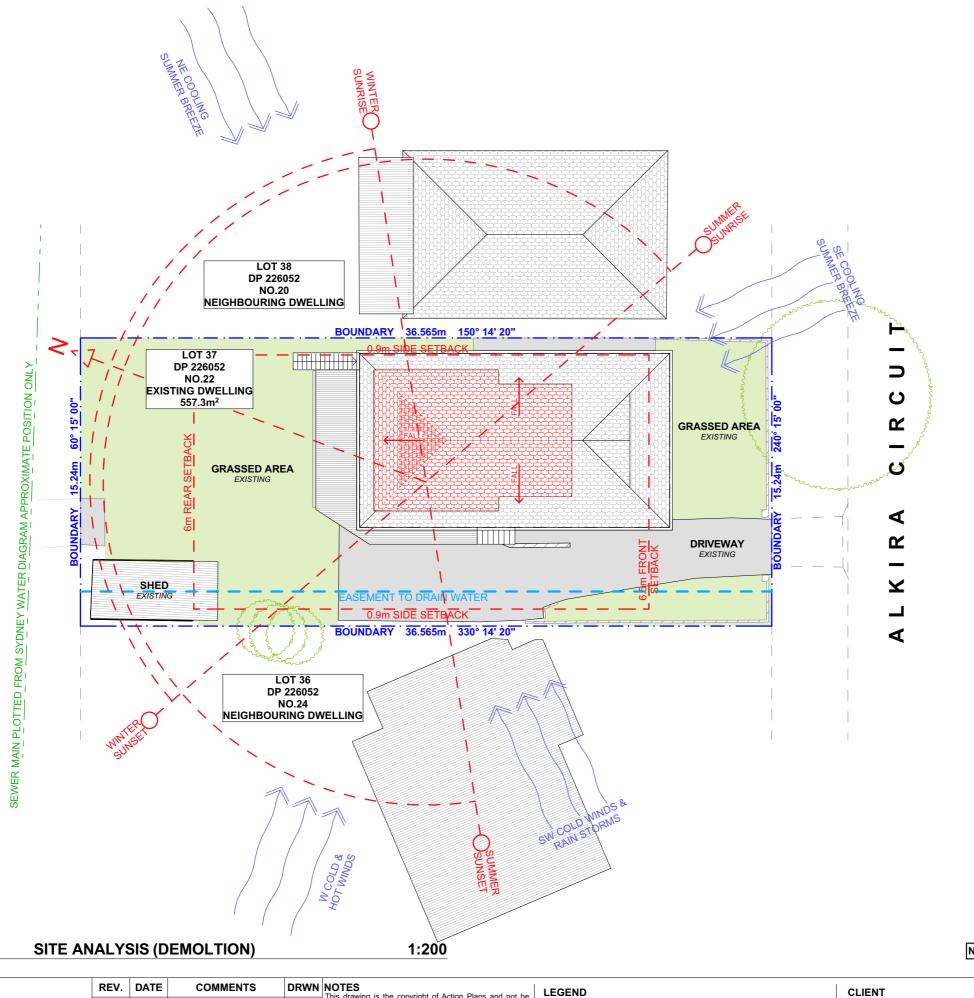







NOTE: ALL DEMOLISHED ELEMENTS TO ENG. SPECIFICATIONS AND AS. 2601 - 2001


DRAWING NAME

1:200 @A3



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REV.	DATE	COMMENTS	DRWN	NOTES
А	23052022	DA: REV A	RNA	This drawing is the copyright of Action Plans and not be altered, reproduced or transmitted in any form or by any means in part or in whole with the written permission of
				Action Plans.  Do not scale measure from drawings. Figured dimensions are to be used only.
				The Builder/Contractor shall check and verify all levels and
				dimensions on site prior to commencement of any work, creation of shop drawings, or fabrication of components.
				All errors and omissions are to be verified by the Builder/Contractor and referred to the designer prior to the

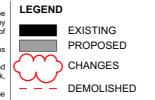

SHELDON & MONICA HATZANTONIS


PROJECT ADDRESS 22 ALKIRA CIRCUIT, NARRAWEENA NSW 2099

DRAWING NO. **DA03** 

Monday, 23 May 2022

SITE ANALYSIS

DATE **SCALE** 

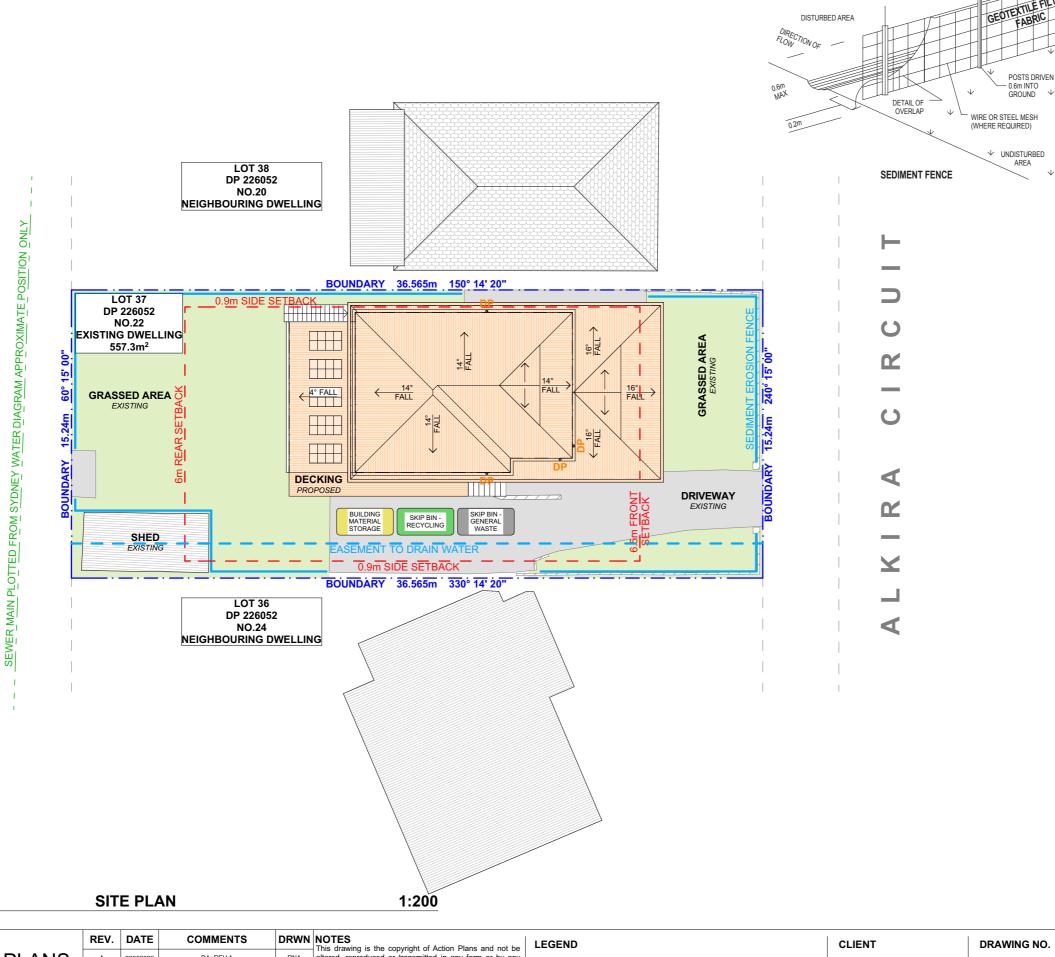

**NOTES REGARDING BOUNDARY** 

THE INFORMATION SHOWN ON THIS PLAN IS FOR DESIGN PURPOSES ONLY. THE POSITION OF BOUNDARY LINES HAVE BEEN ESTABLISHED BY A SURVEY TO MEET THE IDENTIFICATION REQUIREMENTS FOR COUNCIL AND NOT FOR REGISTRATION WITH THE LAND REGISTRATION SERVICES NSW NOR MAY THIS PLAN BE USED FOR ANY OTHER PURPOSE. SUBSEQUENT REGISTERED OR OTHER SURVEYS MAY AFFECT THE DEFINED BOUNDARY POSITIONS IN THIS AREA. ANY DIFFERENCES OF THIS NATURE ARE BEYOND THE PURPOSES OF THIS PLAN. THIS PLAN IS FOR THE ABOVE STATED PURPOSES ONLY. RESTRICTIONS ON THE TITLE HAVE NOT BEEN INVESTIGATED. IF FURTHER DEVELOPMENT IS CONTEMPLATED OR CONSTRUCTION INTENDED THEN IT IS IMPORTANT THAT A SURVEY SET OUT IS CARRIED OUT.

#### **DUST CONTROL:**

TO REDUCE DUST GENERATED BY WIND ACTION, THE REMOVAL OF THE TOP SOIL IS TO BE MINIMISED. TO PREVENT DUST GENERATION, WATERING DOWN OF THE SITE, ESPECIALLY DURING THE MOVEMENT OF MACHINERY IS REQUIRED. WHERE EXCAVATING INTO ROCK, KEEP THE SURFACE MOIST TO MINIMISE DUST. CONSTRUCT A GRAVEL ENTRY/EXIT POINT USING BLUE METAL AND RESTRICT ALL VEHICLE MOVEMENTS WITHIN THE SITE TO A MINIMUM. ENSURE WIND BREAKS, SUCH AS EXISTING FENCES ARE MAINTAINED DURING THE CONSTRUCTION PHASE UNTIL NEW LANDSCAPING IS PROVIDED OR REINSTATED. PREVENT DUST BY COVERING STOCKPILES

#### **SEDIMENT NOTE:**

1. ALL EROSION AND SEDIMENT CONTROL MEASURES TO BE INSPECTED AND MAINTAINED DAILY BY THE SITE MANAGER.

2. MINIMISE DISTURBED AREAS, REMOVE EXCESS SOIL FROM EXCAVATEDAREA AS SOON AS POSSIBLE. 3. ALL MATERIAL STOCKPILE TO BE CLEAR FROM DRAINS, GUTTERS AND FOOTPATHS, OR WITHIN SEDIMENT FENCE AREA.

4. DRAINAGE TO BE CONNECTED TO STORMWATER AS SOON AS POSSIBLE. IF STORED ON SITE, IT MUST BE FILTERED BEFORE RELEASING INTO STORMWATER SYSTEM OR WATERWAYS.

5. ROADS AND FOOTPATHS TO BE SWEPT DAILY.

#### STOCKPILES:

ALL STOCKPILES ARE TO BE KEPT ON-SITE WHERE POSSIBLE. ANY MATERIALS PLACED ON THE FOOTPATHS OR NATURE STRIPS REQUIRE COUNCIL'S PERMISSION.

ALL STOCKPILES ARE TO BE PLACED AWAY FROM THE DRAINAGE LINES AND STREET GUTTERS. IT IS BEST TO LOCATE THESE ON THE HIGHEST PART OF THE SITE IF POSSIBLE. PLACE WATERPROOF COVERING OVER STOCKPILES.

IF REQUIRED PROVIDE DIVERSION DRAIN & BANK AROUND STOCKPILES.


### **GUTTER PROTECTION:**

PROVIDE PROTECTION TO DOWNHILL GRATE IN GUTTER BY MEANS OF SAND BAGS OR BLUE METAL WRAPPED IN GEOTEXTILE FABRIC. WHEN SOIL OR SAND BUILDS UP AROUND THIS SEDIMENT BARRIER, THE MATERIAL SHOULD BE RELOCATED BACK TO THE SITE FOR DISPOSAL.

NOTE: ALL PROPOSED STORMWATER TO CONNECT WITH EXISTING

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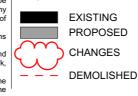


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SHELDON & MONICA **HATZANTONIS** 

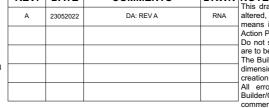PROJECT ADDRESS 22 ALKIRA CIRCUIT. NARRAWEENA NSW

2099

DRAWING NO.

**DA04** 


DATE Monday, 23 May 2022


WASTE MANAGEMENT / STORMWATER CONCEPT PLAN

**DRAWING NAME** 

SCALE

1:1, 1:200 @A3

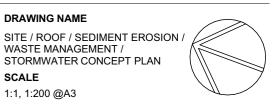

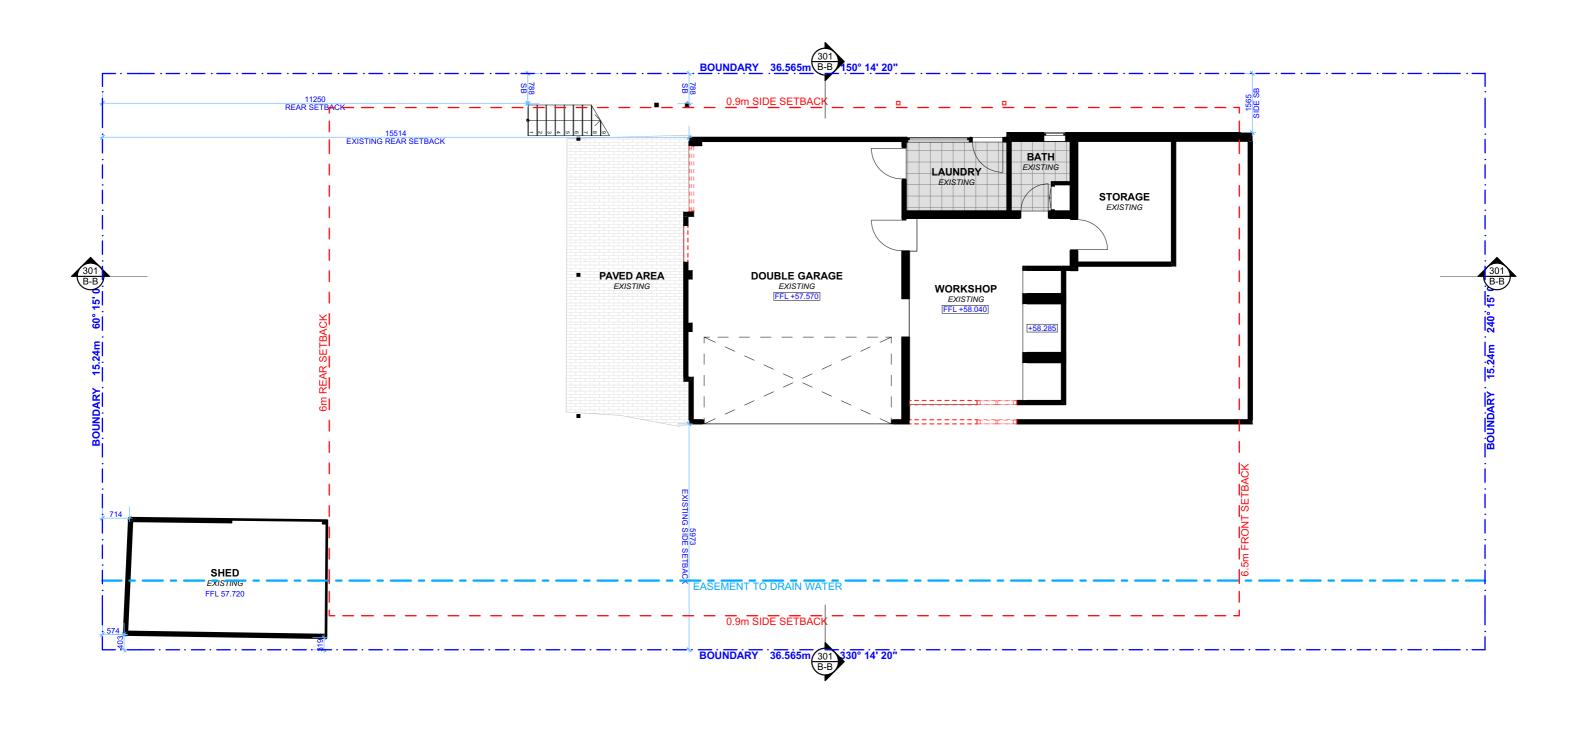

EXISTING LOWER GROUND FLOOR PLAN

REV. DATE

1:100

NOTE: ALL DEMOLISHED ELEMENTS TO ENG. SPECIFICATIONS AND AS. 2601 - 2001

DRAWING NAME




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		creation of shop drawings, or fabrication of components.
		All errors and omissions are to be verified by the
		Builder/Contractor and referred to the designer prior to the
		commoncoment of works



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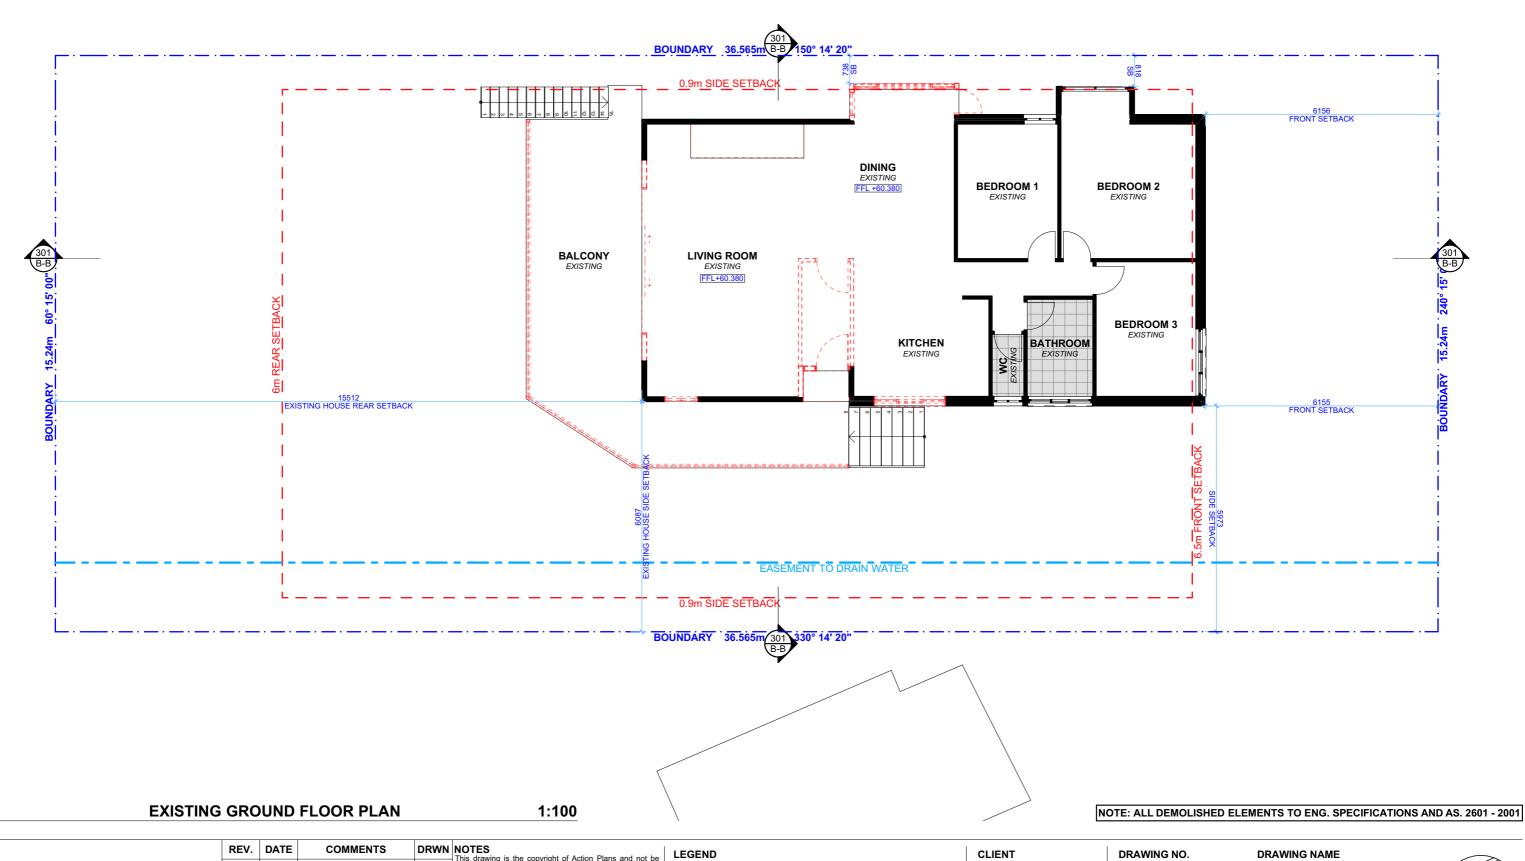
PROJECT ADDRESS 22 ALKIRA CIRCUIT, NARRAWEENA NSW 2099 DRAWING NO.

**DA05** 

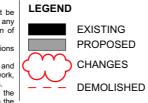DATE Monday, 23 May 2022 EXISTING LOWER GROUND FLOOR PLAN

SCALE 1:100 @A3








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dimensions on site prior to commencement of any work, creation of shop drawings, or fabrication of components. All errors and omissions are to be verified by the Builder/Contractor and referred to the designer prior to the




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PROJECT ADDRESS 22 ALKIRA CIRCUIT, NARRAWEENA NSW 2099

EXISTING GROUND FLOOR PLAN **DA06** 

DATE SCALE 1:100 @A3 Monday, 23 May 2022

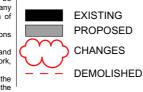

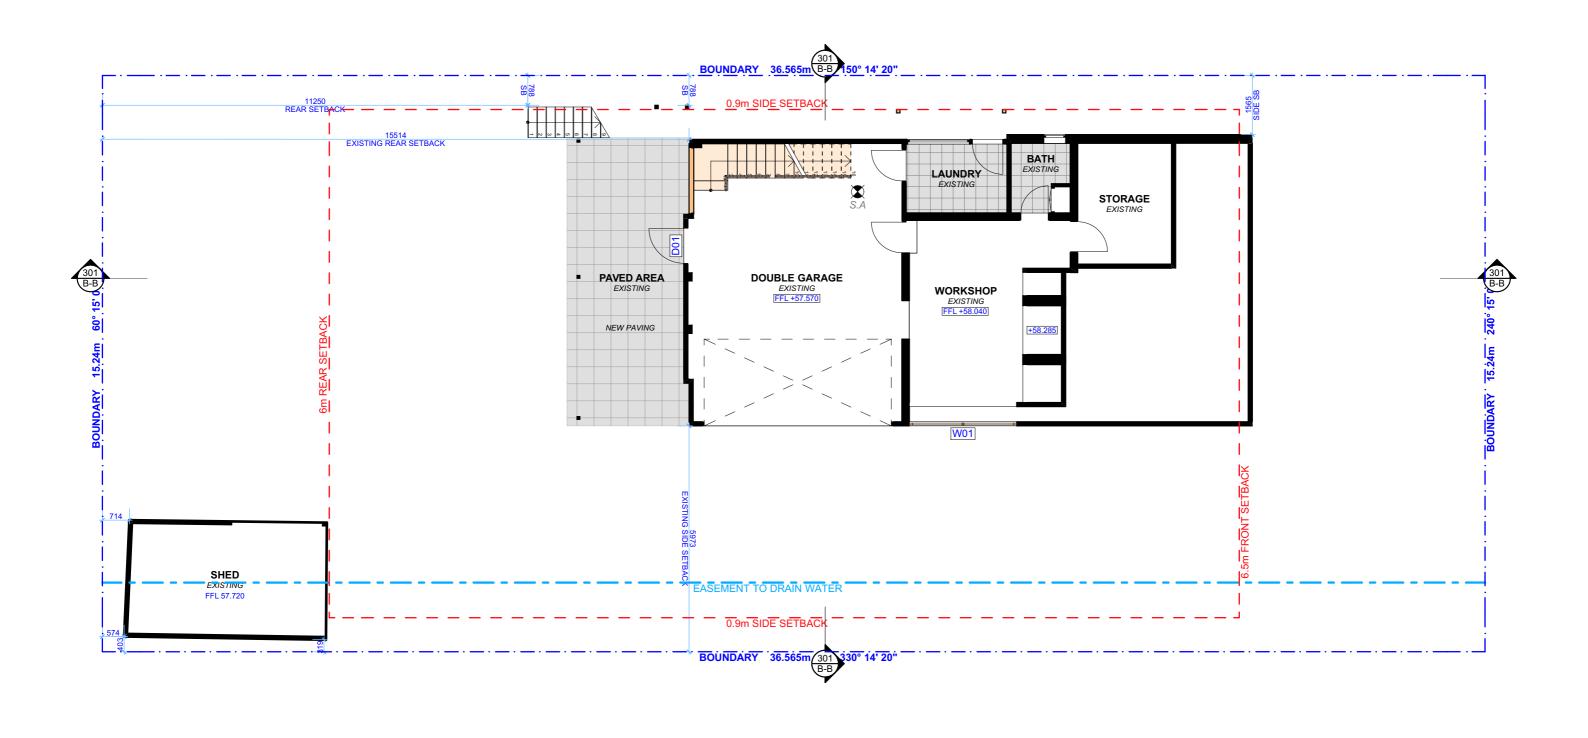


PROPOSED LOWER GROUND FLOOR PLAN

1:100

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REV.	DATE	COMMENIS	DRWN	NOTES	l 1
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				are to be used only.	1
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				creation of shop drawings, or fabrication of components.	`
				All errors and omissions are to be verified by the	-
				Builder/Contractor and referred to the designer prior to the	



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DRAWING NO.

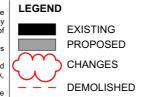**DA07** 

DATE Monday, 23 May 2022

SCALE

DRAWING NAME PROPOSED LOWER GROUND FLOOR PLAN

1:100 @A3








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				dimensions on site prior to commencement of any work, creation of shop drawings, or fabrication of components.
				All errors and omissions are to be verified by the Builder/Contractor and referred to the designer prior to the



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PROJECT ADDRESS 22 ALKIRA CIRCUIT, NARRAWEENA NSW 2099

**DA08** 

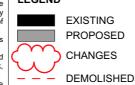
Monday, 23 May 2022

DATE

PROPOSED GROUND FLOOR PLAN

SCALE 1:100 @A3



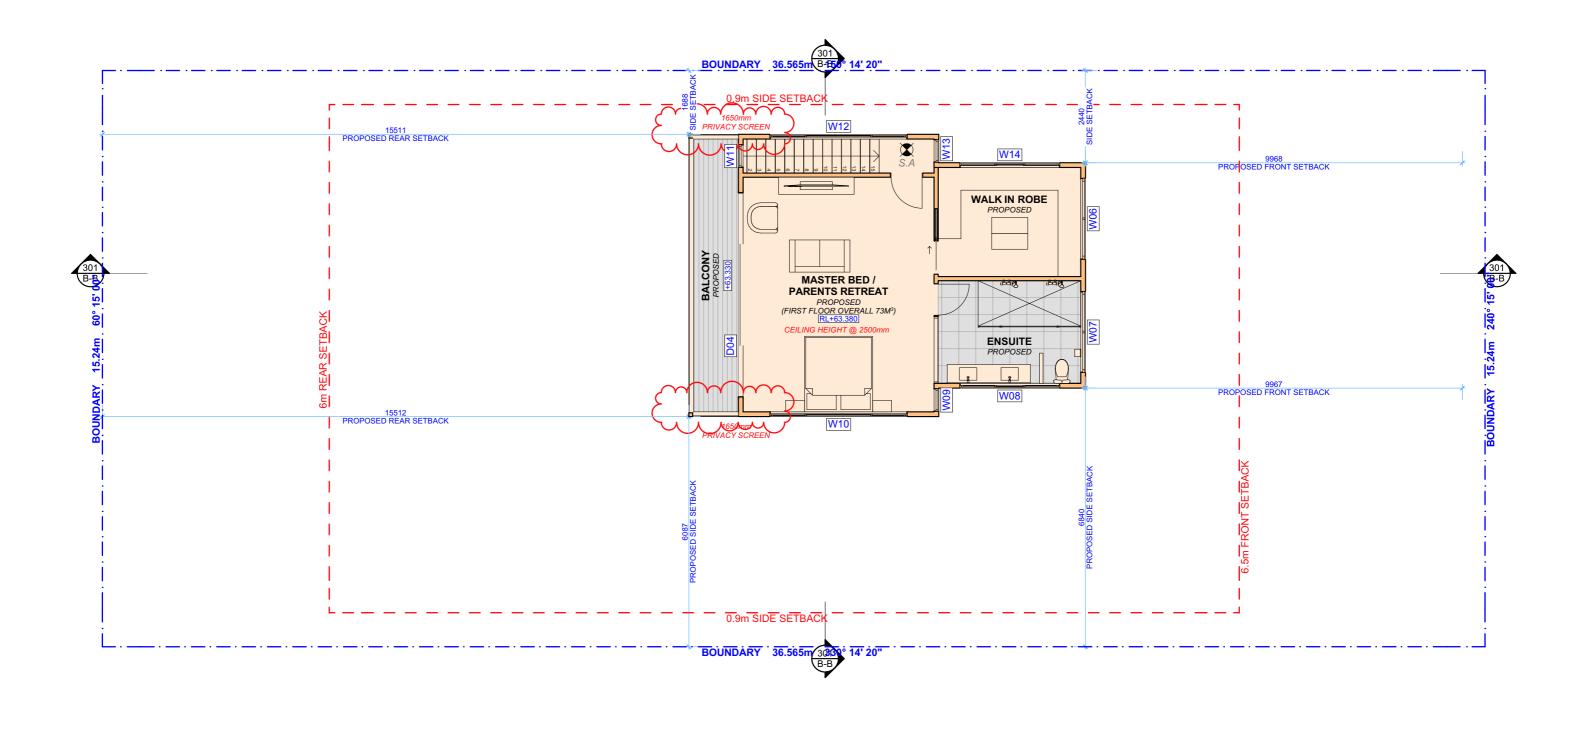

PROPOSED FIRST FLOOR PLAN

1:100


NOTE: ALL PROPOSED WORKS TO BE COMPLIANT WITH THE NBC FLOOD PLANNING POLICY.



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				are to be used only.  The Builder/Contractor shall check and verify all levels and
				dimensions on site prior to commencement of any work creation of shop drawings, or fabrication of components.
				All errors and omissions are to be verified by th Builder/Contractor and referred to the designer prior to th



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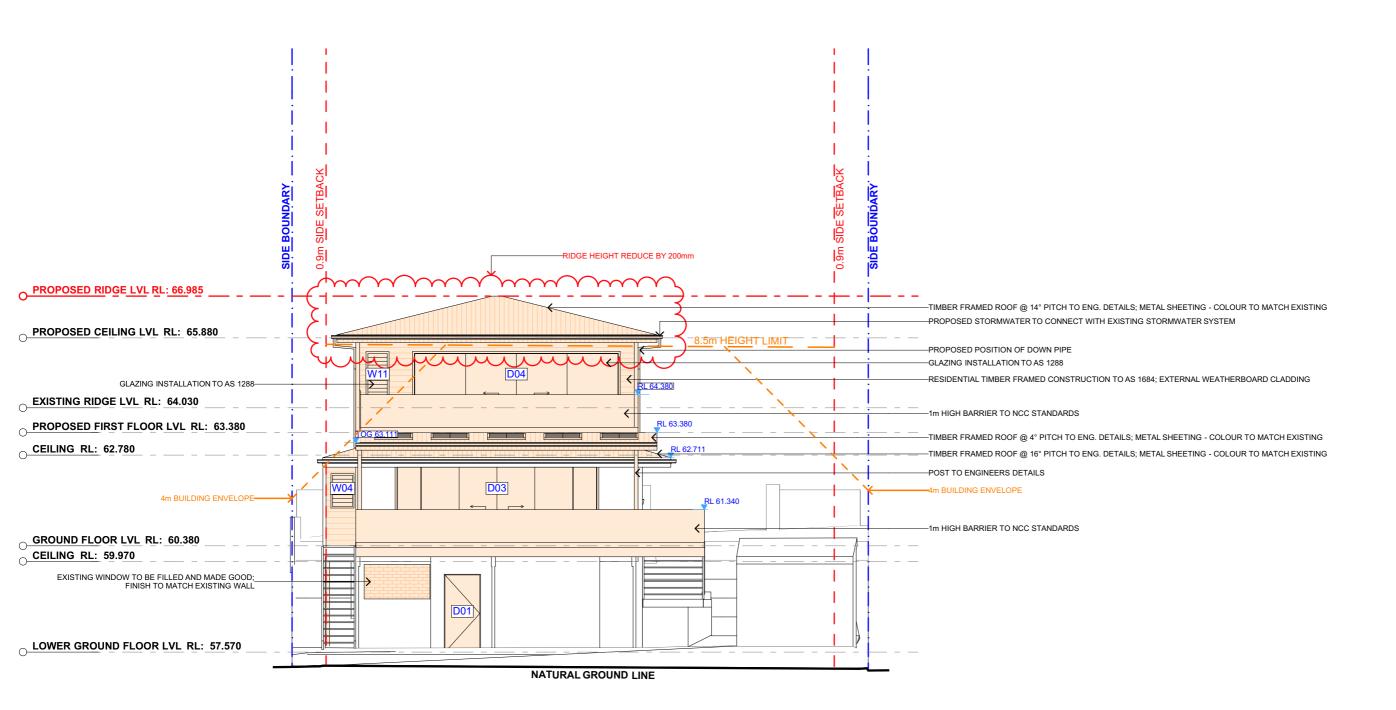
PROJECT ADDRESS 22 ALKIRA CIRCUIT, NARRAWEENA NSW 2099 DRAWING NO.

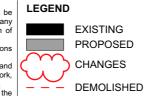PROPOSED FIRST FLOOR PLAN

DRAWING NAME

**DATE SCALE** Monday, 23 May 2022 1:100 @A3





NORTH ELEVATION 1:100

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				dimensions on site prior to commencement of any work,	
				creation of shop drawings, or fabrication of components.	
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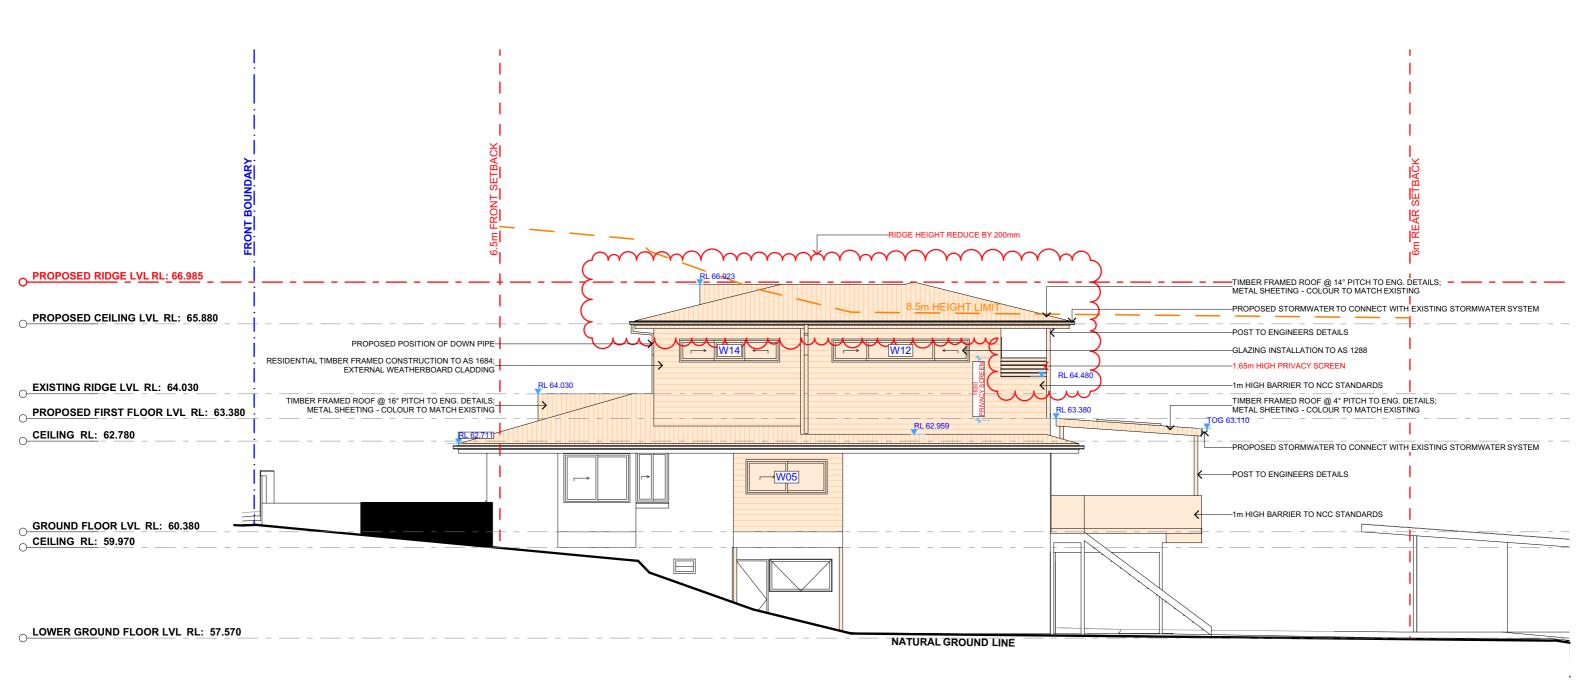
PROJECT ADDRESS 22 ALKIRA CIRCUIT, NARRAWEENA NSW 2099 DRAWING NO.

DRAWING NAME

DA10 NORTH ELEVATION

 DATE
 SCALE

 CUIT,
 Monday, 23 May 2022
 1:100 @A3



**EAST ELEVATION** 1:100

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				creation of shop drawings, or fabrication of components.  All errors and omissions are to be verified by the
				Builder/Contractor and referred to the designer prior to the commencement of works.



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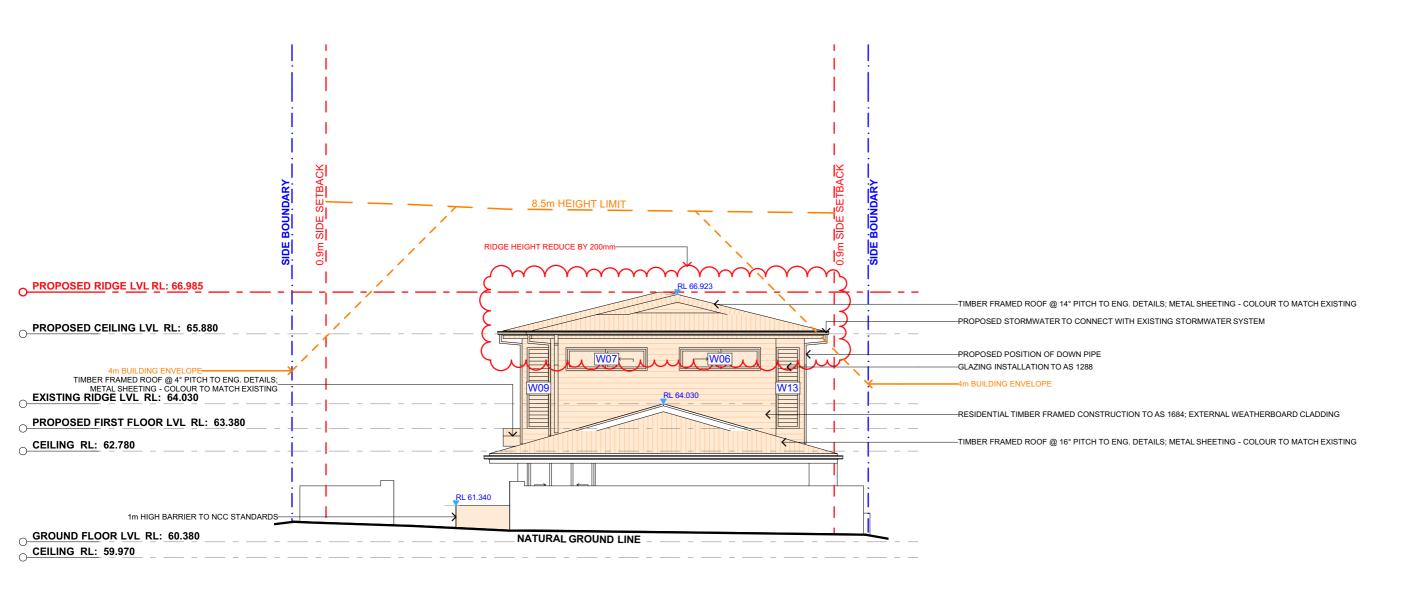
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PROJECT ADDRESS 22 ALKIRA CIRCUIT, NARRAWEENA NSW DRAWING NO.

**DA11** 

DRAWING NAME EAST ELEVATION

DATE SCALE 1:100 @A3 Monday, 23 May 2022



O LOWER GROUND FLOOR LVL RL: 57.570

**SOUTH ELEVATION - PRIMARY ROAD** 

1:100

NOTE: ALL PROPOSED WORKS TO BE COMPLIANT WITH THE NBC FLOOD PLANNING POLICY.

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	В	31/03/2021	DESIGN AMENDMENT	LRP	Action Plans.  Do not scale measure from drawings. Figured dimensions
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ı					dimensions on site prior to commencement of any work, creation of shop drawings, or fabrication of components.
					All errors and omissions are to be verified by the Builder/Contractor and referred to the designer prior to the
					commencement of works.



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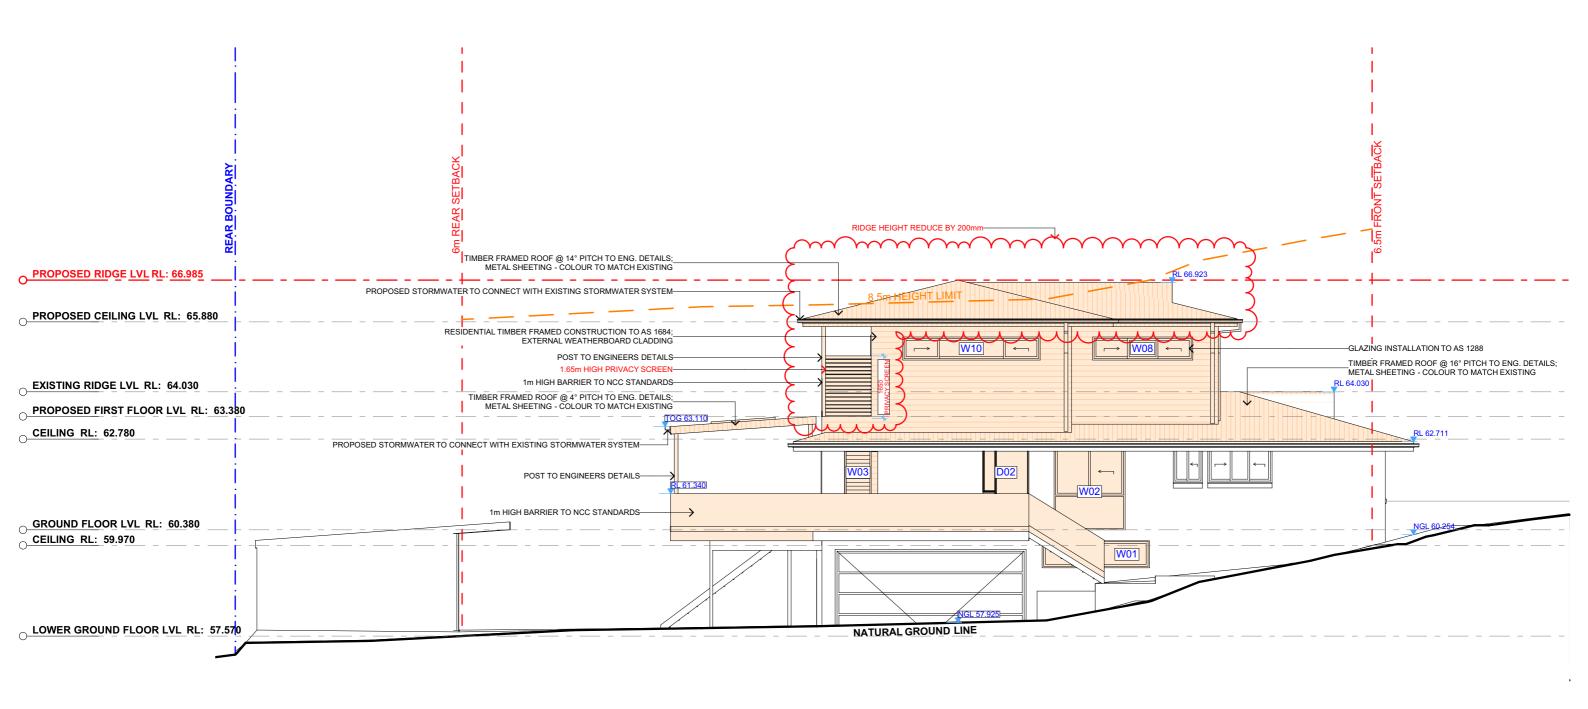
**DA12** 

DRAWING NAME SOUTH ELEVATION

DATE

SCALE 1:100 @A3

Monday, 23 May 2022



**WEST ELEVATION** 1:100

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				are to be used only. The Builder/Contractor shall check and verify all levels and	
				dimensions on site prior to commencement of any work, creation of shop drawings, or fabrication of components.  All errors and omissions are to be verified by the	
				Builder/Contractor and referred to the designer prior to the commencement of works.	




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WEST ELEVATION **DA13** 

DATE SCALE 1:100 @A3 Monday, 23 May 2022



PROPOSED CROSS SECTION

1:100
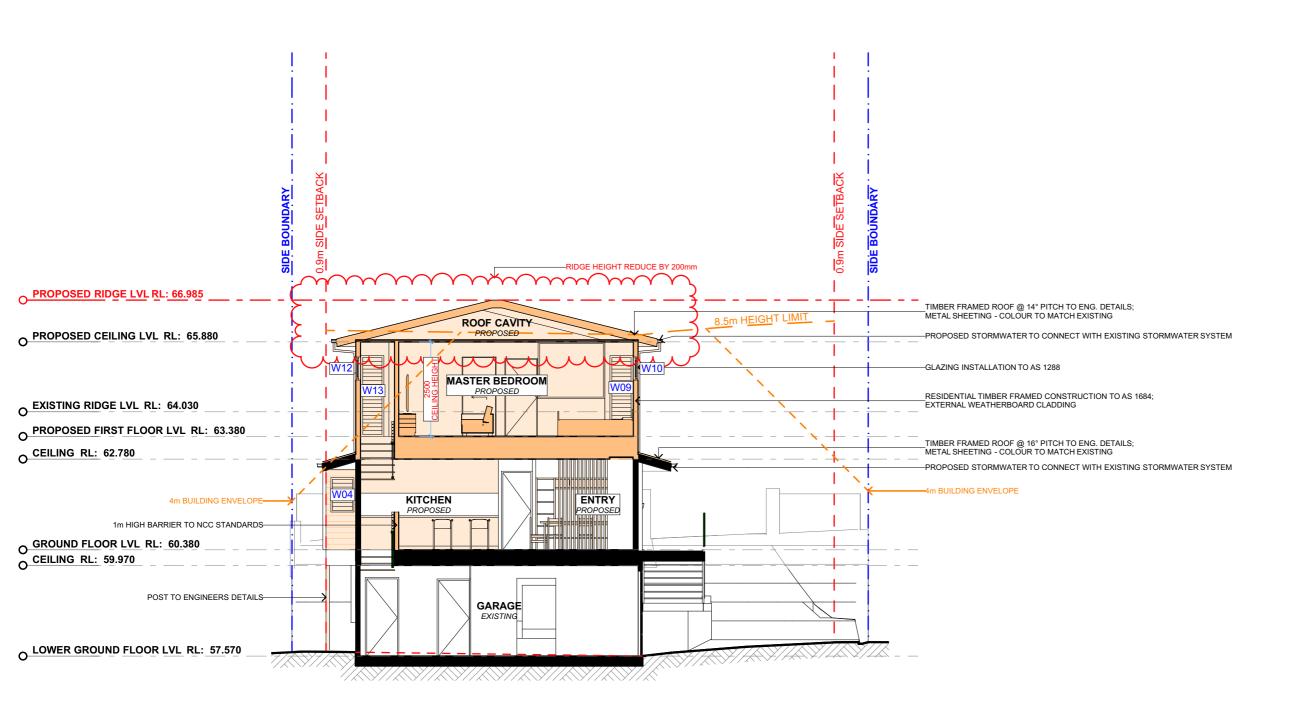
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В	31/03/2021	DESIGN AMENDMENT	LRP	Action Plans.  Do not scale measure from drawings. Figured dimensions
				are to be used only. The Builder/Contractor shall check and verify all levels and
				dimensions on site prior to commencement of any work, creation of shop drawings, or fabrication of components.
				All errors and omissions are to be verified by the Builder/Contractor and referred to the designer prior to the
				commencement of works.



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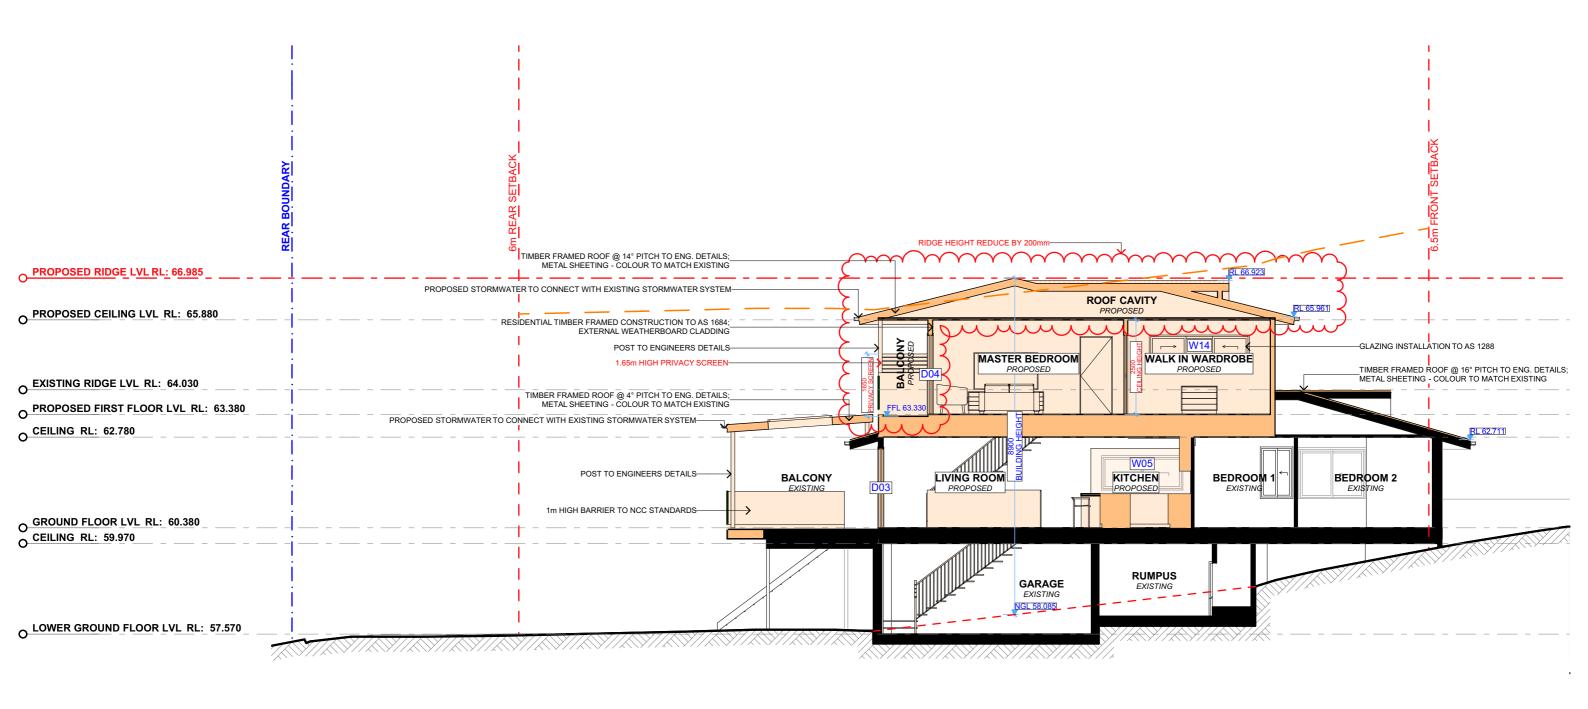
PROJECT ADDRESS 22 ALKIRA CIRCUIT, NARRAWEENA NSW DRAWING NO.

**DA14** 

DRAWING NAME
CROSS SECTION

**SS DATE** T, Monday, 23 May 2022

SCALE 2022 1:100 @A3



PROPOSED LONG SECTION

1:100

NOTE: ALL PROPOSED WORKS TO BE COMPLIANT WITH THE NBC FLOOD PLANNING POLICY.



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	В	31/03/2021	DESIGN AMENDMENT	LRP	Action Plans.  Do not scale measure from drawing
ı					are to be used only. The Builder/Contractor shall check dimensions on site prior to commoreation of shop drawings, or fabric All errors and omissions are Builder/Contractor and referred to
					commencement of works.



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PROJECT ADDRESS 22 ALKIRA CIRCUIT,

DRAWING NO. **DA15** 

DRAWING NAME LONG SECTION

NARRAWEENA NSW

DATE SCALE 1:100 @A3 Monday, 23 May 2022

LANDSCAPED AREA 55.07 m<sup>2</sup> LANDSCAPED AREA 158.61 m<sup>2</sup> LANDSCAPED AREA 18.12 m<sup>2</sup>



**EXISTING AREA CALCULATIONS** 

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m: 0426 957 518

PROPOSED AREA CALCULATIONS

1:200

LEGEND

REV. DATE COMMENTS DA: REV A 23052022

DRWN
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1:200

**CONTROL TABLE** 

SITE AREA 557.3m<sup>2</sup>

**REQUIRED** 

**PROPOSED** 

LANDSCAPED AREA

40% (222.92m<sup>2</sup>)

41.5% 231.80m<sup>2</sup>



**ALUMINIUN FRAMED WINDOWS** BY STEGBAR



EXTERNAL WEATHERBOARD CLADDING - COLOUR TO BE CONFIRMED BY CLIENT



METAL ROOFING -COLOUR TO BE CONFIRMED BY CLIENT

#### **MATERIAL SAMPLE BOARD** 3.

CLIENT

2099

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PROJECT ADDRESS 22 ALKIRA CIRCUIT, NARRAWEENA NSW

DRAWING NO.


**DA16** 

DRAWING NAME AREA CALCULATIONS / SAMPLE BOARD

DATE

**SCALE** Monday, 23 May 2022 1:200 @A3



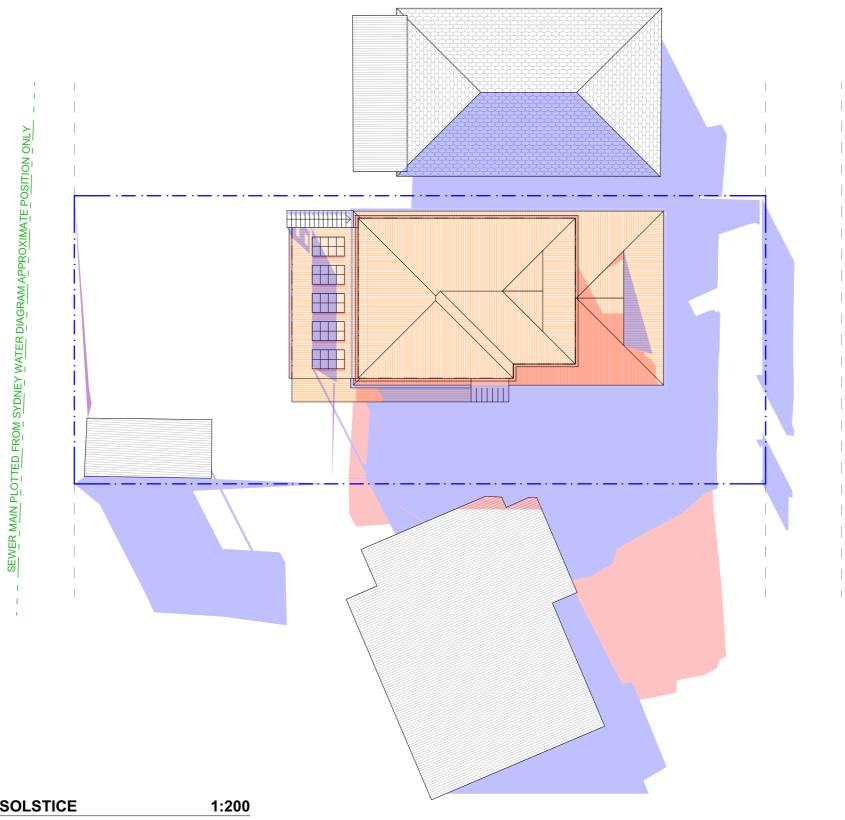


0900 21 JUNE - WINTER SOLSTICE

DRWN
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commencement of works.



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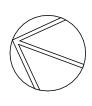
DRAWING NO.

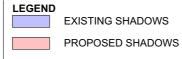DATE

WINTER SOLSTICE 0900 **DA17** 


DRAWING NAME

SCALE Monday, 23 May 2022 1:200 @A3



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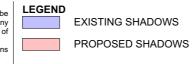
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1200 21 JUNE - WINTER SOLSTICE

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				dimensions on site prior to commencement of any creation of shop drawings, or fabrication of componen All errors and omissions are to be verified by
				Builder/Contractor and referred to the designer prior commencement of works.

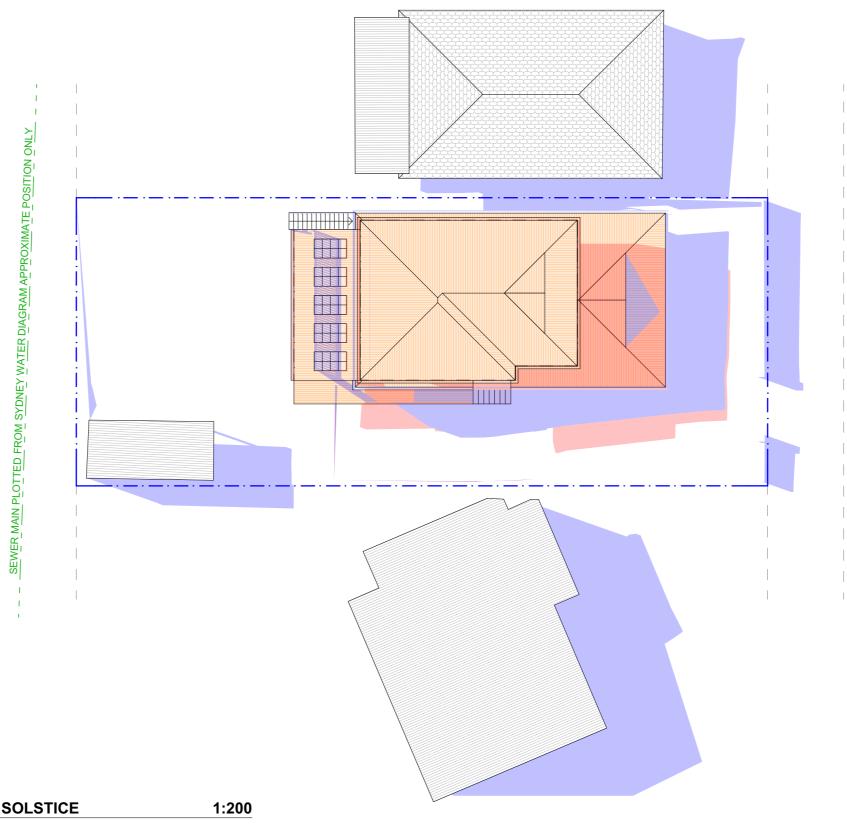

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PROJECT ADDRESS 22 ALKIRA CIRCUIT, NARRAWEENA NSW 2099 DRAWING NO.

**DA18** 


DATE

Monday, 23 May 2022

DRAWING NAME WINTER SOLSTICE 1200

SCALE 1:200 @A3




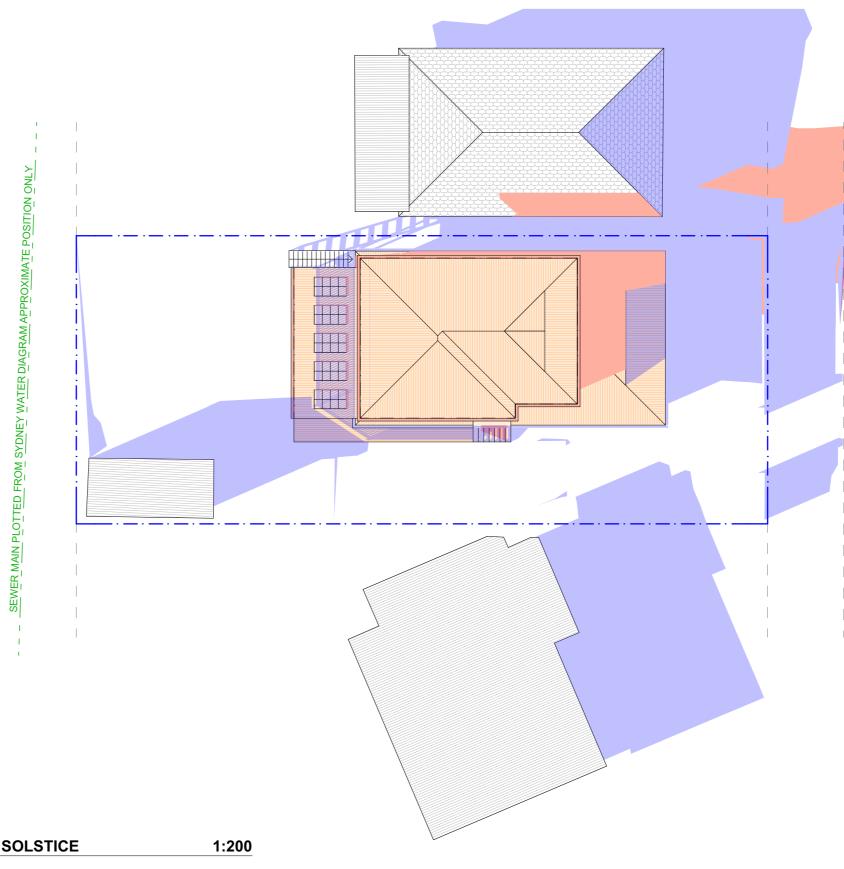

1500 21 JUNE - WINTER SOLSTICE

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PROJECT ADDRESS 22 ALKIRA CIRCUIT, NARRAWEENA NSW 2099 DRAWING NO.

**DA19** 

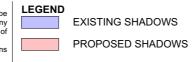DATE SCALE

**DATE SCALE** Monday, 23 May 2022 1:200 @A3

DRAWING NAME

WINTER SOLSTICE 1500



# **BASIX**\*Certificate

Building Sustainability Index www basix nsw gov au

#### Alterations and Additions

Certificate number: A415474\_04

This certificate confirms that the proposed development will meet the NSW government's requirements for sustainability, if it is built in accordance with the commitments set out below. Terms used in this certificate, or in the commitments, have the meaning given by the document entitled "BASIX Alterations and Additions Definitions" dated 06/10/2017 published by the Department. This document is available at www.basix.nsw.gov.au

Secretary
Date of issue: Thursday, 19, May 2022
To be valid, this certificate must be lodged within 3 months of the date of issue.



Project name	0780_22 ALKIRA CIRCUIT, NARRAWEENA_04
Street address	22 ALKIRA CIRCUIT NARRAWEENA 2099
Local Government Area	Northern Beaches Council
Plan type and number	Deposited Plan 226052
Lot number	37
Section number	
Project type	
Dwelling type	Separate dwelling house
Type of alteration and addition	My renovation work is valued at \$50,000 or mor and does not include a pool (and/or spa).

Certificate Prepared by (please complete before submitting to Council or PCA)
Name / Company Name: Action Plans
ABN (if applicable): 17118297587

Fixtures and systems	Show on DA Plans	Show on CC/CDC Plans & specs	Certifier Check
Lighting			
The applicant must ensure a minimum of 40% of new or altered light fixtures are fitted with fluorescent, compact fluorescent, or light-emitting-diode (LED) lamps.		<b>✓</b>	<b>~</b>
Fixtures			
The applicant must ensure new or altered showerheads have a flow rate no greater than 9 litres per minute or a 3 star water rating.		✓	✓
The applicant must ensure new or altered toilets have a flow rate no greater than 4 litres per average flush or a minimum 3 star water rating.		~	~
The applicant must ensure new or altered taps have a flow rate no greater than 9 litres per minute or minimum 3 star water rating.		✓	

Construction	Show on DA Plans	Show on CC/CDC Plans & specs	Certifier Check		
nsulation requirements					
The applicant must construct the new or altere the table below, except that a) additional insul- is not required for parts of altered construction	<b>~</b>	<b>~</b>	<b>~</b>		
floor above existing dwelling or building.	Additional insulation required (R-value)	Other specifications			
floor above existing awening or building.	1111				
external wall: framed (weatherboard, fibro, metal clad)	R1.30 (or R1.70 including construction)				
	ceiling: R0.95 (up), roof: foil backed blanket	medium (solar absorptance 0.475 - 0.70)			

Glazing requ	irements						Show on DA Plans	Show on CC/CDC Plans & specs	Certifier Check
Windows and	l glazed do	ors							
The applicant must install the windows, glazed doors and shading devices, in accordance with the specifications listed in the table below. Relevant overshadowing specifications must be satisfied for each window and glazed door.								<b>~</b>	~
The following re	equirements	must also	be satisfi	ed in relation	to each window and glazed door:			~	~
have a U-value	and a Solar	Heat Gair	n Coefficie	ent (SHGC) n		d glass may either match the description, or, e below. Total system U-values and SHGCs		<b>✓</b>	<b>✓</b>
have a U-value must be calcula	and a Solar ated in accor	Heat Gair dance with	n Coefficie n National	ent (SHGC) n Fenestration	o greater than that listed in the tabl	ar glazing, or toned/air gap/clear glazing must e below. Total system U-values and SHGCs . The description is provided for information		~	<b>✓</b>
					each eave, pergola, verandah, baldhan 2400 mm above the sill.	cony or awning must be no more than 500 mm	✓	<b>✓</b>	<b>✓</b>
Pergolas with polycarbonate roof or similar translucent material must have a shading coefficient of less than 0.35.								✓	✓
Pergolas with fixed battens must have battens parallel to the window or glazed door above which they are situated, unless the pergola also shades a perpendicular window. The spacing between battens must not be more than 50 mm.								✓	✓
Overshadowing buildings or vegetation must be of the height and distance from the centre and the base of the window and glazed door, as specified in the 'overshadowing' column in the table below.							✓	✓	✓
Windows ar	nd glazed	doors g	lazing r	equiremer	nts				
Window / door	Orientation		Oversha	dowing	Shading device	Frame and glass type			
no.		glass inc. frame (m2)	Height (m)	Distance (m)					
W01	W	2.1	0	0	eave/verandah/pergola/balcony >=900 mm	standard aluminium, single clear, (or U-value: 7.63, SHGC: 0.75)			
W02	W	4.15	0	0	eave/verandah/pergola/balcony >=900 mm	standard aluminium, single clear, (or U-value: 7.63, SHGC: 0.75)			

Glazing requ	irements						Show on DA Plans	Show on CC/CDC Plans & specs	Certifier Check
Window / door no.	Orientation	glass inc. frame	Oversha Height (m)	Distance (m)	Shading device	Frame and glass type			
W03	W	(m2) 1.55	0	0	eave/verandah/pergola/balcony >=900 mm	standard aluminium, single clear, (or U-value: 7.63, SHGC: 0.75)			
W04	N	0.55	0	0	eave/verandah/pergola/balcony >=900 mm	standard aluminium, single clear, (or U-value: 7.63, SHGC: 0.75)			
W05	E	1.95	1.3	1.9	eave/verandah/pergola/balcony >=450 mm	standard aluminium, single clear, (or U-value: 7.63, SHGC: 0.75)			
W06	S	1.29	0	0	eave/verandah/pergola/balcony >=600 mm	standard aluminium, single clear, (or U-value: 7.63, SHGC: 0.75)			
W07	S	1.29	0	0	eave/verandah/pergola/balcony >=600 mm	standard aluminium, single clear, (or U-value: 7.63, SHGC: 0.75)			
W08	W	1.62	0	0	eave/verandah/pergola/balcony >=600 mm	improved aluminium, single pyrolytic low-e, (U-value: 4.48, SHGC: 0.46)			
W09	S	1.3	0	0	eave/verandah/pergola/balcony >=900 mm	standard aluminium, single clear, (or U-value: 7.63, SHGC: 0.75)			
W10	W	2.22	0	0	eave/verandah/pergola/balcony >=600 mm	improved aluminium, single pyrolytic low-e, (U-value: 4.48, SHGC: 0.46)			
W11	N	1.3	0	0	eave/verandah/pergola/balcony >=600 mm	standard aluminium, single pyrolytic low-e, (U-value: 5.7, SHGC: 0.47)			
W12	E	2.22	0	0	eave/verandah/pergola/balcony >=600 mm	standard aluminium, single pyrolytic low-e, (U-value: 5.7, SHGC: 0.47)			
W13	S	1.3	0	0	eave/verandah/pergola/balcony >=900 mm	standard aluminium, single clear, (or U-value: 7.63, SHGC: 0.75)			
W14	E	1.62	0	0	eave/verandah/pergola/balcony >=600 mm	standard aluminium, single pyrolytic low-e, (U-value: 5.7, SHGC: 0.47)			
D02	W	0.39	0	0	eave/verandah/pergola/balcony >=900 mm	standard aluminium, single clear, (or U-value: 7.63, SHGC: 0.75)			

Glazing requirements								Show on CC/CDC Plans & specs	Certifier Check
Window / door no.	Orientation	Area of glass inc. frame (m2)	Oversha Height (m)	Distance (m)	Shading device	Frame and glass type			
D03	N	11.14	0	0	eave/verandah/pergola/balcony >=900 mm	standard aluminium, single clear, (or U-value: 7.63, SHGC: 0.75)			
D04	N	11.36	0	0	eave/verandah/pergola/balcony >=900 mm	standard aluminium, single clear, (or U-value: 7.63, SHGC: 0.75)			

Legend
In these commitments, "applicant" means the person carrying out the development.
Commitments identified with a "\" in the "Show on DA plans" column must be shown on the plans accompanying the development application for the proposed development (if a development application is to be lodged for the proposed development).

Commitments identified with a "\script\*" in the "Show on CC/CDC plans & specs" column must be shown in the plans and specifications accompanying the application for a construction certificate / complying development certificate for the proposed development.

Commitments identified with a "\square" in the "Certifier check" column must be certified by a certifying authority as having been fulfilled, before a final occupation certificate for the development may be issued.

ACTION PLANS
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	REV.	DATE	COMMENTS	DRWN
	А	23052022	DA: REV A	RNA
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whole with the written permission of Action Plans.	_
Do not scale measure from drawings. Figured dimensions are to be used only.	٤
The Builder/Contractor shall check and verify all levels and dimensions on site prior to commencement of any work, creation of shop	H
 drawings, or fabrication of components.	
All errors and omissions are to be verified by the Builder/Contractor and referred to the designer prior to the commencement of works.	

All errors and omissions are to be verified by the Builder/Contractor and referred to the designer prior to the commencement of works All window & door dimensions, orientation, glazing materials, opening types, frame types are to be confirmed by a suitably qualified person prior to the ordering of any such materials are to take place.

U value takes precedence over glazing type/colour in all cases.

all new glazing must meet the BASIX specified frame and glass type, <u>OR</u> meet the ecified U value and SHGC value.

CLIENT

SHELDON & MONICA HATZANTONIS

PROJECT ADDRESS 22 ALKIRA CIRCUIT, NARRAWEENA NSW 2099 DRAWING NO.

**DA20** 

DATE Monday, 23 May 2022 **DRAWING NAME**BASIX COMMITMENTS