

DEVELOPMENT APPLICATION (REV C)

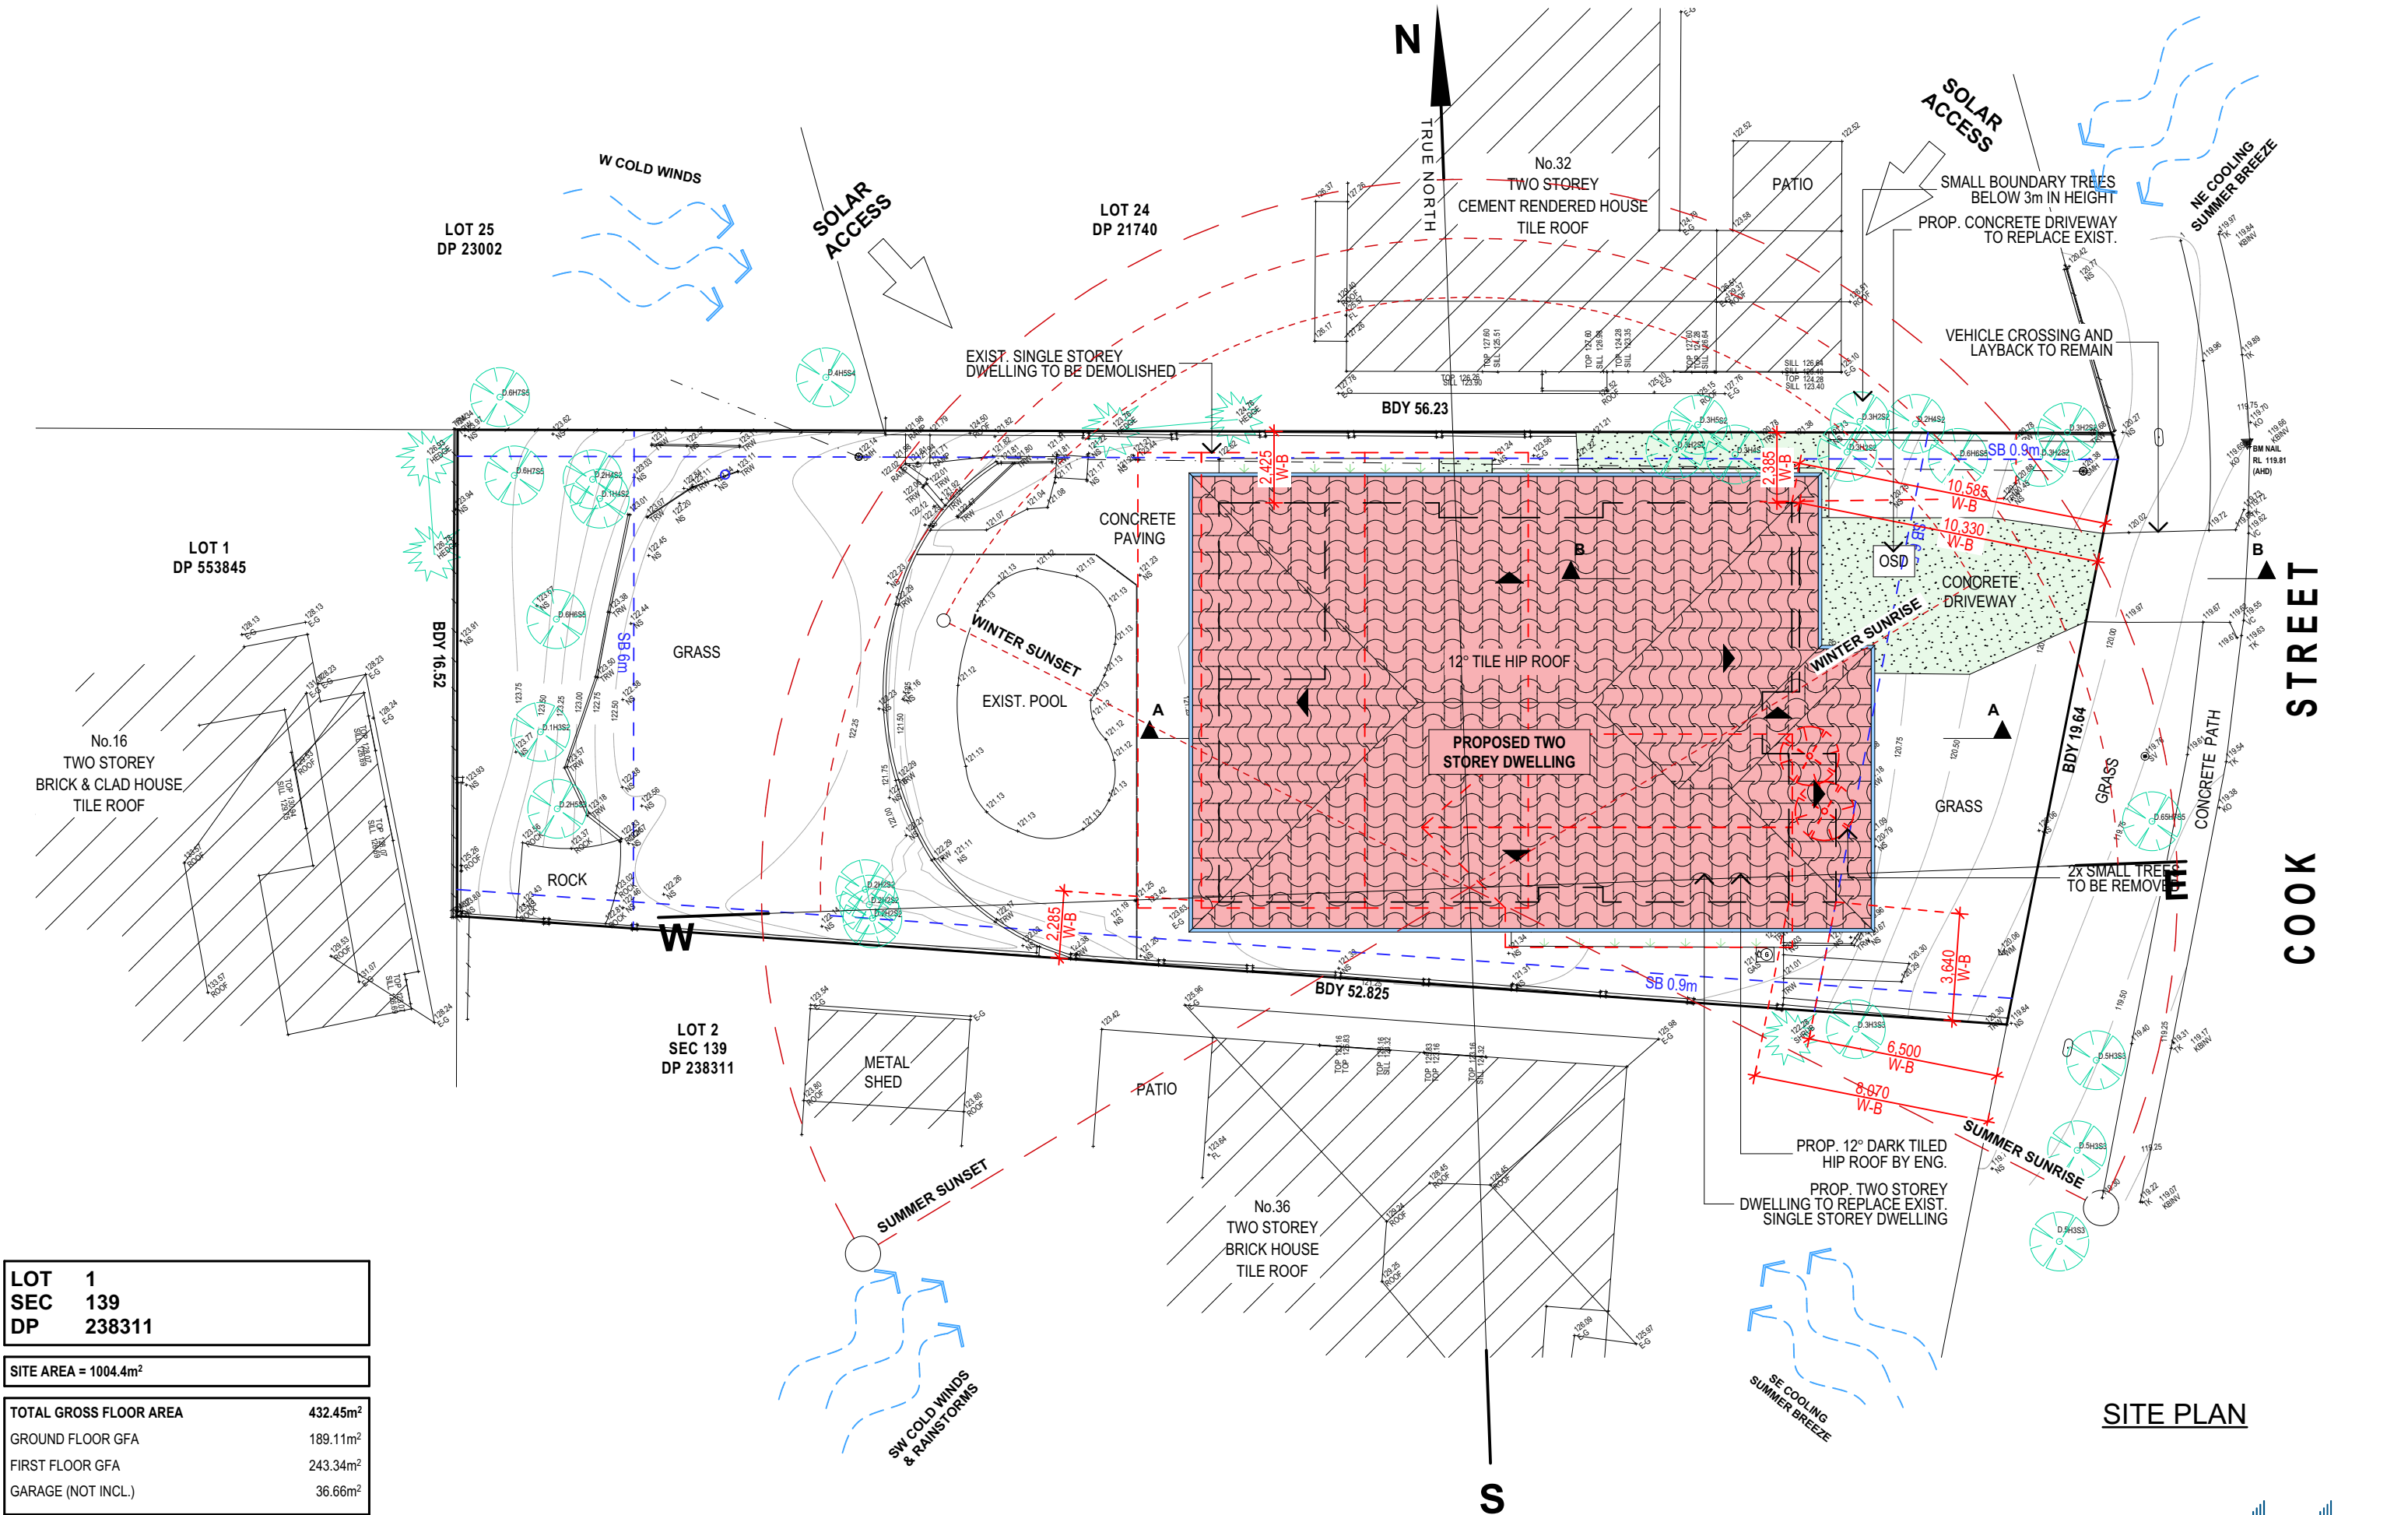
34 COOK STREET, FORESTVILLE



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DA.16	OPENING SCHEDULE
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**JJ DRAFTING**

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LOT 1	DP 238311
SEC 139	
DP 238311	
SITE AREA = 1004.4m ²	
TOTAL GROSS FLOOR AREA	432.45m ²
GROUND FLOOR GFA	189.11m ²
FIRST FLOOR GFA	243.34m ²
GARAGE (NOT INCL.)	36.66m ²

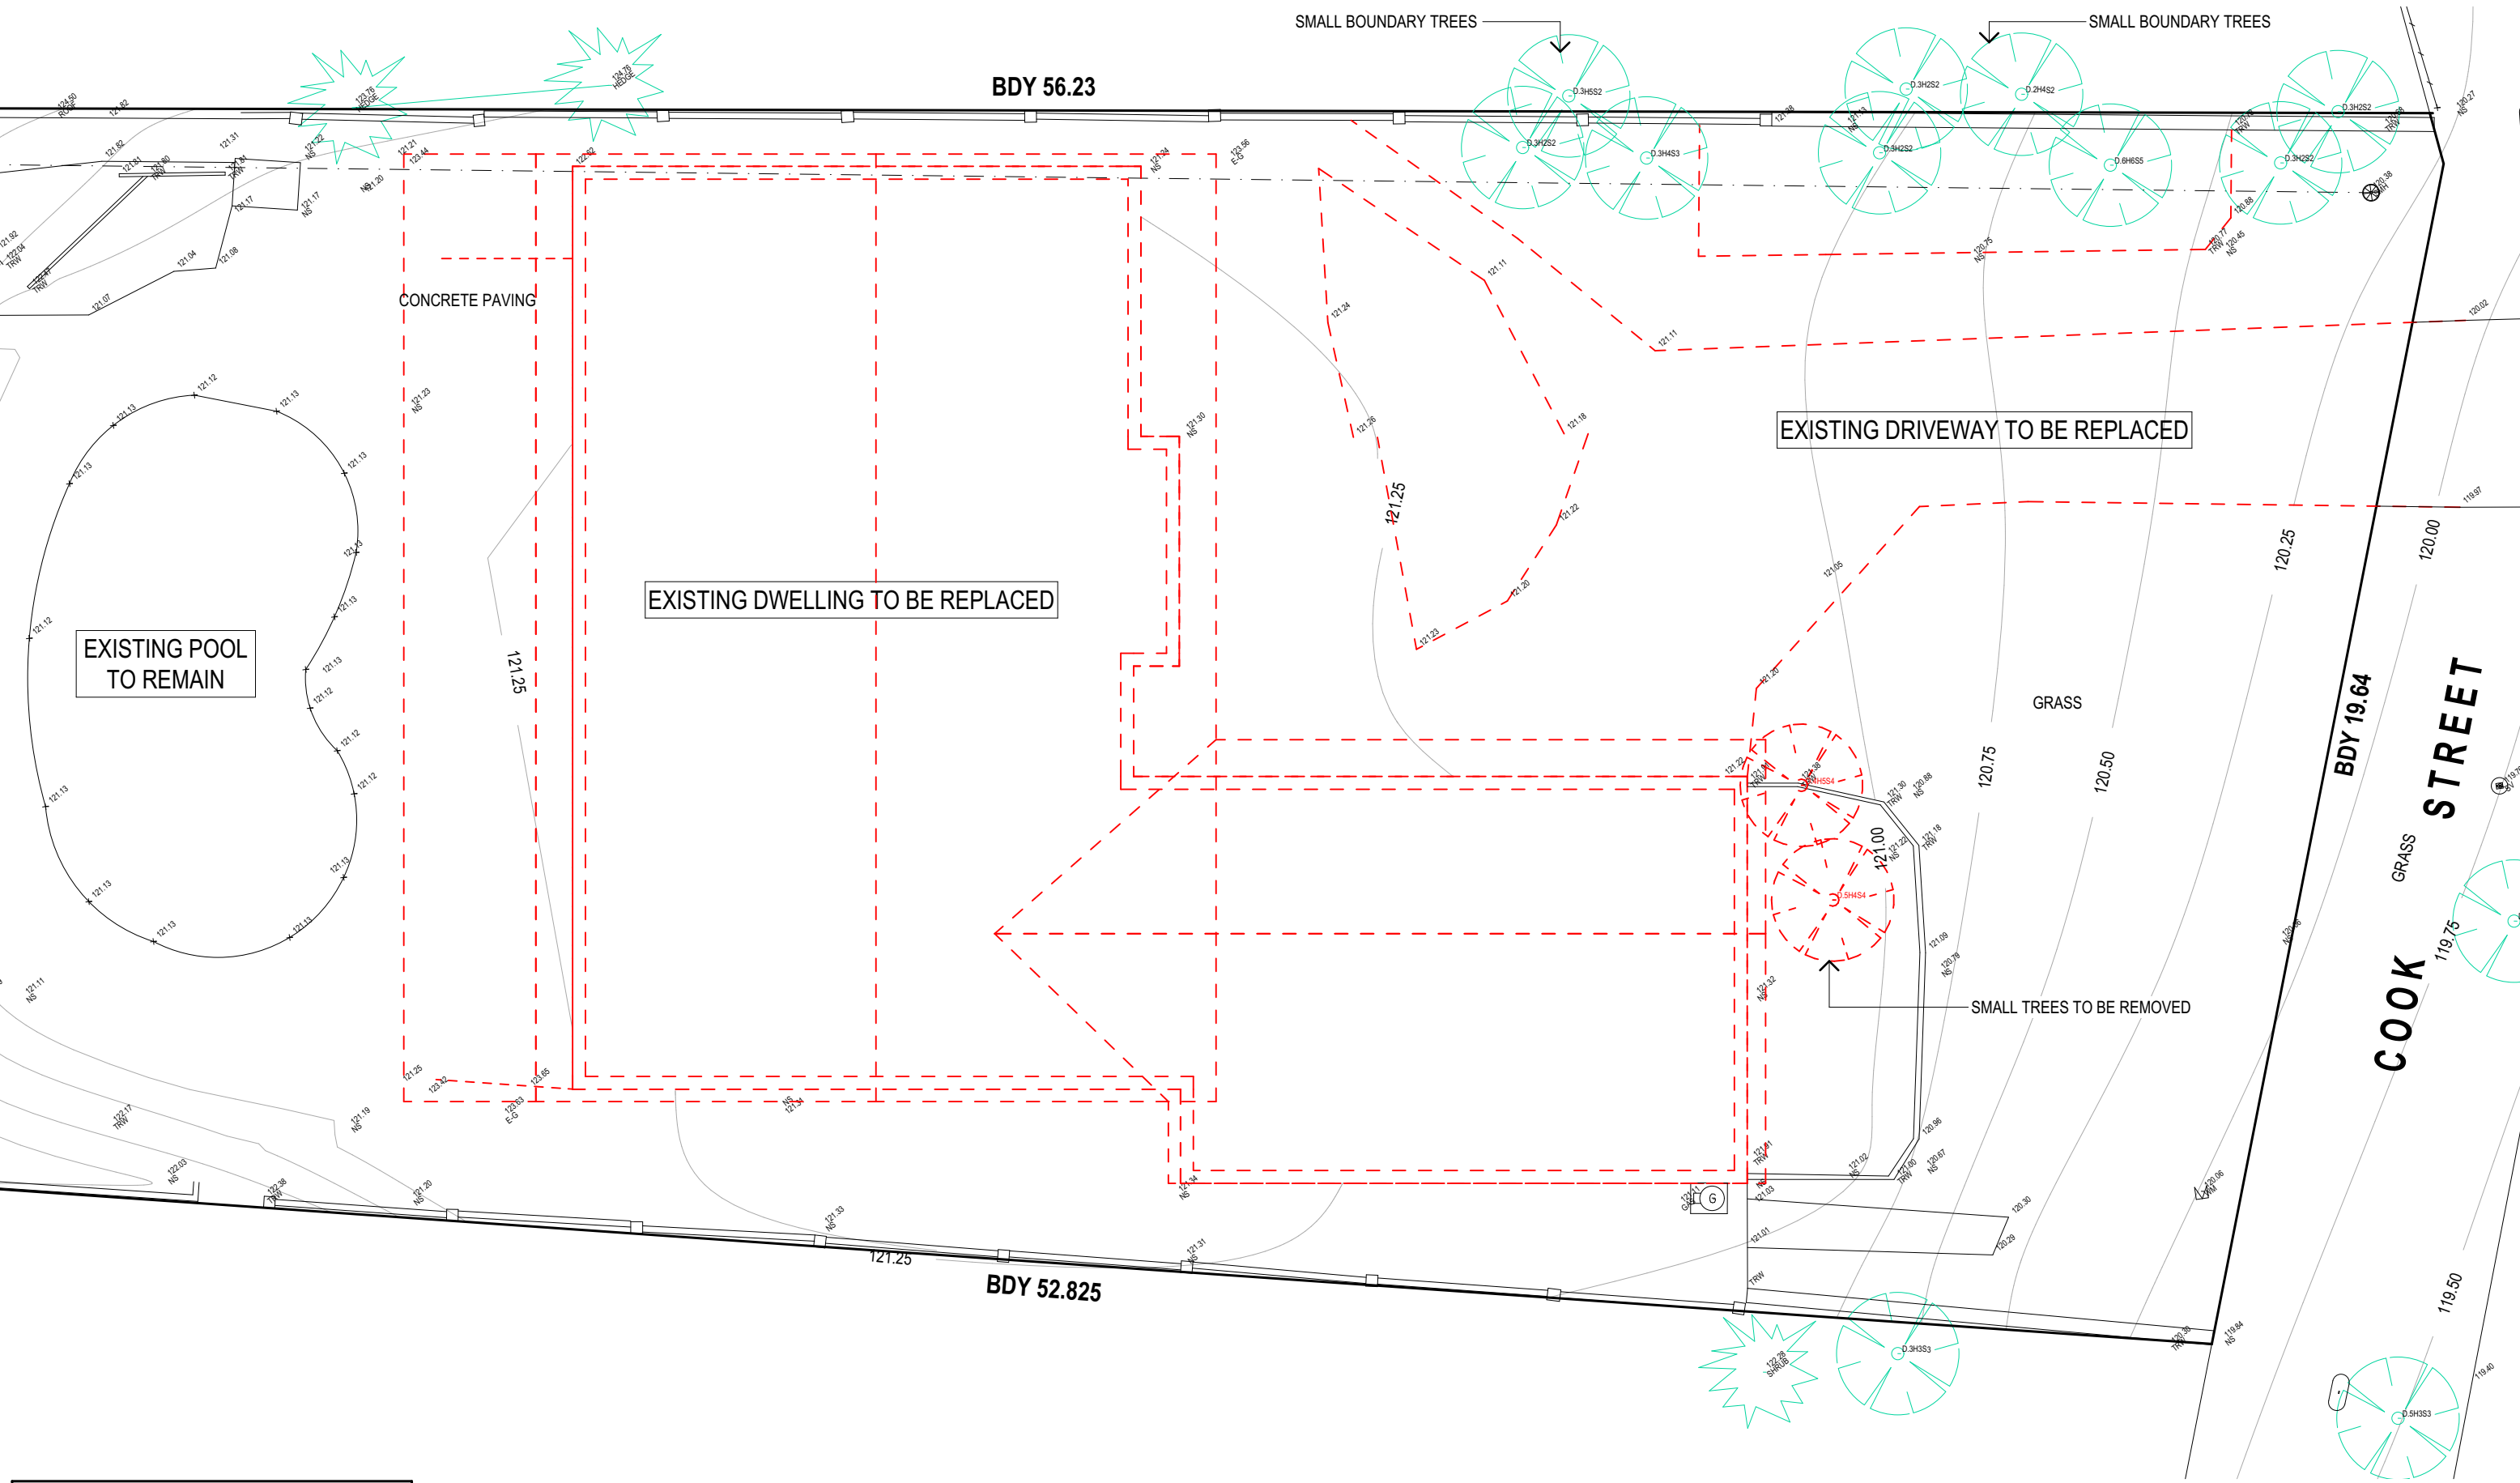
TRUE NORTH:	NOTES (E & OE) <ul style="list-style-type: none">• All structures including stormwater & drainage to engineer's details.• Do not obtain dimensions by scaling drawings.• All dimensions are to be checked on site prior to starting work.• These drawings are to be read in conjunction with all other consultant's drawings and specifications.• All workmanship & materials shall be in accordance with the requirements of current editions including amendments of the National Construction Code, relevant Australian Standards & local council requirements.• New materials are to be used throughout unless otherwise noted.• Concrete footings, slab, structural beams or any other structural members are to be designed by a practicing engineer.
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JJ Drafting Australia P/L.
26/90 Mona Vale Road, Mona Vale, NSW, 2103
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Email. enquiries@jjdrafting.com.au
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REV:	DATE:	DESCRIPTION:
(A)	11/9/2024	PRELIM. DESIGN - FLOOR PLANS
(B)	1/10/2024	PRELIM. REVISION
(C)	30/10/2024	PRELIM. REVISION
A	9/12/2024	DA DRAWINGS
B	8/1/2025	DA DRAWINGS (ADD NATHERS)
C	20/3/2025	DA DRAWING AMENDMENTS

PROPOSED NEW BUILD 34 COOK STREET, FORESTVILLE CLIENT: ANTONIO + AMANDA PETROLO	JOB No: 1289/24
DRAWING TITLE: SITE ANALYSIS PLAN	

DRAWN BY: AD	SCALE: 1:200 @ A3	bdaa ACCREDITED BUILDING DESIGNER
DATE: AUG/24	DRAWING No: DA.01	
CHECKED BY: JJ		



NOTES

ALL DEMOLITION WORK TO COMPLY WITH AS 2601 & SAFE WORK AUSTRALIA CODE OF PRACTICE.

GROUND FLOOR DEMOLITION PLAN

TRUE NORTH:

NOTES (E & OE)

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PROPOSED NEW BUILD

34 COOK STREET, FORESTVILLE

CLIENT:

ANTONIO + AMANDA PETROLO

DRAWING TITLE:

DEMOLITION PLAN

JOB No:

1289/24

DRAWN BY:

AD

DATE:

AUG/24

SCALE:

1:100 @ A3

DRAWING No:

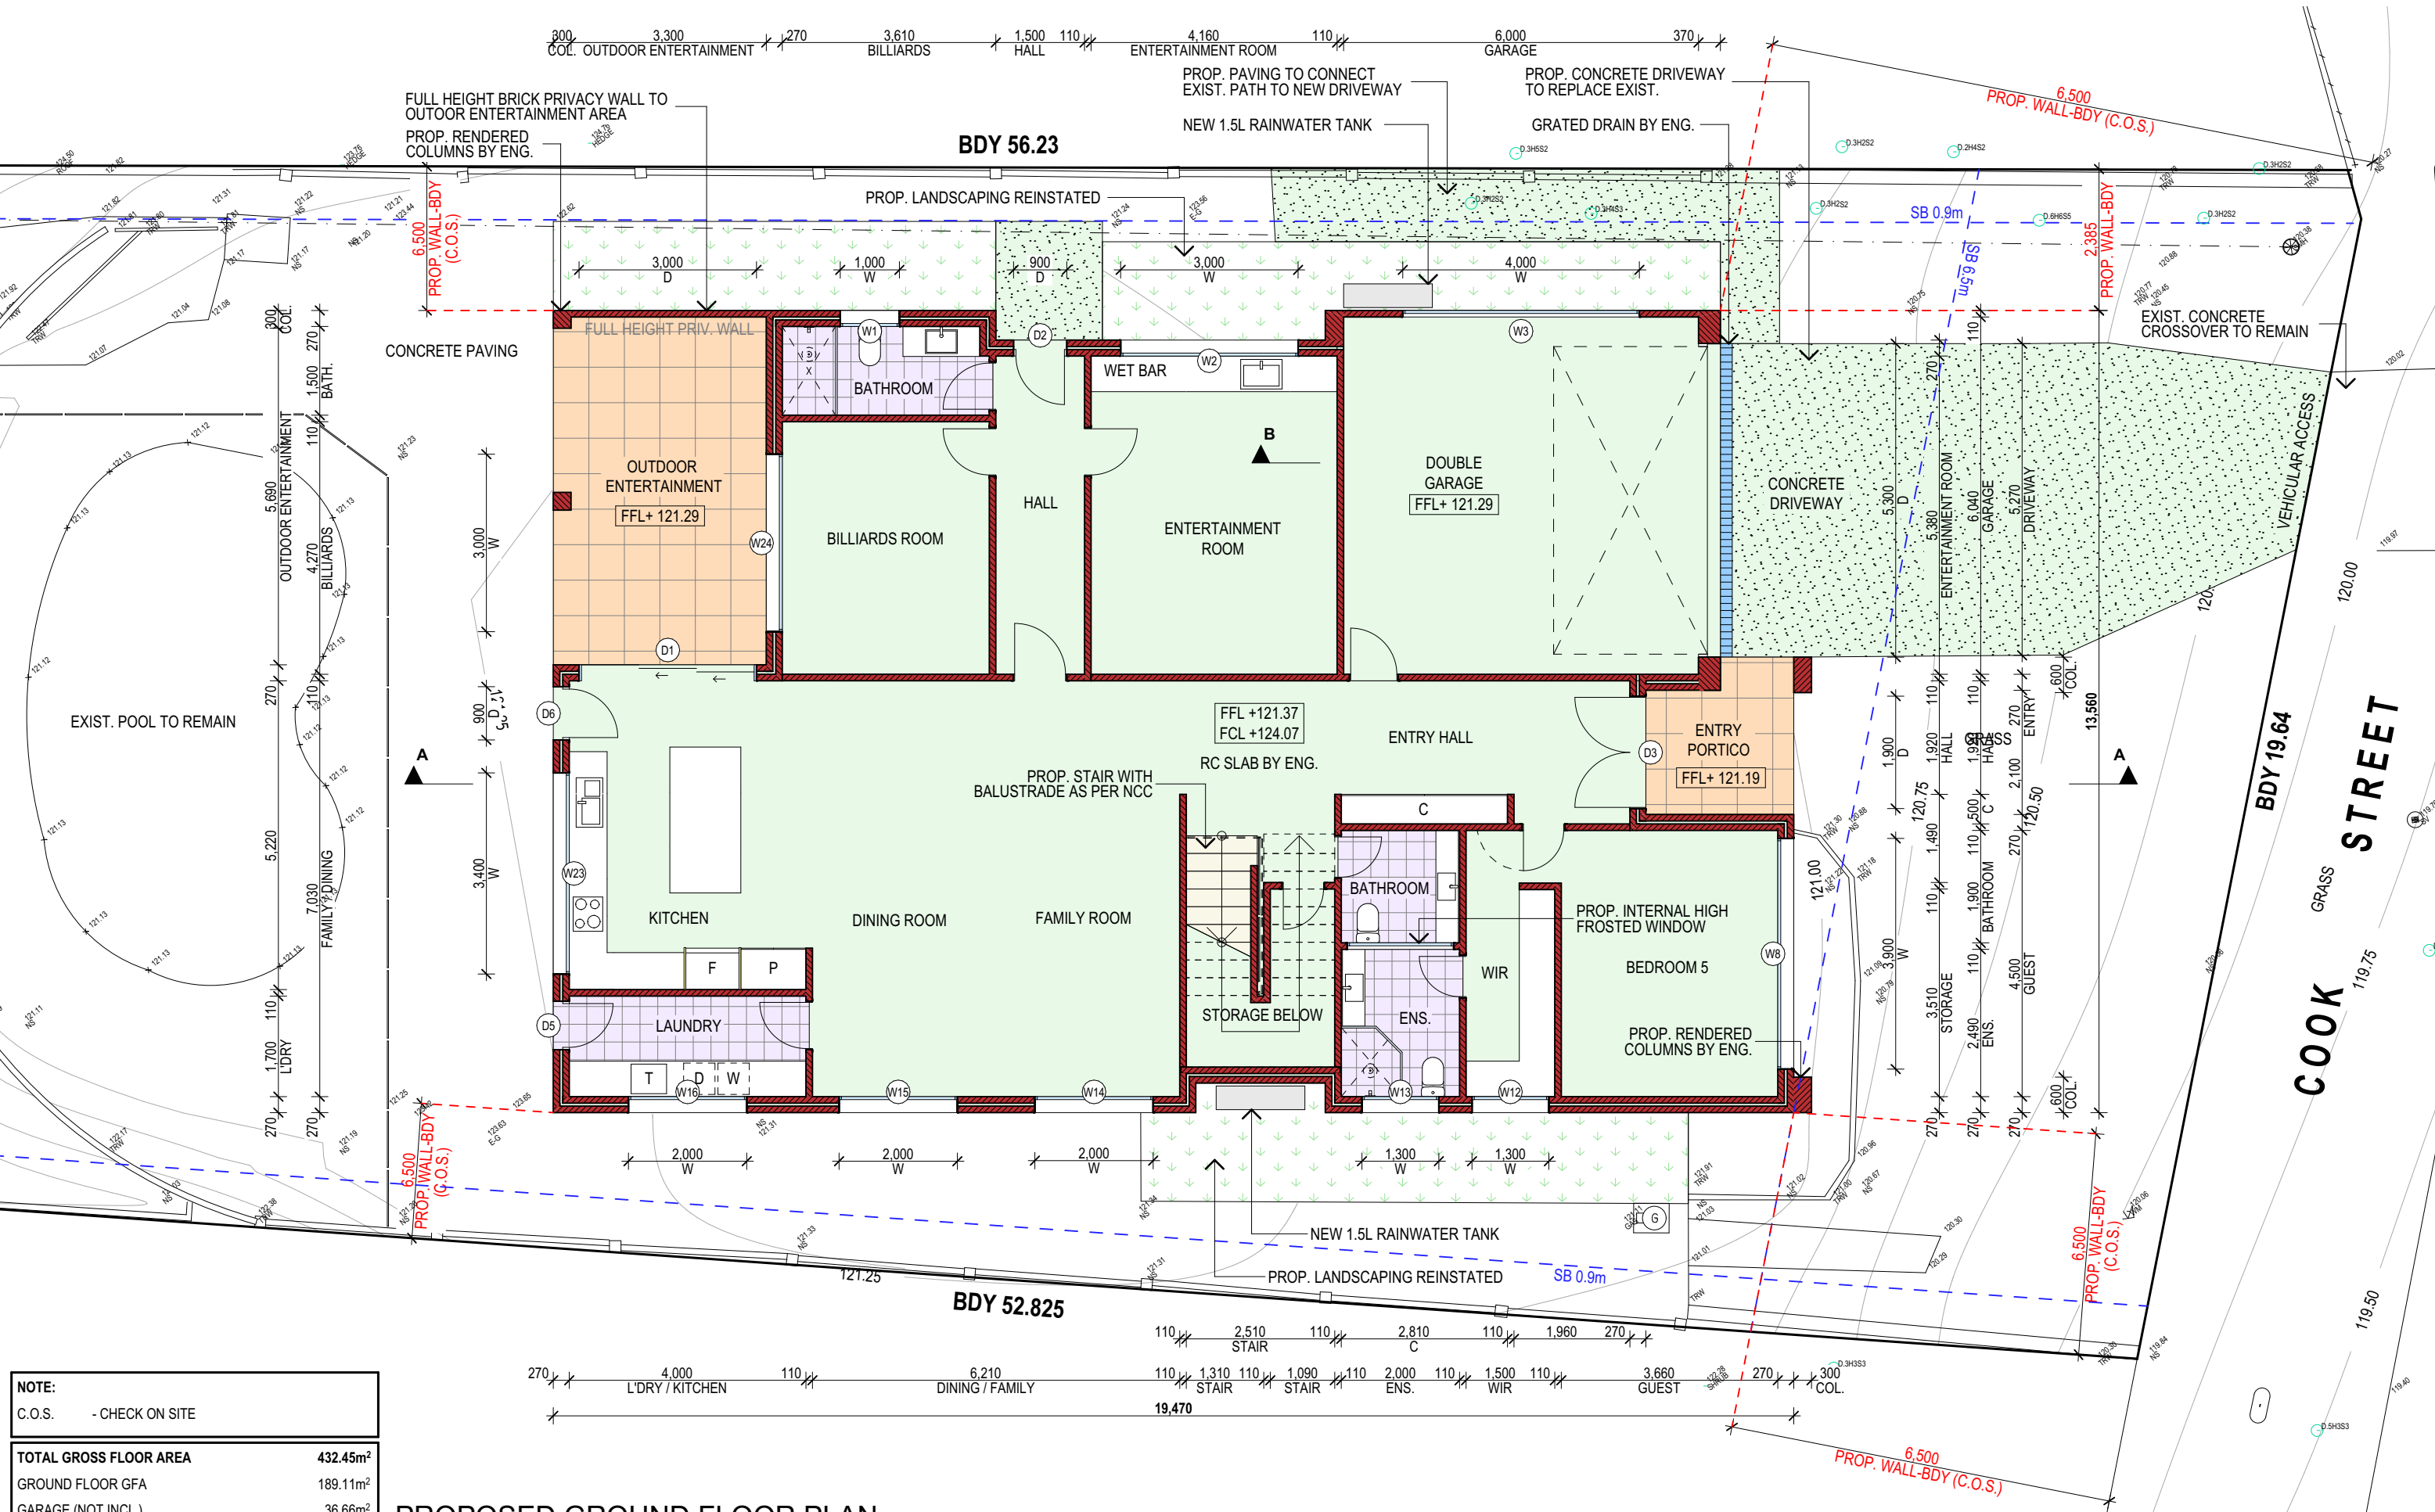
DA.02

CHECKED BY:

JJ

bdac

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NOTE:	
C.O.S.	- CHECK ON SITE
TOTAL GROSS FLOOR AREA	
GROUND FLOOR GFA	432.45m ²
GARAGE (NOT INCL.)	189.11m ²
	36.66m ²

PROPOSED GROUND FLOOR PLAN

TRUE NORTH:

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PROPOSED NEW BUILD
34 COOK STREET, FORESTVILLE
CLIENT:
ANTONIO + AMANDA PETROLO

DRAWING TITLE:
FLOOR PLAN

JOB No:
1289/24

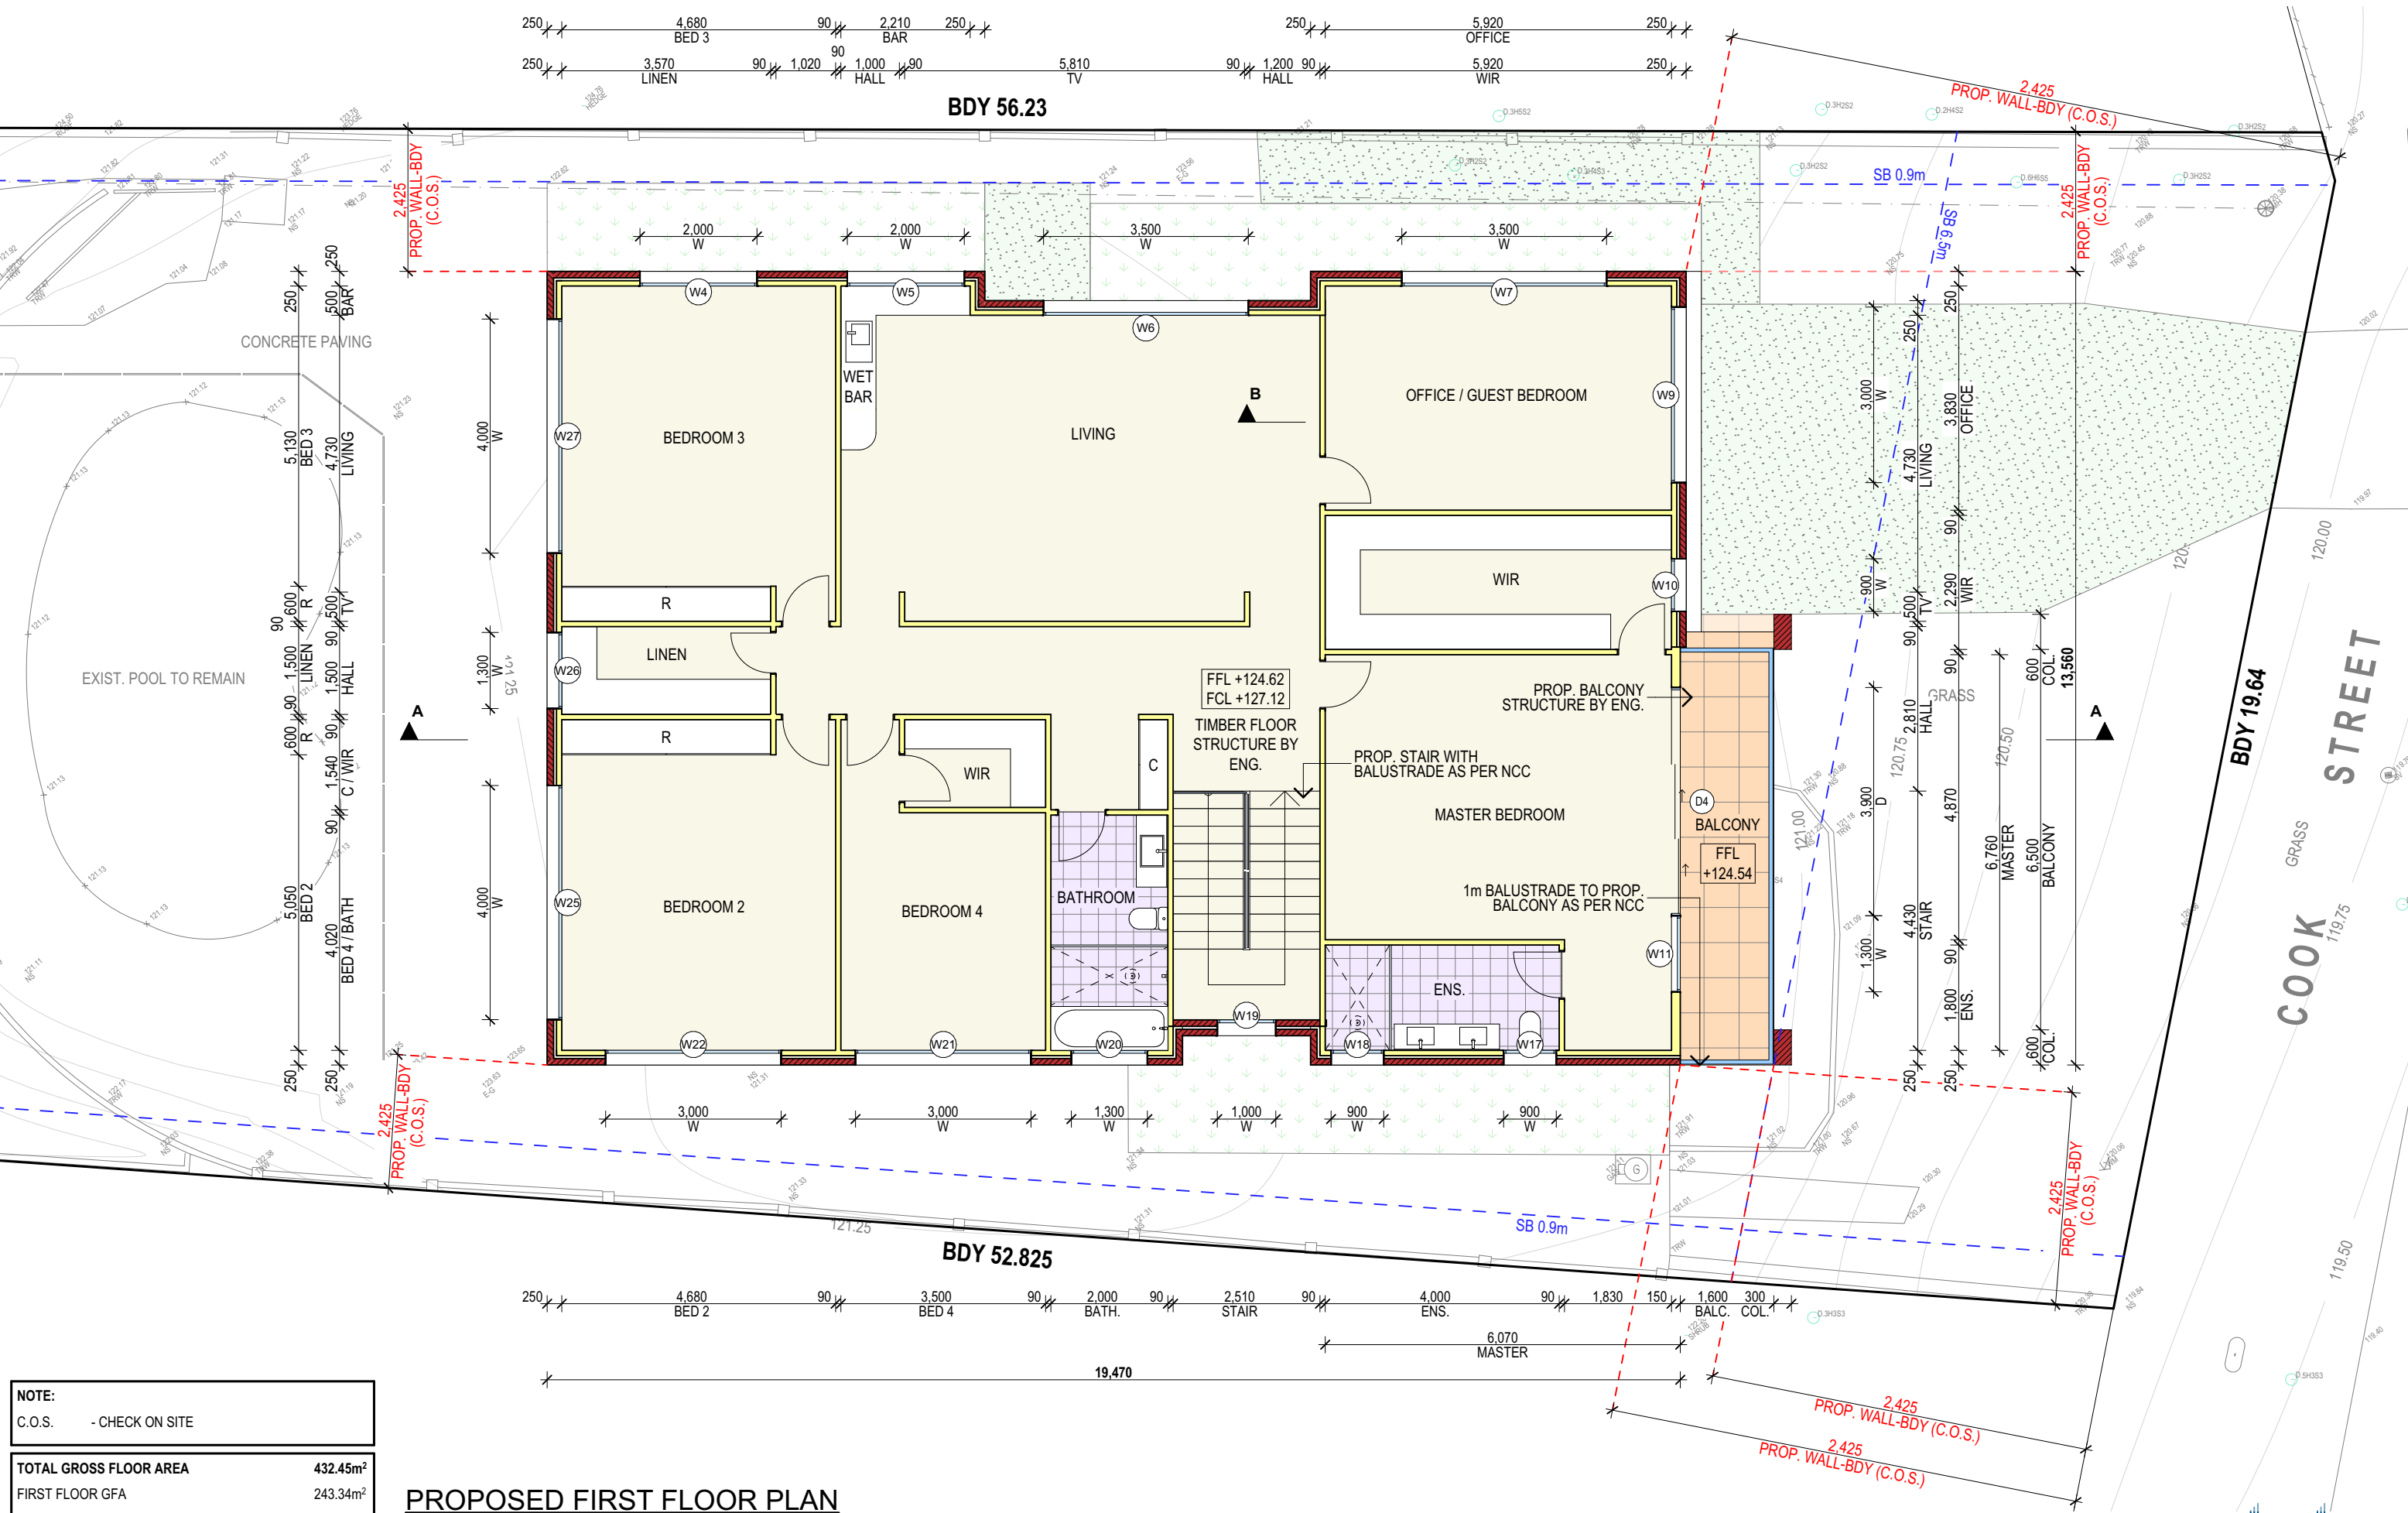
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DA.03

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JJ



NOTE: C.O.S. - CHECK ON SITE	
TOTAL GROSS FLOOR AREA	432.45m ²
FIRST FLOOR GFA	243.34m ²

PROPOSED FIRST FLOOR PLAN

TRUE NORTH:

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34 COOK STREET, FORESTVILLE
CLIENT:
ANTONIO + AMANDA PETROLO

DRAWING TITLE:
FLOOR PLAN

JOB No:
1289/24

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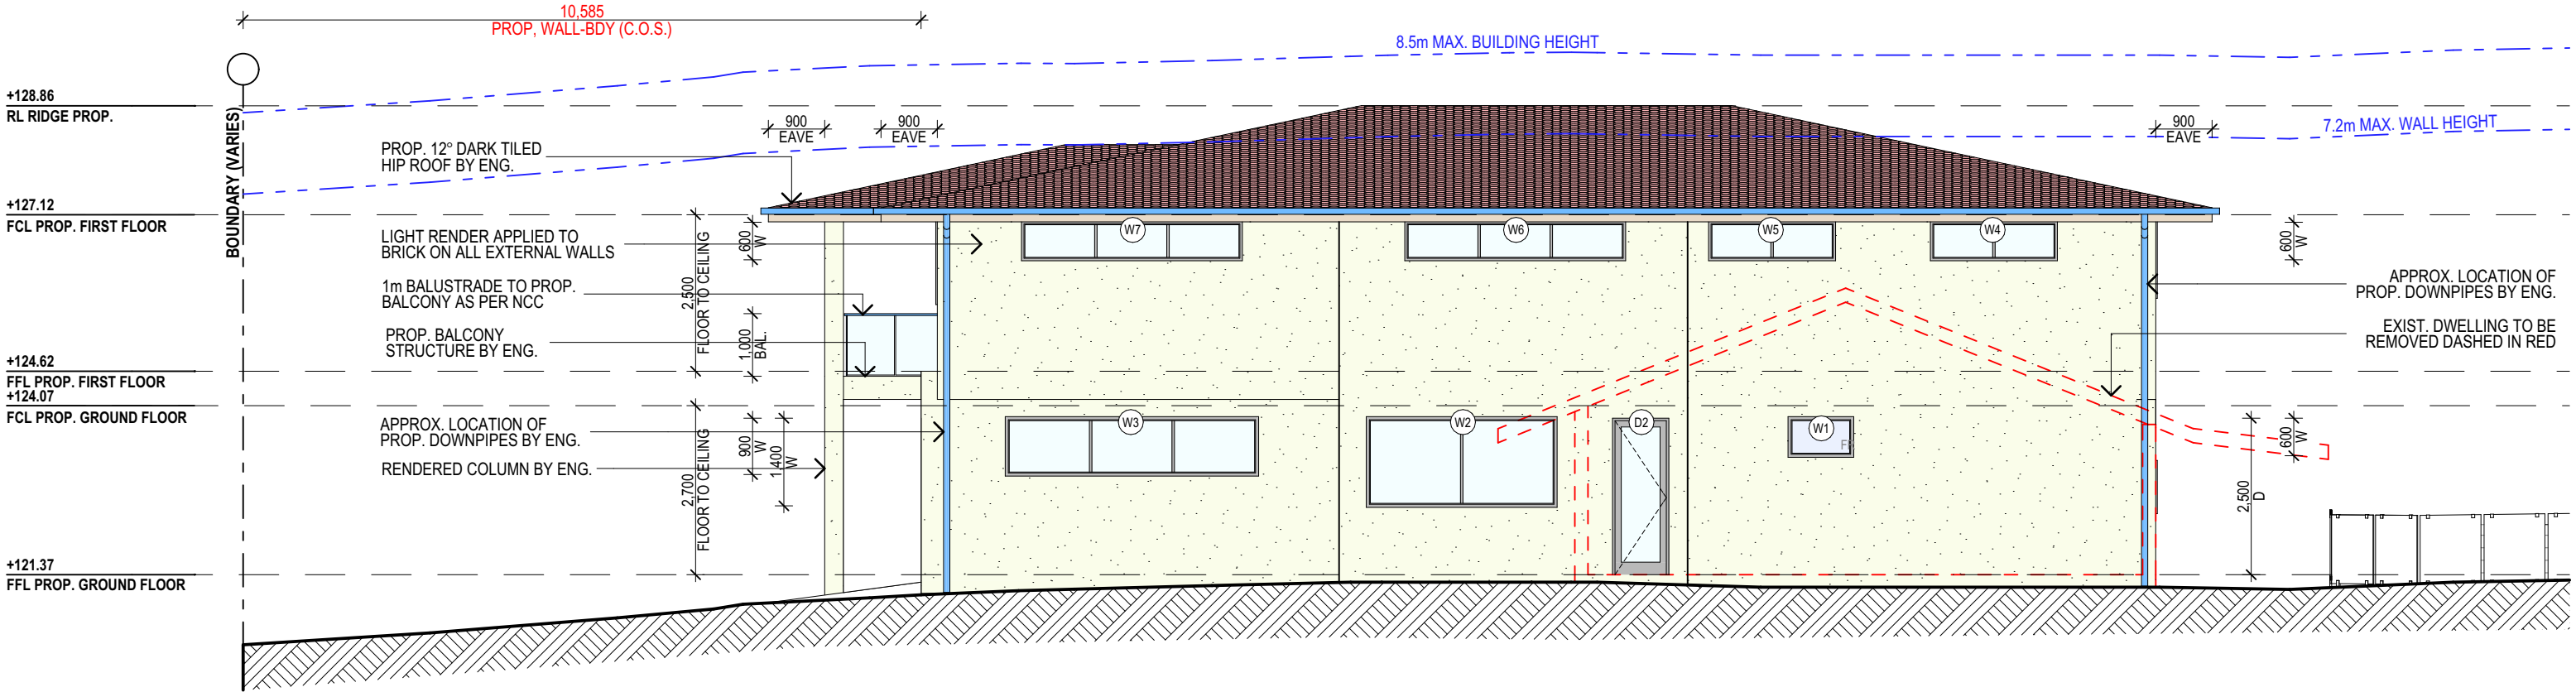
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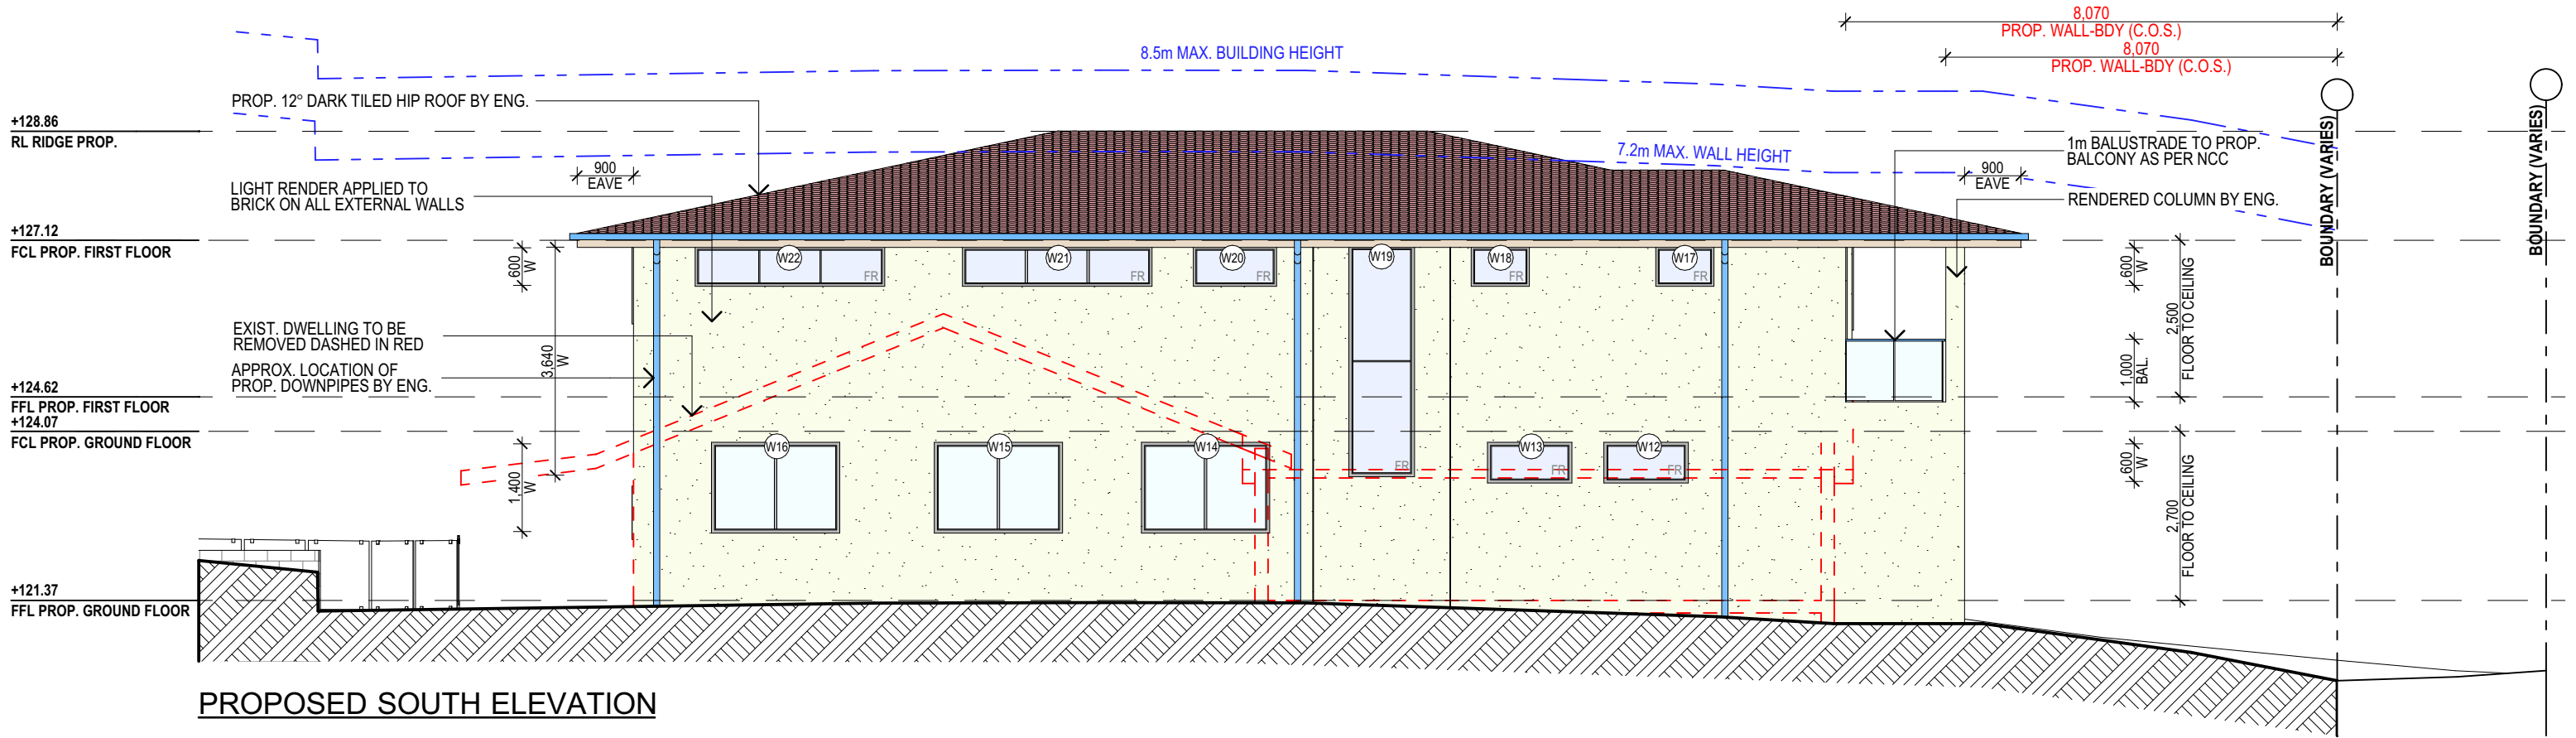
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JJ



PROPOSED NORTH ELEVATION



PROPOSED SOUTH ELEVATION

NOTE:
C.O.S. - CHECK ON SITE

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PROPOSED NEW BUILD
34 COOK STREET, FORESTVILLE
CLIENT:
ANTONIO + AMANDA PETROLO

DRAWING TITLE:
ELEVATIONS SHEET 1

JOB No:
1289/24

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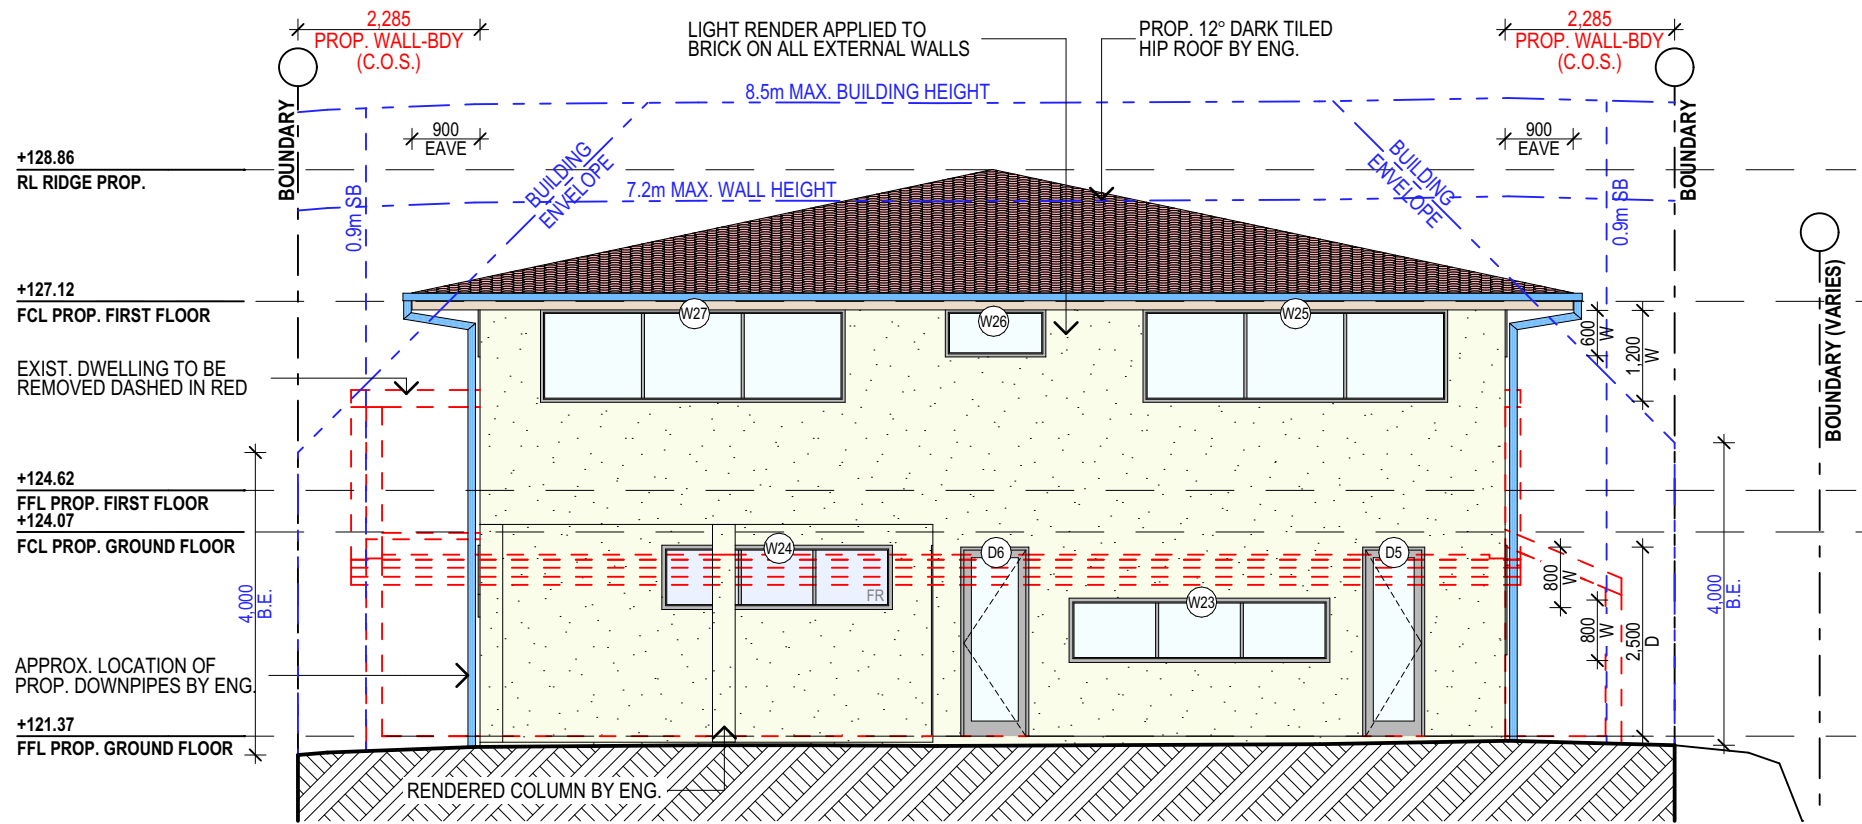
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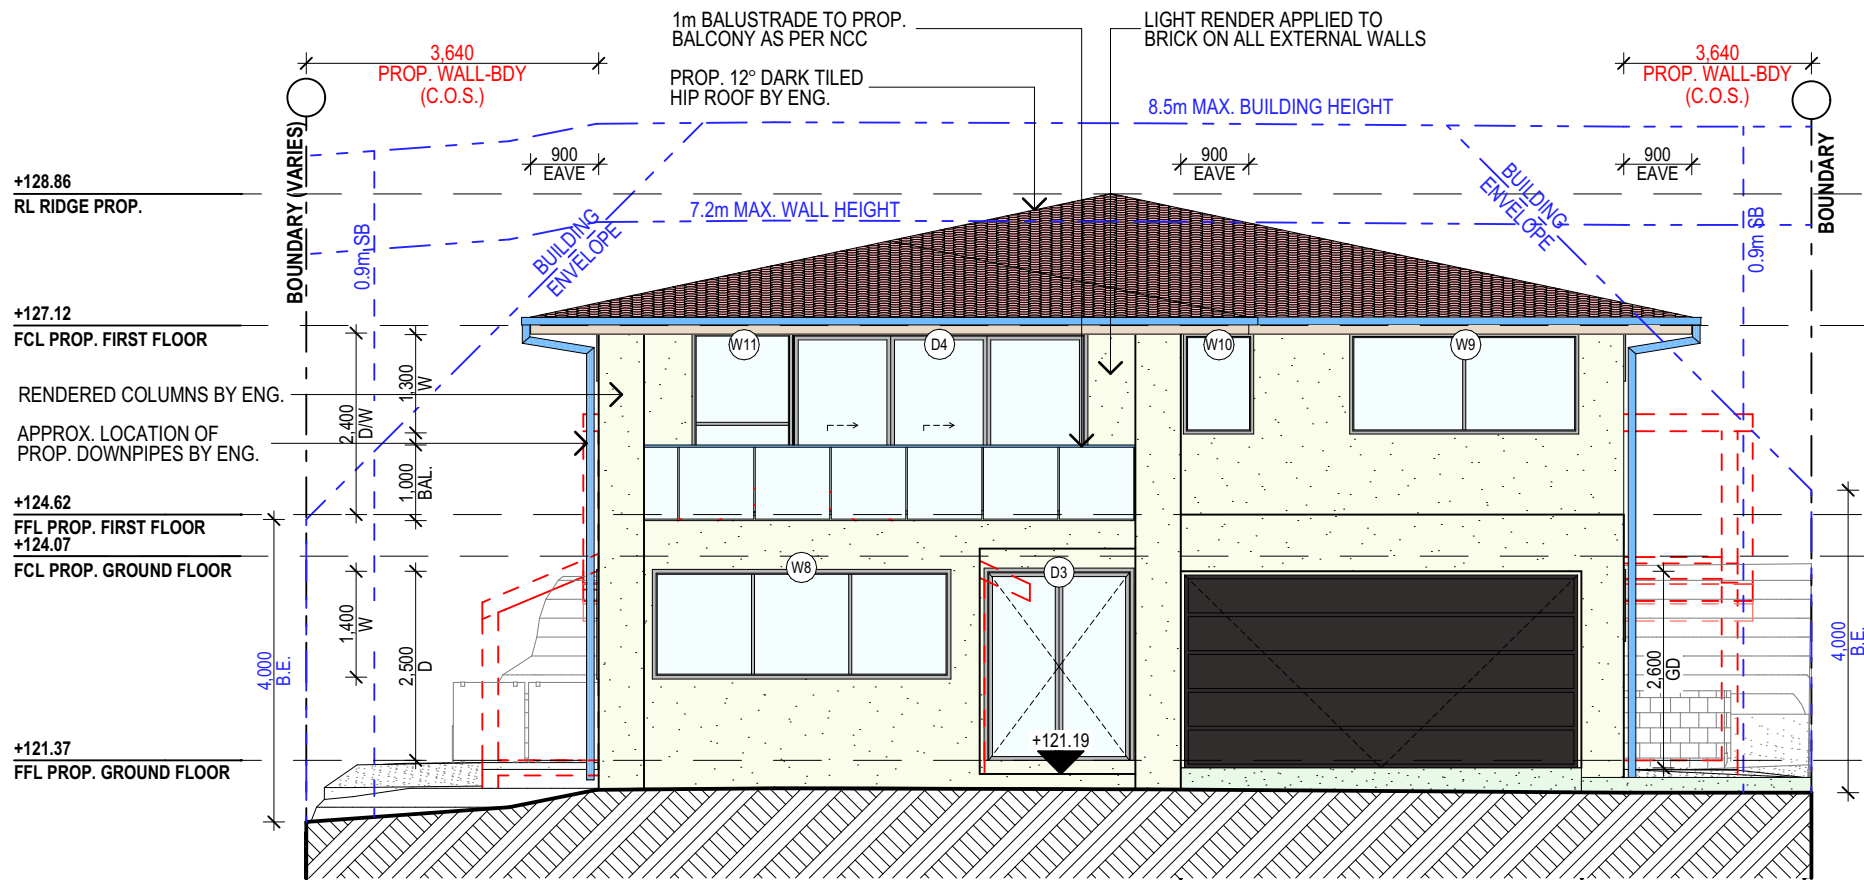
DRAWING No:
DA.05

bdaa
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BUILDING DESIGNER

CHECKED BY:
JJ



PROPOSED WEST ELEVATION



PROPOSED EAST ELEVATION

NOTE:
C.O.S. - CHECK ON SITE

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34 COOK STREET, FORESTVILLE
CLIENT:
ANTONIO + AMANDA PETROLO

DRAWING TITLE:
ELEVATIONS SHEET 2

JOB No:
1289/24

DRAWN BY:
AD

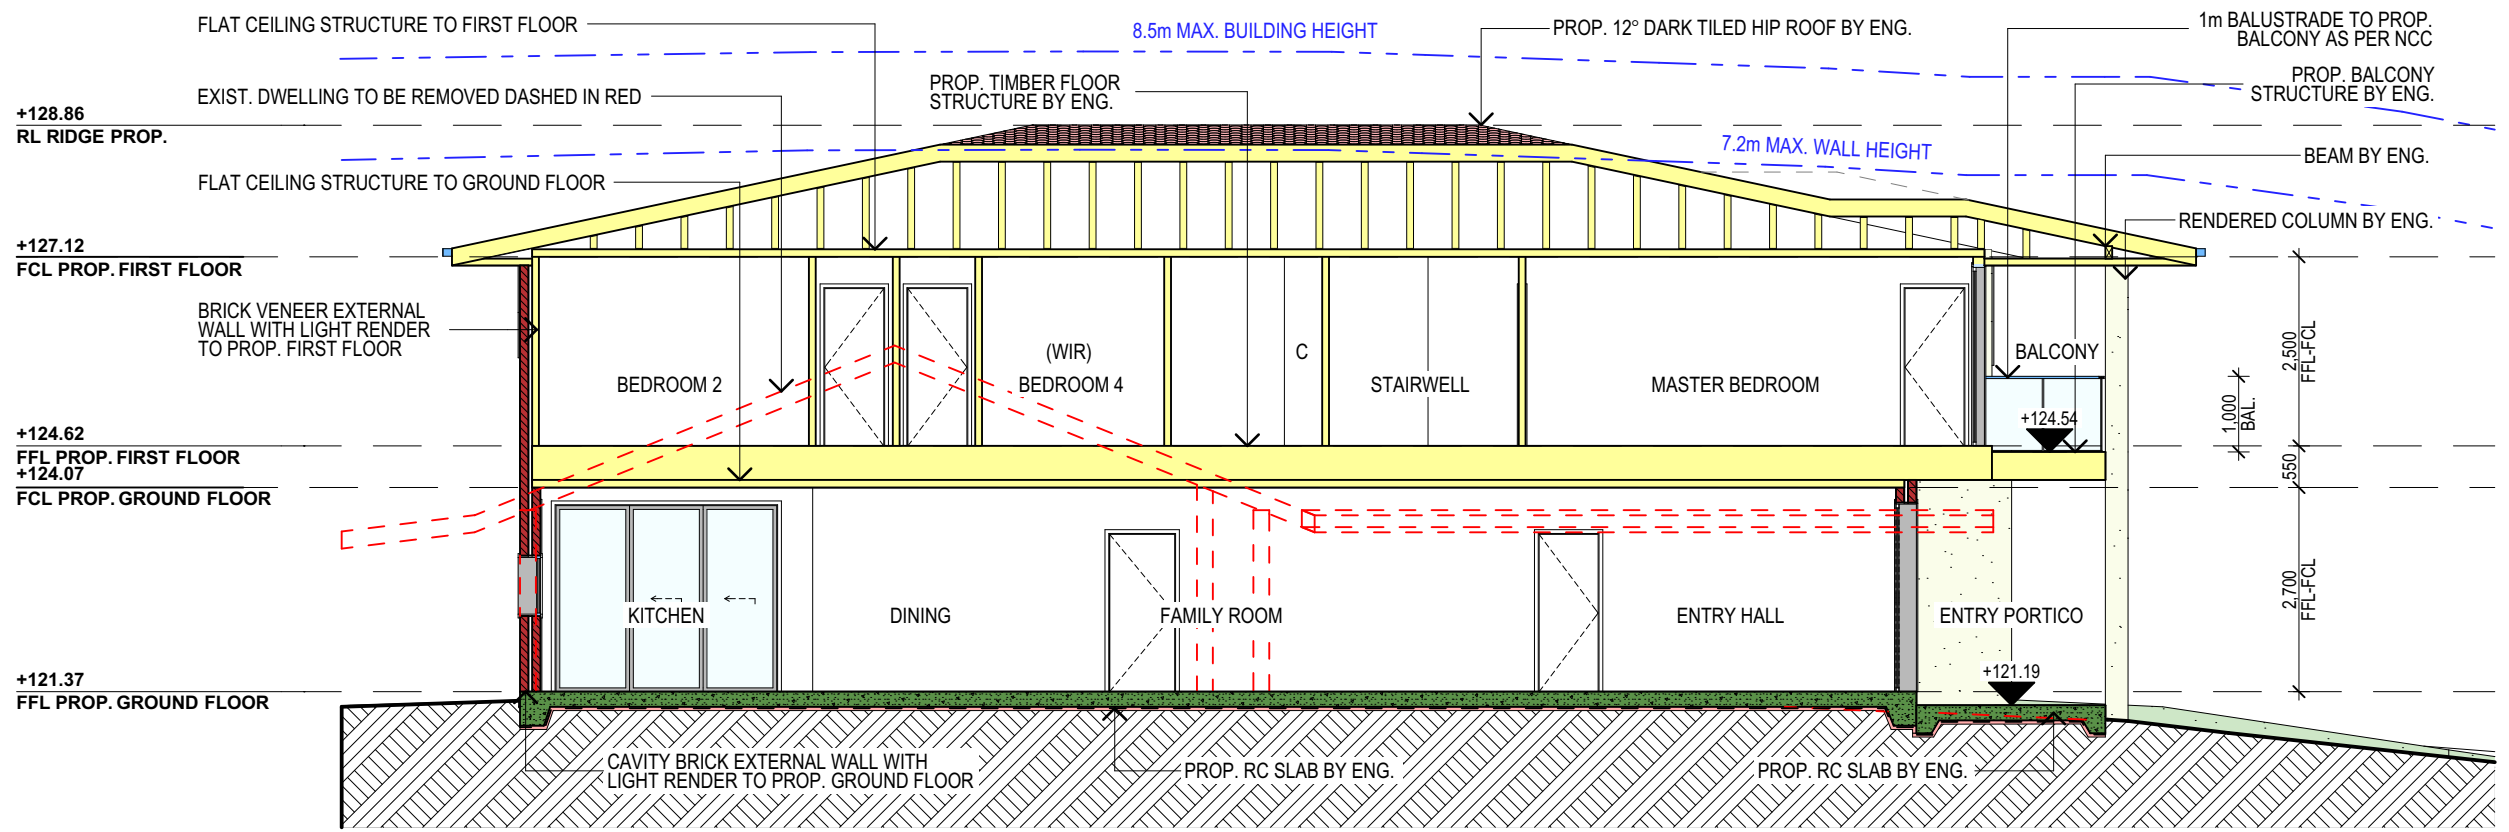
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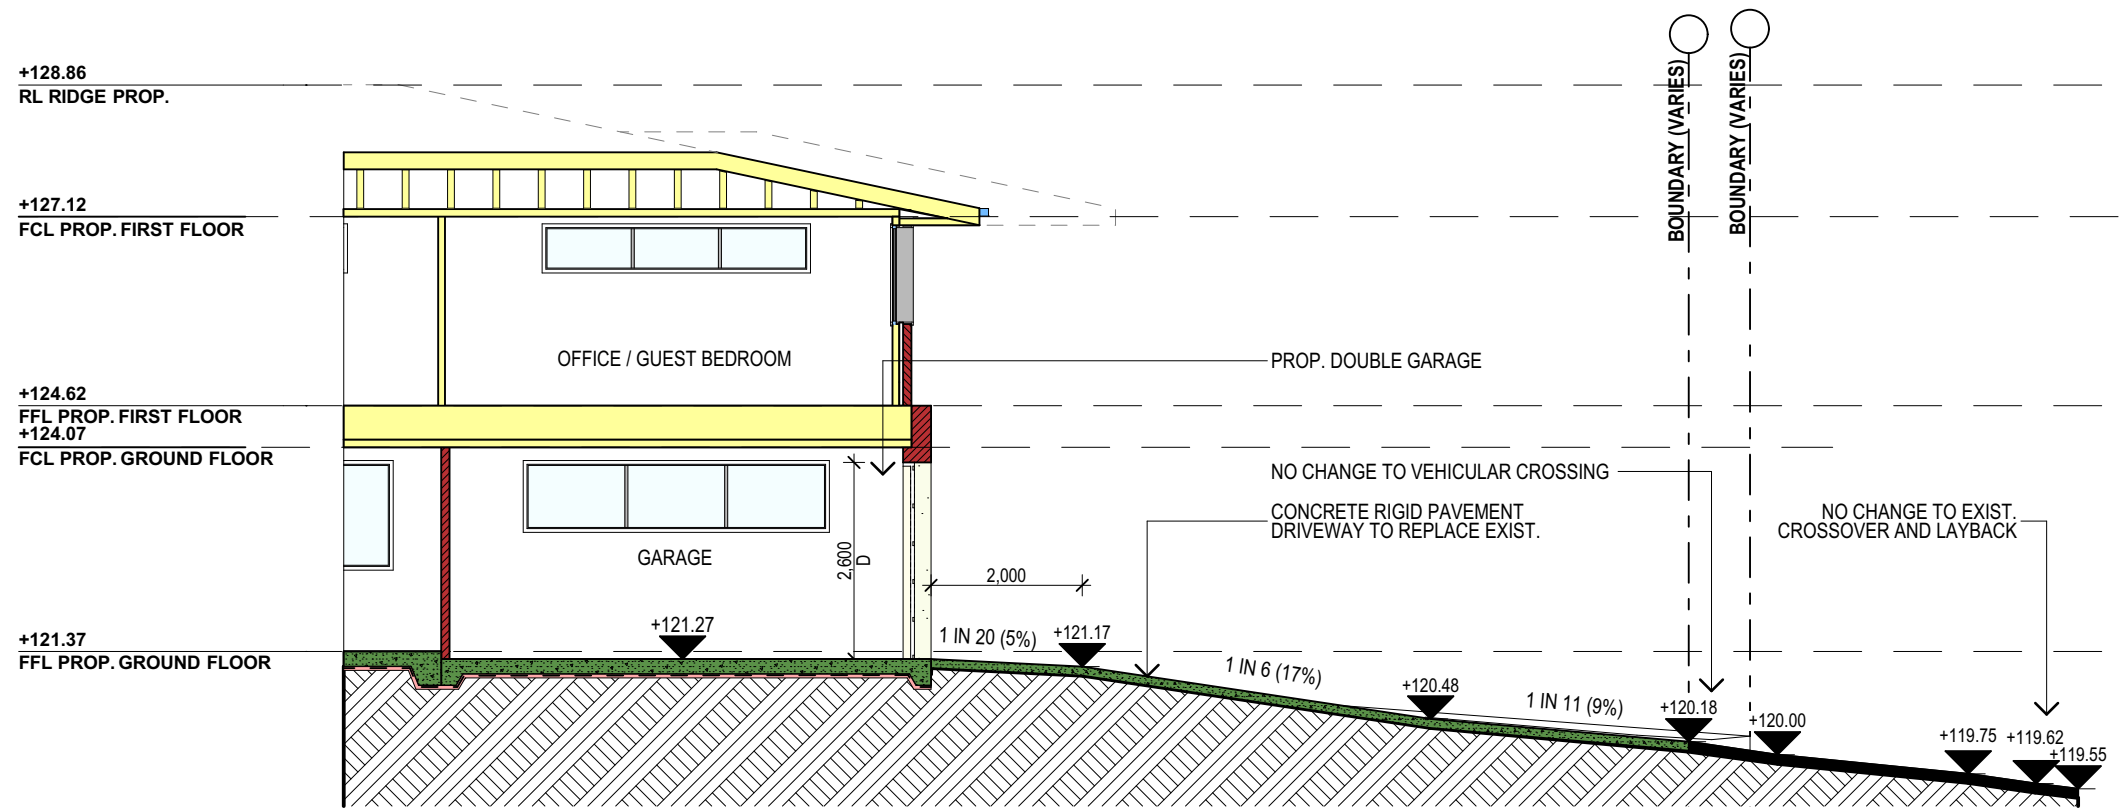
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DA.06

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BUILDING DESIGNER

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JJ



SECTION AA



SECTION BB AND DRIVEWAY SECTION

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34 COOK STREET, FORESTVILLE
CLIENT:
ANTONIO + AMANDA PETROLO

DRAWING TITLE:
SECTIONS

JOB No:
1289/24

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


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DRAWING No:
DA.07

bdca
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BUILDING DESIGNER

CHECKED BY:
JJ

TO BE UPDATED

New Dwelling 34 Cook Street FORESTVILLE		NSW	2087	Prepared by Chapman Environmental Services www.cesenergy.com.au 1300 004 914								
Water Target		40	Water Score		41	Conditioned Area		411.3				
Energy Target		72	Energy Score		89	Unconditioned Area		22.1				
Max H & C Loads are (MJ/m²)		30	Actual H & C Loads are (MJ/m²)		29.8	Star Rating		7				
Basix Commitments												
Landscaping		Total area of garden & lawn (m²)			400	Area of indigenous/low water use plants (m²)			0			
Fixtures		Shower heads			4 star (> 4.5 but <= 6 L/min)		Toilets		4 star		All taps 4 star	
Alternative Water		Minimum Rainwater tank size (L)			3000		Collect run off from roof area of at least (m²)			100		
		Toilet connection Yes		Laundry connection No		Landscape connection Yes		Pool top up n/a		Spa top up n/a		
Pool and Spa		Max pool volume (kL)			n/a							
Energy		Hot water system		Gas instantaneous			Rating		5 star			
		Bathroom ventilation		Individual fan, ducted to facade or roof			with		Manual switch on/off			
		Kitchen ventilation		Individual fan, ducted to facade or roof			with		Manual switch on/off			
		Laundry ventilation		Natural ventilation only, or no laundry								
		Cooling - living areas		1-phase airconditioning			Rating		EER 3.0 - 3.5		Zoned	
		Cooling - bedrooms		1-phase airconditioning			Rating		EER 3.0 - 3.5			
		Heating - living areas		1-phase airconditioning			Rating		EER 3.0 - 3.5			
		Heating - bedrooms		1-phase airconditioning			Rating		EER 3.0 - 3.5			
		Alternate Energy		Photovoltaic system able to generate at least			min 3.0		peak kilowatts of electricity			
Gas cooktop & gas oven					Outdoor clothesline required			No indoor clothesline required				
Thermal Performance Assessment Based on the Following Requirements												
Floor Types		Concrete slab on ground			with		R2.3 under slab insulation					
		Suspended timber			with		R2.5 bulk insulation					
Floor Coverings		Tiles		Living / Wet areas			Timber		n/a			
		Carpet		Bedrooms			Concrete		Garage			
External Walls		Cavity brick			with		R1.2 cavity board			Colour Light		
		Brick veneer			with		Sarking and R2.5 bulk insulation			Colour Light		
Internal Walls		Single skin brick			with		Nil					
		Plasterboard			with		No insulation required					
Ceiling (floor over)		Timber above plasterboard			with		R2.0 bulk insulation					
Ceilings (roof over)		Timber above plasterboard.			with		R5.0 bulk insulation					
Roof		Tiles		22 degrees		with		Sarking		Colour Dark		
Windows and Doors		AF double glazed clear - Lightbridge to all windows and glazed doors unless noted otherwise			Sliding W		AWS-047-323		U-Value 3.70 or less		SHGC 0.45 +/- 5%	
					Awning W		AWS-008-025		U-Value 3.40 or less		SHGC 0.43 +/- 5%	
					D-Hung W		VAN-002-042		U-Value 3.70 or less		SHGC 0.41 +/- 5%	
					Fixed W		AWS-071-009		U-Value 2.70 or less		SHGC 0.51 +/- 5%	
					Sliding D		AWS-036-053		U-Value 3.00 or less		SHGC 0.47 +/- 5%	
					Hinged D		AWS-019-038		U-Value 3.20 or less		SHGC 0.35 +/- 5%	
		AF = Aluminium Framed			TB = Thermally Broken Aluminium Framed			TF = Timber Framed				
If the Universal Certificate indicates downlights, then these are to be non-ventilated LED / fluorescent Any exhaust fans noted are to be fitted with self-closing dampers or be otherwise sealed All insulation specified must be installed in accordance with Part 3.12.1.1 of the BCA												

This document to be read in conjunction with the Basix Certificate and Natheers Universal Certificate

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PROPOSED NEW BUILD
34 COOK STREET, FORESTVILLE
CLIENT:
ANTONIO + AMANDA PETROLO

DRAWING TITLE:
BASIX

JOB No:
1289/24

DRAWN BY:
AD

DATE:
AUG/24

SCALE:
1:1 @ A3

DRAWING No:
DA.08

ACCREDITED
BUILDING DESIGNER

CHECKED BY:
JJ

SPECIFICATION NOTES

INTERNAL LINING
- PROVIDE PLASTERBOARD LINING.
- INSTALL TO MANUFACTURERS SPECIFICATIONS & AS 2589

EXTERNAL WALLS:
- BRICK VENEER WALLS WITH SELECTED BRICKS TO DWELLING.
- ALL EXTERNAL WALL CLADDINGS MUST BE COMPLIANT WITH THE REQUIREMENTS OF NCC 2022 - ABCB HOUSING PROVISIONS PART 7, AS1684 AND ALL RELEVANT CODEMARK CERTIFICATES.
- ROOF AND WALL CLADDING INSTALLATION TO NCC 2022 H1D7 & AS 1562 DESIGN AND INSTALLATION OF SHEET ROOF AND WALL CLADDING.

CONDENSATION MANAGEMENT:
- CONDENSATION MANAGEMENT MUST BE ADHERED TO IN ACCORDANCE WITH NCC 2022 - HOUSING PROVISIONS PART 10.8.

FLOOR:
- GROUND FLOOR TO BE REINFORCED CONCRETE SLAB IN ACCORDANCE WITH AS2870.
- FIRST FLOOR TO BE TIMBER FRAMED FINISHED WITH T&G HARDWOOD FLOORING.

WET AREAS:
- ALL WATERPROOFING TO NCC 2022 - ABCB HOUSING PROVISIONS PART 10, AS3740 AND PROVIDE A GUARANTEED FLEXIBLE WATERPROOF MEMBRANE TO ALL WET AREA FLOORS & SHOWER WALLS TO MANUFACTURED SPECIFICATIONS AND INSTALLATION INSTRUCTIONS.
- WATERPROOF INSTALLATION NCC (2022): HOUSING PROVISIONS PART 10, AS 3740 WATERPROOFING OF DOMESTIC WET AREAS (INTERNAL) & AS 4654 WATERPROOF MEMBRANES FOR EXTERNAL USE.

BEARERS AND JOISTS:
- SHALL BE INSTALLED TO COMPLY WITH AS1684 AS AMENDED FOR TIMBER COMPONENTS OR AS3620 FOR LIGHTWEIGHT STEEL FRAMING SECTIONS OR AS PER THE NASH ALTERNATIVES TO AS 3623.

ANT CAPS:
- SHALL BE INSTALLED IN ACCORDANCE WITH AS3660.

PROFILED STEEL ROOF:
- COLORBOND ROOF CLADDING
- METAL ROOF DESIGN AND INSTALLATION SHALL BE IN ACCORDANCE WITH NCC 2022 - ABCB HOUSING PROVISIONS PART 7, AS 1562.

ROOF TILES OR SHINGLES:
- NCC 2022 -ABCB HOUSING PROVISIONS PART 7.3.

CONCRETE:
- SHALL BE IN ACCORDANCE WITH NCC 2022 - ABCB HOUSING PROVISIONS PART 4 .2.10.
- ALL WORKMANSHIP AND MATERIALS SHALL BE IN ACCORDANCE WITH CURRENT EDITIONS OF THE AS3600.

BRICK AND BLOCKWORK:
- MASONRY STRUCTURES TO NCC 2022 - ABCB HOUSING PROVISIONS PART 5 & AS 3700 MASONRY STRUCTURES.

FOOTINGS:
- FOOTINGS TO BE IN ACCORDANCE WITH AS1480.
- FOOTINGS TO BE IN ACCORDANCE WITH NCC VOL.2 PARTS H1D4
- ALL REINFORCEMENTS SHALL CONFORM TO AS1302, AS1303 AND AS1304.
- RESIDENTIAL SLABS, FOOTINGS AND CONCRETE STRUCTURES TO NCC 2022 – ABCB HOUSING PROVISIONS PART 3 & 4, AS 2870 RESIDENTIAL SLABS AND FOOTING & AS 3600 CONCRETE STRUCTURES.

CARPENTRY:
- TIMBER TO COMPLY WITH AS1170.2 OR AS4055.
- ALL WORKMANSHIP AND MATERIALS SHALL BE IN ACCORDANCE WITH AS1684 AND 1720 AS APPLICABLE.
-TERMITE MANAGEMENT INSTALLATION OF PERIMETER & COLLARS TO NCC 2022 - ABCB HOUSING PROVISIONS PART 3.4 & AS 3660.1 TERMITE MANAGEMENT - NEW BUILDING WORK.

TIMBER FRAMING:
-ALL EXTERNAL TIMBER FRAMED WALLS TO BE WRAPPED IN A BREATHABLE VAPOUR PERMEABLE MEMBRANE IN ACCORDANCE WITH NCC VOL.2 PART H1D6 , INSTALLED WITH AS/NZS 4200.1 & AS/NZS 4200.2.
-TIMBER FRAMING INSTALLATION TO NCC 2022 - VOL.2 PART HAD6(4), AS 1684.4 RESIDENTIAL TIMBER FRAMED CONSTRUCTION & AS/NZS 1170 STRUCTURAL DESIGN ACTIONS.
- GROUND FLOOR TIMBERS SHALL BE ONLY OF HARDWOOD, CYPRESS PINE OR PRESSURE TREATED RADIATA OR CANADA PINE BELOW A HEIGHT OF 300mm ABOVE FINISHED GROUND LEVEL AND MUST NOT BE BUILT INTO BRICKWORK.
- SUBFLOOR VENTILATION SHALL CONFORM TO NCC 2022 - ABCB HOUSING PRIVIONS PART 6.2
- IN BUSHFIRE PRONE AREAS SPECIAL CONDITIONS APPLY.
- WHERE TERMITE BARRIERS NEED TO BE INSPECTED, 400mm CLEARANCE IS REQUIRED BETWEEN THE UNDERSIDE OF BEARER AND GROUND SURFACE.
- USE TREATED TIMBER WHERE REQUIRED FOR DURABILITY.
- DO NOT USE TIMBER UNSUITABLE FOR EXPOSURE TO MOISTURE IN EXPOSED LOCATION.
- PROVIDE STRUCTURE BRACING IN ACCORDANCE WITH AS1684
- PROVIDE STRUCTURE TIEDOWN IN ACCORDANCE WITH AS1684
- USE GALVANISED FIXINGS WHERE EXPOSED TO WEATHER.

STEEL FRAMING:
-ALL STEEL FRAMING TO NCC 2022 - VOL.2 PARTH1D6(3), AS 4100 STEEL STRUCTURES, AS/NZS 4600 COLD-FORMED STEEL STRUCTURES & NASH STANDARD.

TERMITE CONTROL:
- TO BE IN ACCORDANCE WITH TO AS3660.1
- SHALL BE IN ACCORDANCE WITH NCC 2022 - ABCB HOUSING PROVISION PART 3.4

FLASHING AND CAPPINGS:
- SELECTION AND INSTALLATION OF METAL RAINWATER GOODS REFER TO AS2180
- FLASH PROJECTIONS ABOVE THE ROOF WITH TWO PART FLASHINGS CONSISTING OF AN APRON FLASHING AND OVER FLASHING, WITH AT LEAST 100mm OVERLAP.
- PROVIDE FOR INDEPENDENT MOVEMENT BETWEEN ROOF AND PROJECTION.
- DAMP PROOF COURSE AND FLASHINGS TO NCC 2022 - VOL.2 PART H2 & AS/NZS 2904 DAMP-PROOF COURSES AND FLASHINGS.

CONCRETE BLOCKS OR BRICKS:
- TO COMPLY WITH TO AS4455 MASONRY BUILDING BLOCKS/PAVER.

LIGHTING:
- 40% OF NEW OR ALTERED LIGHT FIXTURES TO BE FITTED WITH FLUORESCENT, COMPACT FLUORESCENT, OR LIGHT-EMITTING-DIODE (LED) LAMPS

DOORS & WINDOWS:
- ALL FRAMED WINDOWS SHALL BE INSTALLED IN ACCORDANCE WITH AS2047-48 FOR ALUMINIUM WINDOWS AND AS2047 FOR TIMBER WINDOWS.
- ALUMINIUM FRAMED WINDOWS AND DOORS.
- WEATHER STRIPPING IS TO BE PROVIDED TO ALL EXTERNAL WINDOWS AND DOORS.
- ALL WINDOWS ARE TO BE RESTRICTED IN ACCORDANCE WITH NCC 2022 – ABCB HOUSING PROVISIONS PART 11.3.7 & PART 11.3.8 PROTECTION OF OPENABLE WINDOWS WHERE SURFACE BELOW IS MORE THAN 2M.
- PROVIDE LIFT-OFF HINGES WHERE THE TOILET PAN IS WITHIN 1.2 METRES OF THE HINGED SIDE OF THE DOOR IN ACCORDANCE WITH NCC 2022 – ABCB HOUSING PROVISIONS PART 10.4.

STAIRS, HANDRAILS AND BALUSTRADES:
- RELATIONSHIP OF RISER TO GOING SHALL BE BETWEEN 1:2 AND 1:1.35 UNLESS OTHERWISE DIRECTED TO GOING SHALL BE BETWEEN 1:2 AND 1:1.35 UNLESS OTHERWISE DIRECTED OR AS PERMITTED IN AS1657.
- BALUSTRADES SHALL BE PROVIDED TO ALL LANDINGS, RAMPS, DECKS, ROOFS AND OTHER ELEVATED PLATFORMS WHERE THE VERTICAL DISTANCE FROM THAT LEVEL IS MORE THAN 1m ABOVE THE ADJOINING FLOOR OR FINISHED GROUND LEVEL.
- THE HEIGHT OF BALUSTRADE MUST BE A MINIMUM OF 1m HIGH ABOVE LANDING AND NOT LESS THAN 865mm ABOVE THE NOSINGS OF ANY STAIR TREADS OR FLOOR RAMP AND HAVE NO OPENING GREATER THAN 125mm.
- THE HEIGHT OF BALUSTRADE TO THE NEW STAIRCASES IS TO BE MEASURED A MINIMUM 865mm ABOVE THE NOSING LINE AND HAVE NO OPENING GREATER NO OPENING GREATER THAN 125mm.
- ALL BALUSTRADES & PRIVACY SCREENS TO COMPLY WITH NCC 2022 – ABCB HOUSING PROVISIONS PART 11, AS 1684, AS 1170, AS 1288 & AS/NZS 2208

SLIP RESISTANCE:
- MATERIALS TO BE USED FOR SURFACES OF FLOORS, STAIR LANDING, STEPS AND NOSINGS SHALL BE IN ACCORDANCE WITH THE CLASSIFICATIONS FOR SLIP RESISTANCE AS APPLY IN AS4586 AND HB198.
- ALL STAIRS PROVIDING ACCESS TO COMPLY WITH NCC 2022 – ABCB HOUSING PROVISIONS PART 11, AS 4586 INCLUDING SLIP RESISTANCE P3 / R10 FOR DRY OR P4 / R11 FOR WET.

STORMWATER:
EAVES GUTTERS, VALLEY GUTTERS AND DOWPIPES
- TO COMPLY WITH AS/NZS 2179 FOR METAL AND AS1273 FOR UPVC COMPONENTS.
- IN ACCORDANCE WITH NCC VOL 2 PART 3.5.3
- NEW DOWNPIPES TO BE CONNECTED INTO EXISTING STORMWATER LINE
- COLORBOND GUTTERS AND DOWNPIPES
- MINIMUM SLOPE OF EAVES AND GUTTERS 1:200

GLAZING:
- NCC VOL2 PART H1D8, ABCB HOUSING PROVISIONS PART 8 .3
-ALL WINDOW GLAZING AND DOOR GLAZING TO BE INSTALLED IN ACCORDANCE TO NCC 2022 - ABCB HOUSING PROVISIONS PART 8, AS 1288 GLASS IN BUILDINGS, AS/NZS 2208 SAFETY GLAZING MATERIALS IN BUILDINGS & AS 2047 WINDOWS AND EXTERNAL DOORS IN BUILDINGS.
- SHOWER SCREEN/MIRRORS / WARDROBE GLASS INSTALLATION TO NCC 2022 - HOUSING PROVISIONS PART 8, AS 1288 & AS/NZS 2208.
- GLASS BALUSTRADE INSTALLATION TO NCC 2022 - HOUSING PROVISIONS PART 11, AS 1288 GLASS IN BUILDINGS, AS/NZS 2208 SAFETY GLAZING MATERIALS IN BUILDINGS & AS 1170 STRUCTURAL DESIGN ACTIONS.

WATERPROOFING FOR EXTERNAL TILED BALCONIES:
- WATERPROOFING TO COMPLY WITH AS4654
- ALL WATERPROOFING TO NCC 2022 - ABCB HOUSING PROVISIONS PART 10, AS3740 AND PROVIDE A GUARANTEED FLEXIBLE WATERPROOF MEMBRANE TO ALL WET AREA FLOORS & SHOWER WALLS TO MANUFACTURED SPECIFICATIONS AND INSTALLATION INSTRUCTIONS

FIRE SAFETY, SMOKE DETECTORS/ALARMS:
- PROVIDE HARDWIRED & INTERCONNECTED SMOKE ALARM DEVICES COMPLYING WITH THE REQUIREMENTS OF THE LOCAL GOVERNMENT ACT AND/OR STATE OR TERRITORY REGULATIONS MUST BE FITTED IN THE LOCATIONS REQUIRED AND APPROVED BY THE AUTHORITY. SMOKE ALARMS TO BE INSTALLED TO NCC 2022 – ABCB HOUSING PROVISIONS PART 9.5, NSW 9.5.1 & AS 3786.
- INSTALLATIONS IN BUILDINGS OTHER THAN CLASS 1 AND 10 MUST BE INSTALLED AND MANAGED TO COMPLY WITH NCC SPEC. E2.2a.
- FIRE SEPARATING WALL, A WALL WITHIN 900MM OF BOUNDARY INSTALLATION CERTIFICATE (FRL60/60/60) INCL ACOUSTIC SOUND (RW) + CTR50 TO NCC 2022 - ABCB HOUSING PROVISIONS PART 9 & PART 10.7, AS 1530 ALL PARTS.
- BUSHFIRE-PRONE AREAS CERTIFICATE FOR BUILDING - NCC 2022 - VOL. 2 PART NSW H7D4 CONSTRUCTION IN BUSHFIRE PRONE AREAS - AS 3959 CONSTRUCTION OF BUILDING IN BUSHFIRE- PRONE AREAS & PLANNING FOR BUSHFIRE PROTECTION 2019.

WASTE MANAGEMENT:
- ALL WASTE SHALL BE TAKEN AWAY BY TRUCKS TO A SUITABLE LANDFILL OR RECYCLE DEPOT.
- ALL WASTE SHALL BE COVERED DURING TRANSPORTATION.
- WASTE GENERATED DURING CONSTRUCTION SHALL BE PLACED IN STEEL BINS AND TAKEN AWAY BY AN APPROVED CONTRACTOR TO A APPROVED LANDFILL SITE.

SEDIMENT CONTROL:
- A FILTER CLOTH SYSTEM SHALL BE INSTALLED TO STOP ANY SEDIMENT ENTERING COUNCILS STORMWATER SYSTEM..

SWIMMING POOLS & SAFETY:
-POOL PLUMBING/CIRCULATION TO COMPLY WITH NCC 2022 PART NSW H7D2, AS 1926.3 SWIMMING POOL SAFETY - WATER RECIRCULATION SYSTEMS
- ALL POOL FENCING TO BE INSTALLED TO: NCC 2022 NSW H7D2, AS 1926.1 - 2012 - SAFETY BARRIERS FOR SWIMMING POOLS, AS 1926.2 - 20007 - LOCATION OF SAFETY BARRIERS FOR SWIMMING POOLS, AS 1170 STRUCTURAL DESIGN ACTIONS AND IF GLASS POOL FENCING TO ADDITIONALLY COMPLY WITH AS 1288 - 2021 GLASS IN BUILDINGS, AS/NZS 2208 - SAFETY GLASS,
- AS 2783 USE OF REINFORCED CONCRETE FOR SMALL SWIMMING POOLS

MISCELLANEOUS ITEMS:
- ALLOW FOR SEPARATE TAPS FOR THE WASHING MACHINE AND KEEP THEM SEPARATE FROM THOSE OF THE LAUNDRY TUB. A DEDICATED LAUNDRY SPACE COMPRISING OF ONE WASHTUB AND A SPACE FOR A WASHING MACHINE MUST BE PROVIDED IN ACCORDANCE WITH NCC 2022 – ABCB HOUSING PROVISIONS PART 10.4.
- GAS FIRE SUPPLY AND INSTALLATION TO COMPLY WITH NCC 2022 - ABCB HOUSING PROVISIONS PART 12.4, AS/NZS 5601 GAS INSTALLATIONS.

NOTE:
ALL PLANS ARE TO BE READ IN CONJUNCTION AND COMPLY WITH THE BASIX CERTIFICATE, BUSHFIRE AND GEOTECH REPORTS.

NOTES (E & OE)
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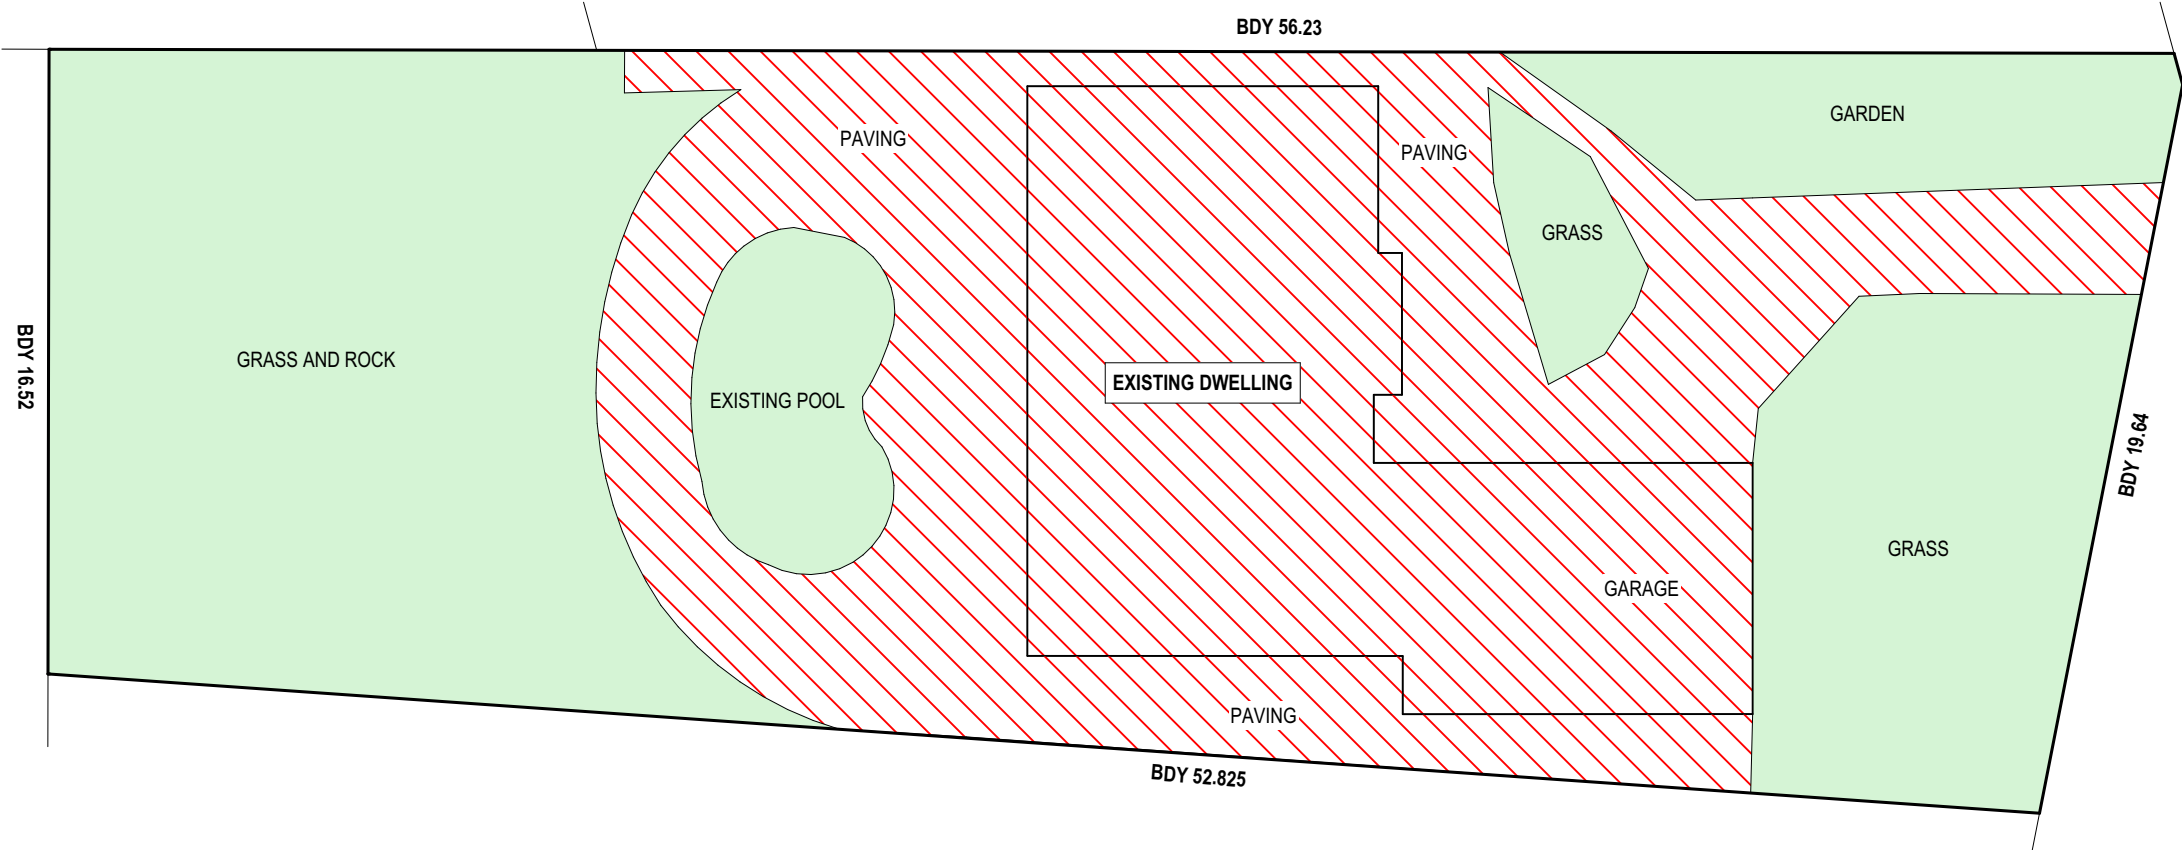
PROPOSED NEW BUILD 34 COOK STREET, FORESTVILLE CLIENT: ANTONIO + AMANDA PETROLO	DRAWING TITLE: SPECIFICATIONS
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JOB No: 1289/24

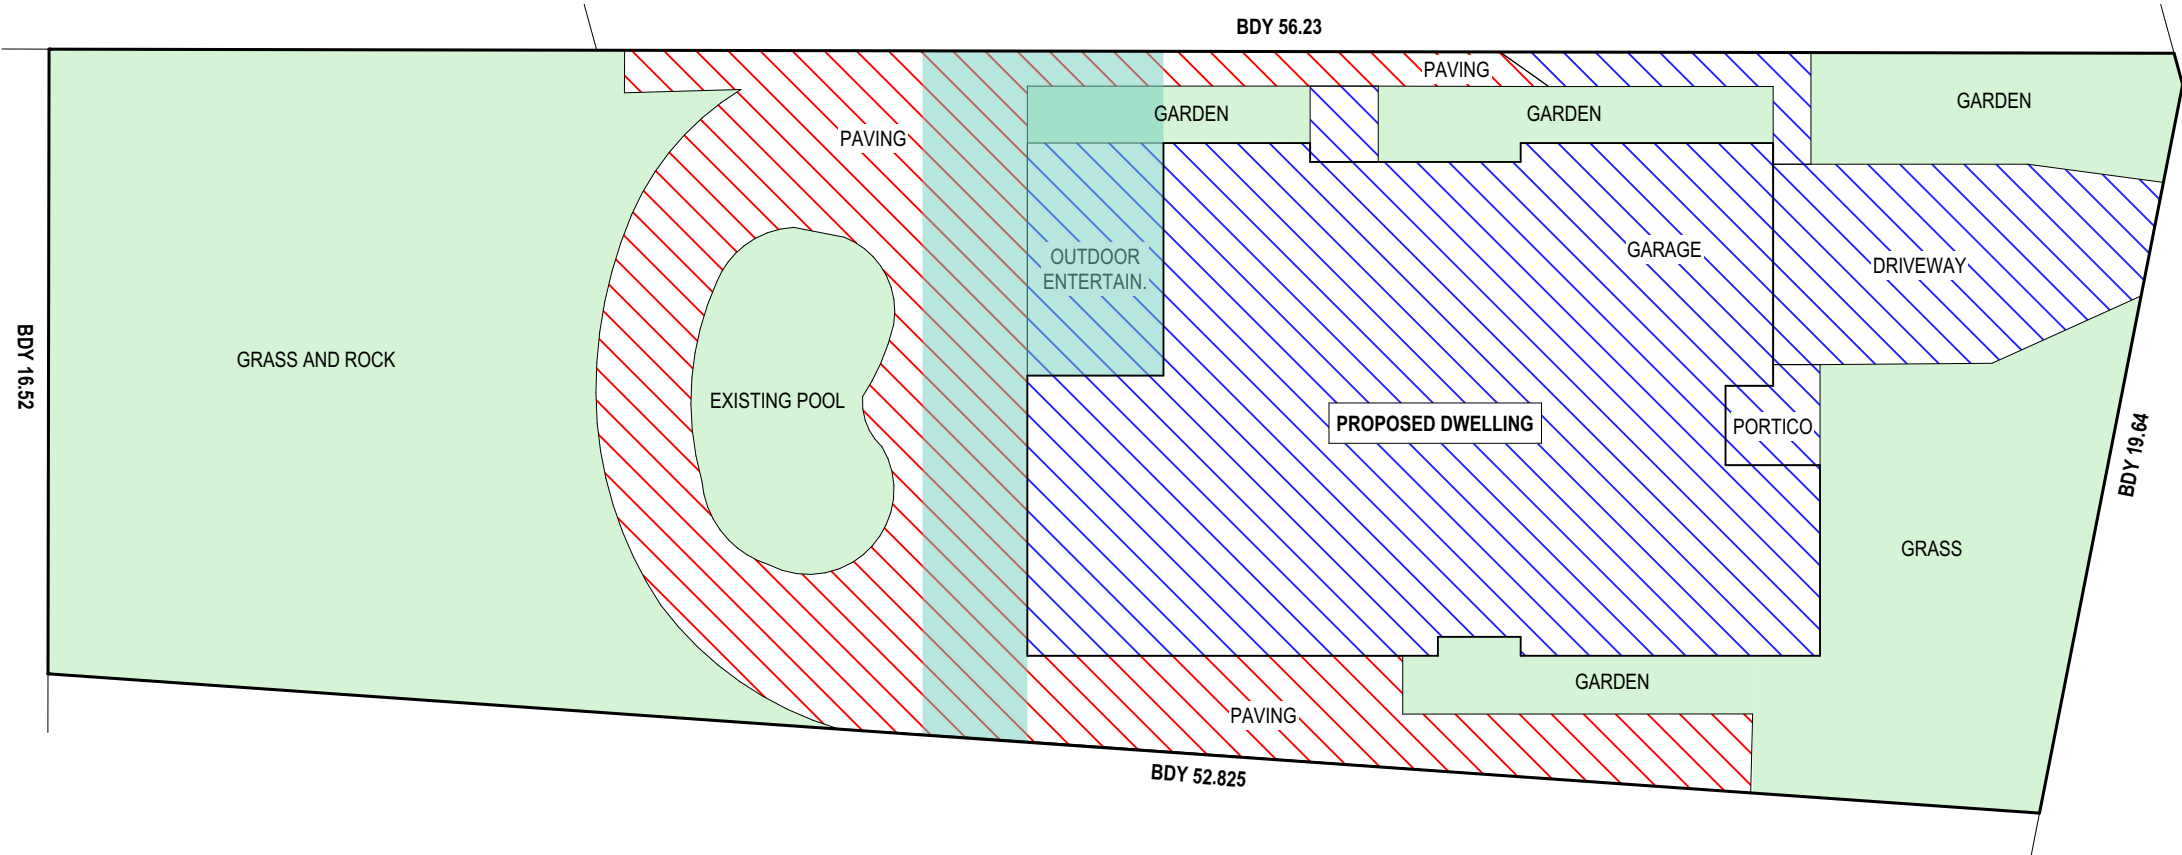
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DRAWING No: DA.09

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CHECKED BY: JJ



EXISTING LANDSCAPED AREA CALCULATIONS PLAN



PROPOSED LANDSCAPED AREA CALCULATIONS PLAN

CALCULATIONS			
SITE AREA			1004.4m ²
LANDSCAPE CONTROL		40%	401.8m ²
EXISTING LANDSCAPED AREA	<div></div>	49.7%	499.4m ²
TOTAL PROPOSED LANDSCAPED AREA	<div></div>	47.2%	474.3m ²
EXISTING HARD SURFACE AREA	<div></div>	50.2%	504.2m ²
TOTAL PROPOSED HARD SURFACE AREA	<div></div>	52.7%	529.1m ²
PRIVATE OPEN SAPCE CONTROL	<div></div>		>60m ²
PROPOSED RIVATE OPEN SPACE	<div></div>		>80m ²

TRUE NORTH:

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PROPOSED NEW BUILD
34 COOK STREET, FORESTVILLE

CLIENT:
ANTONIO + AMANDA PETROLO

JOB No:
1289/24

DRAWN BY:
AD

DATE:
AUG/24

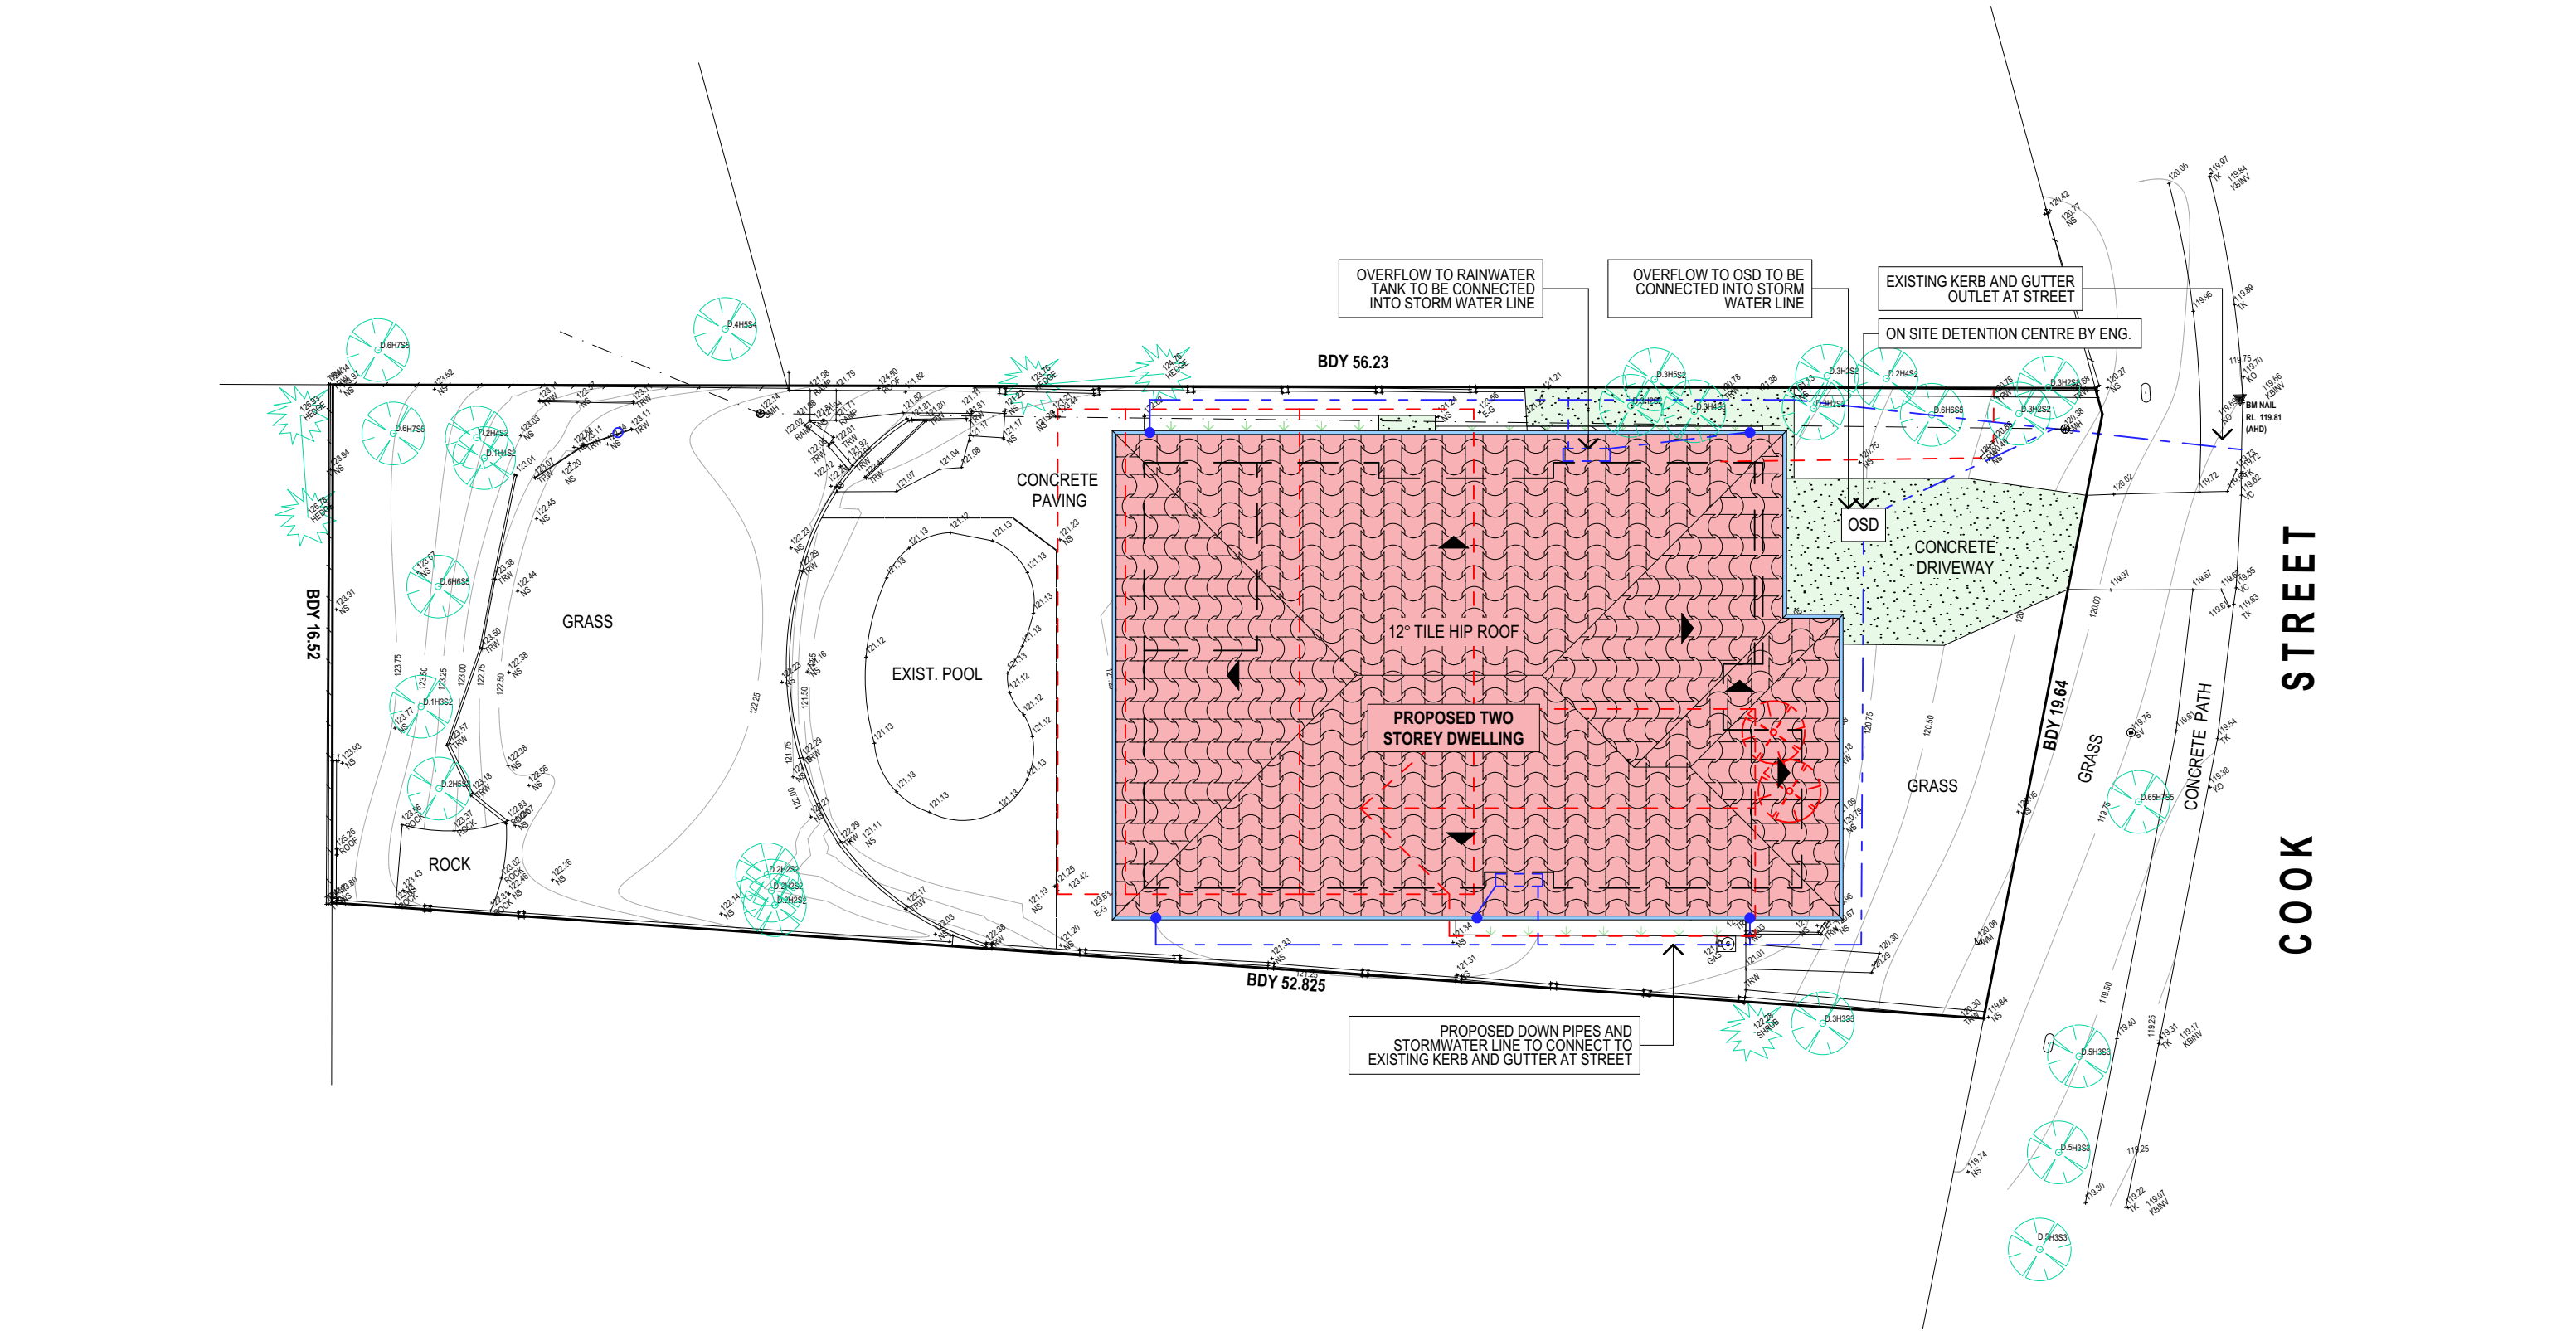
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JJ

DRAWING TITLE:
LANDSCAPED AREA CALCULATION PLAN





STORMWATER CONCEPT LEGEND

PROPOSED DOWNPIPES

APPROX. LOCATION STORMWATER LINE

ROOF AND STORMWATER CONCEPT PLAN

TRUE NORTH:

NOTES (E & OE)

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PROPOSED NEW BUILD
34 COOK STREET, FORESTVILLE
CLIENT:
ANTONIO + AMANDA PETROLO

DRAWING TITLE:
ROOF & STORMWATER CONCEPT PLAN

JOB No:
1289/24

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BUILDING DESIGNER

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NOTES

DESIGNATED SITE MANAGER/BUILDER

PRIOR TO COMMENCEMENT OF WORK A SITE MANAGER OR BUILDER MUST BE NOMINATED. THE SITE MANAGER OR BUILDER WILL BE RESPONSIBLE AND LIABLE FOR ALL WORKS CARRIED OUT ON THE SITE. THIS ASSUMES THE RESPONSIBILITY FOR THE ACTIONS OF ALL SUBCONTRACTED PARTIES AS WELL AS ADVISING THEM OF COUNCIL'S REQUIREMENTS WHEN CARRYING OUT WORKS.

TOPSOIL MANAGEMENT

PRIOR TO THE STRIPPING OF TOPSOIL, THE VEGETATIVE COVER MUST BE REDUCED BY EITHER SLASHING OR MOWING. ALL TOPSOIL IS TO BE RETAINED AND PROTECTED FOR REUSE ON SITE. SOIL STOCKPILES MUST NOT BE LOCATED ON NATURE STRIPS, FOOTPATHS, ROADWAYS, KERBS, ACCESSWAYS, WITHIN DRAINAGE LINES/FLOWS/PATHS OR AROUND OR AGAINST TREE SHRUBS. SEDIMENT CONTROL MEASURES MUST BE INCORPORATED WITH ANY RESULTING STOCKPILE. THE STOCKPILE CAN BE PROTECTED FROM EROSION BY COVERING IT WITH AN IMPERVIOUS MATERIAL, IN CONJUNCTION WITH THE INSTALLATION OF A SEDIMENT FENCE AROUND IT. IF STOCKPILES ARE TO REMAIN FOR MORE THAN ONE MONTH THEY ARE TO BE GRASSED IMMEDIATELY AND STABILISED WITHIN FOURTEEN DAYS. SURPLUS TOPSOIL MUST BE REASONABLY REMOVED FROM SITE.

BUILDING MATERIAL STOCKPILING

SUFFICIENT AREA MUST BE ALLOCATED WITHIN THE SITE FOR SUCH STORAGE OF BUILDING MATERIALS, DEMOLITION WASTE, WASTE CONTAINERS, ETC. AS WILL BE REQUIRED.

SEDIMENT FENCES

A SEDIMENT FENCE SHOULD BE LOCATED ALONG THE DOWNSLOPE BOUNDARY(S) OF THE SITE, ON THE CONSTRUCTION SIDE OF THE TURF FILTER STRIP OR NATIVE VEGETATION, AND AROUND ALL STOCKPILES OF MATERIAL ON THE SITE.

DUST CONTROL

ALL TRUCKS/UTES MUST COVER THEIR LOADS AT ALL TIMES. APPROPRIATE METHODS ARE TO BE EMPLOYED TO PREVENT BLOWING DUST CREATING AN UNACCEPTABLE HAZARD OR NUISANCE ON THE SITE OR DOWN WIND. PRODUCTION OF DUST CAN BE MINIMISED BY LIMITING AREA OF EARTHWORKS, WATERING AND PROGRESSIVE VEGETATION. WHERE DUST IS CREATED AS A RESULT WORKS AND/OR SOIL EXPOSURE, THE BARE SOIL AREAS MUST BE WATERED, DURING AND/OR AT THE END OF EACH DAY TO LAY THE DUST. EARTH MOVING ACTIVITIES SHOULD BE AVOIDED WHERE WINDS ARE SUFFICIENTLY STRONG ENOUGH TO RAISE VISIBLE DUST.

EROSION & SEDIMENT CONTROLS

APPROPRIATE EROSION AND SEDIMENT CONTROLS MUST BE IMPLEMENTED ON ALL SITES THAT INVOLVE SOIL DISTURBANCE. THE MEASURES MUST BE IN PLACE PRIOR TO THE COMMENCEMENT OF WORK. THOSE CONTROLS ARE TO BE MONITORED AND MAINTAINED IN ORDER TO SERVE THEIR INTENDED FUNCTION FOR THE DURATION OF THE WORKS OR UNTIL SUCH TIME AS THE SITE IS FULLY STABILISED. IF ANY CONTROLS ARE DAMAGED OR BECOME INEFFECTIVE DURING THE COURSE OF THE WORKS THEY ARE TO BE REINSTATED OR REPLACED IMMEDIATELY. SUFFICIENT ACCESS TO THESE CONTROLS MUST BE PROVIDED IN CASE OF THE NEED TO REPAIR.

SEDIMENT TRAPS

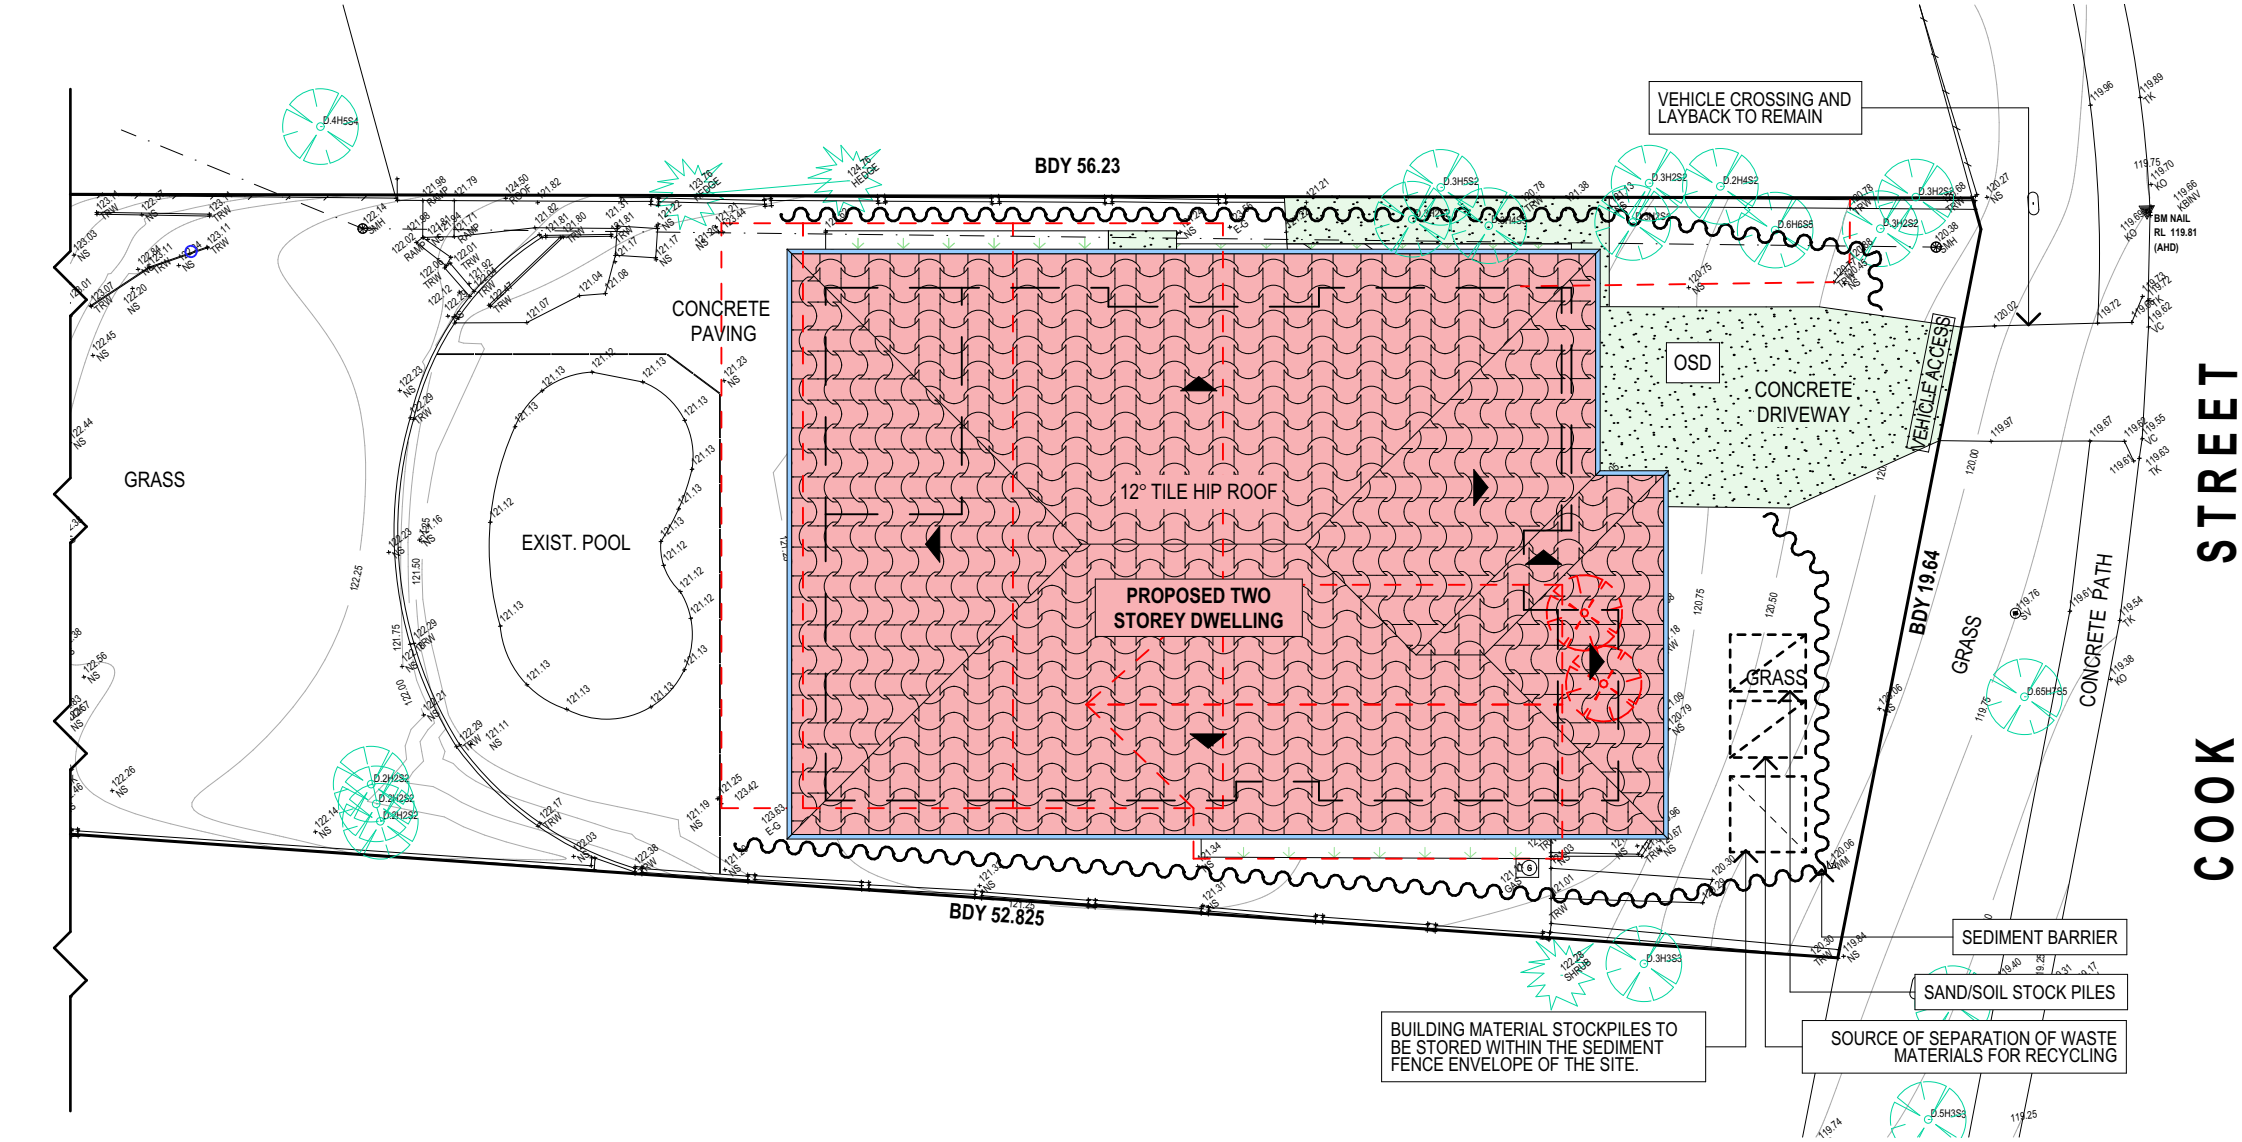
WHERE A SEDIMENT FENCE IS NOT USED APPROPRIATE SEDIMENT TRAPS SHOULD BE LOCATED AT ALL POINTS WHERE STORMWATER LEAVES THE CONSTRUCTION SITE OR LEAVES THE GUTTER AND ENTERS THE DRAINAGE SYSTEM. A COMMON TECHNIQUE IS THE GRAVEL SAUSAGE.

DIVERSION CHANNELS

A DIVERSION CHANNEL IS AN EXCAVATED EARTH DITCH OR PATH. THESE STRUCTURES ARE USED TO INTERCEPT AND DIRECT RUN-OFF TO A DESIRED LOCATION WHERE POSSIBLE. ALL STORMWATER RUN-OFF FLOWING ONTO DISTURBED AREAS, INCLUDING STOCKPILES, MUST BE INTERCEPTED, DIVERTED AND/OR SAFELY DISPOSED OF. THIS CAN BE ACHIEVED BY CONSTRUCTING A TEMPORARY EARTH BANK AROUND THE UPSLOPE EXTENT OF THE CONSTRUCTION SITE WHERE THE DIVERSION DOES NOT AFFECT THE NEIGHBOURING PROPERTIES.

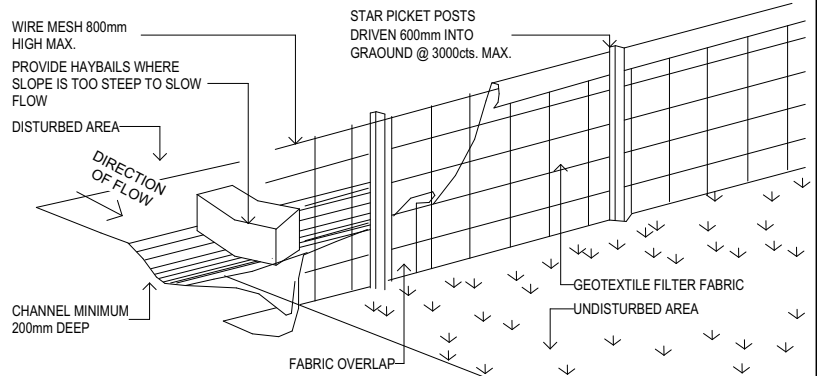
VEHICLE MOVEMENTS

TO LIMIT DISTURBANCE TO THE SITE AND TRACKING OF MATERIAL ONTO THE STREET ALL VEHICLES AND PLANT EQUIPMENT ARE TO USE A SINGLE ENTRY/EXIT POINT UNLESS COUNCIL HAS APPROVED ALTERNATIVE ARRANGEMENTS. ACCESS POINTS AND PARKING AREAS ARE TO BE STABILISED WITH COMPACTED SUB-GRADE ASAP AFTER THEIR FORMATION. IF SPILLAGE DOES OCCUR IT IS TO BE CONTAINED IMMEDIATELY AND CAREFULLY REMOVED. THE AREA AFFECTED IS TO BE RESTORED TO A STANDARD EQUAL TO OR BETTER THAN ITS PREVIOUS CONDITION. ALL VEHICLES ARE TO BE WASHED PRIOR TO EXISTING THE SITE. THIS SERVES THE PURPOSE OF REMOVING SITE MATERIAL ON THE VEHICLE AND PREVENTS IT FROM BEING DEPOSITED ON THE ROAD NETWORK ADJACENT TO THE SITE AND THUS, THE STORMWATER SYSTEM. NO VEHICLE ASSOCIATED WITH THE WORK IS TO BE PARKED ON A FOOTPATH OR PUBLIC RESERVE. ALL VEHICLES VISITING THE SITE DURING DEMOLITION, EXCAVATION AND/OR CONSTRUCTION WORKS, ARE TO COMPLY WITH THE PARKING REQUIREMENTS IN THAT AREA.

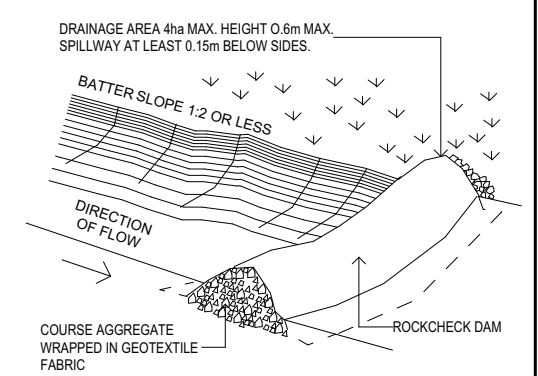


EROSION AND SEDIMENT CONTROL / WASTE MANAGEMENT PLAN

TYPICAL SEDIMENT FENCE - nts



TYPICAL DIVERSION CHANNEL - nts



TRUE NORTH:



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C	20/3/2025	DA DRAWING AMENDMENTS

PROPOSED NEW BUILD
34 COOK STREET, FORESTVILLE
CLIENT:
ANTONIO + AMANDA PETROLO

DRAWING TITLE:
EROSION & SEDIMENT CONTROL / WASTE MANAGEMENT
PI AN

JOB No:
1289/24

DRAWN BY:
AD

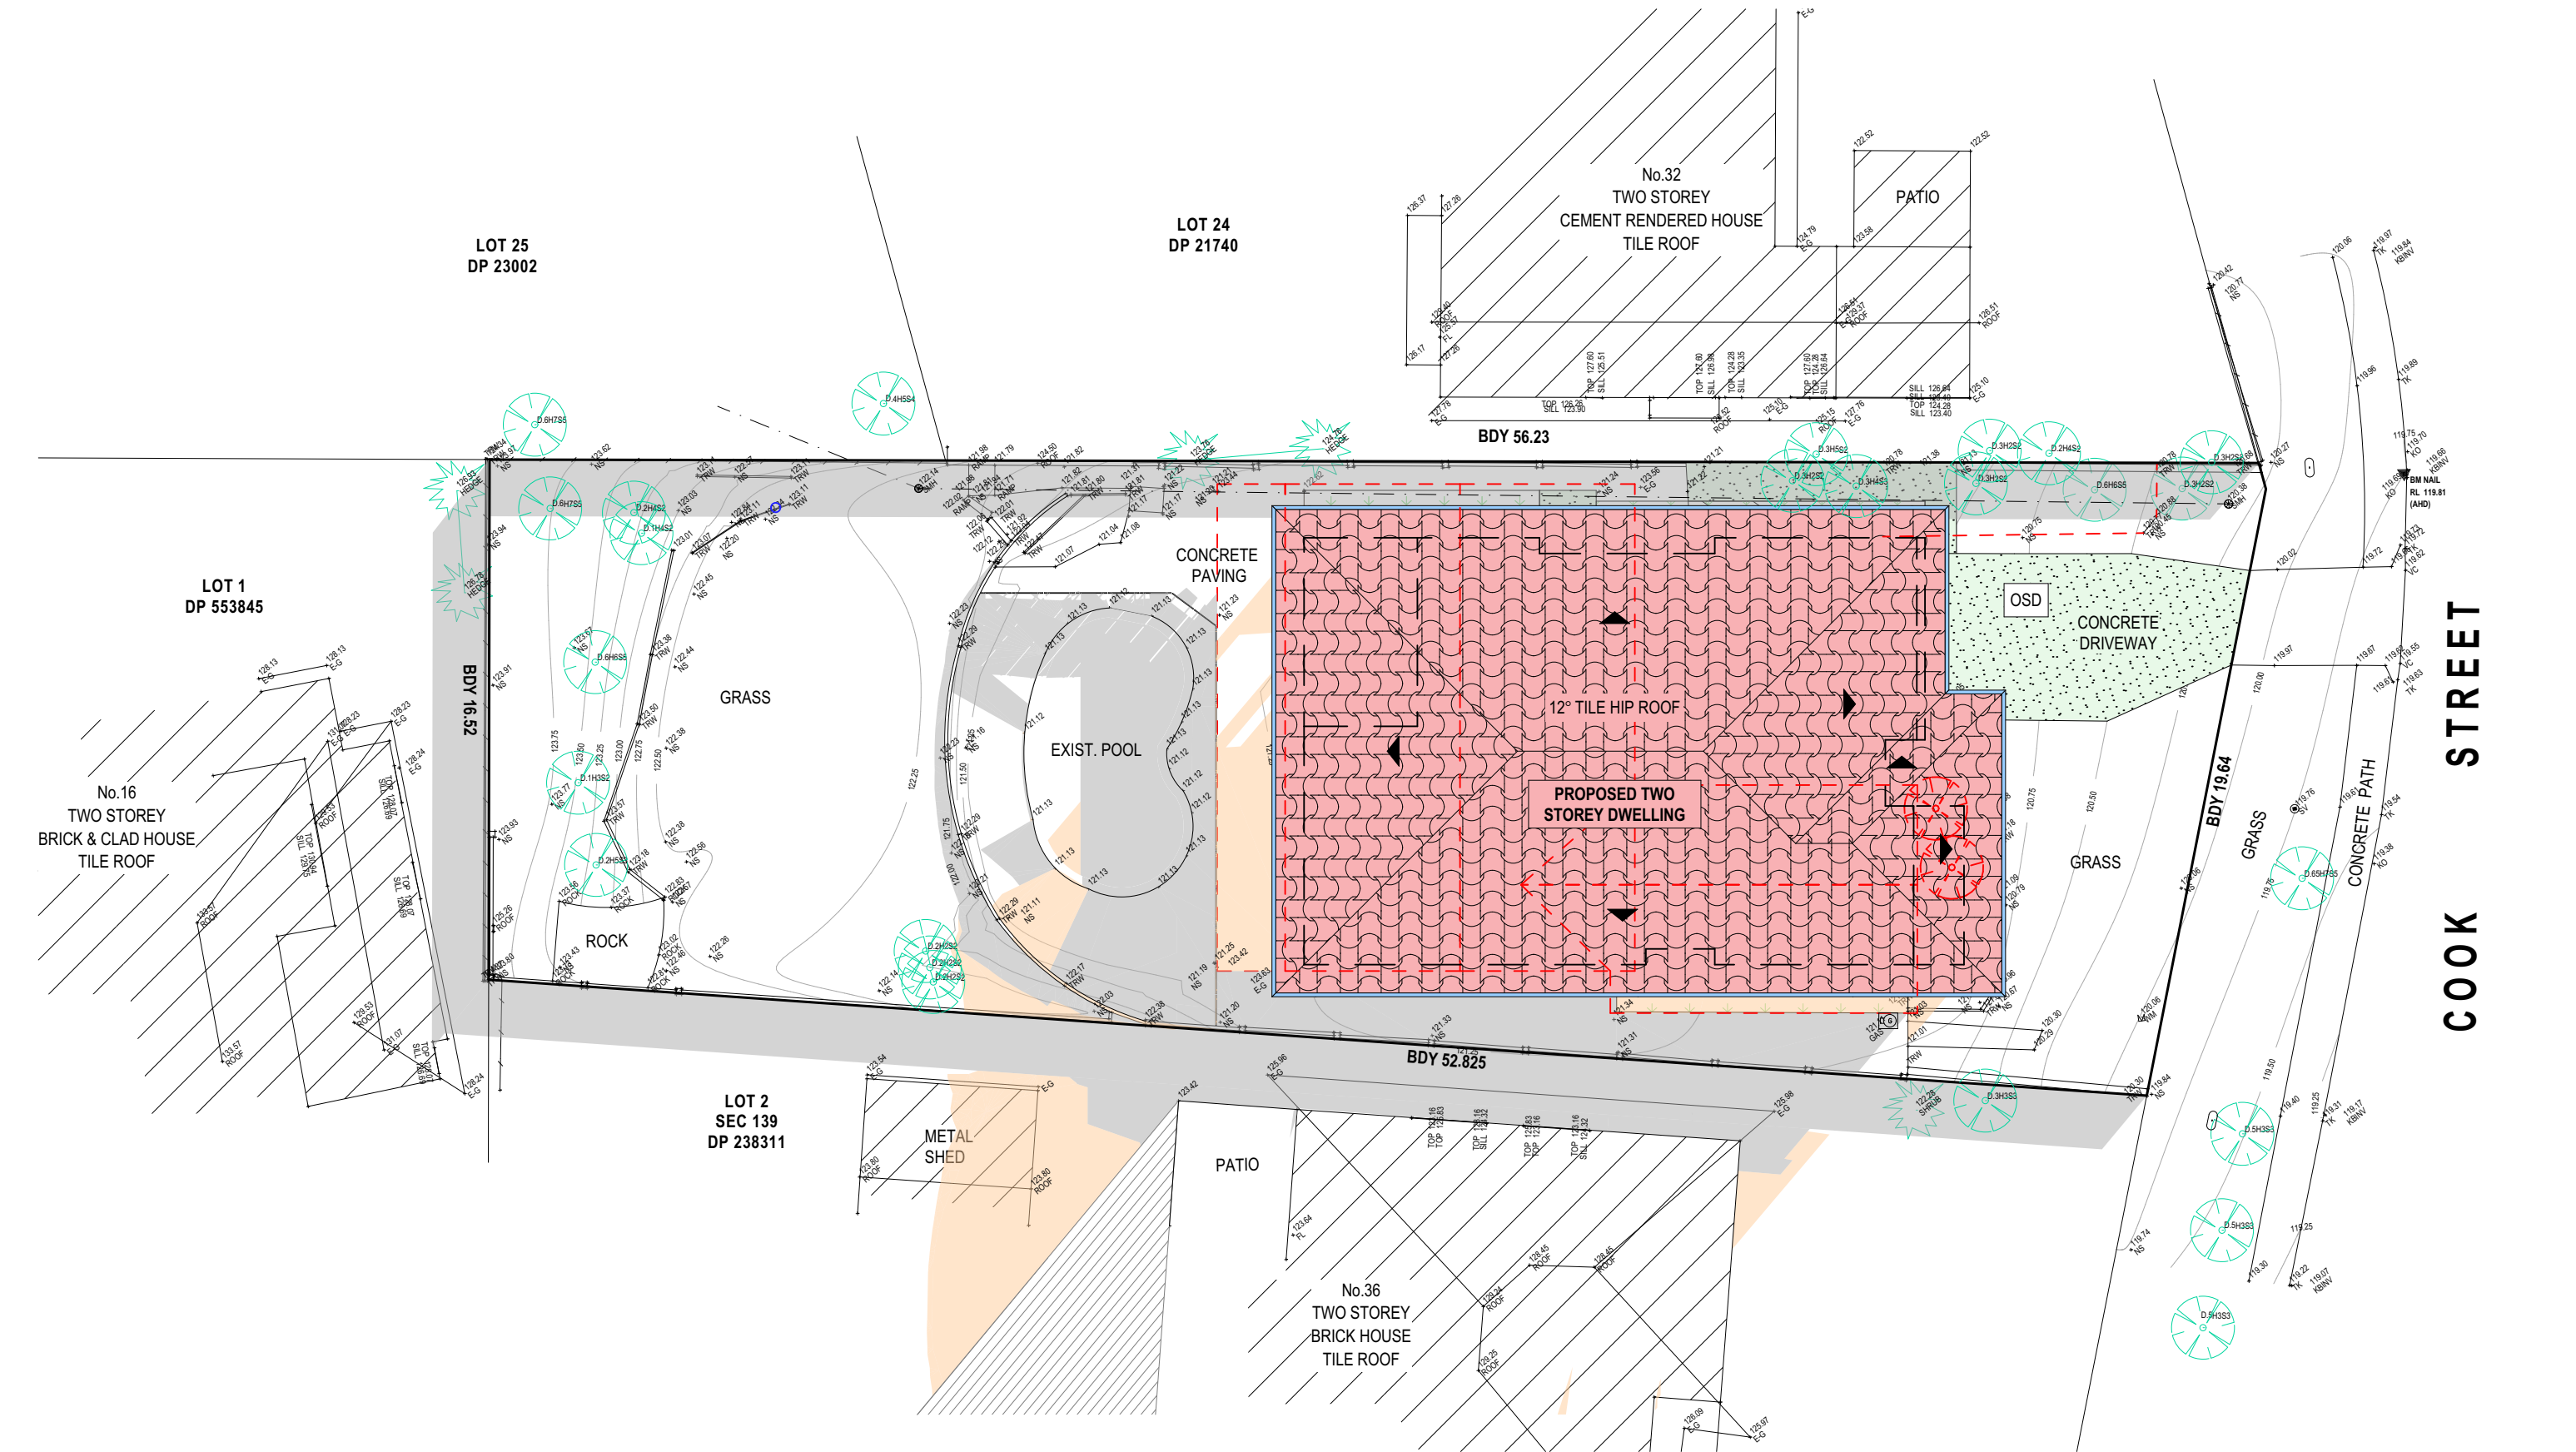
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DRAWING No:
DA.12

bdca
ACCREDITED
BUILDING DESIGNER

CHECKED BY:
JJ



21 JUNE SHADOW DIAGRAM LEGEND

EXISTING SHADOWS

NEW SHADOWS

SHADOW DIAGRAM JUNE 21ST 9AM

TRUE NORTH:

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(C)

30/10/2024

PRELIM. REVISION

A

9/12/2024

DA DRAWINGS

B

8/1/2025

DA DRAWINGS (ADD NATHERS)

C

20/3/2025

DA DRAWING AMENDMENTS

PROPOSED NEW BUILD

34 COOK STREET, FORESTVILLE

CLIENT:

ANTONIO + AMANDA PETROLO

DRAWING TITLE:

SHADOW DIAGRAM JUNE 21 9:00 am

JOB No:

1289/24

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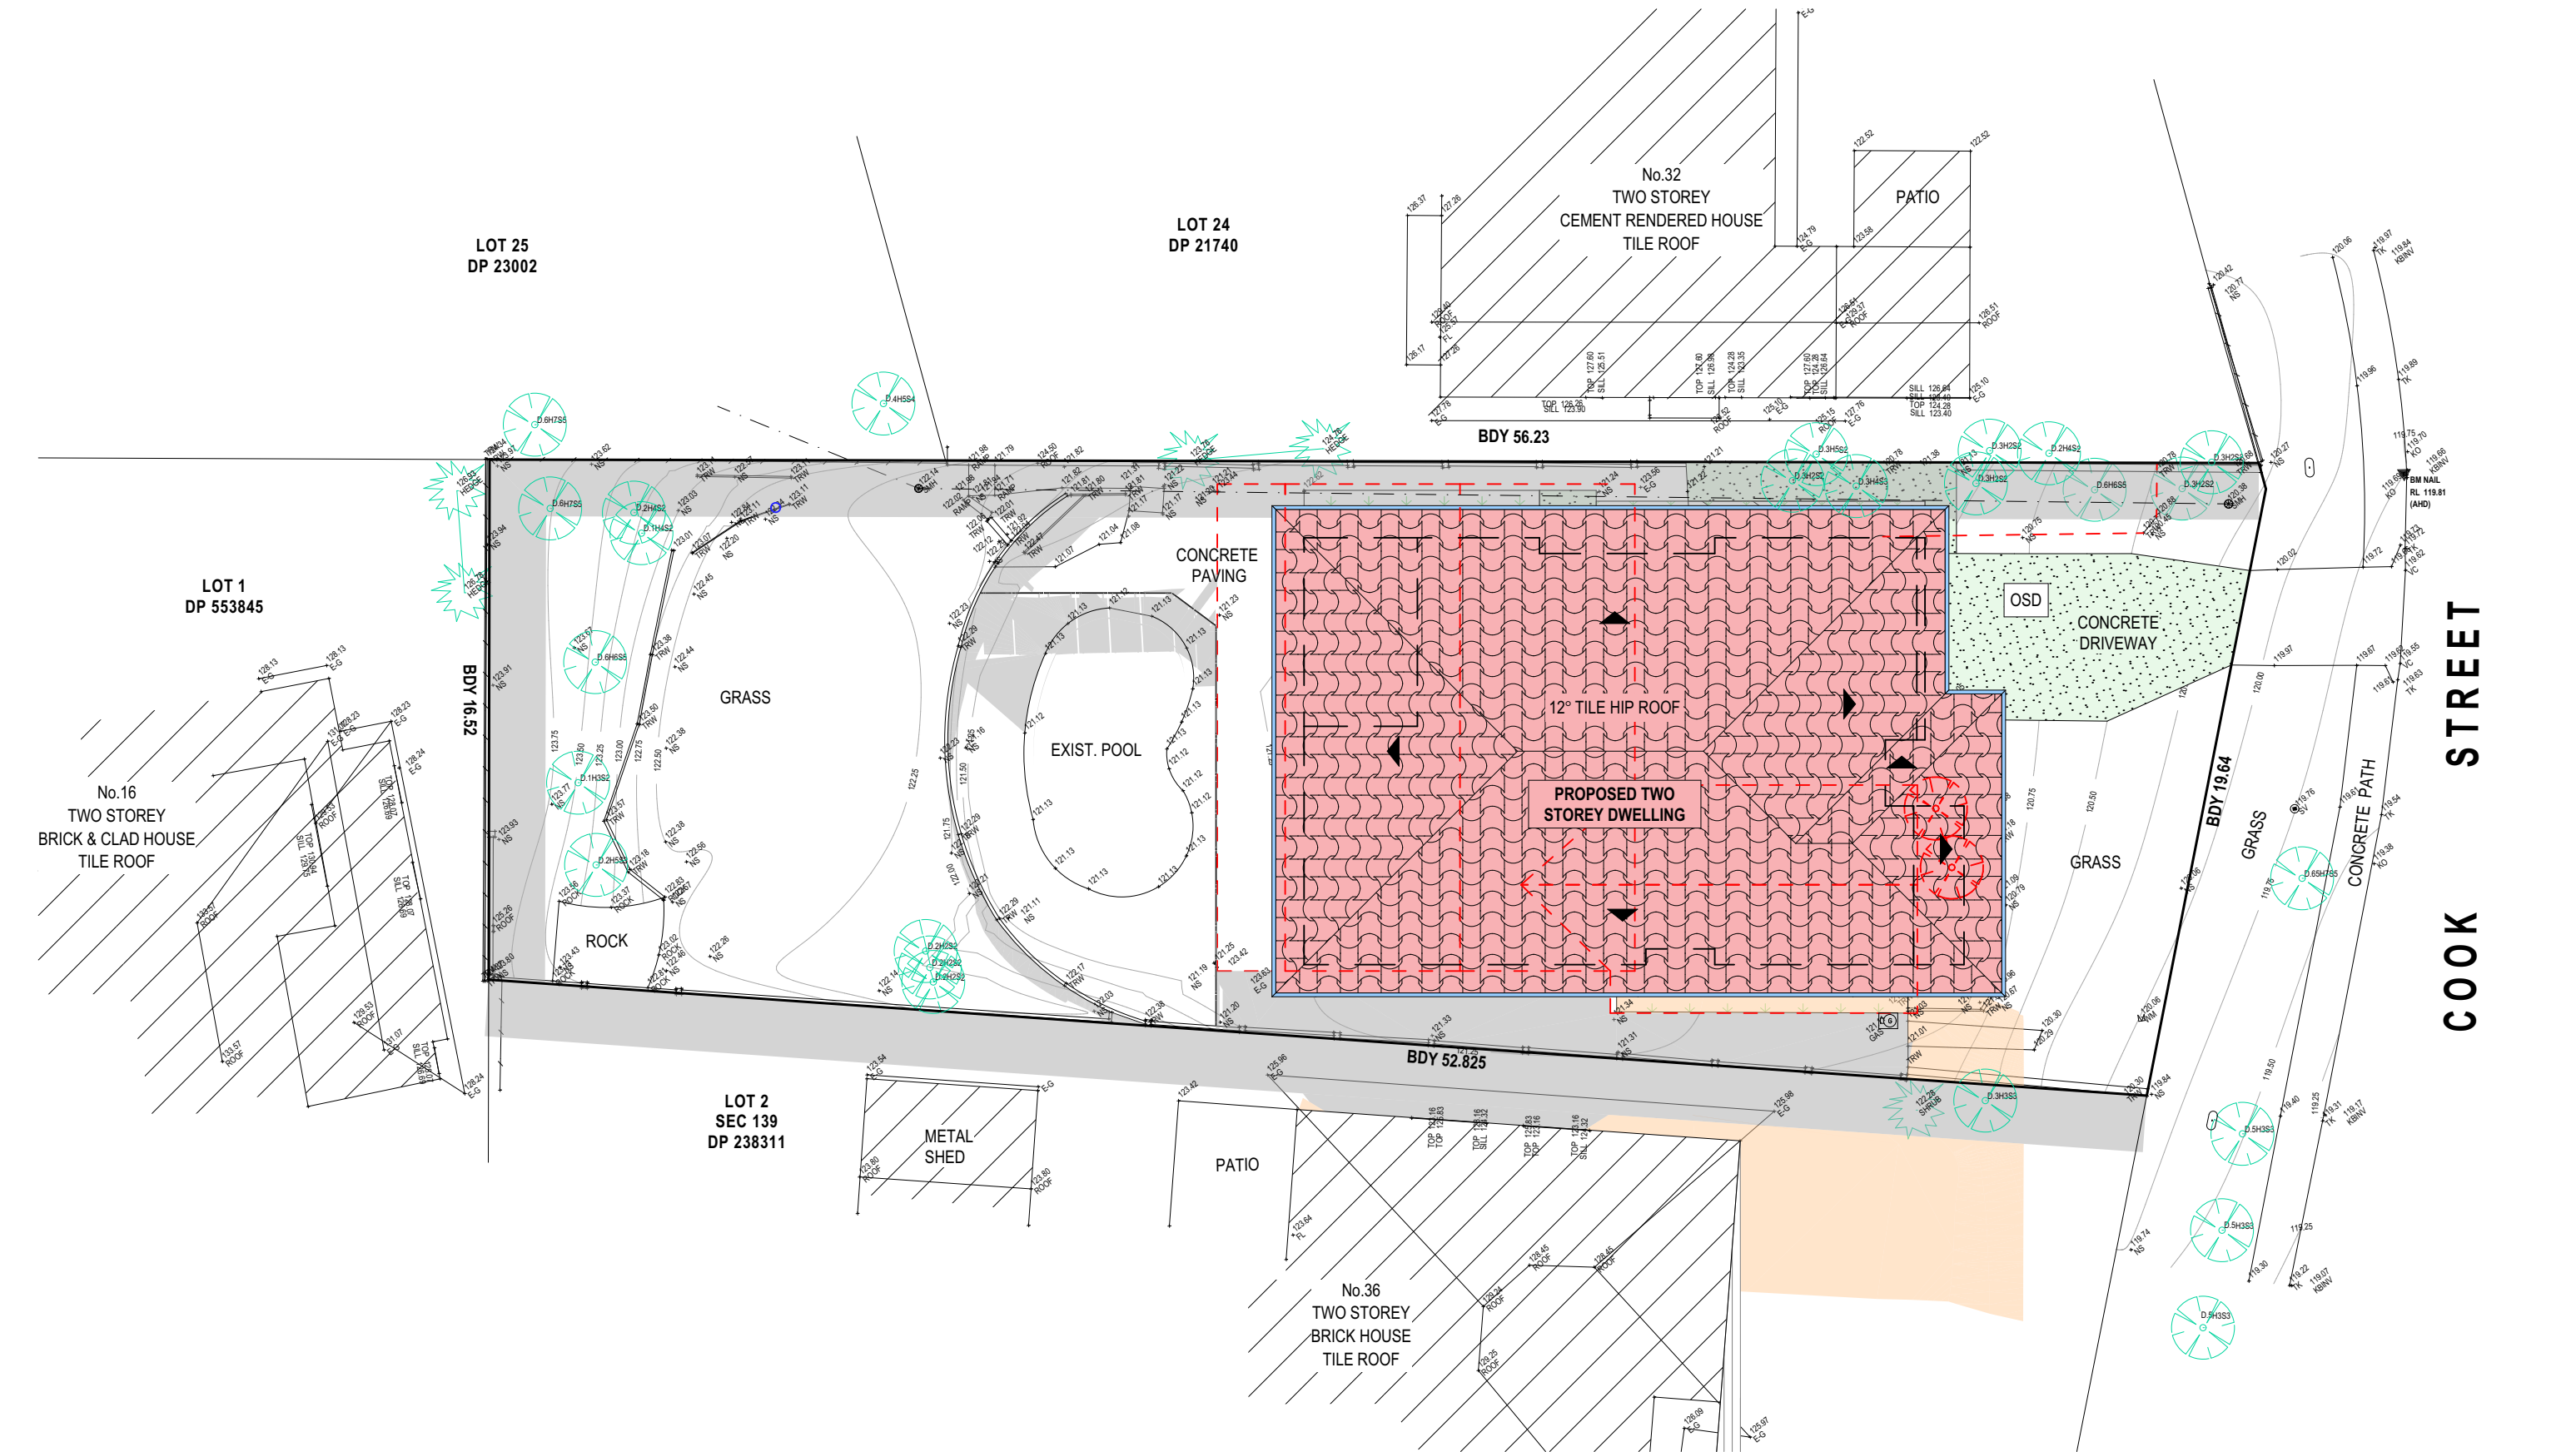
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bdaa

ACCREDITED
BUILDING DESIGNER



21 JUNE SHADOW DIAGRAM LEGEND

EXISTING SHADOWS

NEW SHADOWS

SHADOW DIAGRAM JUNE 21ST 12PM

TRUE NORTH:

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PO Box 687, Dee Why, NSW, 2099
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REV:	DATE:	DESCRIPTION:
(A)	11/9/2024	PRELIM. DESIGN - FLOOR PLANS
(B)	1/10/2024	PRELIM. REVISION
(C)	30/10/2024	PRELIM. REVISION
A	9/12/2024	DA DRAWINGS
B	8/1/2025	DA DRAWINGS (ADD NATHERS)
C	20/3/2025	DA DRAWING AMENDMENTS

PROPOSED NEW BUILD
34 COOK STREET, FORESTVILLE
CLIENT:
ANTONIO + AMANDA PETROLO

DRAWING TITLE:
SHADOW DIAGRAM JUNE 21 12 noon

JOB No:
1289/24

DRAWN BY:
AD

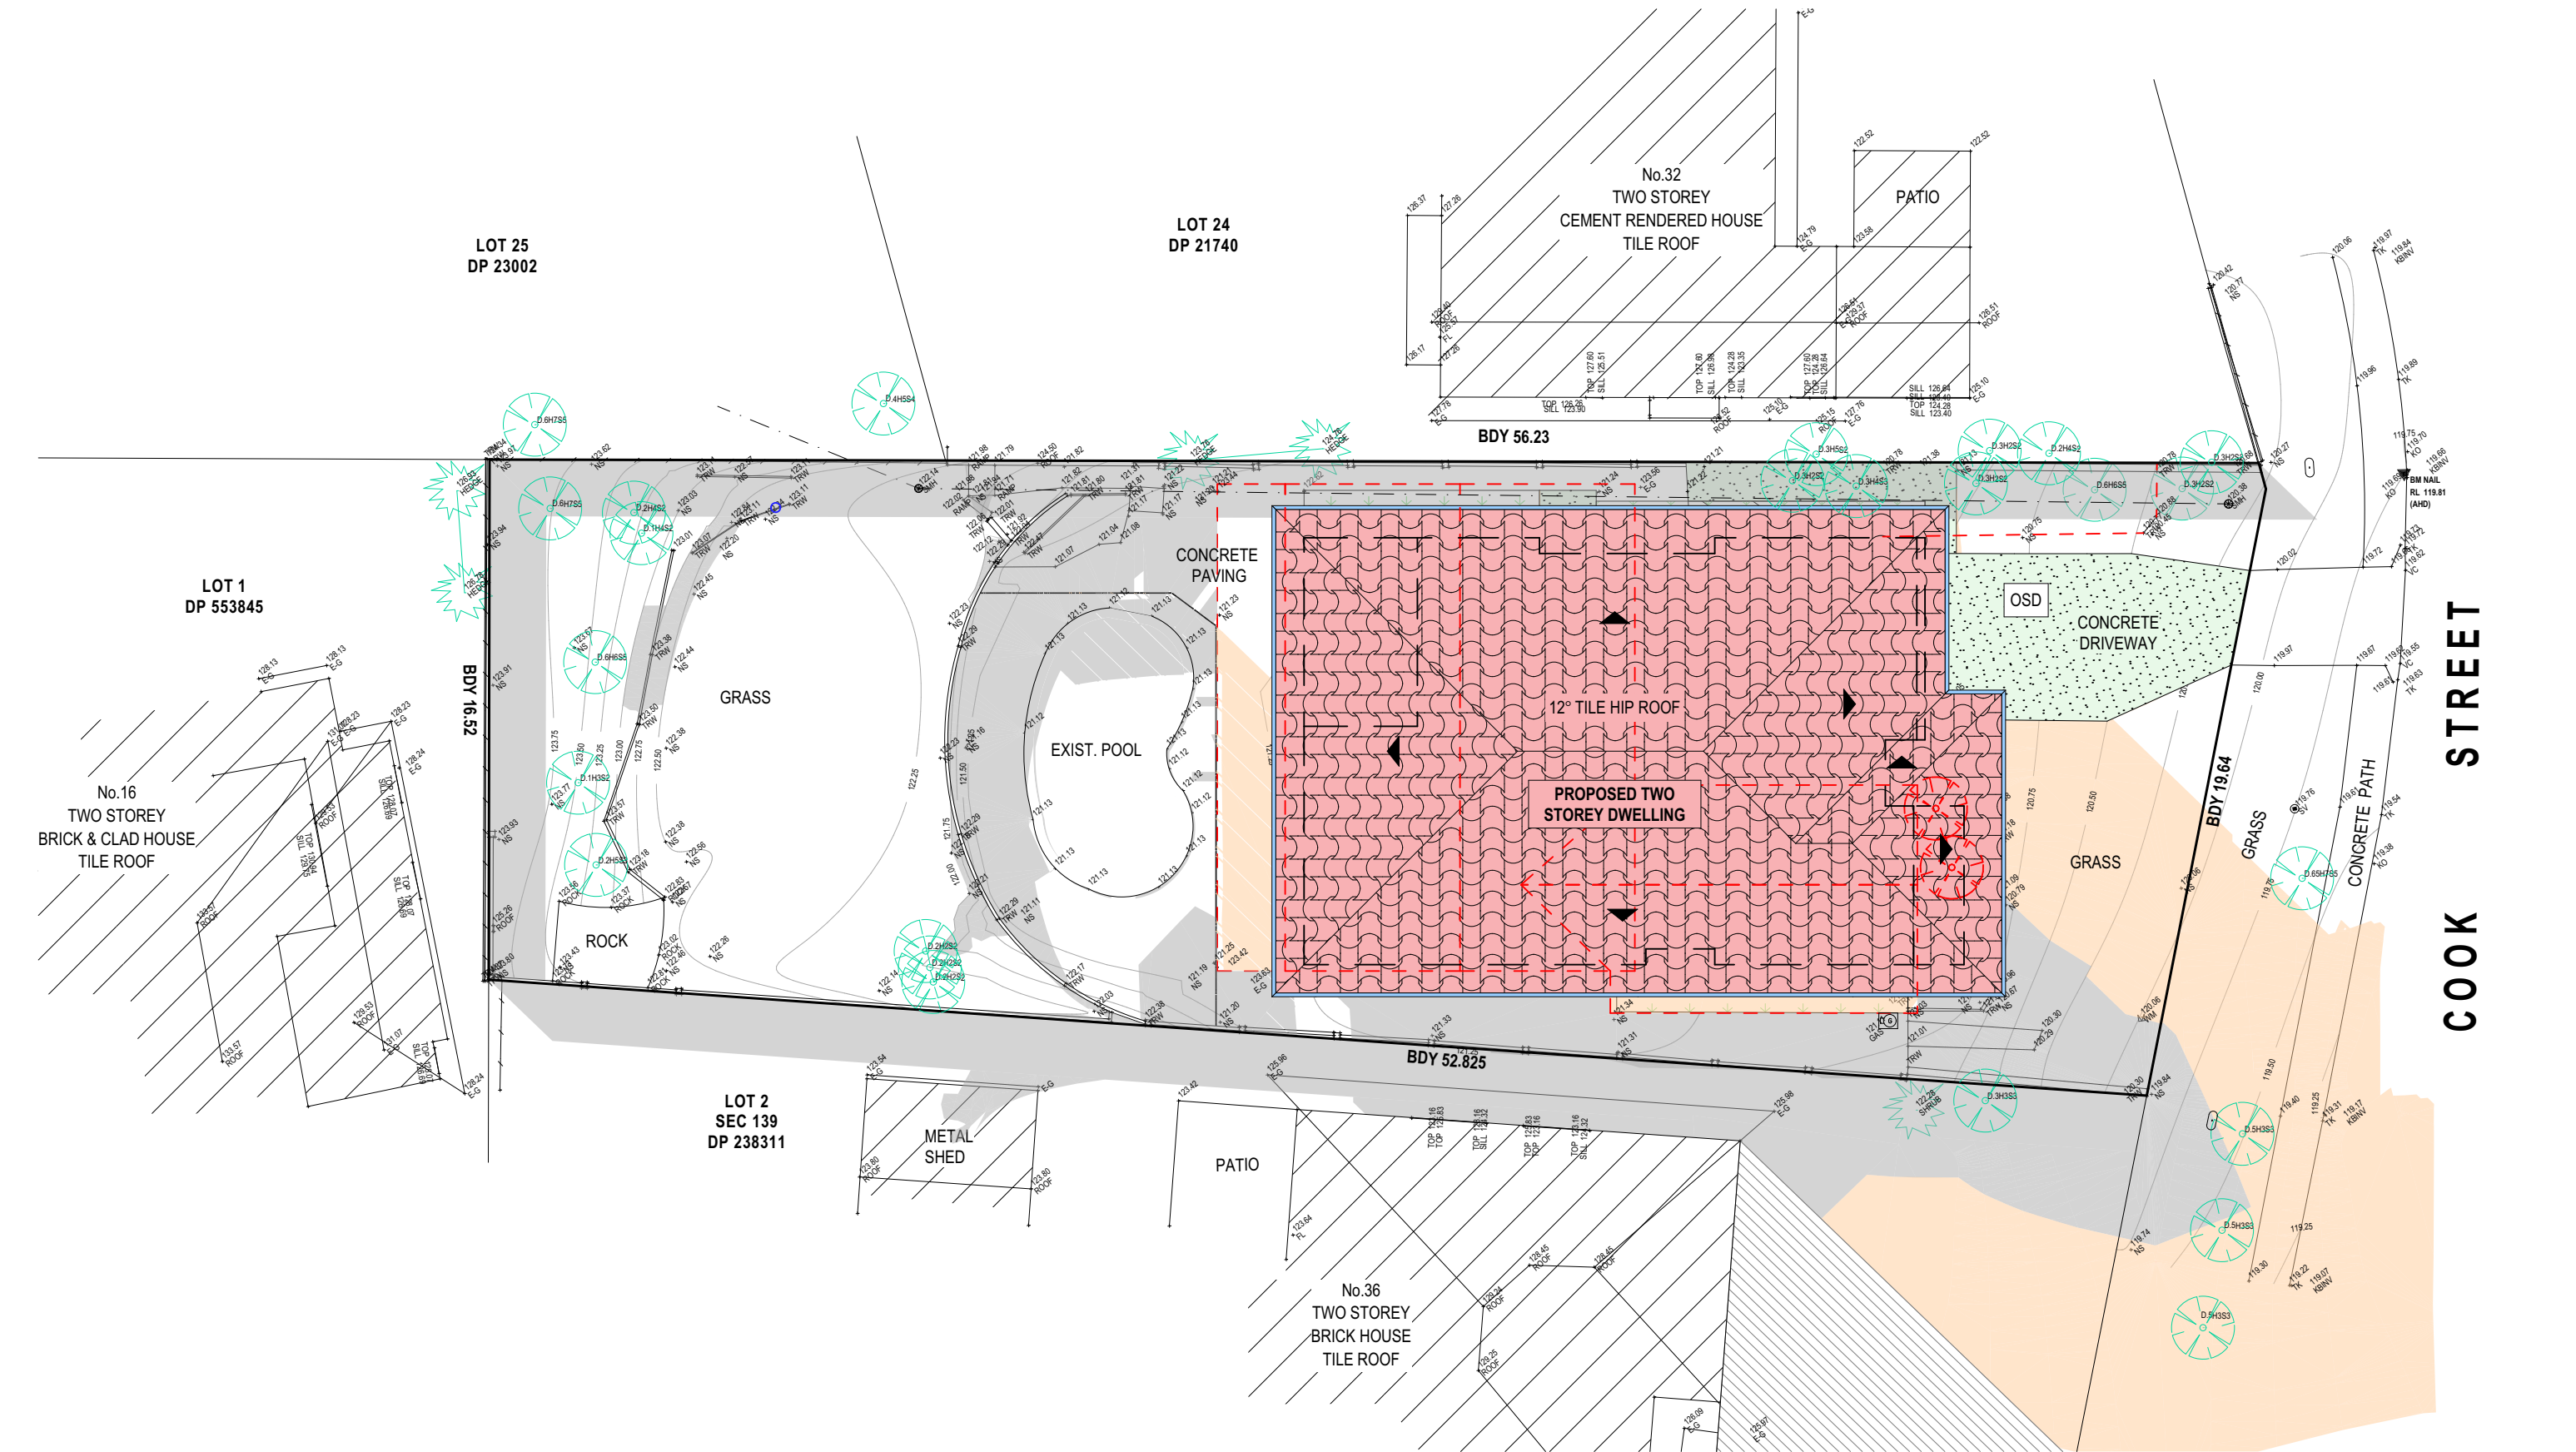
DATE:
AUG/24

SCALE:
1:200 @ A3

DRAWING No:
DA.14

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BUILDING DESIGNER

CHECKED BY:
JJ



21 JUNE SHADOW DIAGRAM LEGEND

EXISTING SHADOWS

NEW SHADOWS

SHADOW DIAGRAM JUNE 21ST 3PM

TRUE NORTH:

NOTES (E & OE)

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PRELIM. REVISION

(C)

30/10/2024

PRELIM. REVISION

A

9/12/2024

DA DRAWINGS

B

8/1/2025

DA DRAWINGS (ADD NATHERS)

C

20/3/2025

DA DRAWING AMENDMENTS

PROPOSED NEW BUILD

34 COOK STREET, FORESTVILLE

CLIENT:

ANTONIO + AMANDA PETROLO

DRAWING TITLE:

SHADOW DIAGRAM JUNE 21 3:00 pm

JOB No:

1289/24

DRAWN BY:

AD

DATE:

AUG/24

SCALE:

1:200 @ A3

DRAWING No:

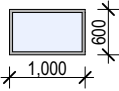
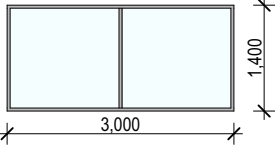
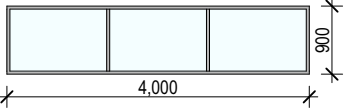
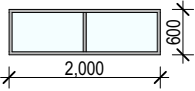
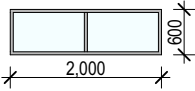
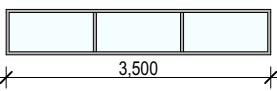
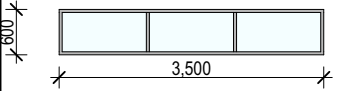
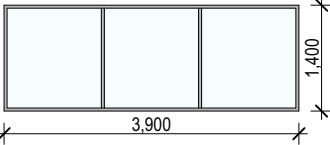
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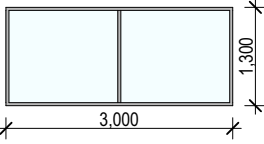
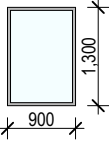
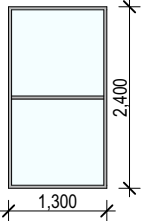
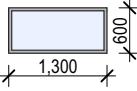
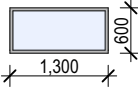
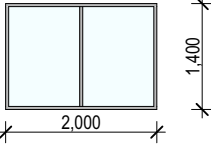
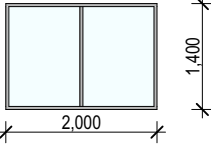
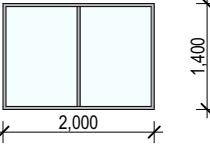
CHECKED BY:

JJ

bda

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BUILDING DESIGNER

LABEL ID	W1	W2	W3	W4	W5	W6	W7	W8
ORIENTATION	NORTH	NORTH	NORTH	NORTH	NORTH	NORTH	NORTH	EAST
ELEVATION								
LOCATION	GROUND FLOOR - BATHROOM	GROUND FLOOR - ENTERTAINMENT ROOM	GROUND FLOOR - GARAGE	FIRST FLOOR - BED 3	FIRST FLOOR - LIVING	FIRST FLOOR - LIVING	FIRST FLOOR - OFFICE / GUEST	GROUND FLOOR - BED 5
GLAZING	FROSTED	CLEAR	CLEAR	CLEAR	CLEAR	CLEAR	CLEAR	CLEAR

LABEL ID	W9	W10	W11	W12	W13	W14	W15	W16
ORIENTATION	EAST	EAST	EAST	SOUTH	SOUTH	SOUTH	SOUTH	SOUTH
ELEVATION								
LOCATION	FIRST FLOOR - OFFICE / GUEST	FIRST FLOOR - WIR	FIRST FLOOR - MASTER	GROUND FLOOR - WIR	GROUND FLOOR - ENS	GROUND FLOOR - FAMILY ROOM	GROUND FLOOR - DINING ROOM	GROUND FLOOR - LAUNDRY
GLAZING	CLEAR	CLEAR	CLEAR	FROSTED	FROSTED	CLEAR	CLEAR	CLEAR

NOTES

FRAME OPENING DIMENSIONS FOR WINDOWS & DOORS TO BE CONFIRMED ON SITE PRIOR TO ORDERING.

WINDOW SCHEDULE

NOTES (E & OE)

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PROPOSED NEW BUILD

34 COOK STREET, FORESTVILLE

CLIENT:

ANTONIO + AMANDA PETROLO

DRAWING TITLE:

OPENING SCHEDULE

JOB No:

1289/24

DRAWN BY:

AD

DATE:

AUG/24

SCALE:

1:1 @ A3

DRAWING No:

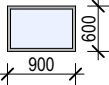
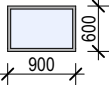
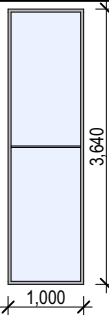
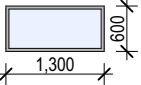
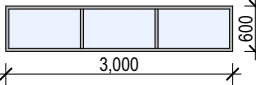
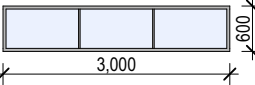
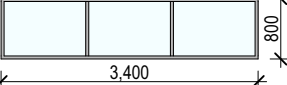
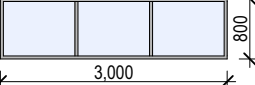
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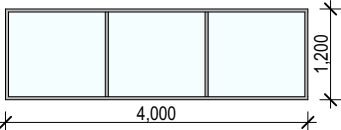
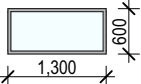
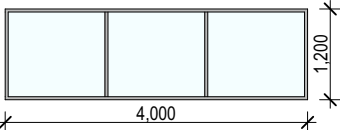
CHECKED BY:

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BUILDING DESIGNER

LABEL ID	W17	W18	W19	W20	W21	W22	W23	W24
ORIENTATION	SOUTH	SOUTH	SOUTH	SOUTH	SOUTH	SOUTH	WEST	WEST
ELEVATION								
LOCATION	FIRST FLOOR - ENS	FIRST FLOOR - ENS	FIRST FLOOR - STAIR	FIRST FLOOR - BATHROOM	FIRST FLOOR - BED 4	FIRST FLOOR - BED 2	GROUND FLOOR - KITCHEN	GROUND FLOOR - BILLIARDS
GLAZING	FROSTED	FROSTED	FROSTED	FROSTED	FROSTED	FROSTED	CLEAR	FROSTED

LABEL ID	W25	W26	W27
ORIENTATION	WEST	WEST	WEST
ELEVATION			
LOCATION	FIRST FLOOR - BED	FIRST FLOOR - LINEN	FIRST FLOOR - BED 3
GLAZING	CLEAR	CLEAR	CLEAR

NOTES

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PROPOSED NEW BUILD
34 COOK STREET, FORESTVILLE
CLIENT:
ANTONIO + AMANDA PETROLO

DRAWING TITLE:
OPENING SCHEDULE

JOB No:
1289/24

DRAWN BY:
AD

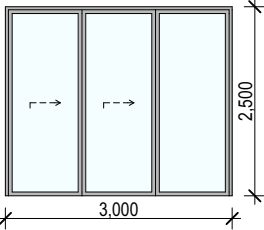
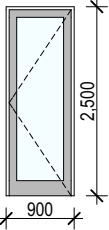
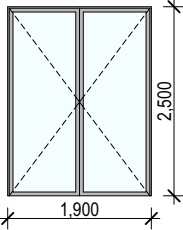
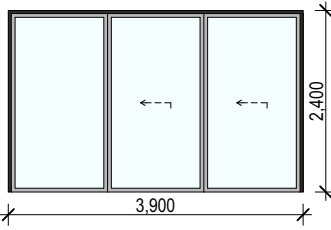
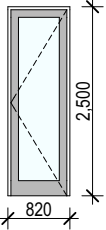
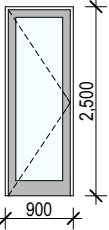
DATE:
AUG/24

SCALE:
1:1 @ A3

DRAWING No:
DA.17

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BUILDING DESIGNER

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LABEL ID	D1	D2	D3	D4	D5	D6
ORIENTATION	WEST	NORTH	EAST	EAST	WEST	WEST
ELEVATION						
LOCATION	GROUND FLOOR	GROUND FLOOR	GROUND FLOOR (FRONT ENTRY)	FIRST FLOOR	GROUND FLOOR	GROUND FLOOR
TYPE	STACKER	HINGED	DOUBLE DOOR HINGED	STACKER	HINGED	HINGED
GLAZING	CLEAR	CLEAR	CLEAR	CLEAR	CLEAR	CLEAR

DOOR SCHEDULE

NOTES

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PROPOSED NEW BUILD

34 COOK STREET, FORESTVILLE

CLIENT:

ANTONIO + AMANDA PETROLO

DRAWING TITLE:

OPENING SCHEDULE

JOB No:

1289/24

DRAWN BY:

AD

DATE:

AUG/24

SCALE:

1:1 @ A3

DRAWING No:

DA.18



ACCREDITED
BUILDING DESIGNER

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