DEVELOPMENT APPLICATION (REV C)


34 COOK STREET, FORESTVILLE



CONTENTS DRAWING TITLE SITE ANALYSIS PLAN DEMOLITION PLAN **PAGE** DA.01 DA.02 FLOOR PLAN FLOOR PLAN ELEVATIONS SHEET 1 ELEVATIONS SHEET 2 DA.03 DA.04 DA.05 DA.06 SECTIONS BASIX DA.07 BASIX SPECIFICATIONS LANDSCAPED AREA CALCULATION PLAN ROOF & STORMWATER CONCEPT PLAN EROSION & SEDIMENT CONTROL / WASTE MANAGEMENT PLAN SHADOW DIAGRAM JUNE 21 9:00 am SHADOW DIAGRAM JUNE 21 12 noon SHADOW DIAGRAM JUNE 21 3:00 pm OPENING SCHEDULE OPENING SCHEDULE OPENING SCHEDULE DA.08 DA.09 DA.10 DA.11 DA.12 DA.13 DA.14 DA.15 DA.16 DA.17 DA.18



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- including amendments of the National Construction Code, relevant Australian Standards & loca council requirements.

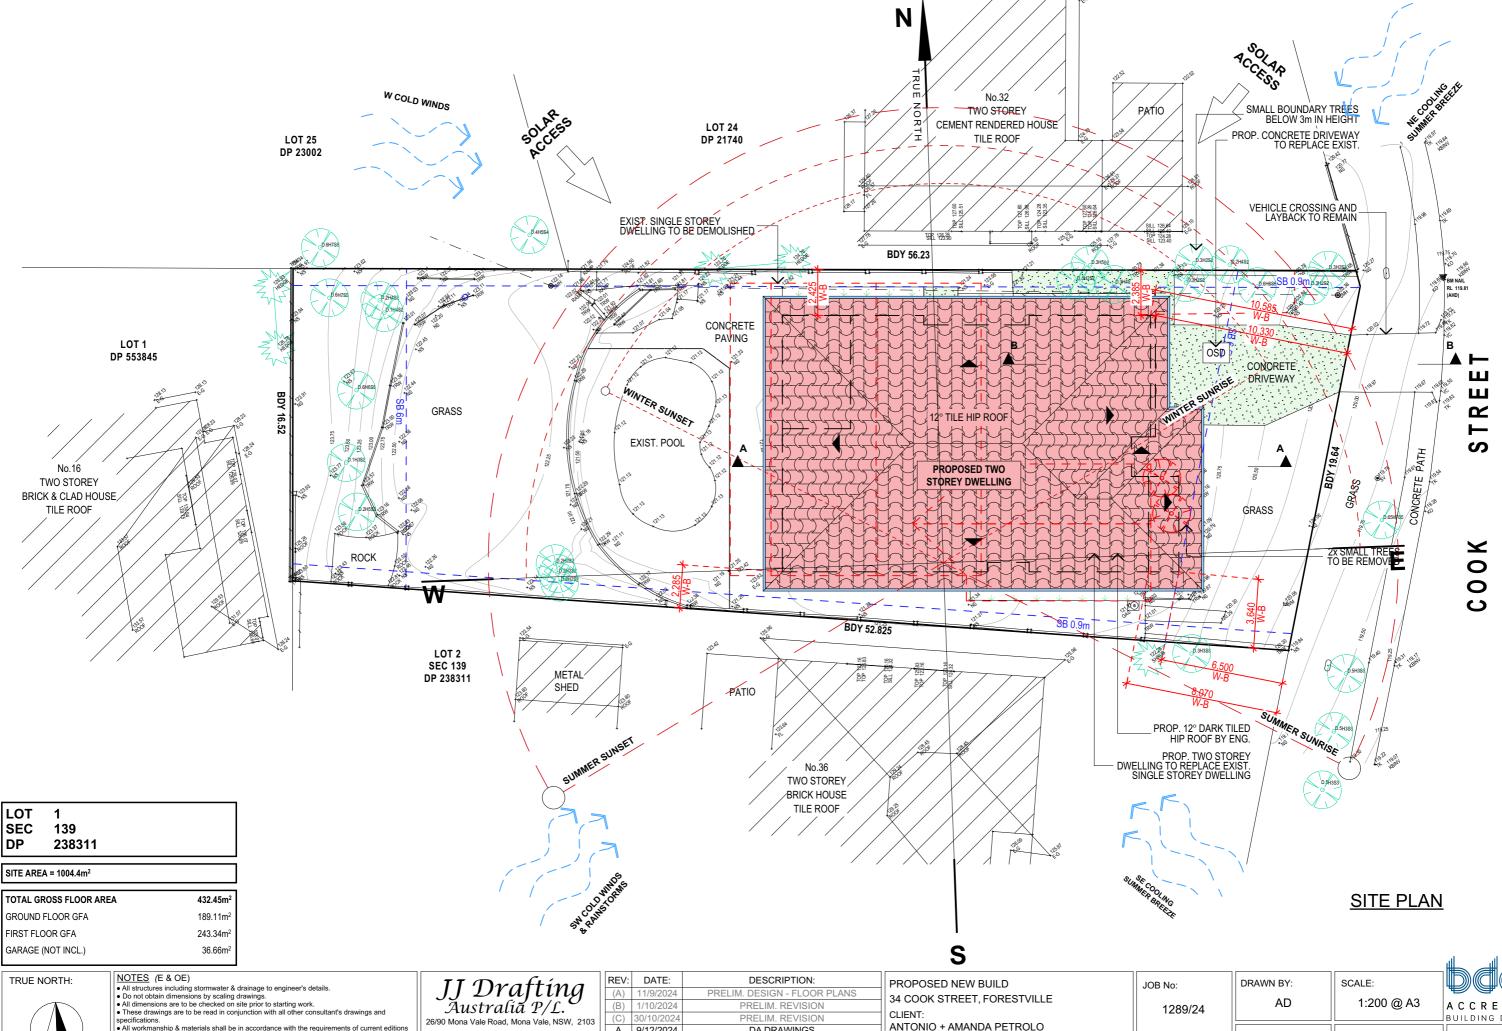 New materials are to be used throughout unless otherwise noted.


 Concrete footings, slab, structural beams or any other structural members are to be designed.
- by a practicing engineer.

PO Box 687, Dee Why, NSW, 2099 Mob. 0414 717 541 | ACN 651 693 346 Email. enquiries@jjdrafting.com.au www.jjdrafting.com.au

- 1	I \ L \ V .	DAIL.	DESCRIPTION.			
	(A)	11/9/2024	PRELIM. DESIGN - FLOOR PLANS			
	(B)	1/10/2024	PRELIM. REVISION			
.	(C)	30/10/2024	PRELIM. REVISION			
	Α	9/12/2024	DA DRAWINGS			
	В	8/1/2025	DA DRAWINGS (ADD NATHERS)			
	С	20/3/2025	DA DRAWING AMENDMENTS			

PROPOSED NEW BUILD	JOB No:	DRAWN BY:
34 COOK STREET, FORESTVILLE	4000/04	AD
CLIENT:	1289/24	
ANTONIO + AMANDA PETROLO		DATE.
DRAWING TITLE:		
SITE ANALYSIS PLAN		AUG/24

ACCREDITED BUILDING DESIGNER DRAWING No: CHECKED BY: **DA.01** JJ

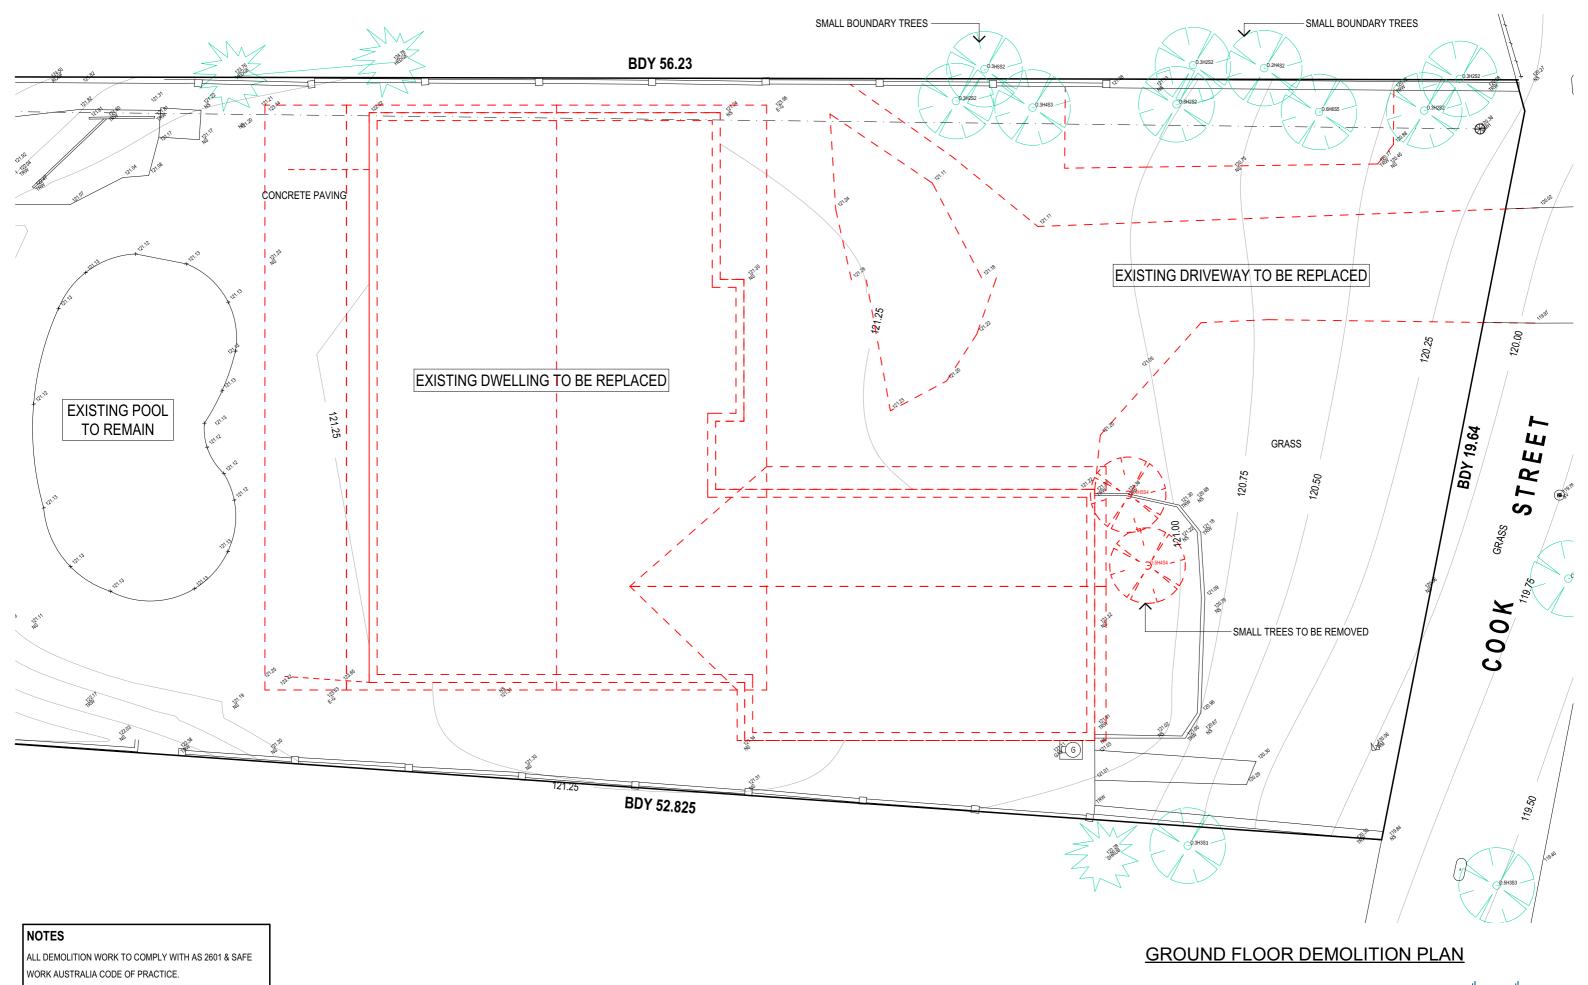

TRUE NORTH:

- NOTES (E & OE)

 All structures including stormwater & drainage to engineer's details.

 Do not obtain dimensions by scaling drawings.
 All dimensions are to be checked on site prior to starting work.
- All WORKHAMSHIP & TRIBERTION AND ASSESSED AND ASSESSED ASSESS

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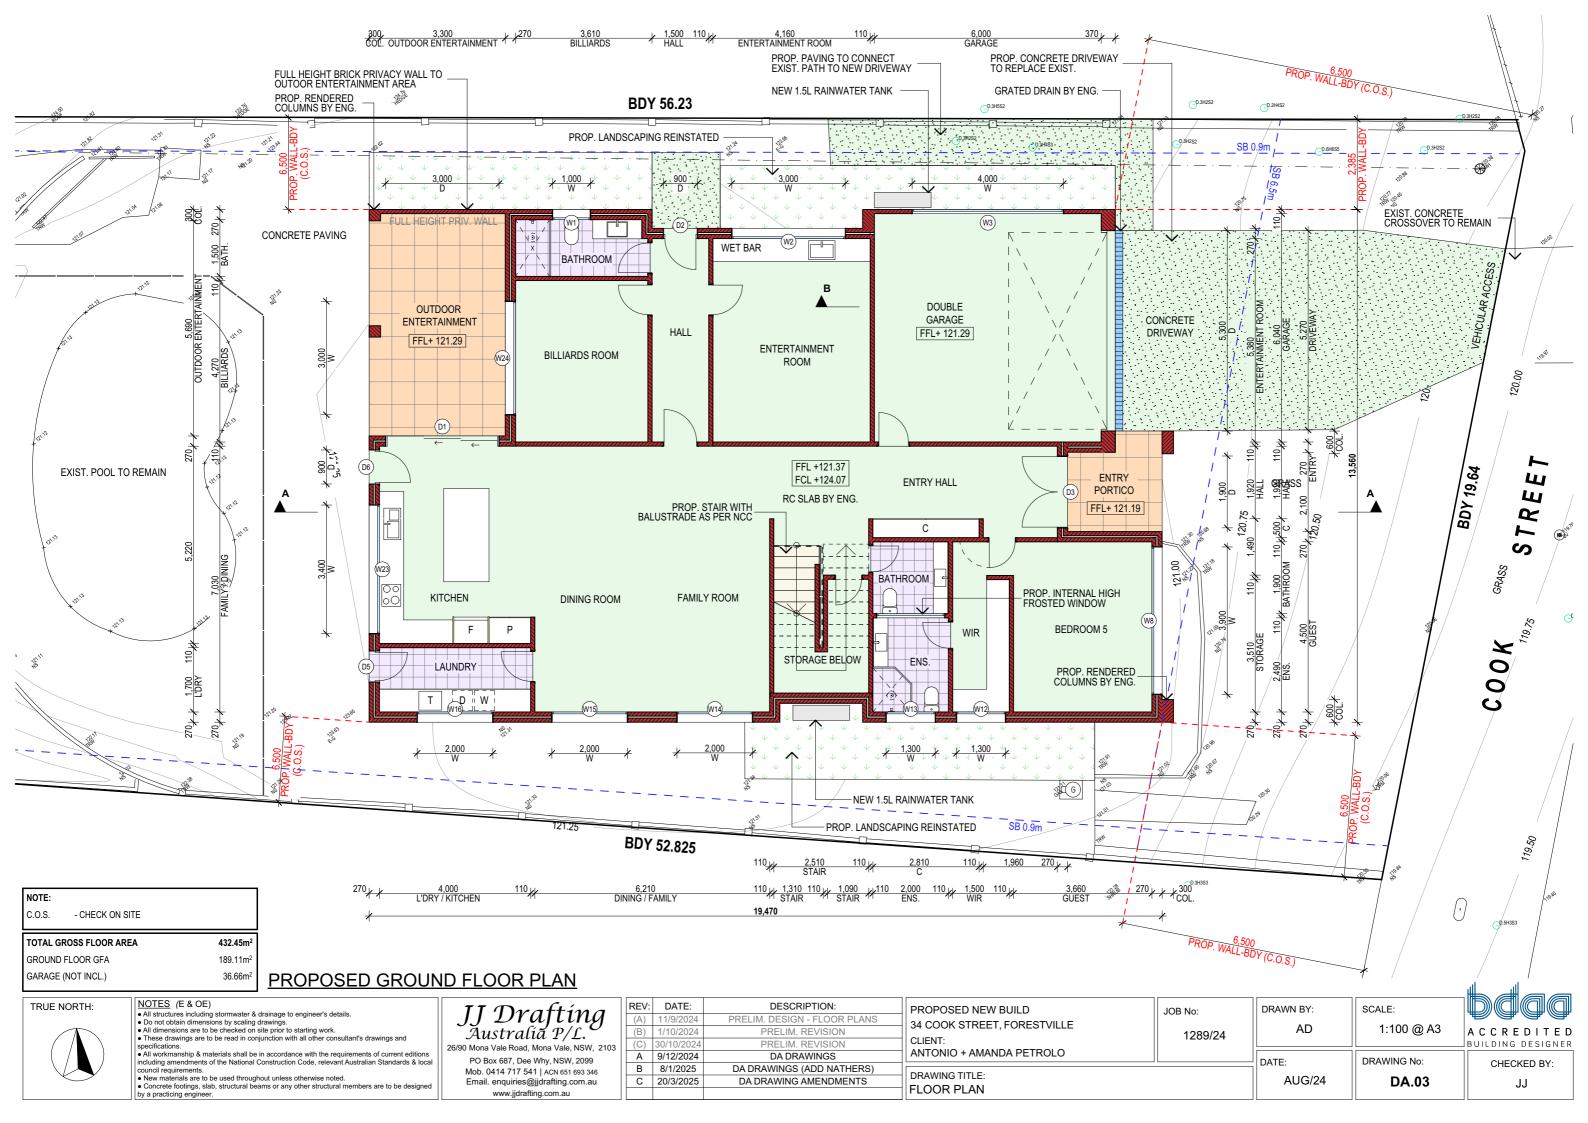
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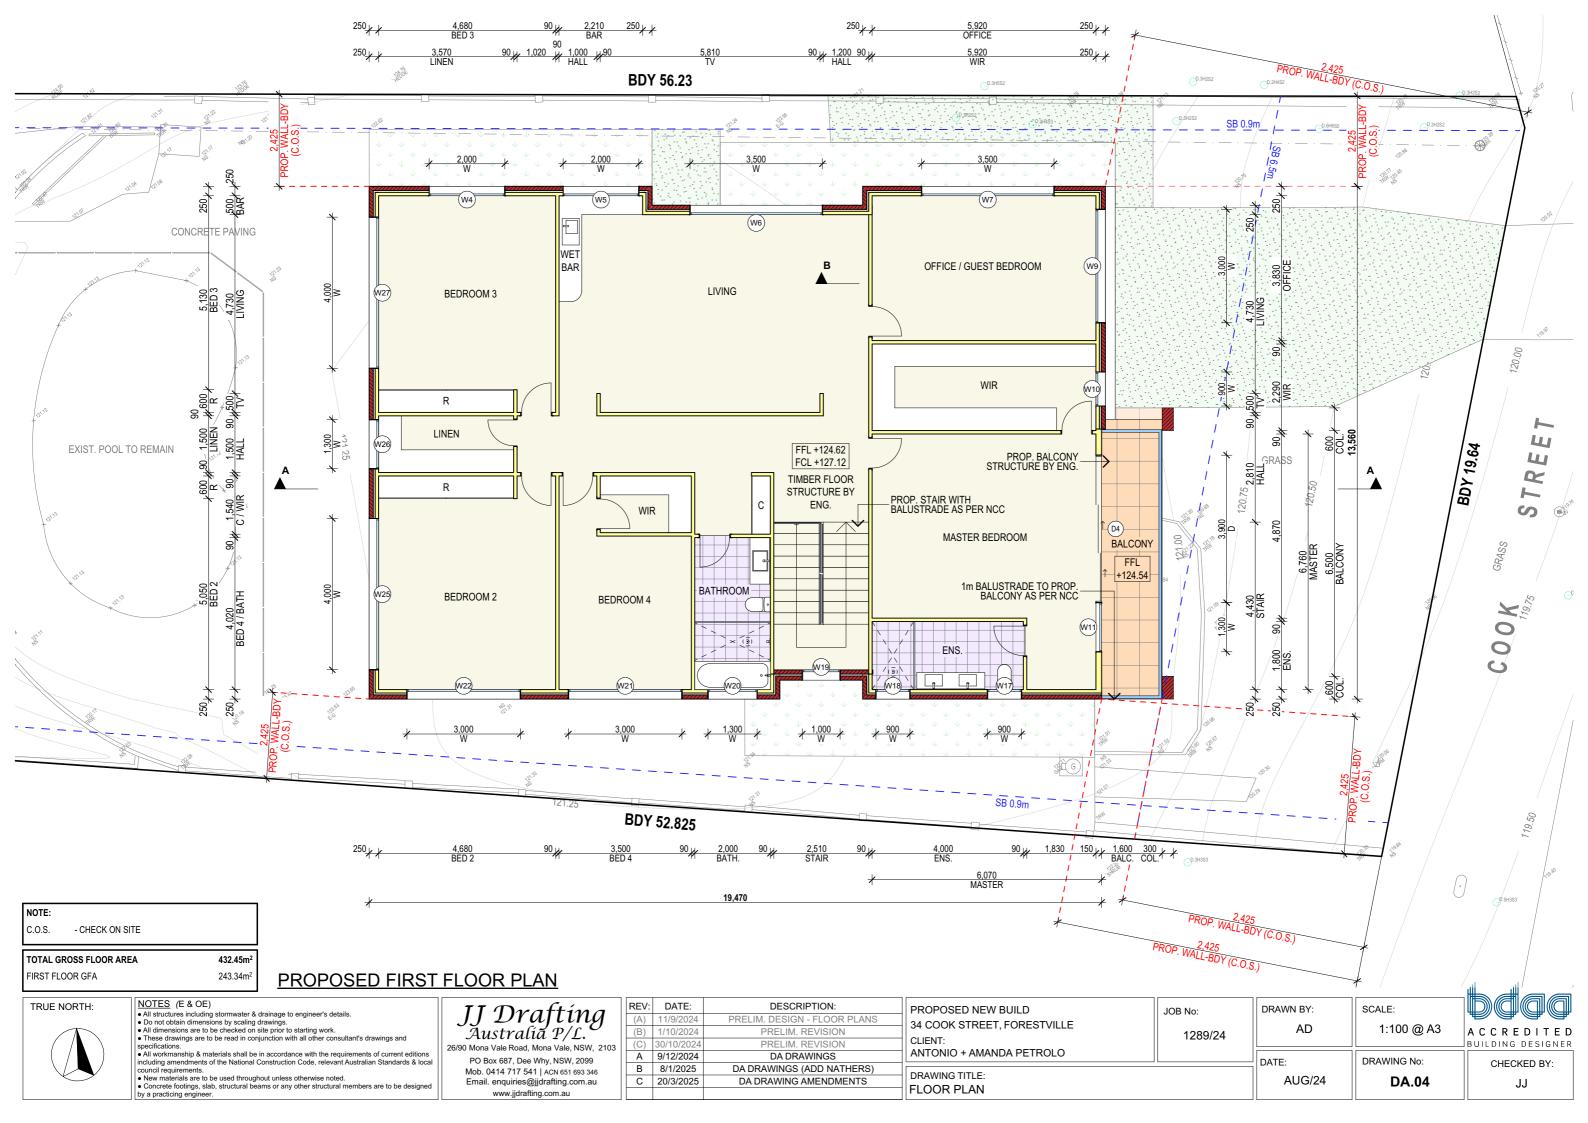
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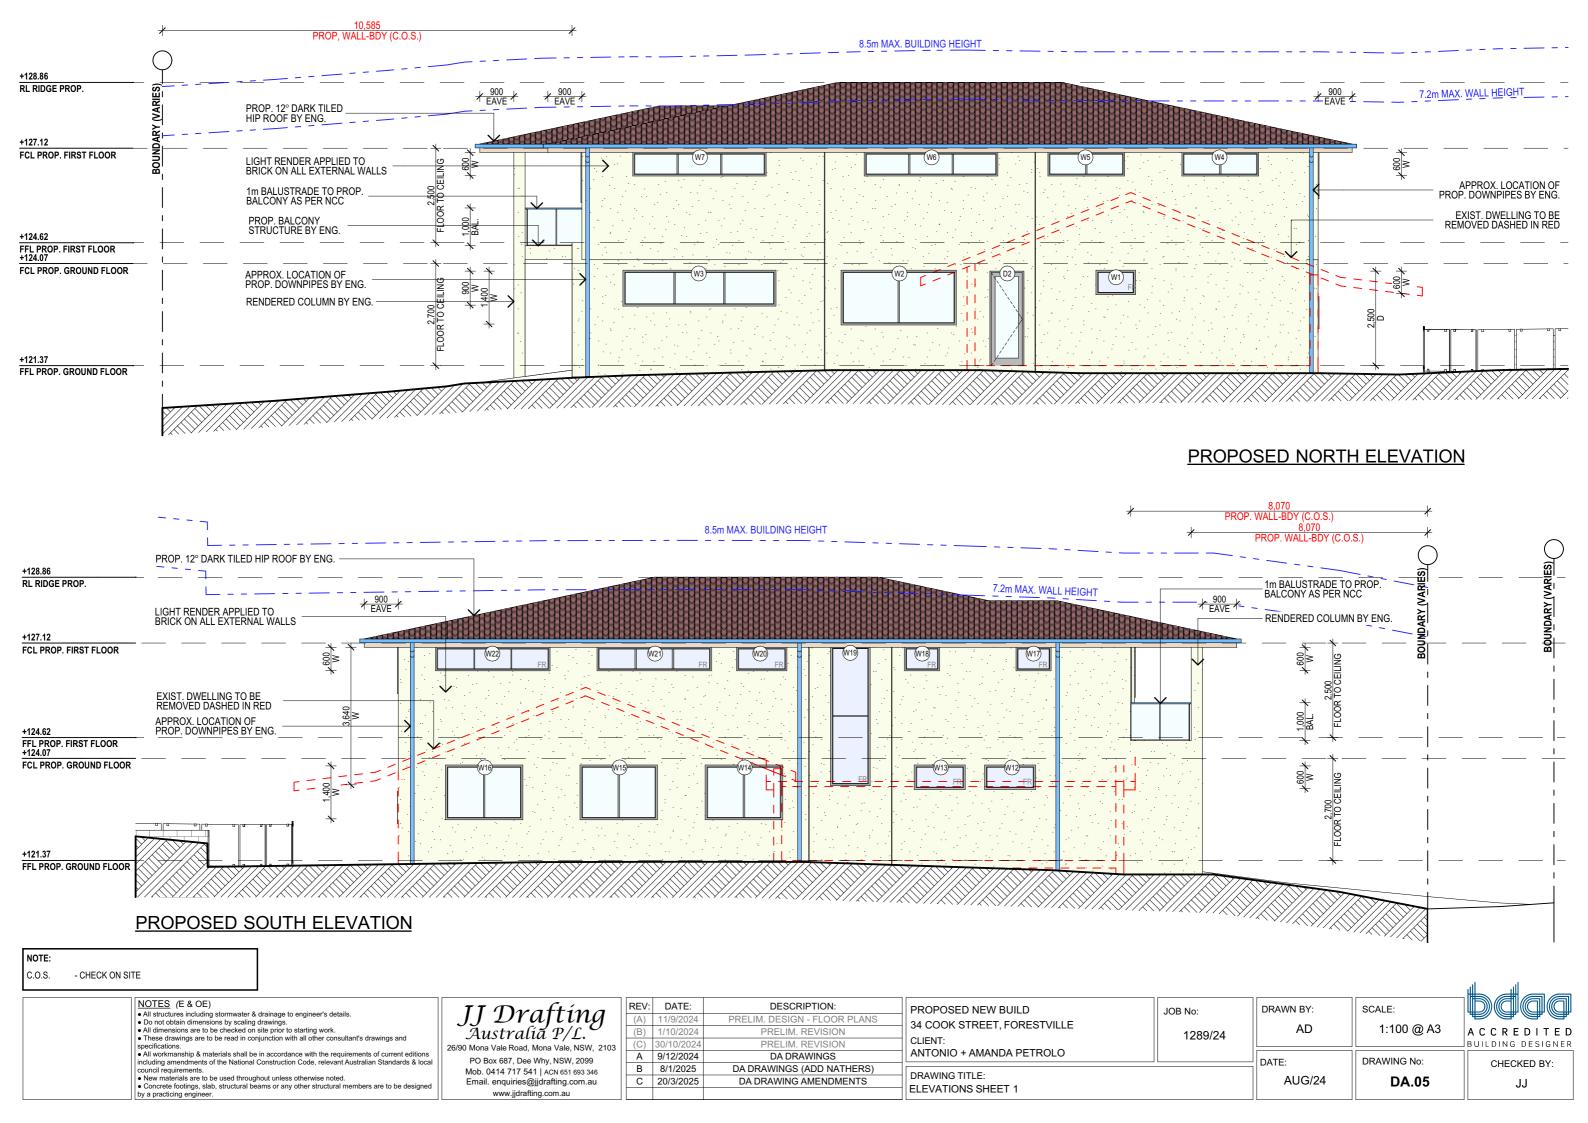
PROPOSED NEW BUILD	JOB No:	DRAWN E
34 COOK STREET, FORESTVILLE	4000/04	A
CLIENT:	1289/24	
ANTONIO + AMANDA PETROLO		DATE:
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AD	1:100 @ A3	A C C R E D I T E D BUILDING DESIGNER
DATE:	DRAWING No:	CHECKED BY:
AUG/24	DA.02	JJ

JJ









PROPOSED WEST ELEVATION



NOTE:

C.O.S. - CHECK ON SITE

NOTES (E & OE)

- All structures including stormwater & drainage to engineer's details.
 Do not obtain dimensions by scaling drawings.
 All dimensions are to be checked on site prior to starting work.
- specifications.

 All workmanship & materials shall be in accordance with the requirements of current editions
- New materials are to be used throughout unless otherwise noted.
 Concrete footings, slab, structural beams or any other structural members are to be designed. by a practicing engineer.


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1	PROPOSED NEW BUILD	JOB No:	
1	34 COOK STREET, FORESTVILLE CLIENT: ANTONIO + AMANDA PETROLO	1289/24	Ļ
	DRAWING TITLE: ELEVATIONS SHEET 2		D

AUG/24	DA.06	JJ	
ATE:	DRAWING No:	CHECKED BY:	
AD		A C C R E D I T E D BUILDING DESIGNER	
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SECTION AA



SECTION BB AND DRIVEWAY SECTION

NOTES (E & OE) All structures including stormwater & drainage to engineer's details. Do not obtain dimensions by scaling drawings. All dimensions are to be checked on site prior to starting work.

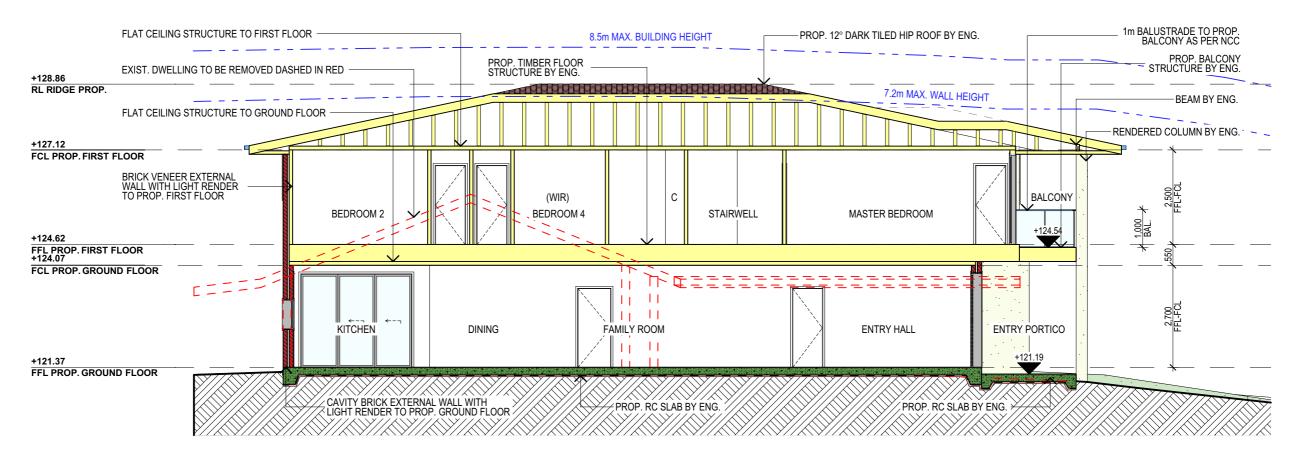- specifications.

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- New materials are to be used throughout unless otherwise noted.
 Concrete footings, slab, structural beams or any other structural members are to be designed. Mob. 0414 717 541 | ACN 651 693 346 Email. enquiries@jjdrafting.com.au www.jjdrafting.com.au by a practicing engineer.

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PROPOSED NEW BUILD 34 COOK STREET, FORESTVILLE CLIENT: ANTONIO + AMANDA PETROLO	JOB No: 1289/24	DRA
DRAWING TITLE: SECTIONS		DAT

RAWN BY:	SCALE:	
AD	1:100 @ A3	A C C R E D I T E D BUILDING DESIGNER
		BUILDING DESIGNER
ATE:	DRAWING No:	CHECKED BY:
AUG/24	DA.07	JJ

TO BE UPDATED

			Basi	x Requirer	nents Summ	ary				
New Dwelling										
34 Cook Street			www.cesene				B.E.R.S	HOUSE		
FORESTVILLE	NSW	2087	1300 004 9	14			B.E.R.S	68 va.	CHA	PMAN
								and a second second	LIVINOITI	MINL DERVICES
Water Target		40	Water Score			41	Conditioned			411.3
Energy Target		72	Energy Score			89	Uncondition	ned Area		22.1
Max H & C Loads are (N	1J/m²)	30	Actual H & C I	Loads are (MJ/m²)	29.8	Star Rating			7
	1=	<u> </u>	(2)		nmitments				. (3)	_
Landscaping	Total area o	f garden & la	awn (m²)	400		Area of indi	genous/low	water use pla	ants (m²)	0
Fixtures	Shower hea	ıds	1 star (> 1 5	Shut <= 61	/min\	Toilets	4 star		All taps	4 star
Fixtures Shower heads 4 star (> 4.5 but <= 6 L/min) Toilets 4 star All taps 4 star									4 3(a)	
	Minimum R	ainwater tar	nk size (L)	3000		Collect ru	n off from ro	of area of at	least (m²)	100
Alternative Water	Toilet co	nnection	Laundry cor	nnoction	Landscane	connection		op up		top up
7.11.00.11.00.11.00.11.00.11		es	No			es		.ор ир /a		ı/a
	T	es	INO		1	es	"	/ d		1/ d
Pool and Spa	Max pool vo	olume (kL)	n/a							
		\ \ \ \ \ \ \ \ \ \ \ \ \ \ \ \ \ \ \	, ~							
	Hot water s		Gas instantan				Rating	5 star		
	Bathroom v	entilation	Individual fan	, ducted to	facade or ro	oof	with		witch on/off	
	Kitchen ven	tilation	Individual fan	, ducted to	facade or ro	oof	with	Manual sv	witch on/off	
	Laundry ver	ntilation	Natural ventil	ation only,	or no laund	ry				
Enorm	Cooling - liv	ing areas	1-phase airco	nditioning			Rating	EER 3.0 - 3	3.5	
Energy	Cooling - be	drooms	1-phase airco				Rating	EER 3.0 - 3	3.5	7anad
	Heating - liv		1-phase airco				Rating	EER 3.0 - 3	3.5	Zoned
	Heating - bedrooms 1-phase airconditioning					Rating	EER 3.0 - 3		1	
	Alternate Er	nergy	Photovoltaic s		e to generate	e at least	min 3.0	peak kilowa	tts of electri	citv
		& gas oven		0	utdoor cloth	esline requir			or clotheslin	
	•		•			•		•		
		Thermal Pe	erformance Ass	sessment B	ased on the	Following Re	equirements			
Floor Torres	Concrete sla	ab on ground			with		slab insulation			
Floor Types	Suspended				with	R2.5 bulk in				
Floor Coverings	Tiles	Living / We	t areas			Timber	n/a			
rioor coverings	Carpet	Bedrooms				Concrete	Garage			
	Ic. 11 1.1.1				***	D4 2	1		0.1	
External Walls	Cavity brick				with	R1.2 cavity		1	Colour	Light
	Brick venee	r			with	Sarking and	R2.5 bulk in:	sulation	Colour	Light
	Single skin b	nrick			with	Nil				
Internal Walls	Plasterboar				with	No insulatio	n required			
	i iusterbour	u			WICH	140 madada	ii required			
Ceiling (floor over)	Timber above plasterboard				with	R2.0 bulk in	sulation			
Ceilings (roof over)	Timber abov	ve plasterbo	ard.		with	R5.0 bulk in	sulation			
Doof	Tiles		22			Carlina			Calarin	Davil
Roof	Tiles		22	degrees	with	Sarking			Colour	Dark
	AF double g	lazed clear -	Lightbridge		Sliding W	AWS-047-323	U-Valu	e 3.70 or less	S I SHGC 0.4	5 +/- 5%
		,	3		Awning W	AWS-008-025		e 3.40 or less		
					D-Hung W	VAN-002-042		e 3.70 or less		
					Fixed W	AWS-071-009		e 2.70 or less		
Windows and Doors	to all windows	s and glazed do	ors unless noted	otherwise	Sliding D	AWS-036-053		e 3.00 or less		
					Hinged D	AWS-019-038		e 3.20 or less		
					i iii geu D	71473 013-030	5 valu	C 3.20 01 1033	7 31100 0.3	3 1 370
	AF = Aluminiu	m Framed	TB = Thermally B	Broken Alumi	nium Framed		TF = Timber Fr	amed	1	
						ventilated LED /				
	If the Universal Certificate indicates downlights, then these are to be non-ventilated LED / fluorescent Any exhaust fans noted are to be fitted with self-closing dampers or be otherwise sealed									
				-						l
1	All insulation specified must be installed in accordance with Part 3.12.1.1 of the BCA									

This document to be read in conjunction with the Basix Certificate and Nathers Universal Certificate

- NOTES (E & OE)

 All structures including stormwater & drainage to engineer's details.

 Do not obtain dimensions by scaling drawings.

 All dimensions are to be checked on site prior to starting work.

 These drawings are to be read in conjunction with all other consultant's drawings and specifications.

 All workmanship & materials shall be in accordance with the requirements of current editions including amendments of the National Construction Code, relevant Australian Standards & local council requirements.

 New materials are to be used throughout unless otherwise noted.

 Concrete footings, slab, structural beams or any other structural members are to be designed by a practicing engineer.

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PROPOSED NEW BUILD
34 COOK STREET, FORESTVILLE
CLIENT: ANTONIO + AMANDA PETROLO
DRAWING TITLE:

BASIX

JOB No:	DRAWN BY:	SCALE:
1289/24	AD	1:1

@ A3 ACCREDITED BUILDING DESIGNER DATE: DRAWING No: CHECKED BY: AUG/24 **DA.08** JJ

SPECIFICATION NOTES

- PROVIDE PLASTERBOARD LINING.

- INSTALL TO MANUFACTURERS SPECIFICATIONS & AS 2589

EXTERNAL WALLS:

- BRICK VENEER WALLS WITH SELECTED BRICKS TO DWELLING.

- ALL EXTERNAL WALL CLADDINGS MUST BE COMPLIANT WITH THE REQUIREMENTS OF NCC 2022 - ABCB HOUSING PROVISIONS PART 7, AS1684 AND ALL RELEVANT CODEMARK CERTIFICATES.

- ROOF AND WALL CLADDING INSTALLATION TO NCC 2022 H1D7 & AS 1562 DESIGN AND INSTALLATION OF SHEET ROOF AND WALL CLADDING.

CONDENSATION MANAGEMENT:

CONDENSATION MANAGEMENT MUST BE ADHERED TO IN ACCORDANCE WITH NCC 2022 - HOUSING PROVISIONS PART 10.8.

- GROUND FLOOR TO BE REINFORCED CONCRETE SLAB IN ACCORDANCE WITH AS2870.

- FIRST FLOOR TO BE TIMBER FRAMED FINISHED WITH T&G HARDWOOD FLOORING.

- ALL WATERPROOFING TO NCC 2022 - ABCR HOUSING PROVISIONS PART 10, AS3740 AND PROVIDE A GUARANTEED FLEXIBLE WATERPROOF MEMBRANE TO ALL WET AREA FLOORS & SHOWER WALLS TO MANUFACTURED SPECIFICATIONS AND INSTALLATION INSTRUCTIONS

- WATERPROOF INSTALLATION NCC (2022): HOUSING PROVISIONS PART 10, AS 3740 WATERPROOFING OF DOMESTIC WET AREAS (INTERNAL) & AS 4654 WATERPROOF MEMBRANES FOR EXTERNAL USE.

- SHALL BE INSTALLED TO COMPLY WITH AS1684 AS AMENDED FOR TIMBER COMPONENTS OR AS3620. FOR LIGHTWEIGHT STEEL FRAMING SECTIONS OR AS PER THE NASH ALTERNATIVES TO AS 3623.

ANT CAPS:
- SHALL BE INSTALLED IN ACCORDANCE WITH AS3660.

PROFILED STEEL ROOF:

- COLORBOND ROOF CLADDING

- METAL ROOF DESIGN AND INSTALLATION SHALL BE IN ACCORDANCE WITH NCC 2022 - ABCB HOUSING PROVISIONS PART 7, AS 1562.

ROOF TILES OR SHINGLES:

- NCC 2022 -ABCB HOUSING PROVISIONS PART 7.3.

SHALL BE IN ACCORDANCE WITH NCC 2022 - ABCB HOUSING PROVISIONS PART 4.2.10. - ALL WORKMANSHIP AND MATERIALS SHALL BE IN ACCORDANCE WITH CURRENT EDITIONS OF THE

BRICK AND BLOCKWORK:
- MASONRY STRUCTURES TO NCC 2022 - ABCB HOUSING PROVISIONS PART 5 & AS 3700 MASONRY

- FOOTINGS:
 FOOTINGS TO BE IN ACCORDANCE WITH AS1480.
- FOOTINGS TO BE IN ACCORDANCE WITH NCC VOL.2 PARTS H1D4
- ALL REINFORCEMENTS SHALL CONFORM TO AS1302 AS1303 AND AS1304

- RESIDENTIAL SLABS, FOOTINGS AND CONCRETE STRUCTURES TO NCC 2022 - ABCB HOUSING PROVISIONS PART 3 & 4, AS 2870 RESIDENTIAL SLABS AND FOOTING & AS 3600 CONCRETE STRUCTURES.

CARPENTRY:

TIMBER TO COMPLY WITH AS1170.2 OR AS4055

- ALL WORKMANSHIP AND MATERIALS SHALL BE IN ACCORDANCE WITH AS1684 AND 1720 AS APPLICABLE. -TERMITE MANAGEMENT INSTALLATION OF PERIMETER & COLLARS TO NCC 2022 - ABCB HOUSING PROVISIONS PART 3.4 & AS 3660.1 TERMITE MANAGEMENT - NEW BUILDING WORK.

-ALL EXTERNAL TIMBER FRAMED WALLS TO BE WRAPPED IN A BREATHABLE VAPOUR PERMEABLE MEMBRANE IN ACCORDANCE WITH NCC VOL.2 PART H1D6, INSTALLED WITH AS/NZS 4200.1 & AS/NZS

-TIMBER FRAMING INSTALLATION TO NCC 2022 - VOL.2 PART HAD6(4), AS 1684.4 RESIDENTIAL TIMBER FRAMED CONSTRUCTION & AS/NZS 1170 STRUCTURAL DESIGN ACTIONS.

- GROUND FLOOR TIMBERS SHALL BE ONLY OF HARDWOOD, CYPRESS PINE OR PRESSURE TREATED RADIATA OR CANADA PINE BELOW A HEIGHT OF 300mm ABOVE FINISHED GROUND LEVEL AND MUST NOT BE BUILT INTO BRICKWORK.

- SUBFLOOR VENTILATION SHALL CONFORM TO NCC 2022 ABCB HOUSING PRIVIONS PART 6.2
- IN BUSHFIRE PRONE AREAS SPECIAL CONDITIONS APPLY. WHERE TERMITE BARRIERS NEED TO BE INSPECTED, 400mm CLEARANCE IS REQUIRED BETWEEN THE JNDERSIDE OF BEARER AND GROUND SURFACE.
- USE TREATED TIMBER WHERE REQUIRED FOR DURABILITY.
- DO NOT USE TIMBER UNSUITABLE FOR EXPOSURE TO MOISTURE IN EXPOSED LOCATION.
- PROVIDE STRUCTURE BRACING IN ACCORDANCE WITH AS1684
- PROVIDE STRUCTURE TIEDOWN IN ACCORDANCE WITH AS1684 - USE GALVANISED FIXINGS WHERE EXPOSED TO WEATHER.

STEEL FRAMING:
-ALL STEEL FRAMING TO NCC 2022 - VOL.2 PARTH1D6(3), AS 4100 STEEL STRUCTURES, AS/NZS 4600 COLD-FORMED STEEL STRUCTURES & NASH STANDARD.

TERMITE CONTROL:

TO BE IN ACCORDANCE WITH TO AS3660.1

- SHALL BE IN ACCORDANCE WITH NCC 2022 - ABCB HOUSING PROVISION PART 3.4

- SELECTION AND INSTALLATION OF METAL RAINWATER GOODS REFER TO AS2180 - FLASH PROJECTIONS ABOVE THE ROOF WITH TWO PART FLASHINGS CONSISTING OF AN APRON
- FLASHING AND OVER FLASHING WITH AT LEAST 100mm OVERLAP
- PROVIDE FOR INDEPENDENT MOVEMENT BETWEEN ROOF AND PROJECTION.
- DAMP PROOF COURSE AND FLASHINGS TO NCC 2022 VOL.2 PART H2 & AS/NZS 2904 DAMP-PROOF COURSES AND FLASHINGS

CONCRETE BLOCKS OR BRICKS:

- TO COMPLY WITH TO AS4455 MASONRY BUILDING BLOCKS/PAVER.

- 40% OF NEW OR ALTERED LIGHT FIXTURES TO BE FITTED WITH FLUORESCENT, COMPACT FLUORESCENT, OR LIGHT-EMITTING-DIODE (LED) LAMPS

DOORS & WINDOWS:

- ALL FRAMED WINDOWS SHALL BE INSTALLED IN ACCORDANCE WITH AS2047-48 FOR ALUMINIUM WINDOWS AND AS2047 FOR TIMBER WINDOWS.
- ALUMINIUM FRAMED WINDOWS AND DOORS.
- WEATHER STRIPPING IS TO BE PROVIDED TO ALL EXTERNAL WINDOWS AND DOORS
- ALL WINDOWS ARE TO BE RESTRICTED IN ACCORDANCE WITH NCC 2022 ARCR HOLISING PROVISIONS PART 11.3.7 & PART 11.3.8 PROTECTION OF OPENABLE WINDOWS WHERE SURFACE BELOW IS MORE
- PROVIDE LIFT-OFF HINGES WHERE THE TOILET PAN IS WITHIN 1.2 METRES OF THE HINGED SIDE OF THE DOOR IN ACCORDANCE WITH NCC 2022 – ABCB HOUSING PROVISIONS PART 10.4.

STAIRS, HANDRAILS AND BALUSTRADES:

- RELATIONSHIP OF RISER TO GOING SHALL BE BETWEEN 1:2 AND 1:1.35 UNLESS OTHERWISE DIRECTED TO GOING SHALL BE BETWEEN 1:2 AND 1:1.35 UNLESS OTHERWISE DIRECTED OR AS PERMITTED IN
- BALUSTRADES SHALL BE PROVIDED TO ALL LANDINGS, RAMPS, DECKS, ROOFS AND OTHER ELEVATED PLATFORMS WHERE THE VERTICAL DISTANCE FROM THAT LEVEL IS MORE THAN 1m ABOVE THE ADJOINING FLOOR OR FINISHED GROUND LEVEL.
- THE HEIGHT OF BALUSTRADE MUST BE A MINIMUM OF 1m HIGH ABOVE LANDING AND NOT LESS THAN 865mm ABOVE THE NOSINGS OF ANY STAIR TREADS OR FLOOR RAMP AND HAVE NO OPENING GREATER
- THE HEIGHT OF BALUSTRADE TO THE NEW STAIRCASES IS TO BE MEASURED A MINIMUM 865mm ABOVE THE NOSING LINE AND HAVE NO OPENING GREATER NO OPENING GREATER THAN 125mm
- ALL BALUSTRADES & PRIVACY SCREENS TO COMPLY WITH NCC 2022 ABCB HOUSING PROVISIONS PART 11, AS 1684, AS 1170, AS 1288 & AS/NZS 2208

- MATERIALS TO BE USED FOR SURFACES OF FLOORS, STAIR LANDING, STEPS AND NOSINGS SHALL BE IN ACCORDANCE WITH THE CLASSIFICATIONS FOR SLIP RESISTANCE AS APPLY IN AS4586 AND HB198. - ALL STAIRS PROVIDING ACCESS TO COMPLY WITH NCC 2022 - ABCB HOUSING PROVISIONS PART 11, AS 4586 INCLUDING SLIP RESISTANCE P3 / R10 FOR DRY OR P4 / R11 FOR WET.

EAVES GUTTERS. VALLEY GUTTERS AND DOWPIPES

- TO COMPLY WITH AS/NZS 2179 FOR METAL AND AS1273 FOR UPVC COMPONENTS.
- IN ACCORDANCE WITH NCC VOL 2 PART 3.5.3
- NEW DOWNPIPES TO BE CONNECTED INTO EXISTING STORMWATER LINE
- COLORBOND GUTTERS AND DOWNPIPES
- MINIMUM SLOPE OF EAVES AND GUTTERS 1:200

- NCC VOL2 PART H1D8. ABCB HOUSING PROVISIONS PART 8.3
- ALL WINDOW GLAZING AND DOOR GLAZING TO BE INSTALLED IN ACCORDANCE TO NCC 2022 ABCB HOUSING PROVISIONS PART 8, AS 1288 GLASS IN BUILDINGS, AS/NZS 2208 SAFETY GLAZING MATERIALS IN BUILDINGS & AS 2047 WINDOWS AND EXTERNAL DOORS IN BUILDINGS.
- SHOWER SCREEN/MIRRORS / WARDROBE GLASS INSTALLATION TO NCC 2022 HOUSING PROVISIONS PART 8 AS 1288 & AS/NZS 2208.
- GLASS BALUSTRADE INSTALLATION TO NCC 2022 HOUSING PROVISIONS PART 11, AS 1288 GLASS IN BUILDINGS, AS/NZS 2208 SAFETY GLAZING MATERIALS IN BUILDINGS & AS 1170 STRUCTURAL DESIGN

WATERPROOFING FOR EXTERNAL TILED BALCONIES:

- WATERPROOFING TO COMPLY WITH AS4654
- ALL WATERPROOFING TO NCC 2022 ABCB HOUSING PROVISIONS PART 10, AS3740 AND PROVIDE A GUARANTEED FLEXIBLE WATERPROOF MEMBRANE TO ALL WET AREA FLOORS & SHOWER WALLS TO MANUFACTURED SPECIFICATIONS AND INSTALLATION INSTRUCTIONS

- FIRE SAFETY, SMOKE DETECTORS/ALARMS:
 PROVIDE HARDWIRED & INTERCONNECTED SMOKE ALARM DEVICES COMPLYING WITH THE REQUIREMENTS OF THE LOCAL GOVERNMENT ACT AND/OR STATE OR TERRITORY REGULATIONS MUST BE FITTED IN THE LOCATIONS REQUIRED AND APPROVED BY THE AUTHORITY. SMOKE ALARMS TO BE INSTALLED TO NCC 2022 – ABCB HOUSING PROVISIONS PART 9.5, NSW 9.5.1 & AS 3786. INSTALLATIONS IN BUILDINGS OTHER THAN CLASS 1 AND 10 MUST BE INSTALLED AND MANAGED TO
- COMPLY WITH NCC SPEC. E2.2a. - FIRE SEPARATING WALL. A WALL WITHIN 900MM OF BOUNDARY INSTALLATION CERTIFICATE (FRL60/60/60) INCL ACOUSTIC SOUND (RW) + CTR50 TO NCC 2022 - ABCB HOUSING PROVISIONS PART 9 & PART 10.7, ÁS 1530 ALL PARTS.
- BUSHFIRE-PRONE AREAS CERTIFICATE FOR BUILDING NCC 2022 VOL. 2 PART NSW H7D4 CONSTRUCTION IN BUSHFIRE PRONE AREAS AS 3959 CONSTRUCTION OF BUILDING IN BUSHFIRE-PRONE AREAS & PLANNING FOR BUSHFIRE PROTECTION 2019.

WASTE MANAGEMENT:

- ALL WASTE SHALL BE TAKEN AWAY BY TRUCKS TO A SUITABLE LANDFILL OR RECYCLE DEPOT.
- ALL WASTE SHALL BE COVERED DURING TRANSPORTATION.
- WASTE GENERATED DURING CONSTRUCTION SHALL BE PLACED IN STEEL BINS AND TAKEN AWAY BY AN APPROVED CONTRACTOR TO A APPROVED LANDFILL SITE.

- A FILTER CLOTH SYSTEM SHALL BE INSTALLED TO STOP ANY SEDIMENT ENTERING COUNCILS STORMWATER SYSTEM..

SWIMMING POOLS & SAFETY

-POOL PLUMBING/CIRCULATION TO COMPLY WITH NCC 2022 PART NSW H7D2, AS 1926.3 SWIMMING POOL SAFETY - WATER RECIRCULATION SYSTEMS

- ALL POOL FENCING TO BE INSTALLED TO: NCC 2022 NSW H7D2, AS 1926.1 2012 SAFETY BARRIERS FOR SWIMMING POOLS, AS 1926.2 - 20007 - LOCATION OF SAFETY BARRIERS FOR SWIMMING POOLS, AS
- 1170 STRUCTURAL DESIGN ACTIONS AND IF GLASS POOL FENCING TO ADDITIONALLY COMPLY WITH AS 1288 - 2021 GLASS IN BUILDINGS, AS/NZS 2208 - SAFETY GLASS,
- AS 2783 USE OF REINFORCED CONCRETE FOR SMALL SWIMMING POOLS

- ALLOW FOR SEPARATE TAPS FOR THE WASHING MACHINE AND KEEP THEM SEPARATE FROM THOSE OF THE LAUNDRY TUB. A DEDICATED LAUNDRY SPACE COMPRISING OF ONE WASHTUB AND A SPACE FOR A WASHING MACHINE MUST BE PROVIDED IN ACCORDANCE WITH NCC 2022 – ABCB HOUSING PROVISIONS
- GAS FIRE SUPPLY AND INSTALLATION TO COMPLY WITH NCC 2022 ABCB HOUSING PROVISIONS PART 12.4, AS/NZS 5601 GAS INSTALLATIONS.

ALL PLANS ARE TO BE READ IN CONJUNCTION AND COMPLY WITH THE BASIX CERTIFICATE, BUSHFIRE AND GEOTECH REPORTS.

NOTES (E & OE)

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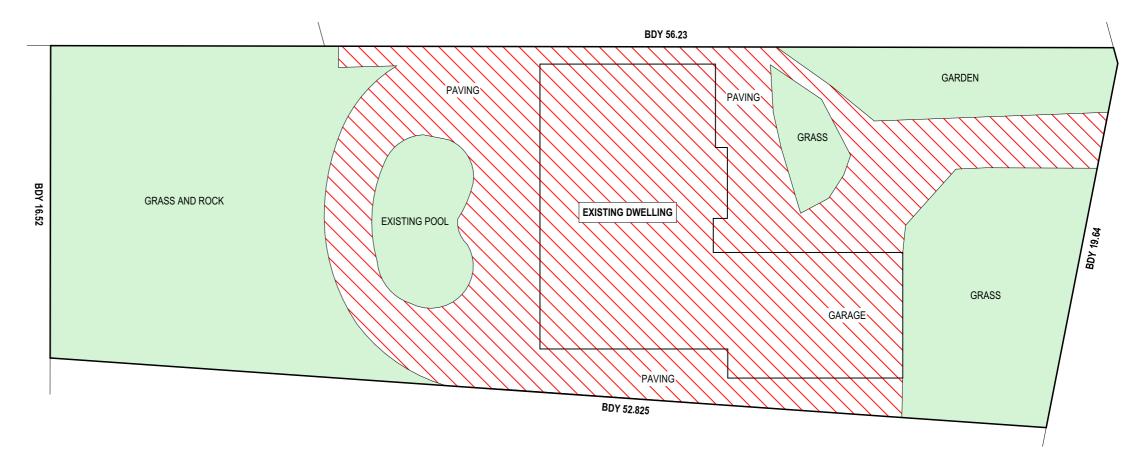


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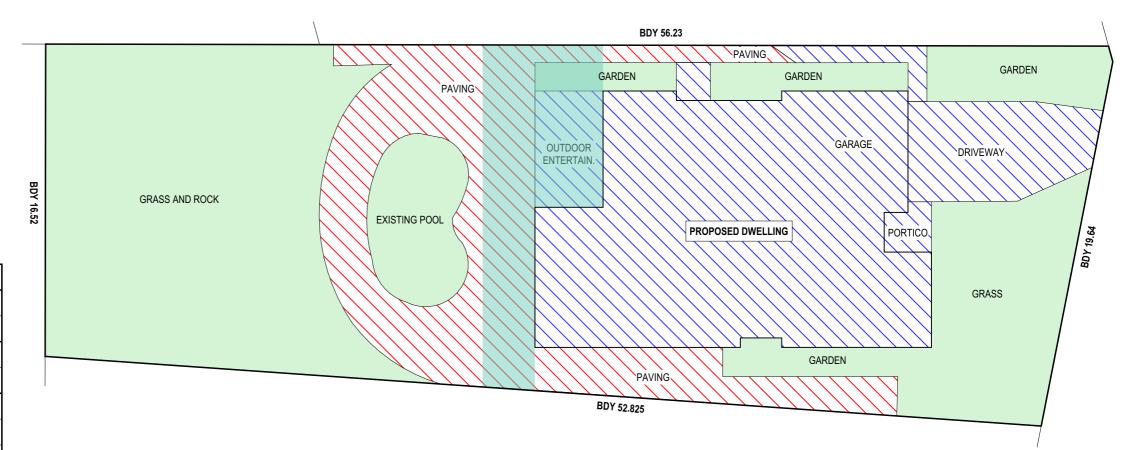
REV:	DATE:	DESCRIPTION:
(A)	11/9/2024	PRELIM. DESIGN - FLOOR PLANS
(B)	1/10/2024	PRELIM. REVISION
(C)	30/10/2024	PRELIM. REVISION
Α	9/12/2024	DA DRAWINGS
В	8/1/2025	DA DRAWINGS (ADD NATHERS)
С	20/3/2025	DA DRAWING AMENDMENTS
	(A) (B) (C) A B	(A) 11/9/2024 (B) 1/10/2024 (C) 30/10/2024 A 9/12/2024 B 8/1/2025

PROPOSED NEW BUILD 34 COOK STREET, FORESTVILLE	JOB No
CLIENT: ANTONIO + AMANDA PETROLO	12
DRAWING TITLE: SPECIFICATIONS	

DRAWN BY: SCALE: @ A3 ACCREDITED 289/24 BUILDING DESIGNER DATE: DRAWING No: CHECKED BY: AUG/24 **DA.09**



EXISTING LANDSCAPED AREA CALCULATIONS PLAN



CALCULATIONS SITE AREA 1004.4m² LANDSCAPE CONTROL 40% 401.8m² EXISTING LANDSCAPED AREA 49.7% 499.4m² 47.2% TOTAL PROPOSED LANDSCAPED AREA 474.3m² EXISTING HARD SURFACE AREA 50.2% 504.2m² TOTAL PROPOSED HARD SURFACE AREA 52.7% 529.1m² PRIVATE OPEN SAPCE CONTROL >60m² PROPOSED RIVATE OPEN SPACE >80m²

TRUE NORTH:



NOTES (E & OE)

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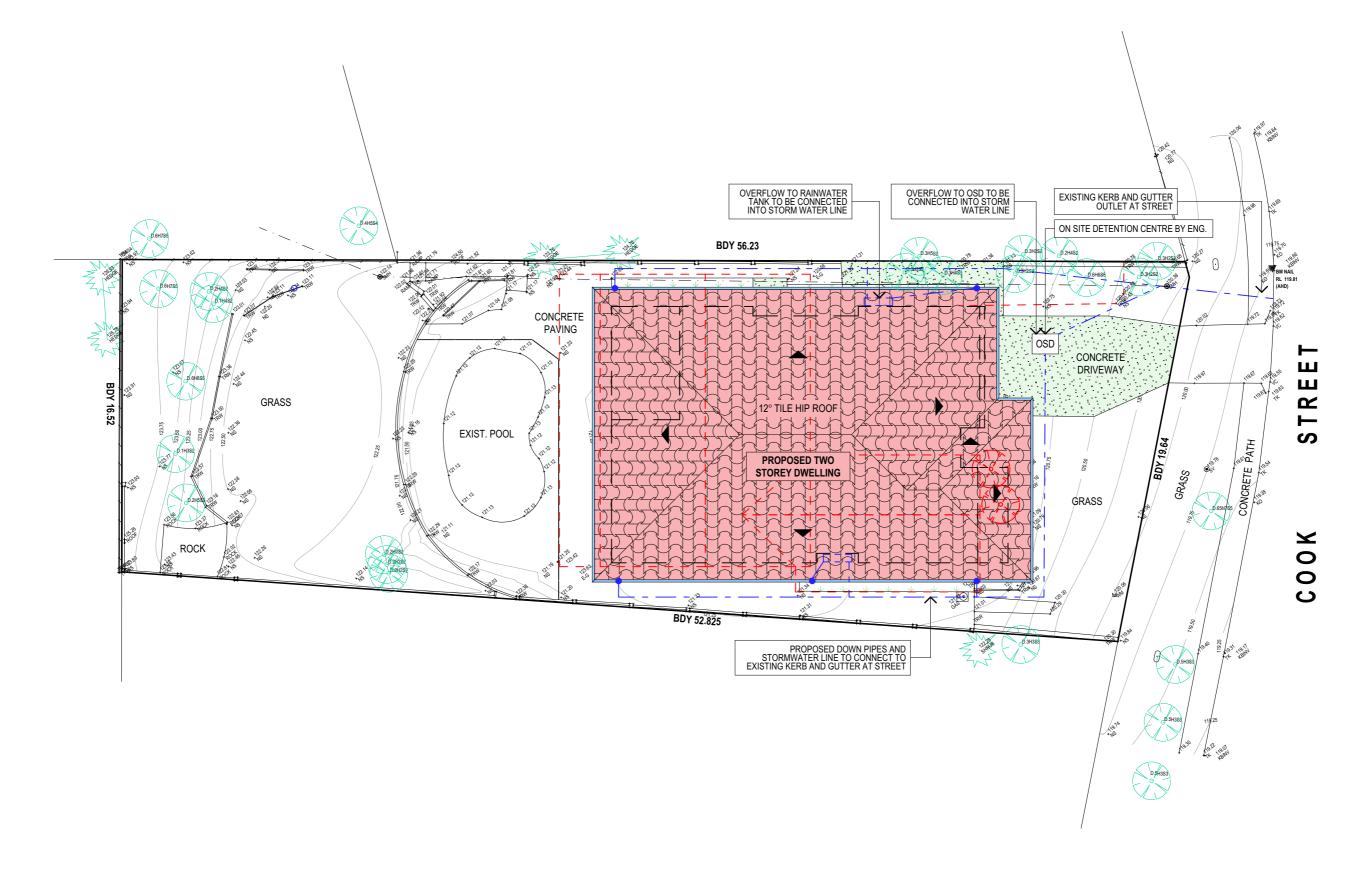
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	Α	9/12/2024	DA DRAWINGS
	В	8/1/2025	DA DRAWINGS (ADD NATHERS)
	С	20/3/2025	DA DRAWING AMENDMENTS

PROPOSED NEW BUILD	JOB No:
34 COOK STREET, FORESTVILLE	1289/24
CLIENT: ANTONIO + AMANDA PETROLO	1200/21
DRAWING TITLE: LANDSCAPED AREA CALCULATION PLAN	
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DRAWN BY:	SCALE:	DQQQ
AD		A C C R E D I T E D BUILDING DESIGNER
DATE:	DRAWING No:	CHECKED BY:
AUG/24	DA.10	JJ

PROPOSED LANDSCAPED AREA CALCULATIONS PLAN



STORMWATER CONCEPT LEGEND

PROPOSED DOWNPIPES

APPROX. LOCATION STORMWATER LINE

TRUE NORTH:

- NOTES (E & OE)

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1	В	8/1/2025	DA DRAWINGS (ADD NATHERS)
1	С	20/3/2025	DA DRAWING AMENDMENTS

PROPOSED NEW BUILD 34 COOK STREET, FORESTVILLE CLIENT: ANTONIO + AMANDA PETROLO	JOB No: 1289/24	DAT
DRAWING TITLE: ROOF & STORMWATER CONCEPT PLAN		DAI

DRAWN BY:	SCALE:	
AD		A C C R E D I T E D BUILDING DESIGNER
DATE:	DRAWING No:	CHECKED BY:
AUG/24	DA.11	JJ

ROOF AND STORMWATER CONCEPT PLAN

NOTES

DESIGNATED SITE MANAGER/BUILDER

PRIOR TO COMMENCEMENT OF WORK A SITE MANAGER OR BUILDER MUST BE NOMINATED. THE SITE MANAGER OR BUILDER WILL BE RESPONSIBLE AND LIABLE FOR ALL WORKS CARRIED OUT ON THE SITE. THIS ASSUMES THE RESPONSIBILITY FOR THE ACTIONS OF ALL SUBCONTRACTED PARTIES AS WELL AS ADVISING THEM OF COUNCIL'S REQUIREMENTS WHEN CARRYING OUT WORKS.

TOPSOIL MANAGEMENT

PRIOR TO THE STRIPPING OF TOPSOIL, THE VEGETATIVE COVER MUST BE REDUCED BY EITHER SLASHING OR MOWING. ALL TOPSOIL IS TO BE RETAINED AND PROTECTED FOR REUSE ON SITE. SOIL STOCKPILES MUST NOT BE LOCATED ON NATURE STRIPS, FOOTPATHS, ROADWAYS, KERBS, ACCESSWAYS, WITHIN DRAINAGE LINES/FLOWS/PATHS OR AROUND OR AGAINST TREE SHRUBS. SEDIMENT CONTROL MEASURES MUST BE INCORPORATED WITH ANY RESULTING STOCKPILE. THE STOCKPILE CAN BE PROTECTED FROM EROSION BY COVERING IT WITH AN MPERVIOUS MATERIAL, IN CONJUNCTION WITH THE INSTALLATION OF A SEDIMENT FENCE AROUND IT. IF STOCKPILES ARE TO REMAIN FOR MORE THAN ONE MONTH THEY ARE TO BE GRASSED IMMEDIATELY AND STABILISED WITHIN FOURTEEN DAYS. SURPLUS TOPSOIL MUST BE REASONABLY REMOVED FROM SITE.

BUILDING MATERIAL STOCKPILING

SUFFICIENT AREA MUST BE ALLOCATED WITHIN THE SITE FOR SUCH STORAGE OF BUILDING MATERIALS, DEMOLITION WASTE, WASTE CONTAINERS, ETC. AS WILL BE REQUIRED.

A SEDIMENT FENCE SHOULD BE LOCATED ALONG THE DOWNSLOPE BOUNDARY(S) OF THE SITE. ON THE CONSTRUCTION SIDE OF THE TURF FILTER STRIP OR NATIVE VEGETATION, AND AROUND ALL STOCKPILES OF MATERIAL ON THE SITE.

DUST CONTROL

ALL TRUCKS/UTES MUST COVER THEIR LOADS AT ALL TIMES. APPROPRIATE METHODS ARE TO BE EMPLOYED TO PREVENT BLOWING DUST CREATING AN UNACCEPTABLE HAZARD OR NUISANCE ON THE SITE OR DOWN WIND. PRODUCTION OF DUST CAN BE MINIMISED BY LIMITING AREA OF EARTHWORKS, WATERING AND PROGRESSIVE VEGETATION. WHERE DUST IS CREATED AS A RESULT WORKS AND/OR SOIL EXPOSURE, THE BARE SOIL AREAS MUST BE WATERED, DURING AND/OR AT THE END OF EACH DAY TO LAY THE DUST. EARTH MOVING ACTIVITIES SHOULD BE AVOIDED WHERE WINDS ARE SUFFICIENTLY STRONG ENOUGH TO RAISE VISIBLE

EROSION & SEDIMENT CONTROLS

APPROPRIATE EROSION AND SEDIMENT CONTROLS MUST BE IMPLEMENTED ON ALL SITES THAT INVOLVE SOIL DISTURBANCE. THE MEASURES MUST BE IN PLACE PRIOR TO THE COMMENCEMENT OF WORK. THOSE CONTROLS ARE TO BE MONITORED AND MAINTAINED IN ORDER TO SERVE THEIR INTENDED FUNCTION FOR THE DURATION OF THE WORKS OR UNTIL SUCH TIME AS THE SITE IS FULLY STABILISED. IF ANY CONTROLS ARE DAMAGED OR BECOME INEFFECTIVE DURING THE COURSE OF THE WORKS THEY ARE TO BE REINSTATED OR REPLACED IMMEDIATELY. SUFFICIENT ACCESS TO THESE CONTROLS MUST BE PROVIDED IN CASE OF THE

SEDIMENT TRAPS


WHERE A SEDIMENT FENCE IS NOT USED APPROPRIATE SEDIMENT TRAPS SHOULD BE LOCATED. AT ALL POINTS WHERE STORMWATER LEAVES THE CONSTRUCTION SITE OR LEAVES THE GUTTER AND ENTERS THE DRAINAGE SYSTEM. A COMMON TECHNIQUE IS THE GRAVEL SAUSAGE.

DIVERSION CHANNELS


A DIVERSION CHANNEL IS AN EXCAVATED EARTH DITCH OR PATH. THESE STRUCTURES ARE USED TO INTERCEPT AND DIRECT RUN-OFF TO A DESIRED LOCATION WHERE POSSIBLE. ALL STORMWATER RUN-OFF FLOWING ONTO DISTURBED AREAS, INCLUDING STOCKPILES, MUST BE INTERCEPTED, DIVERTED AND/OR SAFELY DISPOSED OF. THIS CAN BE ACHIEVED BY CONSTRUCTING A TEMPORARY EARTH BANK AROUND THE UPSLOPE EXTENT OF THE CONSTRUCTION SITE WHERE THE DIVERSION DOES NOT AFFECT THE NEIGHBOURING


VEHICLE MOVEMENTS

TO LIMIT DISTURBANCE TO THE SITE AND TRACKING OF MATERIAL ONTO THE STREET ALL VEHICLES AND PLANT EQUIPMENT ARE TO USE A SINGLE ENTRY/EXIT POINT UNLESS COUNCIL HAS APPROVED ALTERNATIVE ARRANGEMENTS. ACCESS POINTS AND PARKING AREAS ARE TO BE STABILISED WITH COMPACTED SUB-GRADE ASAP AFTER THEIR FORMATION. IF SPILLAGE DOES OCCUR IT IS TO BE CONTAINED IMMEDIATELY AND CAREFULLY REMOVED. THE AREA AFFECTED IS TO BE RESTORED TO A STANDARD EQUAL TO OR BETTER THAN ITS PREVIOUS CONDITION. ALL VEHICLES ARE TO BE WASHED PRIOR TO EXISTING THE SITE. THIS SERVES THE PURPOSE OF REMOVING SITE MATERIAL ON THE VEHICLE AND PREVENTS IT FROM BEING DEPOSITED ON THE ROAD NETWORK ADJACENT TO THE SITE AND THUS, THE STORMWATER SYSTEM. NO VEHICLE ASSOCIATED WITH THE WORK IS TO BE PARKED ON A FOOTPATH OR PUBLIC RESERVE. ALL VEHICLES VISITING THE SITE DURING DEMOLITION, EXCAVATION AND/OR CONSTRUCTION WORKS, ARE TO COMPLY WITH THE PARKING REQUIREMENTS IN THAT AREA.

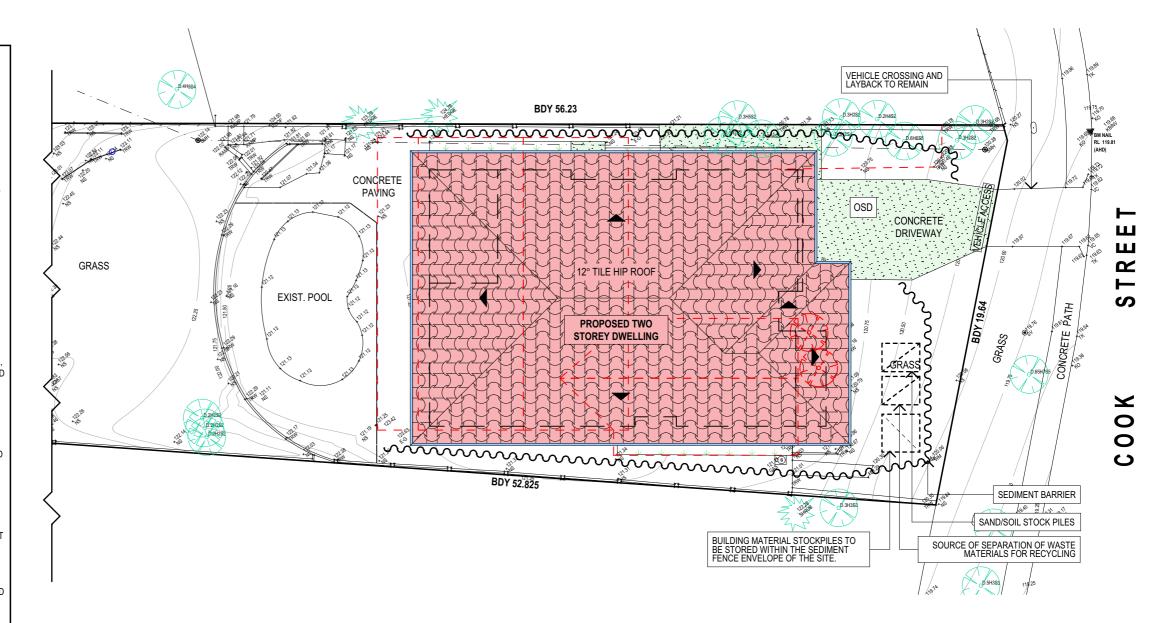

EROSION AND SEDIMENT CONTROL / WASTE MANAGEMENT PLAN

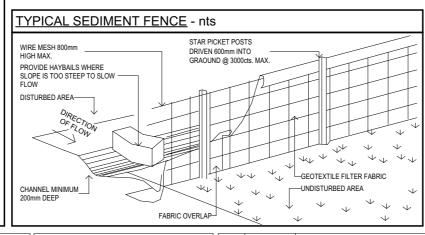

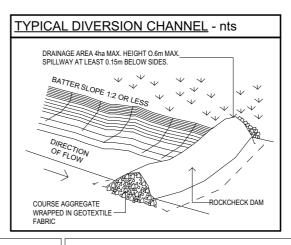

TRUE NORTH:

NOTES (E & OE)

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a Vale Road, Mona Vale, NSW, 2103	(C)	30/10/2024	PRELIM. REVISION
Box 687, Dee Why, NSW, 2099	Α	9/12/2024	DA DRAWINGS
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DESCRIPTION:

	PROPOSED NEW BUILD	JOB No:	DRAWN BY:
	34 COOK STREET, FORESTVILLE	4000/04	AD
	CLIENT:	1289/24	
l	ANTONIO + AMANDA PETROLO		DATE:
	DRAWING TITLE: EROSION & SEDIMENT CONTROL / WASTE	MANAGEMENT	AUG/24
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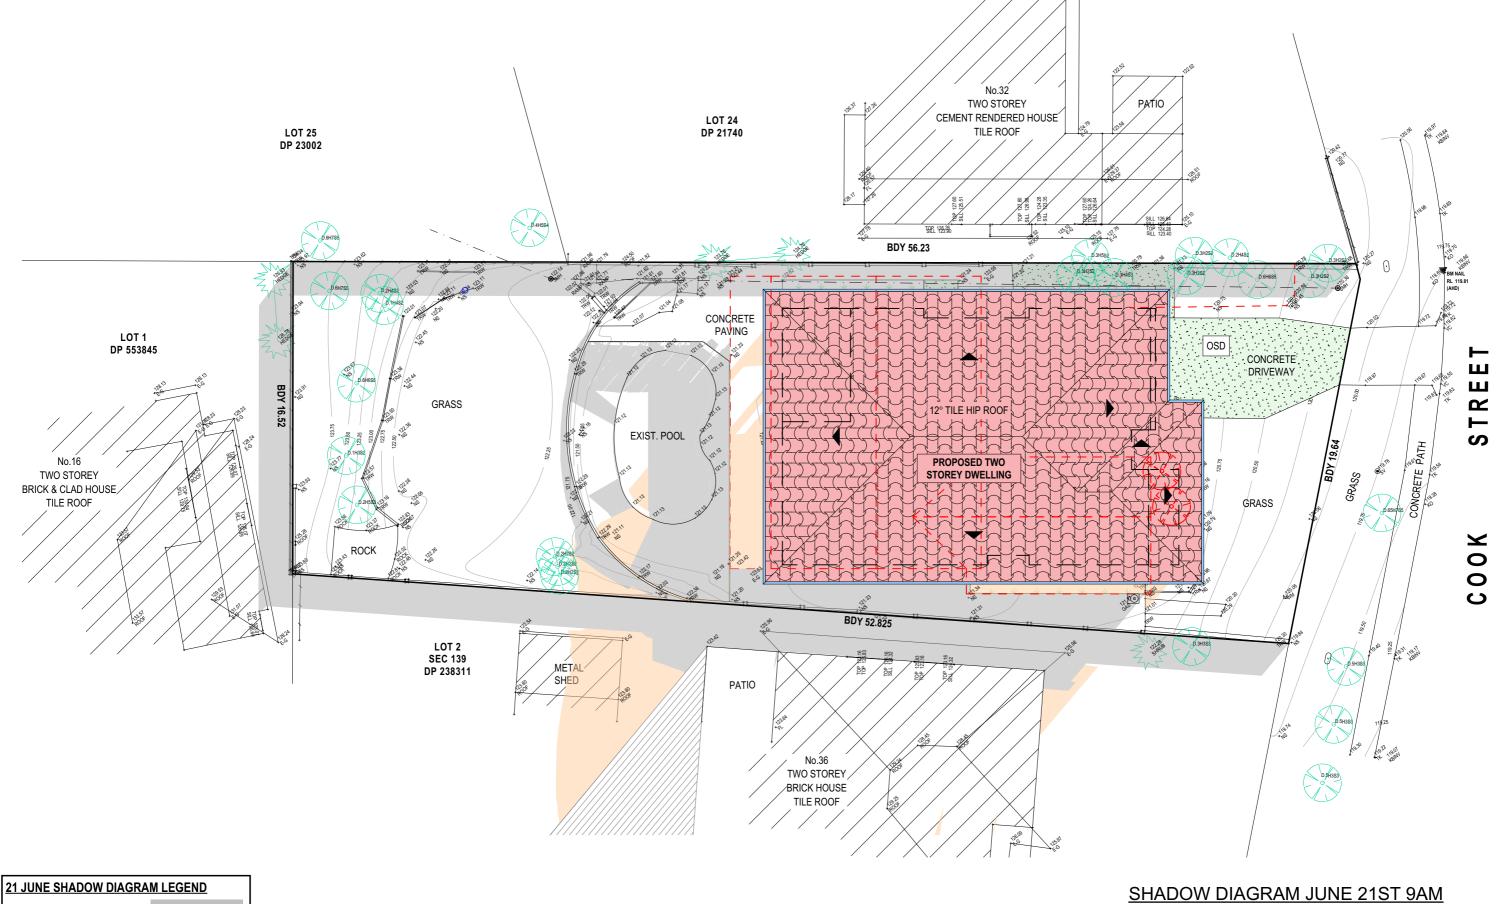


SCALE:

DRAWING No:

1:200 @ A3

DA.12



EXISTING SHADOWS

NEW SHADOWS

TRUE NORTH:

- NOTES (E & OE)

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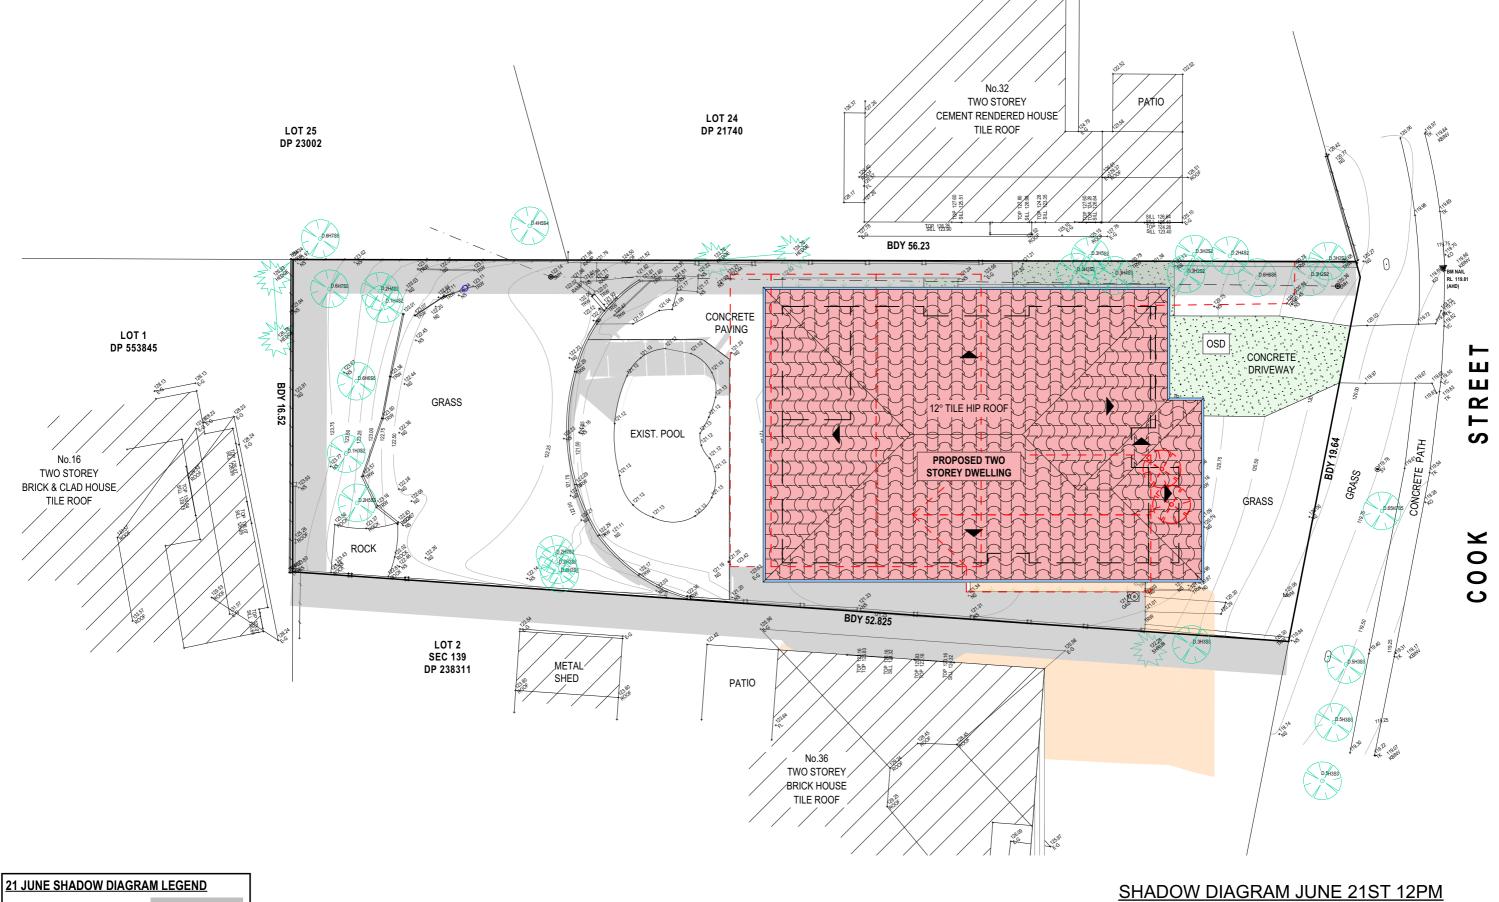
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	C 20/3/2025		DA DRAWING AMENDMENTS
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PROPOSED NEW BUILD 34 COOK STREET, FORESTVILLE CLIENT: ANTONIO + AMANDA PETROLO	JOB No: 1289/24	DF
DRAWING TITLE: SHADOW DIAGRAM JUNE 21 9:00 am		DA

DRAWN BY:	SCALE:	
AD	1:200 @ A3	A C C R E D I T E D BUILDING DESIGNER
DATE:	DRAWING No:	CHECKED BY:
AUG/24	DA.13	JJ





EXISTING SHADOWS

NEW SHADOWS

TRUE NORTH:

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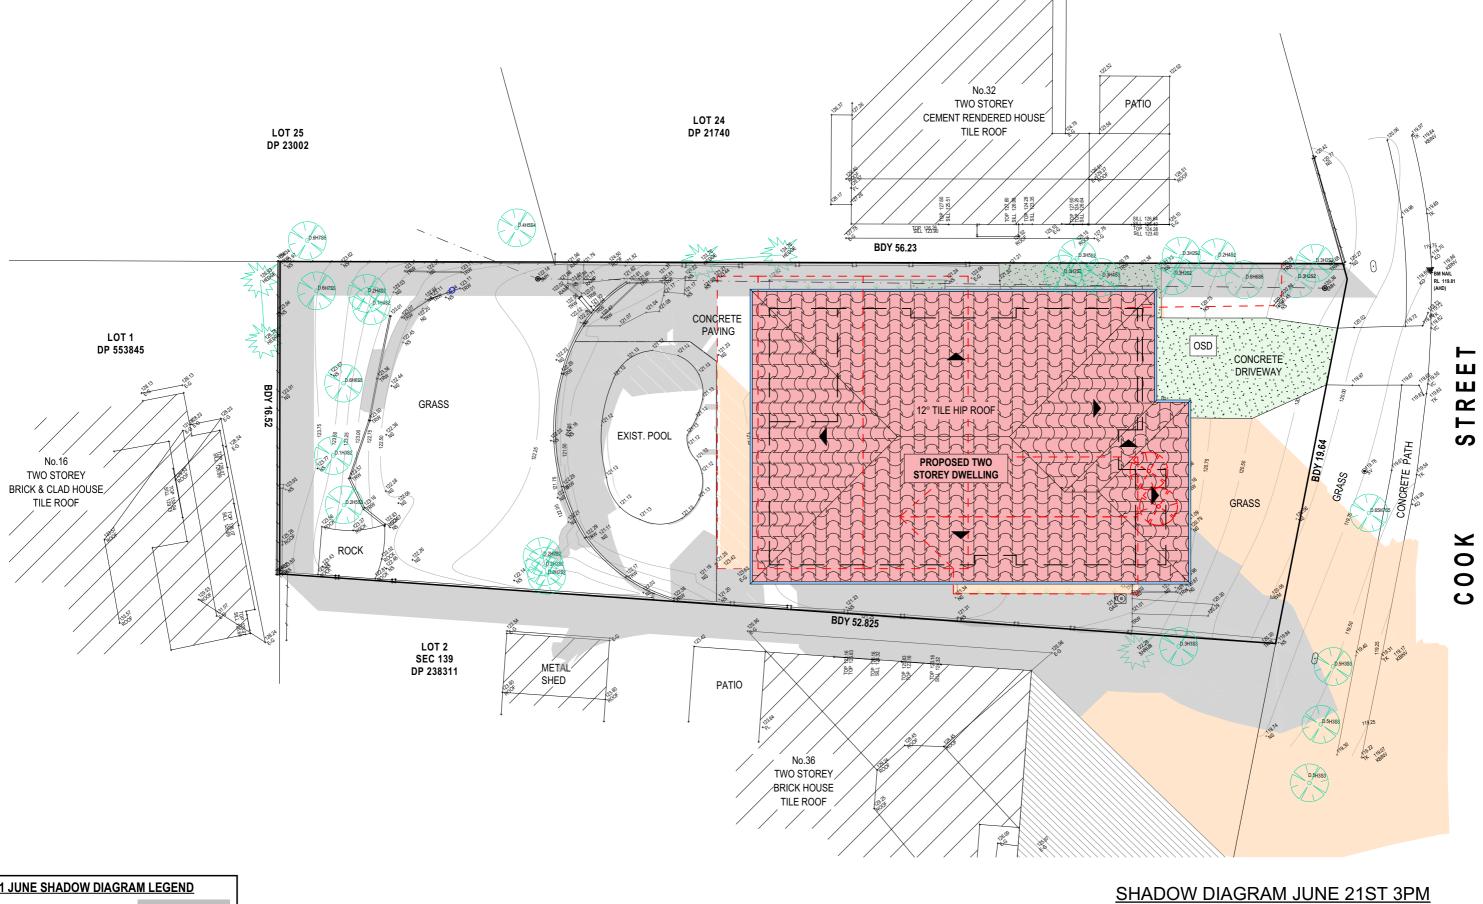
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l	С	20/3/2025	DA DRAWING AMENDMENTS
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PROPOSED NEW BUILD 34 COOK STREET, FORESTVILLE CLIENT:	JOB No: 1289/24	DRAWN BY:	SCALE: 1:200 @ A3
ANTONIO + AMANDA PETROLO		DATE:	DRAWING No:
DRAWING TITLE: SHADOW DIAGRAM JUNE 21 12 noon		AUG/24	DA.14

BUILDING DESIGNER

CHECKED BY:

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21 JUNE SHADOW DIAGRAM LEGEND

EXISTING SHADOWS

NEW SHADOWS

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- 1			

PROPOSED NEW BUILD 34 COOK STREET, FORESTVILLE CLIENT: ANTONIO + AMANDA PETROLO	JOB No: 1289/24	DATE:
DRAWING TITLE: SHADOW DIAGRAM JUNE 21 3:00 pm		A

DRAWN BY:	SCALE:	
AD	1:200 @ A3	A C C R E D I T E D BUILDING DESIGNER
DATE:	DRAWING No:	CHECKED BY:
AUG/24	DA.15	JJ

LABEL ID	W1	W2	W3	W4	W5	W6	W7	W8
ORIENTATION	NORTH	NORTH	NORTH	NORTH	NORTH	NORTH	NORTH	EAST
ELEVATION	# 1,000 #	3,000	4,000	2,000	2,000	₹ 3,500 3 ,500	3,500	3,900
LOCATION	GROUND FLOOR - BATHROOM	GROUND FLOOR - ENTERTAINMENT ROOM	GROUND FLOOR - GARAGE	FIRST FLOOR - BED 3	FIRST FLOOR - LIVING	FIRST FLOOR - LIVING	FIRST FLOOR - OFFICE / GUEST	GROUND FLOOR - BED 5
GLAZING	FROSTED	CLEAR	CLEAR	CLEAR	CLEAR	CLEAR	CLEAR	CLEAR

LABEL ID	W9	W10	W11	W12	W13	W14	W15	W16
ORIENTATION	EAST	EAST	EAST	SOUTH	SOUTH	SOUTH	SOUTH	SOUTH
ELEVATION	3,000	* 900 * 1300 * 1300 * 1	1,300	1,300 x	1,300 x	2,000	2,000	* 2,000 * 1
LOCATION	FIRST FLOOR - OFFICE / GUEST	FIRST FLOOR - WIR	FIRST FLOOR - MASTER	GROUND FLOOR - WIR	GROUND FLOOR - ENS	GROUND FLOOR - FAMILY ROOM	GROUND FLOOR - DINING ROOM	GROUND FLOOR - LAUNDRY
GLAZING	CLEAR	CLEAR	CLEAR	FROSTED	FROSTED	CLEAR	CLEAR	CLEAR

WINDOW SCHEDULE

<u>NOTES</u>

FRAME OPENING DIMENSIONS FOR WINDOWS & DOORS TO BE CONFIRMED ON SITE PRIOR TO ORDERING.

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	С	20/3/2025	DA DRAWING AMENDMENTS
- 1			

PROPOSED NEW BUILD	JOB N
34 COOK STREET, FORESTVILLE	
CLIENT:	1
ANTONIO + AMANDA PETROLO	
DRAWING TITLE:	

OPENING SCHEDULE

No:	DRAWN BY:	SCALE:
1289/24	AD	1:1 @ /
	DATE:	DRAWING No:

AUG/24

ACCREDITED BUILDING DESIGNER DRAWING No: CHECKED BY: **DA.16** JJ

LABEL ID	W17	W18	W19	W20	W21	W22	W23	W24
ORIENTATION	ATION SOUTH SOUTH SOUTH		SOUTH	SOUTH	SOUTH	WEST	WEST	
ELEVATION	* 900 **	**************************************	3,000	1,300 p	3,000	3,000	3,400	3,000
LOCATION	FIRST FLOOR - ENS	FIRST FLOOR - ENS	FIRST FLOOR - STAIR	FIRST FLOOR - BATHROOM	FIRST FLOOR - BED 4	FIRST FLOOR - BED 2	GROUND FLOOR - KITCHEN	GROUND FLOOR - BILLIARDS
GLAZING	FROSTED	FROSTED	FROSTED	FROSTED	FROSTED	FROSTED	CLEAR	FROSTED

LABEL ID	W25	W26	W27
ORIENTATION	WEST	WEST	WEST
ELEVATION	4,000	1,300	4,000
LOCATION	FIRST FLOOR - BED	FIRST FLOOR - LINEN	FIRST FLOOR - BED 3
GLAZING	CLEAR	CLEAR	CLEAR

<u>NOTES</u>

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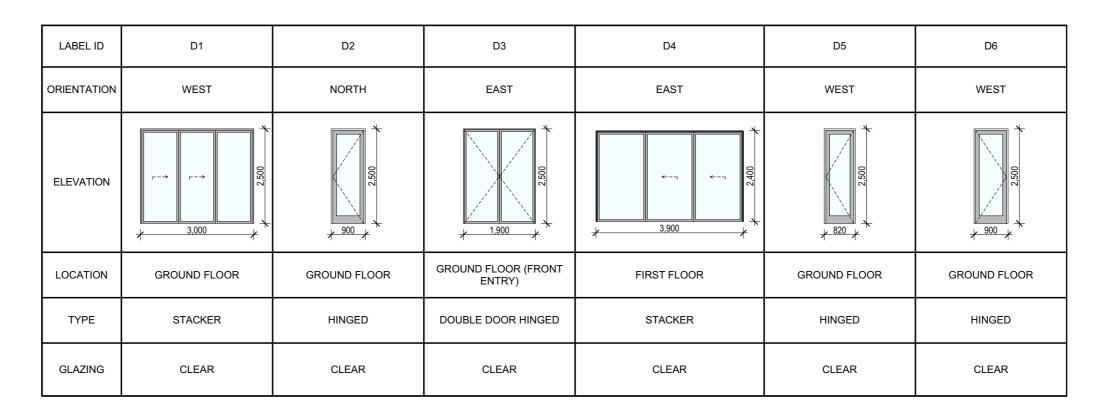
PROPOSED NEW BUILD	JOB N
34 COOK STREET, FORESTVILLE	_
CLIENT: ANTONIO + AMANDA PETROLO	1
DRAWING TITLE:	

OPENING SCHEDULE

DB No:	DRAWN BY:	SCALE:
1289/24	AD	1:1 @

BUILDING DESIGNER DRAWING No: DATE: CHECKED BY: AUG/24 DA.17 JJ

WINDOW SCHEDULE



DOOR SCHEDULE

<u>NOTES</u>

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• All workmanship & materials shall be in accordance with the requirements of current editions including amendments of the National Construction Code, relevant Australian Standards & local council requirements.

• New materials are to be used throughout unless otherwise noted.

• Concrete footings, slab, structural beams or any other structural members are to be designed by a practicing engineer.

by a practicing engineer.

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	REV:	DATE:	DESCRIPTION:
l	(A)	11/9/2024	PRELIM. DESIGN - FLOOR PLANS
l	(B)	1/10/2024	PRELIM. REVISION
l	(C)	30/10/2024	PRELIM. REVISION
l	Α	9/12/2024	DA DRAWINGS
l	В	8/1/2025	DA DRAWINGS (ADD NATHERS)
l	С	20/3/2025	DA DRAWING AMENDMENTS
l			

PROPOSED NEW BUILD 34 COOK STREET, FORESTVILLE CLIENT: ANTONIO + AMANDA PETROLO	JOB No: 1289/24	DR		
DRAWING TITLE: OPENING SCHEDULE				

DRAWN BY:	SCALE:	
AD		A C C R E D I T E D BUILDING DESIGNER
ATE:	DRAWING No:	CHECKED BY:
AUG/24	DA.18	.1.1