STORMWATER DRAINAGE NOTES:

- ALL PIPES TO BE 100mm Ø uPVC, LAID AT 1% MINIMUM GRADE TO AS1254.2002 U.N.O.
- ALL PIPES SHALL BE LAID ON A 75mm SAND BED, COMPACTED TO 100% S.M.D.D BELOW PAVEMENTS. (NO COMPACTION IS REQUIRED BELOW LANDSCAPING).
- · COVER TO SURFACE FROM TOP OF PIPE TO BE 300mm MINIMUM. BACKFILL TO BE ADEQUATELY CONSOLIDATED AROUND PIPES BY METHOD OF RAMMING AND WATERING IN. TRENCHES TO BE FILLED WITH GRANULAR MATERIAL AS SPECIFIED.
- DOWNPIPE LOCATIONS ARE INDICATIVE ONLY. LOCATIONS TO BE CONFIRMED WITH ARCHITECT PRIOR TO COMMENCEMENT OF WORK.
- PROVIDE CLEANING EYES AND LEAF CATCHERS TO ALL DOWNPIPES.
- ALL WORK TO BE IN ACCORDANCE WITH LOCAL COUNCIL STANDARDS AND SPECIFICATIONS.
- ALL LEVELS SHOWN ARE TO AHD.
- ENSURE THAT ALL PITS AND STORMWATER PIPES ARE LOCATED CLEAR FROM TREE ROOT SYSTEMS.
- ALL EXISTING EARTHENWARE PIPES TO BE UPGRADED TO uPVC.
- ALL WORKS TO BE IN ACCORDANCE WITH AS3500.3-2003 NATIONAL PLUMBING AND DRAINAGE CODE PART 3 - STORMWATER DRAINAGE.
- SUBSOIL DRAINS ARE TO BE INSTALLED IN ACCORDANCE WITH AS3500.3 ALONGSIDE WALLS THAT IMPEDE THE NATURAL FLOW OF GROUNDWATER. THIS MAY ALSO INVOLVE TRENCHING INTO THE CLAY OR ROCK SUBGRADE TO DIRECT GROUNDWATER AWAY FROM STRUCTURES.
- EXISTING ROOF DRAINAGE AND SITE DRAINAGE SYSTEM TO BE CHECKED AND UPGRADED AS REQUIRED. BUILDER TO INSPECT AND UPGRADE DRAINAGE IN ACCORDANCE WITH AS3500.3 IF REQUIRED.

RAINWATER STORAGE / REUSE NOTES:

THE RAINWATER TANK IS TO BE INSTALLED AND USED AS PER BASIX REQUIREMENTS AND SYDNEY WATER AND NSW HEALTH REQUIREMENTS FOR NON DRINKING USE ONLY.

- ALL CONNECTIONS TO PLUMBING AND RAINWATER TANKS IS TO BE IN ACCORDANCE WITH SYDNEY WATERS 'GUIDE TO INSTALLING A RAINWATER TANK' AVAILABLE AT: WWW.SYDNEYWATER.COM.AU.
- PROVIDE DUAL SUPPLY SYSTEM AND BACKFLOW PREVENTION SYSTEM IN ACCORDANCE WITH 'BASIX - DESIGN GUIDE FOR SINGLE DWELLINGS' BY NSW DEPARTMENT OF INFRASTRUCTURE, PLANNING AND NATURAL RESOURCES.
- IF NOT SPECIFIED ON PLANS, THE FIRST FLUSH SYSTEM IS TO HAVE A MINIMUM SIZE OF 20L PER 100 m2 OF ROOF CATCHMENT AREA PRIOR TO ENTERING THE RAINWATER TANK. INDIVIDUAL SITE ANALYSIS IS REQUIRED IN HEAVILY POLLUTED AREAS TO DETERMINE IF LARGER VOLUMES OF FIRST FLUSH RAINWATER ARE TO BE DIVERTED. IF IN DOUBT, CHECK WITH LOCAL HEALTH ALITHOPITIES

- SCREENED DOWNPIPE RAINWATER HEAD OR OTHER SUITABLE LEAF AND DEBRIS DEVICE TO BE INSTALLED ON EACH DOWNPIPE. SCREEN MESH TO BE 4-6mm AND DESIGNED TO BE SELF-CLEANING.
- · FIRST FLUSH DEVISED, OR APPROVED ALTERNATIVE TO BE INSTALLED WITH AND AUTOMATED DIVERSION AND DRAINAGE SYSTEM, THAT IS, NO MANUAL DIVERSION AND DRAINAGE VALVES. REFER TYPICAL FLUSH OUT PIT FOR DETAILS.
- BEFORE PURCHASING MATERIALS OR PAINT TO BE USED ON ROOF CATCHMENT AREAS, THE MANUFACTURER'S RECOMMENDATIONS ON LABELS AND BROCHURES FOR RAINWATER TANK SUITABILITY TO BE READ AND ADHERED TO.
- BUILDER/PLUMBER TO ENSURE THE INSTALLATION OF THE RAINWATER TANK SYSTEM IS IN ACCORDANCE WITH THE RELEVANT AUSTRALIAN STANDARDS AND THE RAINWATER TANK DESIGN AND INSTALLATION HANDBOOK - HB 230- 2008. IF IN DOUBT CONTACT FNGINFFR.
- RAINWATER TANK TO BE WATERPROOFED IN ACCORDANCE WITH HB-230-2008.
- · ORIFICE PLATE (IF APPLICABLE) TO BE INSTALLED PRIOR TO THE INSTALLATION OF THE ROOF DRAINAGE SYSTEM AND CONNECTION OF THE STORMWATER SYSTEM TO THE OSD TANK.

LEGEND

DP1 - xxx 🔘 DP1 - 100mm Ø DOWNPIPE TO RAINWATER TANK xxx - ROOF CATCHMENT AREA TO DOWNPIPE

SS PIPELINE SUSPENDED FROM SOFFIT OF SLAB OVER

SP 🔒 100mm Ø DOWNPIPE SPREADER TO LOWER ROOF

GDE

100mm Ø uPVC STORMWATER PIPELINE, UNO

150 (W) x 150 (D) GRATED DRAIN

GRAVITY LINE PROVIDE 1% (MIN) FALL, UNO.

SITE INFORMATION SUMMARY

COUNCIL NORTHERN BEACHES (PITTWATER) SITE AREA 719.4 m 284 m² (40%) **EXISTING IMPERVIOUS AREA**

SINCE THERE IS A REDUCTION IN SITE AREA, OSD IS NOT REQUIRED FOR THIS DEVELOPMENT.

271 m² (38%)

DIAL BEFORE YOU DIG NOTICE

NO INVESTIGATION OF UNDERGROUND SERVICES HAS BEEN MADE. ALL RELEVANT AUTHORITIES SHOULD BE NOTIFIED PRIOR TO ANY EXCAVATION ON OR NEAR THE SITE

DEVELOPERS & EXCAVATORS MAY BE HELD FINANCIALLY RESPONSIBLE BY THE ASSET OWNER SHOULD THEY DAMAGE UNDERGROUND NETWORKS

PROPOSED IMPERVIOUS AREA

- CAUSE EXPENSIVE FINANCIAL LOSSES TO BUSINESS
- CUT OFF EMERGENCY SERVICES
 DELAY PROJECT COMPLETION TIMES
 WHILE THE DAMAGE IS REPAIRED

BEFORE YOU DIG. - TEL. 1100




WITH LO	CAL HEALTH AUTHORITIES.			
				BILL KERLEY
			Architect	
-	ISSUE FOR DA SUBMISSION ONLY	3/12/20		BAIKIE CORR
REVISION	AMENDMENT	DATE		



2/25 Seabeach Avenue, Mona Vale ABN - 90 625 916 341

53 THE AVENUE	EG	EG Designed EG		03/12/2020		
NEWPORT	Checked EG	Approved EG	Scale 1: 200			
Title	Drawing number	Job number		Revision		
	SW0	2020	206	-		

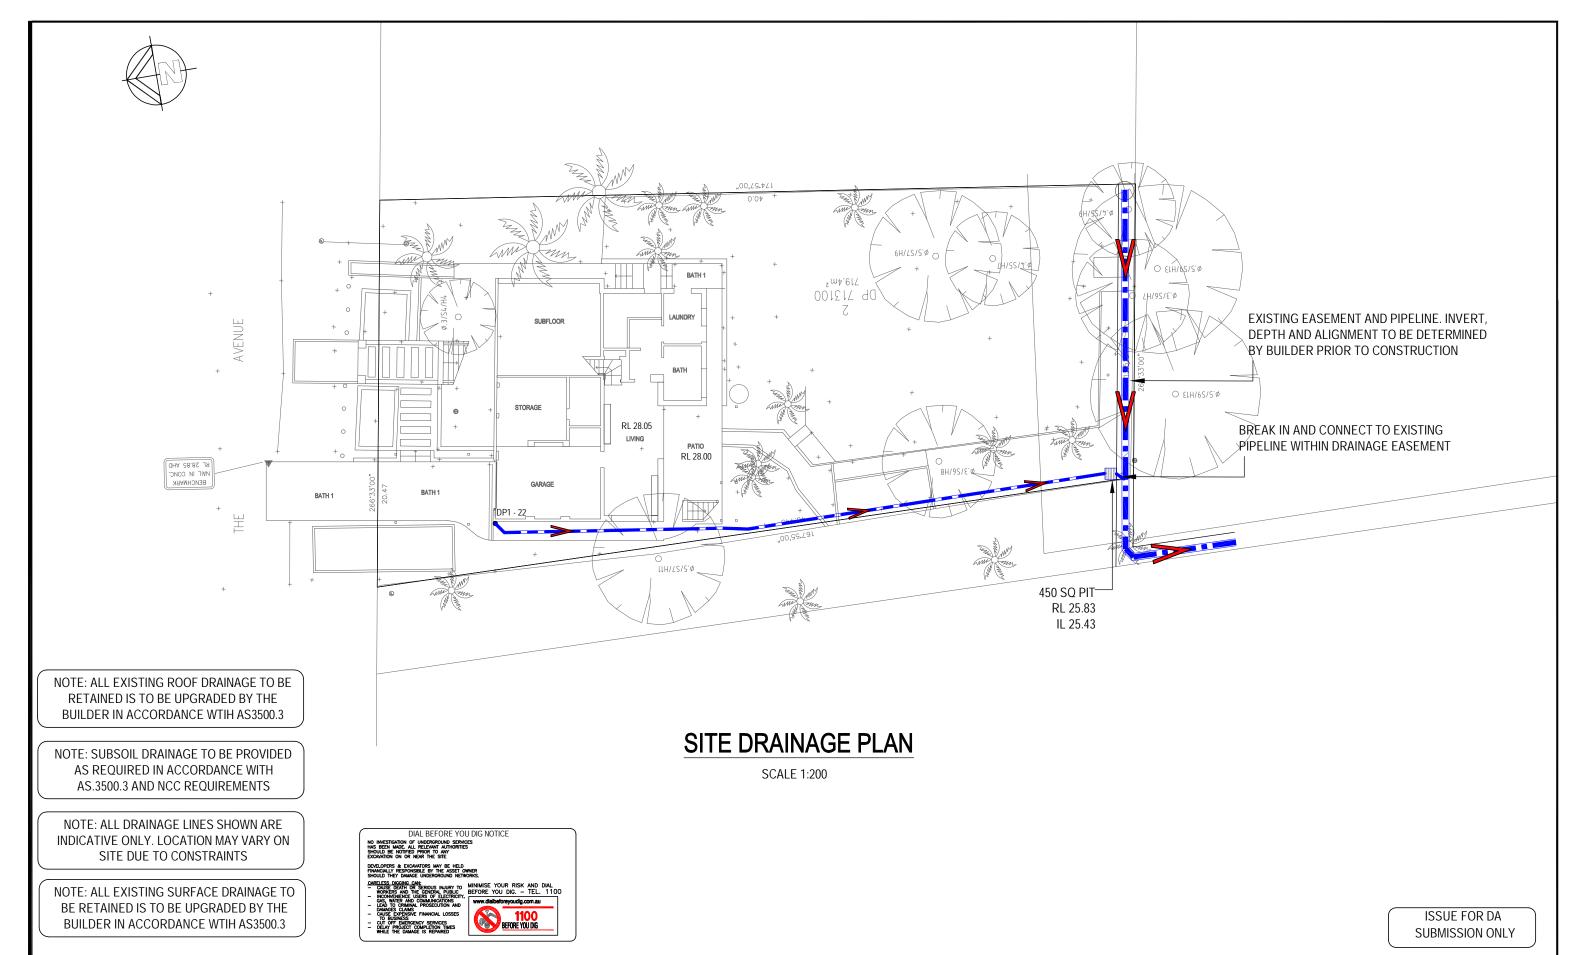

		BILL KERLEY	GREENWOOD CONSULTING	Project	53 THE AVENUE	EG	Designed EG Approved	03/12/2020 Scale
		Architect	ENGINEERS		NEWPORT	Checked EG	EG	1 : 200
				Title	SITE	Drawing number	Job number	Revision
-	ISSUE FOR DA SUBMISSION ONLY 3/12/2	BAIKIE CORR	2/25 Seabeach Avenue, Mona Vale			SW0 2	2020	0206 -
REVISION	AMENDMENT DATE		ABN - 90 625 916 341		DRAINAGE PLAN			






FIRST FLOOR DRAINAGE PLAN

SCALE 1:200

ISSUE FOR DA SUBMISSION ONLY

		BILL KERLEY	GREENWOOD CONSULTING	53 THE AVENUE	EG Checked	Designed EG	03/12/2020 Scale
		Architect	ENGINEERS	NEWPORT	EG	Approved EG	1 : 200
-	ISSUE FOR DA SUBMISSION ONLY 3/12/2		2/25 Seabeach Avenue, Mona Vale ABN - 90 625 916 341	FIRST FLOOR DRAINAGE PLAN	Drawing number SW03	Job number 20202	Revision -
REVISION	AMENDMENT DATE		MBN 70 023 710 341	DIVIIIVIOL I LIIV			



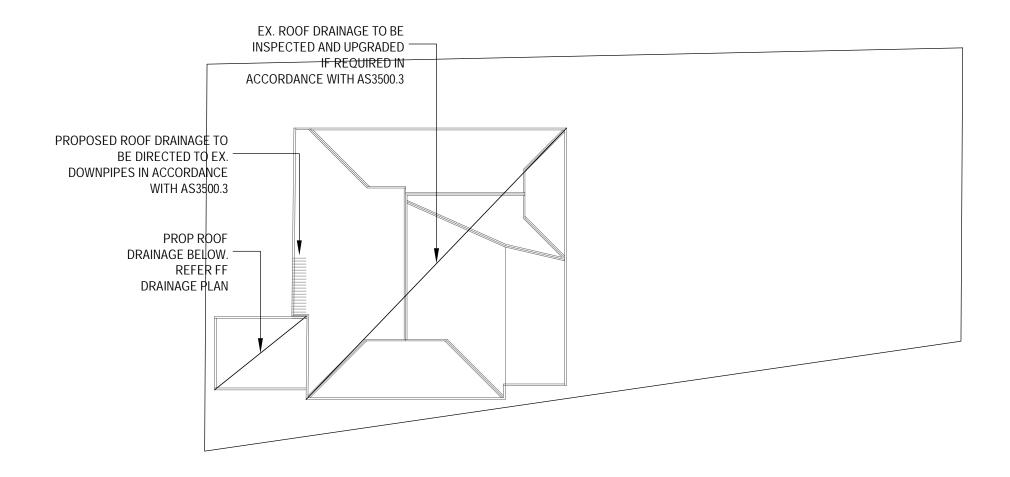

ROOF DRAINAGE PLAN

SCALE 1:200

ISSUE FOR DA SUBMISSION ONLY

	BILL KERLEY Architect	4	GREENWOOD CONSULTING ENGINEERS	Project	53 THE AVENUE NEWPORT	EG Checked EG	Designed EG Approved EG	03/12/2020 Scale 1: 200
12/20 DATE	BAIKIE CORR		2/25 Seabeach Avenue, Mona Vale ABN - 90 625 916 341	Title	ROOF DRAINAGE PLAN	Drawing number SW0 4	Job number 2020	Revision -

CONNECTION TO R.C. PIPE

THE R.C. STORMWATER PIPE SHALL BE PIERCED BY A NEAT OPENING AS SHOWN TO ALLOW THE CONNECTION OF A SQUARE, SLOPED JUNCTION OR BEND WHICH SHALL NOT PROTRUDE BEYOND THE INNER SURFACE OF THE R.C. STORMWATER PIPE


THE INTERNAL JUNCTION SHALL BE SMOOTHLY FINISHED WITH 2:1 CEMENT MORTAR OR EPOXY CEMENT SO AS TO PRESENT NO OBSTRUCTION WITHIN THE INTERNAL SURFACE OF THE R.C. STORMWATER PIPE. THE LINE IS NOT TO EXTEND BEYOND POINT 1 UNTIL APPROVED BY COUNCIL


THE HOLE IN COUNCIL'S PIPE IS TO BE FORMED BY CAREFUL DRILLING TO NEATLY ACCEPT THE OUTSIDE DIAMETER OF THE PIPE

ANY DAMAGE TO THE STRUCTURE OF COUNCIL'S PIPE IS TO BE MADE GOOD TO THE SATISFACTION OF COUNCIL'S ENGINEER, IF NECESSARY BY THE REPLACEMENT OF THE PIPE

PIPE FITTINGS ARE TO BE VETRIFIED CLAY OR SEWER QUALITY UPVC


COUNCIL PIPELINE IS TO BE LEFT FREE OF DROPPED CLAY, CONCRETE, MORTAR, ETC...

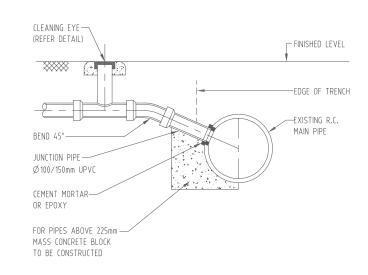

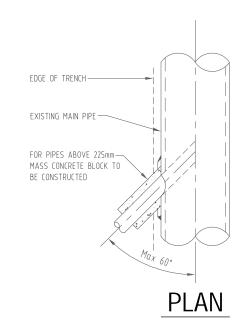


TYPICAL CONNECTION TO EXISTING R.C. PIPE DETAILS

SCALE = N.T.S.

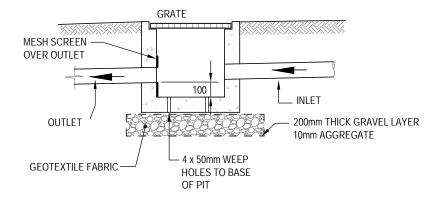

ALTERNATIVE POLYPROPYLENE PIT BY MANUFACTURER

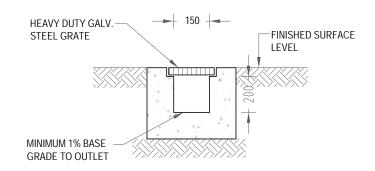

PIT DETAIL SCALE = NTS

GRATED DRAIN DETAIL (GDE)

SCALE = NTS

ISSUE FOR DA SUBMISSION ONLY

- ISSUE FOR DA SUBMISSION ONLY 3/12/20
REVISION AMENDMENT DATE

GREENWOOD CONS ENGINEER	
2/25 Seabeach Avenue, Mona Va	ale

ABN - 90 625 916 341

Project	53 THE AVENUE NEWPORT	EG Checked EG	Designed EG	03/12/2020 Scale 1:200	
Title	DETAILS	Drawing number SW0 5	Job number 2020	206	Revision -



ABN 90 625 916 341 2/25 Seabeach Avenue, Mona Vale, NSW, 2103 Email – eliot@greenwoodengineers.com.au

04/12/2020 Eliot Greenwood 53 The Avenue Newport, NSW

Project Reference: 2020206

To whom it may concern,

RE: ALTERATIONS AND ADDITIONS AT 53 THE AVENUE NEWPORT - CIVIL DESIGN STATEMENT

Greenwood Consulting Engineers has designed the stormwater for the above address (Drawing Numbers: SW01-SW05 (03-12-20)) and confirm that the plans have been completed from the architectural plans prepared by Baikie Corr (Drawing No's: A000 – A501, Revision B).

The design and documentation is in general compliance with the National plumbing and drainage code AS3500.3 and Northern Beaches (Pittwater) Council's DCP.

I am an appropriately qualified and competent person in this area and as such can certify that the design and performance of the alterations & additions to the address above will comply with the above Australian Standards. I possess indemnity insurance to the satisfaction of the building owner or my principal.

Designer: Eliot Greenwood

Business no: 0421399423

Qualifications: MIE Aust. NER

Institute of Engineers Australia No: 3726157

Address: 2/25 Seabeach Avenue, Mona Vale, NSW, 2103

We believe above meets your current need. Please don't hesitate to contact me if you have any queries.

Yours sincerely,

Eliot Greenwood

Director

Greenwood Consulting Engineers