

Level 1, 152-160 Hunter St Newcastle, NSW AUSTRALIA 2300 Ph: 0481 781 757



DEVELOPMENT APPLICATION DRAWINGS ISSUED FOR APPROVALS ONLY - NOT FOR CONSTRUCTION PURPOSES UNTIL ISSUED BY DESIGNER. DO NOT SCALE THE DRAWINGS. THE BUILDER SHALL CHECK AND VERIFY ALL DIMENSIONS AND VERIFY ALL ERRORS AND OMISSIONS WITH THE DESIGNER.

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	01		17/05/2018
S	03		7/11/2018
	04		14/01/2019
Y	05	Landscape Ratios, DA Setbacks, Rear Pergola	3/04/2019
L			
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10 The Crescent North Narrabeen, NSW 2101 LOT:11 DP: 6462 Crescent House


LODGEMENT SET




ISSUED

Site Plan/Analysis/Landscape Site Plans

1710CRE A.01.1 05

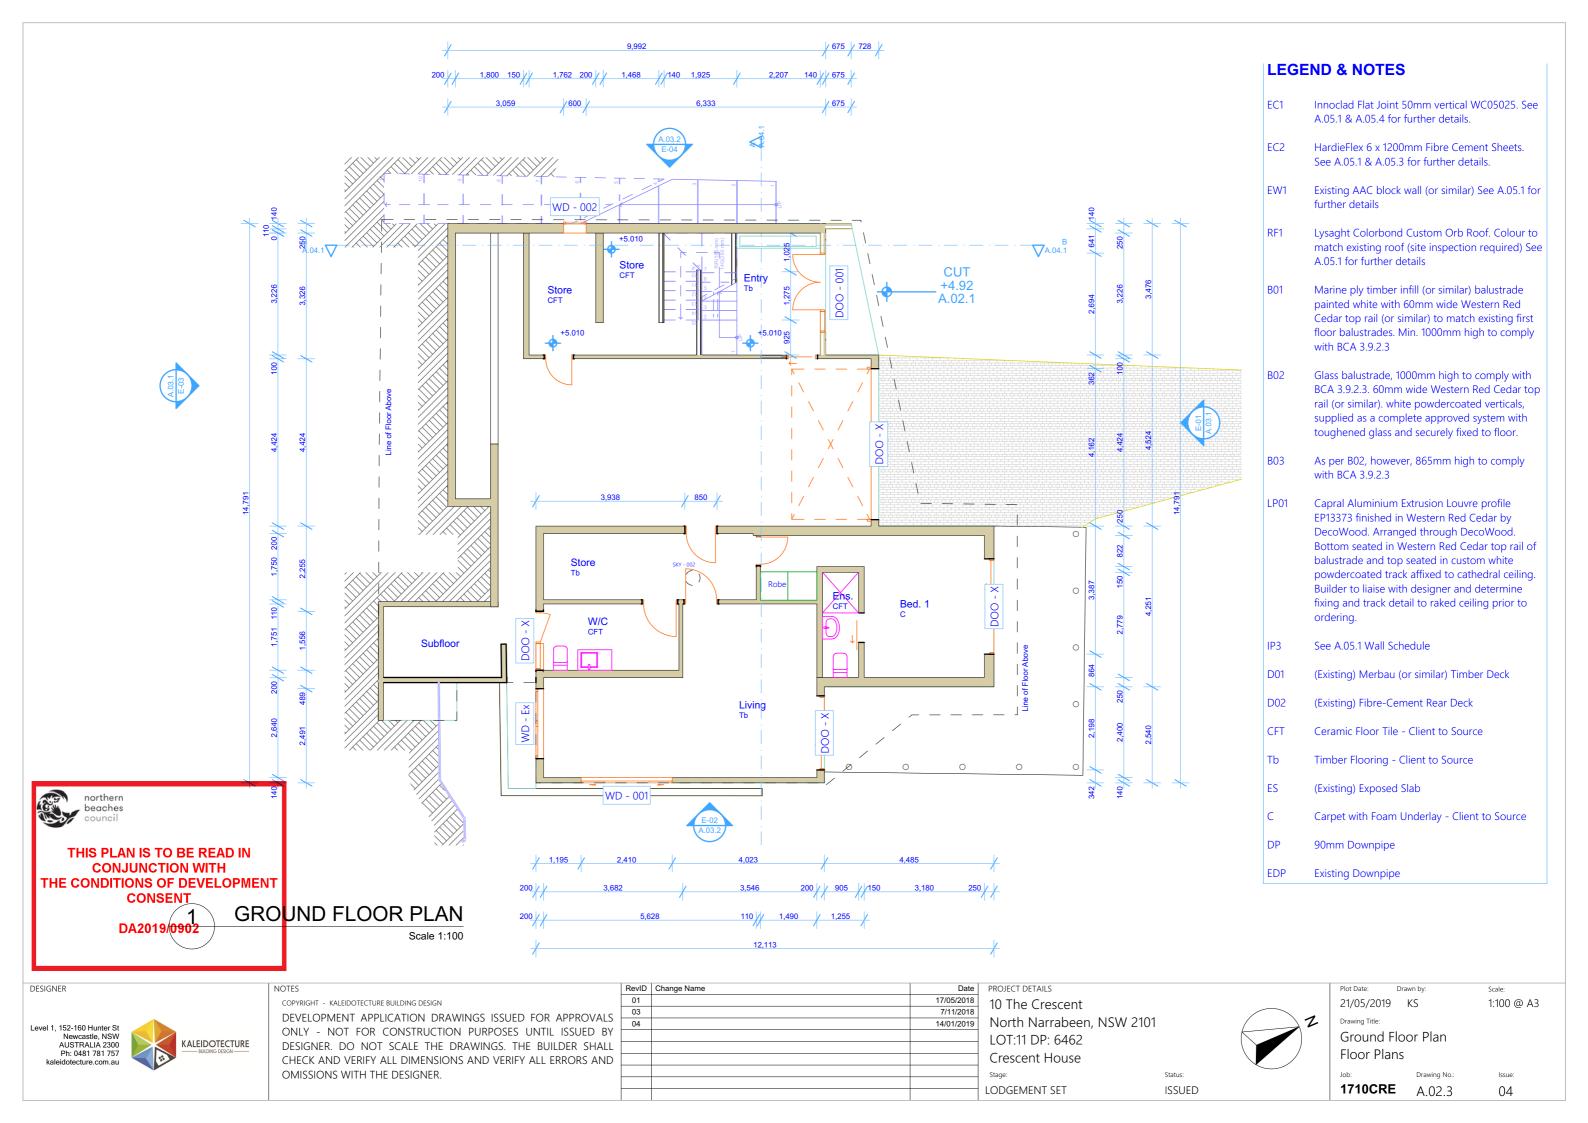

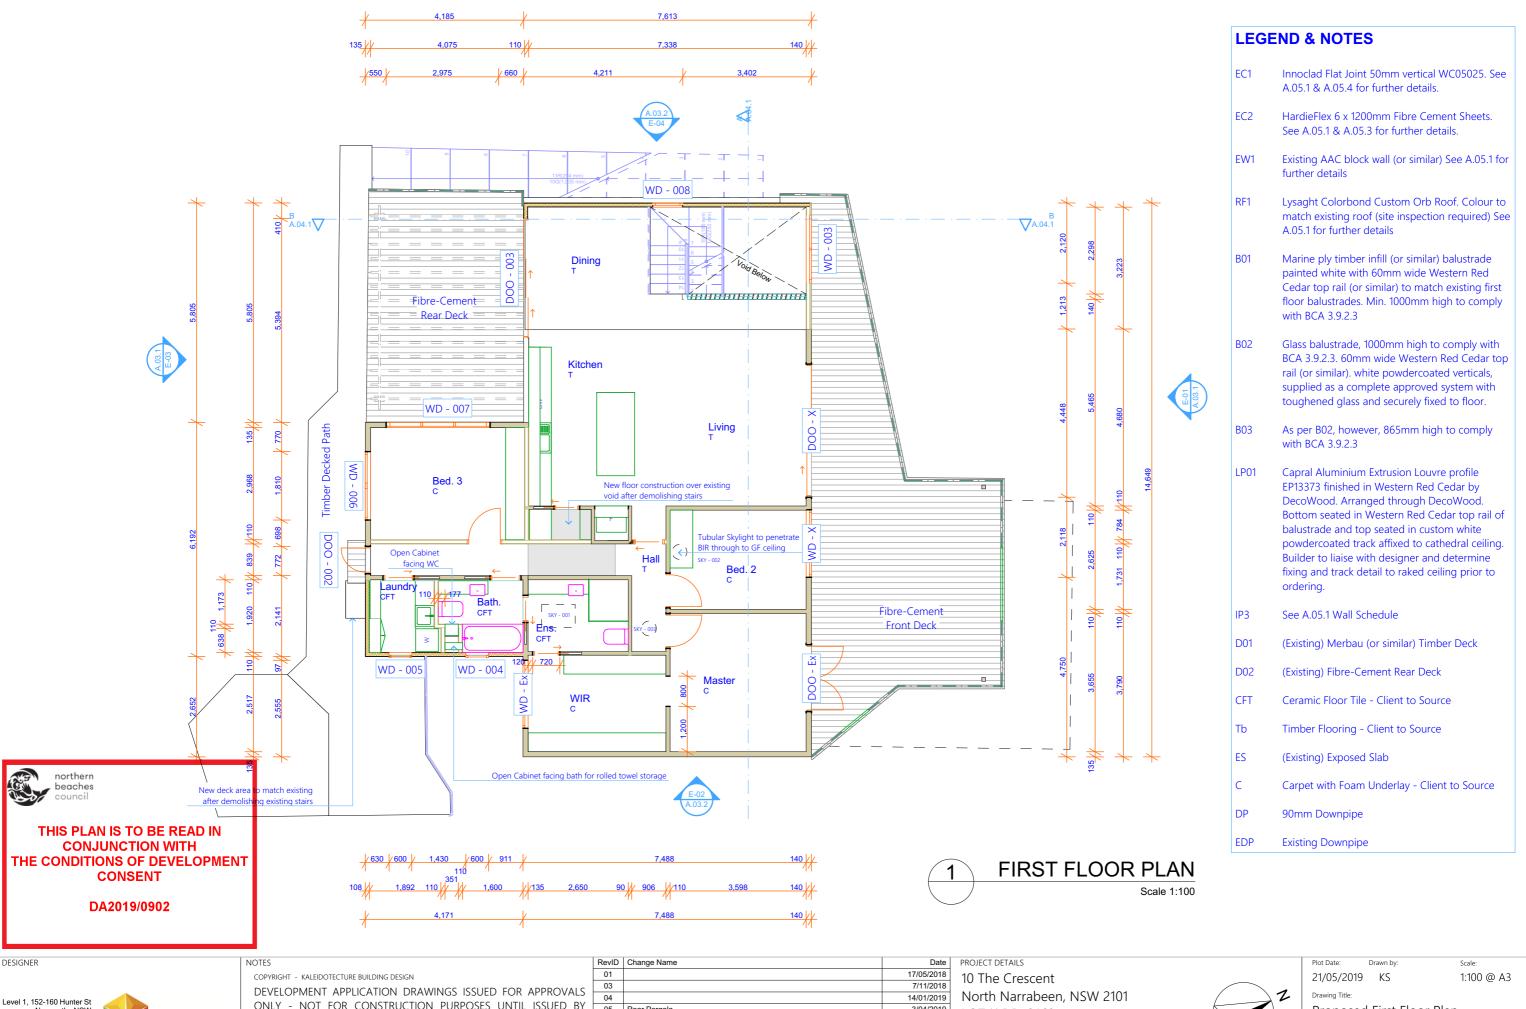

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	01		17/05/2018
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	04		14/01/2019
Υ	05	Rear Pergola	3/04/2019
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LOT:11 DP: 6462 Crescent House

LODGEMENT SET


ISSUED

Proposed First Floor Plan Floor Plans

A.02.4

05

1710CRE

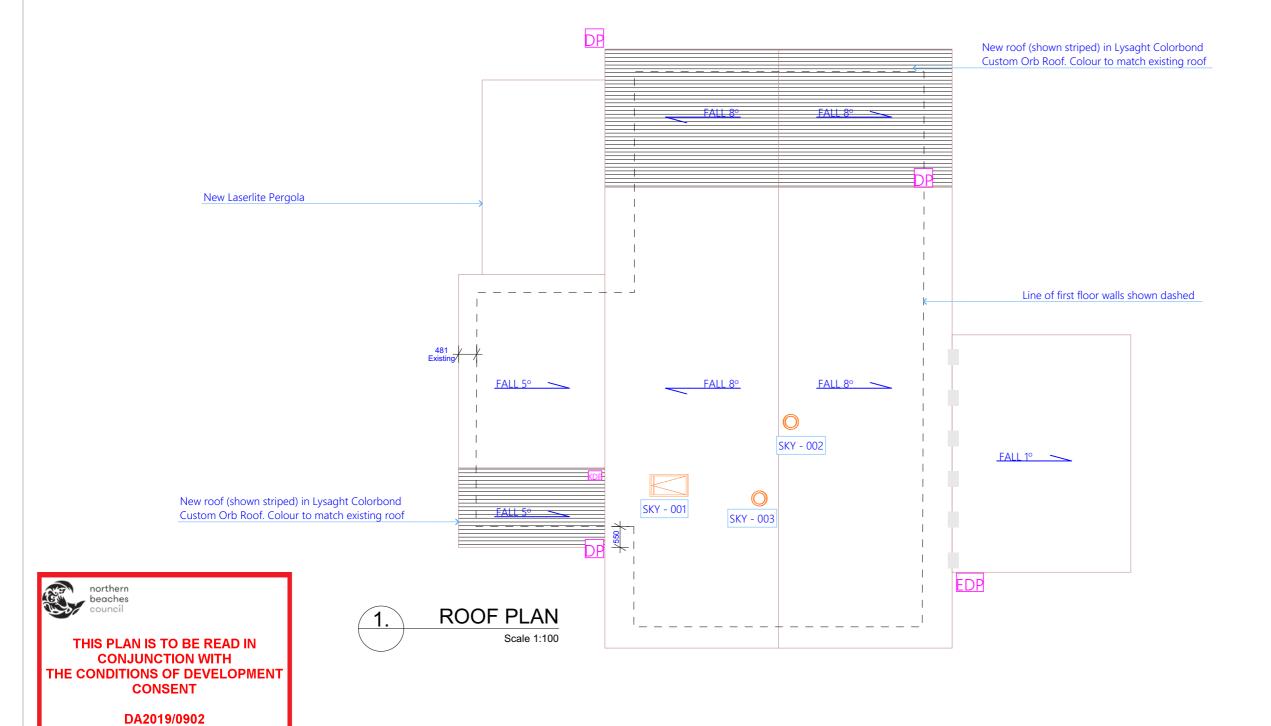

DESIGNER

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NOTES

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	RevID	Change Name	Date
	01		17/05/2018
ς	03		7/11/2018
<i>y</i>	04		14/01/2019
Y	05	Rear Pergola	3/04/2019
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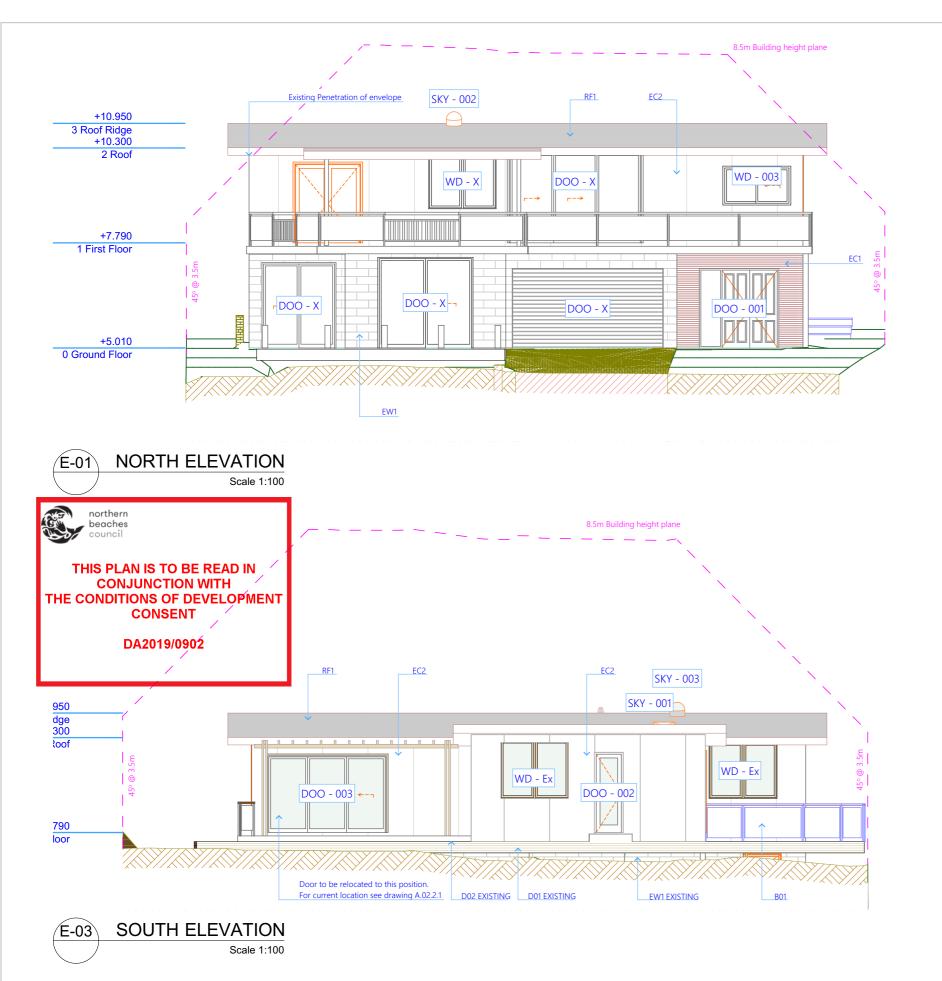
PROJECT DETAILS
10 The Crescent
North Narrabeen, NSW 2101
LOT:11 DP: 6462
Crescent House
61

LODGEMENT SET



ISSUED

Plot Date: Dr.	awn by:	Scale:
21/05/2019	KS	1:100 @ A3
Drawing Title:		
Proposed F	Roof Plan	
Floor Plans		
Job:	Drawing No.:	Issue:
1710CRE	A.02.5	05
	21/05/2019 Drawing Title: Proposed F Floor Plans Job:	21/05/2019 KS Drawing Title: Proposed Roof Plan Floor Plans Job: Drawing No.:



LEGEND & NOTES Innoclad Flat Joint 50mm vertical WC05025. See A.05.1 & A.05.4 for further details. EC2 HardieFlex 6 x 1200mm Fibre Cement Sheets. See A.05.1 & A.05.3 for further details. Existing AAC block wall (or similar) See A.05.1 for further details Lysaght Colorbond Custom Orb Roof. Colour to match existing roof (site inspection required) See A.05.1 for further details Marine ply timber infill (or similar) balustrade painted white with 60mm wide Western Red Cedar top rail (or similar) to match existing first floor balustrades. Min. 1000mm high to comply with BCA 3.9.2.3 Glass balustrade, 1000mm high to comply with BCA 3.9.2.3. 60mm wide Western Red Cedar top rail (or similar). white powdercoated verticals, supplied as a complete approved system with toughened glass and securely fixed to floor. As per B02, however, 865mm high to comply with BCA 3.9.2.3 Capral Aluminium Extrusion Louvre profile EP13373 finished in Western Red Cedar by DecoWood. Arranged through DecoWood. Bottom seated in Western Red Cedar top rail of balustrade and top seated in custom white powdercoated track affixed to cathedral ceiling. Builder to liaise with designer and determine



See A.05.1 Wall Schedule

D01 (Existing) Merbau (or similar) Timber Deck

fixing and track detail to raked ceiling prior to

(Existing) Fibre-Cement Rear Deck

Ceramic Floor Tile - Client to Source

Tb Timber Flooring - Client to Source

(Existing) Exposed Slab

ordering.

Carpet with Foam Underlay - Client to Source

90mm Downpipe

Existing Downpipe

DESIGNER	
Loyal 1 152 160 Huntar St	

Ph: 0481 781 757

NOTES

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	RevID	Change Name	Date
	01		17/05/2018
S	03		7/11/2018
	04		14/01/2019
Y	05	Rear Pergola	3/04/2019
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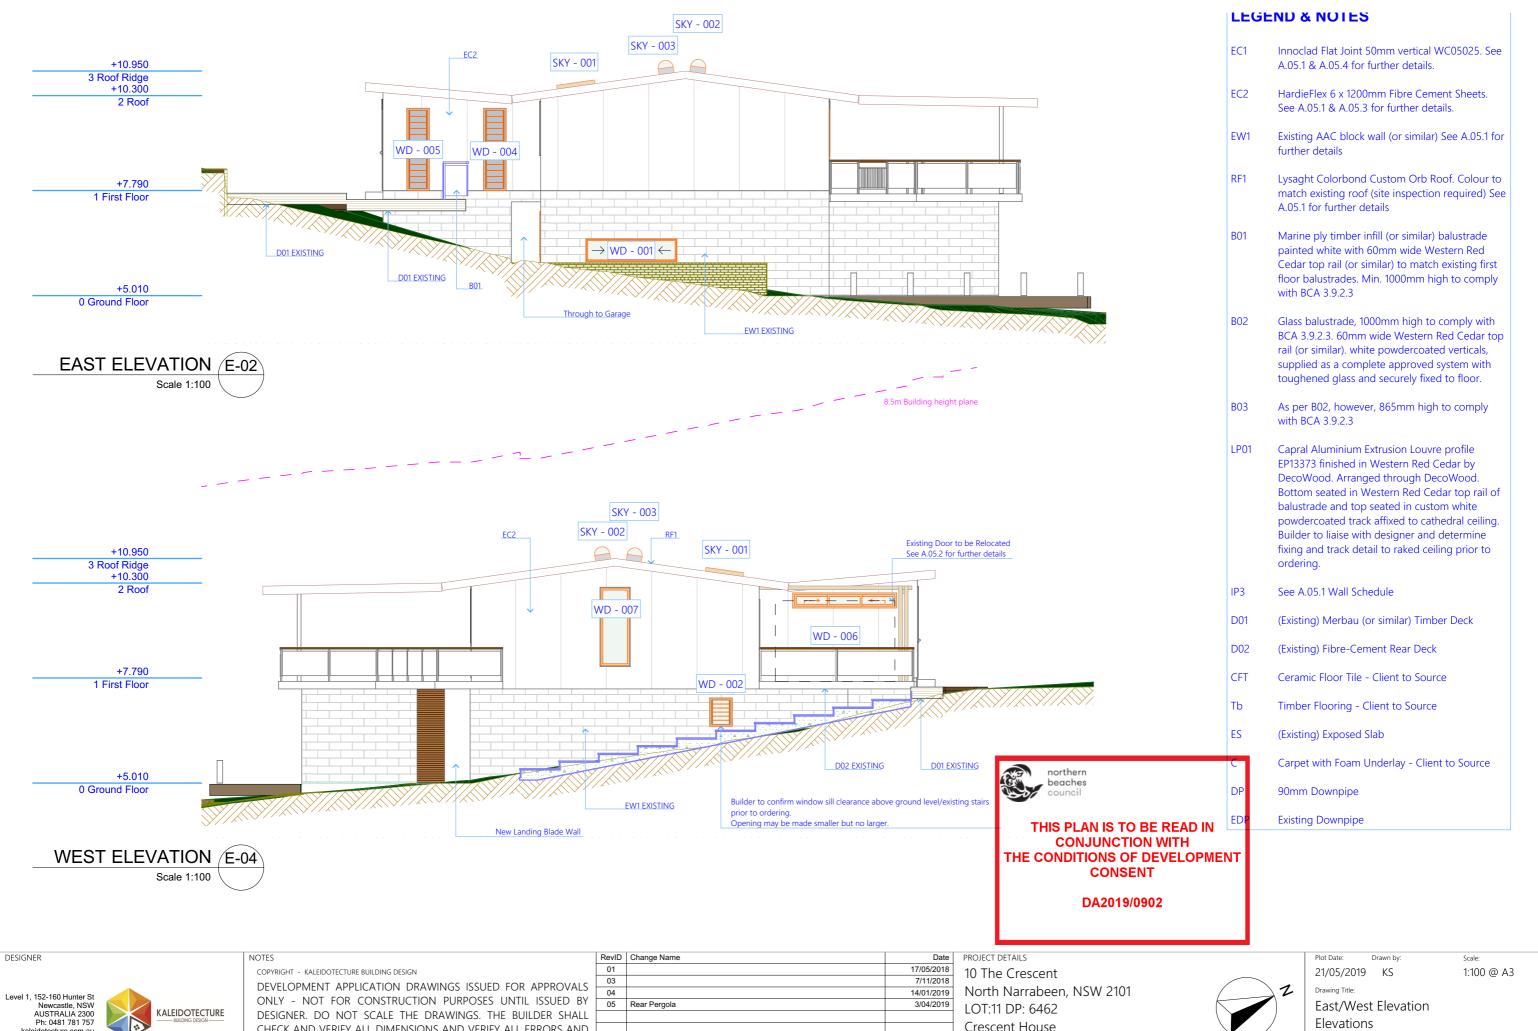
PROJECT DETAILS 10 The Crescent North Narrabeen, NSW 2101 LOT:11 DP: 6462 Crescent House

LODGEMENT SET



ISSUED

Plot Date: Dr	awn by:	Scale:
21/05/2019	KS	1:100 @ A3
Drawing Title:		
North/Sout	h Elevation	
Elevations		
Job:	Drawing No.:	Issue:
1710CRE	A.03.1	05



CHECK AND VERIFY ALL DIMENSIONS AND VERIFY ALL ERRORS AND OMISSIONS WITH THE DESIGNER.


	01		17/05/2018
S	03		7/11/2018
	04		14/01/2019
Y	05	Rear Pergola	3/04/2019
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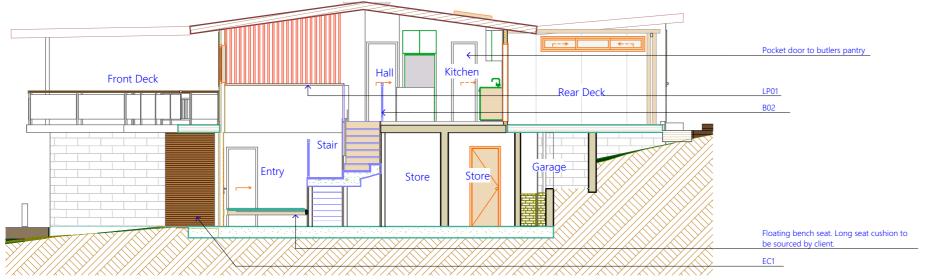
Crescent House

LODGEMENT SET

ISSUED

Plot Date: Dr 21/05/2019	awn by: KS	Scale: 1:100 @ A3
Drawing Title: East/West I Elevations	Elevation	
Job: 1710CRE	Drawing No.: A.03.2	Issue: 05



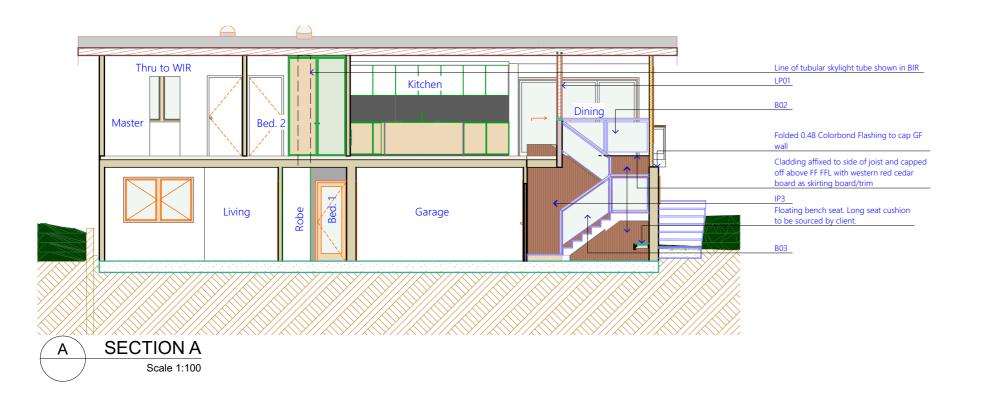

RevID Change Name





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	KeviD	Change Name	Date
	01		17/05/2018
-	03		7/11/2018
,	04		14/01/2019
1	05	Rear Pergola	3/04/2019
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PROJECT DETAILS 10 The Crescent North Narrabeen, NSW 2101 LOT:11 DP: 6462 Crescent House

LODGEMENT SET



ISSUED

Drawing Title:

Sections

Sections A & B

1710CRE A.04.1

05

	Plot Date: Drawn by: Scale: 21/05/2019 KS 1:100 @ A3
EDP	Existing Downpipe
DP	90mm Downpipe
С	Carpet with Foam Underlay - Client to Source
ES	(Existing) Exposed Slab
Tb	Timber Flooring - Client to Source
CFT	Ceramic Floor Tile - Client to Source
D02	(Existing) Fibre-Cement Rear Deck
D01	(Existing) Merbau (or similar) Timber Deck
IP3	See A.05.1 Wall Schedule
LP01	Capral Aluminium Extrusion Louvre profile EP13373 finished in Western Red Cedar by DecoWood. Arranged through DecoWood. Bottom seated in Western Red Cedar top rail of balustrade and top seated in custom white powdercoated track affixed to cathedral ceiling. Builder to liaise with designer and determine fixing and track detail to raked ceiling prior to ordering.
B03	As per B02, however, 865mm high to comply with BCA 3.9.2.3
	supplied as a complete approved system with toughened glass and securely fixed to floor.

LEGEND & NOTES

further details

with BCA 3.9.2.3

A.05.1 for further details

EC2

Innoclad Flat Joint 50mm vertical WC05025. See

HardieFlex 6 x 1200mm Fibre Cement Sheets.

Existing AAC block wall (or similar) See A.05.1 for

Lysaght Colorbond Custom Orb Roof. Colour to match existing roof (site inspection required) See

Marine ply timber infill (or similar) balustrade painted white with 60mm wide Western Red Cedar top rail (or similar) to match existing first floor balustrades. Min. 1000mm high to comply

Glass balustrade, 1000mm high to comply with BCA 3.9.2.3. 60mm wide Western Red Cedar top

rail (or similar). white powdercoated verticals,

See A.05.1 & A.05.3 for further details.

A.05.1 & A.05.4 for further details.