







Perspective plan



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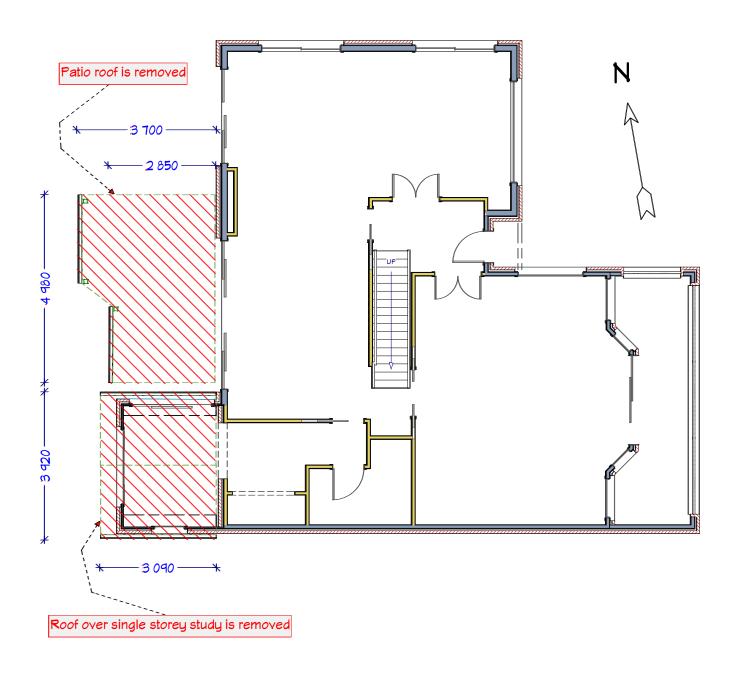
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General Notes:
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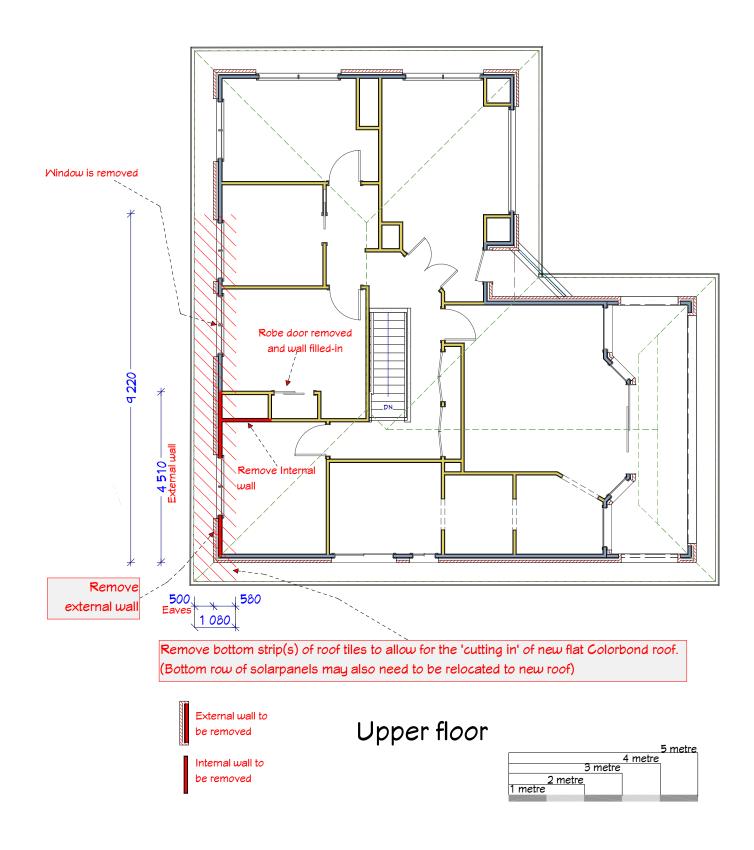
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All work to be carried out in accordance with engineering plans, local council's NOD, BCA, Australian Standards and any relevant authorities.

Alterations and addition to 2 rooms	Scale:	N/A
and new balcony	Size:	A3
51 Radio Avenue,	Date:	10/01/2022
Balgowlah Heights	Drawing No:	01
Emily & David Mashbrook	Version:	4.1



Ground floor



<u>Demolition plan</u>



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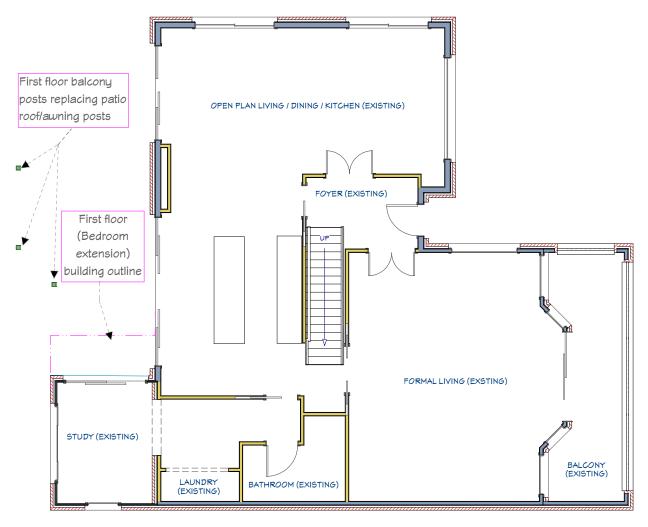
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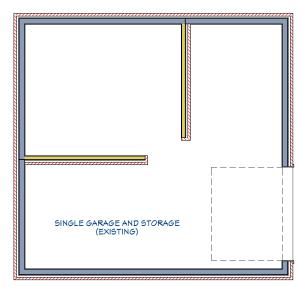
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	Alterations and addition to 2 rooms	Scale:
	and new balcony	Size:
	51 Radio Avenue,	Date:
	Balaowlah Heiahts	Drawina No:

1:100 A3 10/01/2022 Emily & David Mashbrook Version:



Ground floor



Lower ground floor (garage)



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and new balcony	Size:	A3
51 Radio Avenue,	Date:	10/01/2022
Balgowlah Heights	Drawing No:	03
Emily & David Washbrook	Version:	4.1

N

BED (EXISTING) BATH (EXISTING) BALCONY (NEW) D2 BALCONY (EXISTING) BED (IMPROVED) Ground floor building outline New robe D1 MASTER (EXISTING) M4 GUEST BED (NEW) MЗ ENSUITE (EXISTING) MIR (EXISTING) EN-SUITE (NEW) *1 175 \ Robe - 3 **5**30 -*Balcon*y New external wall 2 620 -New internal wall 180,45 -3 770 Guest Bed New internal wall-ledge: Upper floor 1200mm high and 100 deep (to house in-wall cistern)

BED (EXISTING)

Window Schedule

					Head	
Window:	Туре	Width	Height	SQM	Height	Note
W1	Awning	950	500	0.48	2230	Frosted
W2	Triple sliding	2200	500	1.10	2230	Centre fixed
W3	Glass Louvre	900	1400	1.26	2230	(one unit with W4)
W4	Fixed	1400	1400	1.96	2230	(one unit with W3)
D1	Sliding	2130	2230	4.75	2230	Two Panels
D2	Sliding & Aneeta in fixed panel	600	1100	0.66	2230	Door & window combo



Floor plan

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North - secondary street façade - elevation



Elevations plan



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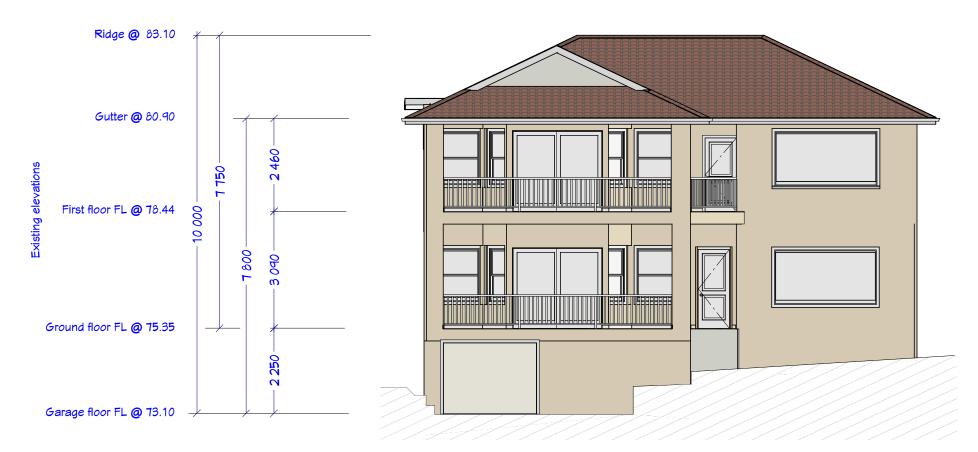
awning posts

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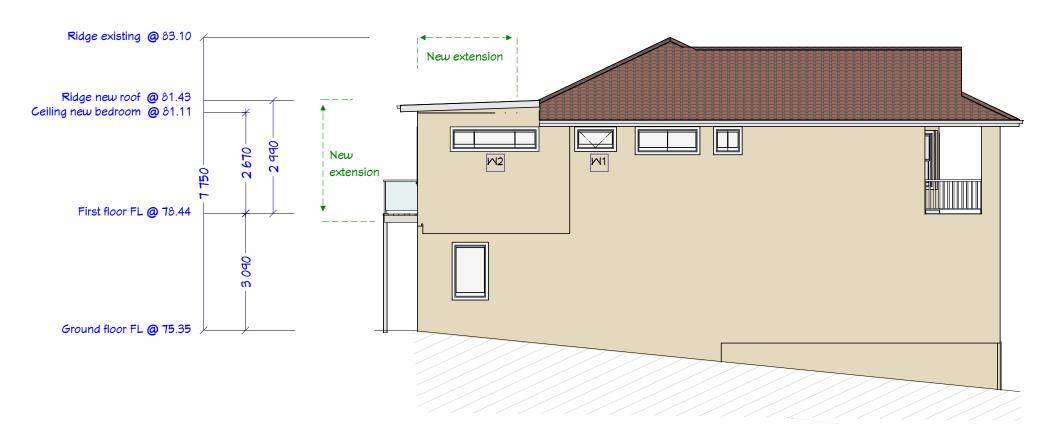
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51 Radio Avenue,	Date:	10/01/2022
Balgowlah Heights	Drawing No:	04.1
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East - primary street façade (Radio Ave) - elevation



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Elevations plan

South - side - elevation



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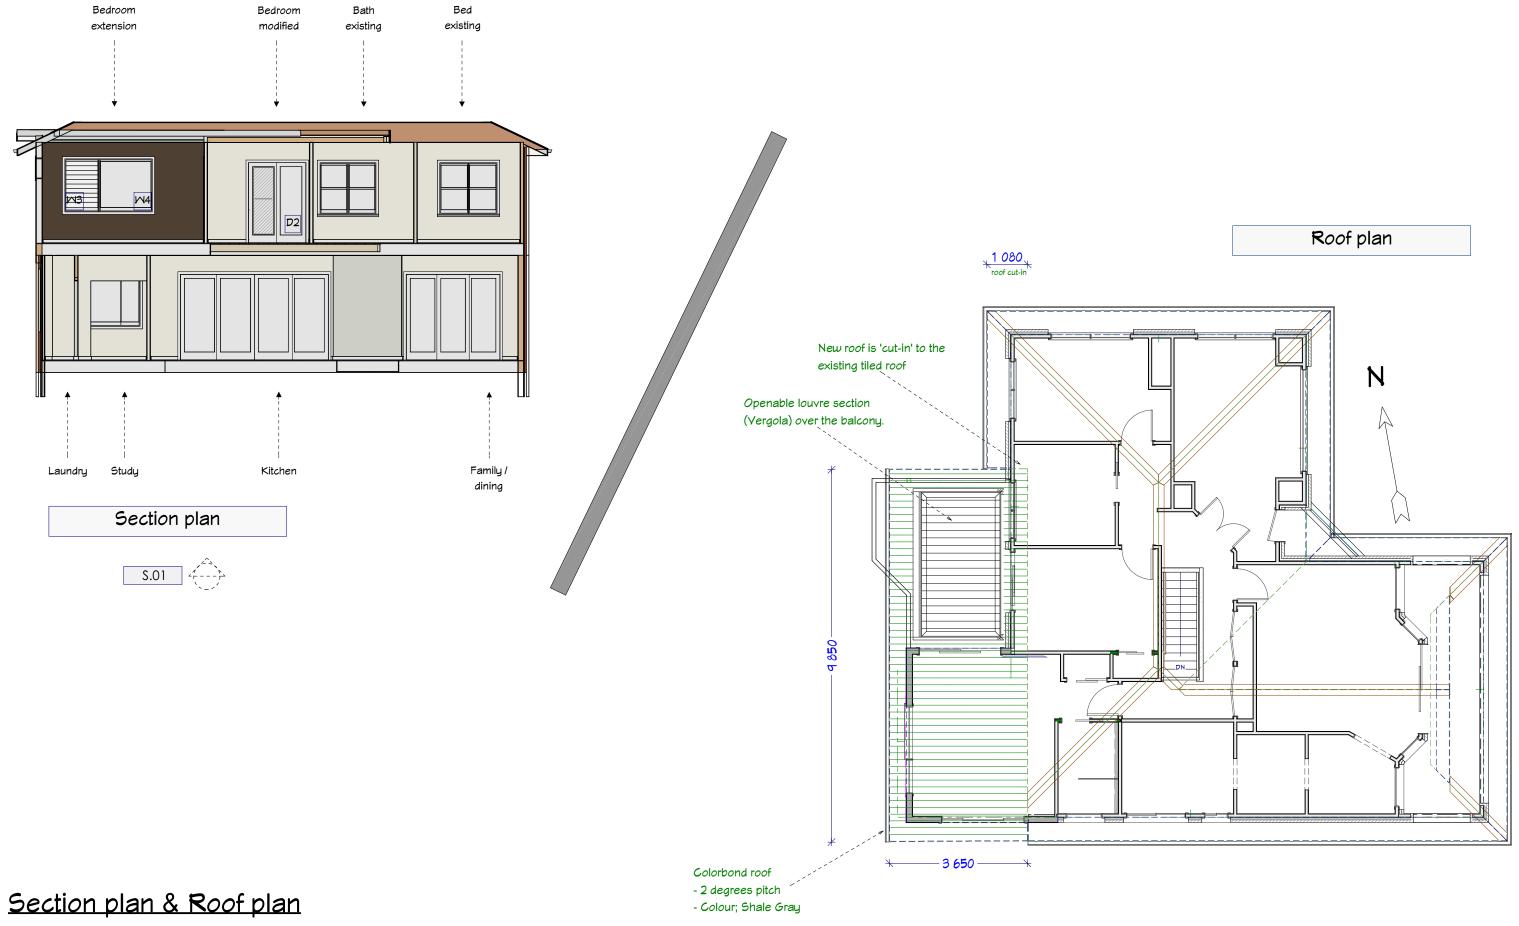
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and new balcony	Size:
51 Radio Avenue,	Date:
Balgowlah Heights	Drawing No:
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1:100

10/01/2022

A3

04.2



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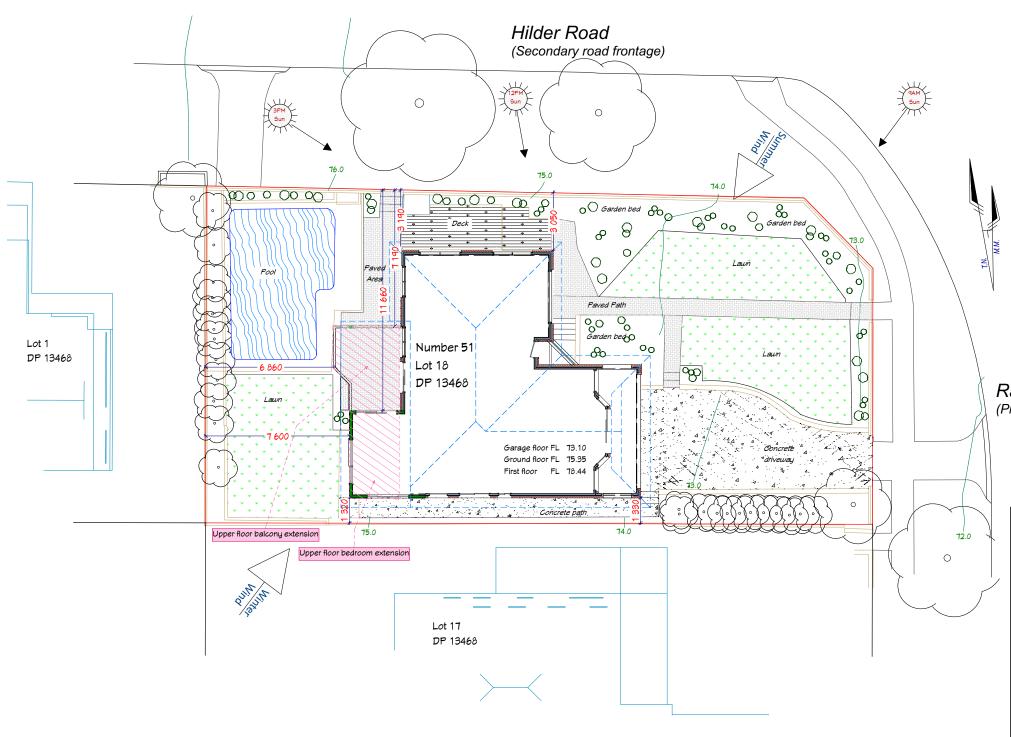
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51 Radio Avenue,	Date:	10/01/2022
Balgowlah Heights	Drawing No:	05
Emily & David Washbrook	Version:	4.1



Radio Avenue (Primary road frontage)

Property width at the building line 17.45 metres				
Property width at the building line 17.45 metes	SQM	SQM	SQM	
Site area			611.1	100%
Existing footprint:				
Dwelling	133.8			21.9%
Front balconies	16.1			2.6%
Total existing dwelling footprint	_	149.9		24.5%
New footprint:				
Bedroom extension northerly overhang	3.0			0.5%
Balcony	14.1			2.3%
Total new	_	17.1		2.8%
Removed:				-2.7%
Patio roof	-16.3			
Zero change:				
(section between study and patio roof is paved)	-0.7			
Net increase of non pervious surfaces	_	0.1		0.0%
Existing other hard surfaces:				
Driveway	53.5			8.8%
Paved front path	34.1			5.6%
Decking (north side)	17.1			2.8%
Rear garden paving (not covered by new balcony)	15.5			2.5%
Pool coping	18.9			3.1%
total additional hard surfaces	_	139.1	_	22.8%
Total of all buildings and hard surfaces post development		_	306.1	50.1%

Site plan & Site Analysis plan

Landscaped area and open space % of open Is the same pre and post construction: SQM SQM SQM space % of site 611.1 100% Site area 363.3 59.5% Total open space 224.2 61.7% Landscaped area Open space above ground (increased by 14.1 sqm) 40.9 11.3%

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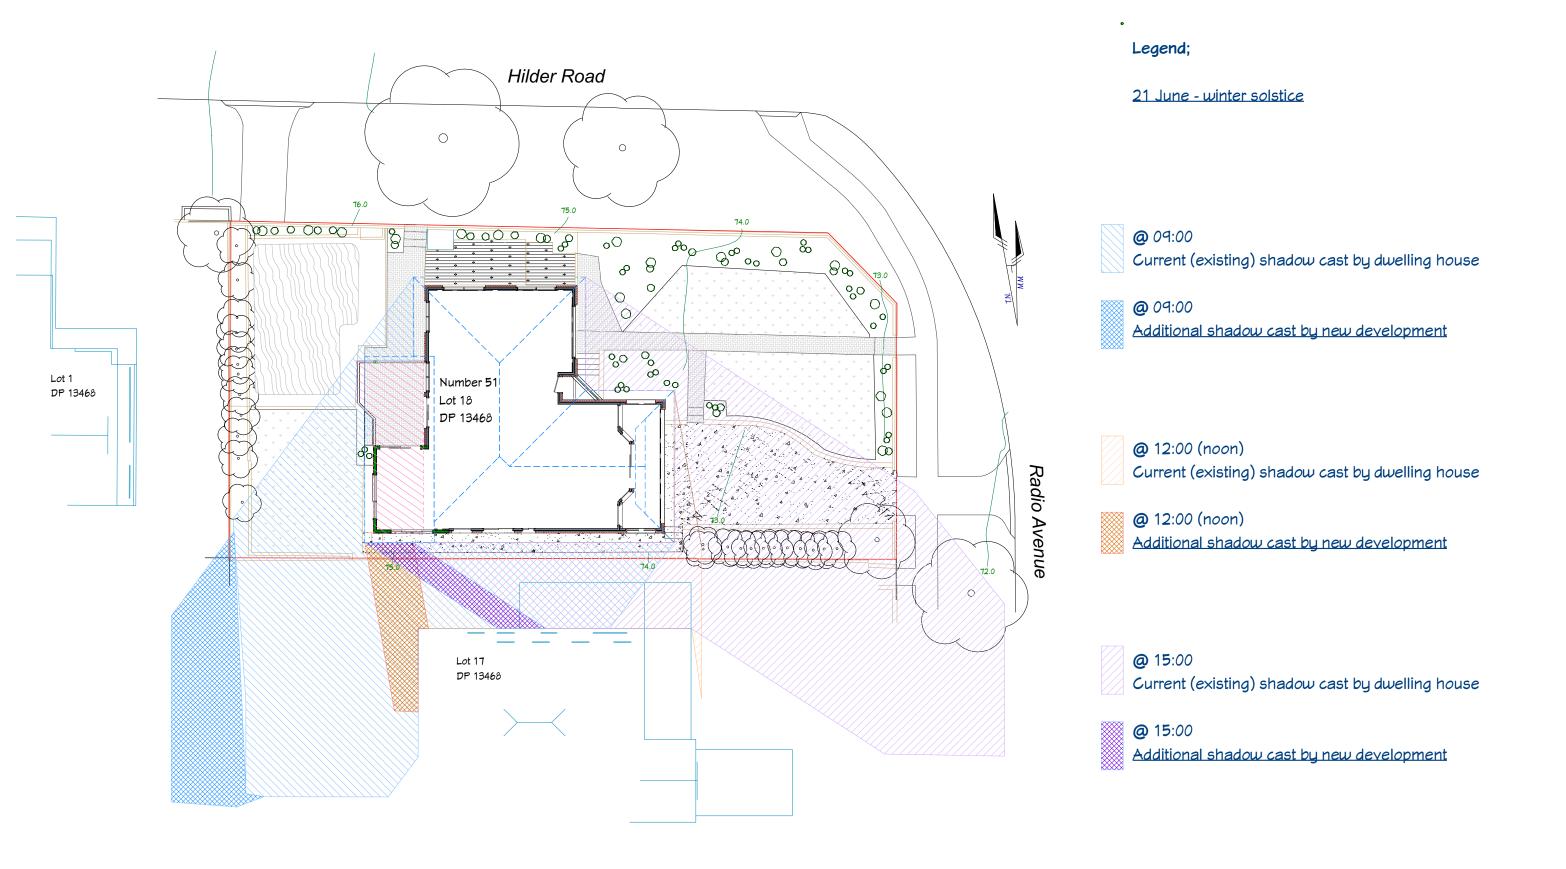
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Certified shadow diagram



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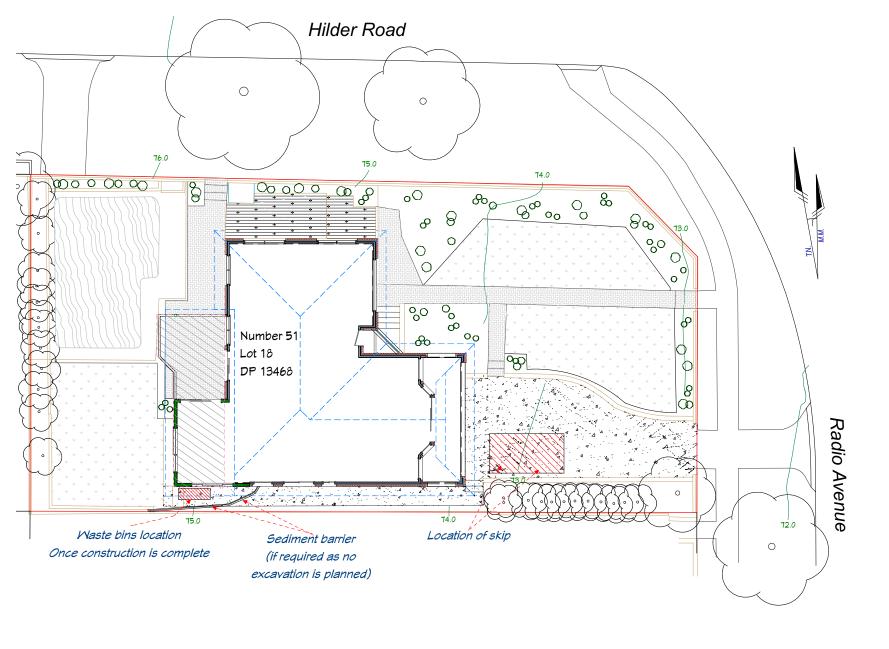
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Alterations and addition to 2 rooms
and new balcony
51 Padio Avenue

Scale: 1:200 Size: Date: 10/01/2022 51 Radio Avenue, Balgowlah Heights Drawing No: Emily & David Mashbrook Version:

4.1



Waste management - Ongoing

The House is currently occupied by the one family and this will remain unchanged during and after the build and as such ongoing waste management remains the same.

Council waste bins:

- Green waste is fortnightly collected in the council provided green bin
- Glass, plastic, metal and carton household containers are fortnightly collected in the council provided yellow bin
- All cardboard and papers are fortnightly collected in the council provided blue bin
- All remaining household waste is collected weekly in the council provided red bin.

Bins are collected by council on Thursdays.

Maste mangement plan and sediment control plan



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Waste Management Plan

General notes:

Good access exists for waste removal, skip location and product delivery via the existing concrete driveway All on site trees and vegetation is retained

Ample street parking for trade vehicles

The following waste is sorted on site and removed

Waste Management Plan - Demolition

Brick

No brick waste is expected during demolition.

Roof tiles

1.5 tonne of roof tiles are removed

To be recycled at the Kimbriki crusher or an alternate stone recycling plant.

Other materials consisting of framing timbers, windows, doors,

plaster board, awning roof, etc.

Estimated between 1.5 and 2.5 tonne

To go to landfill.

Soil

No soil excavation.

Asbestos

It has not been determined as yet if asbestos exists on site.

If asbestos is found and required to be removed then this will be removed, wrapped and discarded in accordance with the appropriate standards and codes.

Waste Management Plan - Build

Excess building waste / cut offs

To be kept to a minimum and deposited in on-site skip for landfill.

Roof cut-offs

Steel roof and gutter leftovers to be removed by the roofing company and recycled

Particular care is to be made that small metal shrapnel and rivet pins are collected and do not find their way into the lawn that surrounds the house.

Other

Builder will provide on-site recycle and waste bins for appropriate disposal and recycling of coffee cups, lunch containers, food waste, etc. These bins are periodically emptied in the appropriate household's yellow, blue and red lidded bins.

> Alterations and addition to 2 rooms Scale: 1:200 Size: A3 and new balcony 51 Radio Avenue, 10/01/2022 Date: Balgowlah Heights 08 Drawing No: Emily & David Mashbrook 4.1 **Version**: