


SITE AND ROOF PLAN

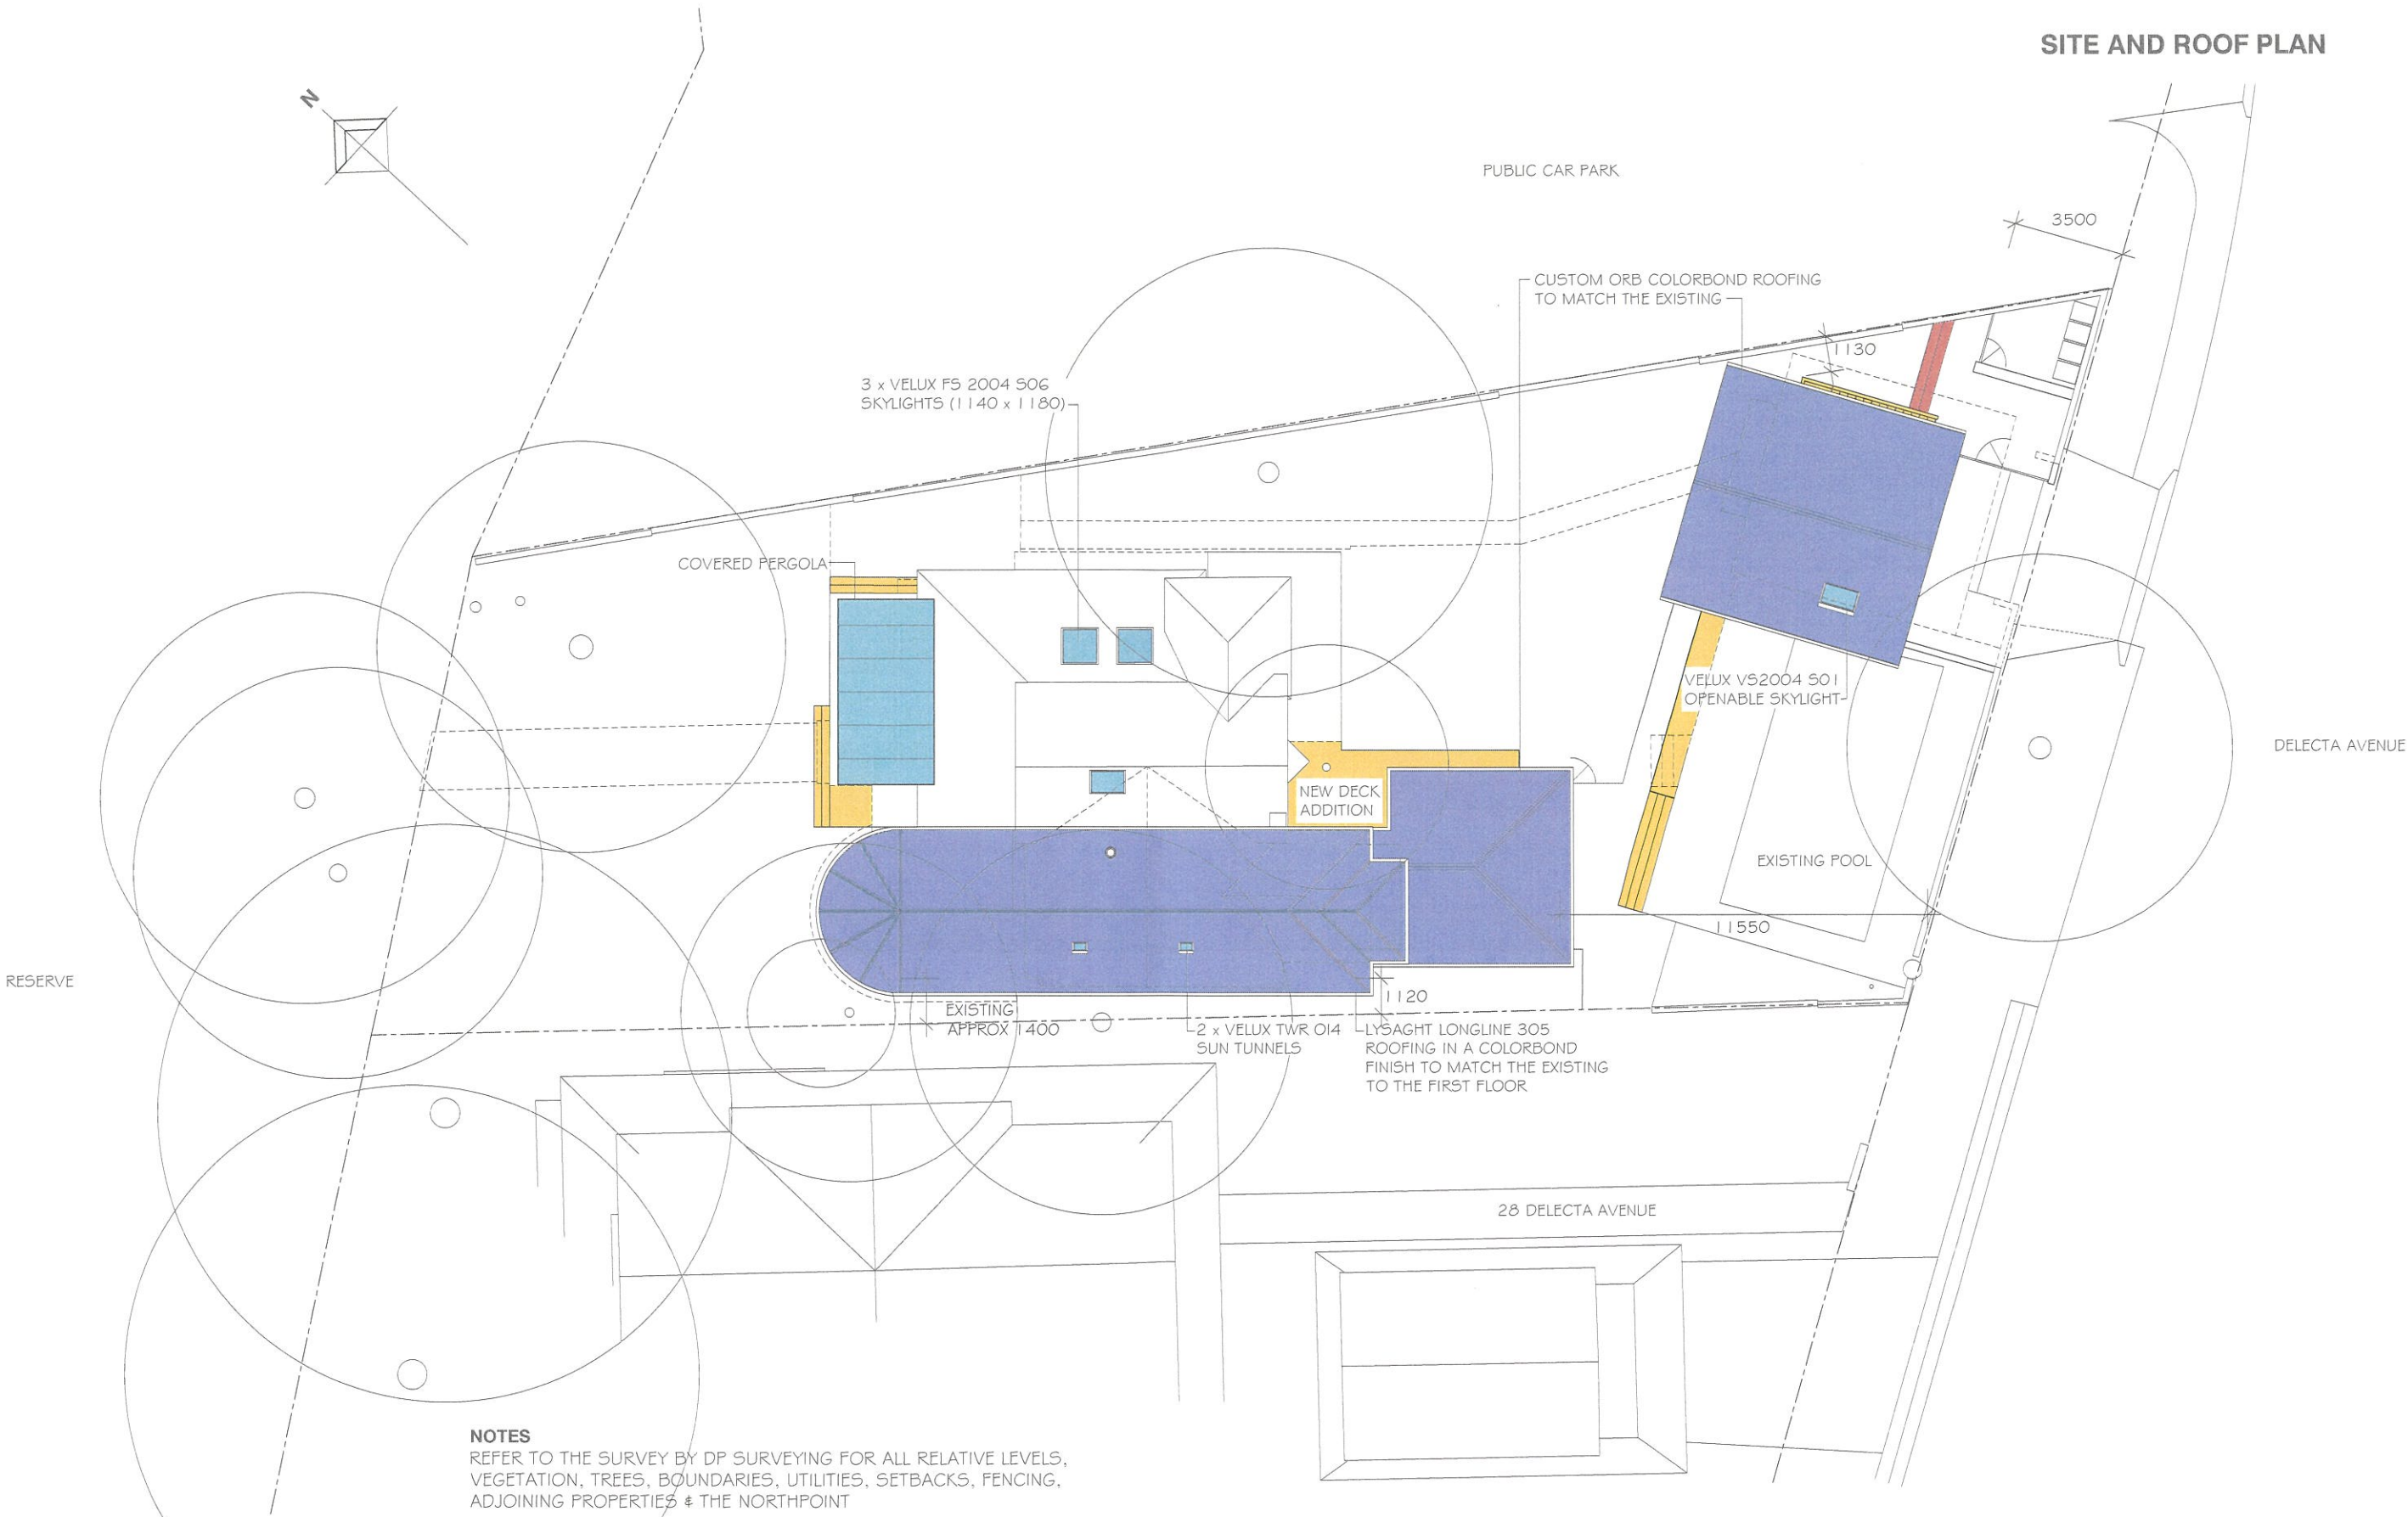

**NOTES**  
REFER TO THE SURVEY BY DP SURVEYING FOR ALL RELATIVE LEVELS, VEGETATION, TREES, BOUNDARIES, UTILITIES, SETBACKS, FENCING, ADJOINING PROPERTIES & THE NORTHPOINT

REFER TO THE HYDRAULIC ENGINEERS PLANS FOR STORMWATER REQUIREMENTS


SITE AREA 902.7m<sup>2</sup>

LANDSCAPE AREA REQUIRED IS 60% OF THE SITE AREA BEING 541.62m<sup>2</sup>. THE PROPOSED COMPLIES WITH THIS REQUIREMENT, REFER TO THE LANDSCAPE PLAN

PROPOSED ALTERATIONS & ADDITIONS	DEVELOPMENT APPLICATION	DATE	SCALE
ROB & SHERIDAN BELGIOVANE		30 May 2022	1:200
28 DELECTA AVE CLAREVILLE		0322 / AD01	
Gerald Gilchrist + Associates Pty Ltd	PHONE 9939 0790	DO NOT SCALE OFF DRAWINGS	



# GROUND FLOOR PLAN PLAN

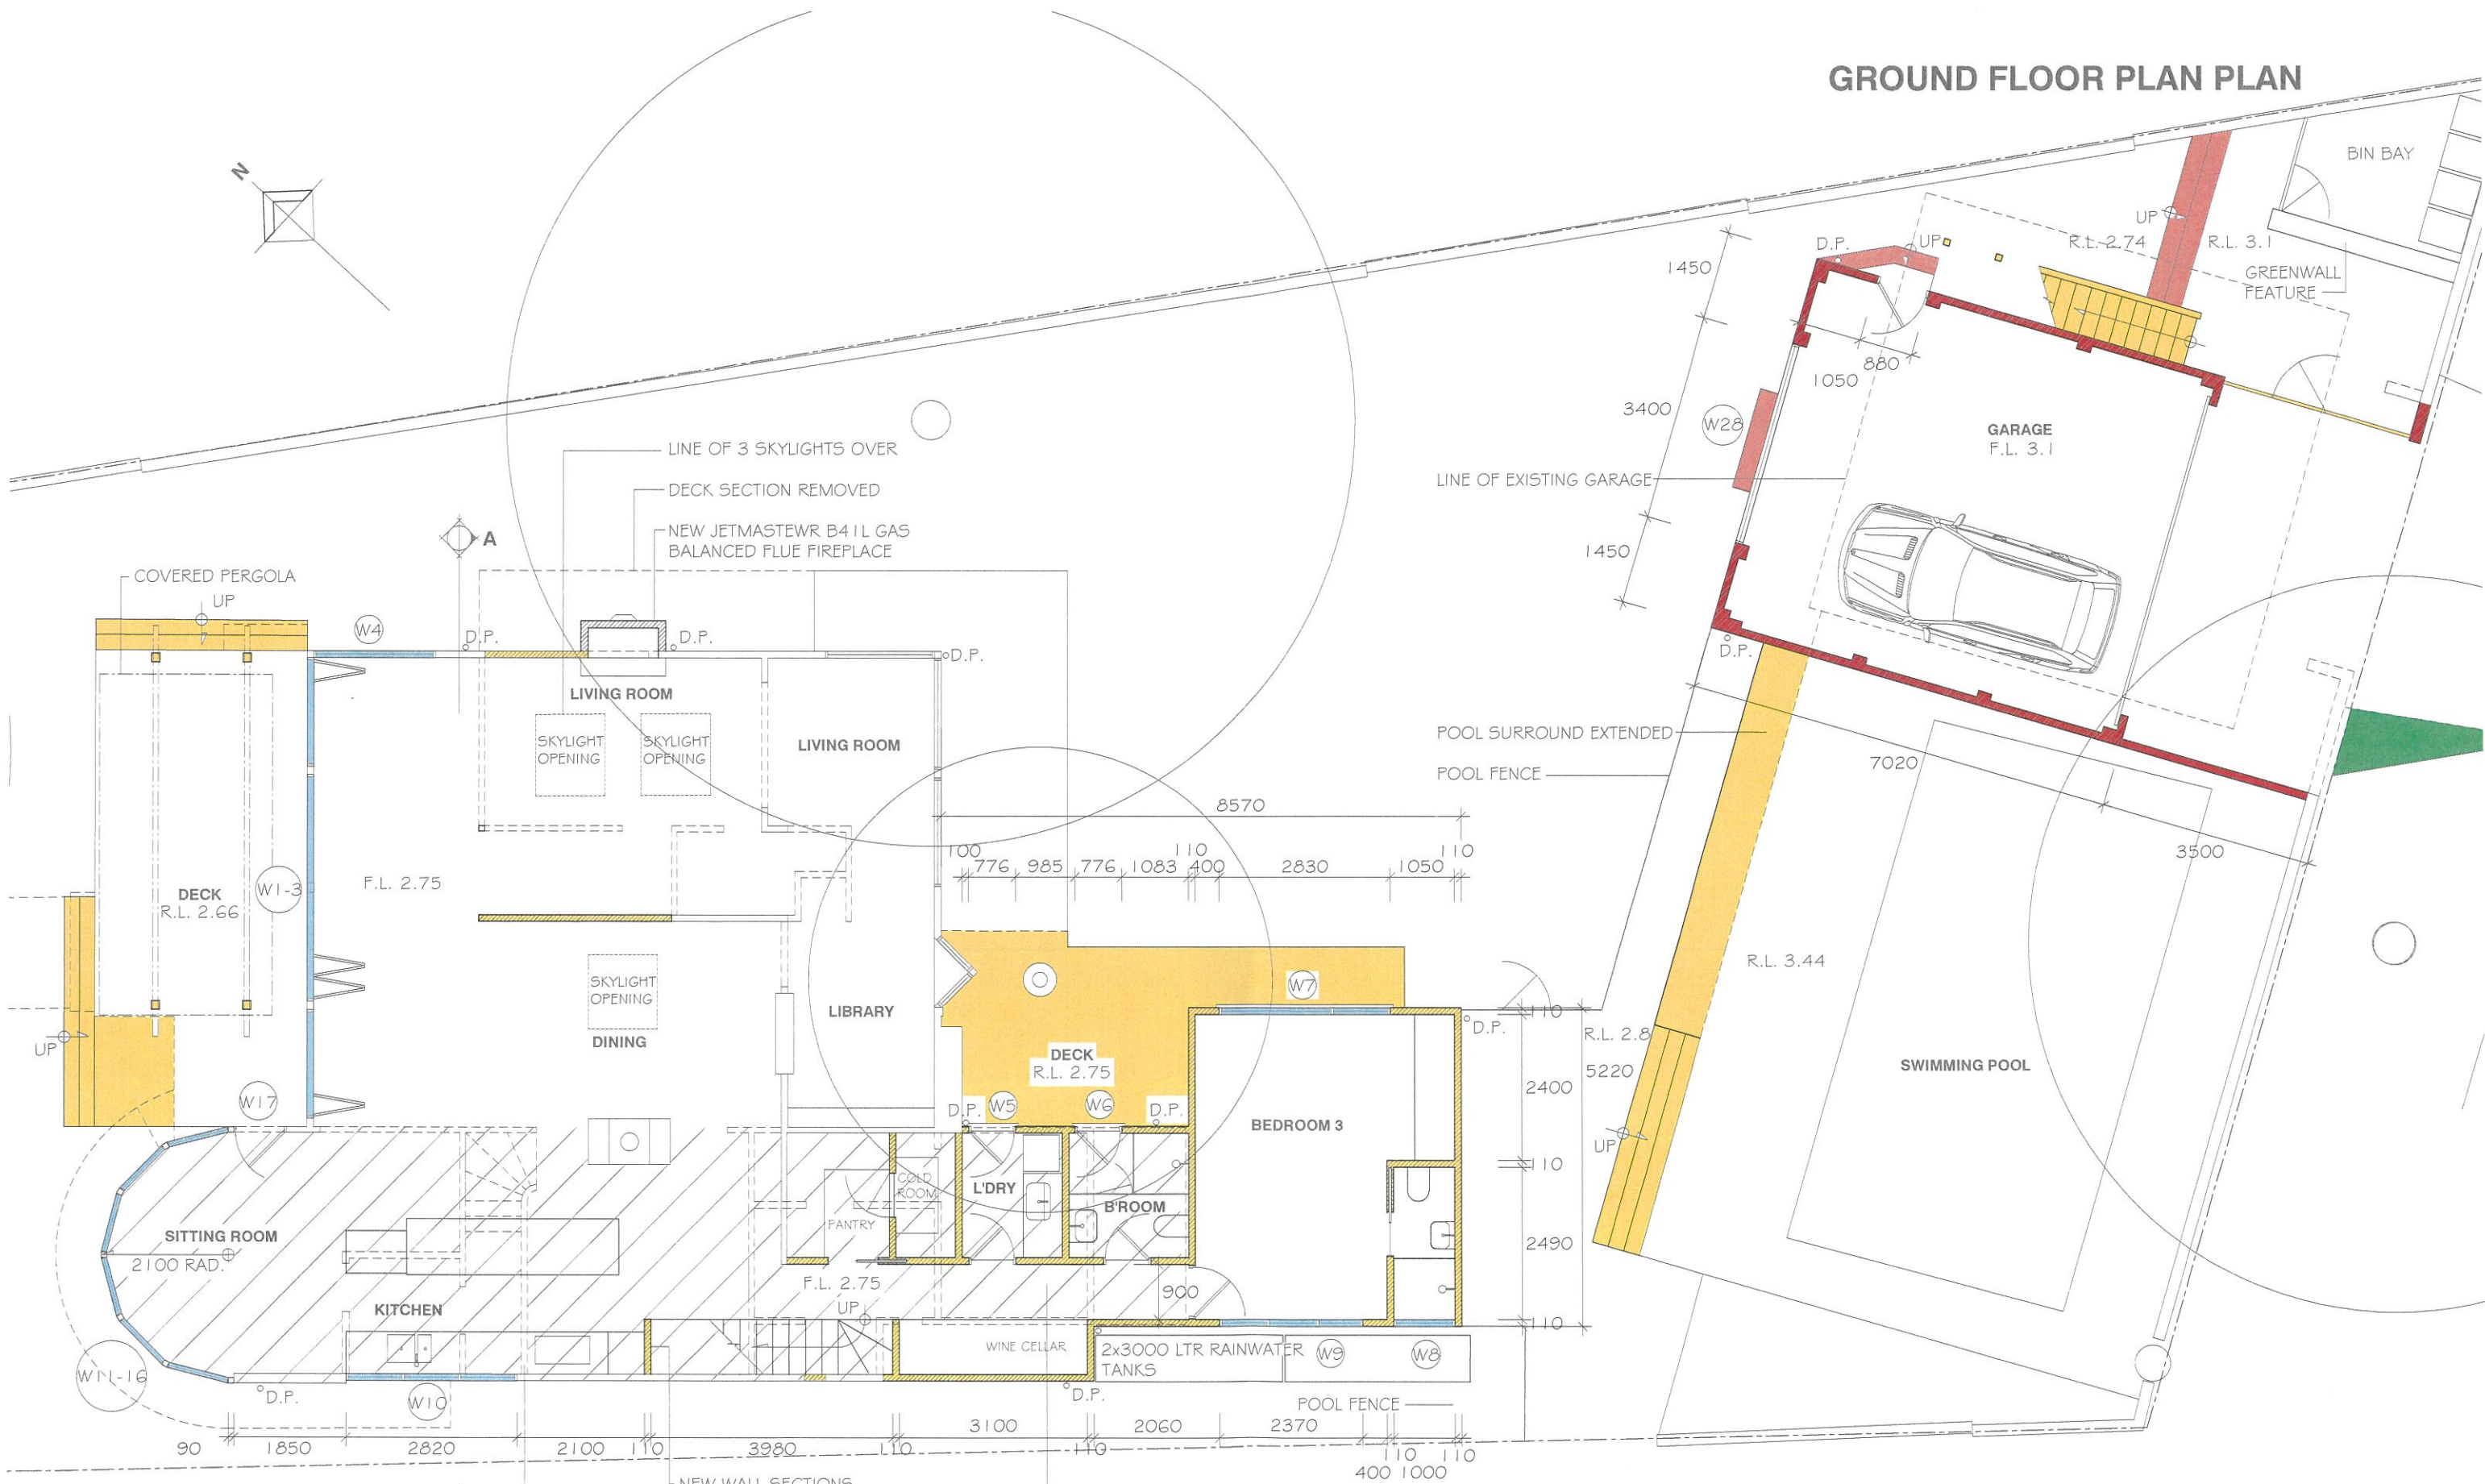

## NOTES

NEW SELECTED FLOORBOARDS  
THROUGHOUT (EXCLUDING WET AREAS)  
NEW KITCHEN, BATHROOMS AND  
LAUNDRY TO DETAIL

RAINWATER TANKS THE TANK FACTORY,  
SL3000 SQ LTR SLIMLINE TANKS OR  
EQUIVALENT WITH TAP & PUMP

NEW WALL SECTIONS

REMOVED WALL SECTIONS

EXISTING GROUND FLOOR SECTION  
SHOWN HATCHED TO BE DEMOLISHED  
AND BUILT AS REPRESENTED

NEW KITCHEN, BATHROOMS AND  
LAUNDRY TO DETAIL

PROPOSED ALTERATIONS & ADDITIONS

DEVELOPMENT APPLICATION

DATE

SCALE

ROB & SHERIDAN BELGIOVANE

30 May 2022 1:100

28 DELECTA AVE CLAREVILLE

0322 / AD02


Gerald Gilchrist + Associates Pty Ltd

PHONE 9939 0790

DO NOT SCALE OFF DRAWINGS



# FIRST FLOOR PLAN PLAN

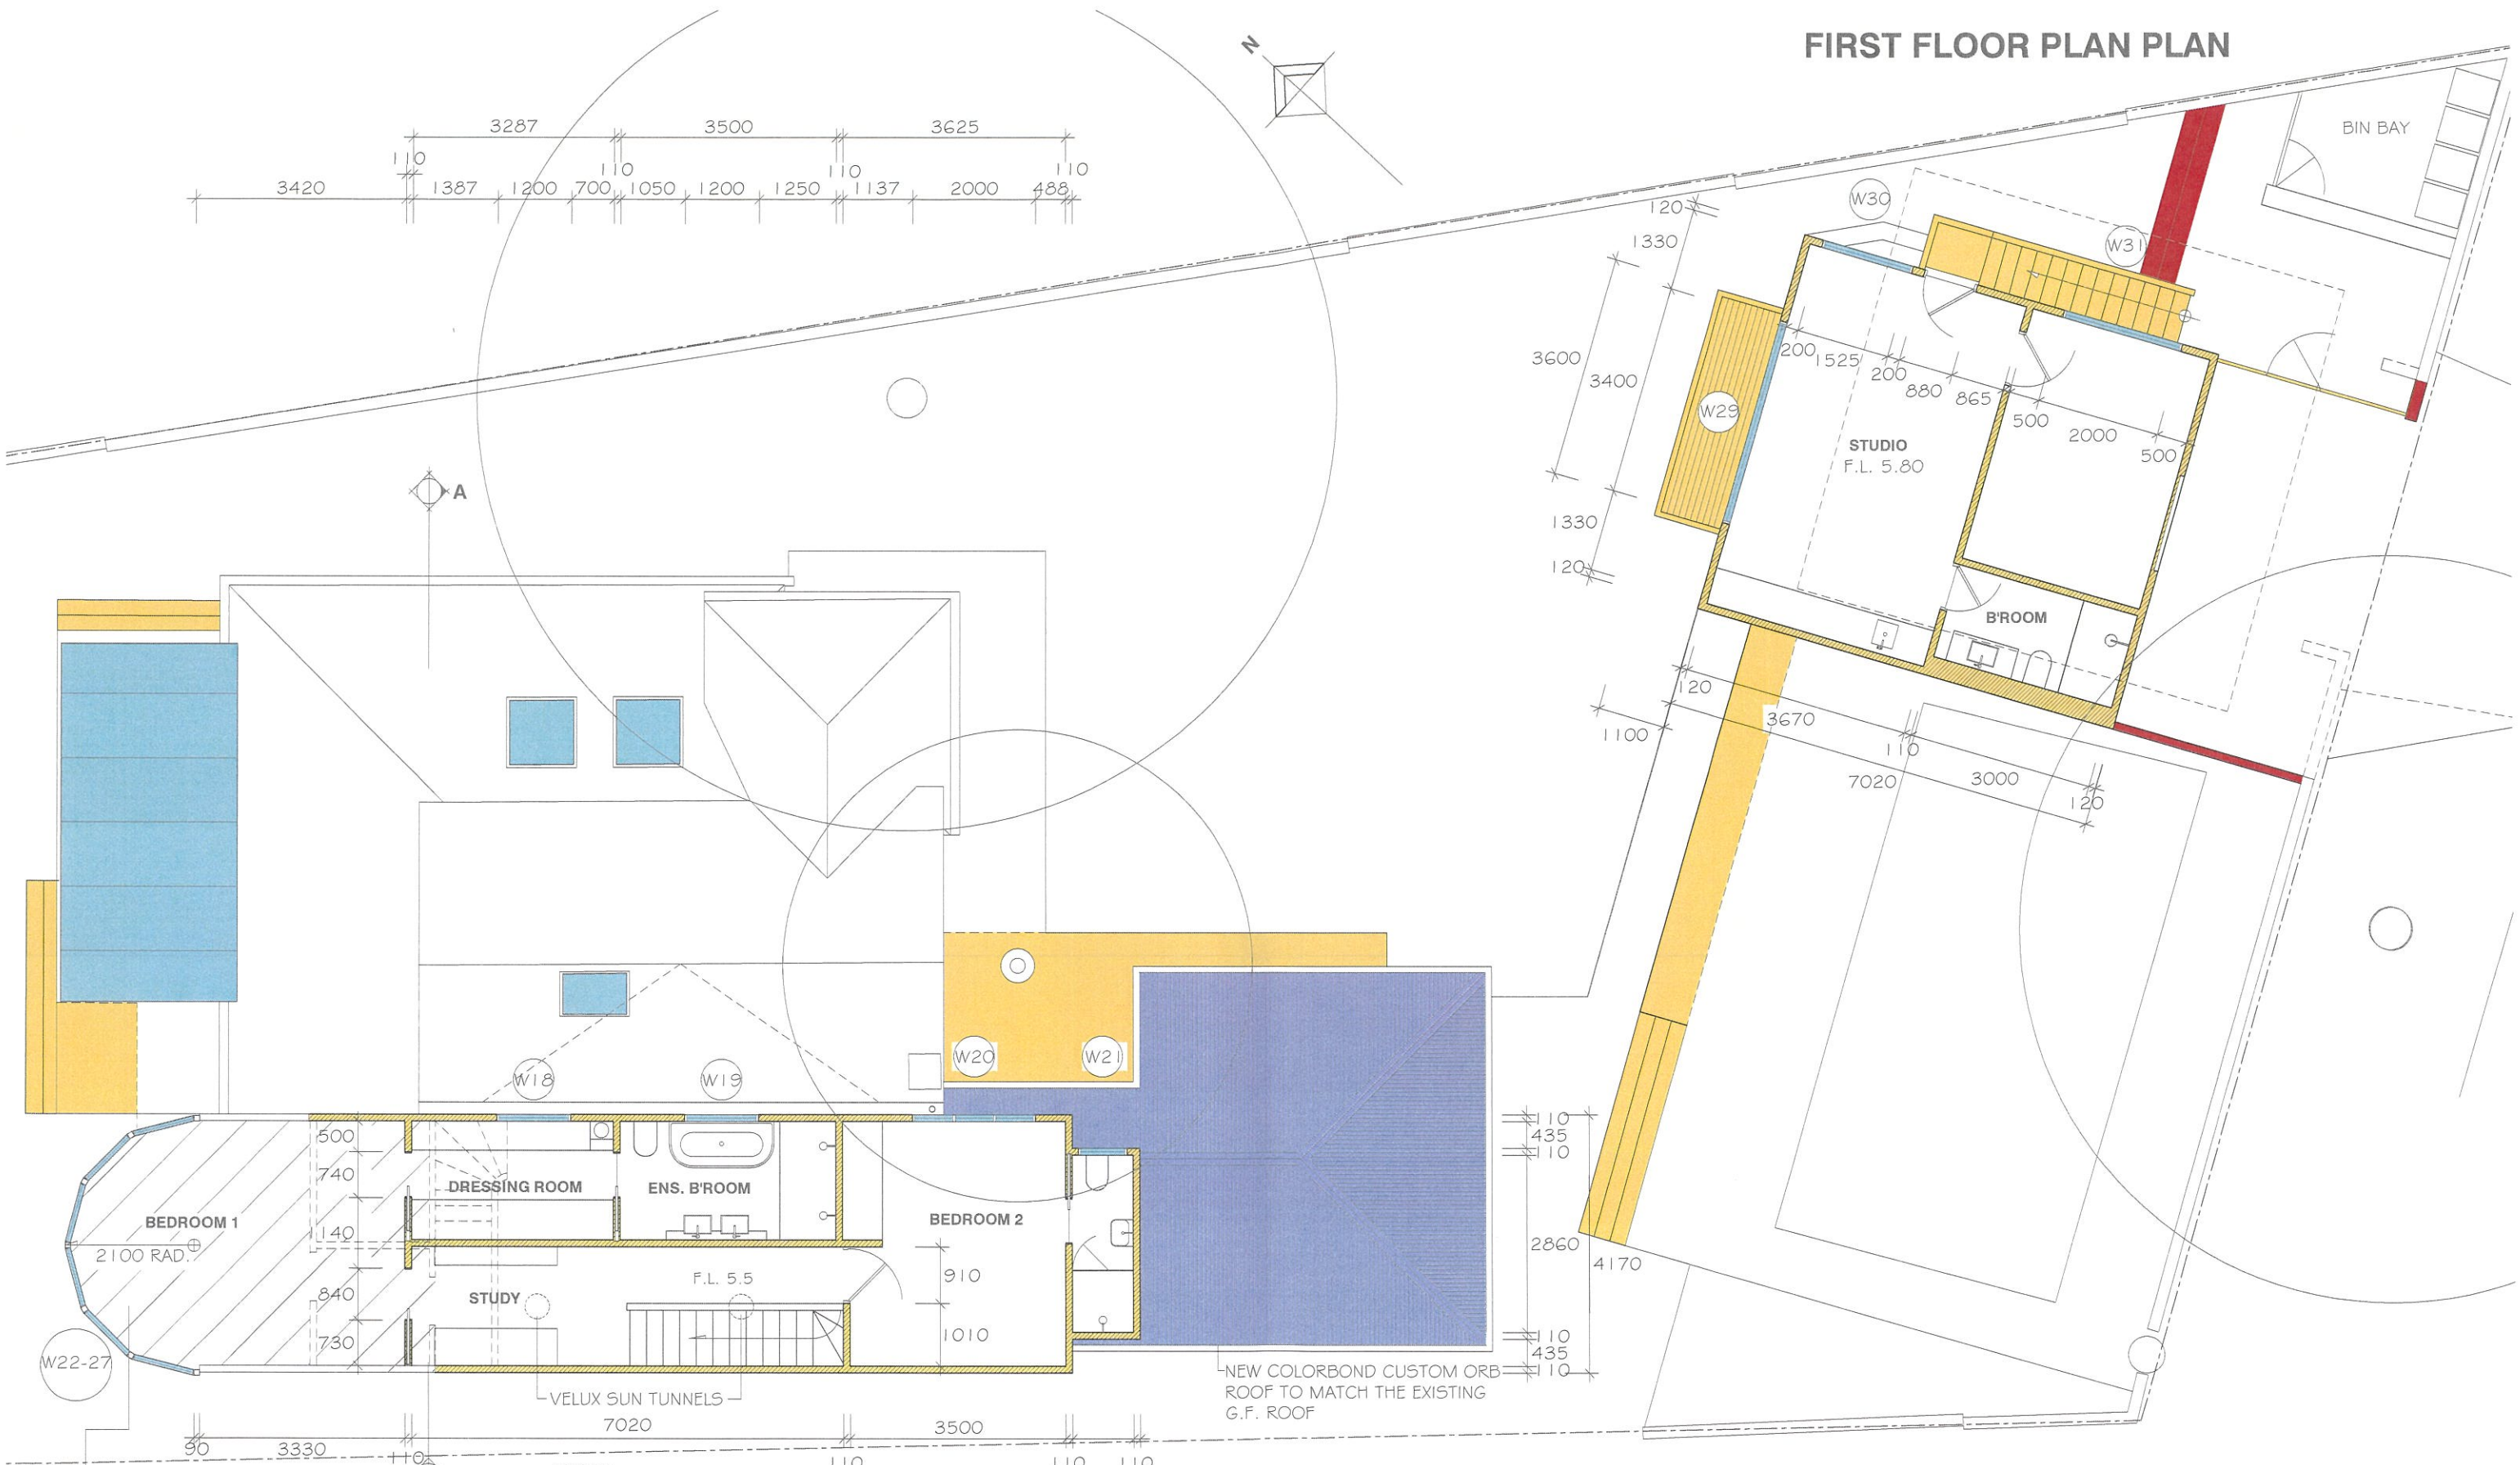

THE EXISTING FIRST FLOOR SHOWN  
HATCHED TO BE DEMOLISHED AND  
REBUILT AS SHOWN

## NOTES

THE PROPOSED WORKS HAVE BEEN DESIGNED SO THAT WHEN CONSTRUCTED  
THEY CAN COMPLY WITH THE BCA AND RELEVANT AUSTRALIAN STANDARDS

ALL R.L.S ARE FINISHED LEVELS

ALL DRAWINGS ARE FOR APPROVAL PURPOSES NOT CONSTRUCTION

STAIRS & BALUSTRADING TO COMPLY WITH THE BCA.

STORMWATER AS PER THE HYDRAULIC ENGINEERS DETAILS

FRAMING, LINTELS, STRUCTURAL STEEL, CONCRETE, AND FOOTINGS TO THE  
ENGINEERS DETAILS

PROPOSED ALTERATIONS & ADDITIONS

DEVELOPMENT APPLICATION

DATE

SCALE

ROB & SHERIDAN BELGIOVANE

30 May 2022 1:100

28 DELECTA AVE CLAREVILLE

0322 / AD03



Gerald Gilchrist + Associates Pty Ltd

PHONE 9939 0790

DO NOT SCALE OFF DRAWINGS



# N.E & S.W ELEVATIONS

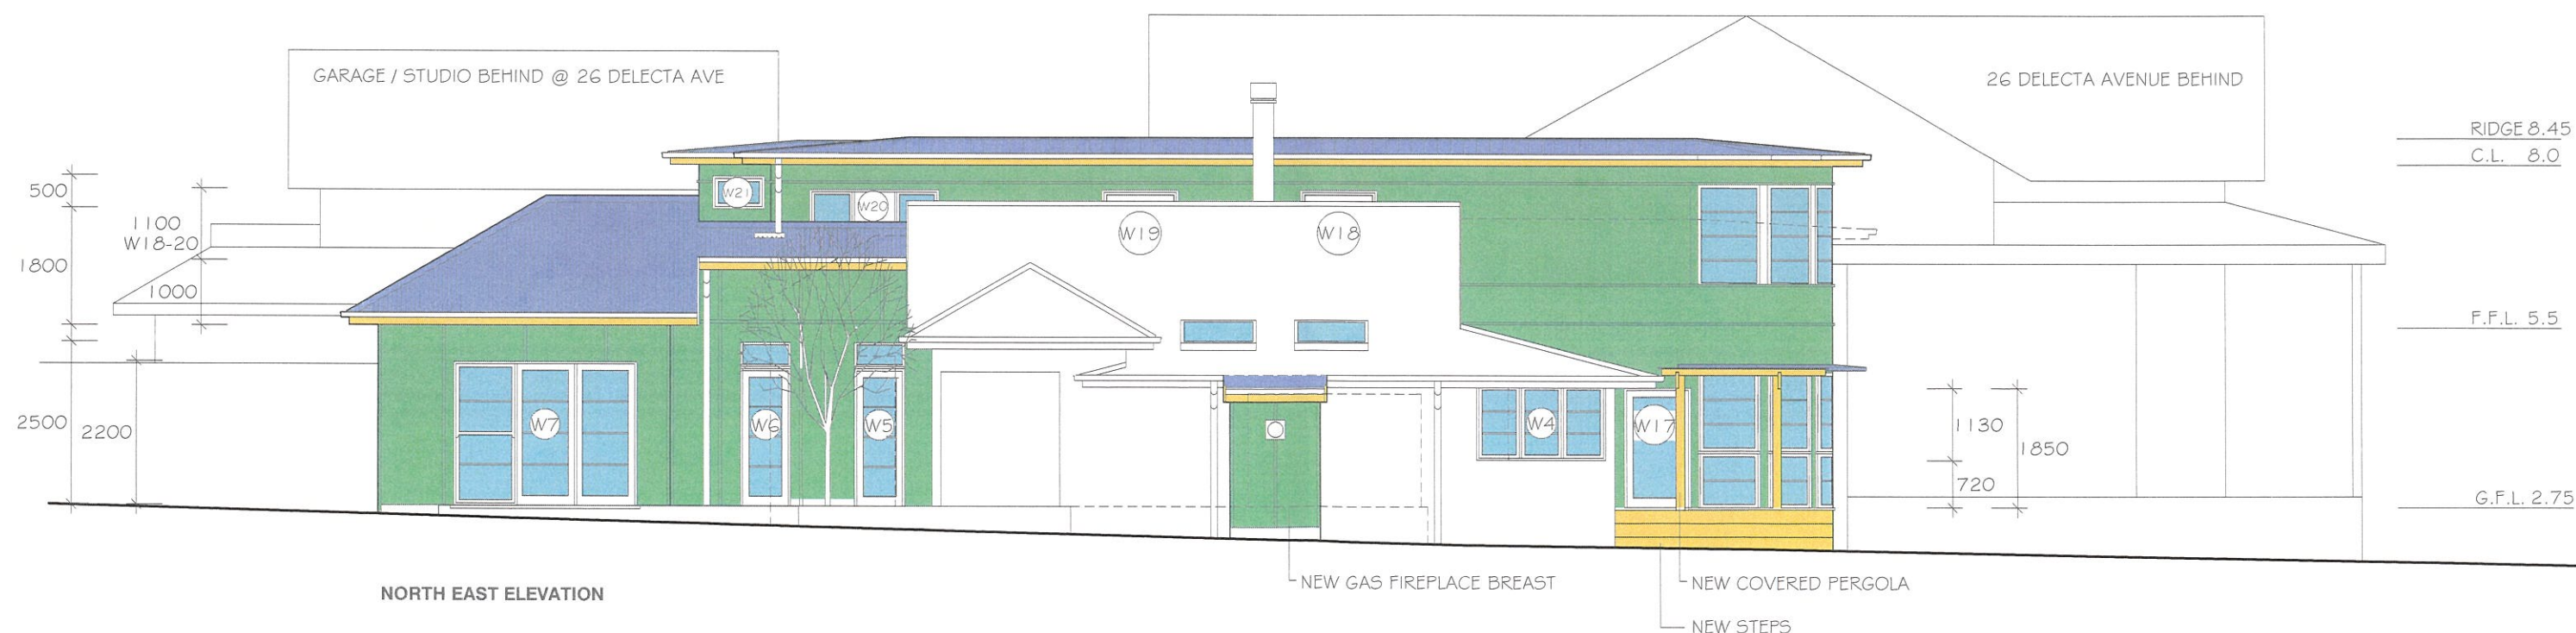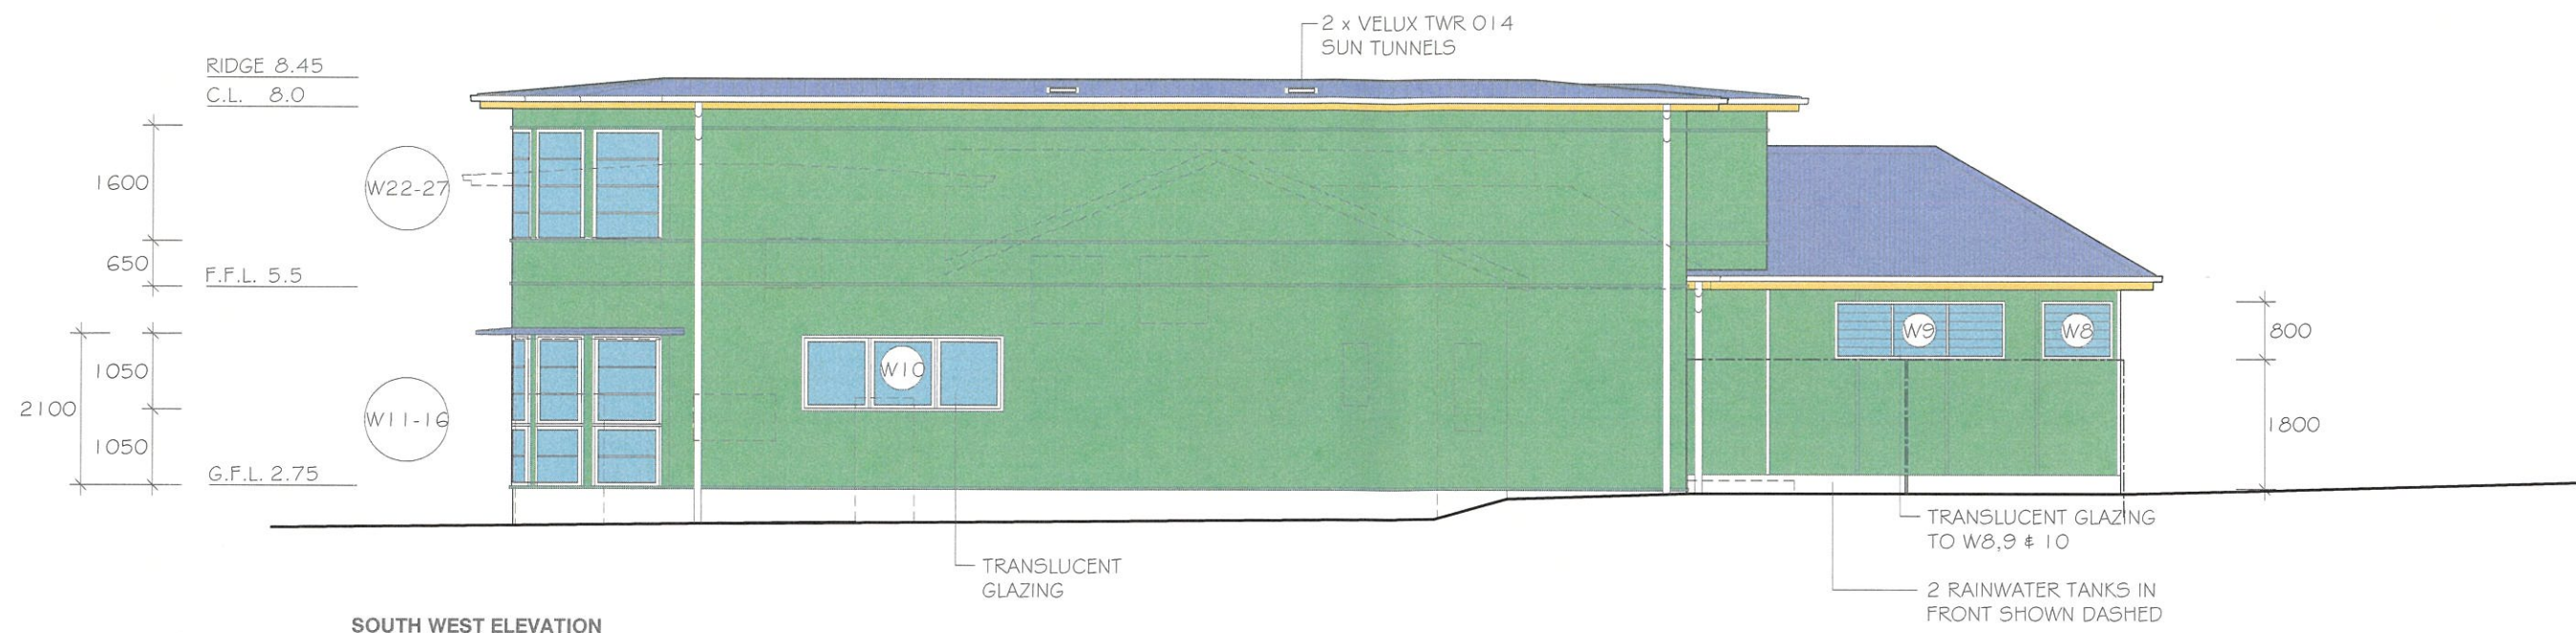

## NOTES

ALL NEW WINDOWS IN CEDAR PRIMED AND PAINTED

ALL GUTTERS TO BE QUAD WITH ROUND DOWNPIPES IN SELECTED COLORBOND

EXTERIOR CLADDING (FLAT SHHEETING WITH STRAPS TO MATCH THE EXISTING

CUSTOM ORB ROOFING IN COLORBOND AS THE EXISTING TO THE GROUND FLOOR ROOF & LYSAGHT LONGLINE 305 THE THE FIRST FLOOR ROOF IN COLORBOND TO MATCH THE EXISTING

PROPOSED ALTERATIONS & ADDITIONS

DEVELOPMENT APPLICATION

DATE

SCALE

ROB & SHERIDAN BELGIOVANE

30 May 2022 1:100

**28 DELECTA AVE CLAREVILLE**

**0322 / AD04**


Gerald Gilchrist + Associates Pty Ltd

PHONE 9939 0790


DO NOT SCALE OFF DRAWINGS




N.W & S.E ELEVATIONS & SECTION AA

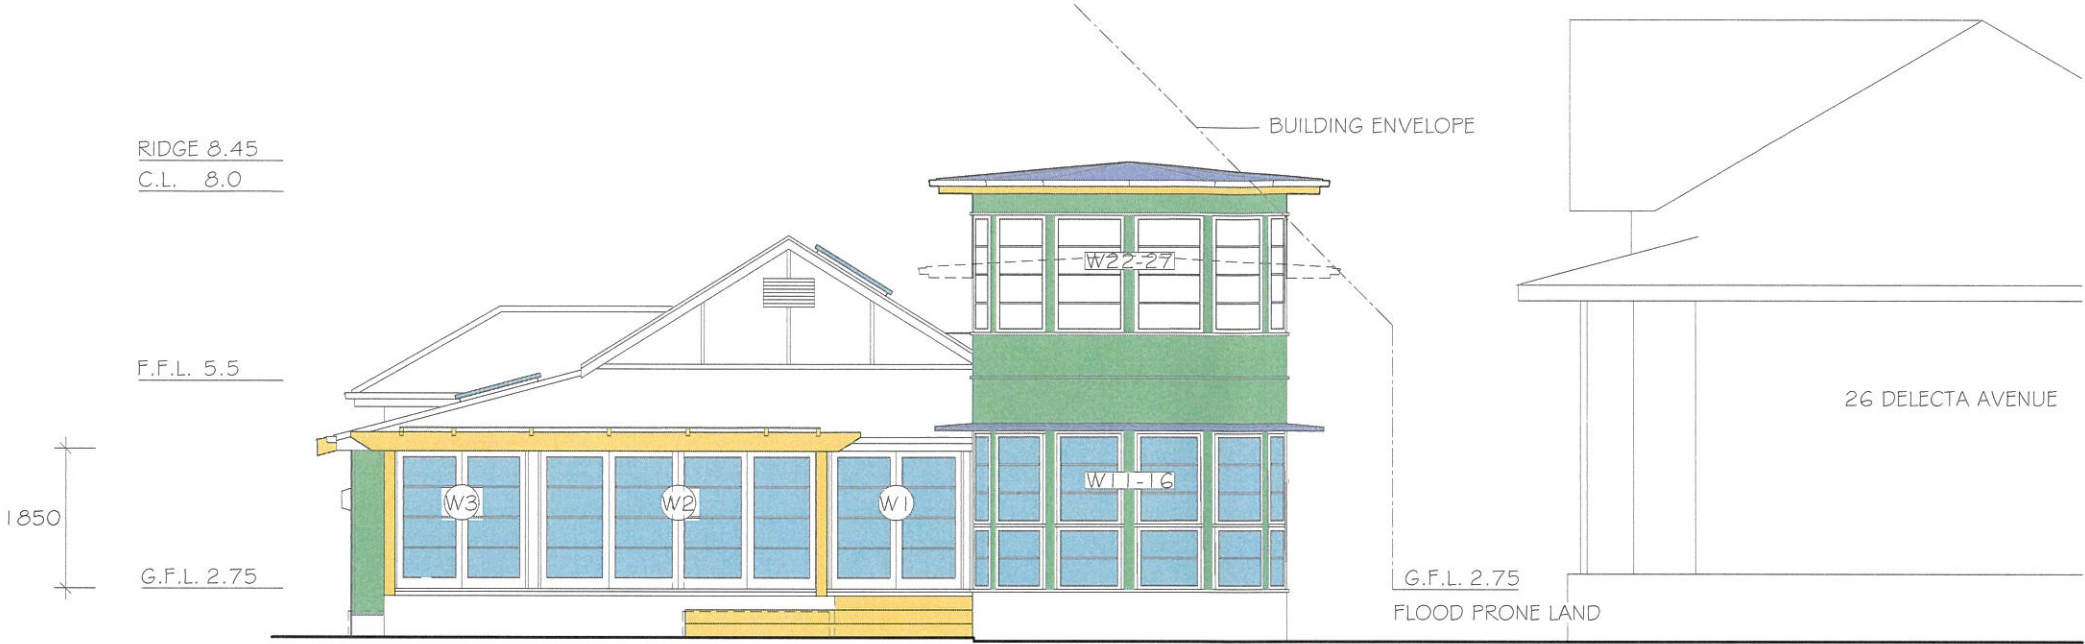

NORTH WEST ELEVATION

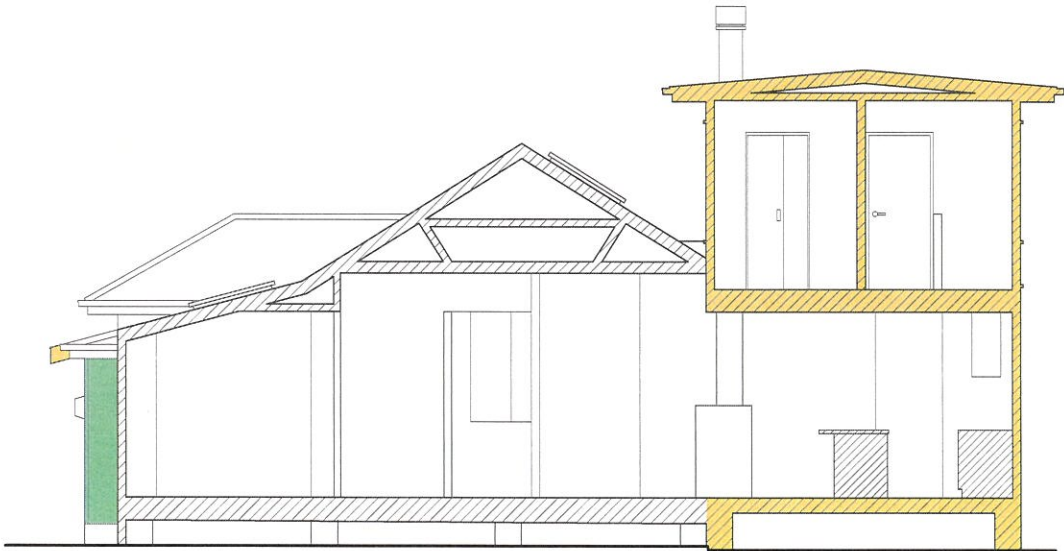

SECTION AA




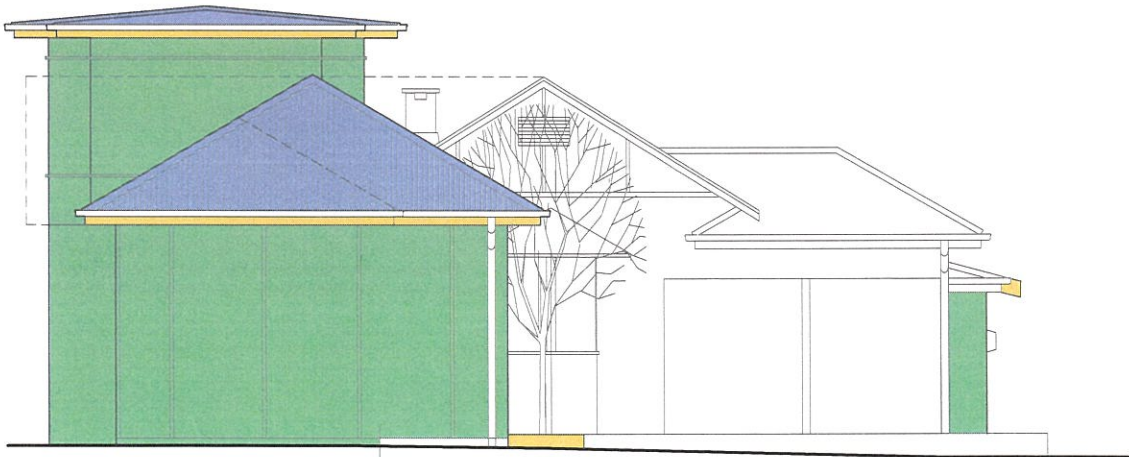


SOUTH EAST ELEVATION

PROPOSED ALTERATIONS & ADDITIONS	DEVELOPMENT APPLICATION	DATE	SCALE
ROB & SHERIDAN BELGIOVANE		30 May 2022	1:100
28 DELECTA AVE CLAREVILLE		0322 / AD05	
Gerald Gilchrist + Associates Pty Ltd	PHONE 9939 0790	DO NOT SCALE OFF DRAWINGS	



GARAGE & STUDIO ELEVATIONS

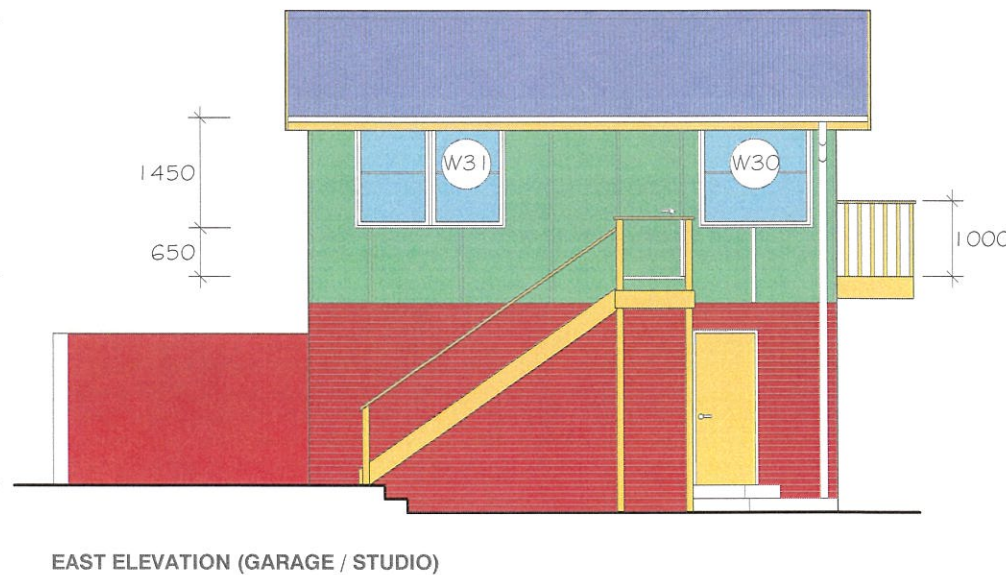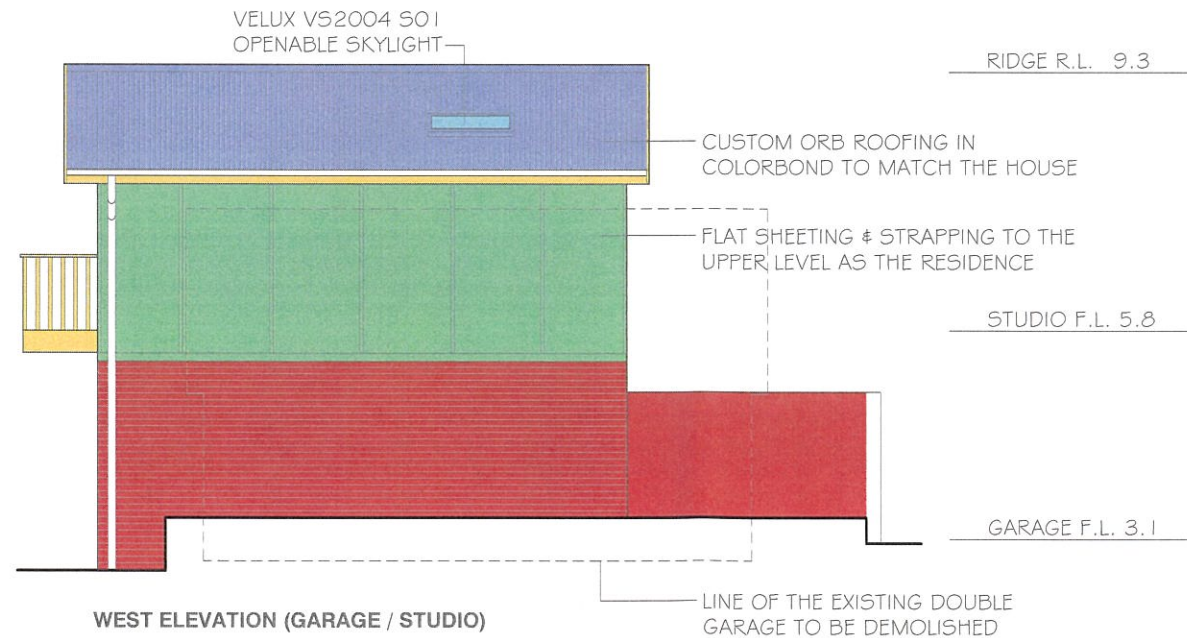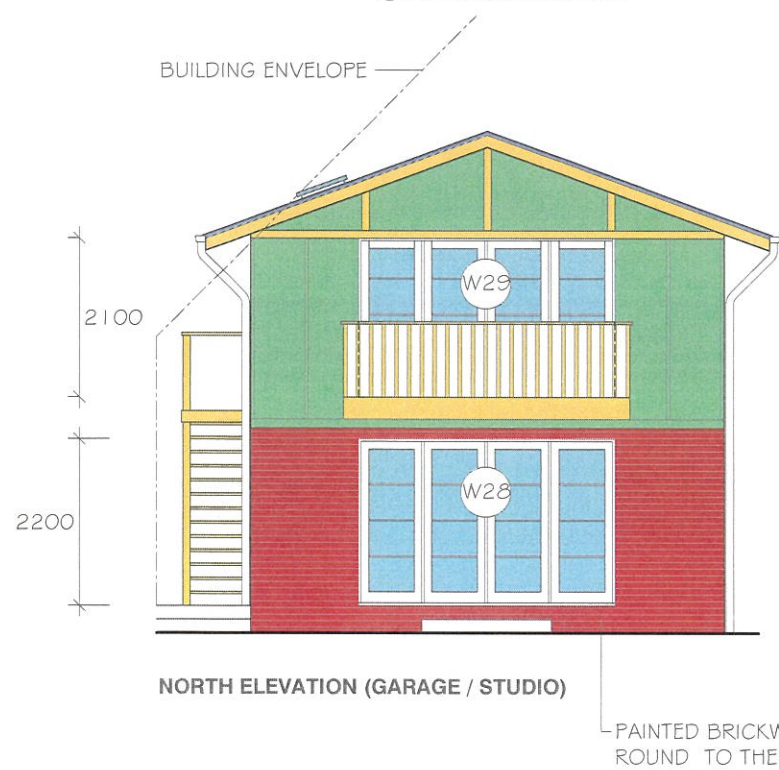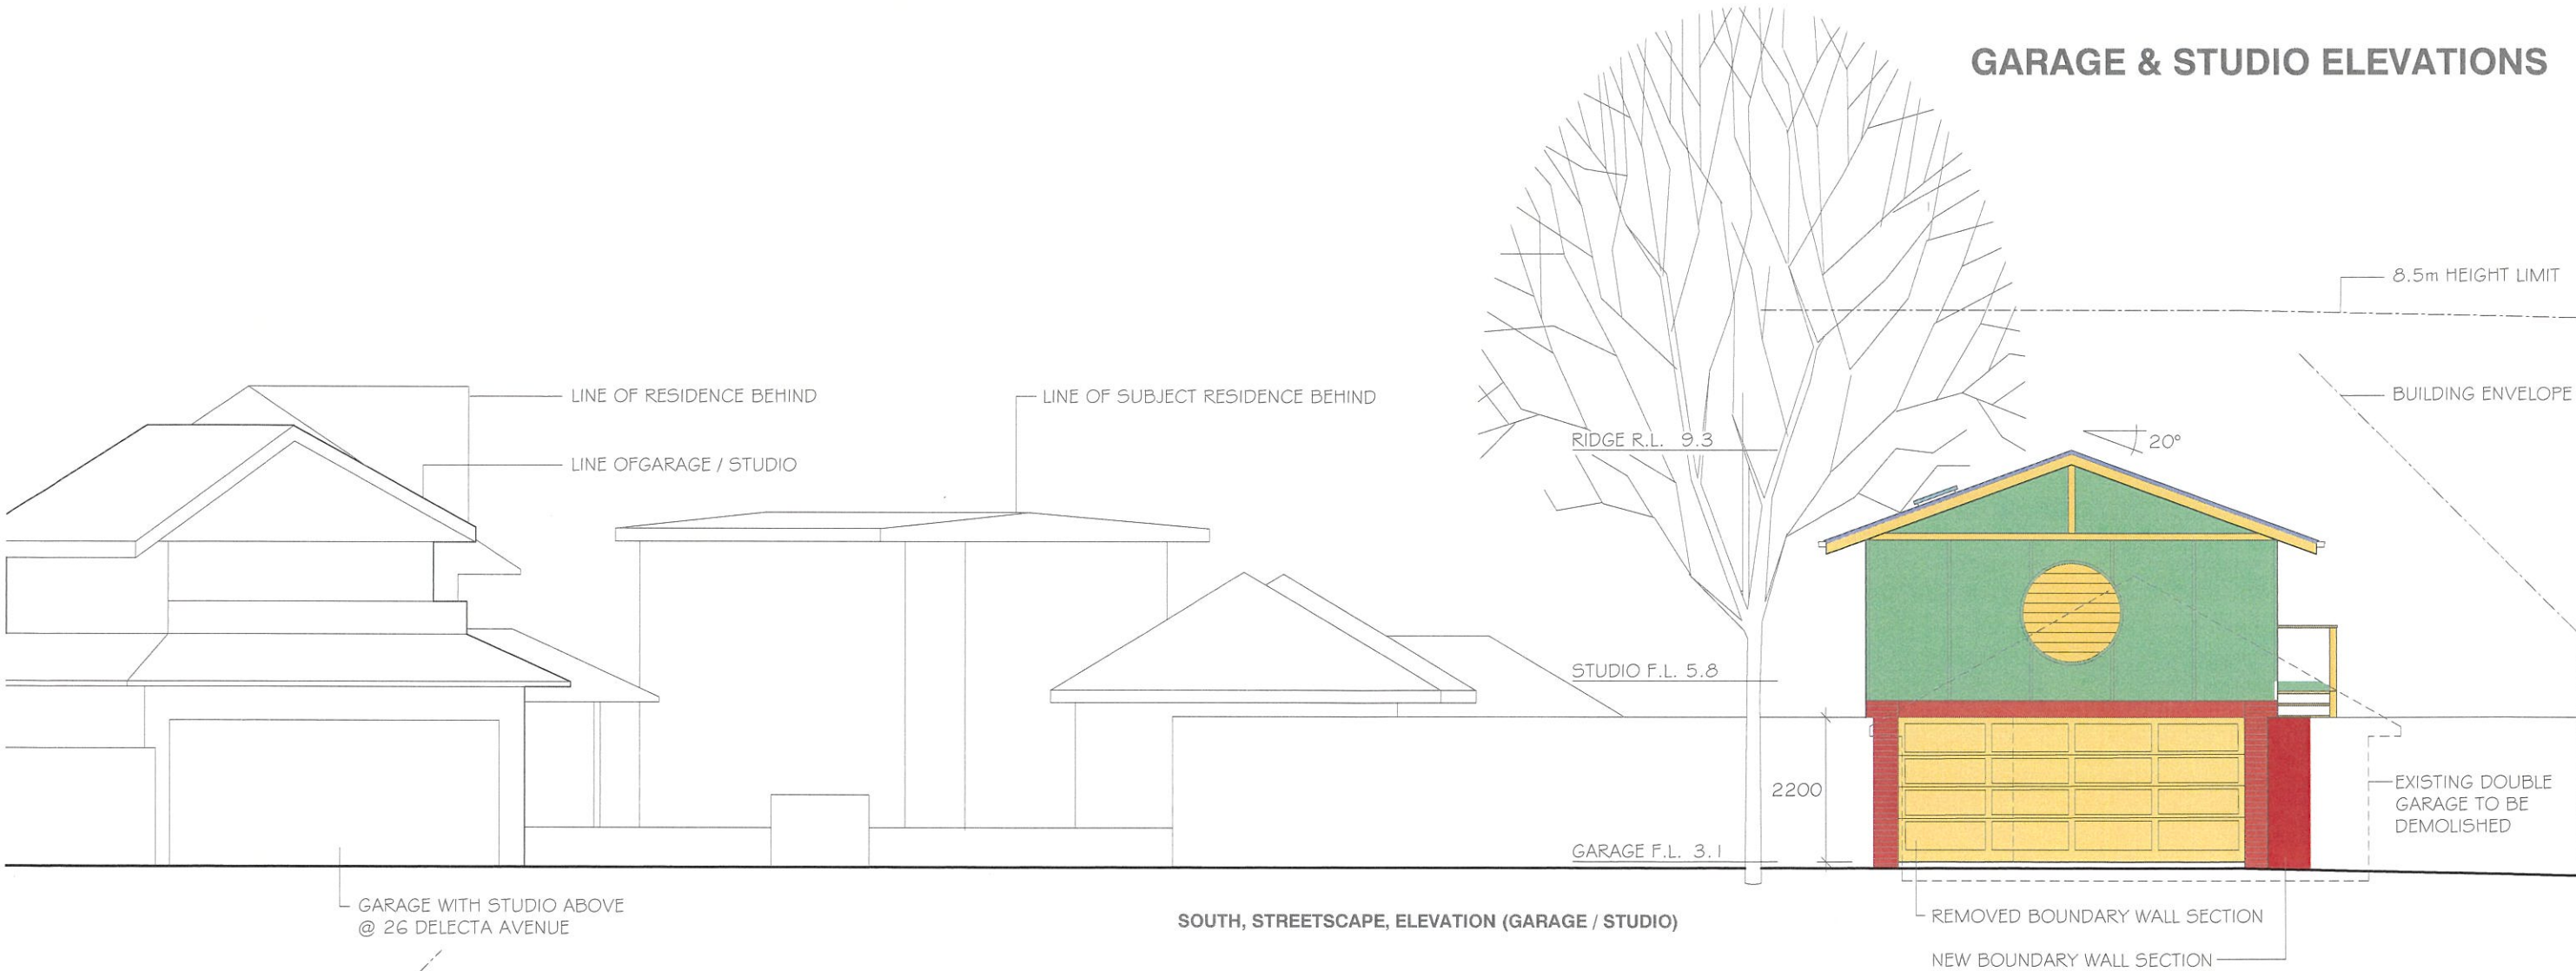

PROPOSED ALTERATIONS & ADDITIONS	DEVELOPMENT APPLICATION	DATE	SCALE
ROB & SHERIDAN BELGIOVANE		30 May 2022	1:100
28 DELECTA AVE CLAREVILLE		0322 / AD06	
Gerald Gilchrist + Associates Pty Ltd	PHONE 9939 0790	DO NOT SCALE OFF DRAWINGS	



**Alterations and Additions**

Certificate number: A464147

This certificate confirms that the proposed development will meet the NSW government's requirements for sustainability, if it is built in accordance with the commitments set out below. Terms used in this certificate, or in the commitments, have the meaning given by the document entitled "BASIX Alterations and Additions Definitions" dated 06/10/2017 published by the Department. This document is available at [www.basix.nsw.gov.au](http://www.basix.nsw.gov.au)

Secretary  
Date of issue: Thursday, 23, June 2022  
To be valid, this certificate must be lodged within 3 months of the date of issue.



Description of project

Project address	
Project name	Belgiovanne
Street address	28 Delecta Avenue Clareville 2107
Local Government Area	Northern Beaches Council
Plan type and number	Deposited Plan 13291
Lot number	10
Section number	
Project type	
Dwelling type	Separate dwelling house
Type of alteration and addition	My renovation work is valued at \$50,000 or more, and does not include a pool (and/or spa).

<b>Certificate Prepared by</b> (please complete before submitting to Council or PCA)
Name / Company Name: Gerald Gilchrist & Associates
ABN (if applicable): 39002967839

Construction	Show on DA Plans	Show on CC/CDC Plans & specs	Certifier Check
Insulation requirements			
The applicant must construct the new or altered construction (floor(s), walls, and ceilings/roofs) in accordance with the specifications listed in the table below, except that a) additional insulation is not required where the area of new construction is less than 2m2, b) insulation specified is not required for parts of altered construction where insulation already exists.		✓	✓
Construction	Additional insulation required (R-value)	Other specifications	
concrete slab on ground floor.	nil		
suspended floor above garage: framed (R0.7).	nil		
floor above existing dwelling or building.	nil		
external wall: framed (weatherboard, fibro, metal clad)	R1.30 (or R1.70 including construction)		
flat ceiling, pitched roof	ceiling: R0.70 (up), roof: foil backed blanket (55 mm)	light (solar absorbance < 0.475)	

Glazing requirements	Show on DA Plans	Show on CC/CDC Plans & specs	Certifier Check			
<b>Windows and glazed doors</b>						
The applicant must install the windows, glazed doors and shading devices, in accordance with the specifications listed in the table below. Relevant overshadowing specifications must be satisfied for each window and glazed door.	✓	✓	✓			
The following requirements must also be satisfied in relation to each window and glazed door:		✓	✓			
Each window or glazed door with improved frames, or pyrolytic low-e glass, or clear/air gap/clear glazing, or toned/air gap/clear glazing must have a U-value and a Solar Heat Gain Coefficient (SHGC) no greater than that listed in the table below. Total system U-values and SHGCs must be calculated in accordance with National Fenestration Rating Council (NFRC) conditions. The description is provided for information only. Alternative systems with complying U-value and SHGC may be substituted.		✓	✓			
For projections described in millimetres, the leading edge of each eave, pergola, verandah, balcony or awning must be no more than 500 mm above the head of the window or glazed door and no more than 2400 mm above the sill.	✓	✓	✓			
Pergolas with polycarbonate roof or similar translucent material must have a shading coefficient of less than 0.35.		✓	✓			
Pergolas with fixed battens must have battens parallel to the window or glazed door above which they are situated, unless the pergola also shades a perpendicular window. The spacing between battens must not be more than 50 mm.		✓	✓			
Overshadowing buildings or vegetation must be of the height and distance from the centre and the base of the window and glazed door, as specified in the 'overshadowing' column in the table below.	✓	✓	✓			
<b>Windows and glazed doors glazing requirements</b>						
Window / door no.	Orientation	Area of glass inc. frame (m2)	Overshadowing Height (m) Distance (m)	Shading device	Frame and glass type	
W1	NW	13.16	0	0	eave/verandah/pergola/balcony >=450 mm	timber or uPVC, single pyrolytic low-e, (U-value: 3.99, SHGC: 0.4)
W2	NE	2.3	0	0	eave/verandah/pergola/balcony >=450 mm	timber or uPVC, single pyrolytic low-e, (U-value: 3.99, SHGC: 0.4)
W3	NE	3.88	0	0	eave/verandah/pergola/balcony >=450 mm	timber or uPVC, single pyrolytic low-e, (U-value: 3.99, SHGC: 0.4)
W4	NE	6.22	0	0	eave/verandah/pergola/balcony	timber or uPVC, single pyrolytic low-e,

**BASIX COMMITMENTS - CERTIFICATE NUMBER A464147 DATED 23.6.22**

Glazing requirements							Show on DA Plans	Show on CC/CDC Plans & specs	Certifier Check
Window / door no.	Orientation	Area of glass inc. frame (m2)	Overshadowing Height (m) Distance (m)		Shading device	Frame and glass type			
W5	SW	2.7	0	0	>=450 mm eave/verandah/pergola/balcony >=450 mm	(U-value: 3.99, SHGC: 0.4) timber or uPVC, single pyrolytic low-e, (U-value: 3.99, SHGC: 0.4)			
W6	SW	2.96	3.7	3.3	none	timber or uPVC, single pyrolytic low-e, (U-value: 3.99, SHGC: 0.4)			
W7	NW	10	0	0	eave/verandah/pergola/balcony >=450 mm	timber or uPVC, single pyrolytic low-e, (U-value: 3.99, SHGC: 0.4)			
W8	NE	1.86	0	0	eave/verandah/pergola/balcony >=450 mm	timber or uPVC, single pyrolytic low-e, (U-value: 3.99, SHGC: 0.4)			
W9	NE	2.64	0	0	eave/verandah/pergola/balcony >=450 mm	timber or uPVC, single pyrolytic low-e, (U-value: 3.99, SHGC: 0.4)			
W10	NE	2.2	0	0	eave/verandah/pergola/balcony >=450 mm	timber or uPVC, single pyrolytic low-e, (U-value: 3.99, SHGC: 0.4)			
W11	NE	0.4	0	0	eave/verandah/pergola/balcony >=450 mm	timber or uPVC, single pyrolytic low-e, (U-value: 3.99, SHGC: 0.4)			
W12	NW	9.12	0	0	eave/verandah/pergola/balcony >=450 mm	timber or uPVC, single pyrolytic low-e, (U-value: 3.99, SHGC: 0.4)			
W13	NW	7.14	0	0	eave/verandah/pergola/balcony >=450 mm	timber or uPVC, single pyrolytic low-e, (U-value: 3.99, SHGC: 0.4)			
W14	NE	5.11	0	0	eave/verandah/pergola/balcony >=450 mm	timber or uPVC, single pyrolytic low-e, (U-value: 3.99, SHGC: 0.4)			
<b>Skylights</b>									
The applicant must install the skylights in accordance with the specifications listed in the table below.							✓	✓	✓
The following requirements must also be satisfied in relation to each skylight:								✓	✓


Glazing requirements				Show on DA Plans	Show on CC/CDC Plans & specs	Certifier Check
Each skylight may either match the description, or, have a U-value and a Solar Heat Gain Coefficient (SHGC) no greater than that listed in the table below.					✓	✓
<b>Skylights glazing requirements</b>						
Skylight number	Area of glazing inc. frame (m2)	Shading device	Frame and glass type			
S1	1.35	no shading	timber, low-E internal/argon fill/clear external, (or U-value: 2.5, SHGC: 0.456)			
S2	1.35	no shading	timber, low-E internal/argon fill/clear external, (or U-value: 2.5, SHGC: 0.456)			
S3	1.35	no shading	timber, low-E internal/argon fill/clear external, (or U-value: 2.5, SHGC: 0.456)			

Legend
In these commitments, "applicant" means the person carrying out the development.
Commitments identified with a "✓" in the "Show on DA plans" column must be shown on the plans accompanying the development application for the proposed development (if a development application is to be lodged for the proposed development).
Commitments identified with a "✓" in the "Show on CC/CDC plans & specs" column must be shown in the plans and specifications accompanying the application for a construction certificate / complying development certificate for the proposed development.
Commitments identified with a "✓" in the "Certifier check" column must be certified by a certifying authority as having been fulfilled, before a final occupation certificate for the development may be issued.

PROPOSED ALTERATIONS & ADDITIONS	DEVELOPMENT APPLICATION	DATE
ROB & SHERIDAN BELGIOVANE		23 June 2022
28 DELECTA AVE CLAREVILLE		0322 / AD07
Gerald Gilchrist + Associates Pty Ltd	PHONE 9939 0790	



SITE ANALYSIS PLAN

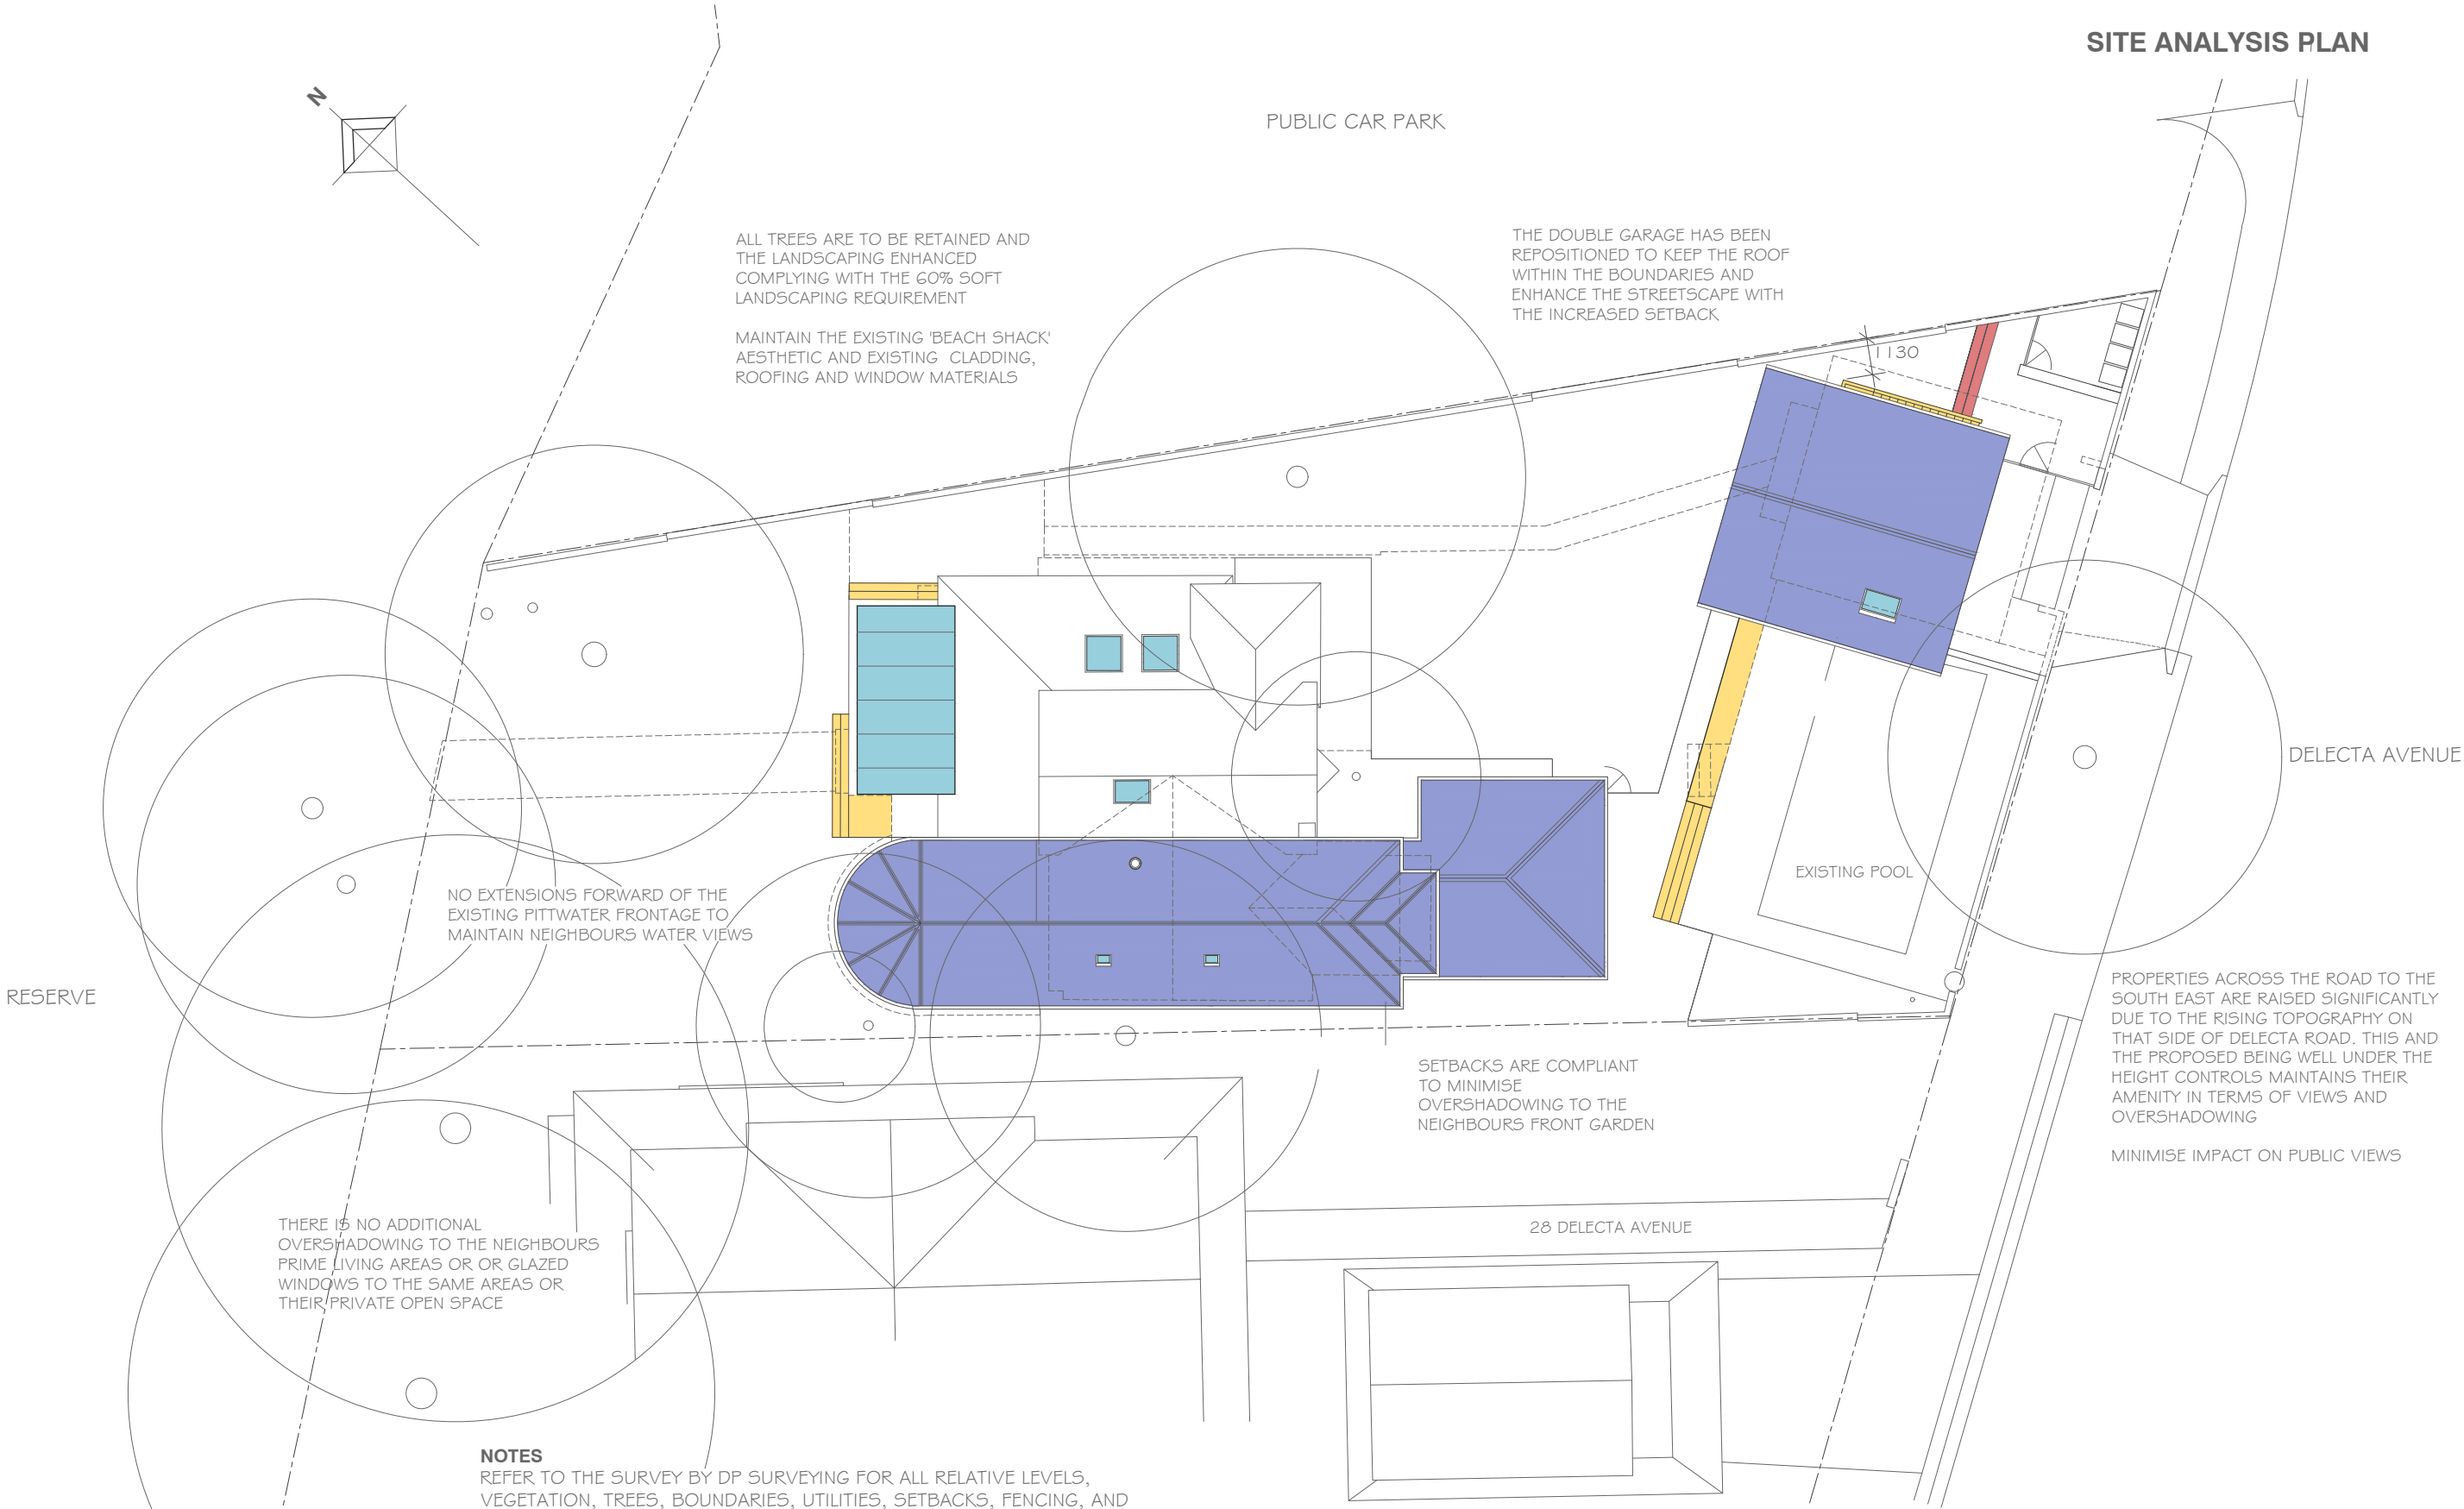


**NOTES**  
REFER TO THE SURVEY BY DP SURVEYING FOR ALL RELATIVE LEVELS, VEGETATION, TREES, BOUNDARIES, UTILITIES, SETBACKS, FENCING, AND ADJOINING PROPERTIES  
REFER TO THE LANDSCAPE PLAN PREPARED BY JAMIE DURIE DESIGN  
REFER TO THE SHADOW DIAGRAMS PREPARED BY CAD DRAFT PTY LTD

PROPOSED ALTERATIONS & ADDITIONS	DEVELOPMENT APPLICATION	DATE	Scale 1:200
ROB & SHERIDAN BELGIOVANE		30 May 2022	
28 DELECTA AVE CLAREVILLE		0322 / AD08	
Gerald Gilchrist + Associates Pty Ltd	PHONE 9939 0790	DO NOT SCALE OFF DRAWINGS	



## DEMOLITION PLAN

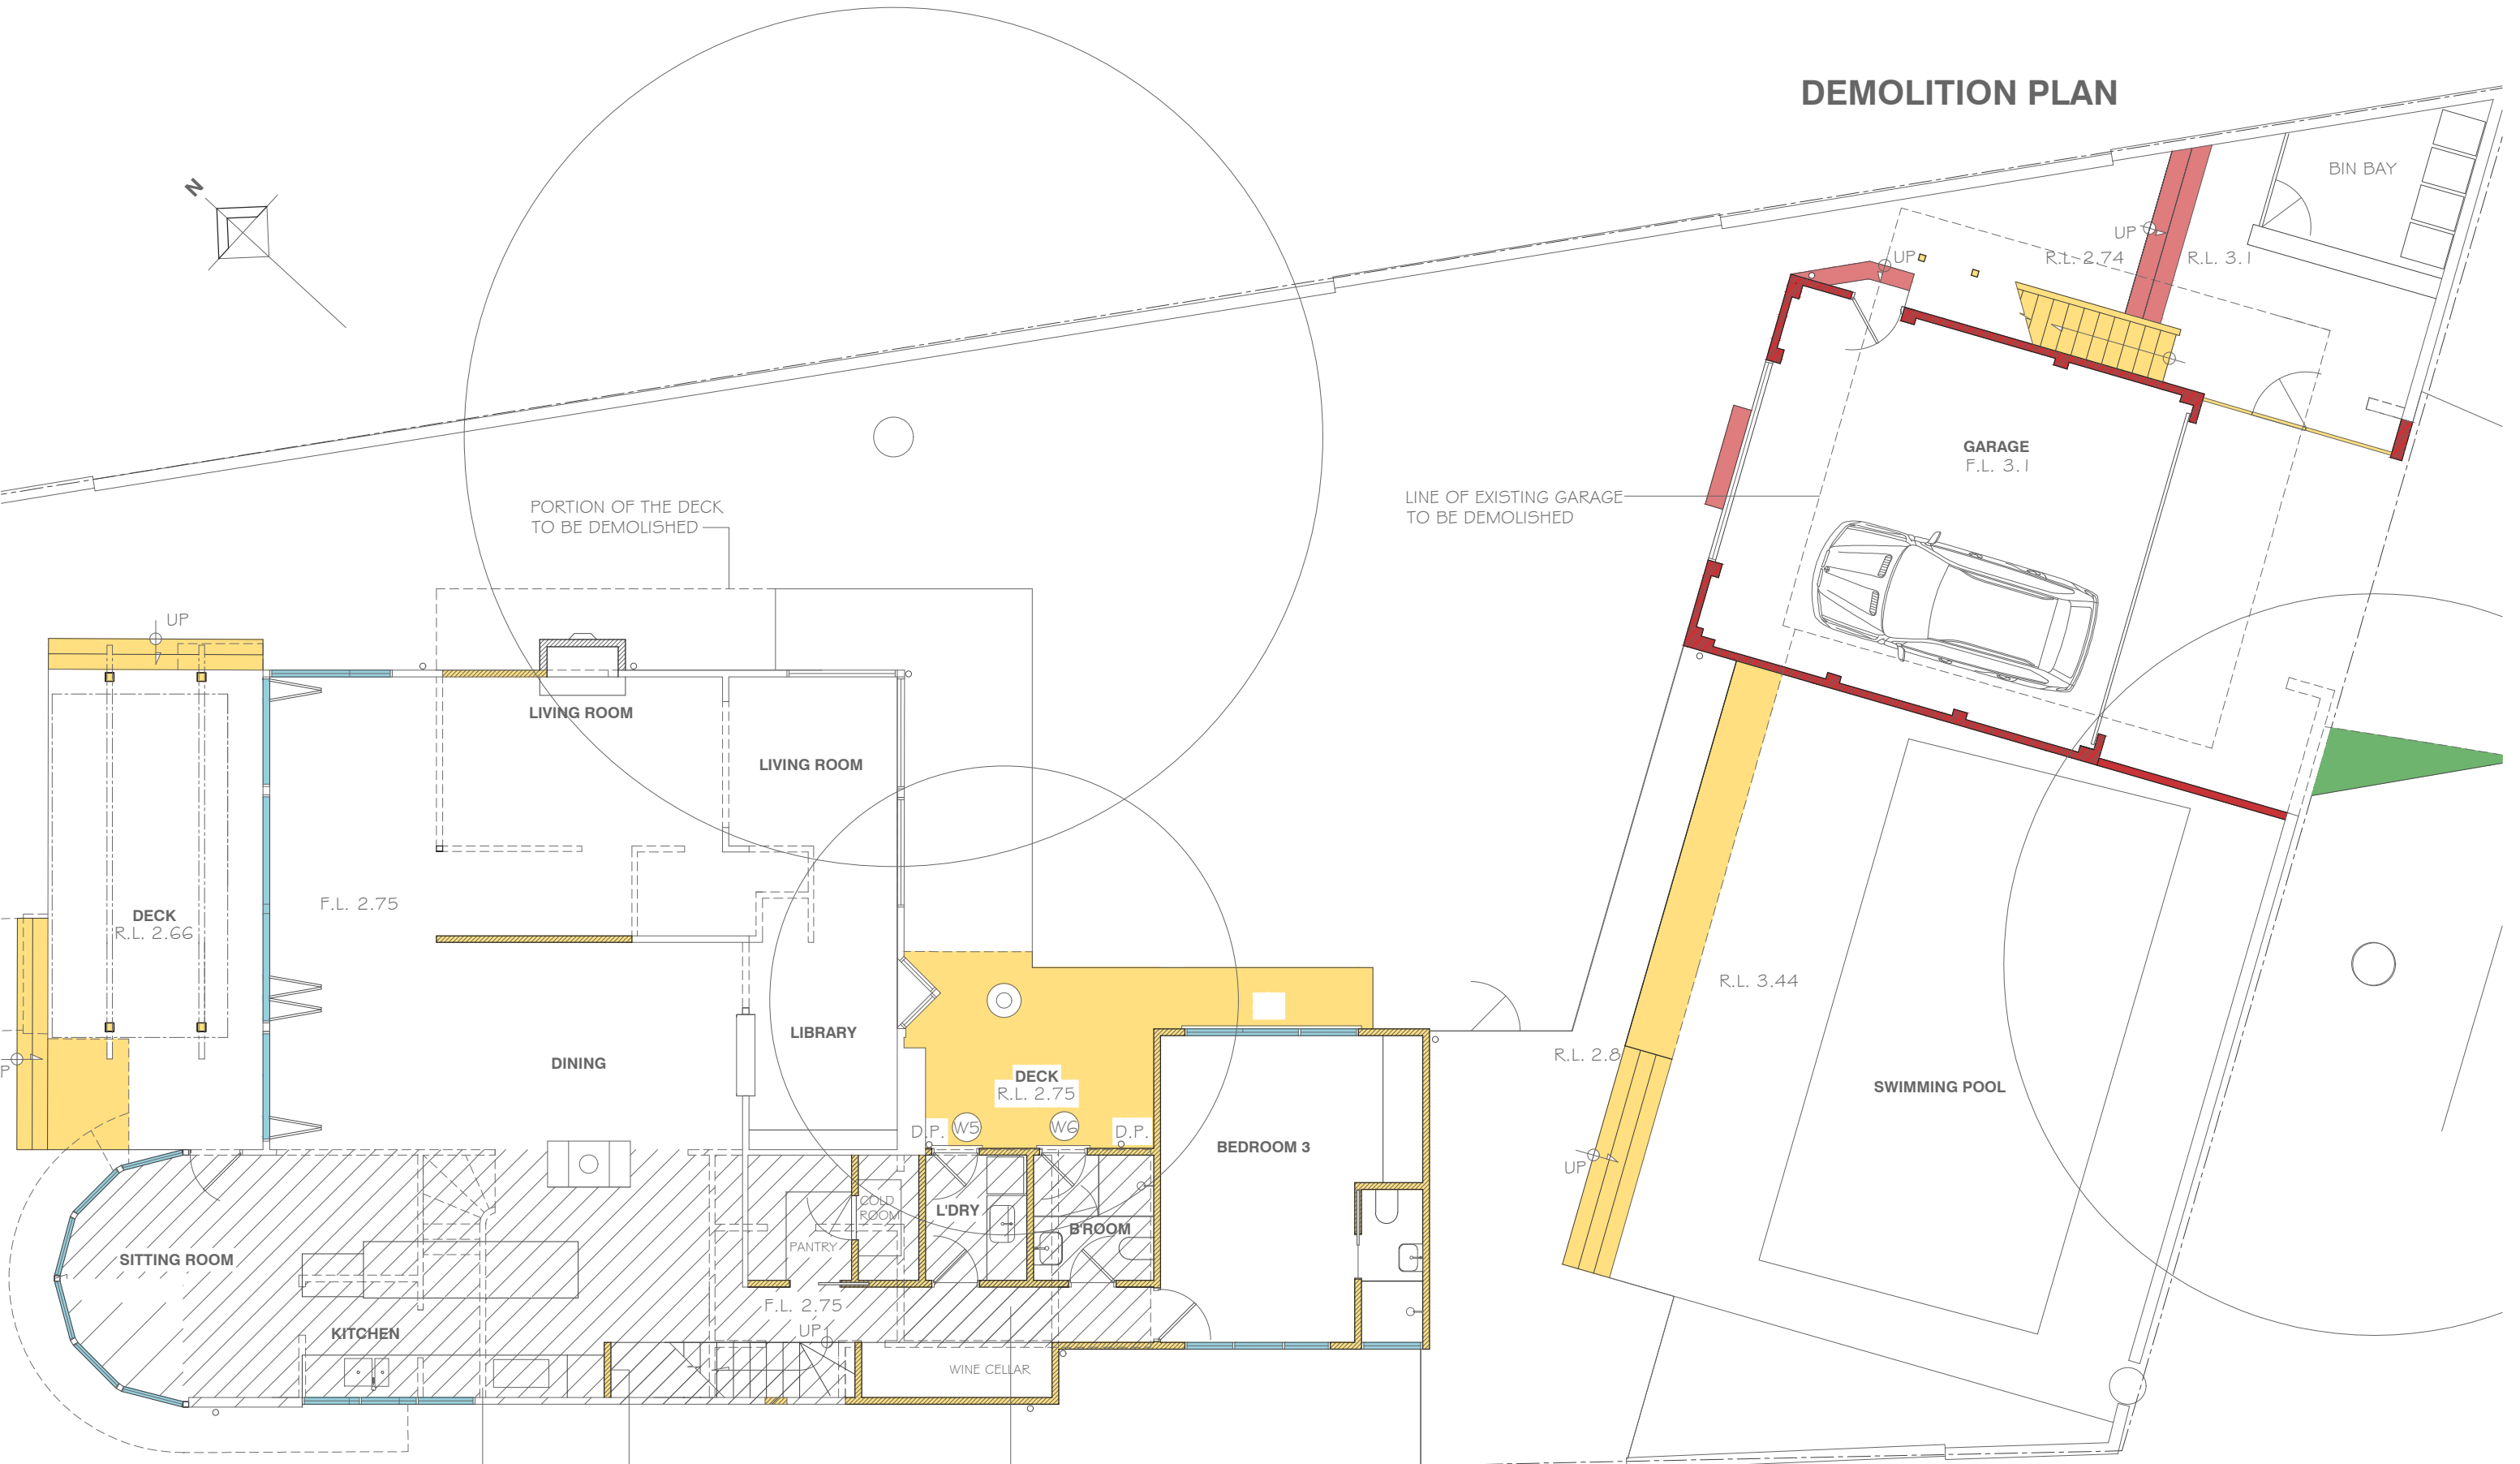

**NOTES**  
NEW WORKS SHOWN COLOURED

NEW WALL SECTIONS  
— REMOVED WALL SECTIONS

EXISTING GROUND FLOOR SECTION SHOWN  
HATCHED TO BE DEMOLISHED AND THE  
PROPOSED BUILT ON THE EXISTING  
FOOTPRINT & BEYOND AS REPRESENTED——

PROPOSED ALTERATIONS & ADDITIONS

**ROB & SHERIDAN BELGIOVANE**

## 28 DELECTA AVE CLAREVILLE

**Gerald Gilchrist + Associates Pty Ltd**

## DEVELOPMENT APPLICATION

DATE	SCALE
<b>30 May 2022</b>	<b>1:100</b>


0322 / AD09

DO NOT SCALE OFF DRAWINGS

PHONE 9939 0790



SOFT LANDSCAPE AREAS

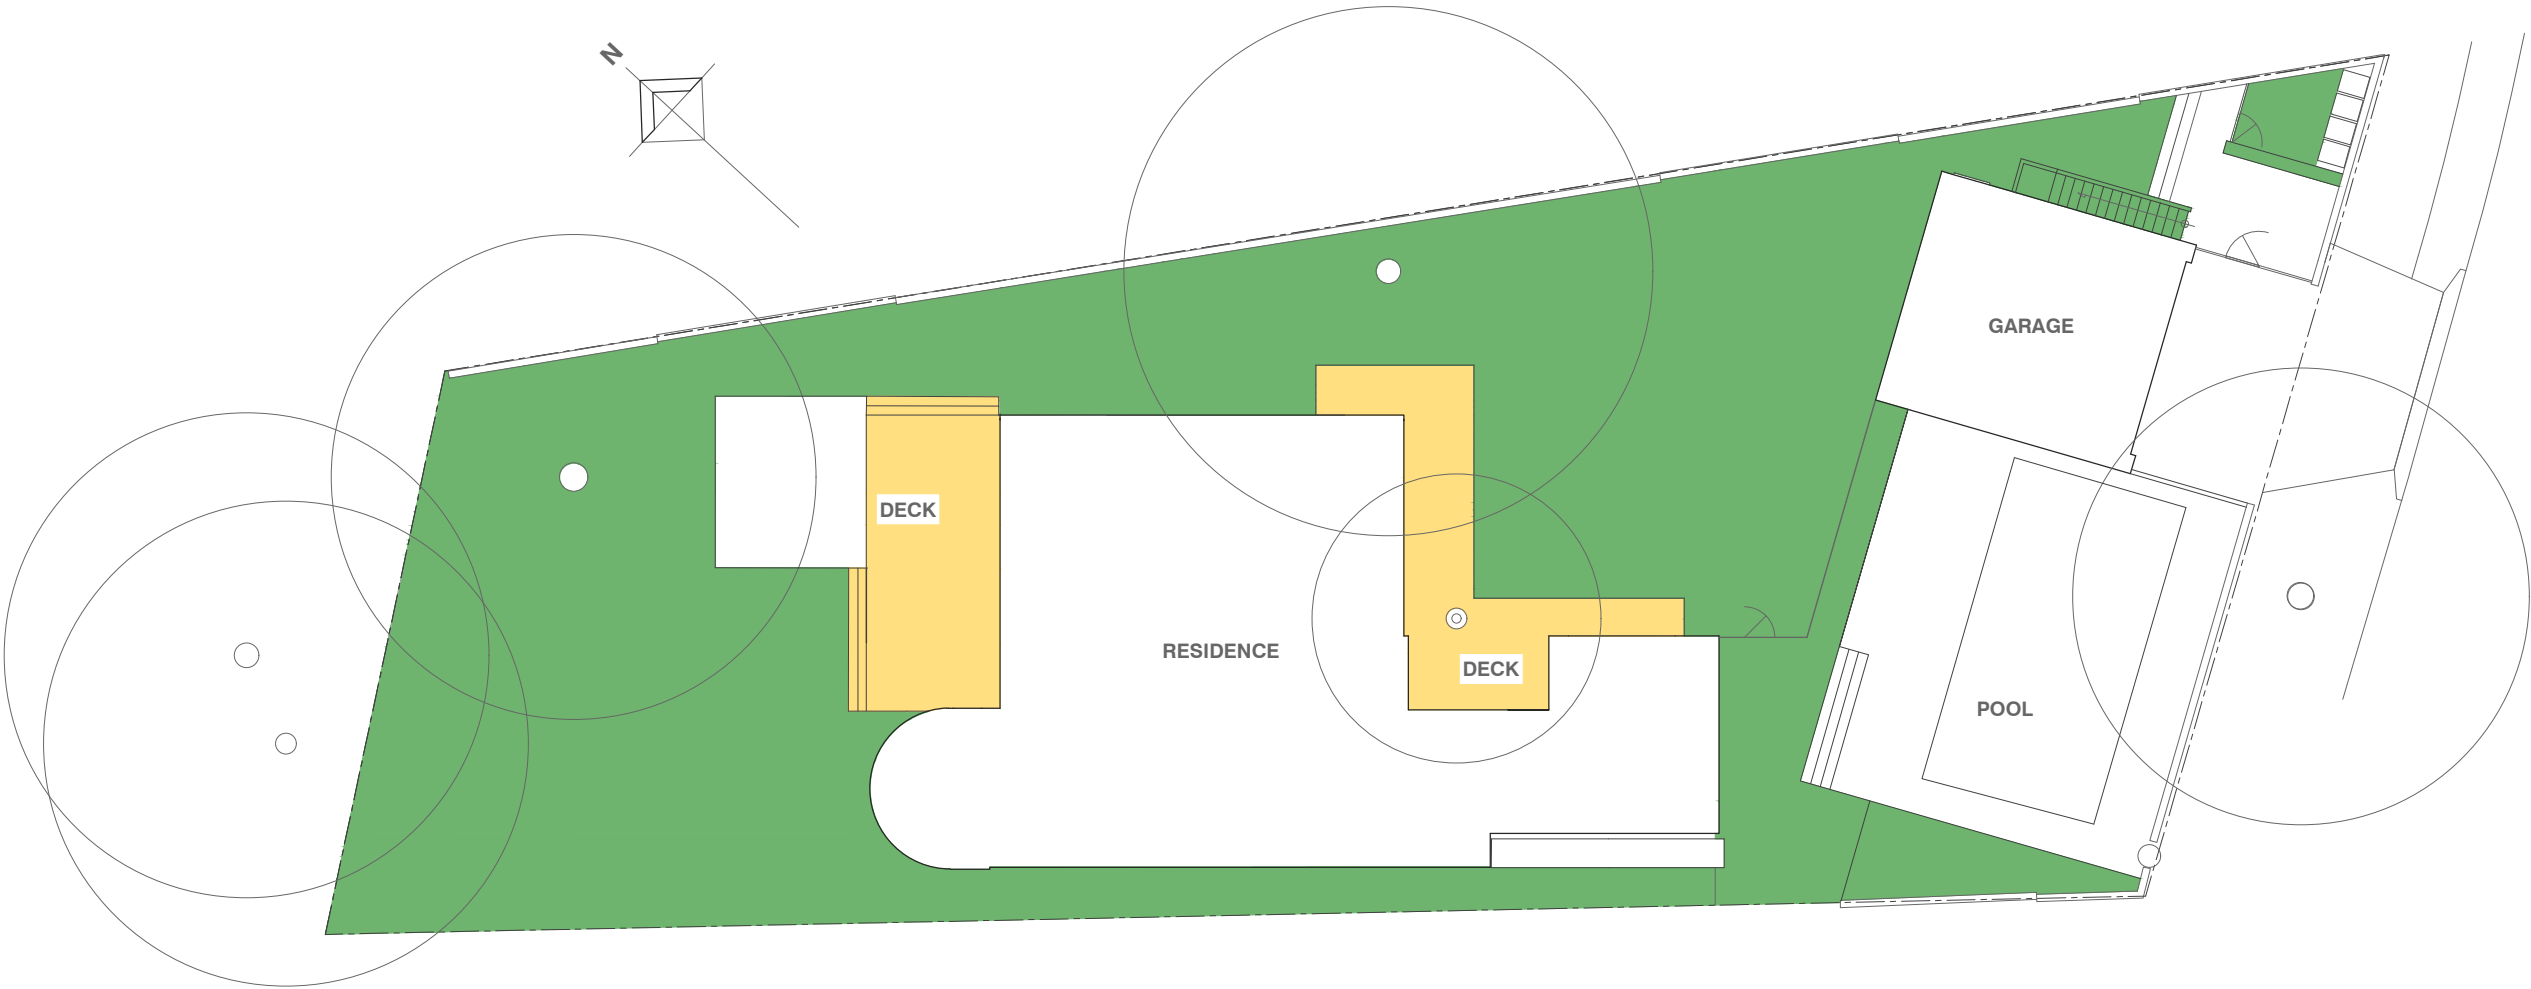

NOTES

SITE AREA 902.7m2


SOFT LANDSCAPE REQUIRED IS 60% OF THE SITE AREA BEING 541.62m2.  
DECKING CAN CONTRIBUTE 6% OF THE SITE AREA BEING 54.16.

PATHS UNDER 1.0m WIDE CAN BE INCLUDED AS SOFT LANDSCAPE AREA.

AS REPRESENTED WE HAVE HAVE 490.36m2 OF LANDSCAPE AREA PLUS 54.16  
ALLOWED FOR DECKS (ACTUAL DECK AREAS 61.39m2) TOTAL 544.52m2 BEING  
2.9m2 OVER THE REQUIREMENT

PROPOSED ALTERATIONS & ADDITIONS	DEVELOPMENT APPLICATION	DATE	SCALE
ROB & SHERIDAN BELGIOVANE		30 May 2022	1:200
28 DELECTA AVE CLAREVILLE		0322 / AD10	
Gerald Gilchrist + Associates Pty Ltd	PHONE 9939 0790	DO NOT SCALE OFF DRAWINGS	



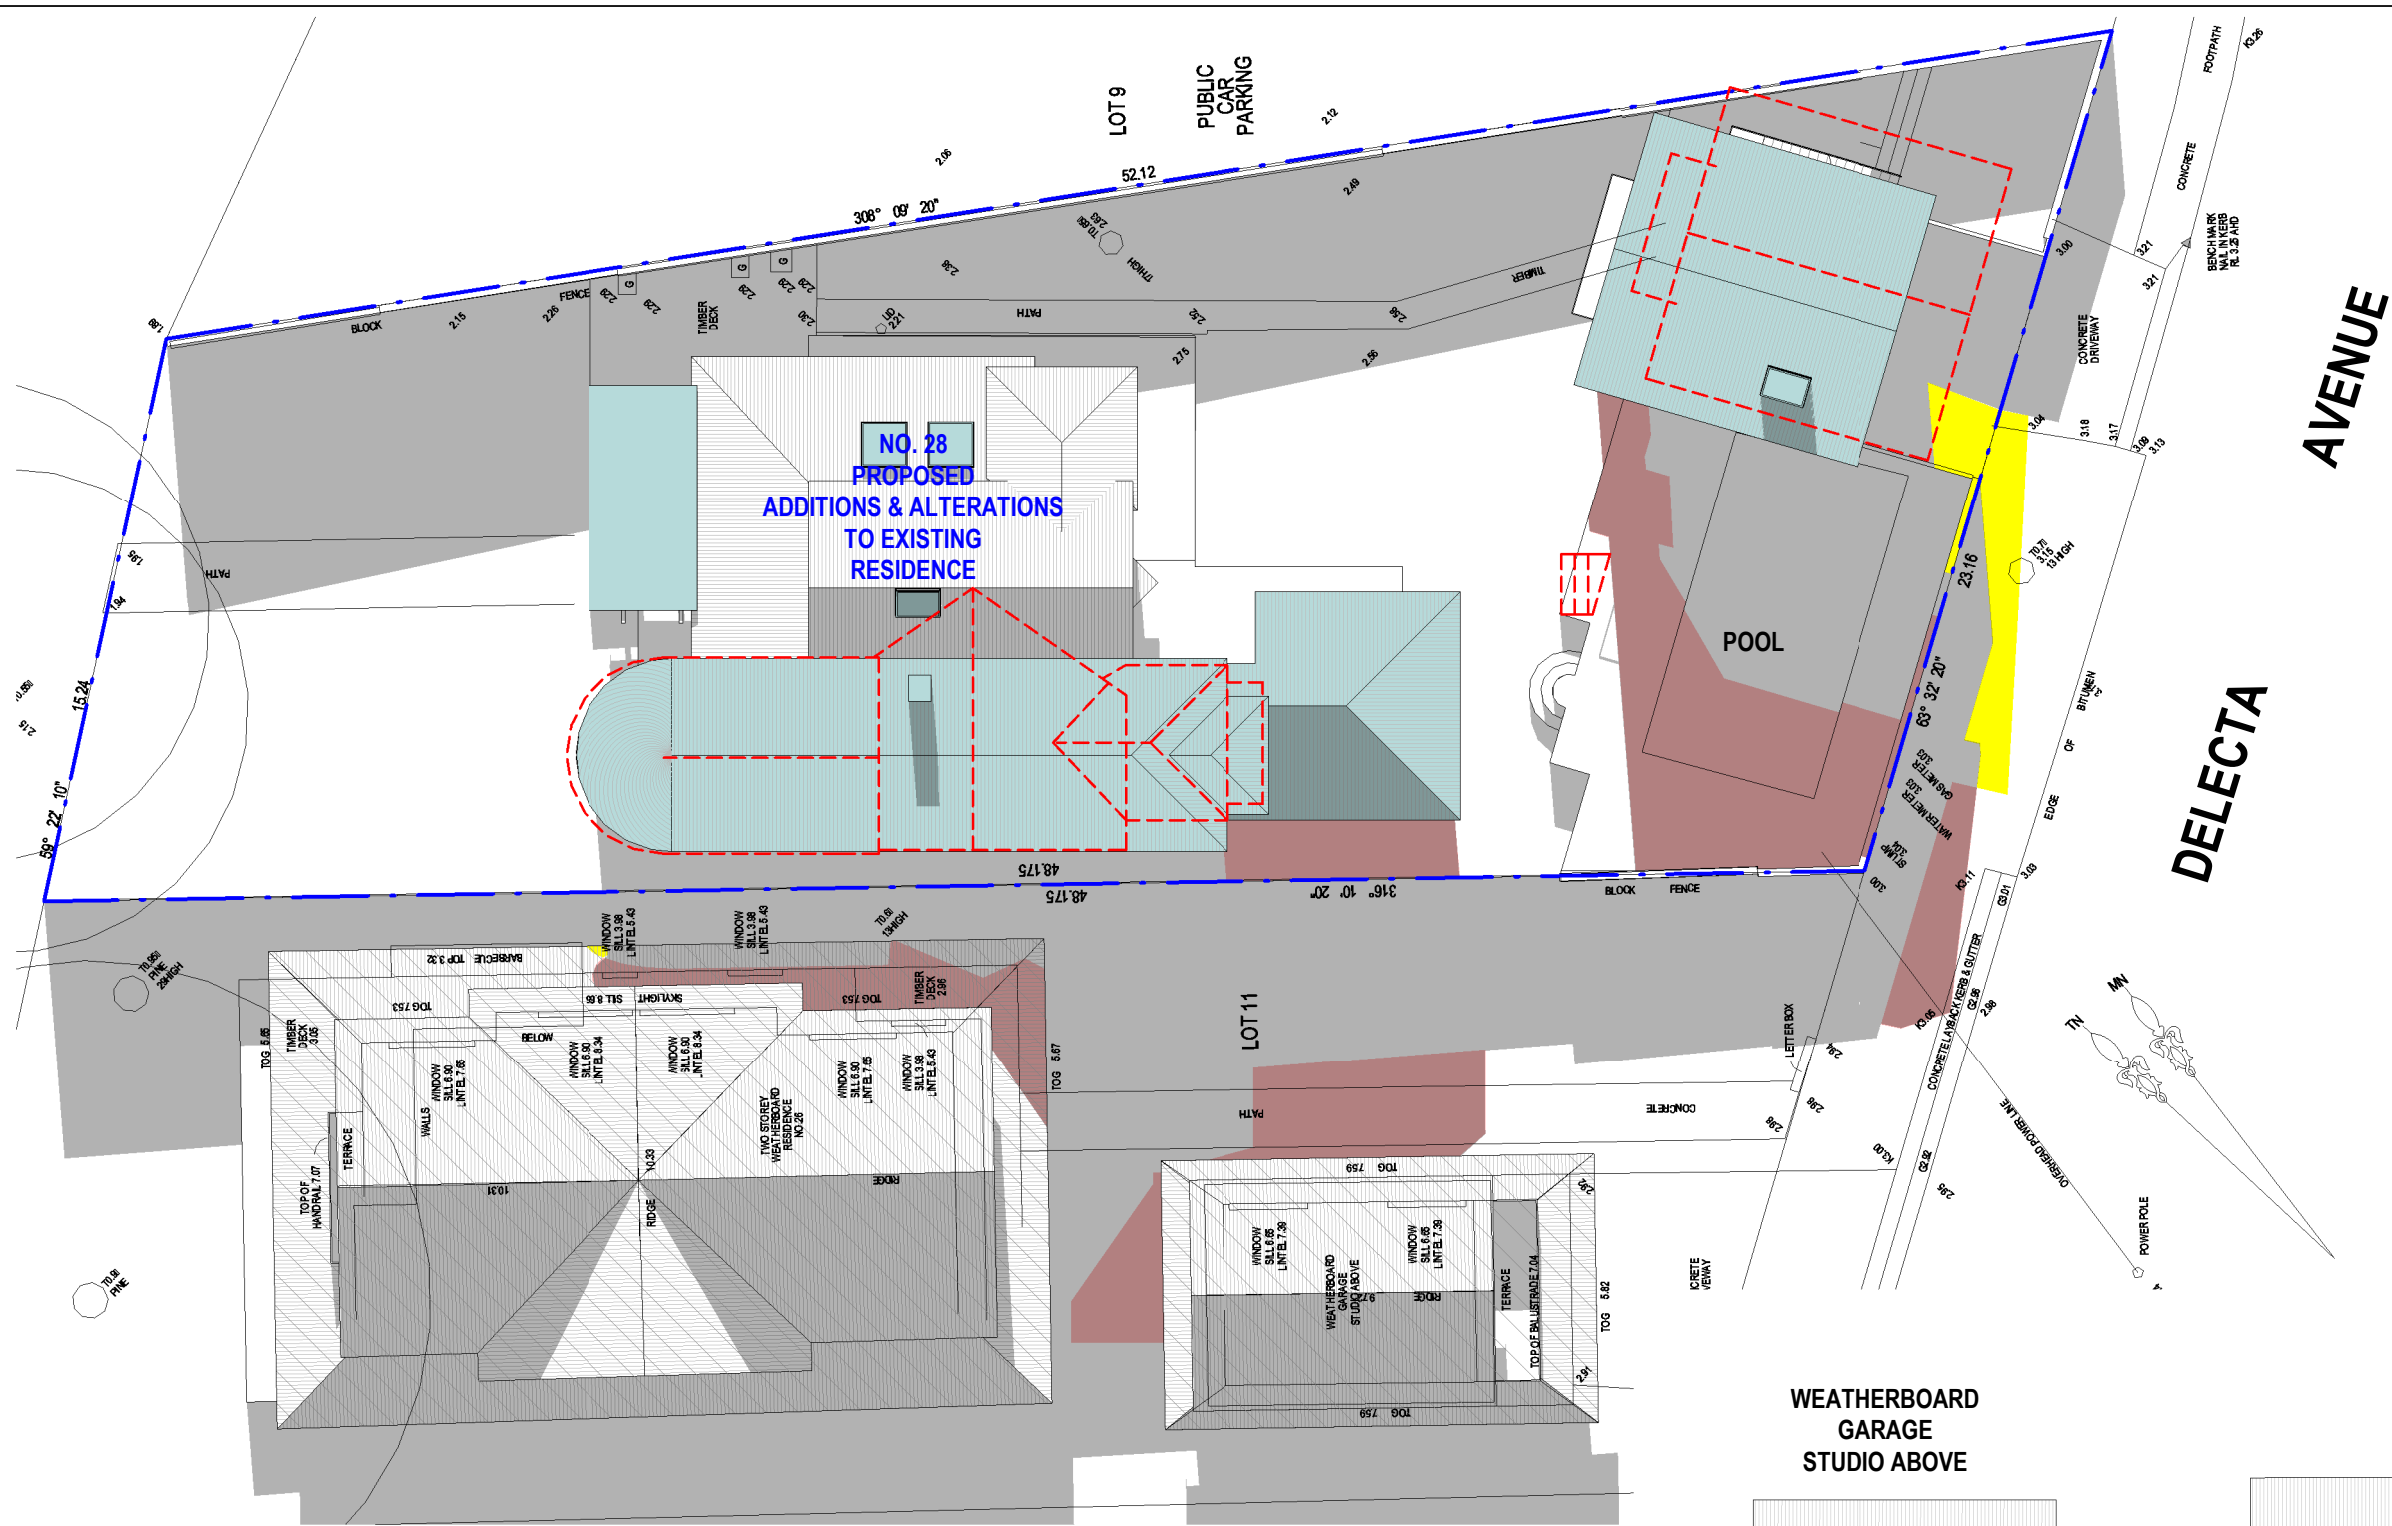

NOTE:

SHADOWS SHOWN HAVE BEEN COMPILED FROM  
DETAIL & LEVEL SURVEY BY DP SURVEYING REF  
NO. 1886 DATED 19 JANUARY 2022 AND  
ARCHITECTURAL DRAWINGS SUPPLIED BY  
GERALD GILCHRIST + ASSOC. P/L REF NO. 0322  
DATED 21 MAR 2022

LEGEND:


- DENOTES OUTLINE OF EXISTING STRUCTURES TO BE DEMOLISHED
- DENOTES AREA OF EXISTING & SURROUNDING BUILDING SHADOW
- DENOTES AREA OF PROPOSED ADDITIONS & ALTERATIONS
- DENOTES AREA OF PROPOSED ADDITIONAL BUILDING SHADOW
- DENOTES AREA OF PROPOSED REDUCTION OF BUILDING SHADOW (STRUCTURES TO BE DEMOLISHED)

1


Shadowing June 21st 9.00am

1 : 200

WEATHERBOARD  
GARAGE  
STUDIO ABOVE

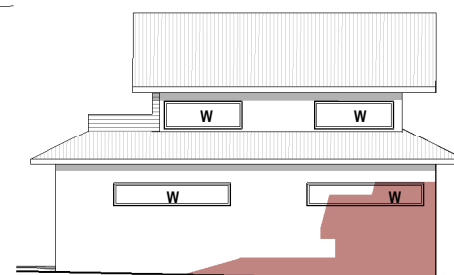

NORTH EAST ELEVATION  
NO. 26  
TWO STOREY  
WEATHERBOARD RESIDENCE

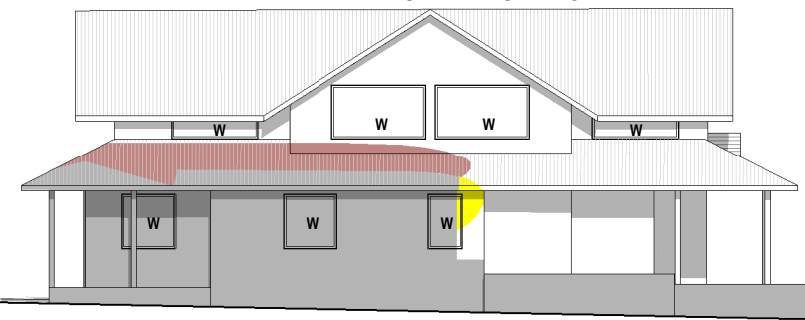

Cad Draft P/L

ABN 27 083 288 153

SUITE 1, 505 BALMAIN ROAD,  
LILYFIELD, NSW 2040

SHADOW ANALYSIS CONSULTANTS

PH: 9555 8545

info@caddraftnsw.com.au

No.	Description	Date

SHADOW DIAGRAMS  
No. 28 DELECTA AVENUE  
CLAREVILLE

CLIENT: ROB & SHERIDAN BELGIOVANE


Shadowing June 21st 9.00am

Project number	22-40
Date	31-03-22
Drawn by	KP
Checked by	JD

A100

Scale 1 : 200



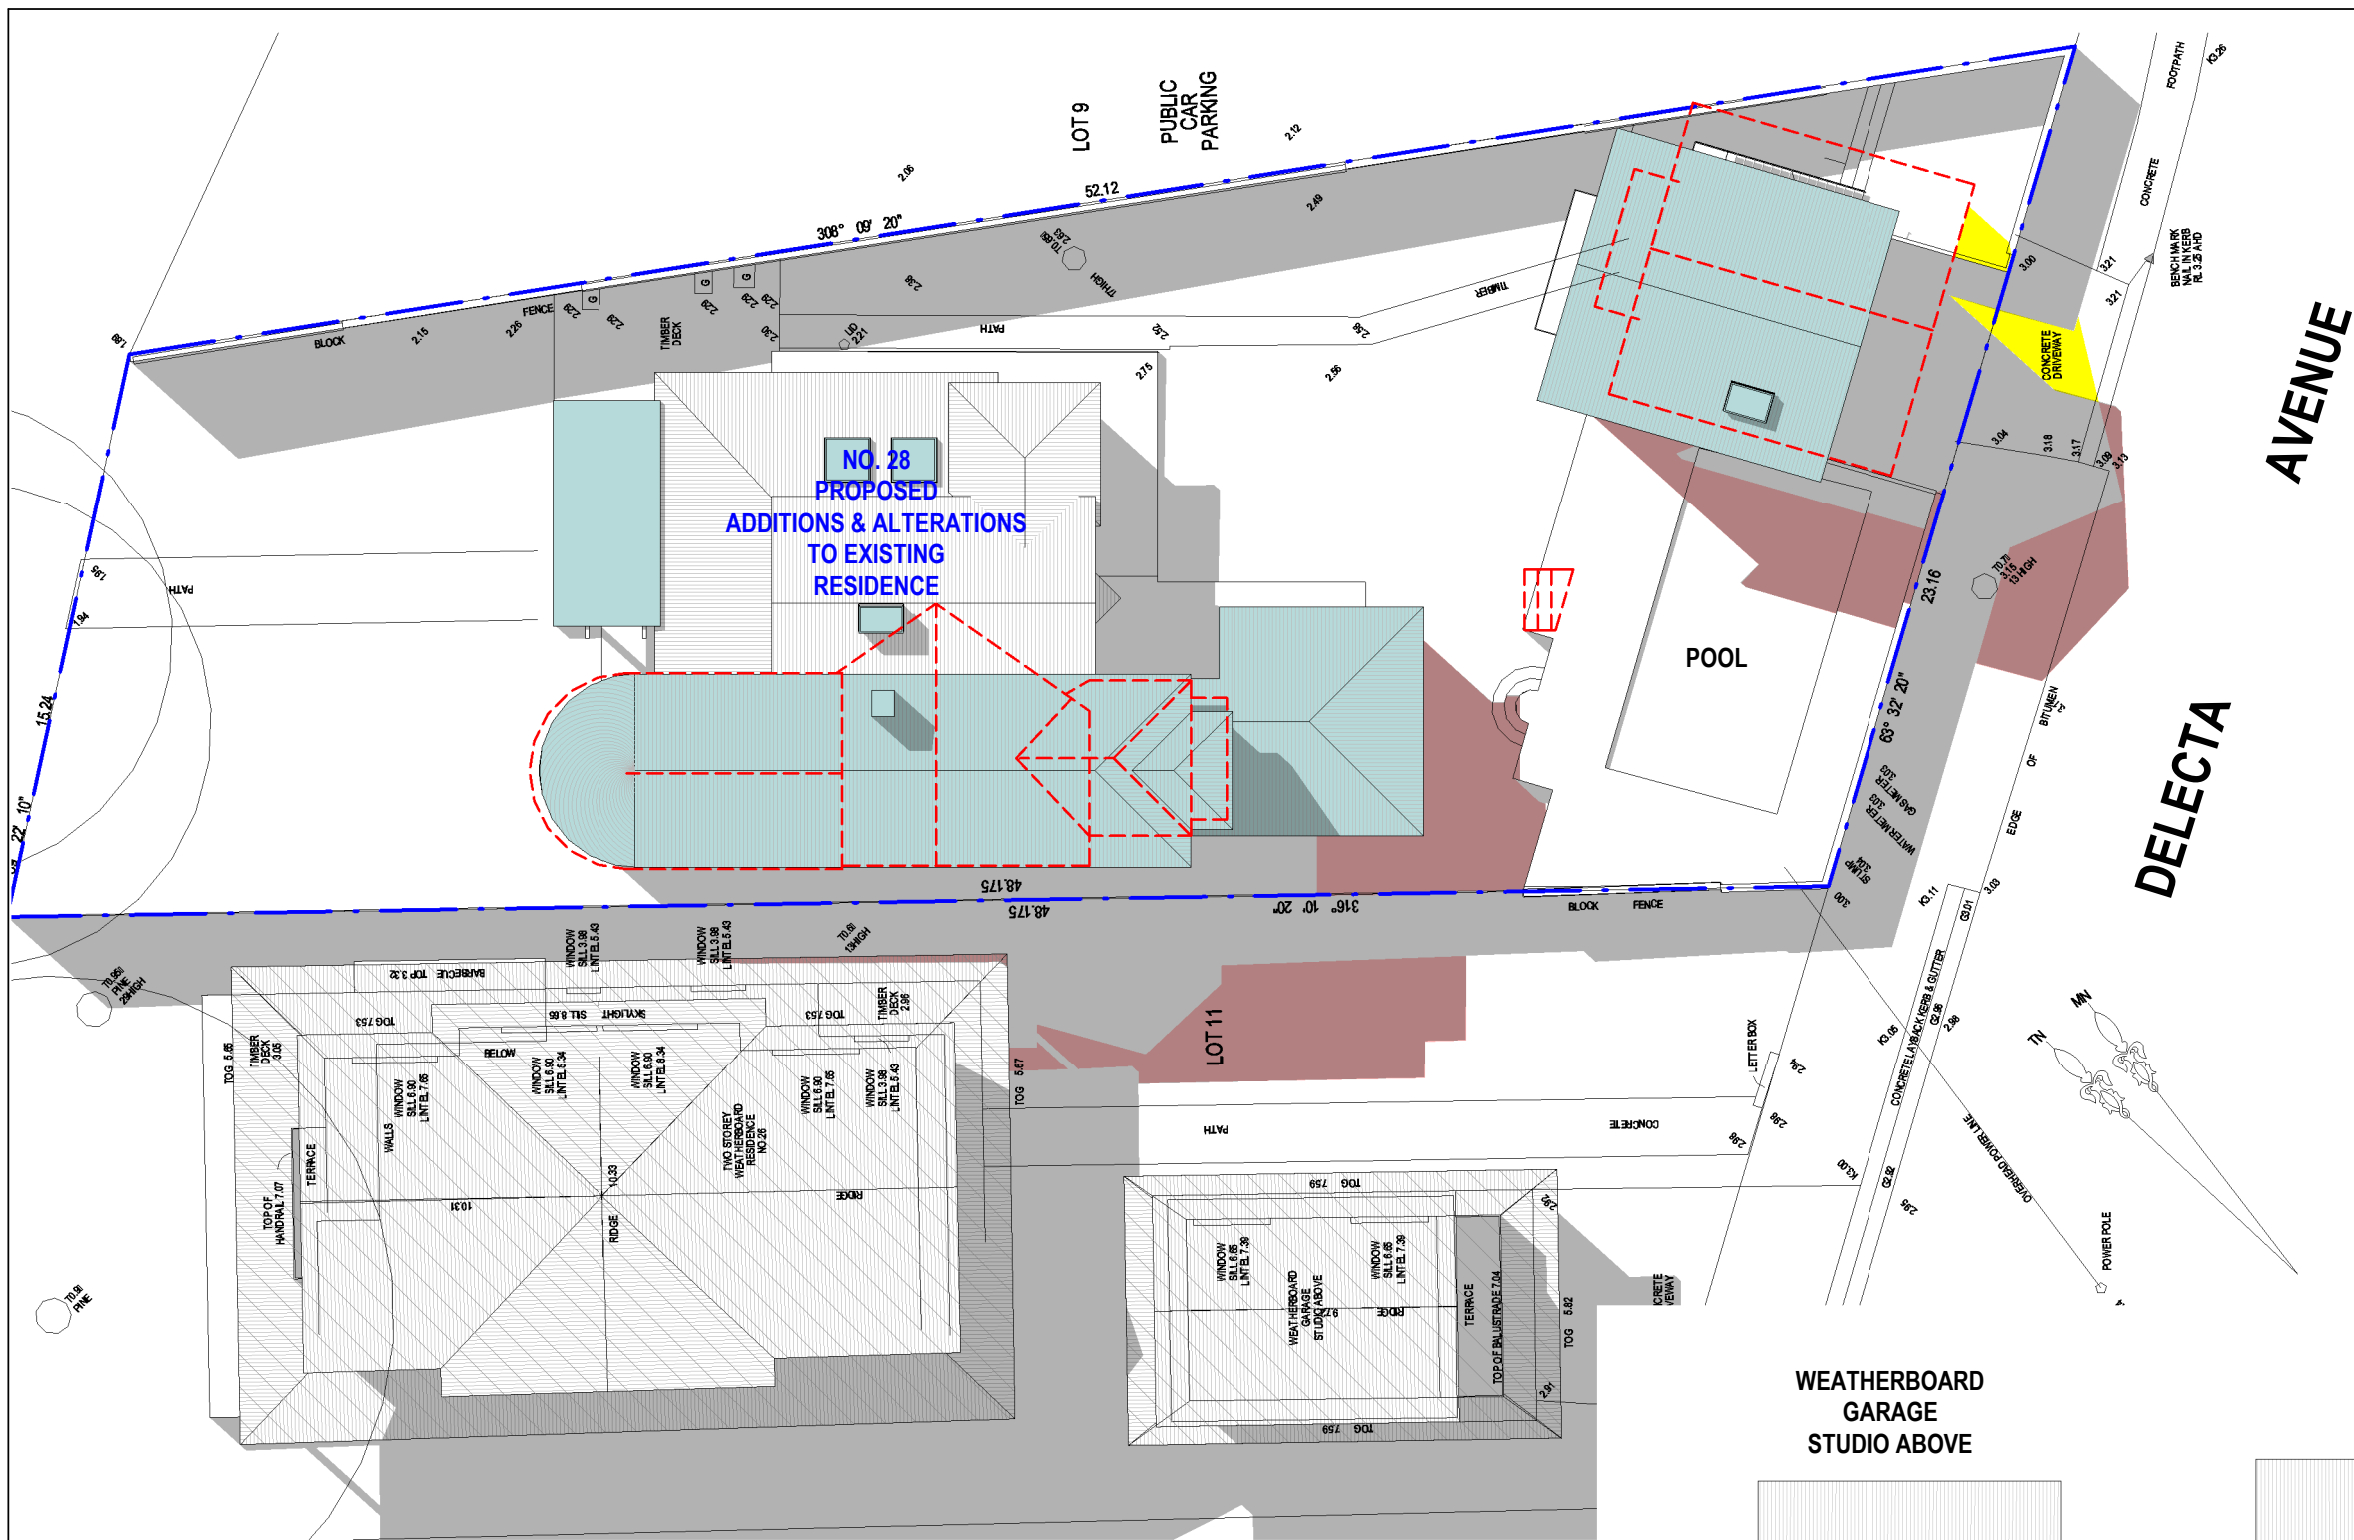


NOTE:  
SHADOWS SHOWN HAVE BEEN COMPILED FROM  
DETAIL & LEVEL SURVEY BY DP SURVEYING REF  
NO. 1886 DATED 19 JANUARY 2022 AND  
ARCHITECTURAL DRAWINGS SUPPLIED BY  
GERALD GILCHRIST + ASSOC. P/L REF NO. 0322  
DATED 21 MAR 2022

LEGEND:

- DENOTES OUTLINE OF EXISTING STRUCTURES TO BE DEMOLISHED
- DENOTES AREA OF EXISTING & SURROUNDING BUILDING SHADOW
- DENOTES AREA OF PROPOSED ADDITIONS & ALTERATIONS
- DENOTES AREA OF PROPOSED ADDITIONAL BUILDING SHADOW
- DENOTES AREA OF PROPOSED REDUCTION OF BUILDING SHADOW (STRUCTURES TO BE DEMOLISHED)

1 Shadowing June 21st 12.00pm  
1 : 200

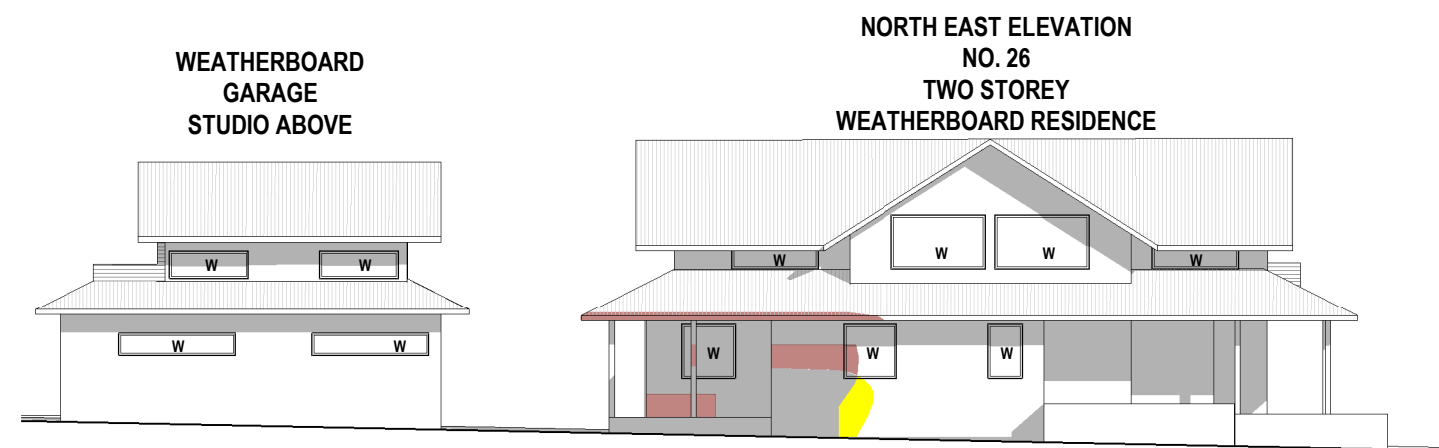

Cad Draft P/L

ABN 27 083 288 153

SUITE 1, 505 BALMAIN ROAD,  
LILYFIELD, NSW 2040

SHADOW ANALYSIS CONSULTANTS

PH: 9555 8545

info@caddraftnsw.com.au

No.	Description	Date

SHADOW DIAGRAMS  
No. 28 DELECTA AVENUE  
CLAREVILLE

CLIENT: ROB & SHERIDAN BELGIOVANE


Shadowing June 21st 12.00pm

Project number	22-40
Date	31-03-22
Drawn by	KP
Checked by	JD

A101

Scale 1 : 200



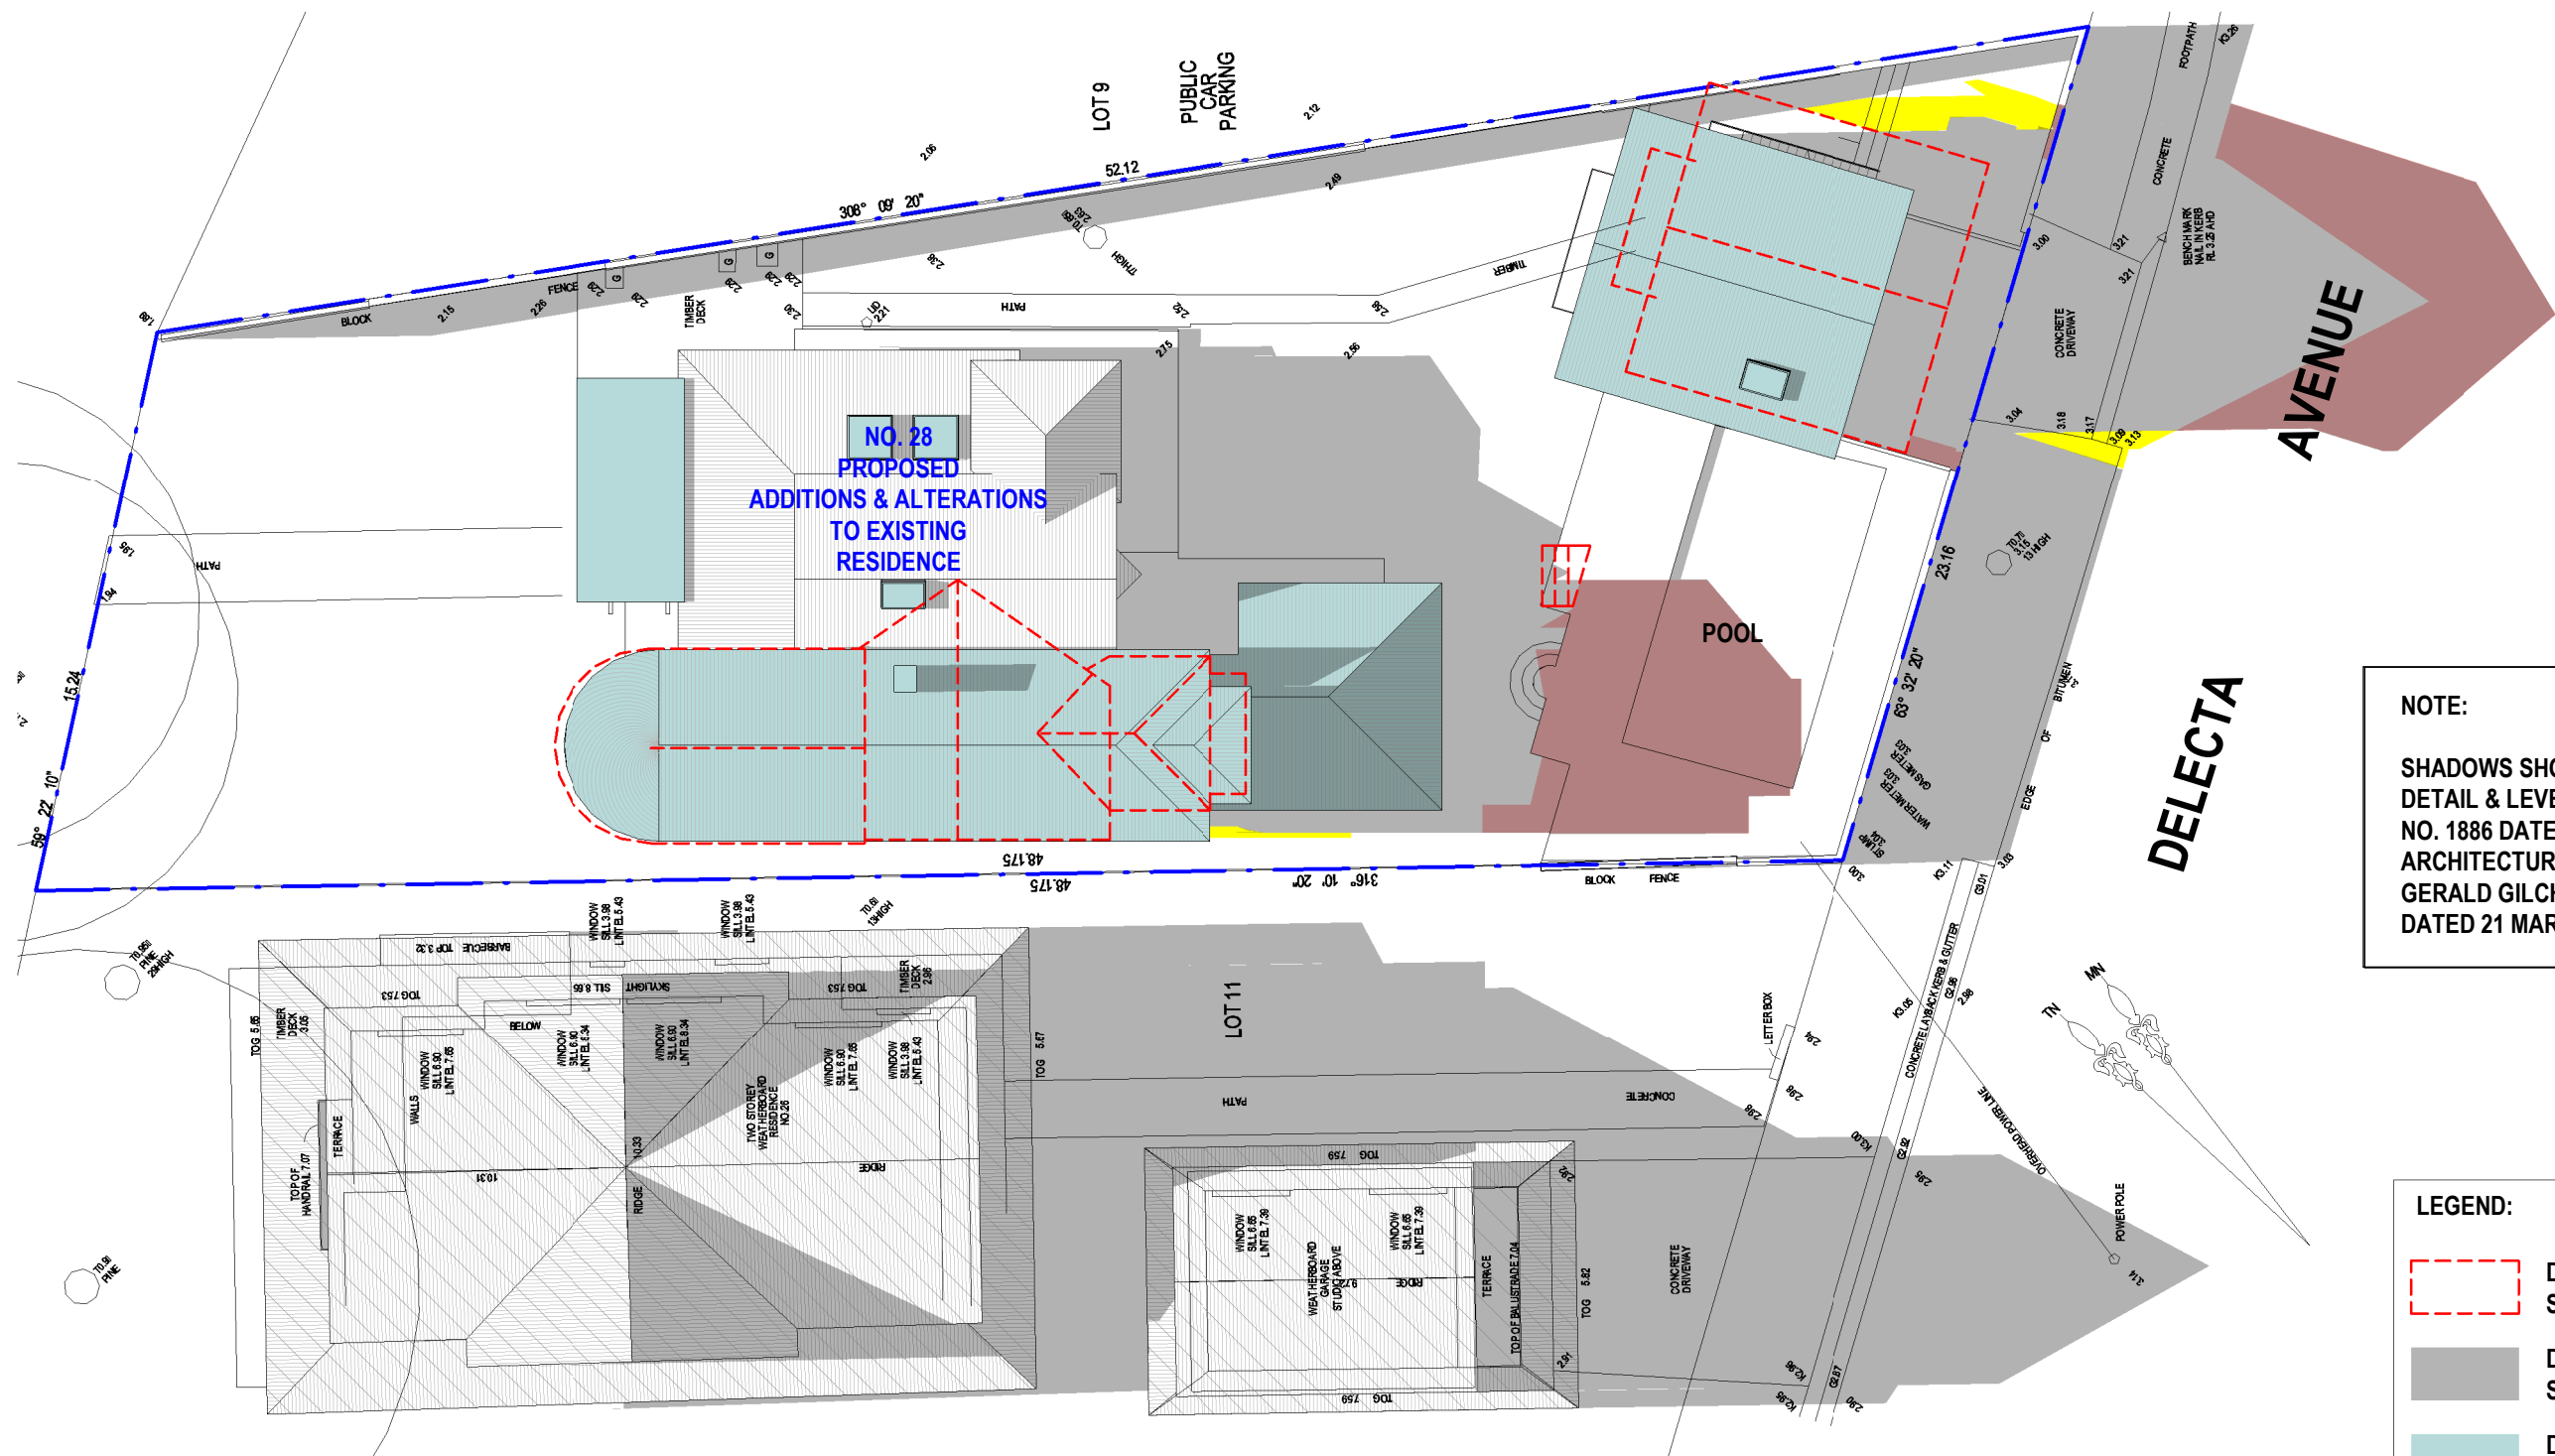

NOTE:

SHADOWS SHOWN HAVE BEEN COMPILED FROM  
DETAIL & LEVEL SURVEY BY DP SURVEYING REF  
NO. 1886 DATED 19 JANUARY 2022 AND  
ARCHITECTURAL DRAWINGS SUPPLIED BY  
GERALD GILCHRIST + ASSOC. P/L REF NO. 0322  
DATED 21 MAR 2022

LEGEND:

- DENOTES OUTLINE OF EXISTING  
STRUCTURES TO BE DEMOLISHED
- DENOTES AREA OF EXISTING &  
SURROUNDING BUILDING SHADOW
- DENOTES AREA OF PROPOSED  
ADDITIONS & ALTERATIONS
- DENOTES AREA OF PROPOSED  
ADDITIONAL BUILDING SHADOW
- DENOTES AREA OF PROPOSED  
REDUCTION OF BUILDING SHADOW  
(STRUCTURES TO BE DEMOLISHED)

1

Shadowing June 21st 3.00pm  
1 : 200

Cad Draft P/L

ABN 27 083 288 153

SUITE 1, 505 BALMAIN ROAD,  
LILYFIELD, NSW 2040

SHADOW ANALYSIS CONSULTANTS

PH: 9555 8545

info@caddraftnsw.com.au

No.	Description	Date

SHADOW DIAGRAMS  
No. 28 DELECTA AVENUE  
CLAREVILLE

CLIENT: ROB & SHERIDAN BELGIOVANE

Shadowing June 21st 3.00pm

Project number	22-40
Date	31-03-22
Drawn by	KP
Checked by	JD

A102

Scale 1 : 200




Belgiovine Residence Plant List			
Plant Species	Quantity	Pot Size	Height
Isopogon anemonifolius	14	300mm	1800
Red spider flower Grevillea	17	300mm	1200
Xanthostemon chrysanthus	8	45ltr	1800
Livingstonia australis	2	400ltr	3000
Xanthorrhoea arborea	3	400ltr	2000
Pimelea linifolia	34	200mm	500
Carpobrotus glaucescens	105	200mm	600
Dianella caerulea	45	200mm	500
Banksia integrifolia	17	45ltr	1800
Banksia spinulosa	9	100ltr	2000
Correa reflexa	6	45ltr	1800
Callistemon citrinus	42	100ltr	2000
Waterhousea floribunda, 'Sweeper'	45	100ltr	2000
Grevillea 'Red Spider Flower'	17	300mm	1500
Banksia 'Birthday Candles'	15	300mm	600
3.6m 1.8m high Greenwall	88	200mm	300



Isopogon anemonifolius



Grevillea 'Red spider flower'

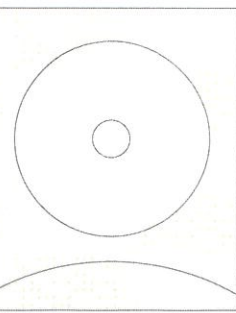

Existing Tree

8 x 45ltr Xanthostemon chrysanthus  
17 x 45ltr Banksia integrifolia

Timber Outdoor Lounge

Pebble Mulch

Outdoor Firepit

Pergola to Architects specifications

15 x 300mm Banksia 'Birthday Candles'

17 x 300mm Grevillea 'Red Spider Flower'

60 x 200mm Carpobrotus glaucescens

14 x 300mm Isopogon anemonifolius

42 x 100ltr Callistemon citrinus

Sandstone Steps to Entrance

Pebble Mulch

3.2m x 1.8m high Greenwall

1 x 400ltr  
Livingstonia australis

'Reading Boy' Sculpture

20 x 200mm Pimelea linifolia  
6 x 45ltr Correa reflexa



Olearia tomentosa



Callistemon citrinus



Correa reflexa



Lambertia Formosa



xanthostemon chrysanthus



Livingstonia australis



Xanthorrhoea arborea



Pimelea linifolia




Carpobrotus glaucescens



Dianella caerulea



Banksia integrifolia

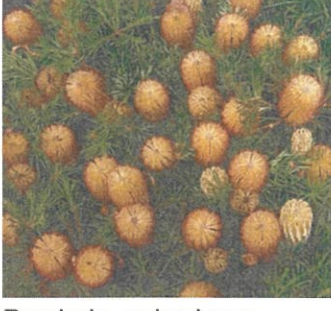

Banksia spinulosa

DRAWING TITLE  
LANDSCAPE PLAN FOR DA SUBMISSION

	<b>DURIEDDESIGN</b>  <b>Sydney</b> 117 Old Pittwater Road, NSW 2100 T +61 2 9313 3200 <b>Los Angeles</b> 8033 Sunset Boulevard #427 CA 90046 USA T +1 323 654 2206 www.jamieduriedesign.com	<b>CLIENT</b> Rob and Sheridan Belgiovine  <b>PROJECT</b> Belgiovine Residence 28 Delecta Ave, Clareville, NSW	SCALE [A3] 1:200	DATE 29.04.22	DRAWN JD	CHECKED JD
			JOB: DD	DRAWING: L001		REVISION: 3