


EXISITNG COUNCIL'S STORMWATER ASSET

NOT TO SCALE

Copyright This docum	ent is & shall remain the property of ING Consulting Engineers Pty Ltd. The document may only be use	ed for the purpose for which it was commiss	sioned. They must not be used, reproduce
			Drawn & Designed By :
			Checked By :
С	Update for S82 Review Submission	8 Dec. 2021	
В	Incorporate Council's Comments re WSUD	20 Apr. 2021	Approved By : Kenneth MIEAust CPEng IntPE(Aus) (Reg.
А	Development Application	28 Jan. 2021	Registered Certi Road & Drainage Registered Desig (Reg. No. DEPOO
Issue	Description	Date of Drawing	(Reg. No. DEP00 & Professional E NSW Fair Tradin




iving (Stage 2)	Drawing Title Existing Services and Survey Plan		
	Date	Scale	
V 2086	January 2021	As Shown @ A1	
	Project No.	Drawing & Sheet No./Issue	
	284012021DA	28401-01/18 / C	

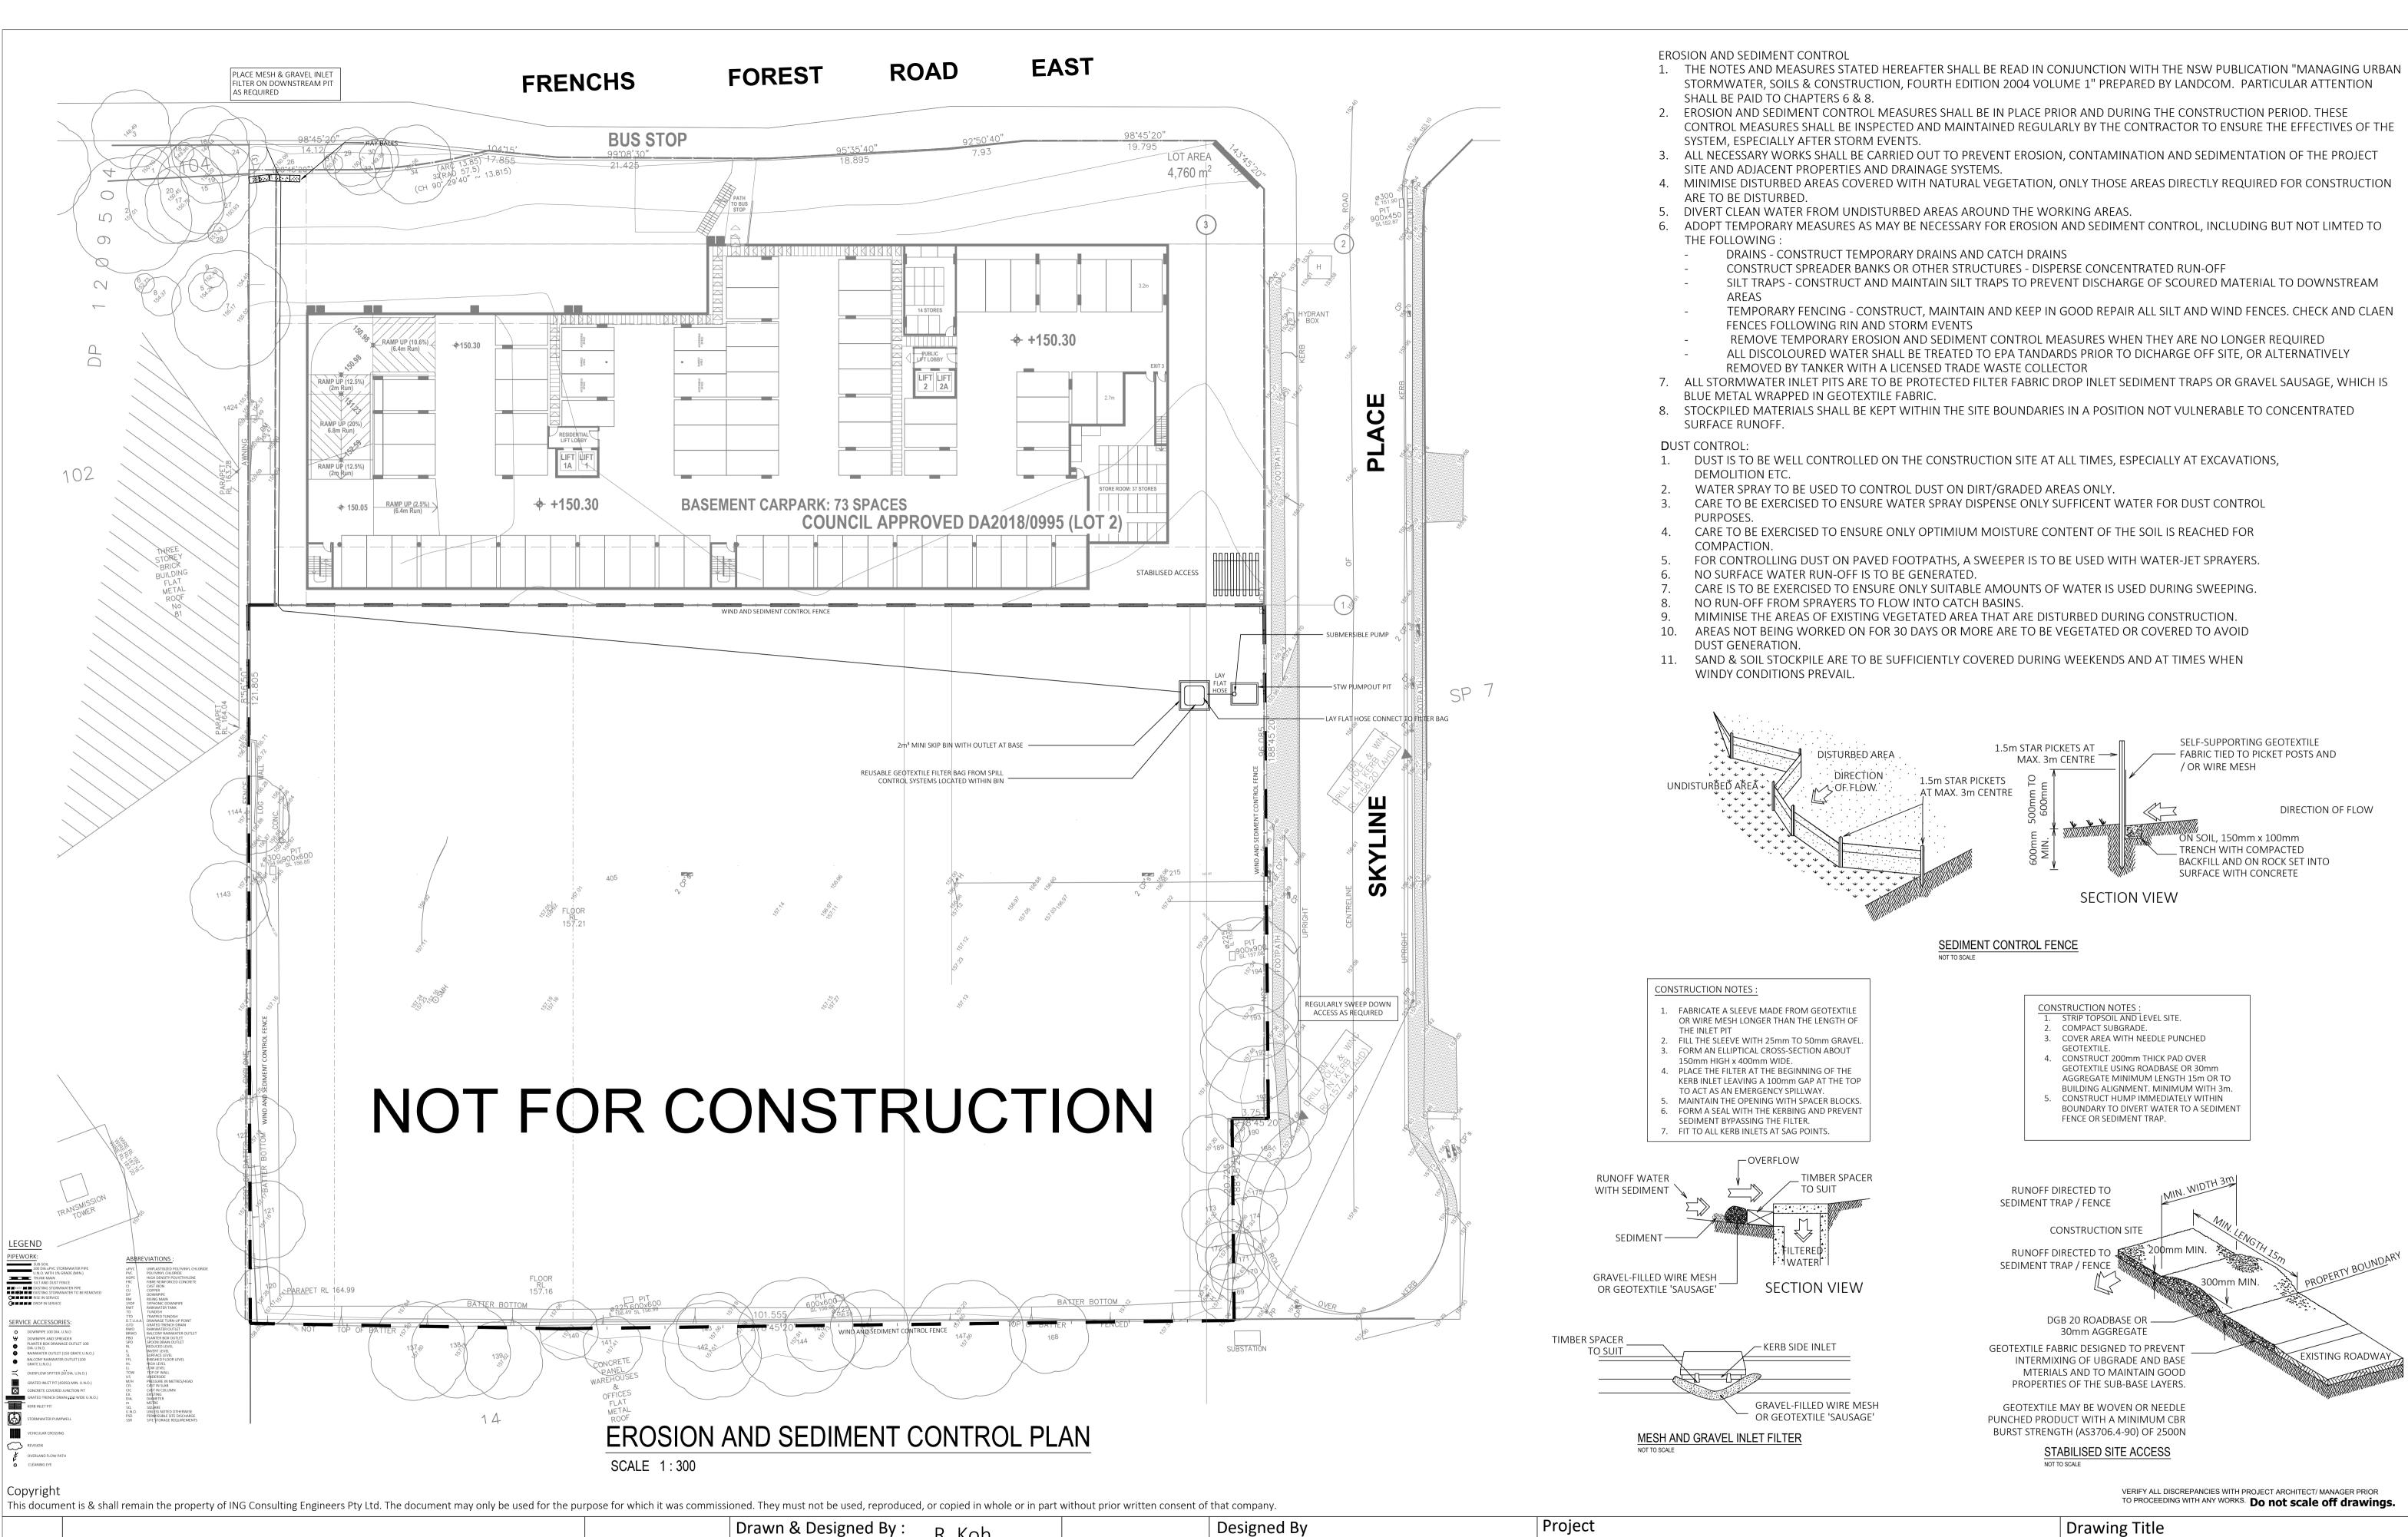

			Drawn & Design	ned By :
			Checked By :	
С	Update for S82 Review Submission	8 Dec. 2021		
В	Incorporate Council's Comments re WSUD	20 Apr. 2021	Approved By :	Kenneth MIEAust CPEng I IntPE(Aus) (Reg.
А	Development Application	28 Jan. 2021	la Tono	Registered Certil Road & Drainage Registered Desig
Issue	Description	Date of Drawing	1 2 1	(Reg. No. DEPOO & Professional E NSW Fair Trading

Designed By R. Koh ING CONSULTING Proposed Seniors Li N. Evans **ENGINEERS PTY LTD** 5 Skyline Place At P. O BOX 1543 th T. NG Frenchs Forest NSW g NER APEC Engineer BAULKHAM HILLS NSW 1755 eg. No. 2206352) RPEQ tifier (Hydraulic (stormwater F : (02) 8807 5656 Client age and Stormwater) (Reg. No. BDC0827) ign Practitioner (Drainage & Civil Engineering M: 0433 778 109 000692) Engineer (Civil) (Reg. No. DEP0000630) E : ken@ingengineers.com.au

iving (Stage 2)	Drawing Title Erosion & Sediment Control Plan		
V 2086	Date January 2021	Scale As Shown @ A1	
	Project No.	Drawing & Sheet No./Issue	
	284012021DA	28401-02/18 / C	

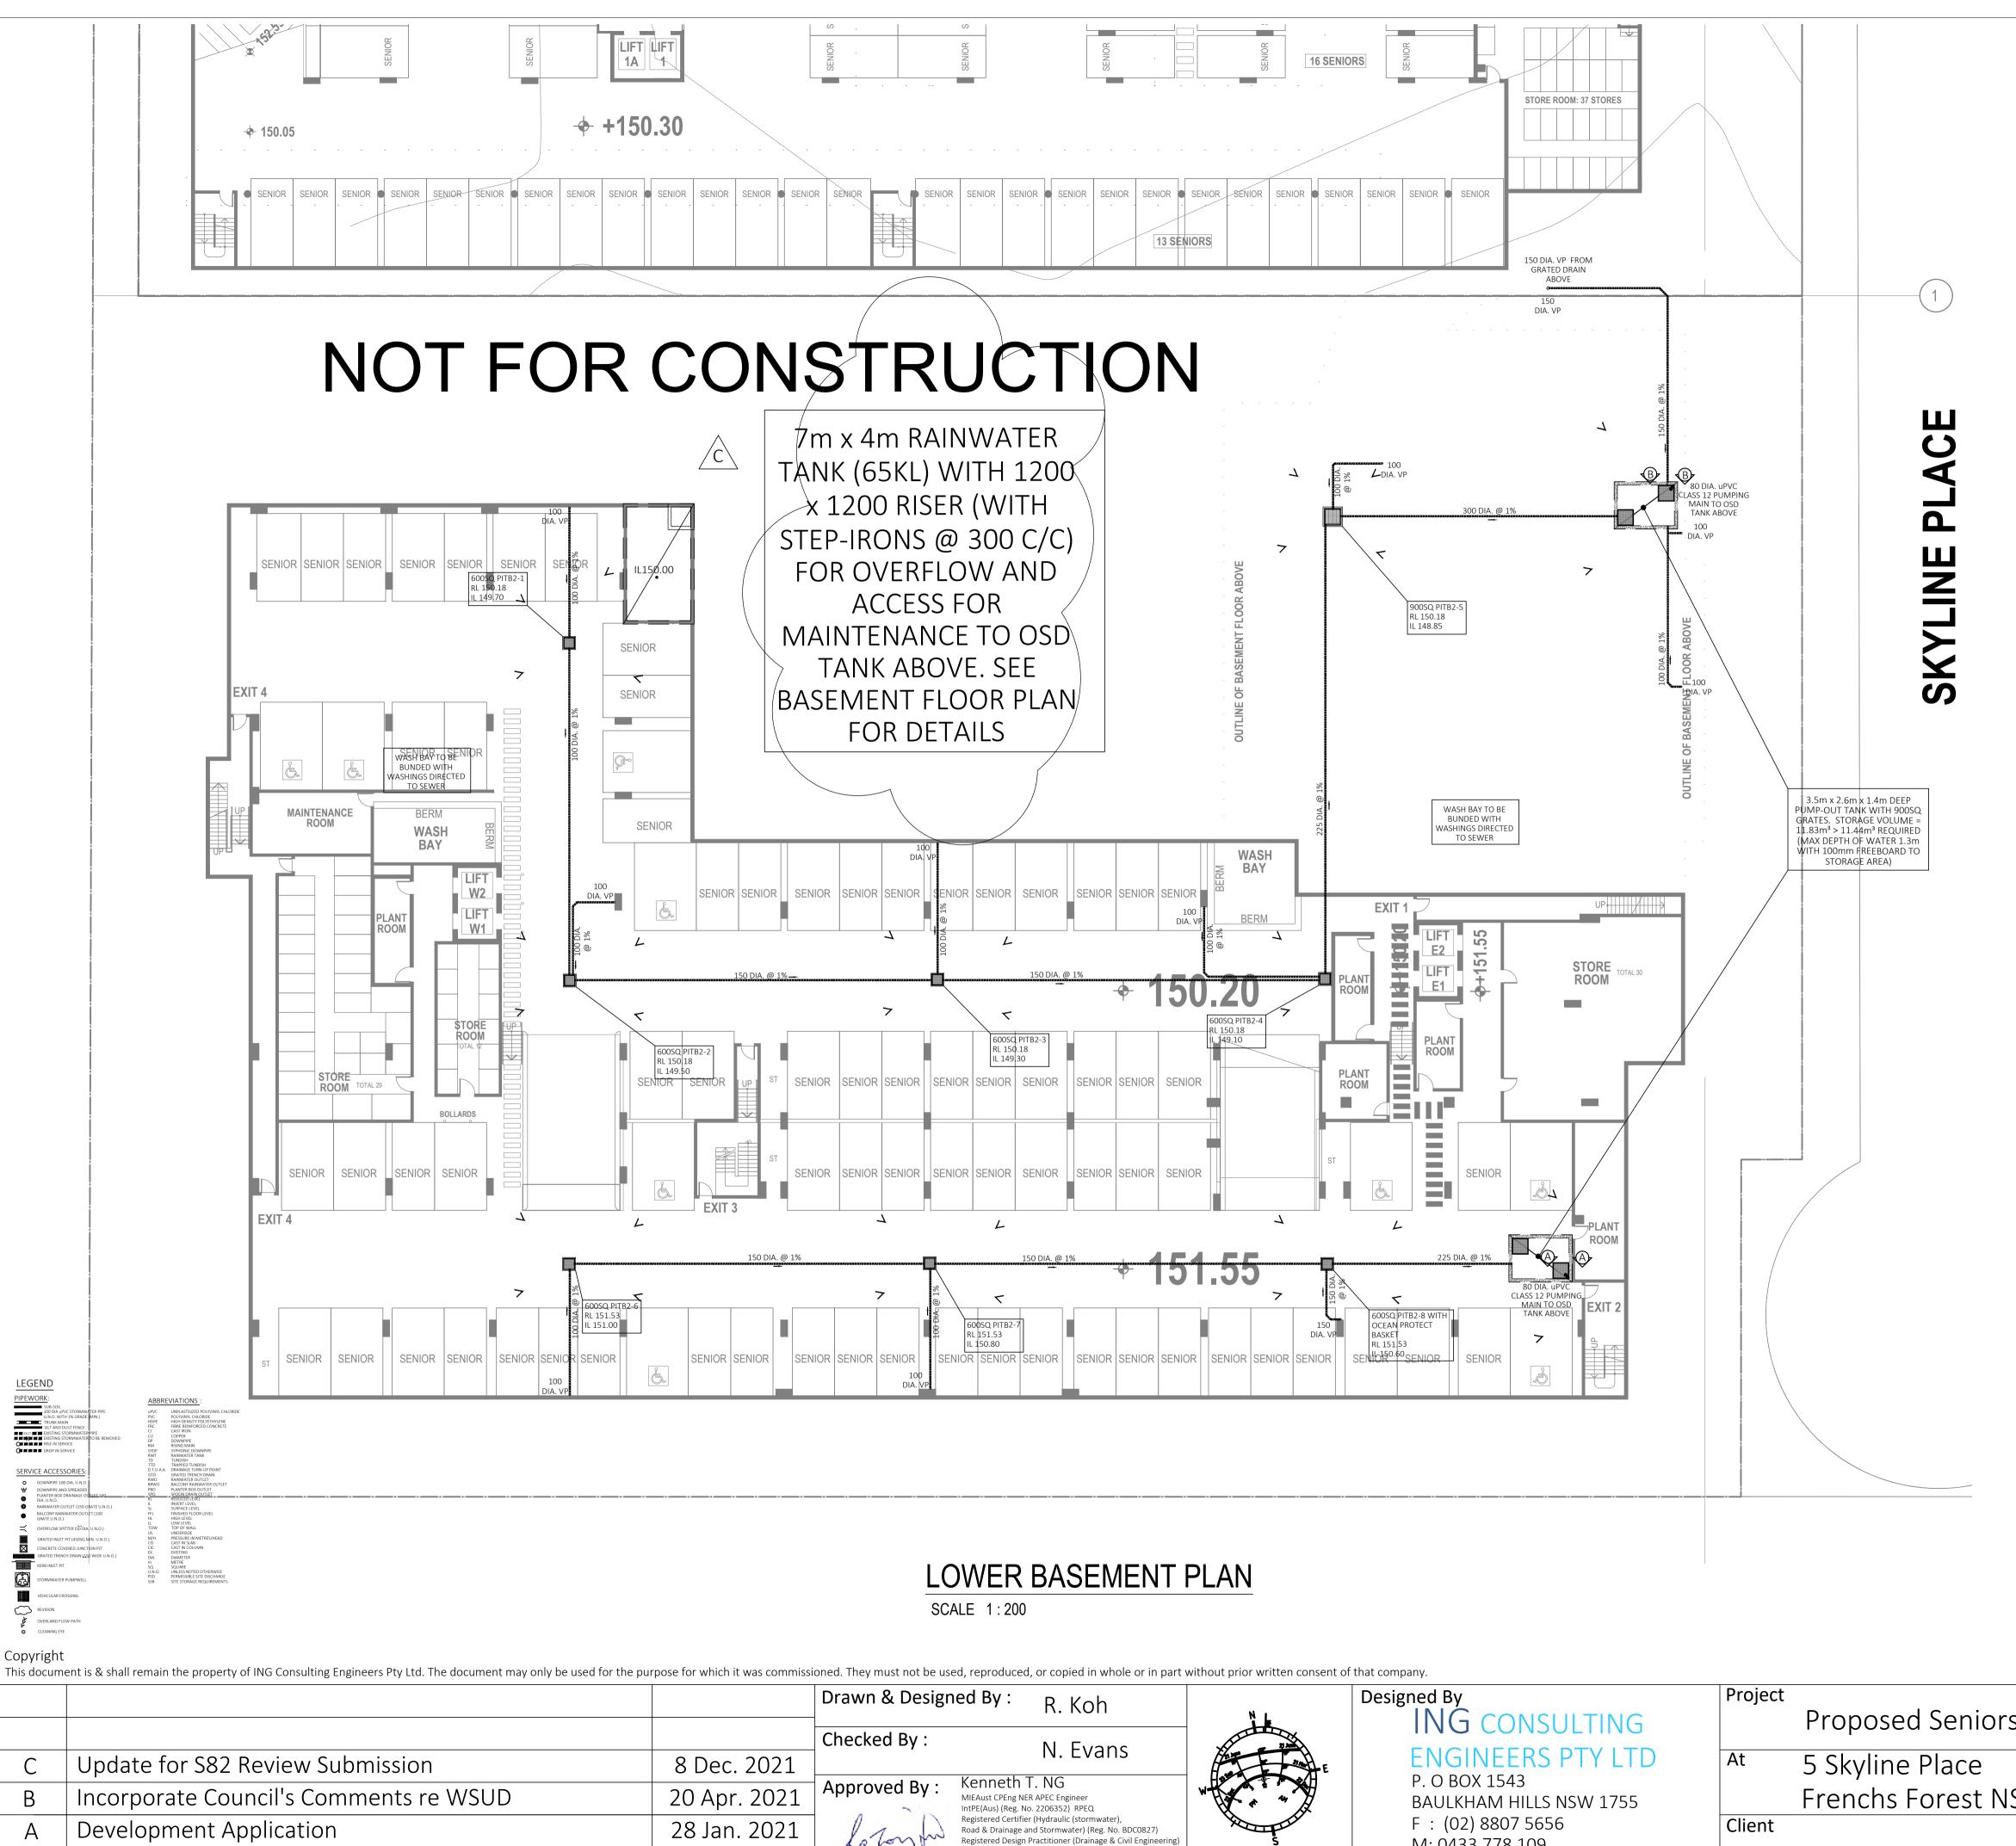

Date of Drawing


Description

lssue

Proposed Seniors Living (Stage 2) Frenchs Forest NSW 2086 M: 0433 778 109 (Reg. No. DEP0000692 & Professional Engineer (Civil) (Reg. No. DEP0000630) E : ken@ingengineers.com.au NSW Fair Trading

DWK.0.6.80.22.5.0D.R



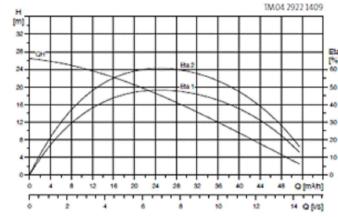


3 × 390 - 415 V 50

> Technical Information

	3 X 380 - 415 V, 50 HZ
Part Number	96922727
Maximum shut off head	26.5 m
Flow head @ BEP	18 L/s @ 7.1 m
Maximum flow @ low head	14.3 L/s @ 2.5 m
Pump power rating	2.2 kW
Full load current	5.1 A
Outlet size	3" / 80 mm Hose tail
Pump weight	45 kg
Can operate partially submerged	No
Cooling jacket included / material	No / NA
Motor enclosure material	Cast iron GG20
Pump casing material	Cast iron GG20
Impeller type & material	Open style high chrome stainless stee
Free passage size solids	6 mm
Mechanical seal configuration and materials	Double in oil bath Pump side – silicon carbide Motor side – silicon carbide
Strainer material	400 Stainless steel
Cable length	10 m
Insulation protection	Class F / IP68
Liquid temperature range	0 °C to 40 °C
Aluminium present in pump	Yes






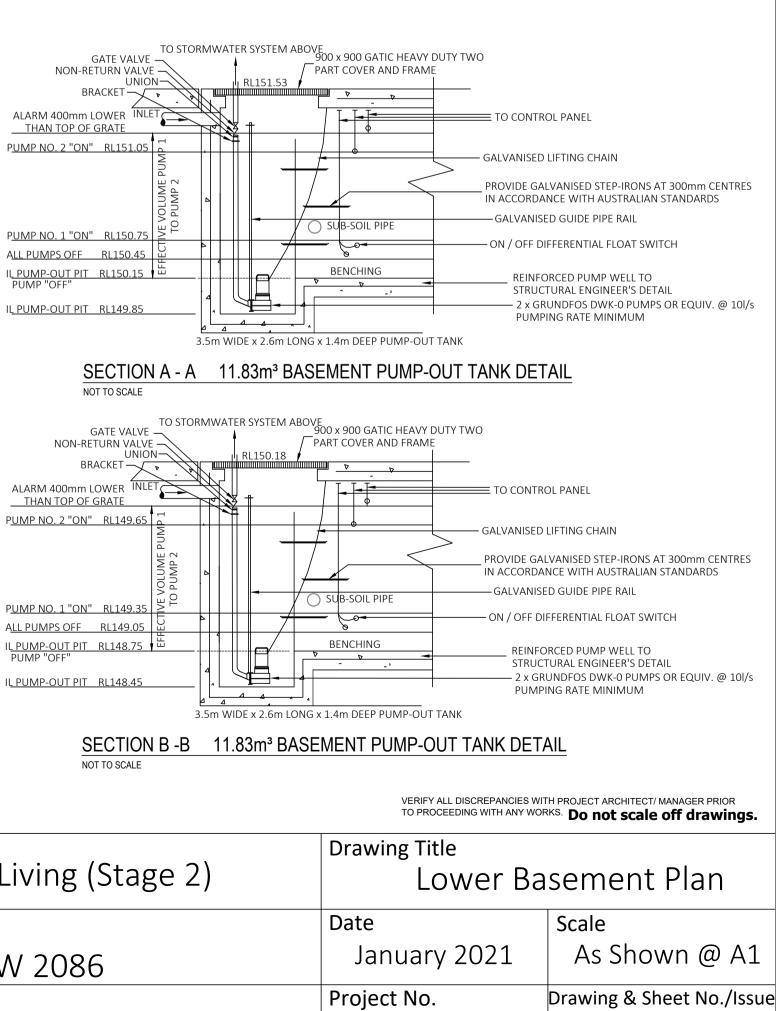

284012021DA

28401-03/18 / C

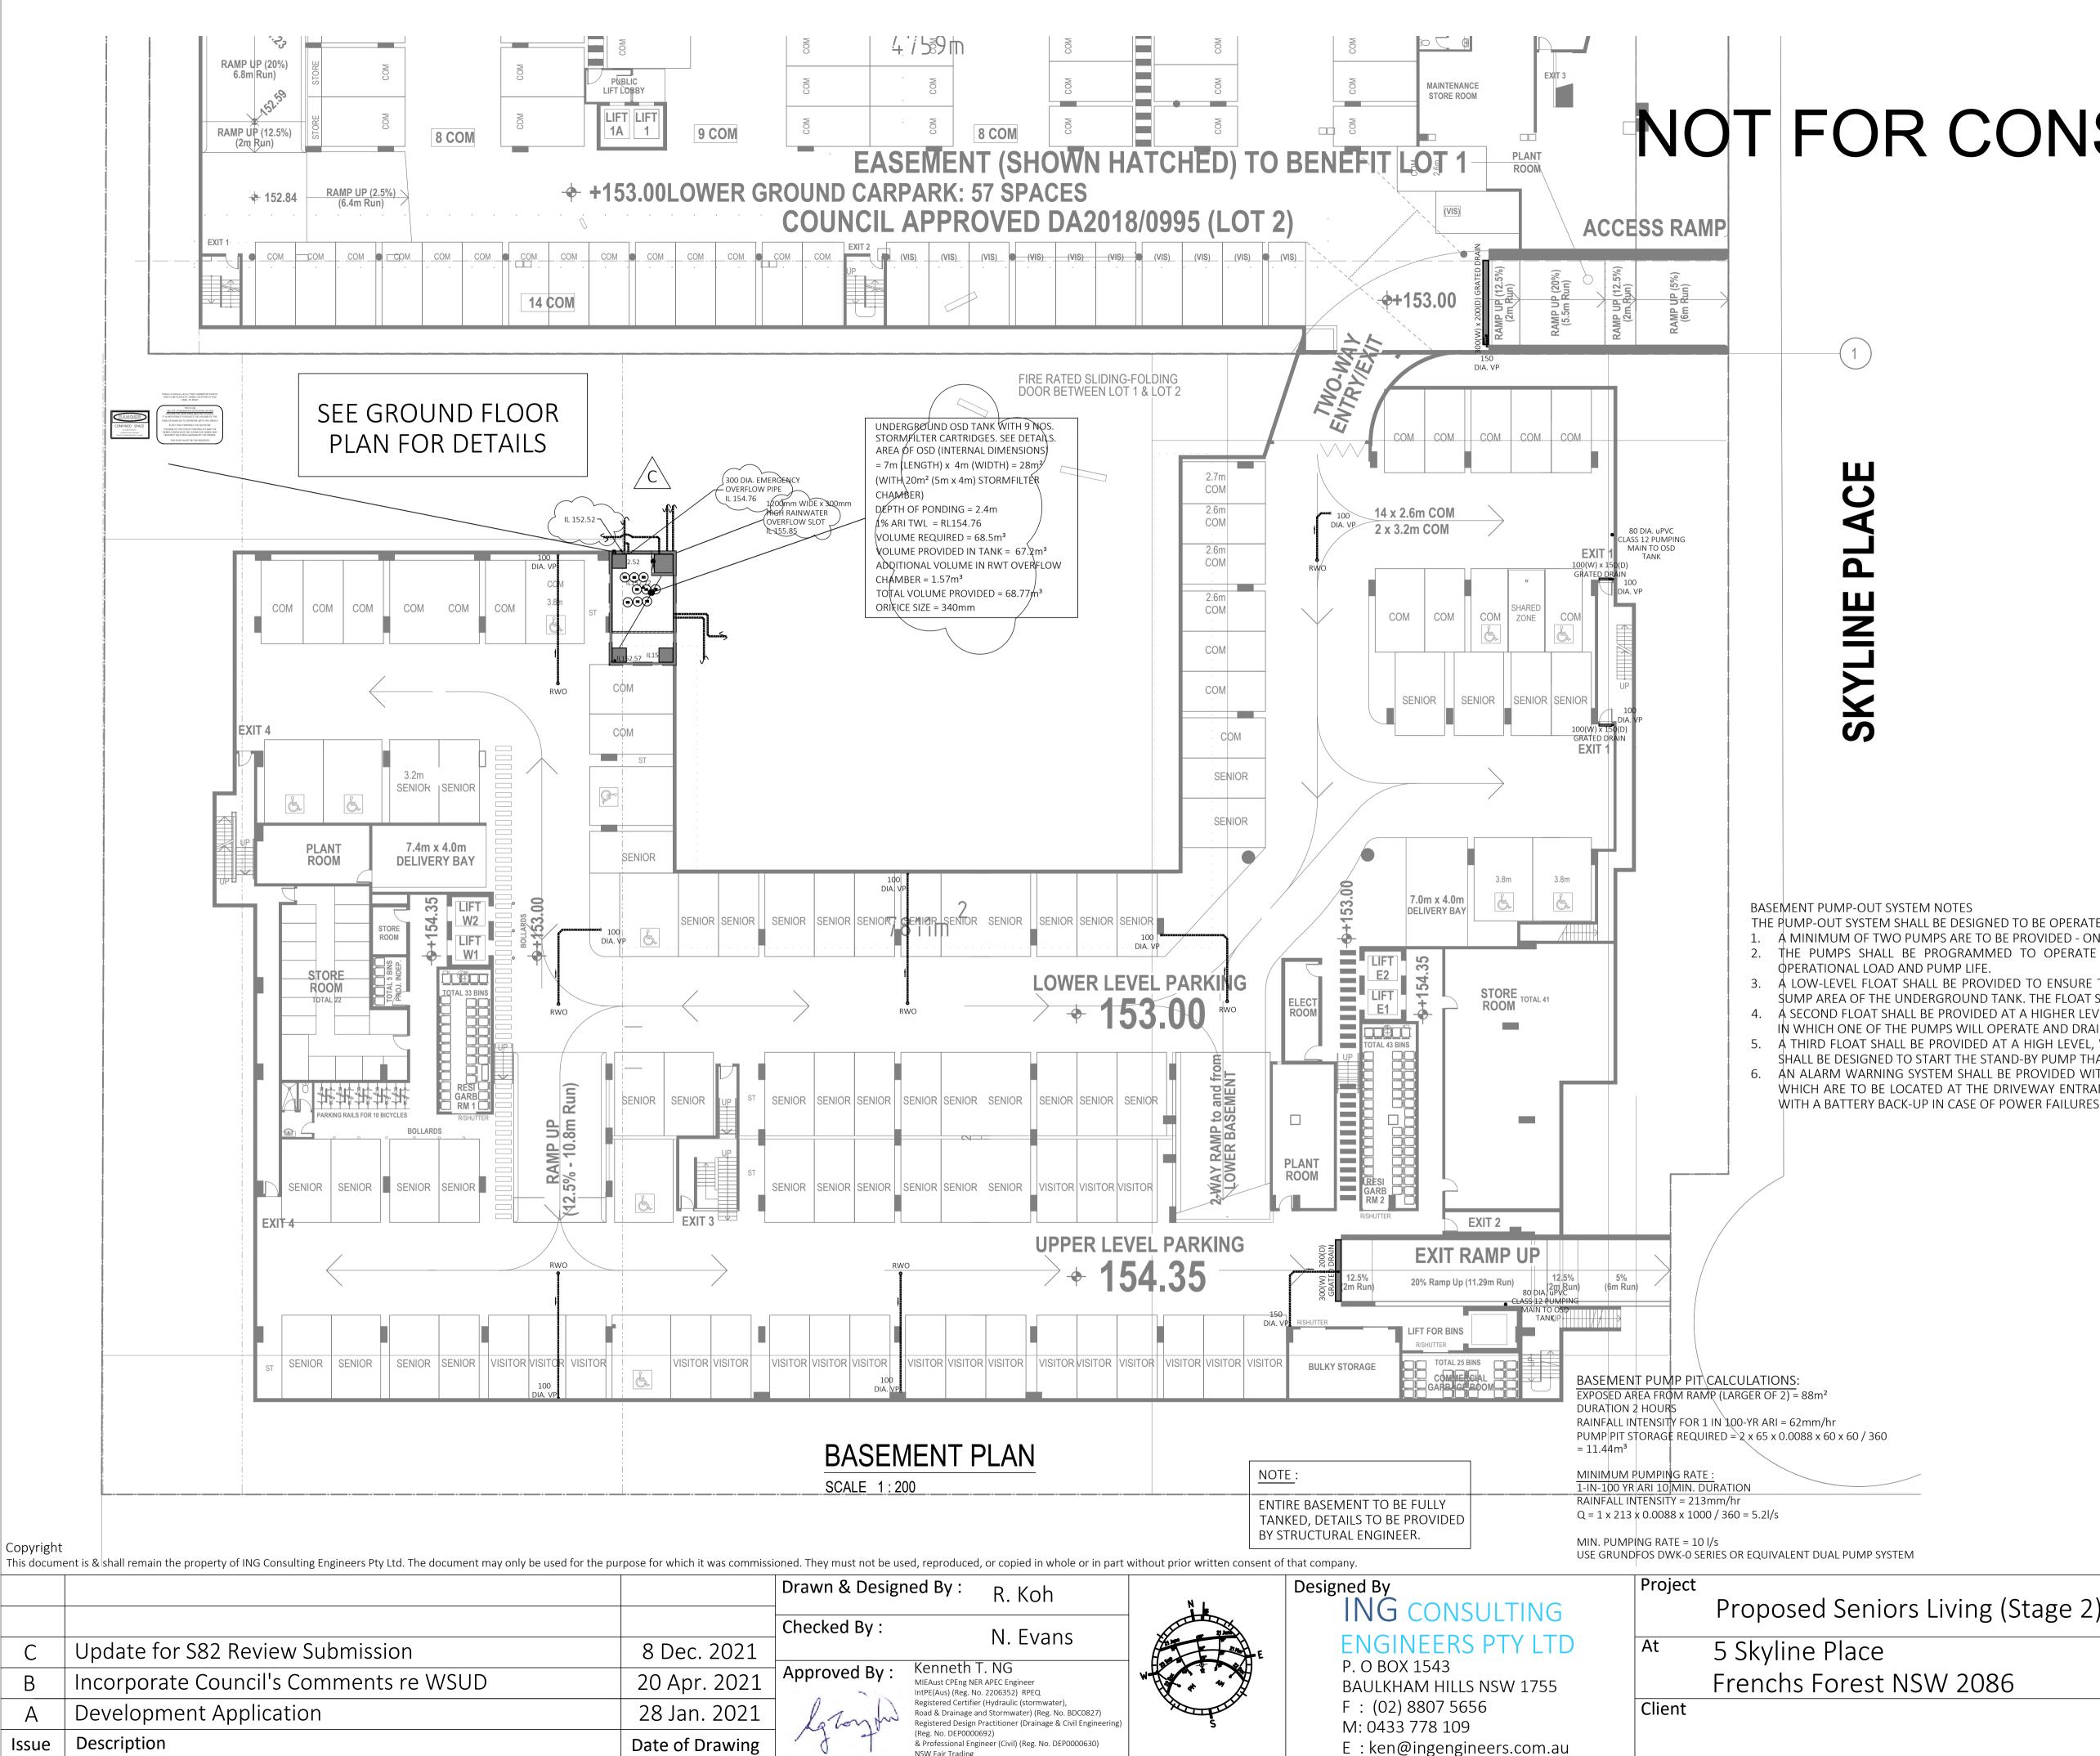


lssue

С

В

NSW Fair Trading

NOT FOR CONSTRUCTION

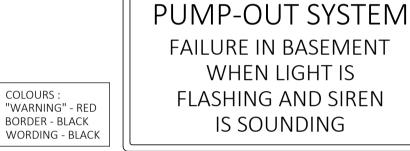

BASEMENT PUMP-OUT FAILURE WARNING SIGN NOT TO SCALE

WARNING

WHEN LIGHT IS

IS SOUNDING

THE PUMP-OUT SYSTEM SHALL BE DESIGNED TO BE OPERATED AS FOLLOWS :

A MINIMUM OF TWO PUMPS ARE TO BE PROVIDED - ONE DUTY PUMP AND ONE STAND-BY PUMP.

2. THE PUMPS SHALL BE PROGRAMMED TO OPERATE ALTERNATIVELY SO AS TO ALLOW BOTH PUMPS TO HAVE AN EQUAL 3. A LOW-LEVEL FLOAT SHALL BE PROVIDED TO ENSURE THAT THE MINIMUM REQUIRED WATER LEVEL IS MAINTAINED WITHIN THE

SUMP AREA OF THE UNDERGROUND TANK. THE FLOAT SHALL FUNCTION AS AN "OFF" SWITCH FOR THE PUMP. 4. A SECOND FLOAT SHALL BE PROVIDED AT A HIGHER LEVEL, WHICH IS APPROXIMATELY 200mm ABOVE THE MINIMUM WATER LEVEL, IN WHICH ONE OF THE PUMPS WILL OPERATE AND DRAIN THE UNDERGROUND TANK TO THE LEVEL OF THE LOW-LEVEL FLOAT.

5. A THIRD FLOAT SHALL BE PROVIDED AT A HIGH LEVEL, WHICH IS APPROXIMATELY 200mm ABOVE THE SECOND FLOAT. THIS FLOAT SHALL BE DESIGNED TO START THE STAND-BY PUMP THAT IS NOT OPERATING AND ACTIVATE THE ALARM. 6. AN ALARM WARNING SYSTEM SHALL BE PROVIDED WITH A FLASHING STROBE LIGHT, SIREN AND A PUMP FAILURE WARNING SIGN

WHICH ARE TO BE LOCATED AT THE DRIVEWAY ENTRANCE TO TH BASEMENT. THE ALARM WARNING SYSTEM SHALL BE PROVIDED



iving (Stage 2)	Drawing Title Basement Plan		
V 2086	Date January 2021	Scale As Shown @ A1	
	Project No.	Drawing & Sheet No./Issue	
	284012021DA	28401-04/18/ C	


DRAINS results prepar PIT / NODE DETAILS	red from Version 20	21.02	V	ersion 8			
Name Overflow Pit-1	Max HGL 150.67	Max Pond HGL	Max Surface Flow Arriving (cu.m/s) 0	Max Pond Volume (cu.m)	Min Freeboard (m) 5.23	Overflow (cu.m/s)	
Overflow Pit-2 KIP	148.72 147.19		0		1.28		None
SUB-CATCHMENT DE	TAILS						
Name Lot1-Post (ex bypa	Max Flow Q (cu.m/s) 0.483	Paved Max Q (cu.m/s) 0.349	Grassed Max Q (cu.m/s) 0.134	Paved Tc (min) 5	Grassed Tc (min) 5	Supp. Tc (min) 0	Due to Stor 1% AEP, 5
Bypass Area	0.016	0	0.016	5	5	5	1% AEP, 1
Lot1-Pre	0.447	0	0.447	5	5	0	1% AEP, 1
PIPE DETAILS Name	Max Q	Max V	Max U/S	Max D/S	Due to Storm		
Maine	Max Q						
Pipe 3	(cu.m/s) 0.349	(m/s) 2.98	HGL (m) 154.119	HGL (m) 150.666	1% AEP, 10 min burs	st, Storm 7	
Pipe 2 Pipe 1	0.349 0.349	2.98 6.29	149.989 148.379	148.723 147.185	1% AEP, 10 min burs 1% AEP, 10 min burs	•	
CHANNEL DETAILS Name	Max Q	Max V			Due to Storm		
	(cu.m/s)	(m/s)					
OVERFLOW ROUTE I	DETAILS						
Name OF	Max Q U/S 0	Max Q D/S 0	Safe Q 1.479	Max D 0	Max DxV 0	Max Width 0	Max ∨ 0
DETENTION BASIN DI	ETAILS						
Name	Max WL	MaxVol	Max Q Total	Max Q Low Level	Max Q High Level		
OSD	154.76	68.5	0.349	0.349	0		
Run Log for Stage 2 r	in at 10.57.27 on 1	0/12/2021 using vers	sion 2021 02				

Run Log for Stage 2 run at 10:57:27 on 10/12/2021 using version 2021.02

No water upwelling from any pit. Freeboard was adequate at all pits. Flows were safe in all overflow routes.


DRAINS MODELLING RESULTS

NOT TO SCALE

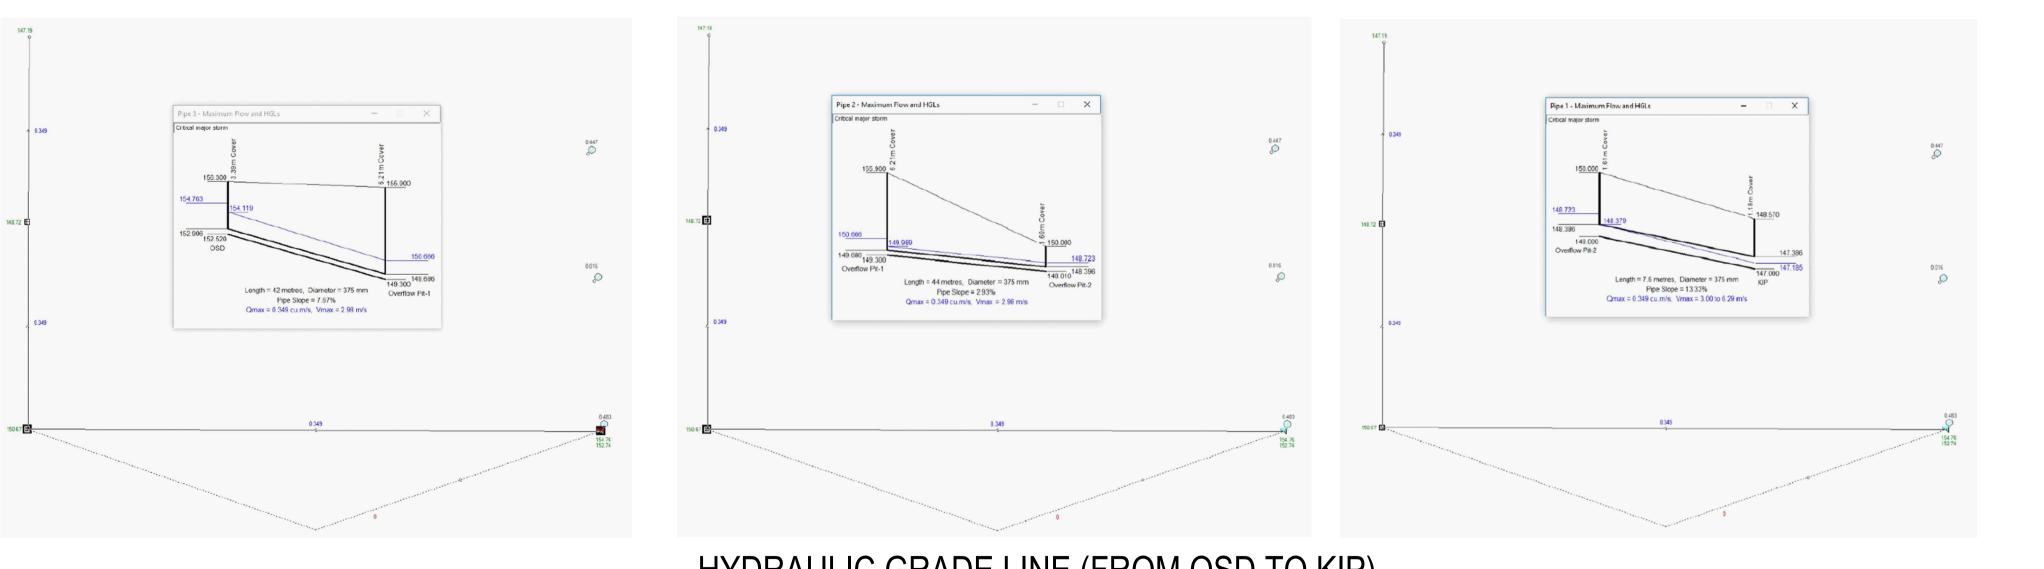

Copyright

			Drawn & Designed	d By :
			Checked By :	
С	Update for S82 Review Submission	8 Dec. 2021		<u></u>
В	Incorporate Council's Comments re WSUD	20 Apr. 2021		Kennet MIEAust CPEn ntPE(Aus) (Re
А	Development Application	28 Jan. 2021	Ro	Registered Ce Road & Draina Registered De
Issue	Description	Date of Drawing		Reg. No. DEP(& Professional NSW Fair Trad

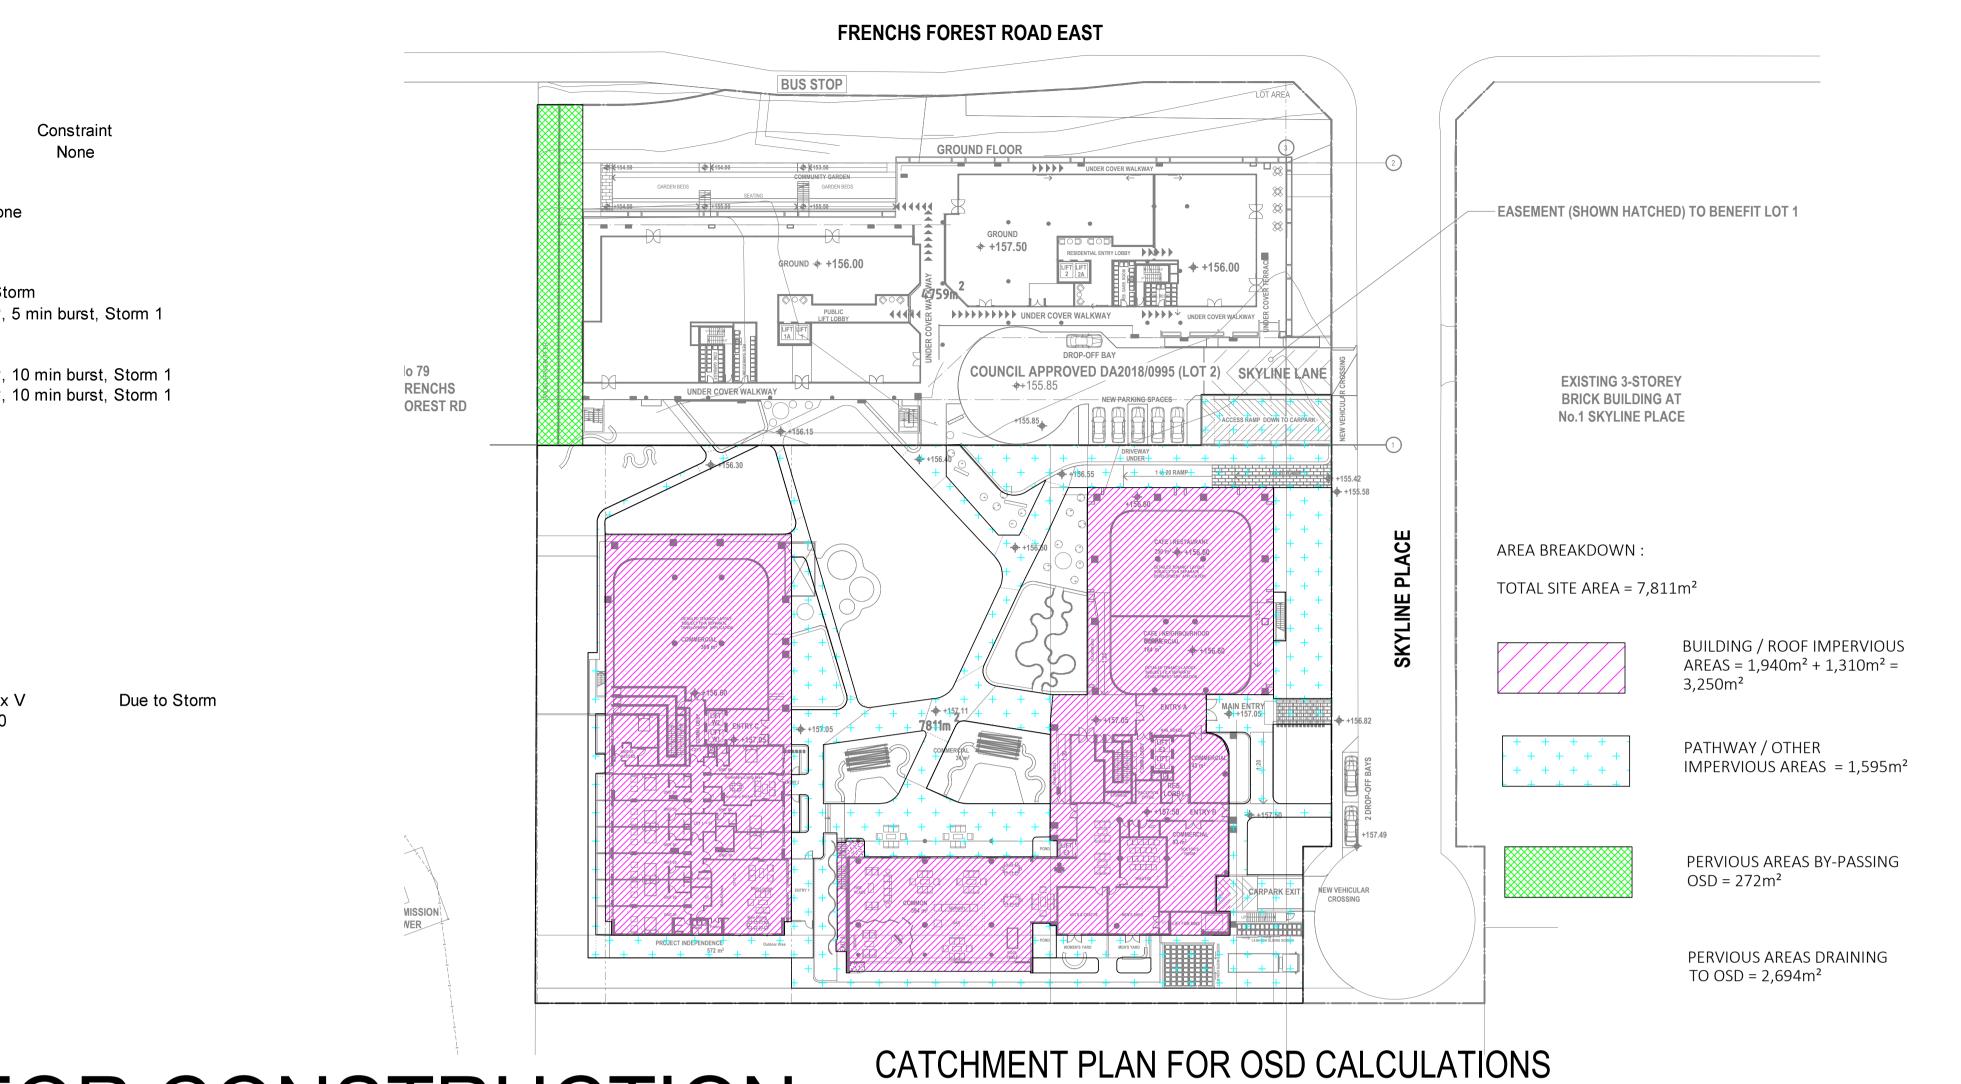

NOT FOR CONSTRUCTION

SCALE 1:500


HYDRAULIC GRADE LINE (FROM OSD TO KIP)

NOT TO SCALE


uced, or copied in whole or in part without prior written consent of that company.



	•	
i_{1} i_{1} i_{2} f_{1} f_{2} f_{2	Drawing Title Catchment Plan &	
iving (Stage 2)	OSD Calculations	
	Date	Scale
V 2086	January 2021	As Shown @ A1
	Project No.	Drawing & Sheet No./Issue
	284012021DA	28401-05/18 / C

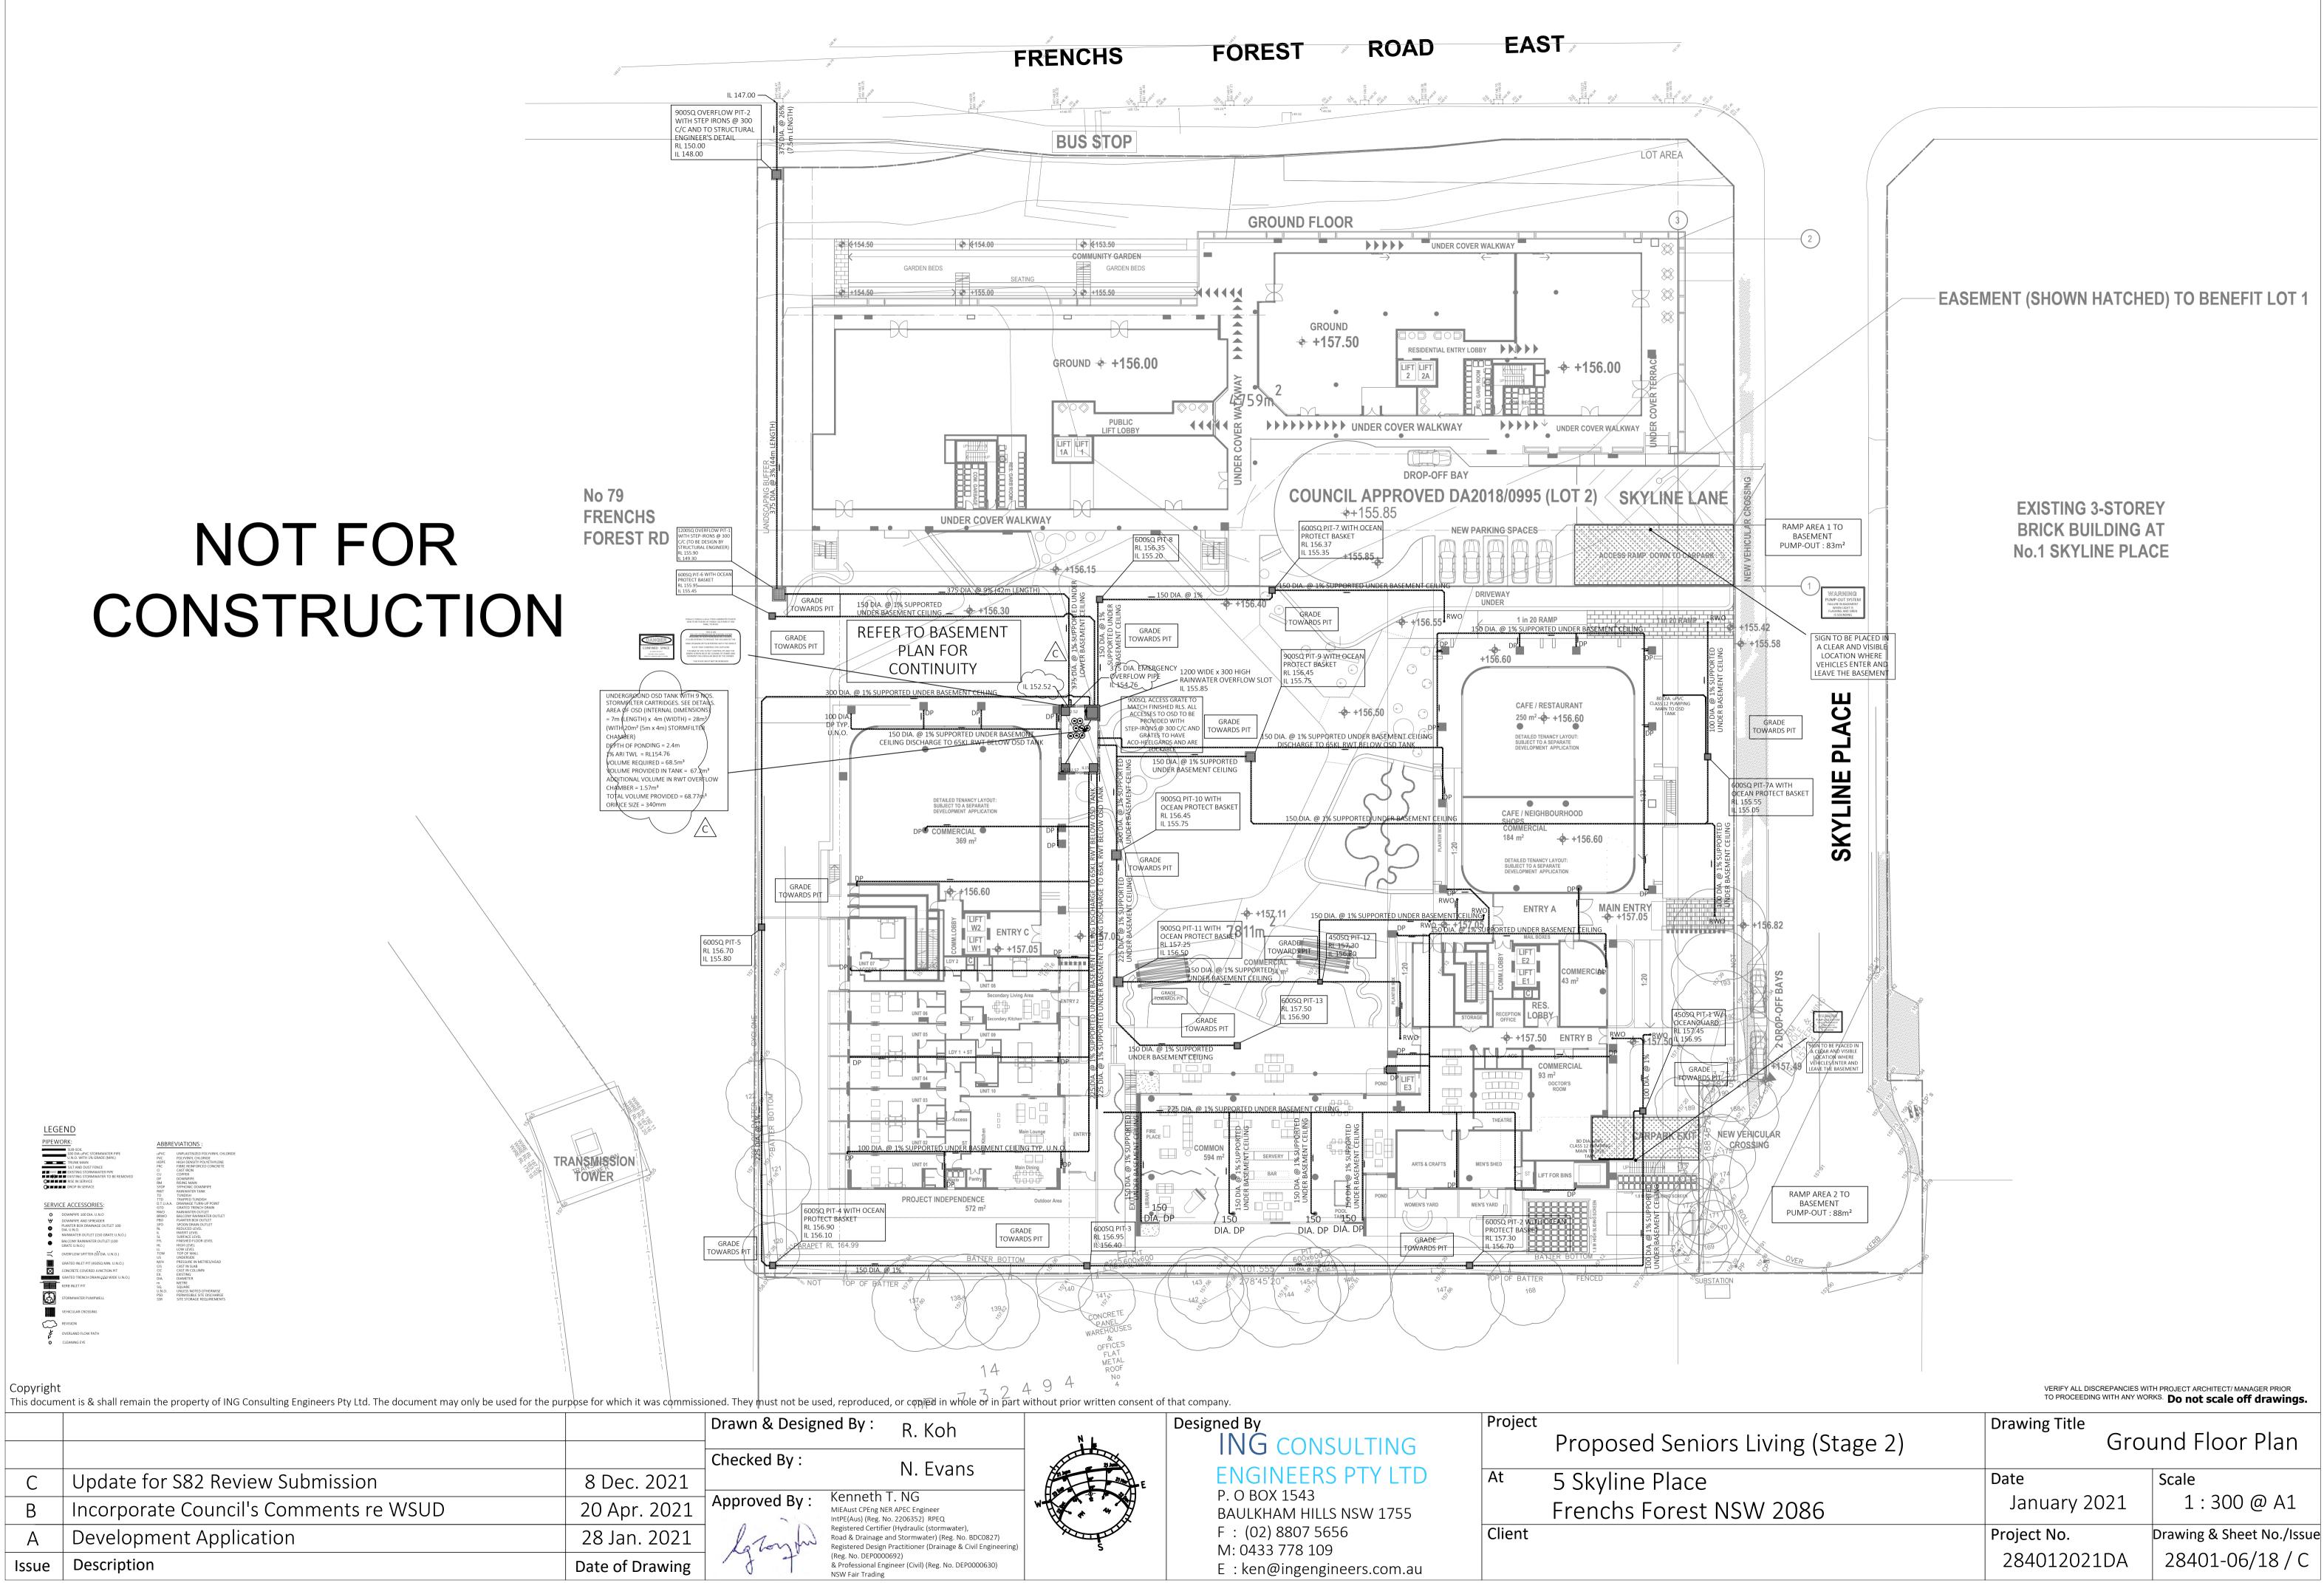


			-
			Checked By :
C	Update for S82 Review Submission	8 Dec. 2021	
В	Incorporate Council's Comments re WSUD	20 Apr. 2021	Approved By: Kennet MIEAust CPEng IntPE(Aus) (Reg
Α	Development Application	28 Jan. 2021	Registered Cer Road & Draina, Registered Des (Reg. No. DEPC
Issue	Description	Date of Drawing	(Reg. No. DEPC & Professional NSW Fair Tradi

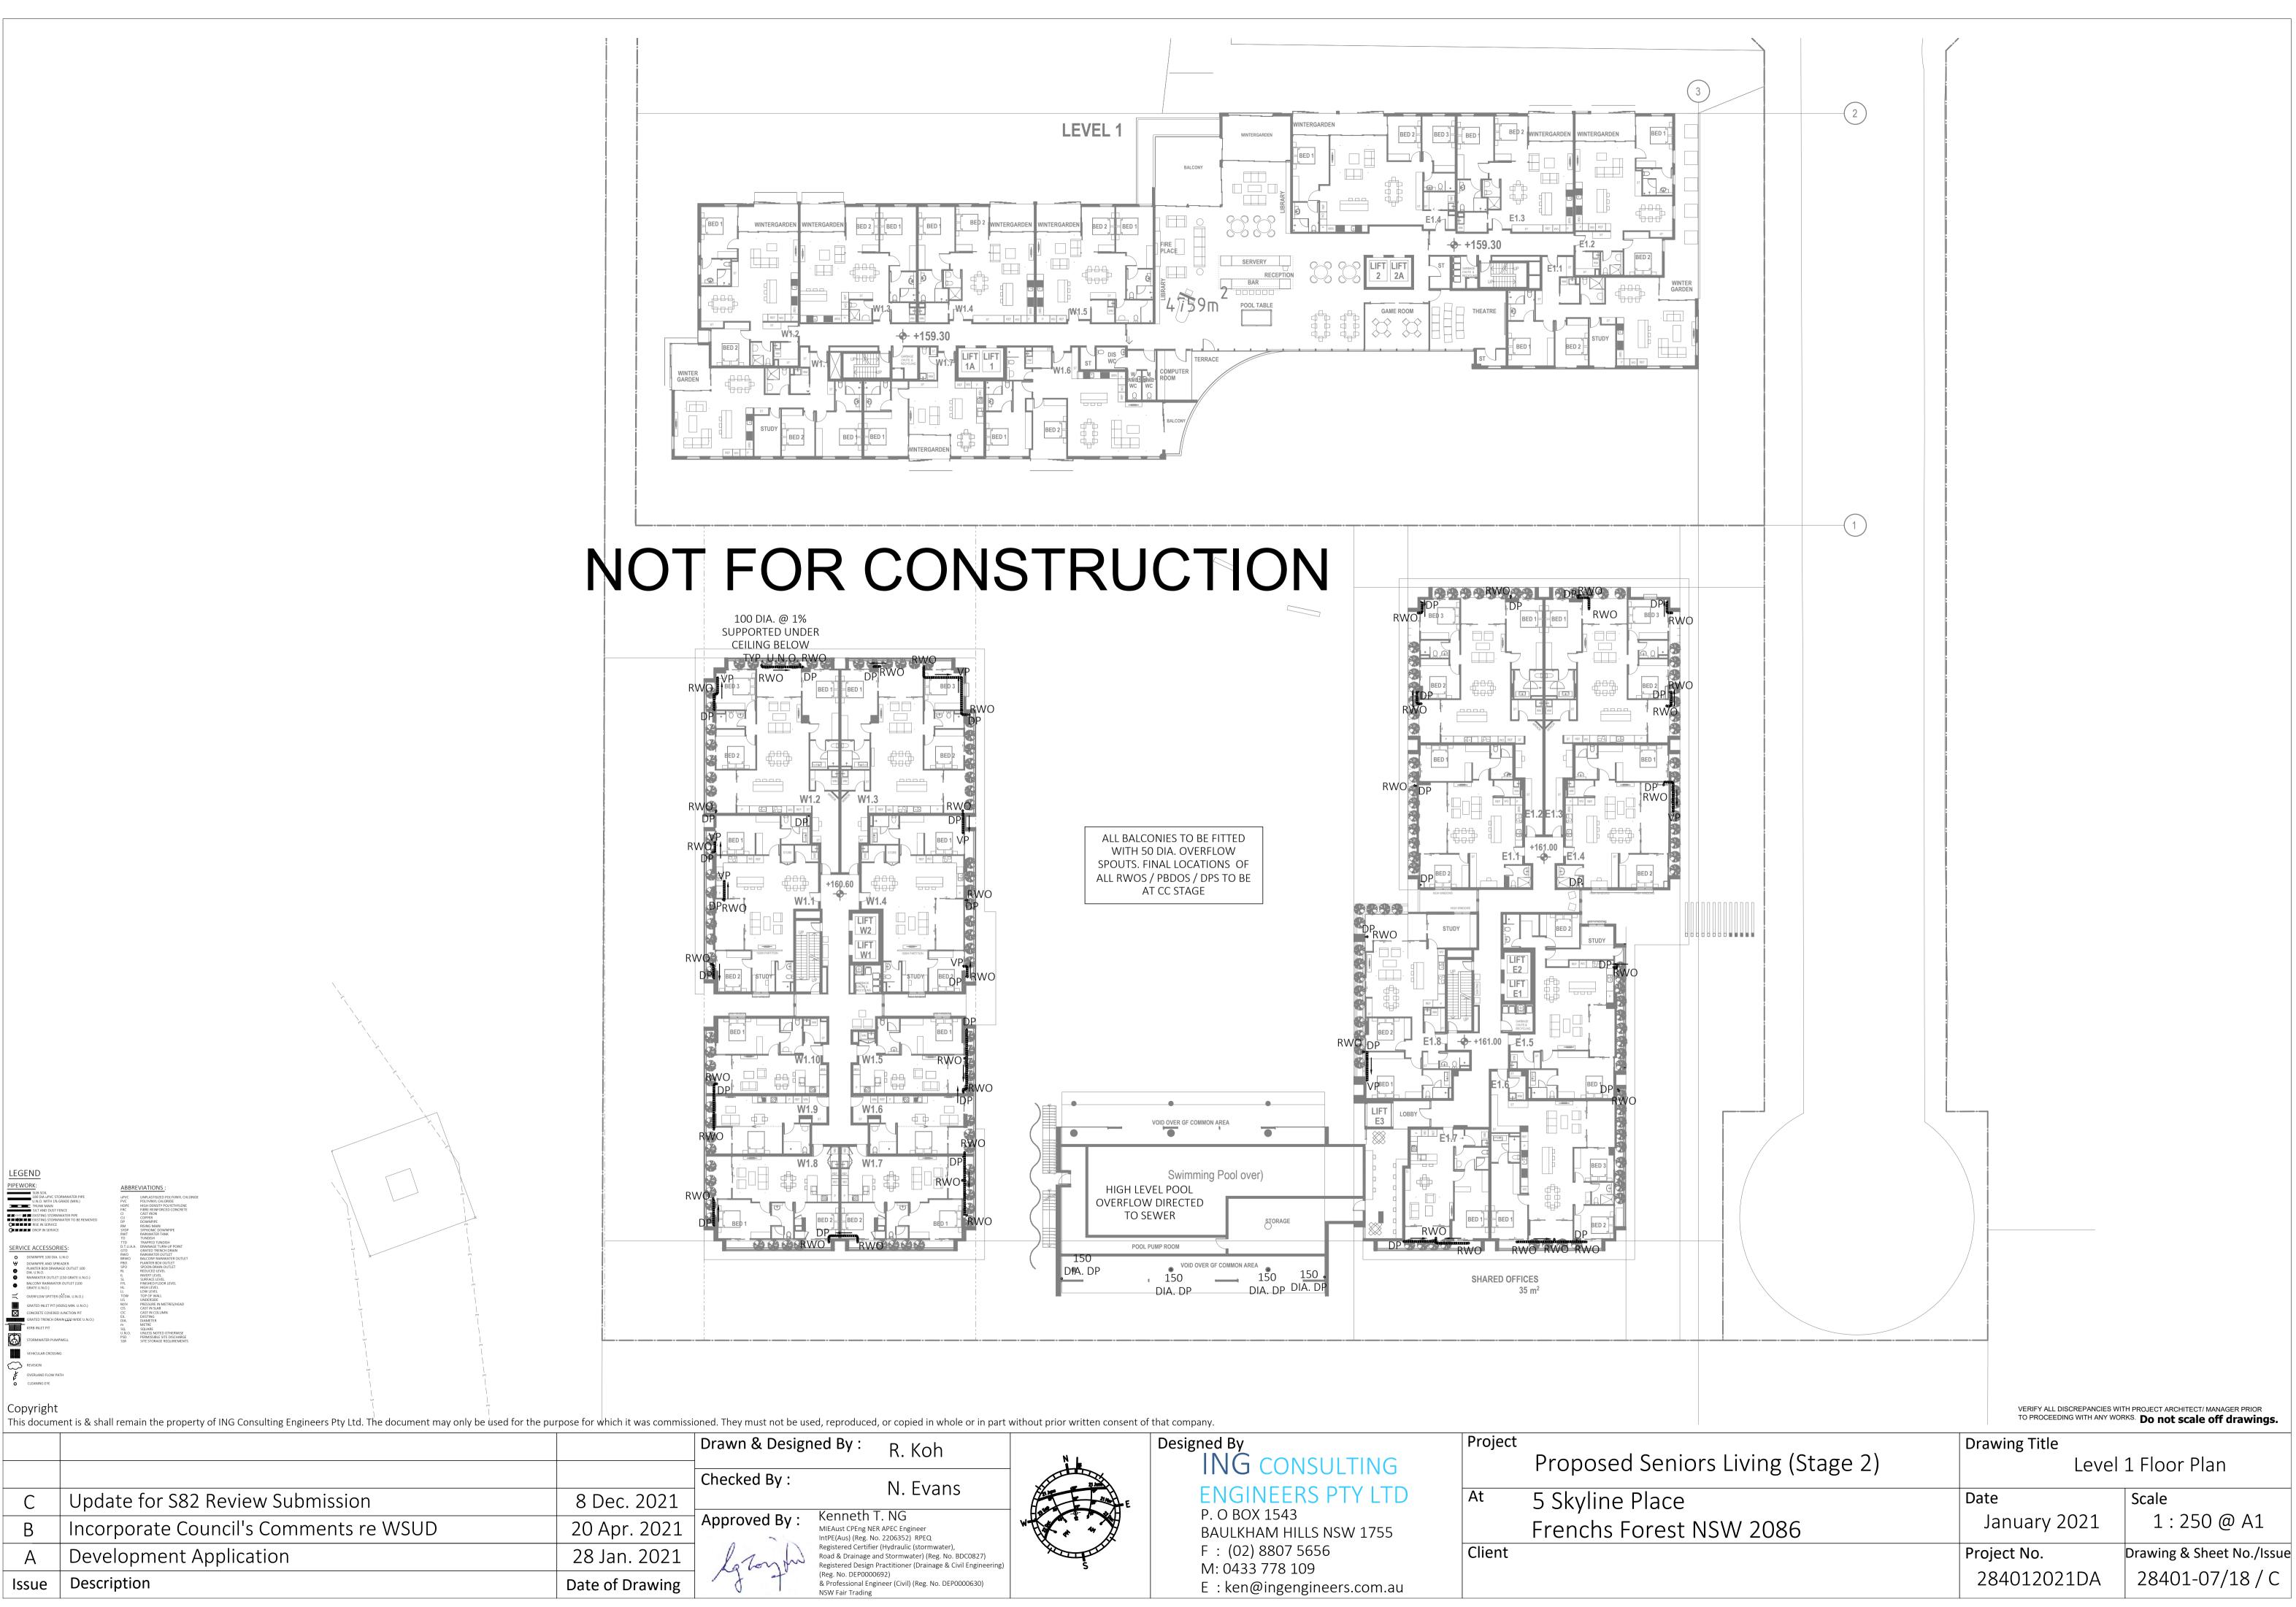

Copyright	


			Drawn & Desigr	ned By :
			Checked By :	
С	Update for S82 Review Submission	8 Dec. 2021		
В	Incorporate Council's Comments re WSUD	20 Apr. 2021	Approved By :	Kenneth MIEAust CPEng IntPE(Aus) (Reg.
А	Development Application	28 Jan. 2021	la Longin	Registered Certi Road & Drainag Registered Desig
lssue	Description	Date of Drawing	~J. +	(Reg. No. DEPOC & Professional E NSW Fair Tradin

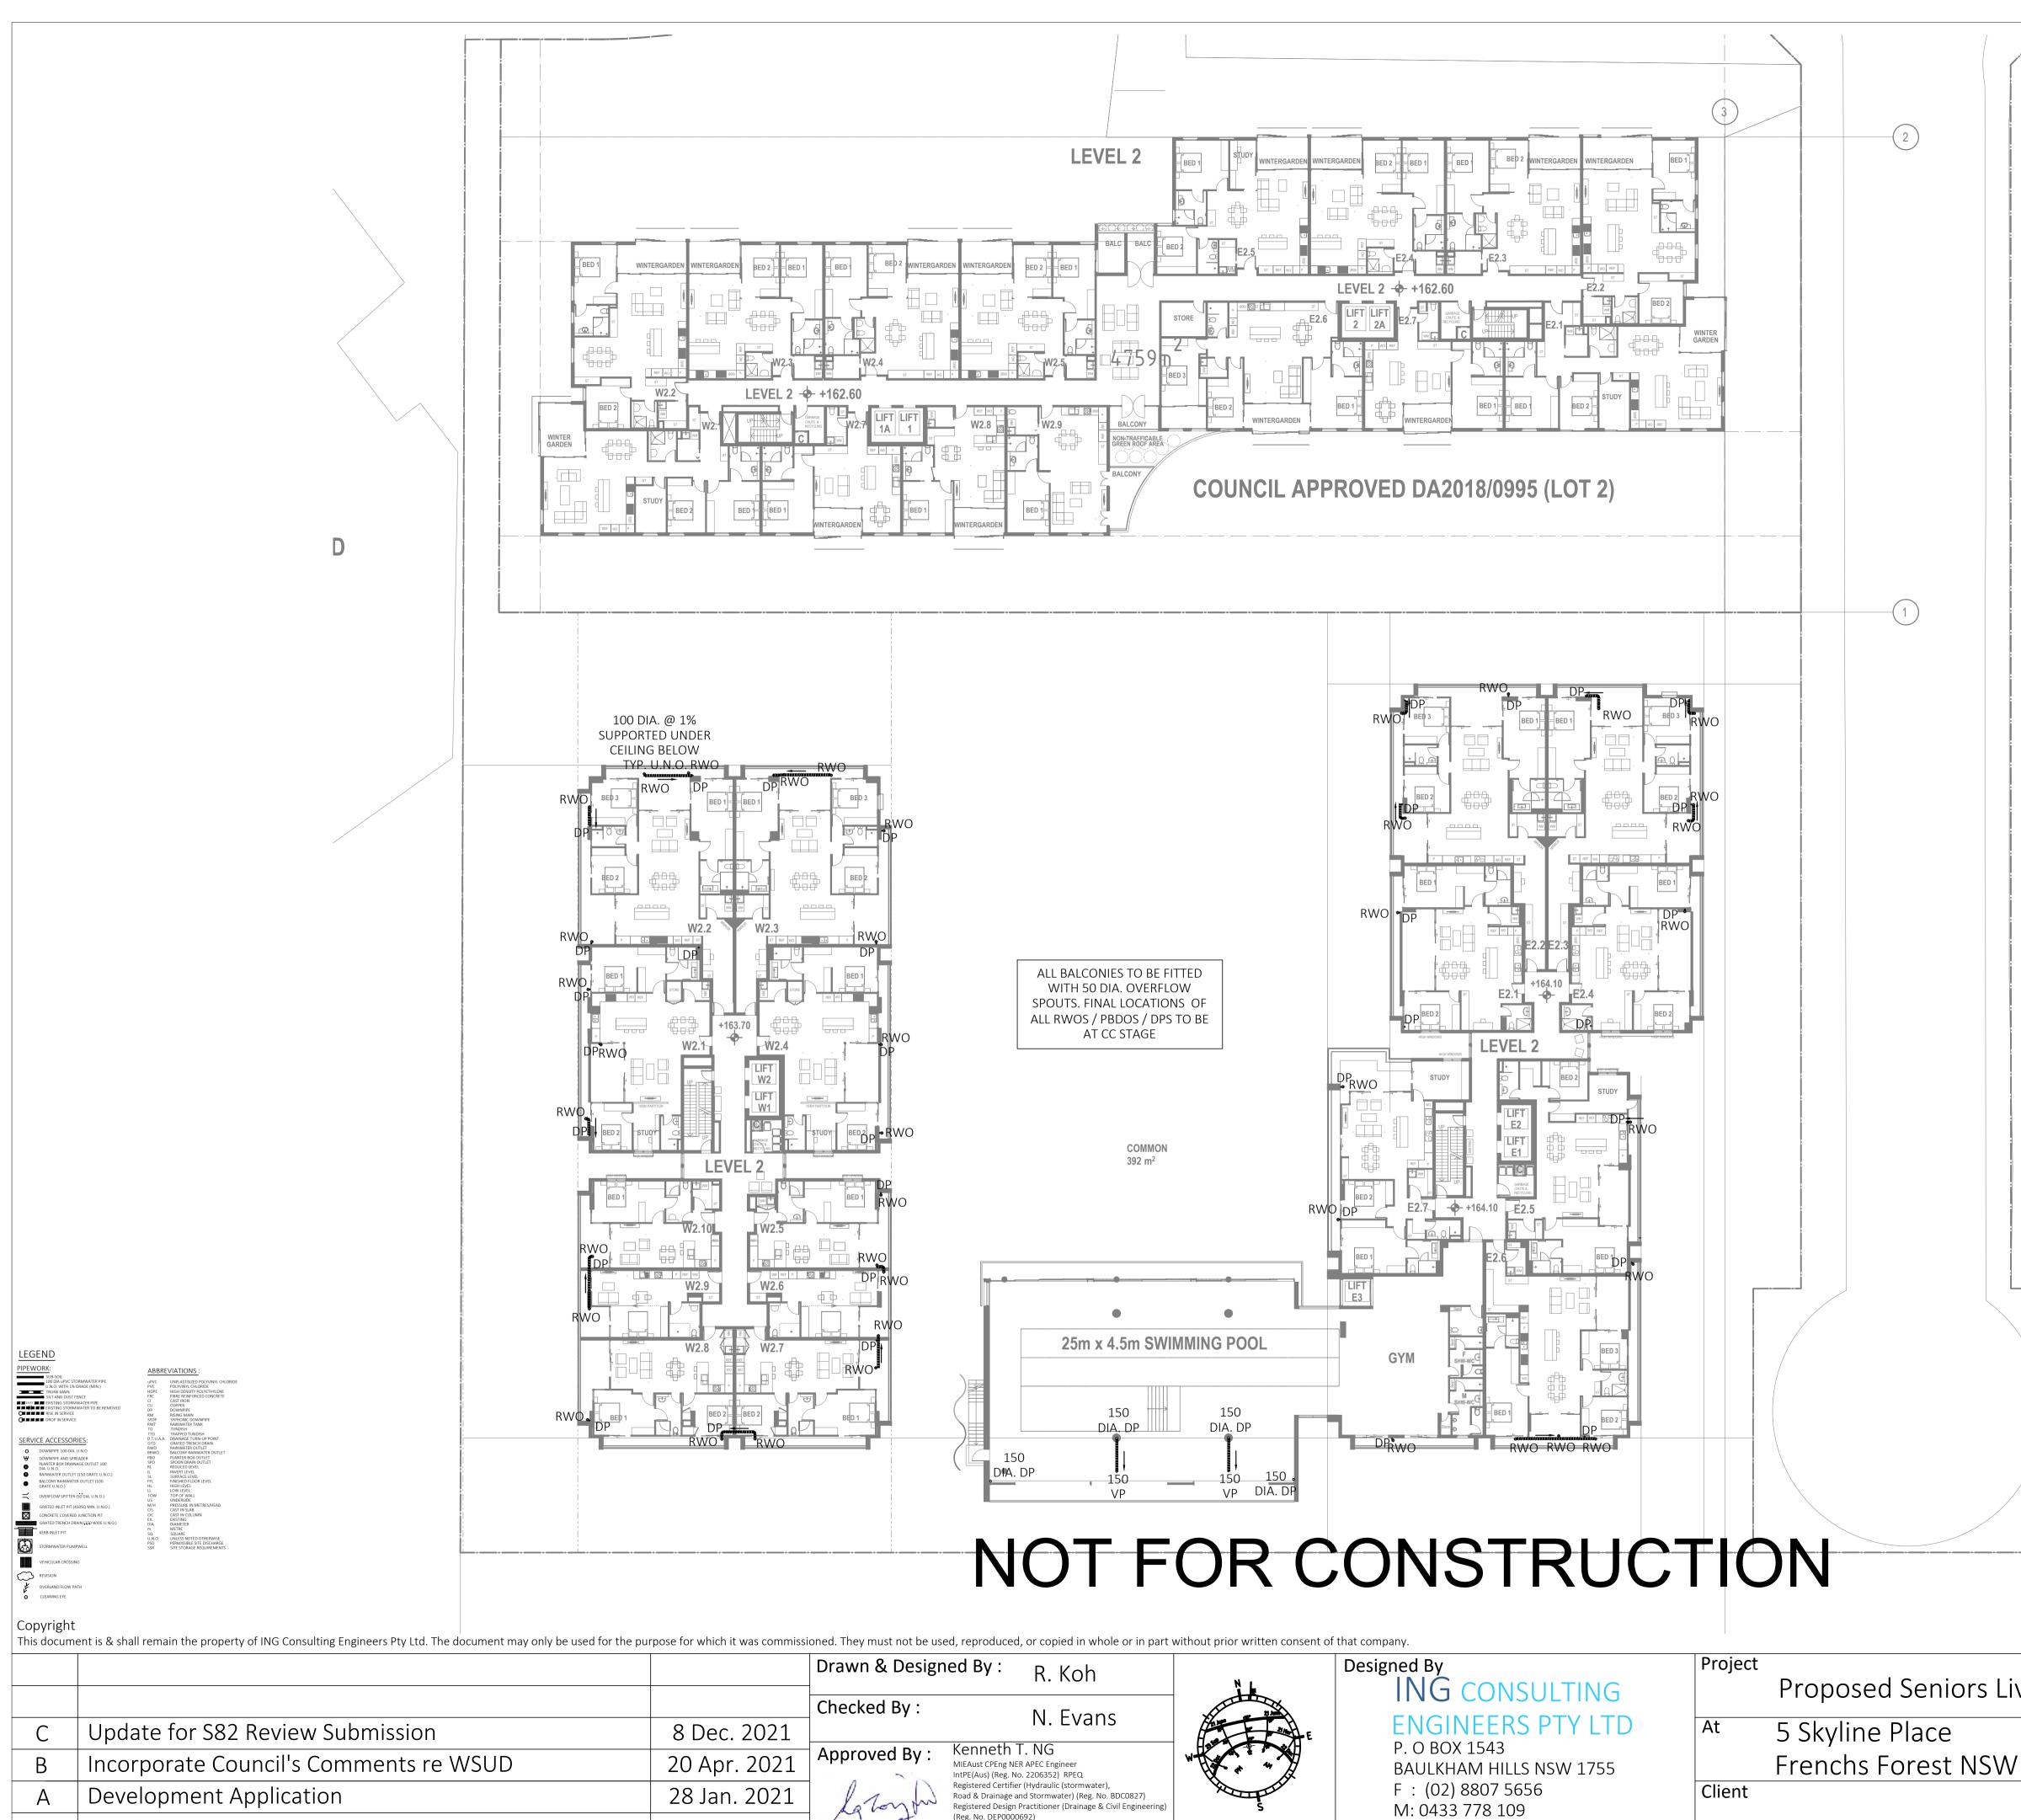

E : ken@ingengineers.com.au

			Drawn & Designed By : R. Koh	
			Checked By :	N. Evans
С	Update for S82 Review Submission	8 Dec. 2021		
В	Incorporate Council's Comments re WSUD	20 Apr. 2021	Approved By :	Kenneth T. NG MIEAust CPEng NER APEC Engineer IntPE(Aus) (Reg. No. 2206352) RPEQ
А	Development Application	28 Jan. 2021	La Tonto	Registered Certifier (Hydraulic (stormwater), Road & Drainage and Stormwater) (Reg. No. BDC0827) Registered Design Practitioner (Drainage & Civil Engineerin
Issue	Description	Date of Drawing	1 ~ 7 7	(Reg. No. DEP0000692) & Professional Engineer (Civil) (Reg. No. DEP0000630) NSW Fair Trading

	Drawing Title		
iving (Stage 2)	Level	2 Floor Plan	
	Date	Scale	
V 2086	January 2021	1 : 250 @ A1	
	Project No.	Drawing & Sheet No./Issue	
	284012021DA	28401-08/18 / C	

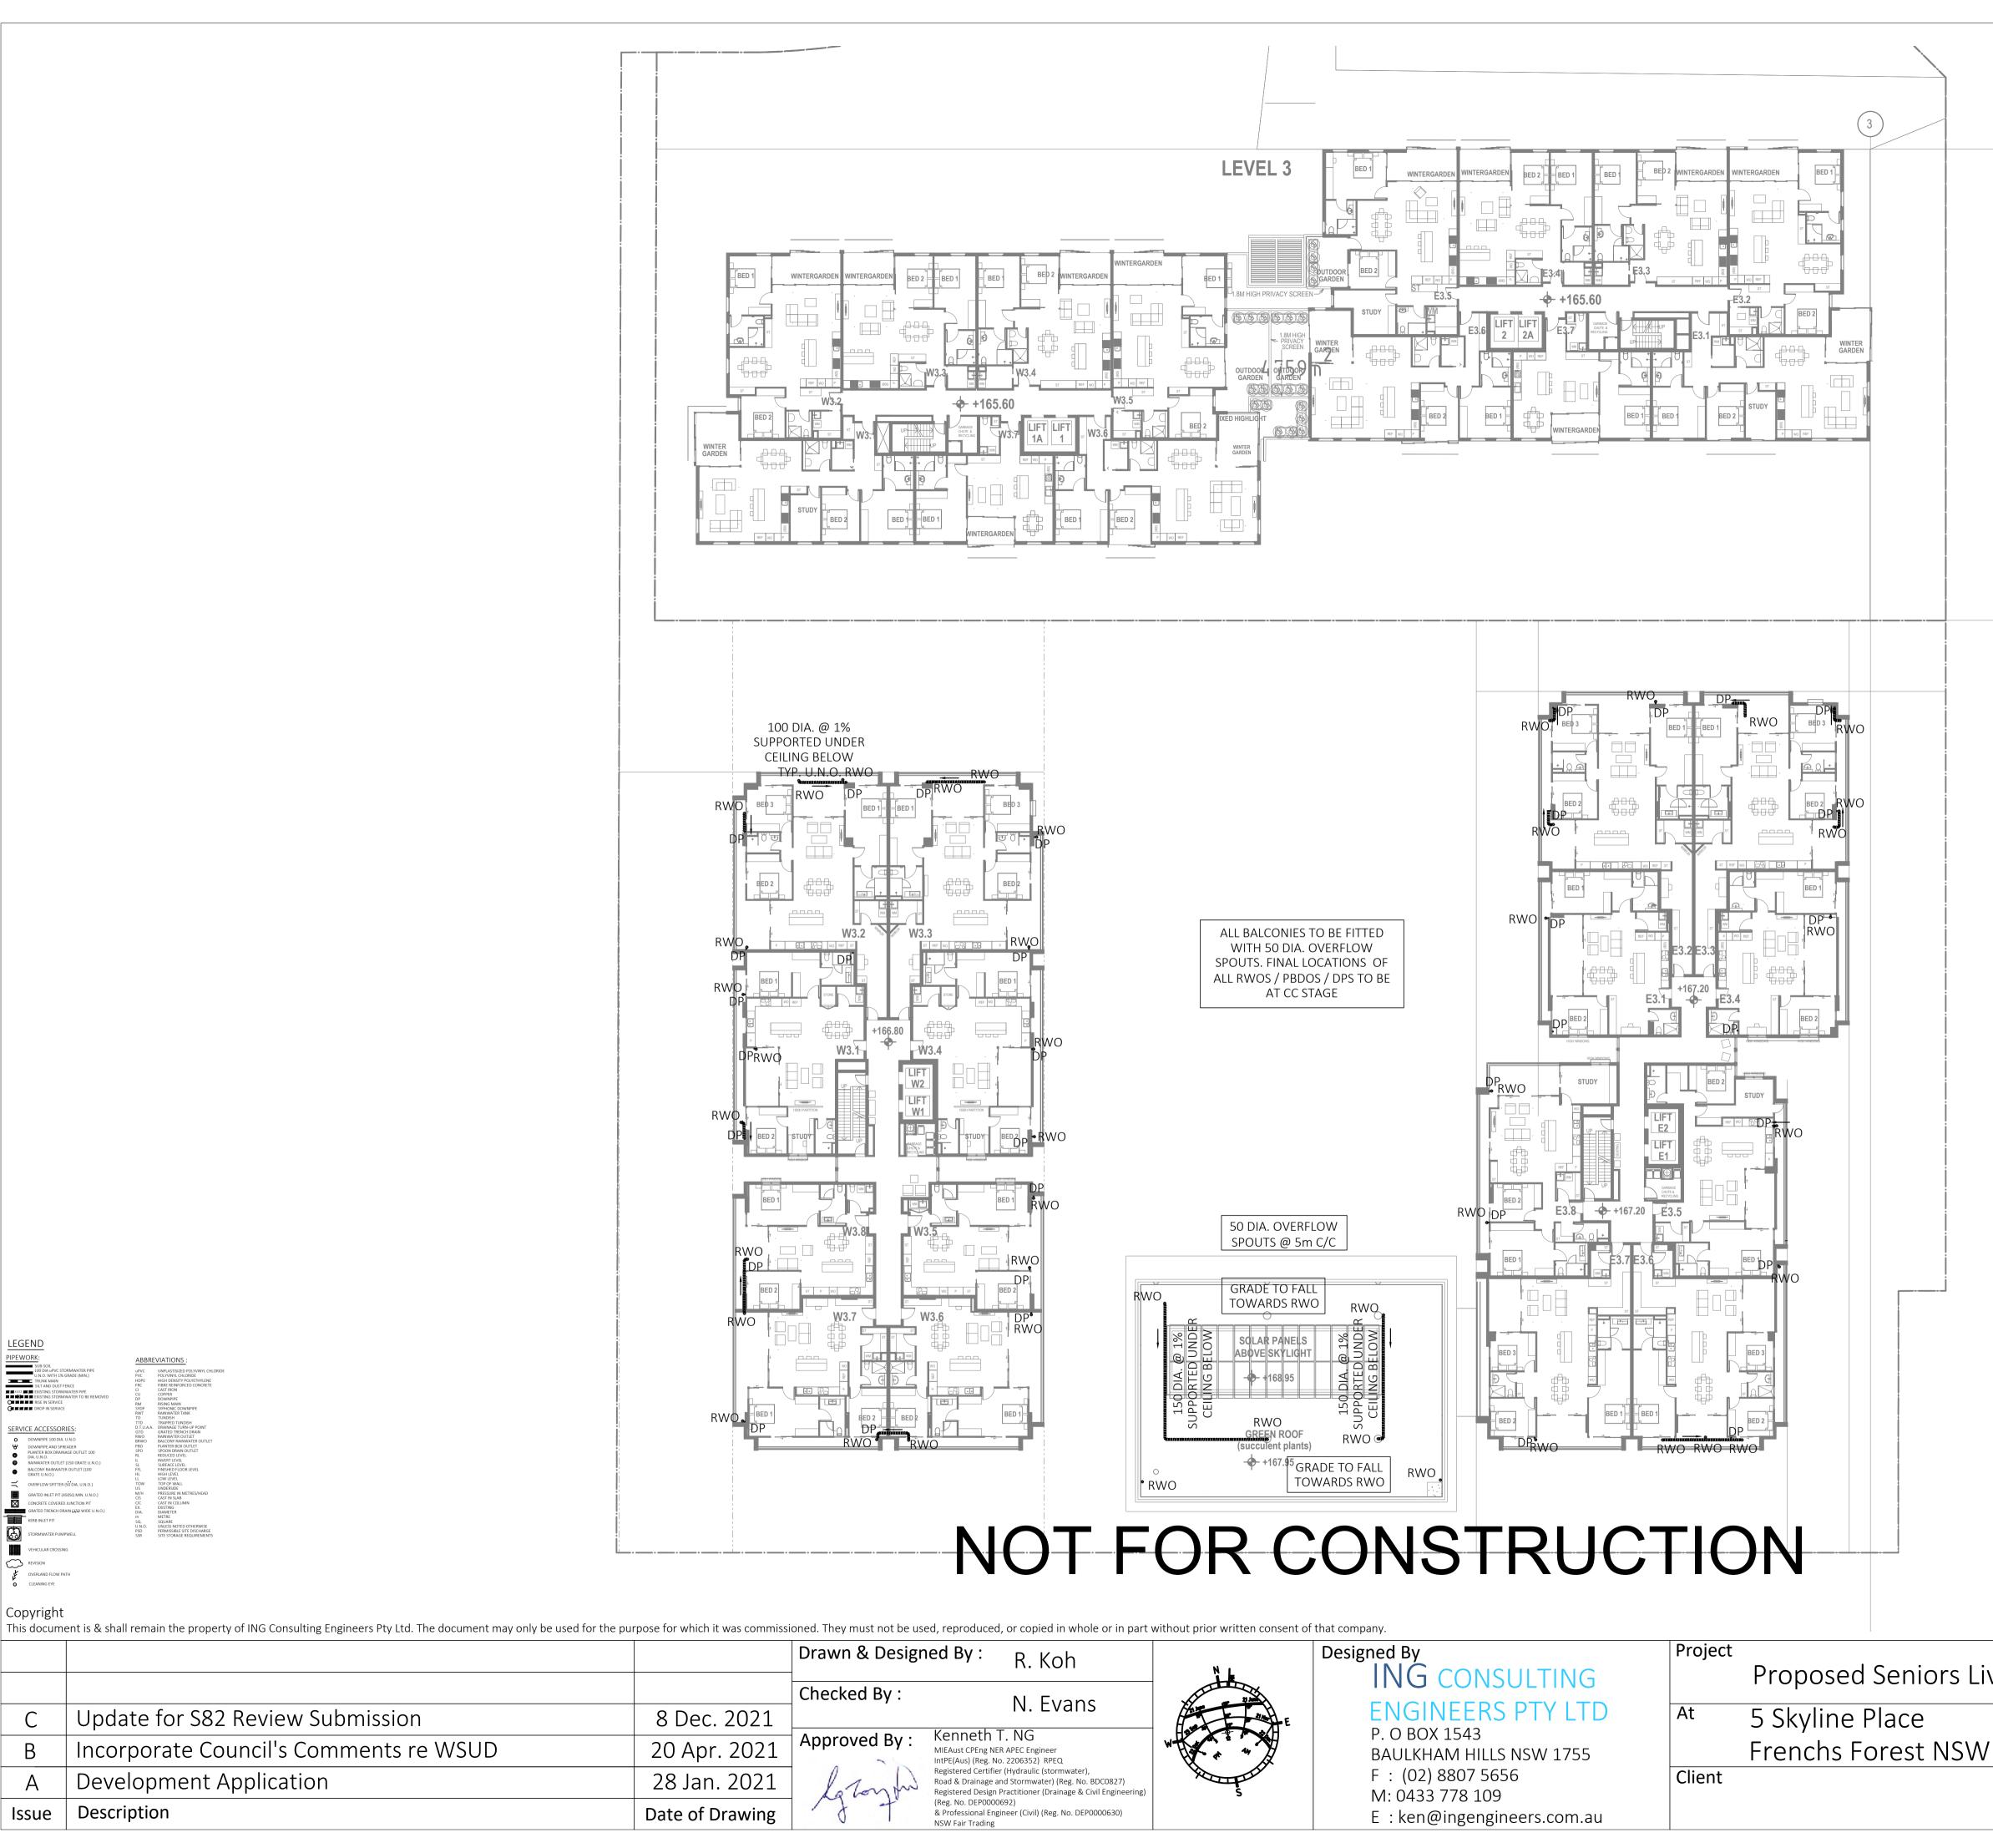

SERVICE ACCESSOR T B REVISION COVERLAND FLOW PATH COVERLANING EYE

Copyright

OLVIVINI, CHLORIDE GING DENSTY POLYCHTHLENE BRE REINFORCED CONCRETE DRE REINFORCED CONCRETE OPPER OWNPPE SING MAIN WHOLE DOWNPPE SING MAIN ANWATER TAKE ANNAGE TURK-LUP POINT RATED TRENCH DRAIN MANTER GOVINTET JAFTE ROX OUTLET JAFTE ROX OUTLET JAFTE ROX OUTLET URFACE LEVEL URFACE LEVEL INFAD FLOOR LEVEL
IBRE REINFORCED CONCRETE SATIRON OPPER OWNMANN WANNATER TANK UNDISH MANWATER TANK ANAVATER TANK ANAVATER OLANA ANAVATER OUTLET ALCONY RANWATER OUTLET ALCONY RANWATER OUTLET UNFACE LEVEL UNFACE LEVEL UNFACE LEVEL
AST IRON OPPER OWNPIPE SING MAIN MINIME MINIME RAPED TUNDISH RAPED TUNDISH RANGE TURK-UP POINT RATED TRENCH DRAIN MANTER DUTUET AUTER BOX OUTLET AUTER BOX OUTLET EDUCED LEVEUTLET URFACE LEVEL URFACE LEVEL NISHED FLOOR LEVEL
OPPER OWNPIPE SING MAN OWNPIPE HINWACETANK HINWACETANK UNDISH RAINAGETURK-UP POINT AATED TERKCH OT AATED TERKC
ÖVNNPPE SING MAIN VPH-ONC DOWNPPE ANWATER TAK UNDESH ANMAGE TURN-UP POINT RANNAG TURN-UP POINT RANNAG TURN-UP POINT ALCONY RANNA/TER OUTLET JAHTE BOX OUTLET DANTER BOX OUTLET URFACE LEVEL URFACE LEVEL
ISING MAIN PHONIC DOWNPIPE AINWATER TANK UNDSH RANPED TUNDSH RANGET URK-UP POINT RAITED TERKICH DRAIN MAWATER OUTLER OUTLET DANTER BOX SUTLET POON DRAIN OUTLET EDUCED LEVEL URFACE LEVEL URFACE LEVEL
YPHONIC DOWNPIPE ANIWATER TANK UNDISH RAINAGE TURN-UP POINT RAINAGE TURN-UP POINT RAITED TRENCH TORAIN ANIWATER OUTLET LAONY RAIWATER OUTLET DAUCONY RAIWATER OUTLET POOD RAIN OUTLET POOD RAIN OUTLET URFACE LEVEL URFACE LEVEL URFACE LEVEL
ANIWATER TANK WORSH RAPPED TUNDISH RAPPED TUNDISH RATED TRENCH DRAIN ANIWATER OUTLET ALCOWY RAINWATER OUTLET LAVTER BOX OUTLET EDUCED LEVEL WERT LEVEL URFACE LEVEL WERT LEVEL
UNDISH RAPPED TUNDISH RAINAGE TURN-UP POINT RATED TRENCH ORAN AIRED TRENCH ORAN AIRWATER OUTLET ALCONY RAINWATER OUTLET LANTER BOX OUTLET EDUCED LEVEL URFACE LEVEL URFACE LEVEL URFACE LEVEL
RAPPED TUNDISH RAINAGE TURN-UP POINT RATED TRENCH DRAIN AINWATER OUTLET LAUTER BOX OUTLET LAUTER BOX OUTLET DOCH DRAIN OUTLET EDUCED LEVEL URFACE LEVEL URFACE LEVEL NISHED FLOOR LEVEL
RAINAGE TURK-UP POINT RATED TRENCH DRAIN AIRWATER OUTLET ALCONY RAINWATER OUTLET LAITER BOX OUTLET POON DRAIN OUTLET EDUCED LFVEL IVERT LEVEL URFACE LEVEL URFACE LEVEL
RATED TRENCH DRAIN AINWATER OUTLET ALCONY RAINWATER OUTLET LANTER BOX OUTLET POON DRAIN OUTLET EDUCED LEVEL VIERT LEVEL URFACE LEVEL INSHED FLOOR LEVEL
AINWATER OUTLET ALCONY RAINWATER OUTLET LANTER BOX OUTLET POON DRAIN OUTLET EDUCED LEVEL WERT LEVEL URFACE LEVEL URFACE LEVEL NISHED FLOOR LEVEL
ALCONY RAINWATER OUTLET LANTER BOX OUTLET POON DRAIN OUTLET EDUCED LEVEL VIERT LEVEL URFACE LEVEL NISHED FLOOR LEVEL
LANTER BOX OUTLET POON DRAIN OUTLET EDUCED LEVEL IVERT LEVEL URFACE LEVEL INISHED FLOOR LEVEL
POON DRAIN OUTLET EDUCED LEVEL IVERT LEVEL URFACE LEVEL INISHED FLOOR LEVEL
EDUCED LEVEL IVERT LEVEL URFACE LEVEL INISHED FLOOR LEVEL
IVERT LEVEL URFACE LEVEL NISHED FLOOR LEVEL
URFACE LEVEL INISHED FLOOR LEVEL
NISHED FLOOR LEVEL
IGH LEVEL
DW LEVEL
OP OF WALL
NDERSIDE
RESSURE IN METRES/HEAD
AST IN SLAB
AST IN COLUMN
KISTING
IAMETER
1ETRE
QUARE
NLESS NOTED OTHERWISE
ERMISSIBLE SITE DISCHARGE ITE STORAGE REQUIREMENTS


8 Dec. 2021 Update for S82 Review Submission С Incorporate Council's Comments re WSUD 20 Apr. 2021 В Development Application 28 Jan. 2021 А Description Date of Drawing Issue

VERIFY ALL DISCREPANCIES WITH PROJECT ARCHITECT/ MANAGER PRIOR TO PROCEEDING WITH ANY WORKS. Do not scale off drawings.

	J
Drawing Title	
Level	3 Floor Plan
Date	Scale
January 2021	1 : 250 @ A1
Project No.	Drawing & Sheet No./Issue
284012021DA	28401-09/18 / C
	Level Date January 2021 Project No.

2

-(1)

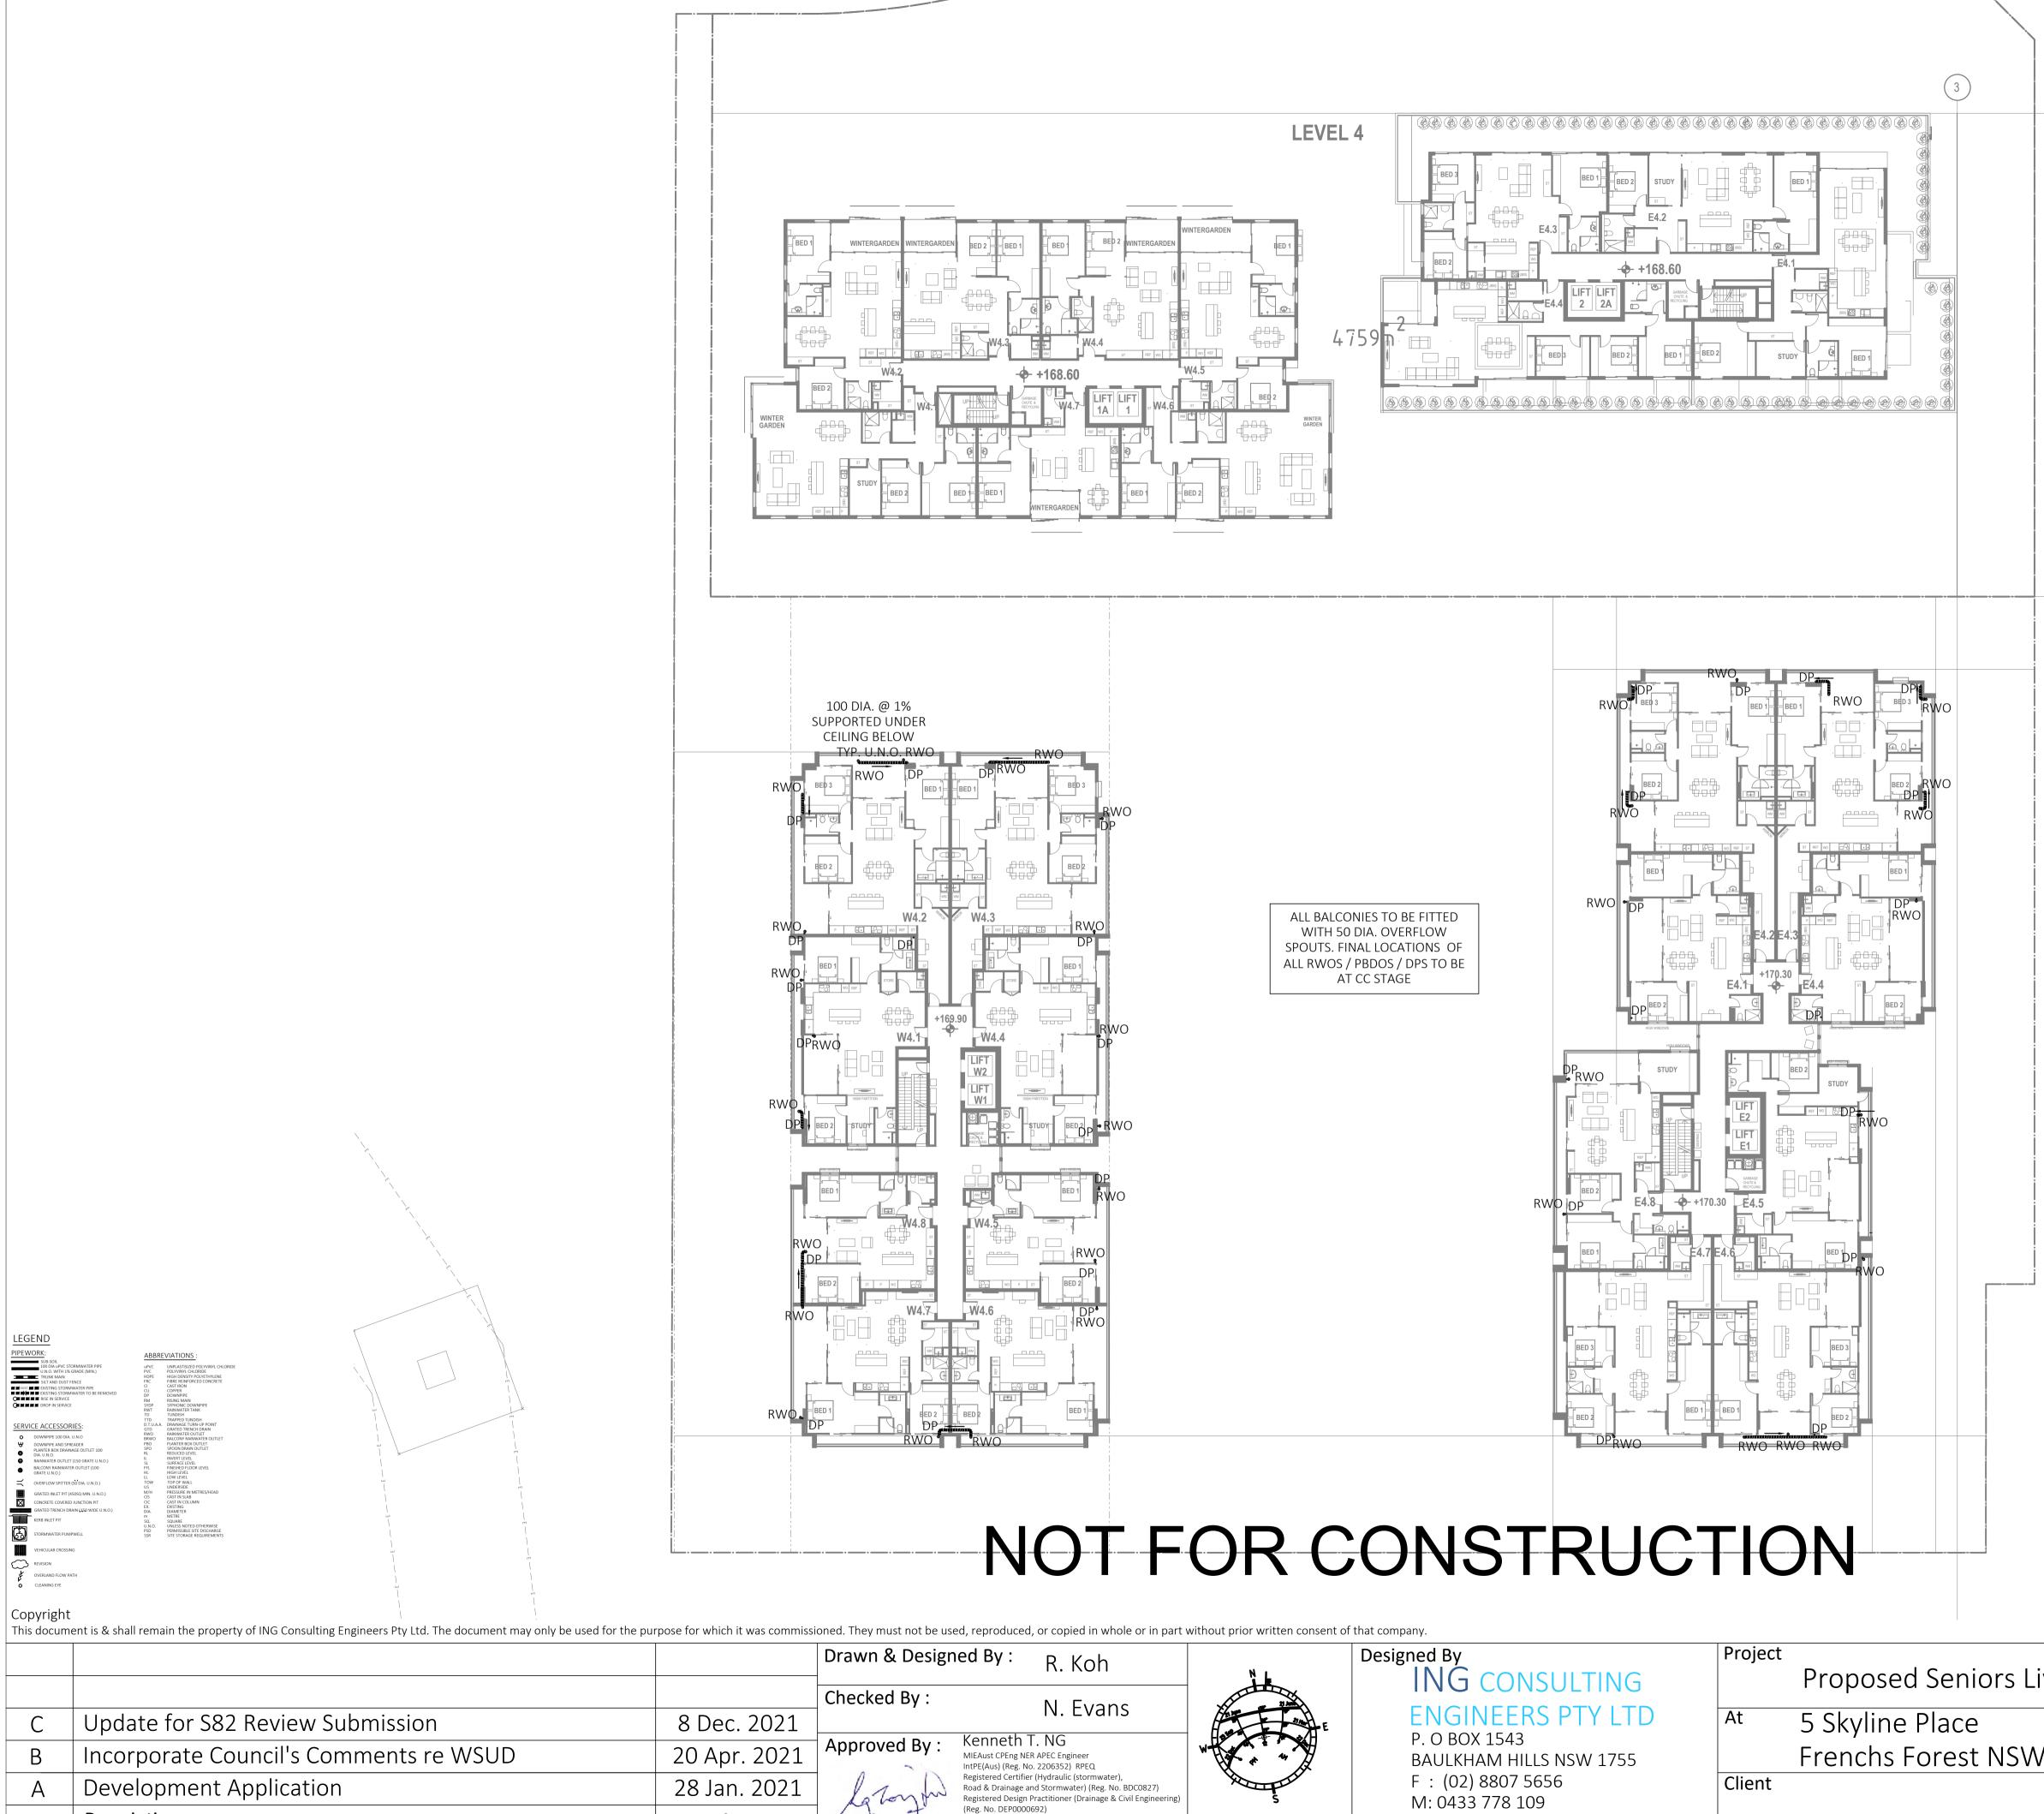

E : ken@ingengineers.com.au

~		
Co	pyri	ight

Í G


			Drawn & Design	ed By : R. Koh
			Checked By :	
С	Update for S82 Review Submission	8 Dec. 2021	Approved By : MIEAust CPEng NER APEC Engineer IntPE(Aus) (Reg. No. 2206352) RPEQ Registered Certifier (Hydraulic (stormwater) Road & Drainage and Stormwater) (Reg. No. Registered Design Practitioner (Drainage & C (Reg. No. DEP0000692)	N. Evans
В	Incorporate Council's Comments re WSUD	20 Apr. 2021		MIEAust CPEng NER APEC Engineer
А	Development Application	28 Jan. 2021		Registered Certifier (Hydraulic (stormwater), Road & Drainage and Stormwater) (Reg. No. BDC0827) Registered Design Practitioner (Drainage & Civil Engineerii
lssue	Description	Date of Drawing		& Professional Engineer (Civil) (Reg. No. DEP0000630)

VERIFY ALL DISCREPANCIES WITH PROJECT ARCHITECT/ MANAGER PRIOR TO PROCEEDING WITH ANY WORKS. Do not scale off drawings.

		J
	Drawing Title	
iving (Stage 2)	Level	4 Floor Plan
	Date	Scale
N 200C	January 2021	1 : 250 @ A1
V 2086		1.200 @ //1
	Project No.	Drawing & Sheet No./Issue
	284012021DA	28401-10/18 / C

-(2)

-(1)

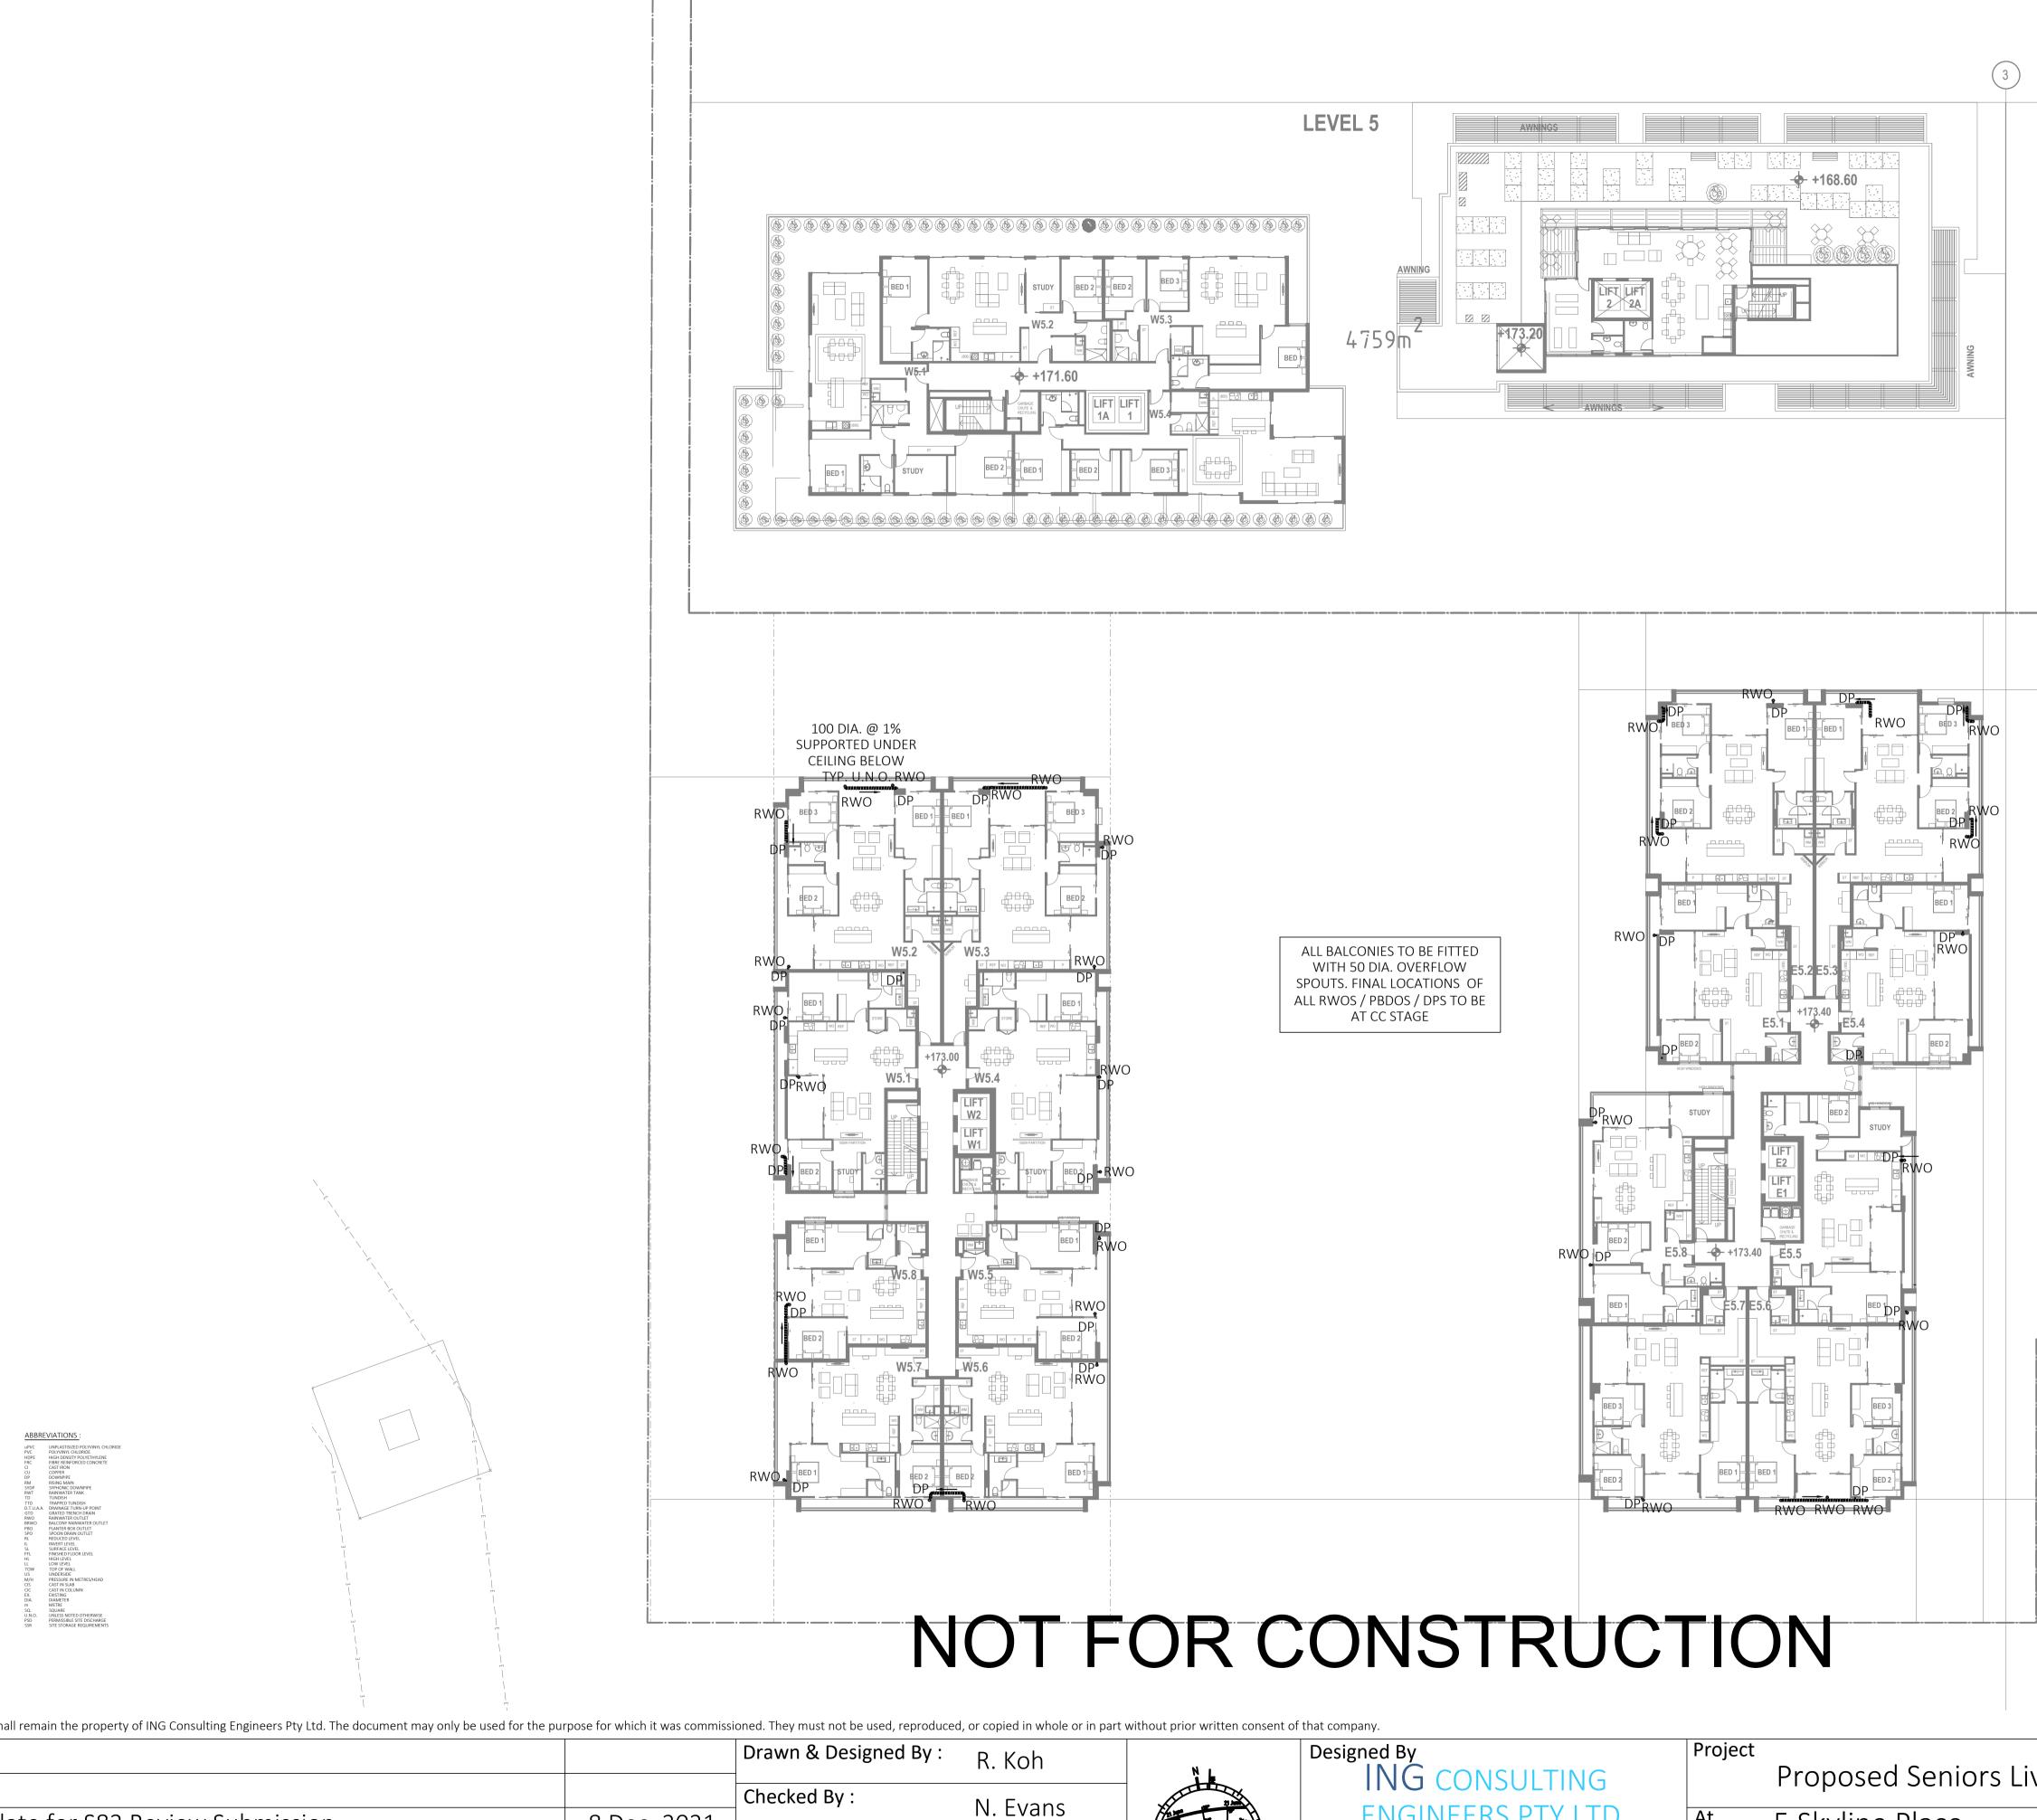

Со	pyrigł	nt


REVISION VERLAND FLOW PATH CLEANING EYE

LEGEND

æ

			Drawn & Desigr	ned By :
			Checked By :	
С	Update for S82 Review Submission	8 Dec. 2021		<u> </u>
В	Incorporate Council's Comments re WSUD	20 Apr. 2021	Approved By :	Kennet MIEAust CPEng IntPE(Aus) (Reg
А	Development Application	28 Jan. 2021	la Longitu	Registered Cert Road & Drainag Registered Des
Issue	Description	Date of Drawing	1 2 4	(Reg. No. DEPO & Professional NSW Fair Tradir

th I. NG
ng NER APEC Engineer
eg. No. 2206352) RPEQ
ertifier (Hydraulic (stormwater),
age and Stormwater) (Reg. No. BDC0827)
esign Practitioner (Drainage & Civil Engineering
P0000692)
al Engineer (Civil) (Reg. No. DEP0000630)
ding

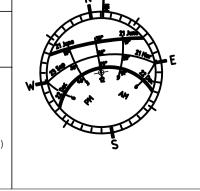


ENGINEERS PTY LTD

P. O BOX 1543 BAULKHAM HILLS NSW 1755 F : (02) 8807 5656 M: 0433 778 109 E : ken@ingengineers.com.au

5 Skyline Place At Frenchs Forest NSW Client

iving (Stage 2)	Level	5 Floor Plan
V 2086	Date January 2021	Scale 1 : 250 @ A1
	Project No. 284012021DA	Drawing & Sheet No./Issue 28401-11/18 / C

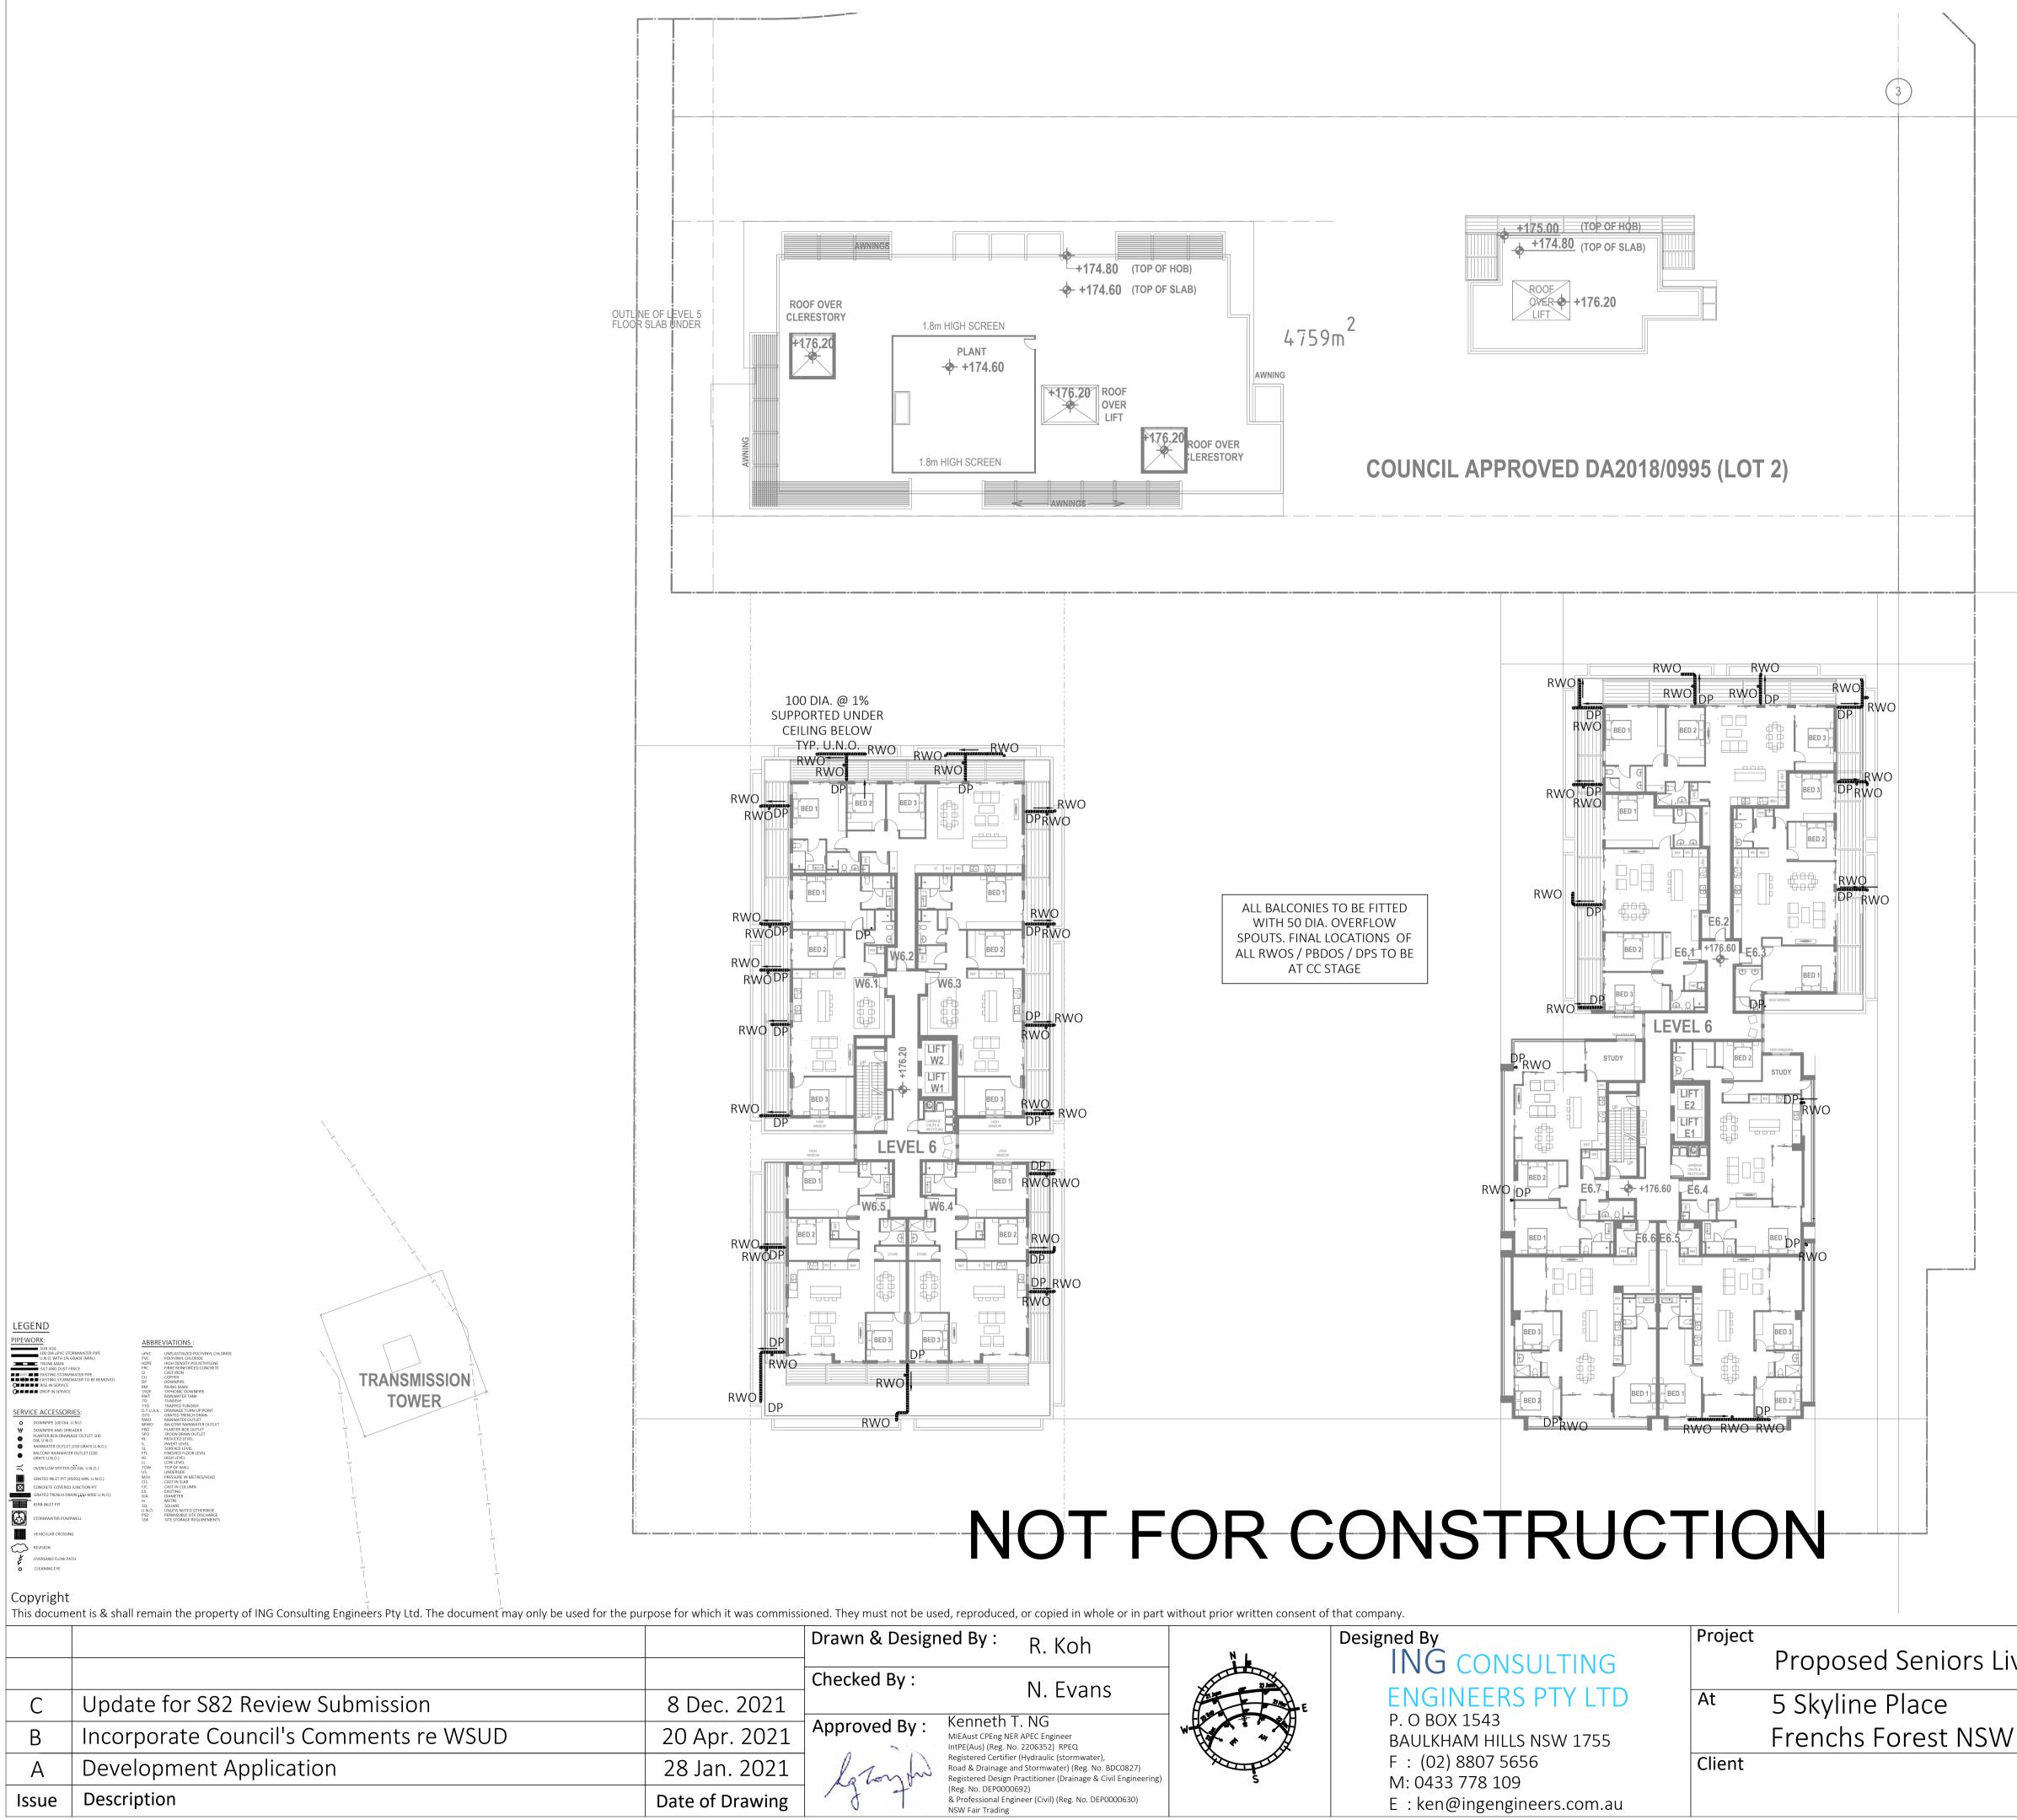


			Drawn & Designed By :	
			Checked By :	
С	Update for S82 Review Submission	8 Dec. 2021		
В	Incorporate Council's Comments re WSUD	20 Apr. 2021	Approved By: Kenr	
А	Development Application	28 Jan. 2021	A Longhon Registere Road & E Registere (Reg No	
Issue	Description	Date of Drawing	(Reg. No & Profes NSW Fair	

VERIFY ALL DISCREPANCIES WITH PROJECT ARCHITECT/ MANAGER PRIOR TO PROCEEDING WITH ANY WORKS. Do not scale off drawings.

	Drawing Title		
iving (Stage 2)	Level 6 Floor Plan		
	Date	Scale	
V 2086	January 2021	1 : 250 @ A1	
	Project No.	Drawing & Sheet No./Issue	
	284012021DA	28401-12/18 / C	

_2

-(1)

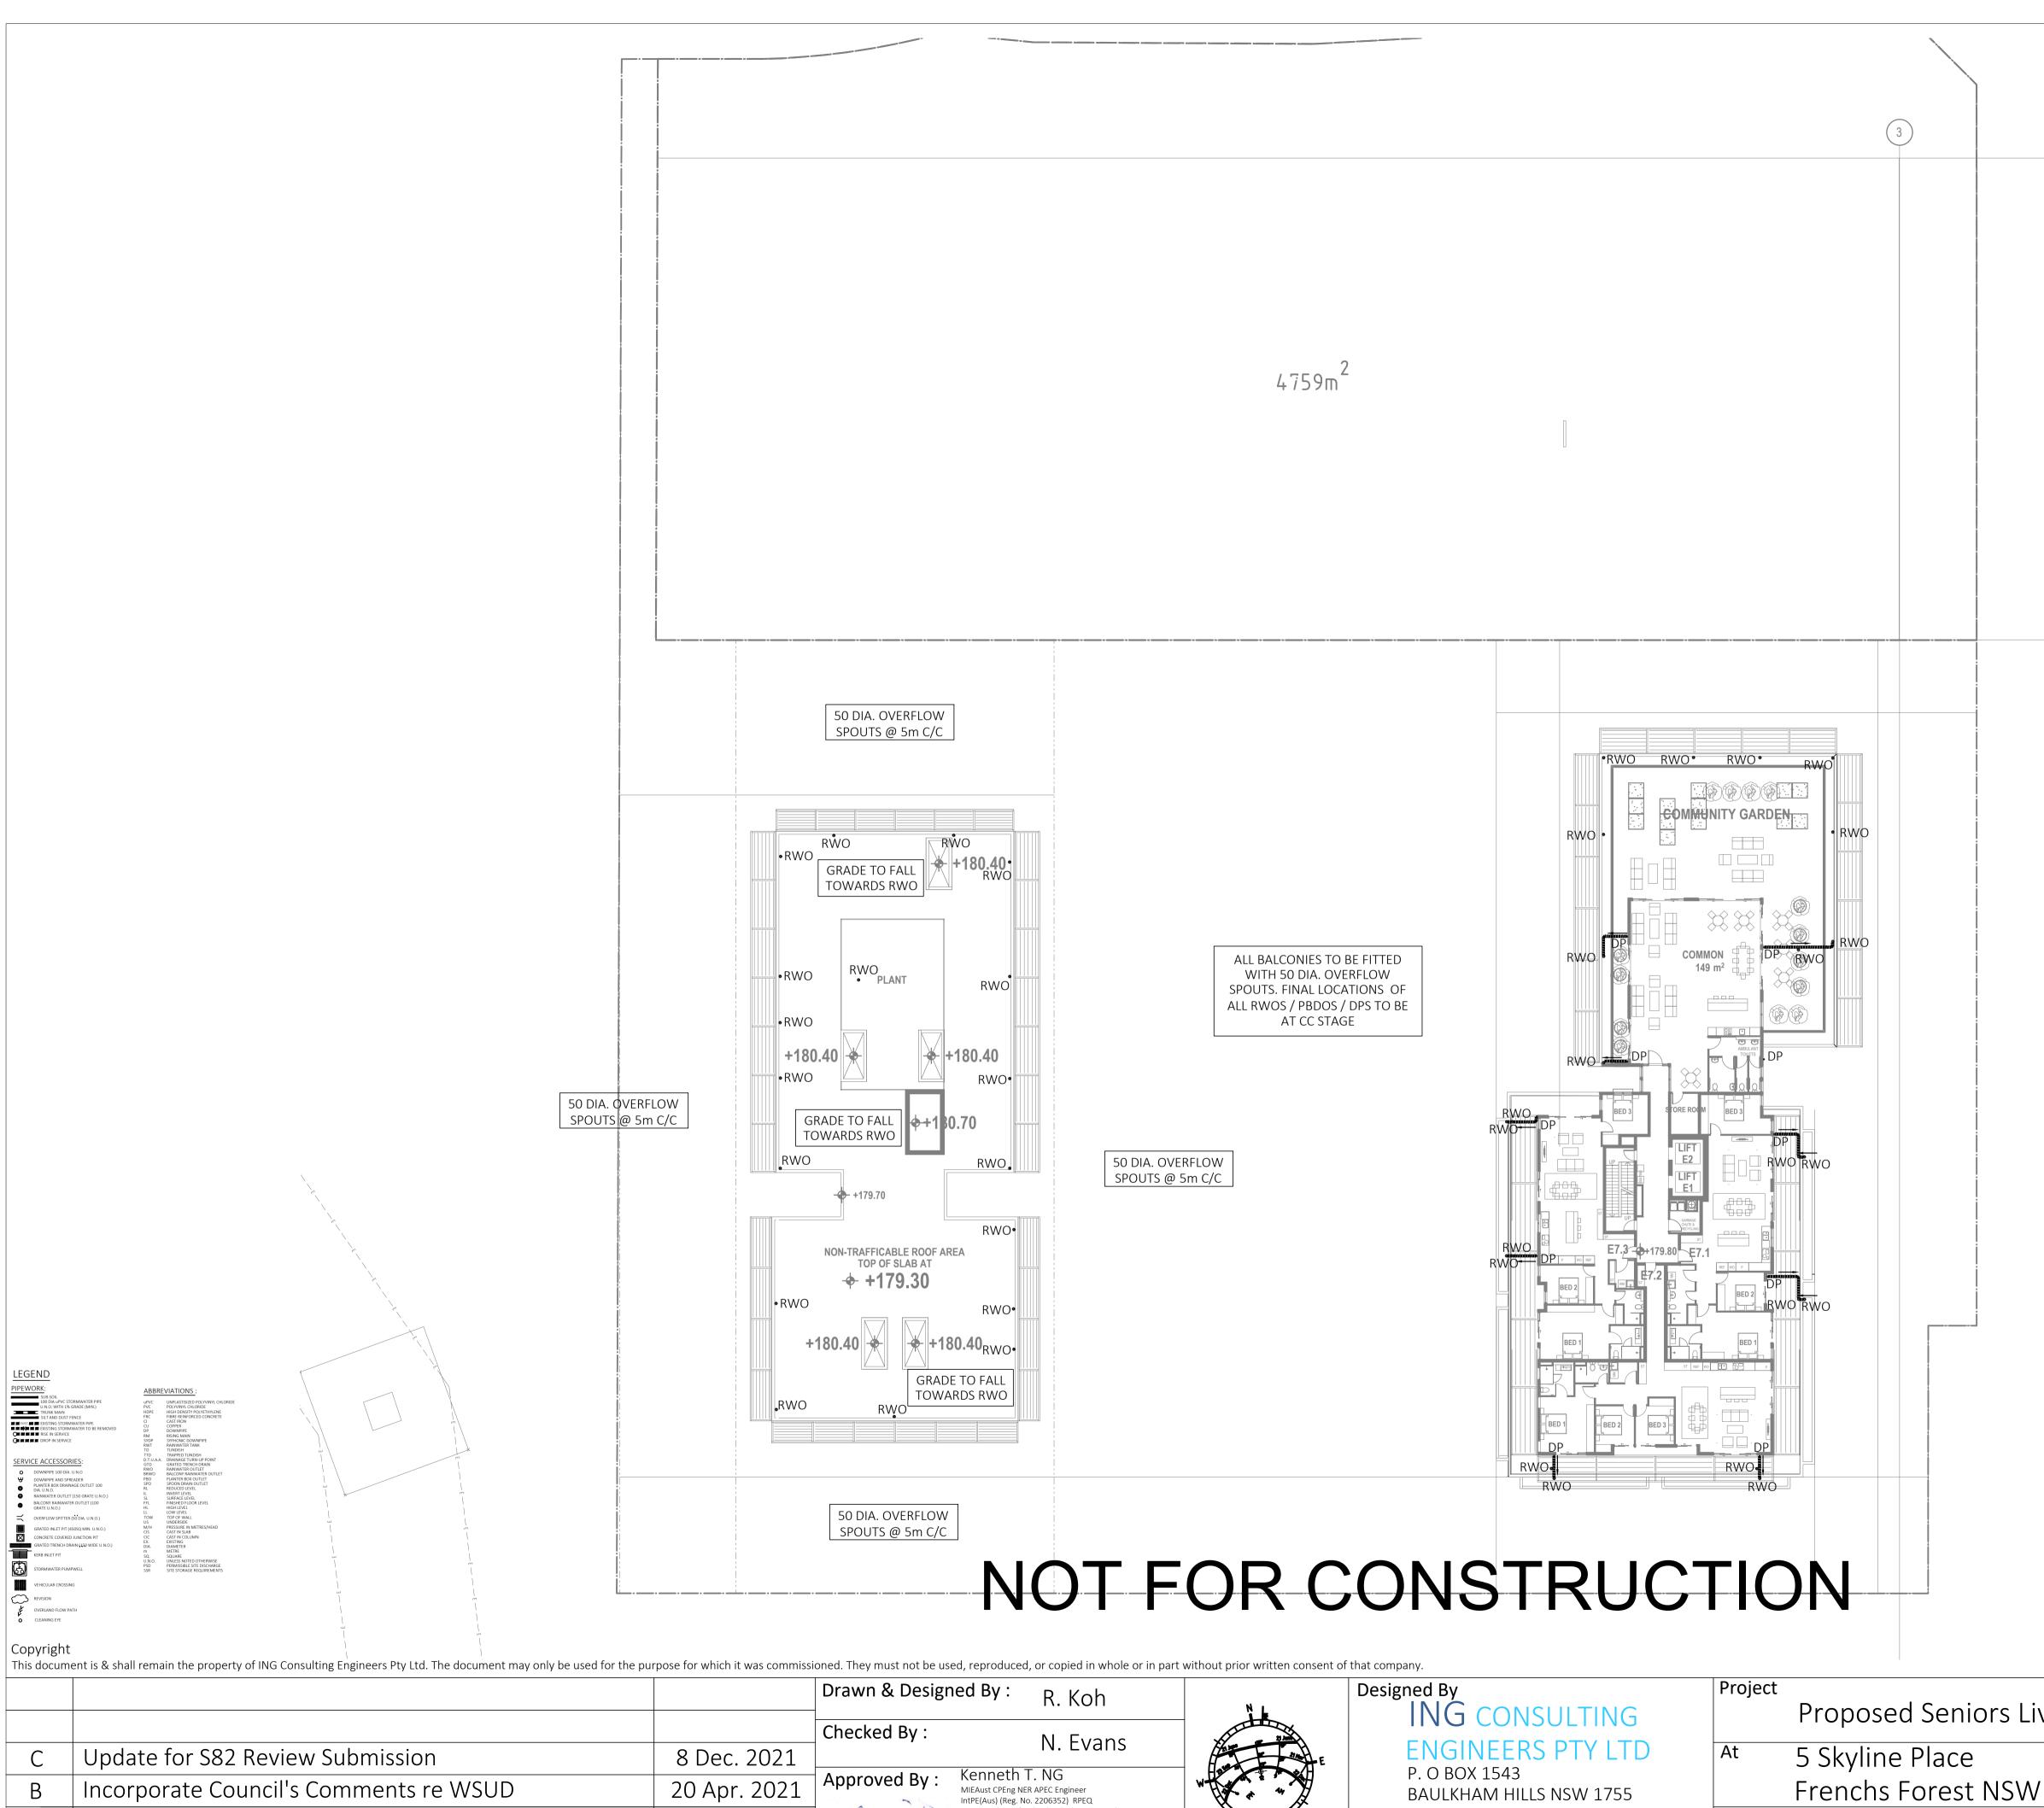

F : (02) 8807 5656

E : ken@ingengineers.com.au

M: 0433 778 109

Client

			Drawn & Desigr	ned By : R. Koh
			Checked By :	N. Evans
С	Update for S82 Review Submission	8 Dec. 2021		
В	Incorporate Council's Comments re WSUD	20 Apr. 2021	Approved By :	Kenneth T. NG MIEAust CPEng NER APEC Engineer IntPE(Aus) (Reg. No. 2206352) RPEQ
А	Development Application	28 Jan. 2021	la Tongton	Registered Certifier (Hydraulic (stormwater), Road & Drainage and Stormwater) (Reg. No. BDC0827) Registered Design Practitioner (Drainage & Civil Engineering)
lssue	Description	Date of Drawing	1 - 7 - 7	(Reg. No. DEP0000692) & Professional Engineer (Civil) (Reg. No. DEP0000630) NSW Fair Trading


-2

-(1)


		_	
iving (Stage 2)	Drawing Title Level 7 Floor Plan		
V 2086	Date January 2021	Scale 1 : 250 @ A1	
	Project No.	Drawing & Sheet No./Issue	
	284012021DA	28401-13/18 / C	


PIPEWORK: Piework: Piework: Piework: Piework: Piework: Piework: <td></td> <td></td> <td></td> <td></td>				
This document is & shall remain the property of ING Consulting Engineers Pty Ltd. The document may only	/ be use	ed for the pur	pose for which it was commiss	ioned. They must not be used, reproc

			Drawn & Desigr	ned By :
			Checked By :	
С	Update for S82 Review Submission	8 Dec. 2021		
В	Incorporate Council's Comments re WSUD	20 Apr. 2021	Approved By :	Kenneth MIEAust CPEng IntPE(Aus) (Reg
А	Development Application	28 Jan. 2021	la Longon	Registered Cert Road & Drainag Registered Desi
Issue	Description	Date of Drawing	173 7	(Reg. No. DEPO & Professional NSW Fair Tradir

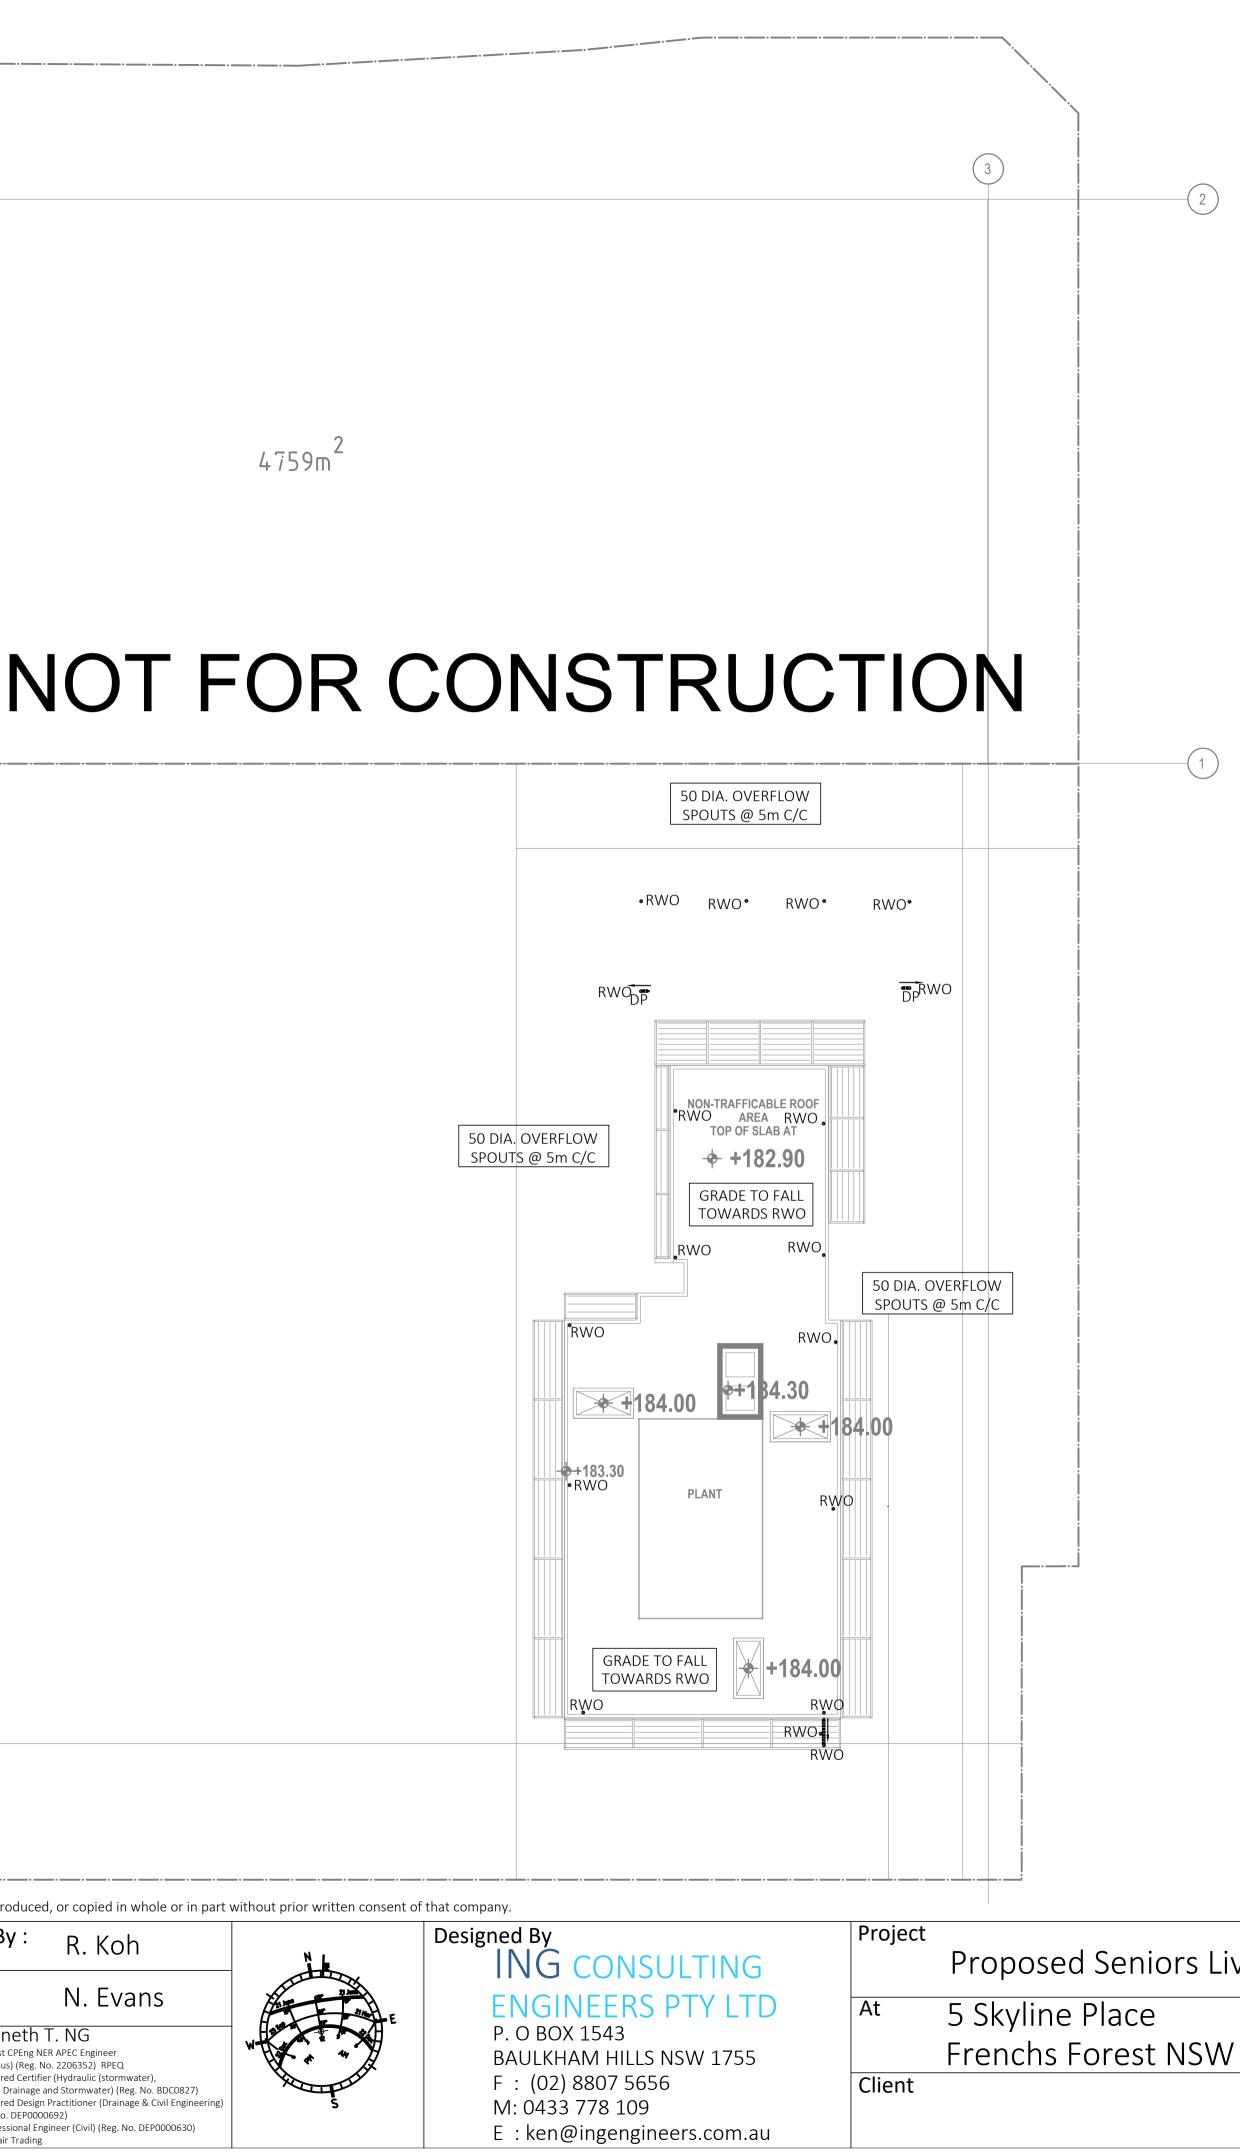

		Do not scale on drawings.	
	Drawing Title		
iving (Stage 2)	Roof Plan		
	Date	Scale	
V 2086	January 2021	1 : 250 @ A1	
	Project No.	Drawing & Sheet No./Issue	
	284012021DA	28401-14/18/ C	

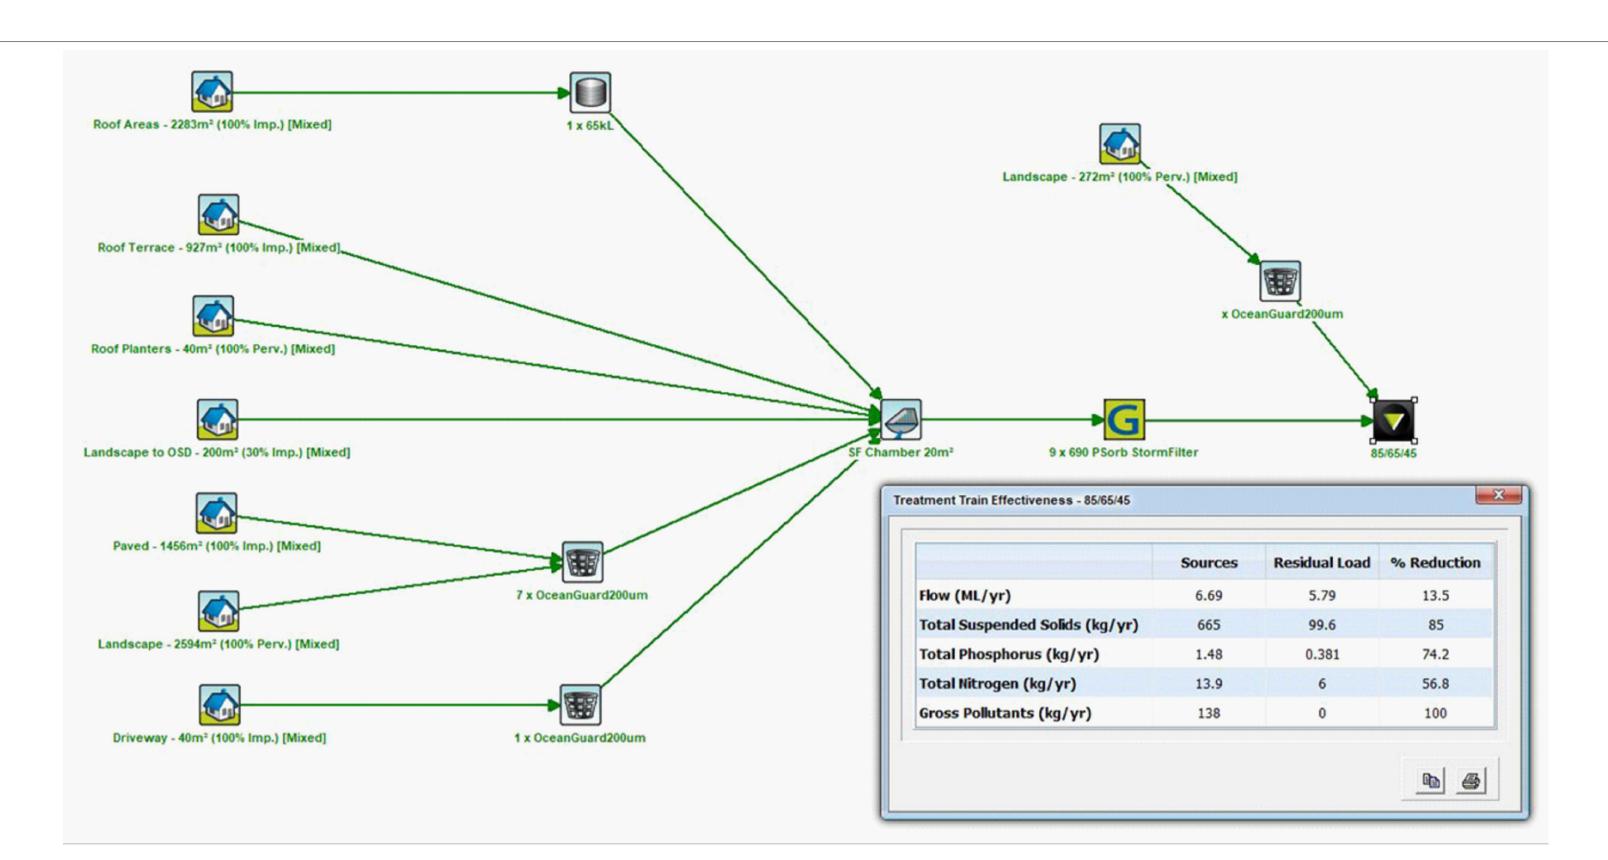

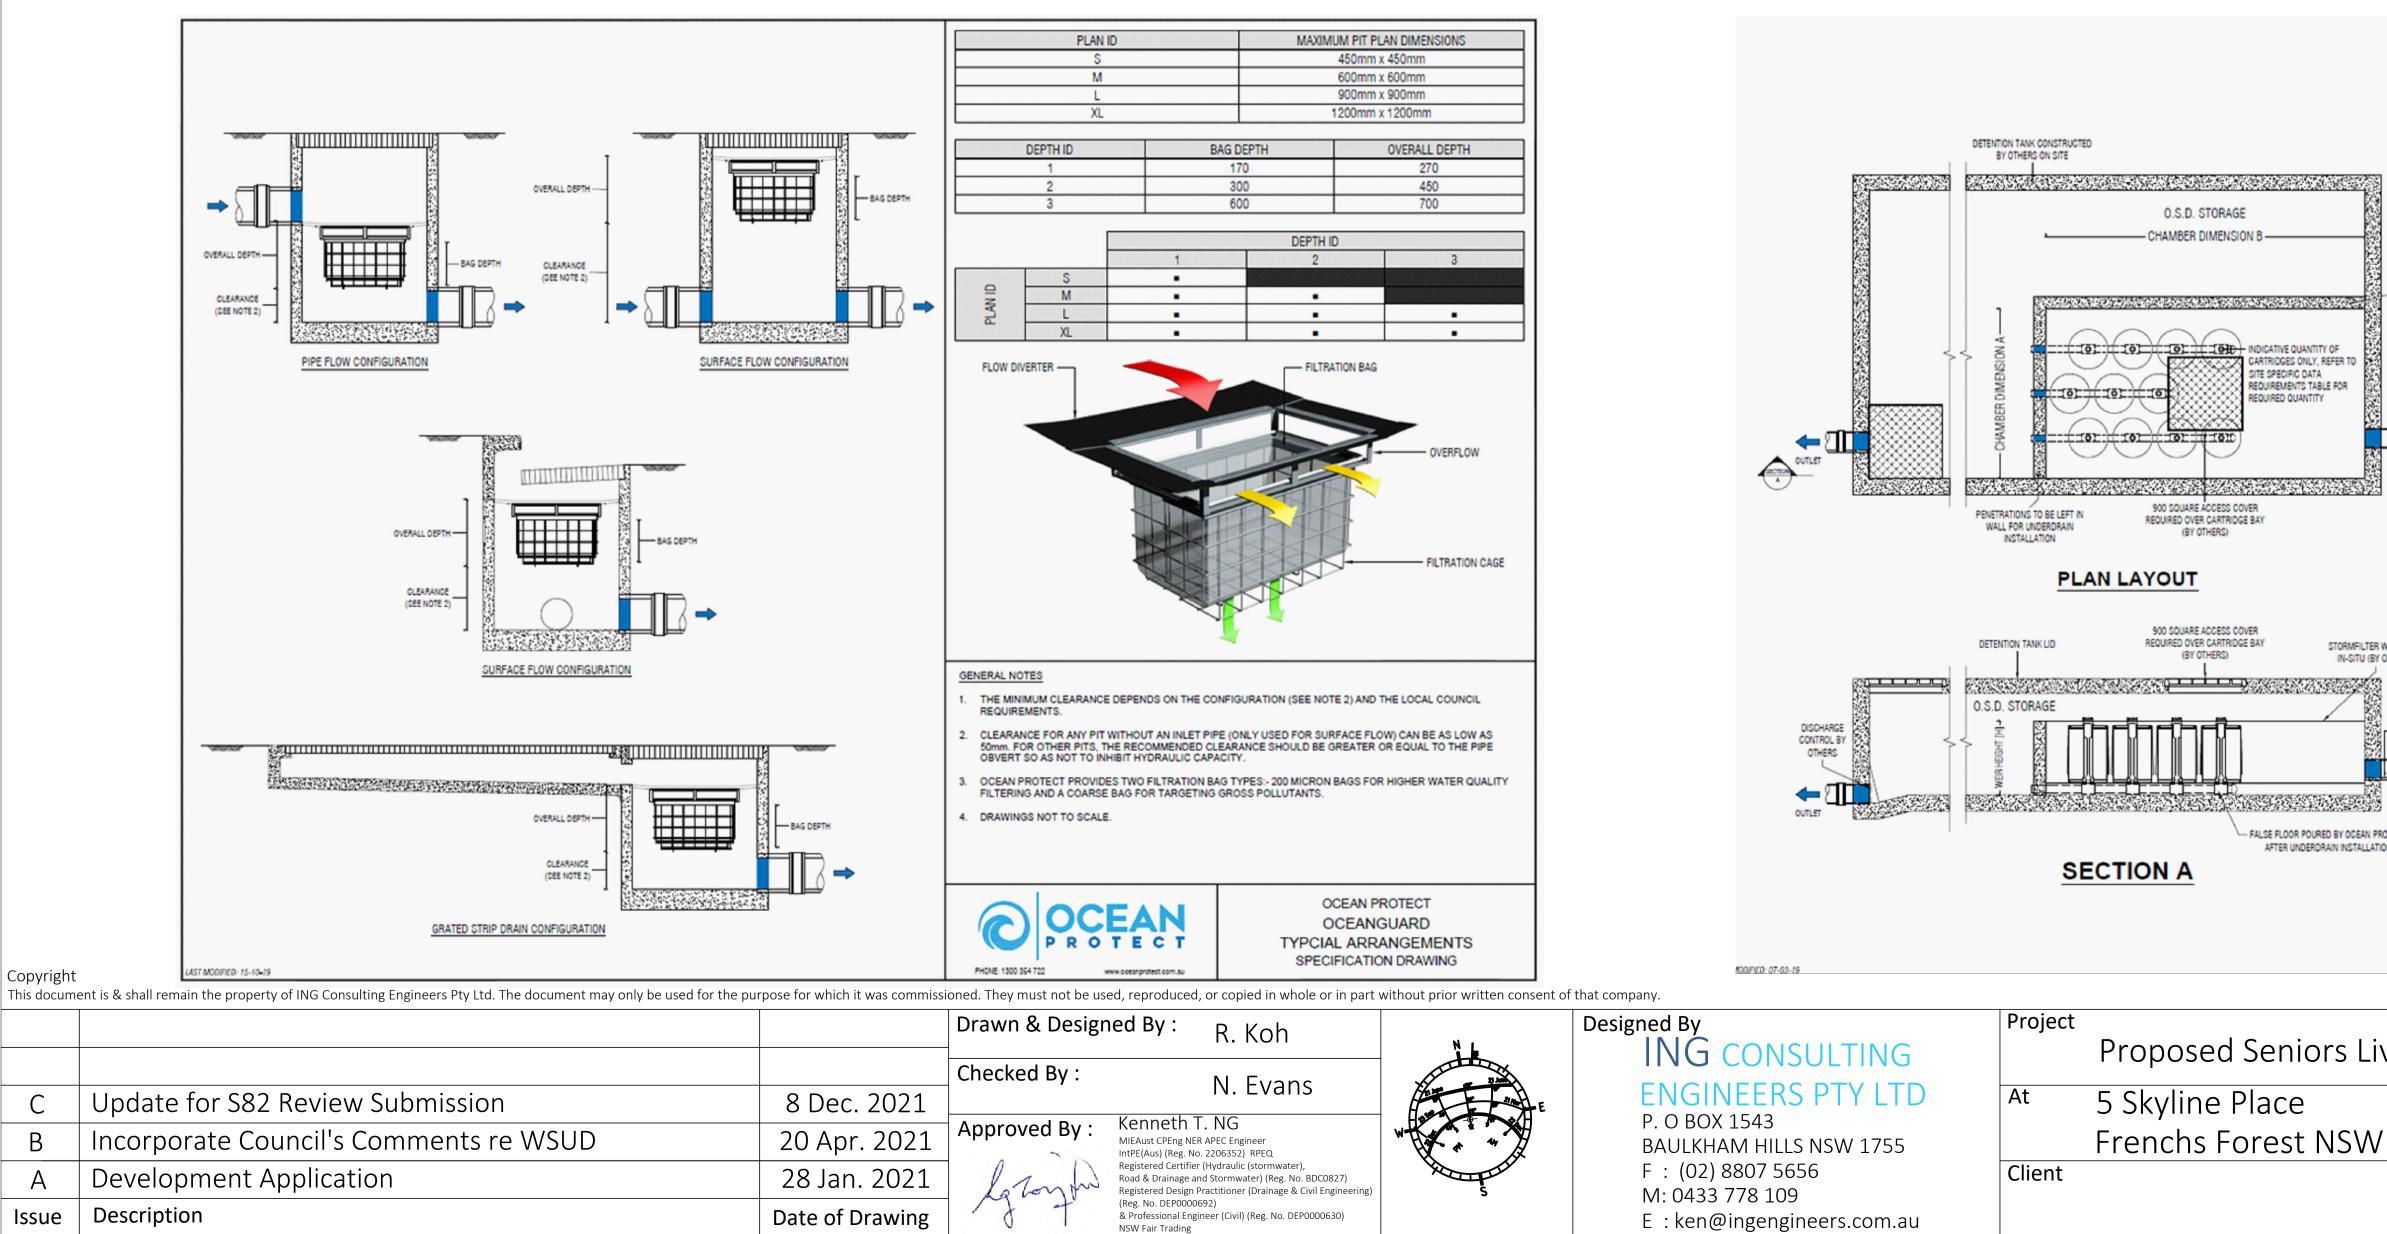

Copyright

С

В

А

lssue

NOT FOR CONSTRUCTION

	STORMFILTER DESIGN TABLE STORMFILTER TREATMENT CAPACITY VARIES BY NUMBER OF FILTER CARTRIDGES INSTALLED. THE STANDARD CONFIGURATION IS SHOWN. ACTUAL CONFIGURATION OF THE SPECIFIED STRUCTURE(S) PER CERTIFYING ENGINEER WILL BE SHOWN ON SUBMITTAL DRAWING(S). FILTER CARTRIDGES SHALL BE MEDIA-FILLED, PASSIVE, SIPHON ACTUATED, RADIAL FLOW, AND SELF-CLEANING. RADIAL					
7	PILTER CARTRIDGES SHALL BE MEDIA-PIL MEDIA DEPTH SHALL BE 178mm. CARTRIDGE NAME / SIPHON HEIGHT CARTRIDGE PHYSICAL HEIGHT (mm) TYPICAL WEIR HEIGHT [H] (mm) CARTRIDGE FLOW RATE FOR ZPG MI	690 840 920 1.6	460 600 690	310 600 540 0.7		
STORMFILTER WALL	CARTRIDGE FLOW RATE FOR PSORE		0.9	0.46 SITE SPECIF	0.39 FIC	
INLET	HORH HORE AND		STRUCTURE ID [NUMBER OF CARTRIDGES REQD [SIPHON HEIGHT (310 / 460 / 690) [MEDIA TYPE (ZPG / PSORB) [WATER QUALITY FLOW RATE (L/S) [DIMENSION A [DIMENSION B [TOTAL CARTRIDGE BAY AREA (A x B) TO MATCH AREA REQUIRED BY MUSIC		[] [] [] [] [] [] EA (A × B) BY MUSIC	
	CARTRIDGE DETAIL MODELLING OR COUNCIL SPECIFIC REQUIREMENTS GENERAL NOTES					
INLET IL MINIMUM ISOmm ABOVE BAGE OF TANK ROTECT ION	 SITE SPECIFIC PRODUCTION DRAWIN THE INVERT LEVEL OF THE INLET PIR CARTRIDGE CHAMBER. CONCRETE STRUCTURE AND ACCES A MINIMUM 900 X 900 ABOVE CARTRI ASSESSED BY OTHERS ON SITE. THE STRUCTURE THICKNESSES SHO DRAWINGS NOT TO SCALE. INSTALLATION NOTES UNDERDRAIN AND FALSE FLOOR INST 	NG WILL BE PR PE MUST BE GR SS COVERS DES IDGES. OH&S R	OVIDED ON PLACEMEN REATER THAN THE RL O SIGNED AND PROVIDED EGARDING ACCESS CO REPRESENTATIONAL PO	OF THE FALSE FLOOP BY OTHERS. ACCES OVERS AND TANK AC	SS COVERS TO BE	
	PHONE: 1300 354 722 www.ioscangrotee	OCEAN PROTECT STORMFILTER SYSTEM DETENTION TANK ARRANGEMENT SPECIFICATION DRAWING				
ving (St		Drawing Wate	TO PROCEEDING WITH	ANY WORKS. Do no	architect/ MANAGER I ot scale off dra	wings.
/ 2086		Date Janu	ary 2021	Scale As S	Shown @	A1
		Project 2840	No. 12021DA		g & Sheet No.)1-15/18	

GENERAL NOTES


- THE CONTRACTOR MUST VERIFY ALL DIMENSIONS AND EXISTING LEVELS ON SITE PRIOR TO COMMENCEMENT OF WORKS.
- ALL WORKS ARE TO BE CARRIED OUT TO THE DETAILS SHOWN ON THE DRAWINGS.
 THESE PLANS ARE READ IN CONJUNCTION WITH APPROVED ARCHITECTURAL, STRUCTURAL, HYDRAULIC AND MECHANICAL DRAWINGS AND SPECIFICATIONS.
- CARE IS TO BE TAKEN WHEN EXCAVATING NEAR SERVICES. NO MECHANICAL EXCAVATION ARE TO BE UNDERTAKEN OVER TELECOMMUNICATION OR ELECTRICAL SERVICES. HAND EXCAVATE IN THESE AREAS ONLY.
- 5. DIAL 1100 BEFORE YOU DIG FOR LOCATION OF UNDERGROUND SERVICES PRIOR TO ANY CONSTRUCTION WORKS.
- 6. SERVICES HAVE NOT BEEN SHOWN ON THIS PLAN. FIELD INVESTIGATIONS ARE TO BE CARRIED OUT SEPARATELY TO DETERMINE EXACT POSITIONS OF SERVICES OR INFORMATION IS TO BE PROVIDED BY THE PROPERTY PROPRIETOR. NOT WITSTANDING THIS, ALL INFORMATION PROVIDED SHALL BE VERIFIED BY THE CONTRACTOR PRIOR TO COMMENCEMENT OF
- CONSTRUCTION WORKS. 7. THESE DRAWINGS ARE ONLY APPROVED WHEN THEY ARE SIGNED WITH AN ORIGINAL SIGNATURE BY THE ENGINEER.

STORMWATER DRAINAGE

- 8. ALL WORKS TO BE CARRIED OUT IN ACCORDANCE WITH AS 3500 AND THE REQUIREMENTS OF THE LOCAL COUNCIL'S POLICIES AND CODES.
- 9. ALL GUTTERS TO BE 100 x 75 MIN. AND DOWNPIPES TO BE 100 x 75 (76 DIA.) UNLESS OTHERWISE NOTED.
- ALL PIPES TO BE 100mm uPVC SEWER GRADE UNLESS NOTED OTHERWISE.
 ALL GRADIENTS FOR STORMWATER PIPES TO BE NOT LESS THAN 1.0% UNLESS NOTED OTHERWISE.
- 12. THE INVERTS OF ALL OUTLET PIPES ARE TO BE INSTALLED FLUSHED WITH THE BASE OF ALL
- STORMWATER/RAINWATER PIT. 13. ALL FENCES SHALL BE KEPT AT LEAST 100mm ABOVE THE GROUND LEVEL TO FACILITATE THE FREE PASSAGE FOR STORMWATER OVERLAND FLOW.
- MANUFACTURER'S CERTIFICATE SHALL BE OBTAINED BY THE BUILDER FOR PIPES, PRE-CAST PITS AND GRATES FOR THE STRUCTURAL ADEQUACY RELATING TO ITS LOCATION.
- 15. AREAS SPREAD WITH BARK SHALL BE BARRICADED TO PREVENT BARK GETTING INTO THE PITS AND STORMWATER SYSTEMS.
- MINIMUM SLOPE FOR PAVED AREAS SHALL BE 0.5%, FOR LANDSCAPED AREAS MINIMUM SLOPE SHALL BE 1% AND GRADED TOWARDS THE GRATED PITS.
 ALL EXCAVATIONS WITHIN THE INFLUENCE OF BUILDINGS AND SERVICES SHALL BE UNDERTAKEN WITH THE
- KNOWLEDGE OF THE HYDRAULIC AND STRUCTURAL ENGINEER.
 18. THE DETENTION AND DRAINAGE SYSTEM SHALL BE MAINTAINED AT REGULAR INTERVALS AND THE CONTRACTOR SHALL MAKE NECESSARY ARRANGEMENTS.
- CONNECTION OF DISCHARGE PIPE TO EXISTING COUNCIL KERB AND GUTTER, PIPE OR KERB INLET PIT SHALL BE CARRIED OUT IN ACCORDANCE WITH COUNCIL'S REQUIREMENTS.
- 20. PROVIDE STEP-IRONS 'MASCOT S1:104' OR SIMILAR STAGGERED TO GIVE SPACING 300 VERTICAL AND 220 HORIZONTAL TO ALL PIT DEEPER THAN 1m .
- 21. SUITABLE AG-LINES SHALL BE PROVIDED AND CONNECTED TO STORMWATER SYSTEM OR AS INSTRUCTED BY THE ENGINEER ON SITE PRIOR TO BACKFILLING.


RAINWATER TANK


- 22. DRAWING IS TO BE READ IN CONJUNCTION WITH SYDNEY WATER'S "PLUMBING REQUIREMENTS GUIDELINES FOR RAINWATER TANKS ON RESIDENTIAL PROPERTIES".
- 23. ALL PLUMBING WORK UNDERTAKEN ON OR FOR THE TANK THAT AFFECTS THE WATER SERVICE PIPE OR WATER MAIN MUST BE UNDERTAKEN WITH THE CONSENT OF SYDNEY WATER IN ACCORDANCE WITH THE REQUIREMENTS OF SYDNEY WATER, AND THE MANUFACTURER'S SPECIFICATIONS.
- 24. ALL PLUMBING WORKS UNDERTAKEN SHALL BE UNDERTAKEN BY A LICENSED PLUMBER IN ACCORDNACE WITH THE NEW SOUTH WALES CODE OF PRACTICE PLUMBING AND DRAINAGE PRODUCED BY THE COMMITTEE ON UNIFORMITY OF PLUMBING AND DRAINAGE REGULATIONS IN NEW SOUTH WALES.
- 25. ALL PLUMBING MUST BE COMPLETED BY A LICENSED PLUMBER IN COMPLIANCE WITH AS/NZS3500.5, AND ANY OTHER RELEVANT NATIONAL STANDARDS.
- 26. INLET TO THE RAINWATER TANKS MUST BE SCREENED OR FILTERED TO PREVENT ENTRY OF FOREIGN MATTER AND CREATURES.
- 27. THE RAINWATER TANKS MUST BE MAINTAINED AT ALL TIMES SO AS NOT TO CAUSE A NUISANCE WITH RESPECT TO MOSQUITO BREEDING OR OVERLAND FLOW OF WATER.
 28. A SIGN MUST BE AFEIVED TO THE PAINWATER TANKS CLEARLY STATING THAT THE WATER IN THE TANKS IS
- A SIGN MUST BE AFFIXED TO THE RAINWATER TANKS CLEARLY STATING THAT THE WATER IN THE TANKS IS RAINWATER.
 BOTH THE RE-USE AND ANY FITTINGS CONNECTED TO THE RAINWATER TANKS MUST BE LABELED "RAINWATER , NOT
- SUITABLE FOR DRINKING".
 ALL ROOF GUTTERS ARE TO BE FITTED WITH LEAF GUARDS AND INSPECTED REGULARLY AND CLEANED TO ENSURE
- LEAF LITTER CANNOT ENTER THE DOWNPIPES.
- 31. PRESSURE PUMP ELECTRICAL CONNECTION TO BE CARRIED OUT BY A LICENSED ELECTRICIAN.

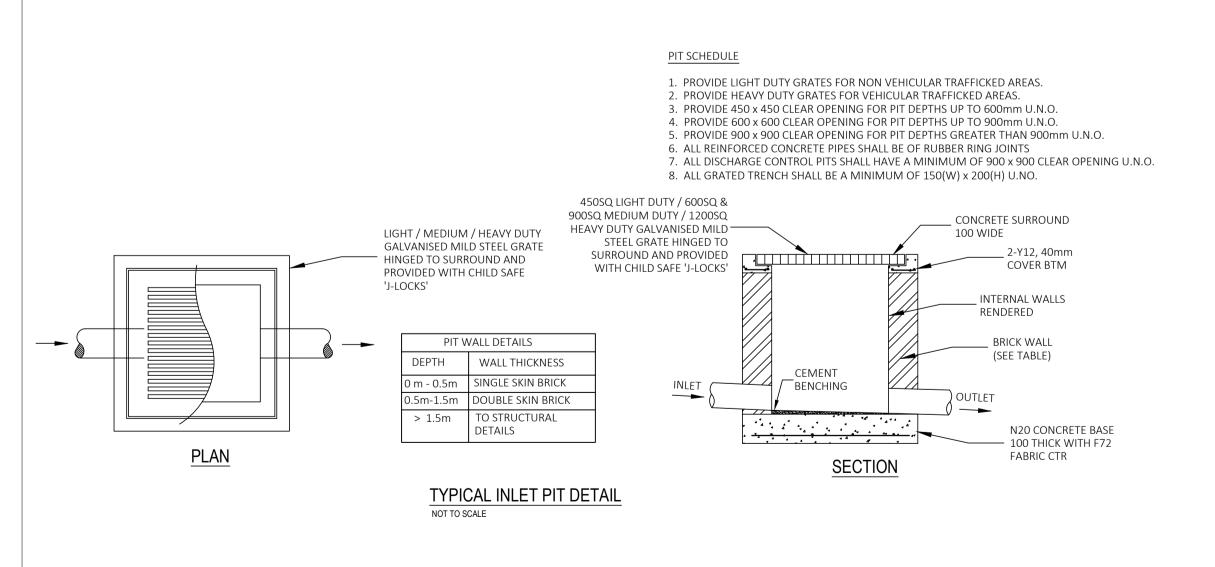


Copyright

			Drawn & Designed By	
			Checked By :	
С	Update for S82 Review Submission	8 Dec. 2021	Ист	
В	Incorporate Council's Comments re WSUD	20 Apr. 2021	Approved By : Kenr	
А	Development Application	28 Jan. 2021	Laton the Registere Road & D Registere (Bar No.	
lssue	Description	Date of Drawing	(Reg. No. & Profess NSW Fair	

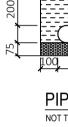

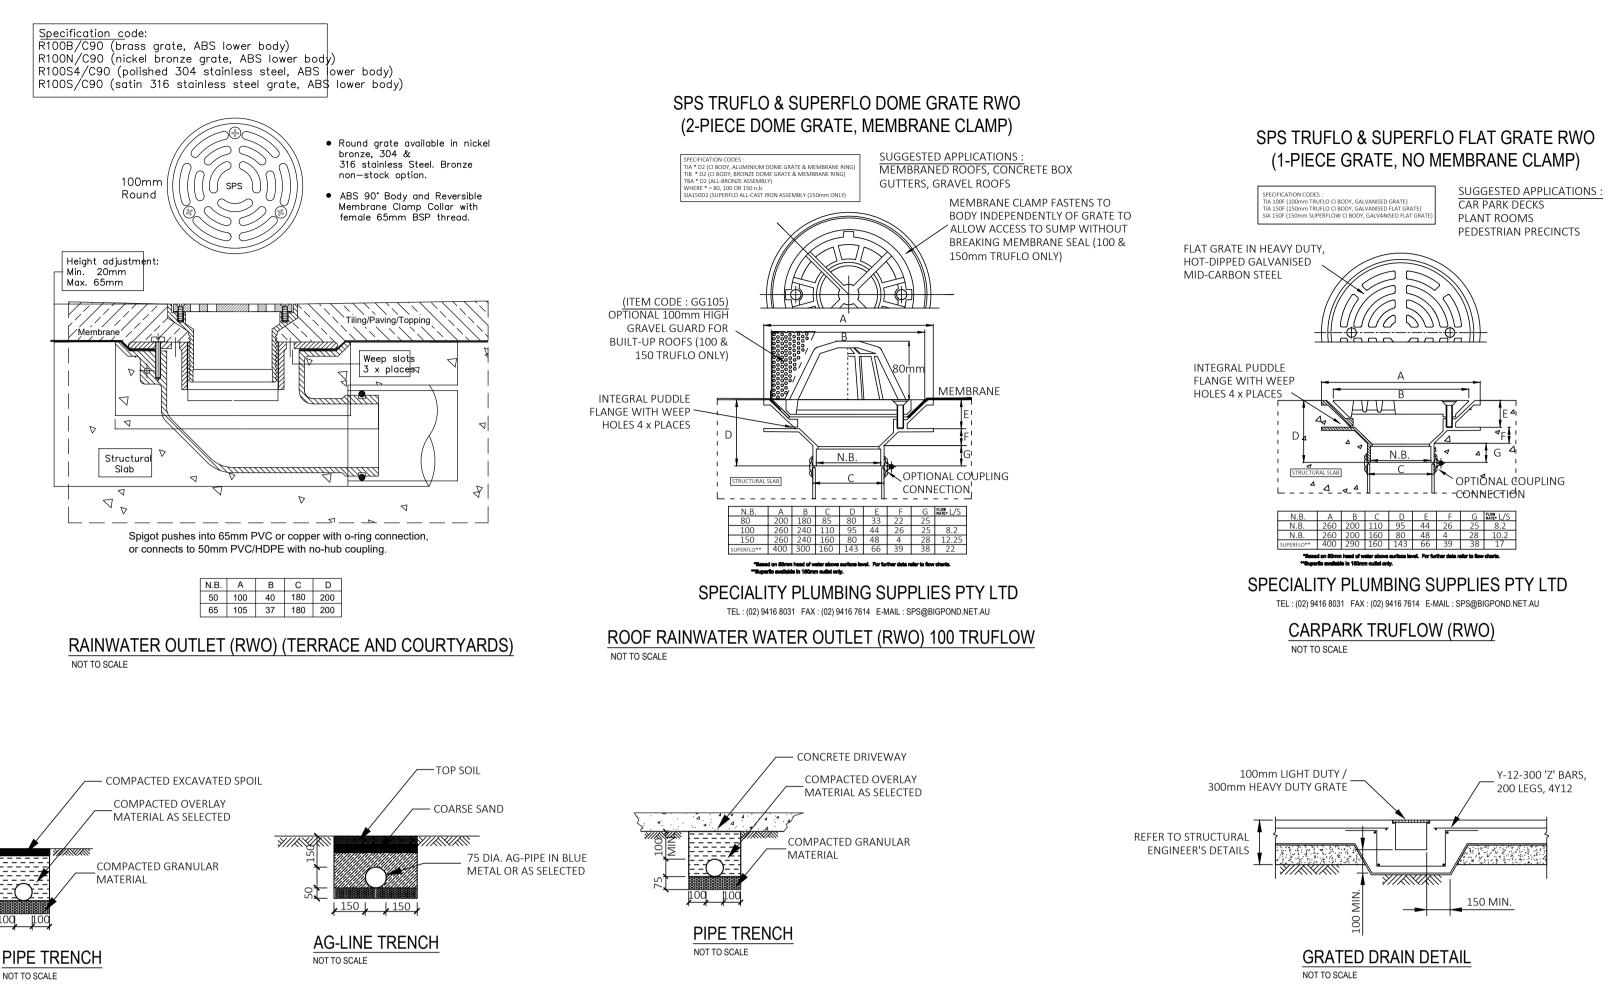


NOT FOR CONSTRUCTION

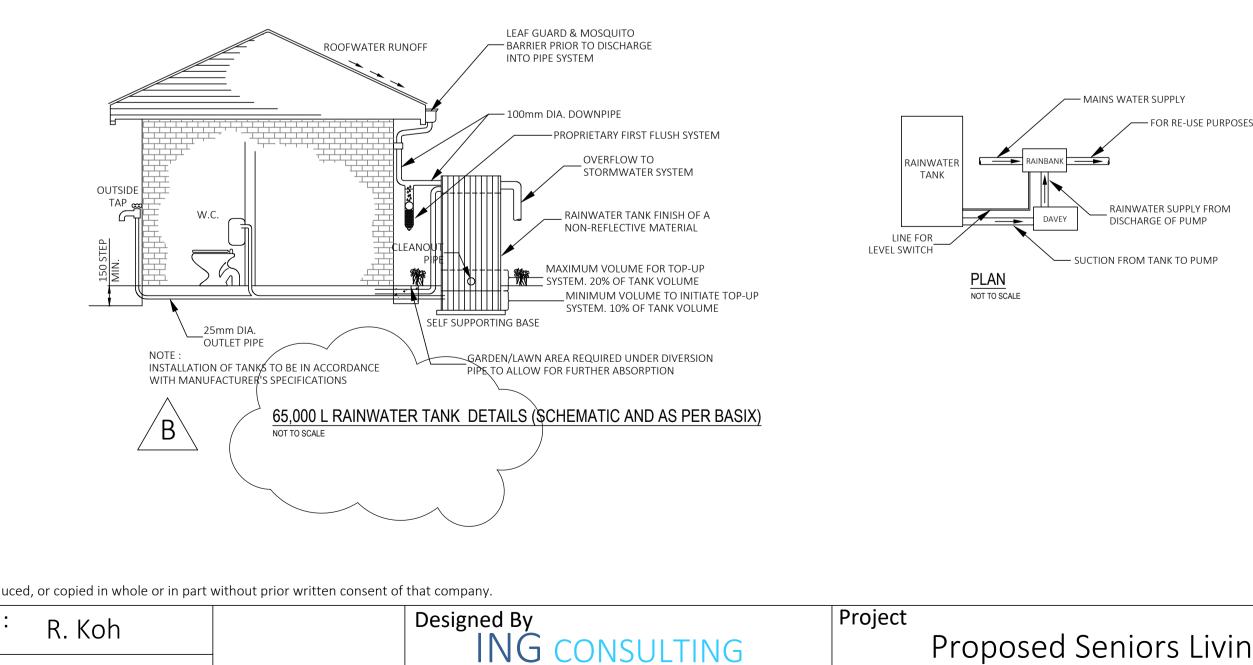

N. Evans
h T. NG
g NER APEC Engineer
g. No. 2206352) RPEQ
rtifier (Hydraulic (stormwater),
ge and Stormwater) (Reg. No. BDC0827)
sign Practitioner (Drainage & Civil Engineering)
0000692)
l Engineer (Civil) (Reg. No. DEP0000630)
•

ING CONSULTING		FTOPOSEU SEITIOIS LI
NGINEERS PTY LTD P. O BOX 1543	At	5 Skyline Place
BAULKHAM HILLS NSW 1755		Frenchs Forest NSW
· : (02) 8807 5656	Client	
И: 0433 778 109		
: ken@ingengineers.com.au		


iving (Stage 2)	Drawing Title Notes & Details		
V 2086	Date January 2021	Scale As Shown @ A1	
	Project No.	Drawing & Sheet No./Issue	
	284012021DA	28401-16/18 / C	

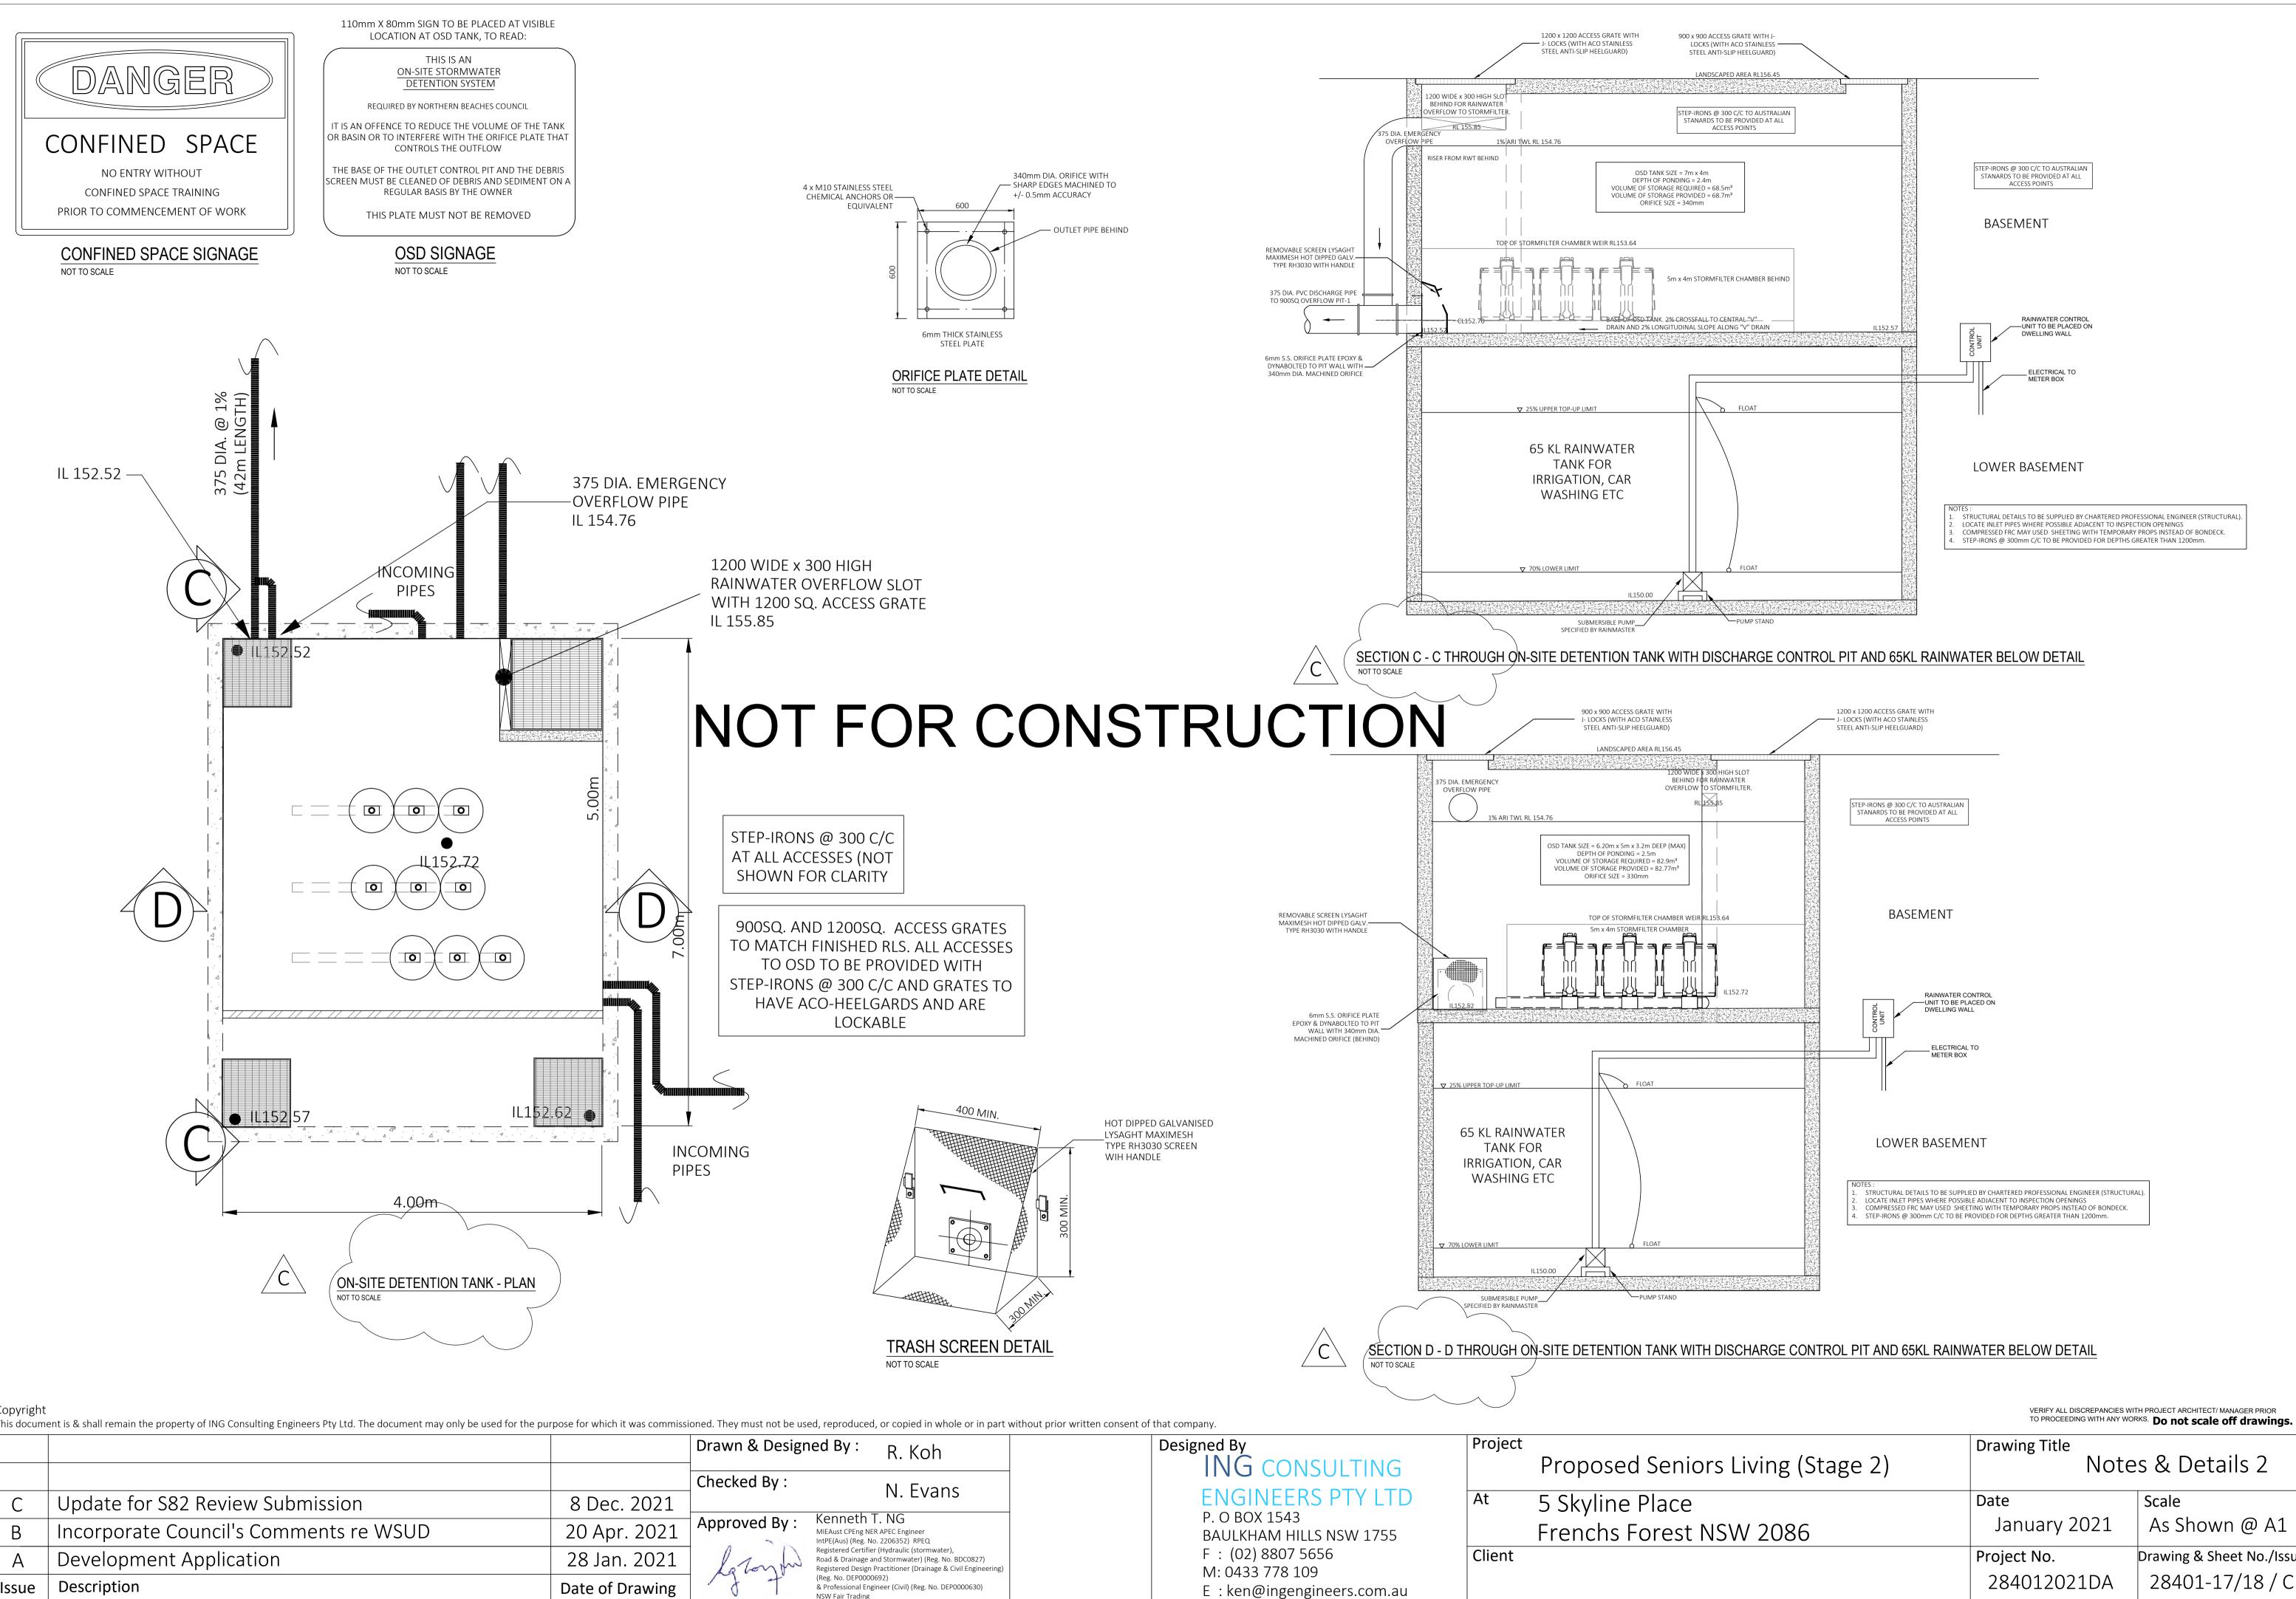

Copyright


			Drawn & Design	ned By :
			Checked By :	
С	Update for S82 Review Submission	8 Dec. 2021		
В	Incorporate Council's Comments re WSUD	20 Apr. 2021	Approved By :	Kenneth MIEAust CPEng NE IntPE(Aus) (Reg. N
А	Development Application	28 Jan. 2021	la Longon	Registered Certifie
Issue	Description	Date of Drawing	~J. +	(Reg. No. DEP0000 & Professional Eng NSW Fair Trading

iving (Stage 2)	ng (Stage 2) Drawing Title Notes & Detail		
V 2086	Date January 2021	Scale As Shown @ A1	
	Project No.	Drawing & Sheet No./Issue	
	284012021DA	28401-17/18 / C	

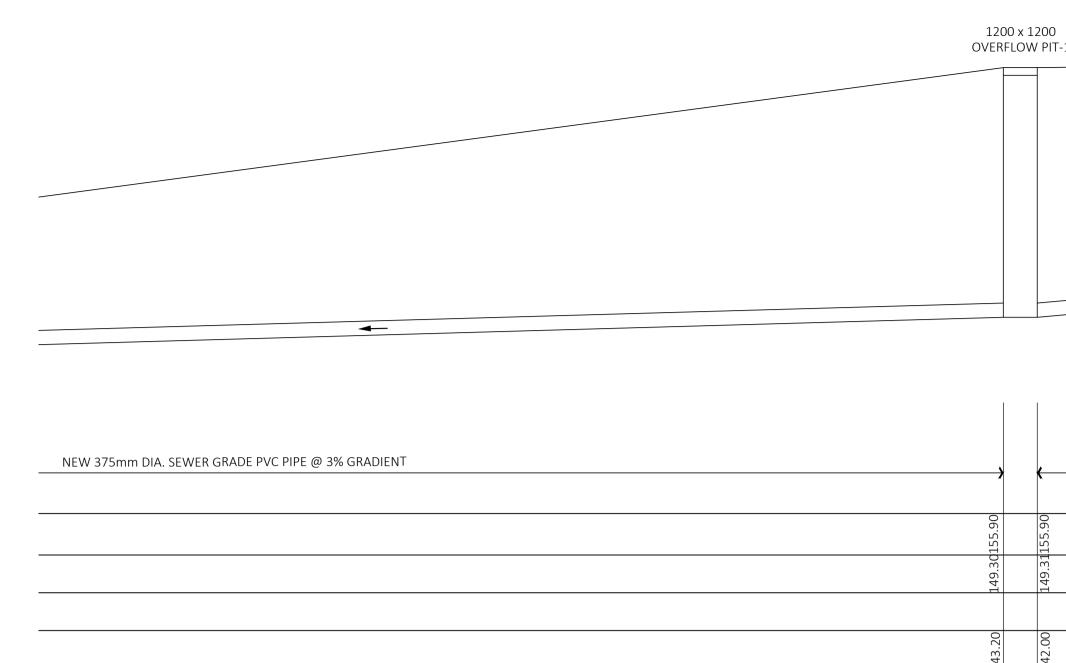

NOT



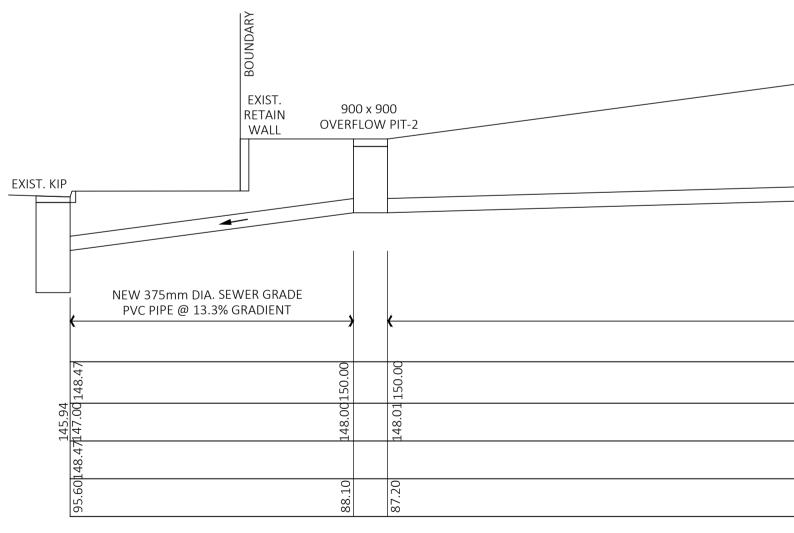

Copyright

			Drawn & Designed By :
			Checked By :
С	Update for S82 Review Submission	8 Dec. 2021	Kannath
В	Incorporate Council's Comments re WSUD	20 Apr. 2021	Approved By : Kenneth MIEAust CPEng N IntPE(Aus) (Reg. 1
А	Development Application	28 Jan. 2021	Registered Certif Road & Drainage Registered Desig (Reg. No. DEPOOD
lssue	Description	Date of Drawing	(Reg. No. DEP000 & Professional Er NSW Fair Trading

	EXISTING / PROPOSED SUI	RFACE LEVEL
) T-1		
		4
		$\sim\sim$
	NEW 375mm DIA. SEWE	ER GRADE PVC PIPE @ 7.6% GRADIENT
OSD / P	PIPE LONGITUDINAL SECTION	
SCALE 1:10	0	
	DNSTRUCTIO	
	NEW 375mm DIA. SEWER GRADE PVC PIPE @ 3% GRADIENT	
SCALE 1:100	ELONGITUDINAL SECTION (CON	TINUE)
SCALE 1.100		
ced, or copied in whole or in part without prior wr	itten consent of that company. Designed By	Project
R. Koh	ING CONSULTING	Proposed Seniors Li
N. Evans	ENGINEERS PTY LTD P. O BOX 1543	At 5 Skyline Place
g NER APEC Engineer g. No. 2206352) RPEQ tifier (Hydraulic (stormwater), ge and Stormwater) (Reg. No. BDC0827)	BAULKHAM HILLS NSW 1755 F : (02) 8807 5656	Frenchs Forest NSW
ign Practitioner (Drainage & Civil Engineering) 1000692) Engineer (Civil) (Reg. No. DEP0000630) ing	M: 0433 778 109 E : ken@ingengineers.com.au	

		OSD TANK ON BASEMENT LEVEL	
	I		
		DATUM RL 156.00	
	156.30	EXIST. / PROPOSED SURFACE LEVEL	
		EXIST. LEVEL (GUTTER)	
Ć	152.52	PROPOSED INVERT LEVEL (PIPE)	
	0.00	CHAINAGE	

1200 x 1200		
OVERFLOW PIT-1		

	
.30155.90	55.90
149.301	149.311
43.20	42.00

	Drawing Title	OSD and	
iving (Stage 2)	Discharge Pipe Long Section		
	Date	Scale	
V 2086	January 2021	1:100 @ A1	
	Project No.	Drawing & Sheet No./Issue	
	284012021DA	28401-18/18 / C	