

GENERAL NOTES:

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3. All work to be in accordance with BUILDING CODE of AUSTRALIA & to the satisfaction of local council requirements & other authorities.

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6 Roof water & sub-soil drainage to be disposed of in the approved manner or as directed by local council inspectors. 7 All electrical power & light outlets to be determined by owner. 8 Make good and repair all existing finishes damaged by new work. Reuse existing material where possible.

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DESIGN BY:

MICHAL KORECKY

21 NALYA ROAD, NARRAWEENA NSW 2099 ABN: 79 393 130 294

Email: koreckym@gmail.com Phone: 99813332, Mob: 0438 148 944

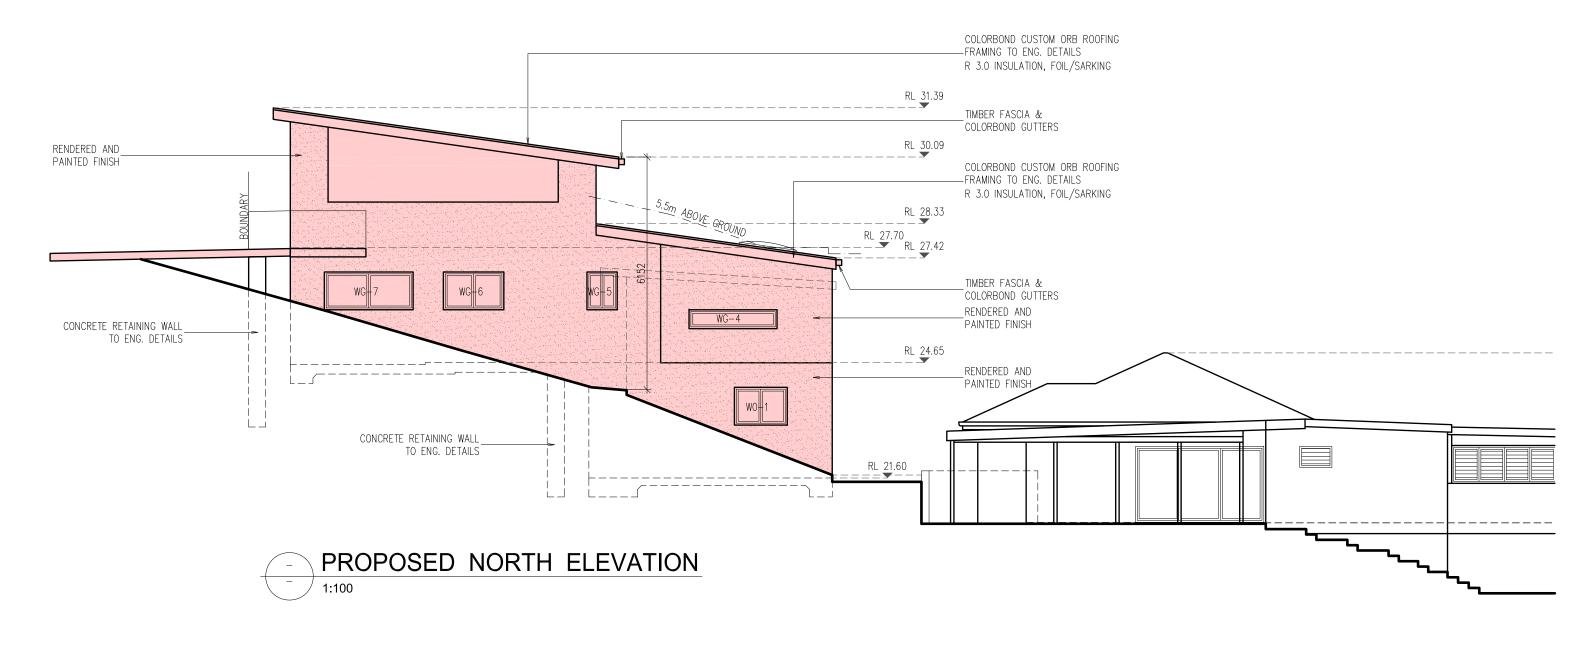
BON KAIN

PROJECT: PROPOSED ADDITIONS AND ALTERATIONS No 30 NARRABEEN PARK PARADE WARRIEWOOD NSW 2102

LOT 23 DP 15763

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DATE:	10/08/19	SCALE:	AS NOTED
DRAWN:	MK	ISSUE:	1
DRAWING	9006	SHEET:	1

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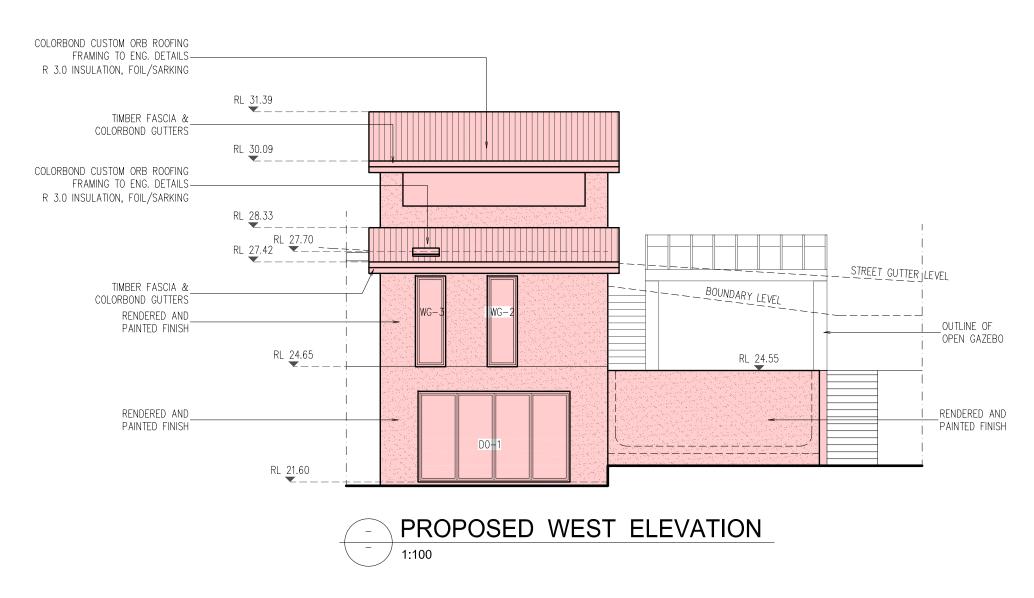
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PROPOSED ADDITIONS AND ALTERATIONS No 30 NARRABEEN PARK PARADE WARRIEWOOD NSW 2102 CLIENT: BON KAIN LOT 23 DP 15763

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	DATE: 10/08/	9 SCALE: AS	NOTED			
	DRAWN: MK	ISSUE:	1			
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	WINDOWS AND DOOR SCHEDULE						
	ORIENT.	SIZE		AREA (m2)	SHADING DEVICE	FRAME AND GLASS TYPE	
	OINILIVI.	W	Н	/ (1112)	SINDING BEVIOL	MIN. REQUIREMENTS	
WG-1	SOUTH	1810	2400	4.34			
WG-2	WEST	800	2400	1.92			
WG-3	WEST	800	2400	1.92			
WG-4	NORTH	2330	500	1.17			
WG-5	NORTH	800	1000	0.80			
WG-6	NORTH	1600	1000	1.60			
WG-7	NORTH	2350	1000	2.35			
WG-8	SOUTH	500	1000	0.50			
DG-1	SOUTH	2400	2400	5.76			
DG-2	SOUTH	2700	2400	6.48			
W0-1	NORTH	1400	1000	10.5			
D0-1	WEST	4020	2400	9.65			

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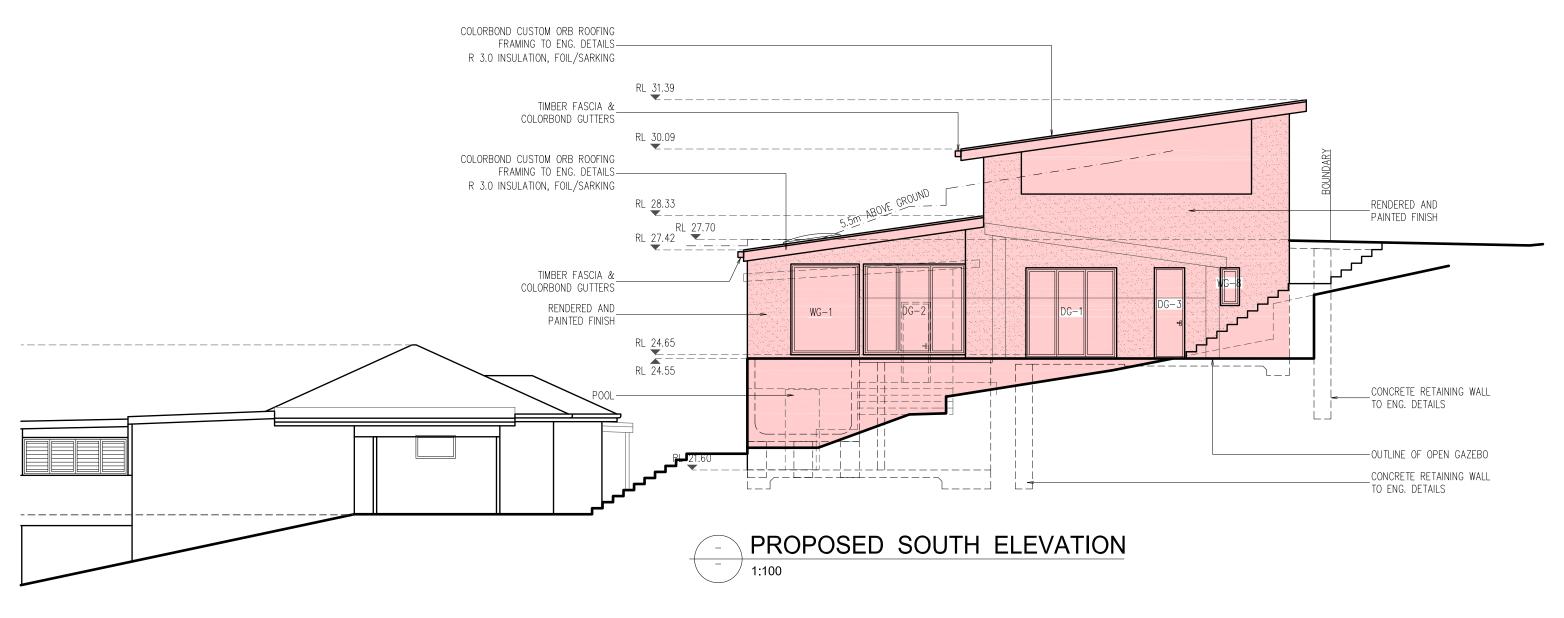
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POOL FENCES

Essentially a barrier fence can be made of any material that has a reasonable life span when exposed to the likely conditions of weather, pool chemicals, pollution, decay, insects, salt water spray, etc. Fences must have an effective perpendicular height of 1.2 metres. Existing standard paling fences can be used provided that they are well-maintained and at least 1650mm high. If the rails are on the outside of the pool area, then 60 degree splayed sections are to be fitted securely to the middle and top rails (unless fence height is over 2400mm).

When a fence is not controlled by the pool owners, i.e. a neighbour's boundary fence, then the pool area must be protected for a radius of 1.2 metres by an approved safety fence.

Ground clearance between bottom of fence and ground level is not to exceed 100mm and any horizontal rails, rods, etc, which could assist climbing, should be on the pool side of the fence. If they're on the outside, they should be at least 900mm apart. The space between vertical members must not exceed 100mm.

POOL GATES

These must open outward only and have an effective perpendicular height of 1.2 metres. They must return to the closed position and engage the latch automatically from any position and not re-open without using the manual release mechanism. The latch must be at least 1.5 metres above ground level unless it is inside the fence can only be reached over or through a fence higher than 1.2 metres or is 150mm below the fence top (no hand hole) or at least 150mm away from the edge of any hand hole opening. Latches less than 1.5 metres above ground level must be shielded so that no opening greater than 10mm is closer than 450mm. Any hand hole shall be at least 1.2 metres from ground level.

10 M SCALE 1:100

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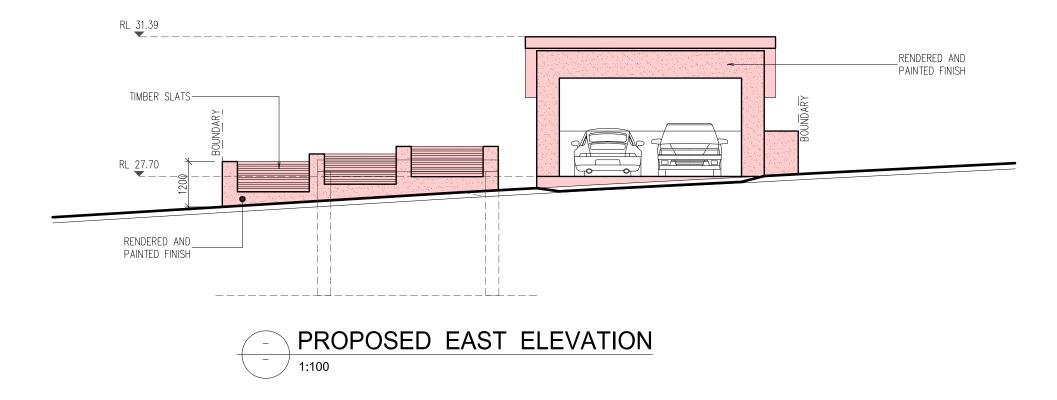
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