DRAWING REGISTER


Issue Date									
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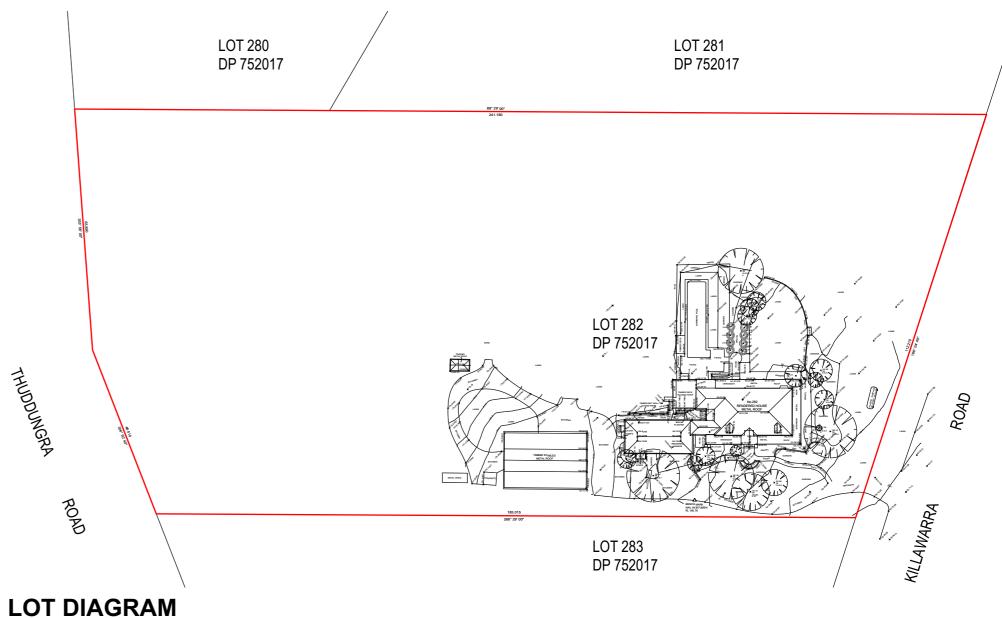
Drawing Number	Drawing Title	Revision
A00	Drawing Register & Location Plan	0
A01	Site Analysis Plan 1:200	0
A02	Site Plan 1:200, Area Calculations	0
A03	Ground Floor Plan - Existing 1:100	0
A04	Ground Floor Plan - Proposed 1:100	0
A05	First Floor Plan - Proposed 1:100	0
A06	North & East Elevation 1:100	0
A07	South & West Elevation 1:100	0
A08	Section A 1:100, Pedestrian Entry Gate Plan / Elevation	0
A09	Section B, Section C 1:100	0
A10	Erosion & Sediment Control Plan 1:200	0
A11	External Window & Door Schedule / External Finishes Schedule	0
A12	BASIX Requirements (sheet 1)	0

Document Distribution:	DA1
Client	0
Structural Engineer	
Hydraulic Engineer	
Landsc. Consultant	
Approval Authority	0

GENERAL BUILDING SPECIFICATION

- All general construction to conform to the current BCA and Local Govt conditions of Development Consent.
- Demolition works to be carried out in accordance with AS 2601.
- All masonry work in accordance with AS 3700.
- Termite protection to be installed in accordance with AS 3660.1 and the current BCA.
- All roof water and storm-water runoff to be connected to a Council approved system of collection and/or disposal.
- All carpentry work to conform to AS1684 for Light Timber Framing.
- All sewer waste to be connected to an on-site system accordance with AS 3500.
- All pre-fabricated timber trusses and frames to utilize sustainable plantation timbers installed to the manufacturer's detail and specification.
- All concrete slabs, retaining walls, structural steel, foundations and footings to be designed & specified by the consulting structural engineer and built strictly in accordance with such details, as approved.
- Plumbing services to be carried out only by licenced tradespersons and in accordance with AS 3500.3.2, AS 3500.2.2, AS 3500.1.2, AG 601 and other associated standards and codes.
- All electrical services to be installed by licenced electricians and in accordance with AS3000. Telecommunications cabling to be installed in accordance
- with AS/ACIF S009:2000 and associated standards and guidelines. Upgrade safety switches & smoke alarms as required to meet relevant standards.
- All measurements shown and scheduled are nominal. The contractor shall check all measurements on site before ordering materials and check any anomalies with Cadence & Co Design before proceeding.
- All insulation to be provided and installed in accordance with AS4859.1, AS3999 (bulk insul'n), AS1904 (foil insul'n) and associated standards and codes.
- Proposed RL's shown on drawings are to be FINISHED LEVELS. Builder to provide set down's and allowances to accommodate finished levels.



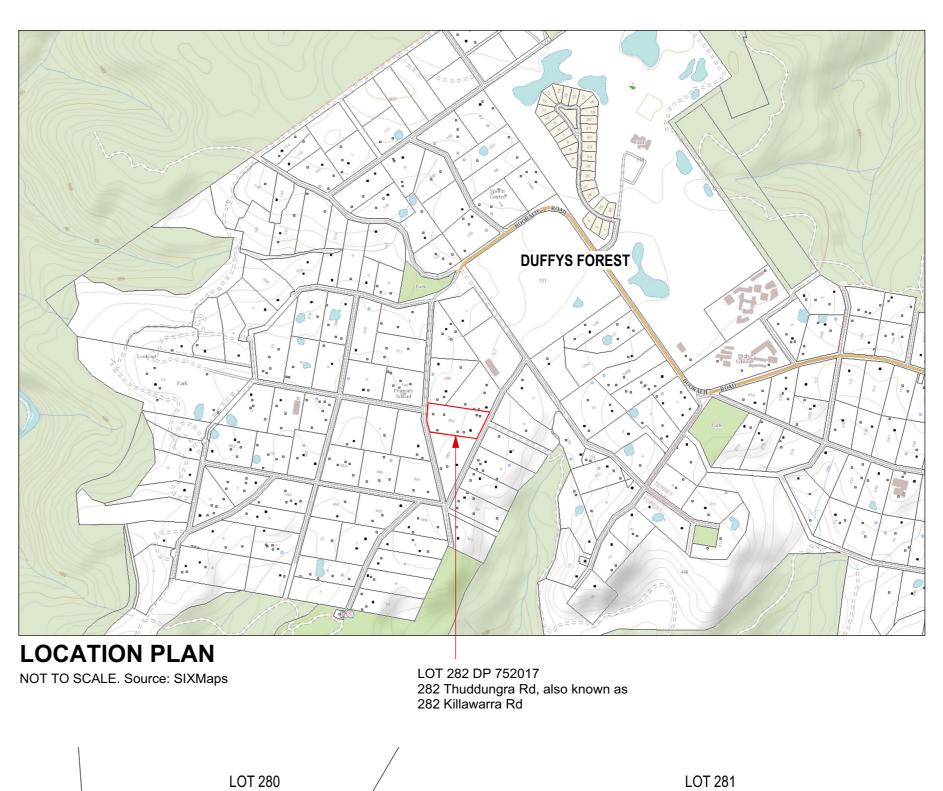





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REVISION DATE REVISION NOTE

1:1000. Source: Survey

F

CLIENT:
Kristi & Sean Muffet

PROJECT:
282 Thuddungra Road, Duffys Forest
Being LOT 282 in D.P. 752017

DRAWING:
Drawing Register

PROJECT NO: ISSUE TYPE:
H18/109
DA1

SHEET NO:

A00

SCALE @ A2:

REVISION:


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CHKD:

ISSUE DATE:

6/8/19

NERAL NOTES: ALL RL'S SHOWN ARE FINISHED LEVELS, BUILDER TO PROVIDE SET DOWNS & ALLOWANCES AS REQUIRED. ALL OPENING DIMENSIONS ARE NOMINAL, BUILDER TO CHECK SIZES ON-SITE BEFORE ORDERING WINDOW AND DOOR

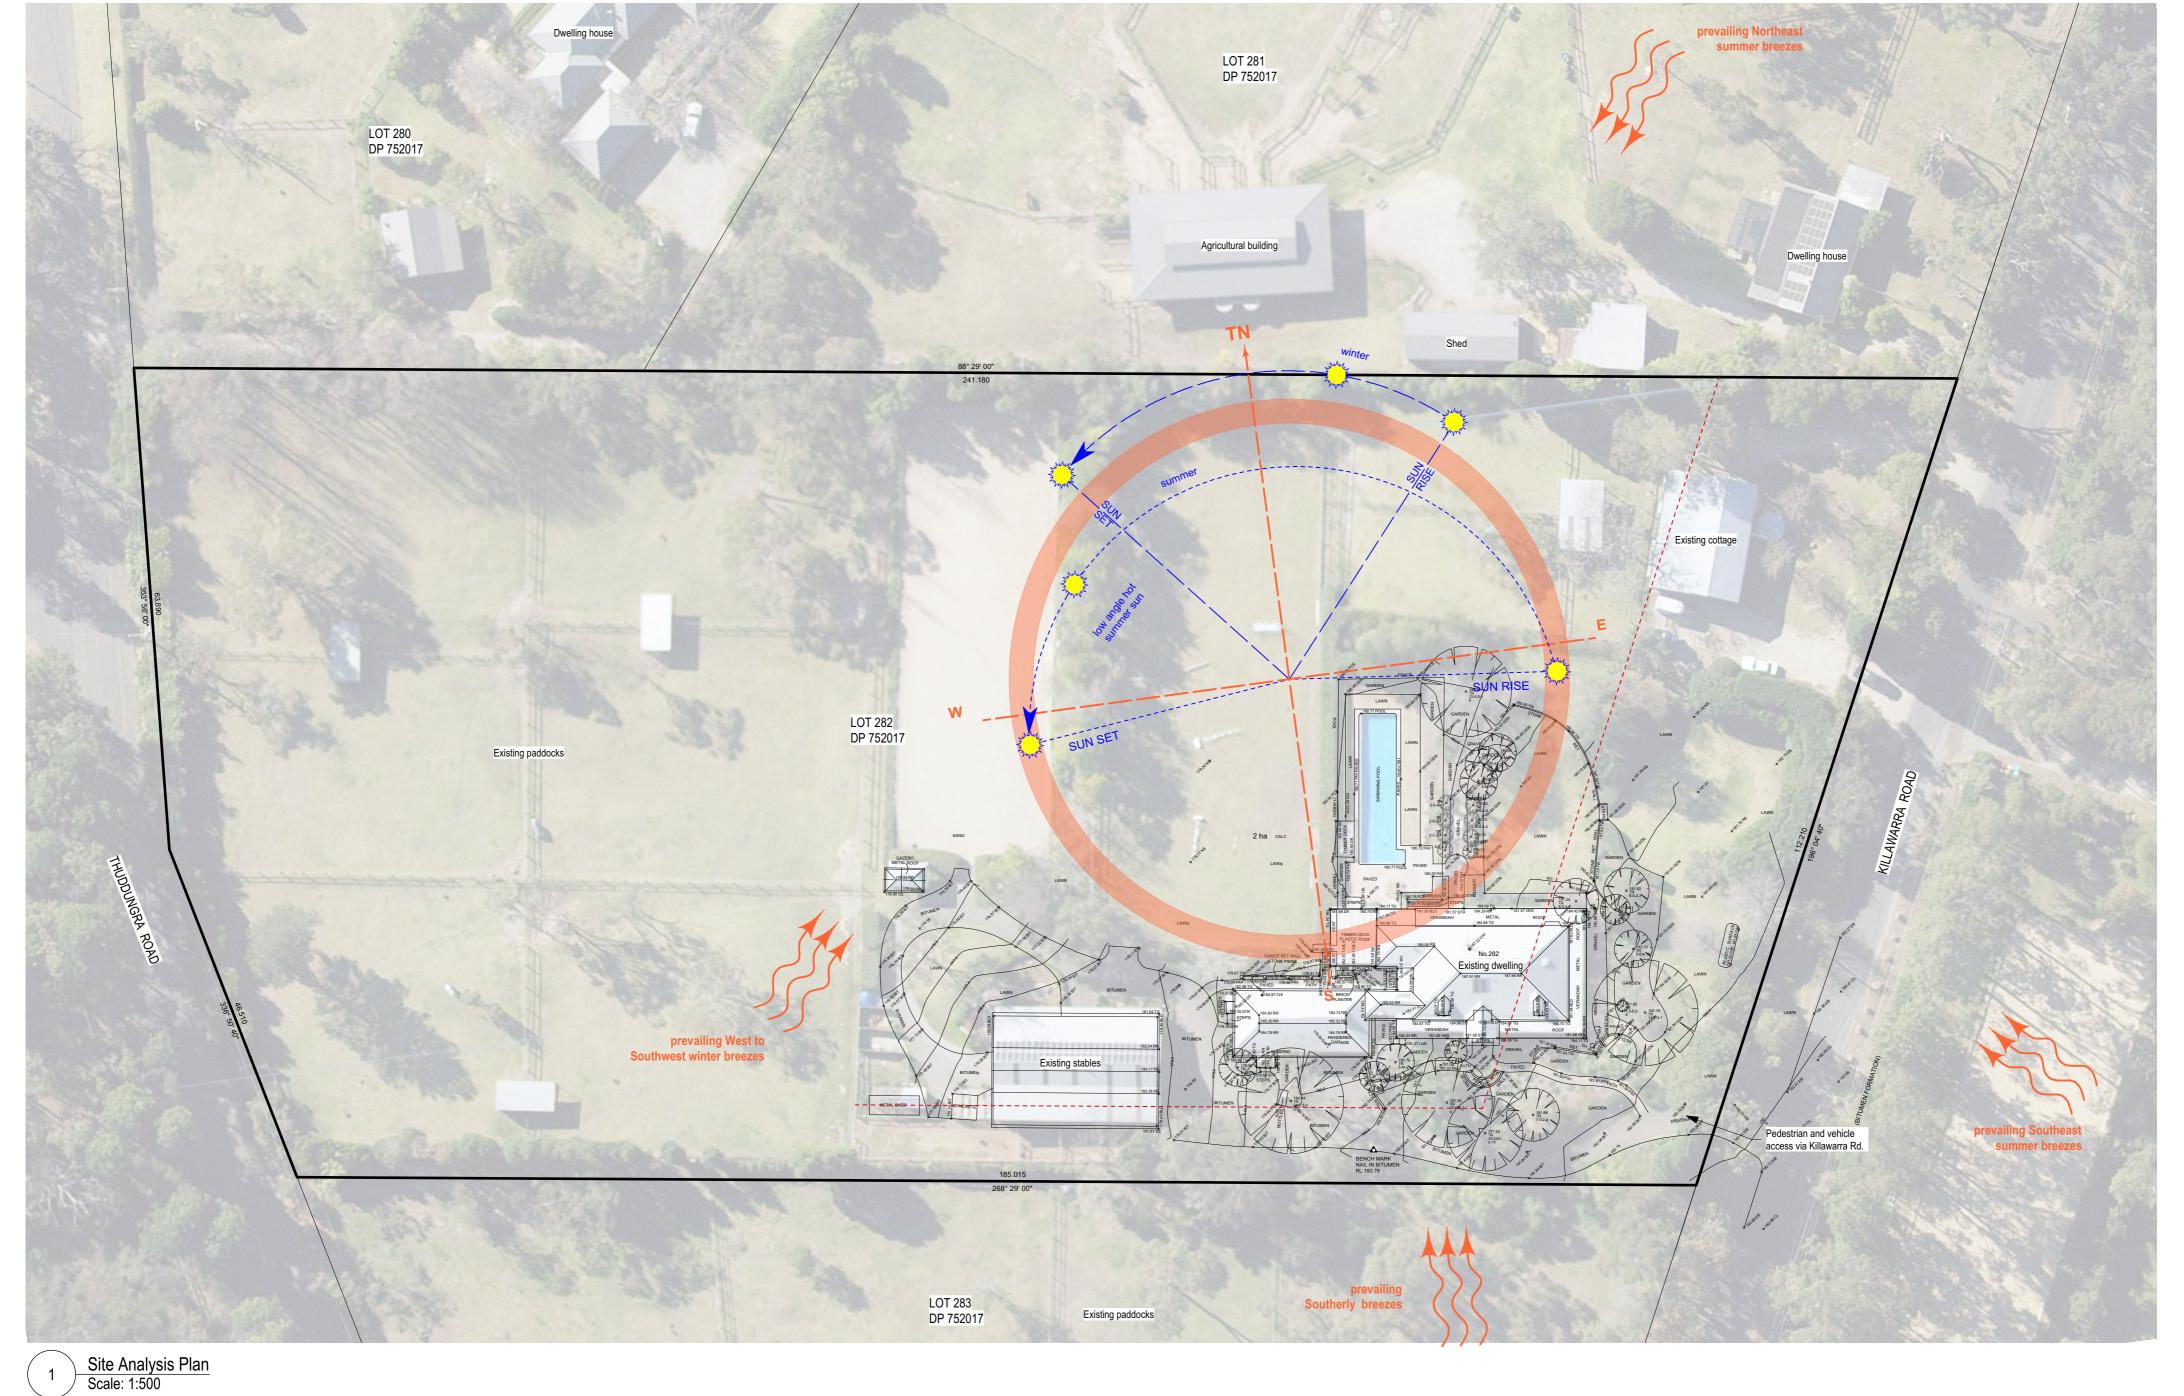

Scale: 1:500

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REVISION DATE REVISION NOTE

CLIENT:
Kristi & Sean Muffet

Site Analysis

PROJECT:
282 Thuddungra Road, Duffys Forest Being LOT 282 in D.P. 752017

DRAWING:
Site Analysis

PROJECT NO:
ISSUE TYPE:

H18/109

DA1


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A01


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SCALE @ A2:
1:500


ISSUE DATE:
REVISION:
6/8/19


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GENERAL NOTES: ALL RL'S SHOWN ARE FINISHED LEVELS, BUILDER TO PROVIDE SET DOWNS & ALLOWANCES AS REQUIRED. ALL OPENING DIMENSIONS ARE NOMINAL, BUILDER TO CHECK SIZES ON-SITE BEFORE ORDERING WINDOW AND DO



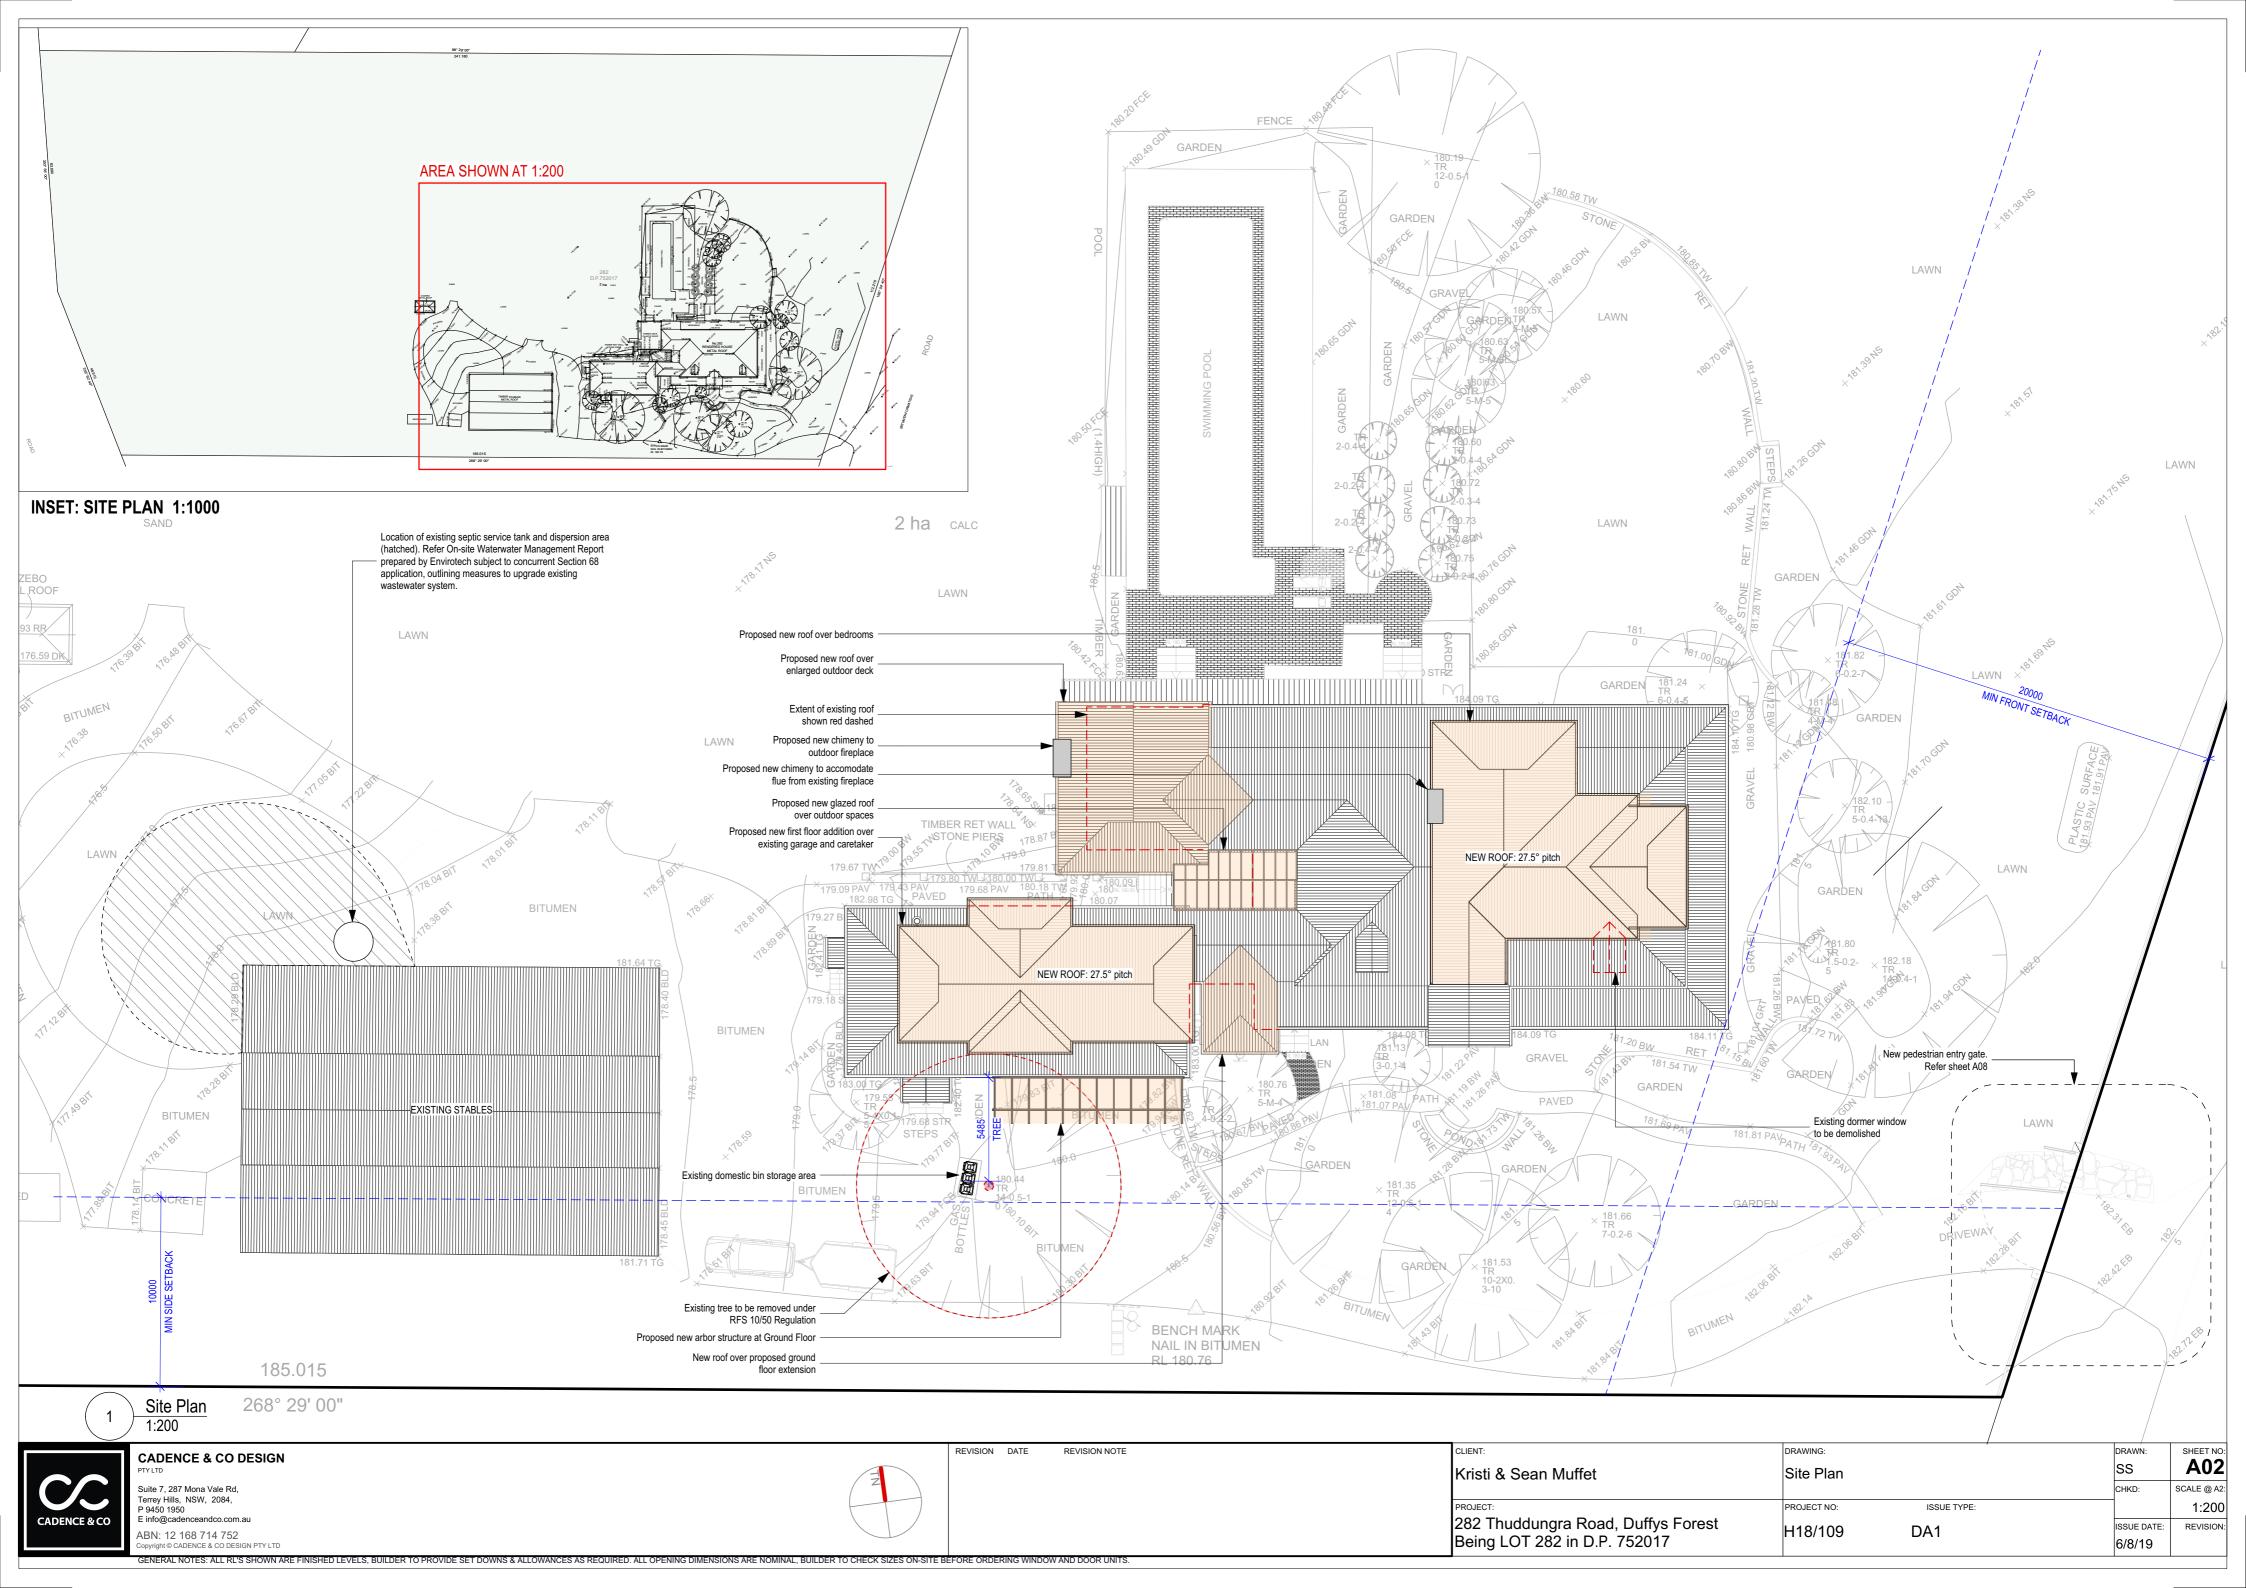

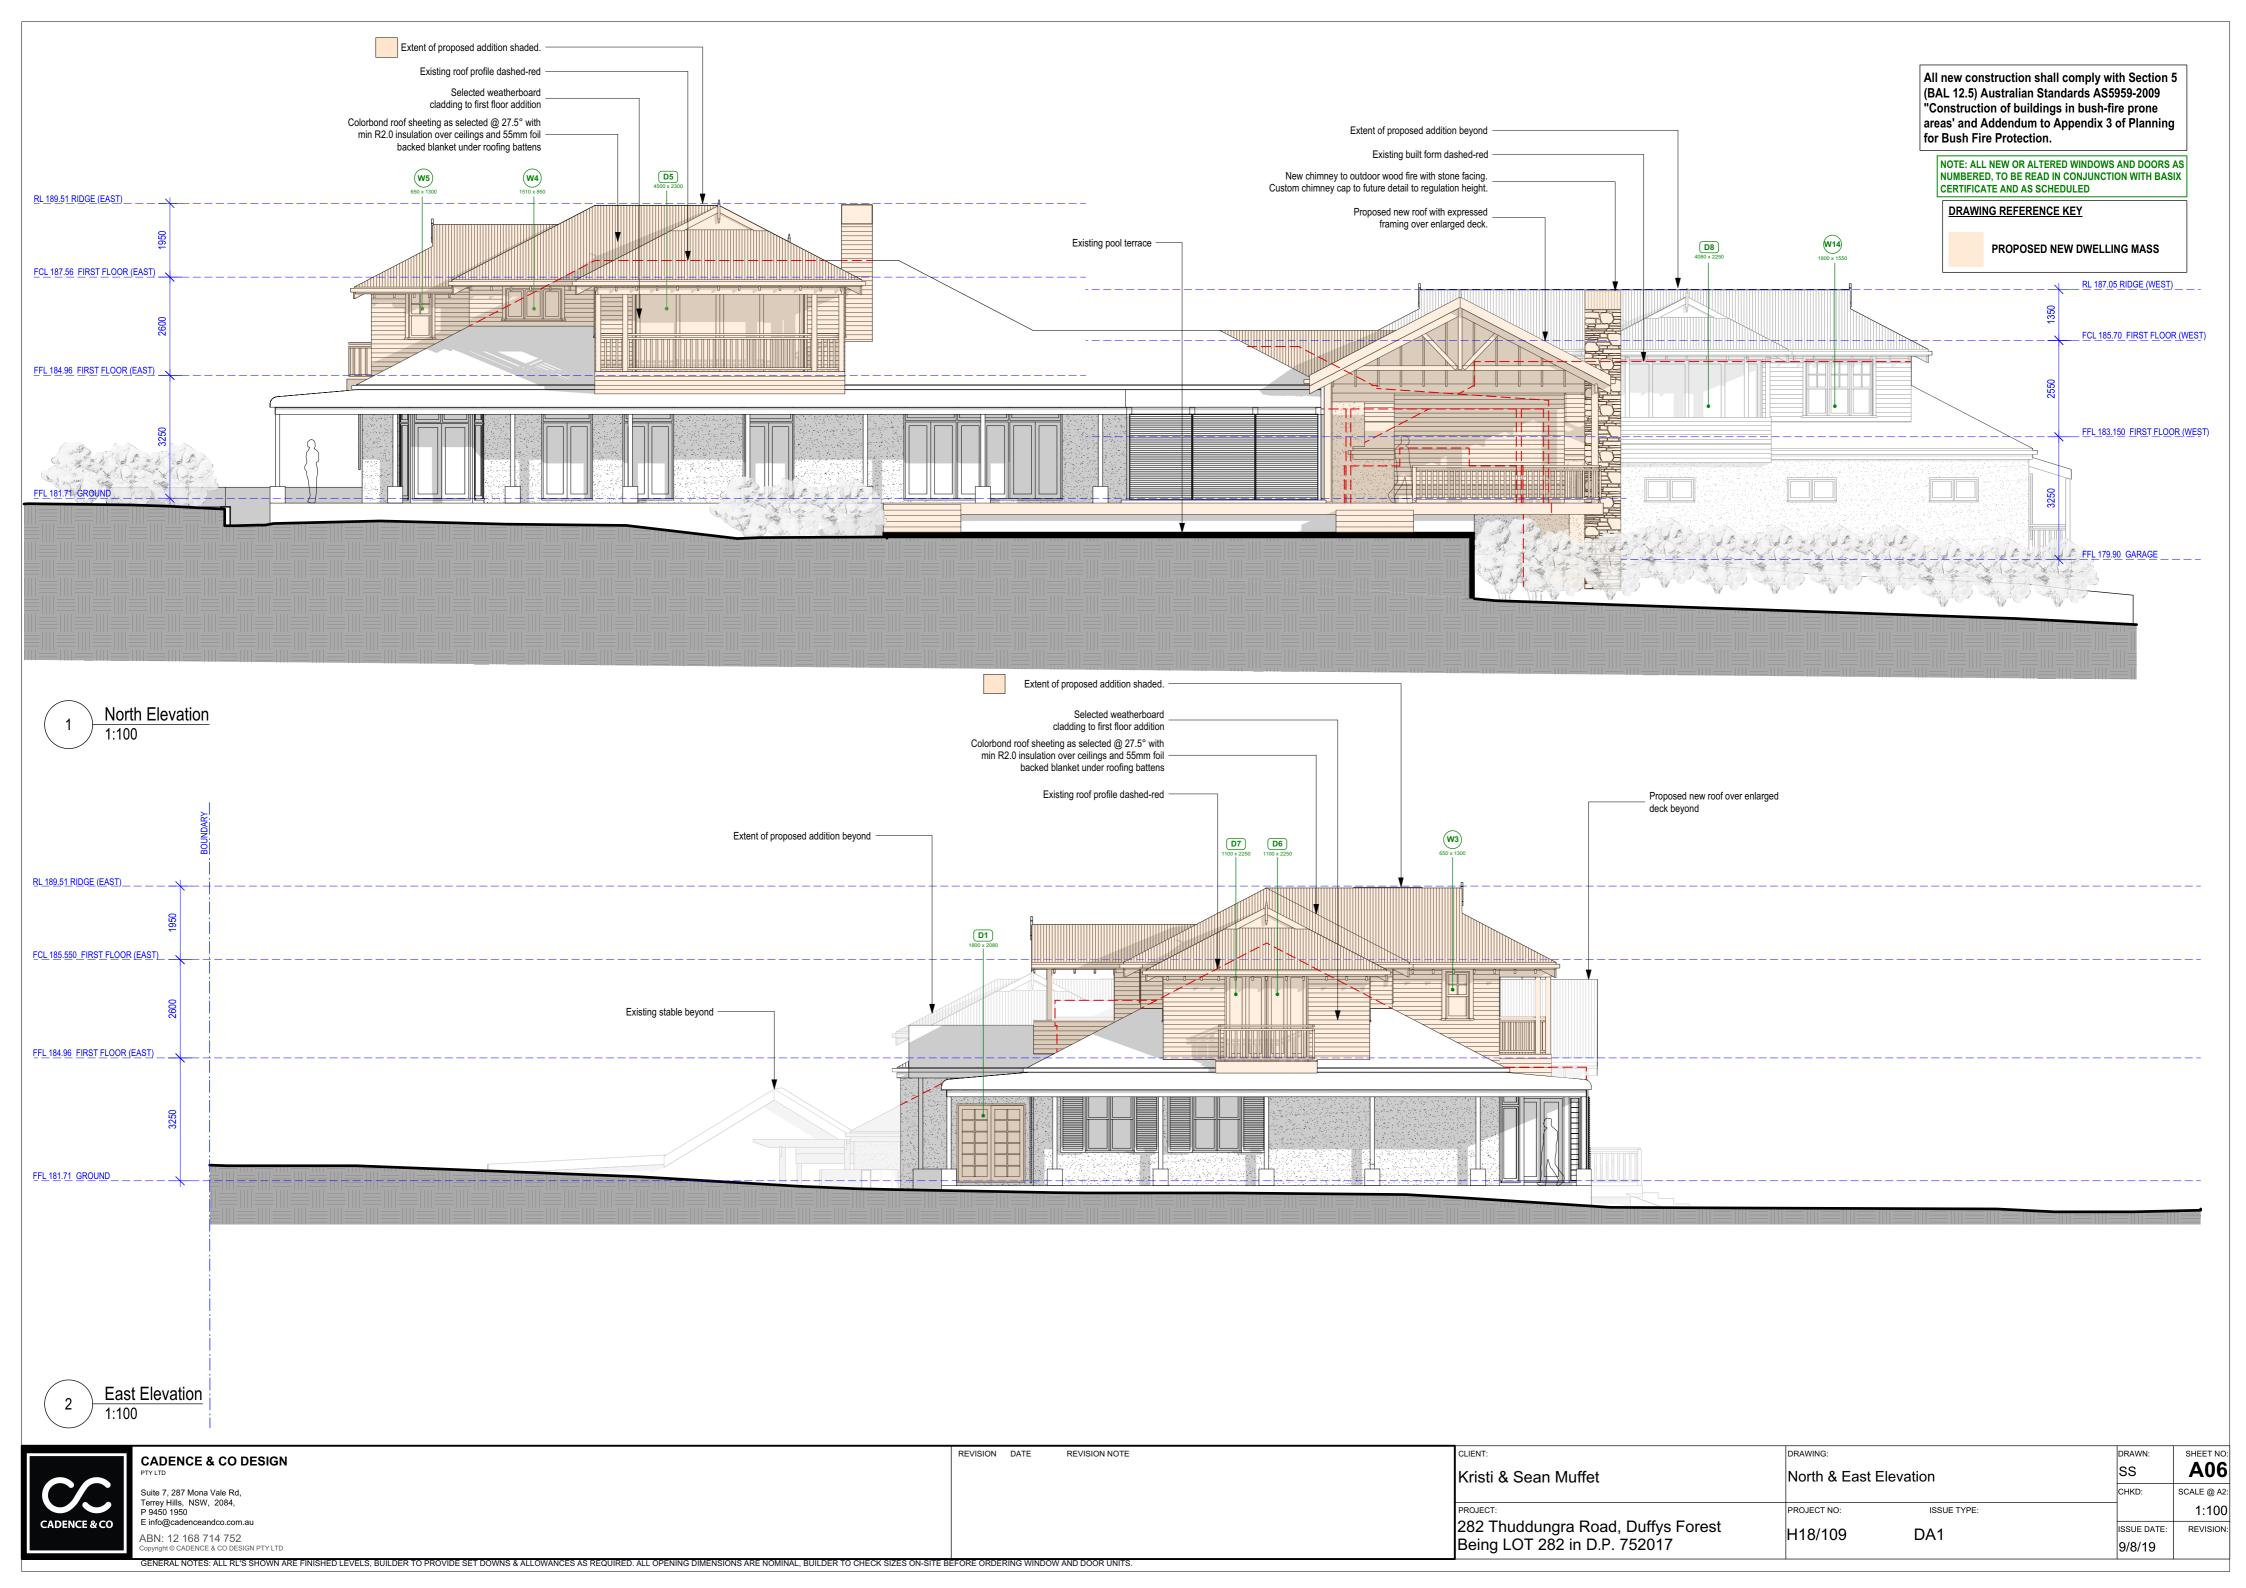

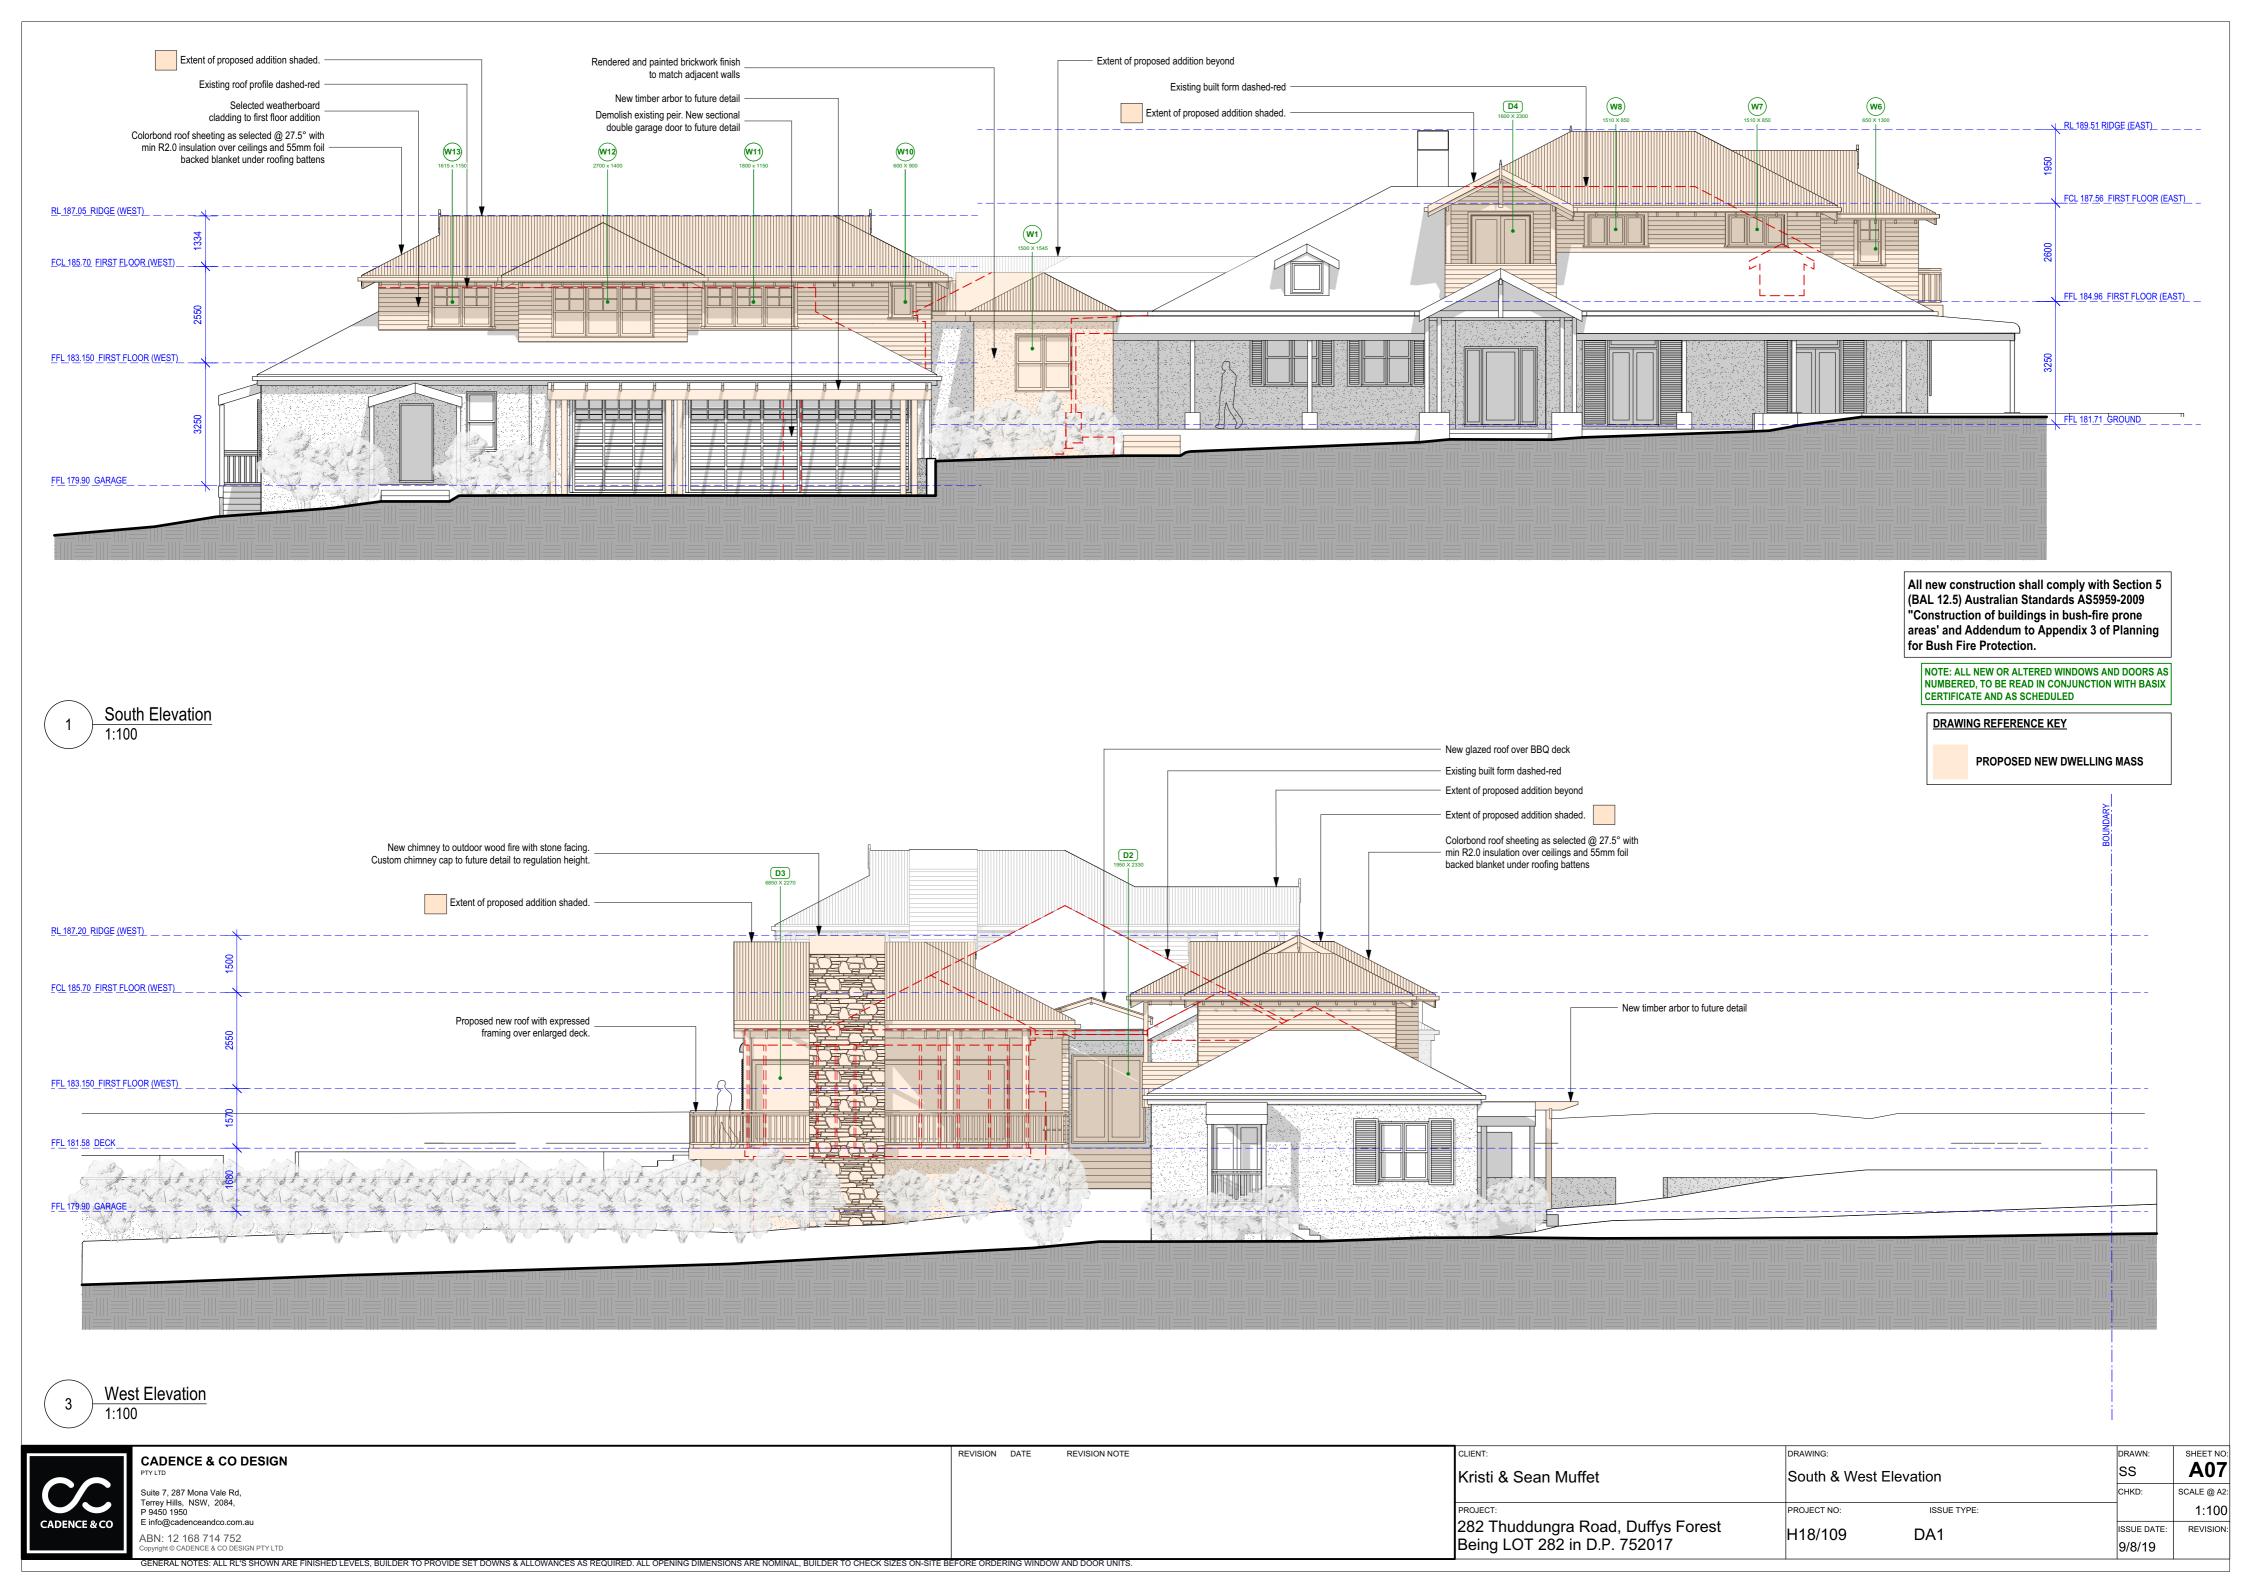

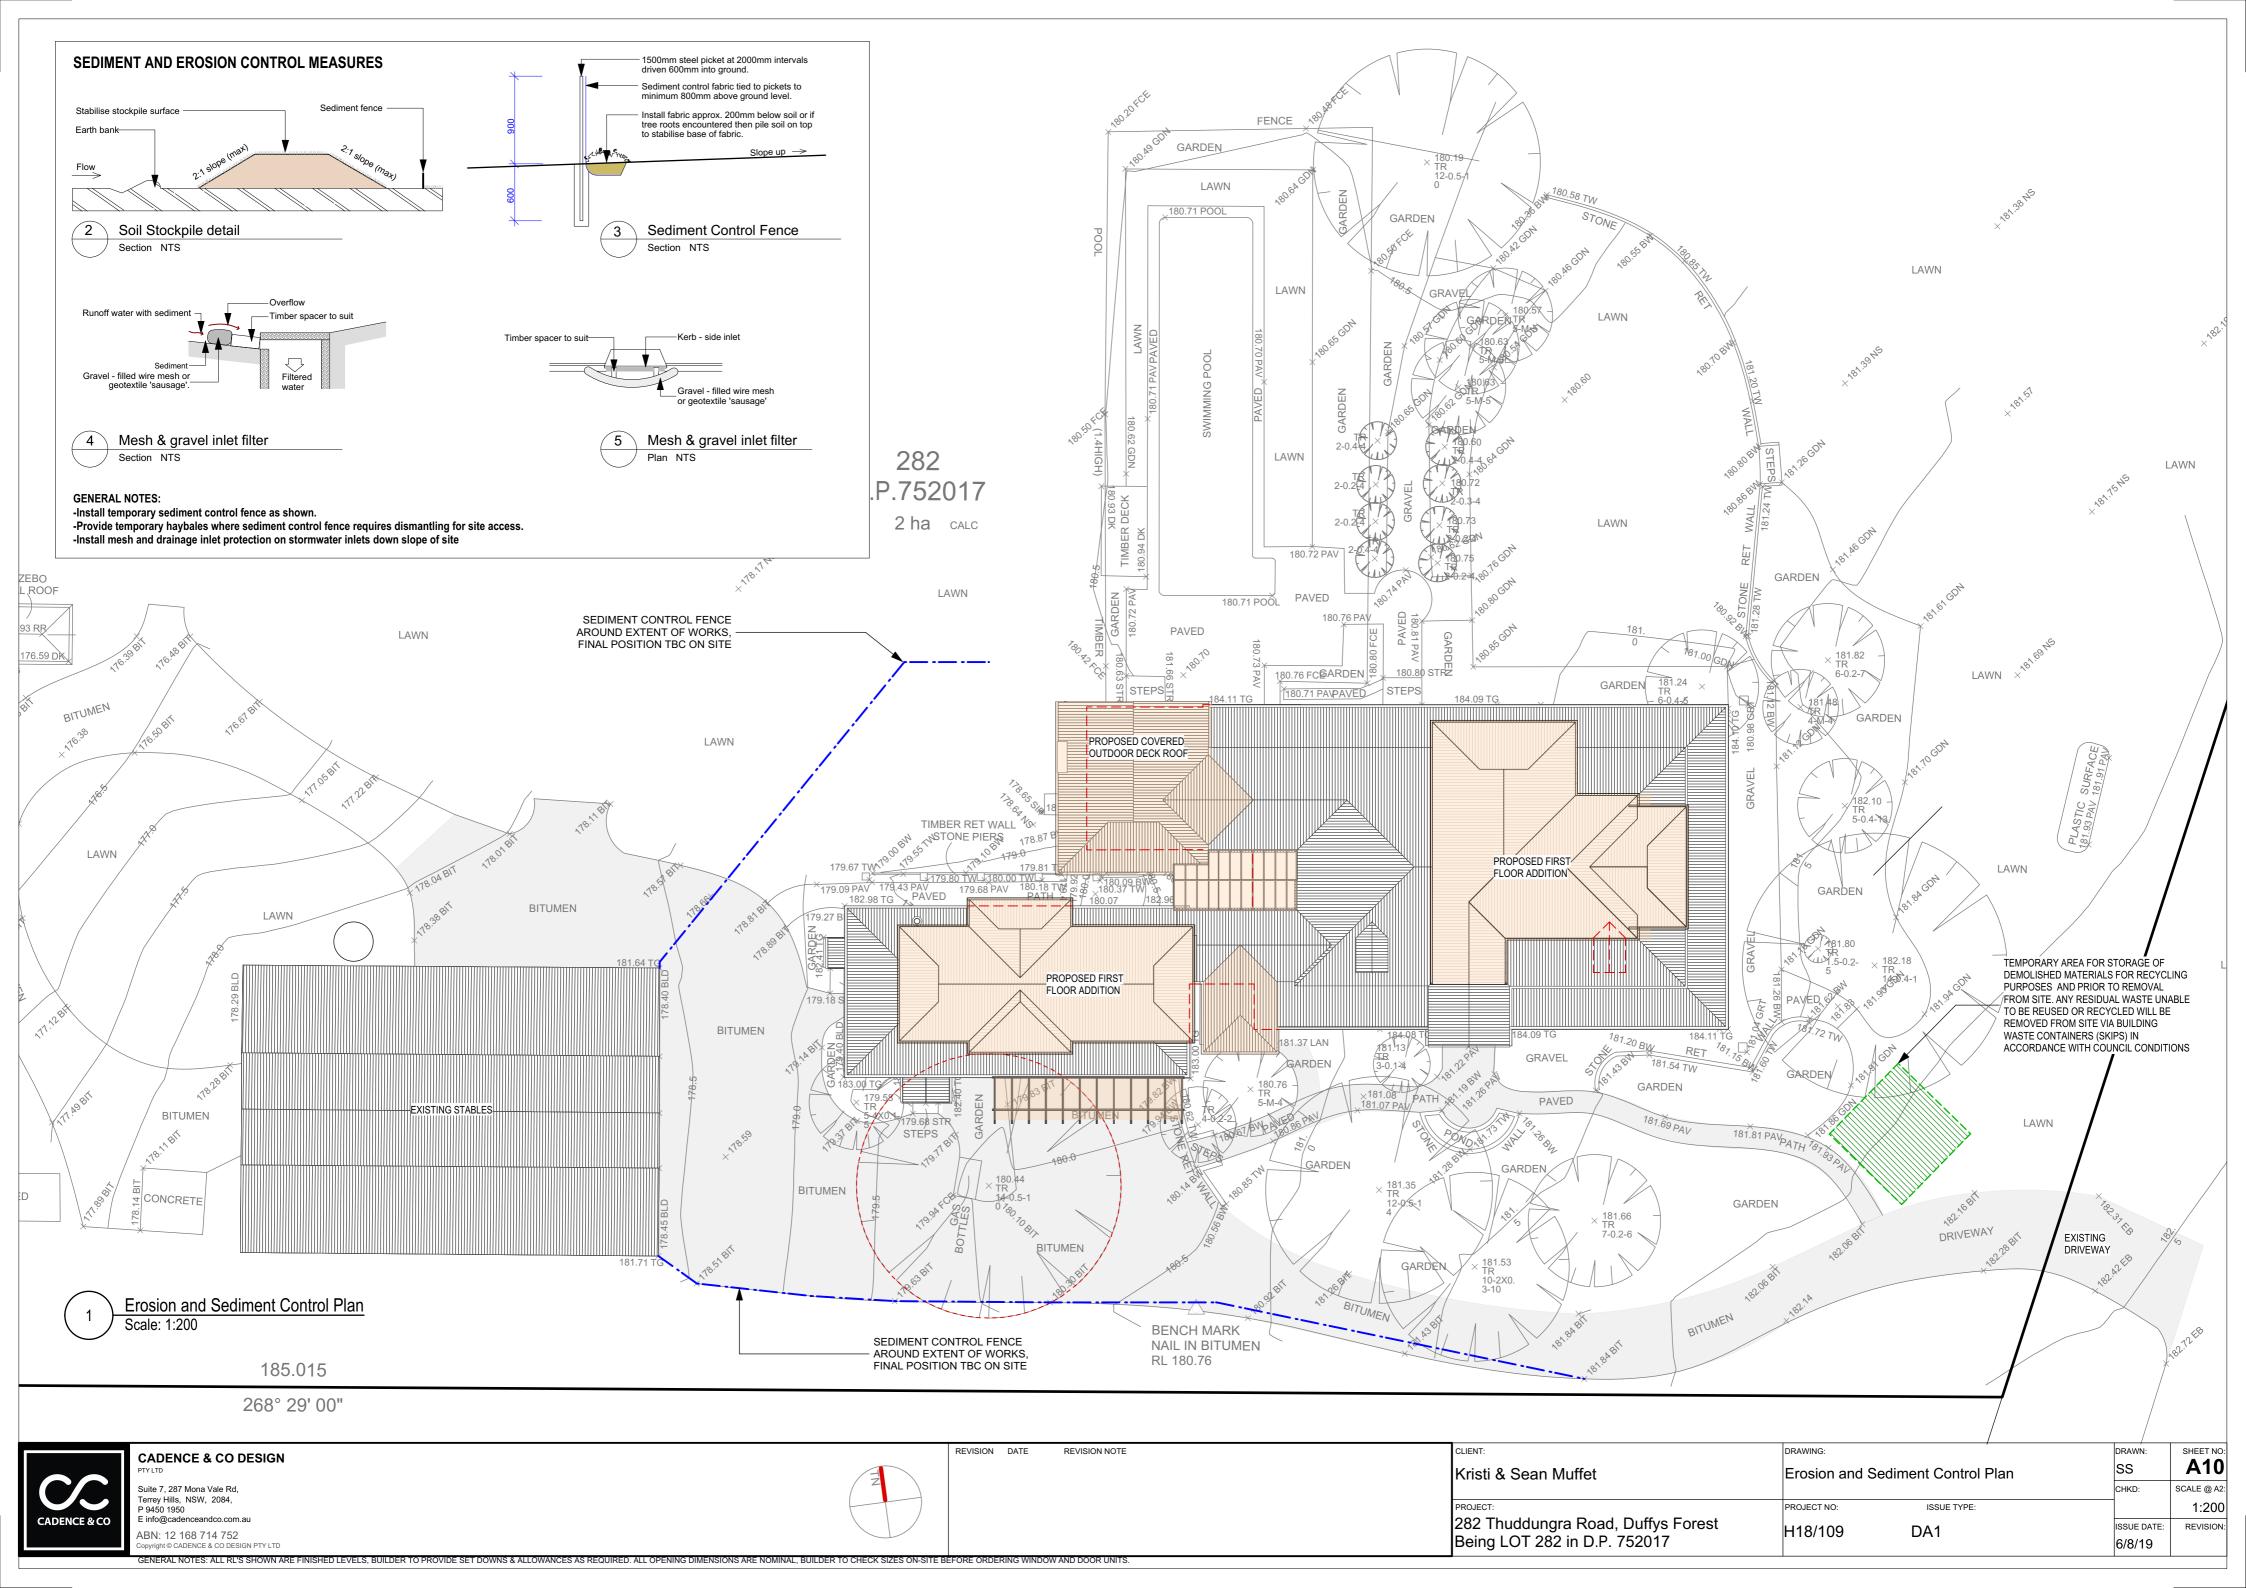EXTERNAL WINDOW AND DOOR SCHEDULE

WINDO	OWS SCHEDULE	E									
ID	Type	Opening Height	Opening Width	Unit Area	Glazing Type	Head (nom.)	Comments				
W1	double-hung	1545 mm	1500 mm	2.317 m2	single clear	2400					
W2	awning	1300 mm	650 mm	0.845 m2	single clear low-e	2300					
W3	awning	1300 mm	650 mm	0.845 m2	single clear low-e	2300					
W4	casement (3)	850 mm	1510 mm	1.284 m2	single clear low-e	2300					
W5	awning	1300 mm	650 mm	0.845 m2	single clear low-e	2250					
W6	awning	1300 mm	650 mm	0.845 m2	single clear	2250		,			
W7	casement (3)	850 mm	1510 mm	1.284 m2	single clear	2300					
W8	casement (3)	850 mm	1510 mm	1.284 m2	single clear	2300					
W9	awning	900 mm	600 mm	0.54 m2	single clear	2250					
W10	awning	900 mm	600 mm	0.54 m2	single clear	2250					
W11	double-hung	1150 mm	2400 mm	2.76 m2	single clear	2250					
W12	double-hung	1400 mm	2700 mm	3.78 m2	single clear	2250					
W13	double-hung	1150 mm	1615 mm	1.857 m2	single clear	2250		,			
W14	double-hung	1550 mm	1800 mm	2.79 m2	single clear low-e	2250		,			
W15	double-hung	1550 mm	1800 mm	2.79 m2	single clear low-e	2250					
DOOR	DOORS SCHEDULE										
ID	Туре	Opening Height	Opening Width	Unit Area	Glazing Type	Head (nom.)	No. Doors	Comments			
D1	french-door pair	2080 mm	1800 mm	3.744 m2	single clear	2030					
D2	french-door pair	2330 mm	1950 mm	4.543 m2	single clear	2330					
D3	sliding stacker	2270 mm	6850 mm	15.55 m2	single clear	2270	000F				
D4	french-door pair	2300 mm	1600 mm	3.68 m2	single clear	2300					
D5	sliding stacker	2300 mm	4500 mm	10.35 m2	single clear	2300	FOOF				
D6	french-door pair	2250 mm	1100 mm	2.475 m2	single clear low-e	2250					
D7	french-door pair	2250 mm	1100 mm	2.475 m2	single clear low-e	2250					
D8	sliding stacker	2250 mm	4000 mm	9 m2	single clear	2250	000F				


NOTES

- 1. All external glazing units to have painted timber frames as selected. Owner to give final approval to external glazing units before ordering.
- 2. Refer to Thermal Assessment Report for glazing
- 3. Typically Viridian 'ComfortPlus Clear' glazing throughout, 'Comfortplus Clear' 6mm toughened to 'low-e' windows. All glazing to comply with Part 3.6 of the current BCA.
- 4. Dimensions given are nominal and to suit scheduled opening sizes - Contractor to check all dimensions on site before ordering glazing units. Contact Cadence & Co Design if dimensions conflict.
- 5. Refer to Elevations for fixed/openable sashes.
- 6. Provide approved matching insect screens to opening window and door sashes.
- 7. Internal door sixes generally as noted on plan, to be painted flush solid core doors unless noted otherwise. 8. Provide Brio (or similar) retractable screens to all glazed external sliding doors
- 9. Code: LV = Louvre, FX = Fixed
- 8. All new construction (including Windows and Doors) shall comply with section 5 (BAL 12.5) Australian Standards AS5959-2009 "Construction of buildings in bush-fire prone areas' and Addendum to Appendix 3 of Planning for Bush Fire Protection.

EXTERNAL FINISHES SCHEDULE FOR DA



WEATHERBOARD CLADDING

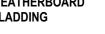

PAINTED WARM GREY



TIMBER FRAMED



WINDOWS & DOORS



DECKING



HARDWOOD AS SELECTED



EXTERNAL WOODWORK / **FASCIAS & GUTTERS**

MID GREY OR SIMILAR



METAL ROOFING



EXTERNAL STONE CLADDING

ECO OUTDOOR 'COOLUM' or similar

CORRUGATED PROFILE (TO COLOUR: WALLABY OR SIMILAR (MEDIUM)

NOTE:

- All colour selections shall be sampled and swatch tested on subject surface prior to final application.
- Colours represented on this schedule do NOT necessarily reflect true colours.
- All new construction (including Windows and Doors) shall comply with section 5 (BAL 12.5) Australian Standards AS5959-2009
- "Construction of buildings in bush-fire prone areas' and Addendum to Appendix 3 of Planning for Bush Fire Protection.

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REVISION DATE

REVISION NOTE

DRAWING: SHEET NO: **A11** SS Kristi & Sean Muffet External Window & Door Schedule CHKD: SCALE @ A2: 1:200 PROJECT NO: ISSUE TYPE: 282 Thuddungra Road, Duffys Forest Being LOT 282 in D.P. 752017 REVISION: ISSUE DATE: H18/109 DA1 6/8/19


BASIX REQUIREMENTS





		page 1 / 7	BASIX Certificate number: A354139			page 2/7
oject	Project address Project name Street address	282 Killawarra Rd 282 thuddungra Road duffys forest 2074	Fixtures and systems	Show on DA Plans	Show on CC/CDC Plans & specs	Certifier Check
	Local Government Area Plan type and number	Northern Beaches Council Deposited Plan 752017	Hot water			
5	Lot number Section number	282	The applicant must install the following hot water system in the development: electric heat pump system that is eligible to create Renewable Energy Certificates under the (Commonwealth) Renewable Energy (Electricity) Regulations 2001 (incorporating Amendment Regulations 2005 (No. 2)).	_	V	V
	Project type		Lighting			·
2	Dwelling type	Separate dwelling house	The applicant must ensure a minimum of 40% of new or altered light fixtures are fitted with fluorescent, compact fluorescent, or light-emitting-diode (LED) lamps.		~	✓
_	Type of alteration and addition	My renovation work is valued at \$50,000 or more, and does not include a pool (and/or spa).	Fixtures			
בפאכ			The applicant must ensure new or altered showerheads have a flow rate no greater than 9 litres per minute or a 3 star water rating. The applicant must ensure new or altered toilets have a flow rate no greater than 4 litres per average flush or a minimum 3 star water rating. The applicant must ensure new or altered taps have a flow rate no greater than 9 litres per minute or minimum 3 star water rating.		* *	*
	<u> </u>	by (please complete before submitting to Council or PCA)				
	Name / Company Name: C	Cadence & Co Design Pty Ltd				
	ABN (if applicable): 121687	714752				
			Planning & Environment	uilding Sustainab	ility Index www.l	asix.nsw.gov.au

Construction			Show on DA Plans	Show on CC/CDC Plans & specs	Certifie Check
nsulation requirements					
The applicant must construct the new or altere the table below, except that a) additional insula is not required for parts of altered construction	d construction (floor(s), walls, and ceilings/roofs) ation is not required where the area of new const where insulation already exists.	in accordance with the specifications listed in ruction is less than 2m2, b) insulation specified	~	~	~
Construction	Additional insulation required (R-value)	Other specifications			
suspended floor with enclosed subfloor: framed (R0.7).	R0.60 (down) (or R1.30 including construction)				
suspended floor above garage: framed (R0.7).	nil				
floor above existing dwelling or building.	nil				
external wall: cavity brick	nil				
external wall: framed (weatherboard, fibro, metal clad)	R1.30 (or R1.70 including construction)				
flat ceiling, pitched roof	ceiling: R1.95 (up), roof: foil backed blanket (55 mm)	medium (solar absorptance 0.475 - 0.70)			

	nber: A354139								page 4
Glazing requi	irements						Show on DA Plans	Show on CC/CDC Plans & specs	Certifier Check
Vindows and	glazed do	ors							
The applicant m Relevant oversh	~	~	~						
The following re	quirements i	must also	be satisfi	ed in relation	to each window and glazed door:			✓	~
	ed glass may either match the description, or, le below. Total system U-values and SHGCs 3.		✓	~					
ach window or ave a U-value nust be calcula nly. Alternative		✓	✓						
					f each eave, pergola, verandah, bai than 2400 mm above the sill.	cony or awning must be no more than 500 mm	✓	✓	✓
Pergolas with polycarbonate roof or similar translucent material must have a shading coefficient of less than 0.35.								✓	~
Pergolas with fixed battens must have battens parallel to the window or glazed door above which they are situated, unless the pergola also shades a perpendicular window. The spacing between battens must not be more than 50 mm.									✓
Vindows an	d glazed o	doors g	lazing r	equireme	nts				
Window / door no.	Orientation	Area of glass inc. frame (m2)	Oversha Height (m)	Distance (m)	Shading device	Frame and glass type			
	S	2.32	0	0	none	timber or uPVC, single clear, (or U-value: 5.71, SHGC: 0.66)			
W1	F	0.85	0	0	eave/verandah/pergola/balcony >=450 mm	timber or uPVC, single pyrolytic low-e, (U-value: 3.99, SHGC: 0.4)			
W1 W2	_			0	eave/verandah/pergola/balcony	timber or uPVC, single pyrolytic low-e,			

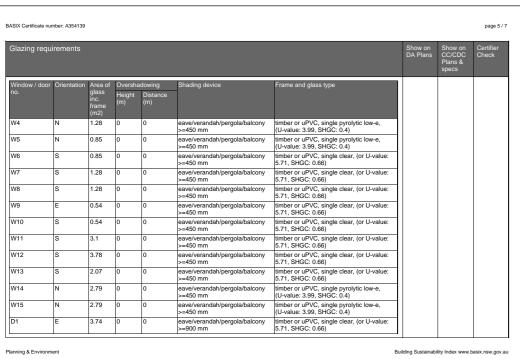

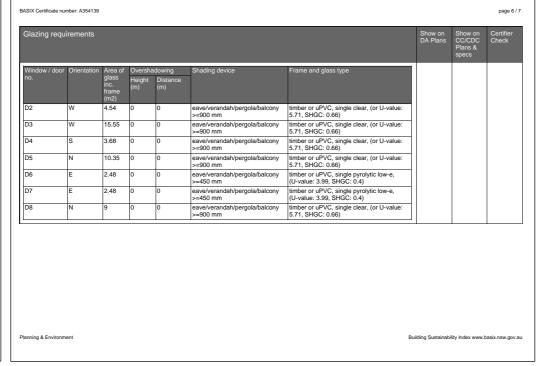

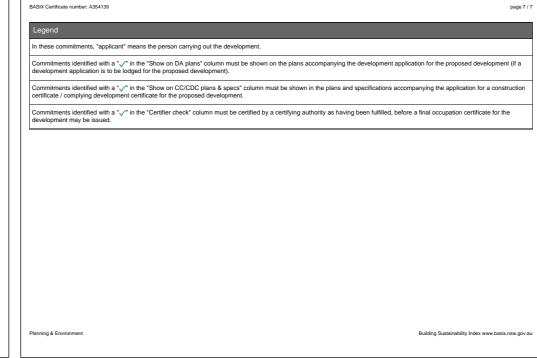



CADENCE & CO DESIGN PTYLTD	REVISION DATE REVISION NOTE	CLIENT: Kristi & Sean Muffet	DRAWING: BASIX Requirements		SHEET NO:
Suite 7, 287 Mona Vale Rd,				CHKD:	SCALE @ A2:
Suite 7, 287 Mona Vale Rd, Terrey Hills, NSW, 2084, P 9450 1950 E info@cadenceandco.com.au		PROJECT:	PROJECT NO: ISSUE TYPE:		-
		282 Thuddungra Road, Duffys Forest	H18/109 DA1	ISSUE DATE:	REVISION:
ABN: 12 168 714 752 Copyright © CADENCE & CO DESIGN PTY LTD		Being LOT 282 in D.P. 752017	H16/109 DA1	6/8/19	

GENERAL NOTES: ALL RL'S SHOWN ARE FINISHED LEVELS, BUILDER TO PROVIDE SET DOWNS & ALLOWANCES AS REQUIRED. ALL OPENING DIMENSIONS ARE NOMINAL, BUILDER TO CHECK SIZES ON-SITE BEFORE ORDERING WINDOW AND DOOR UNITS.