

TRUE NORTH:




All workmanship & materials shall be in accordance with the requirements of current editions including amendments of the relevant SAA Codes of Practice, the Building Code of Australia and local council requirements.
 New materials are to be used throughout unless otherwise noted.
 Concrete footings, slab, structural beams or any other structural members are to be designed by a practicing engineer.

JJ Drafting


174 Garden St, North Narrabeen, NSW, 2101 PO Box 687, Dee Why, NSW, 2099 Mob. 0414 717 541 Email. jjdraft@tpg.com.au www.jjdrafting.com.au

| DESCRIPTION: | PROJECT DETAILS: PROPOSED ALTERATIONS AND ADDITIONS 54 MONASH PARADE, DEE WHY | DATE: 16/07/2019 | DRAWN BY: | SCALE: 1:200 @ A3 |
|--------------|---|------------------|-------------|----------------------|
| | DRAWING TITLE: SITE ANALYSIS PLAN | JOB No: | CHECKED BY: | DRAWING No: |
| | | 716/19 | JJ | DA.01 |

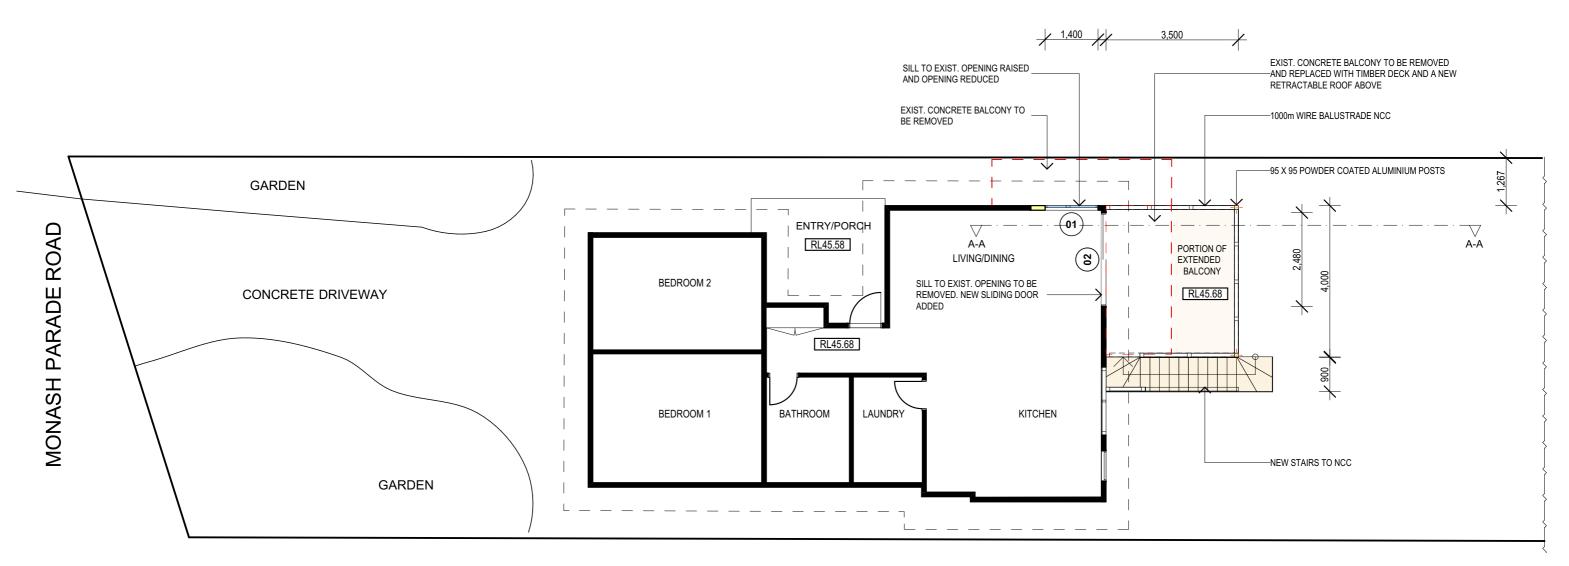

FIRST FLOOR PLAN

Proposed Floor Plan Area = 91.43m²

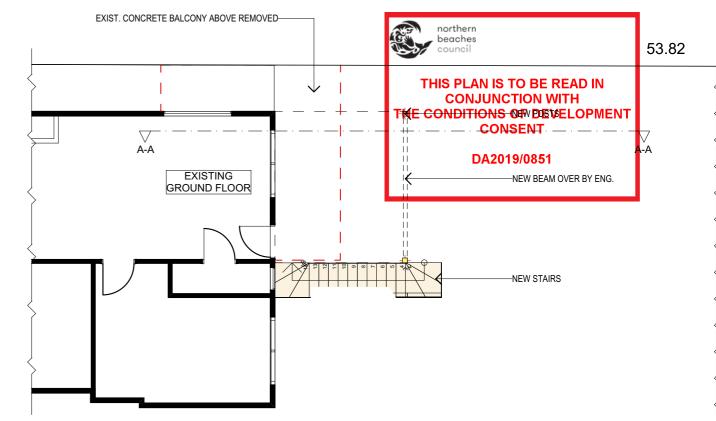

TRUE NORTH:

- NOTES:

- NOTES:

 All structures including stormwater & drainage to engineer's details.

 Do not obtain dimensions by scaling drawings.

 All dimensions are to be checked on site prior to starting work.

 These drawings are to be read in conjunction with all other consultant's drawings and specifications.

 All workmanship & materials shall be in accordance with the requirements of current editions.
- including amendments of the relevant SAA Codes of Practice, the Building Code of Australia and local council requirements.

 New materials are to be used throughout unless otherwise noted.

 Concrete footings, slab, structural beams or any other structural members are to be designed by

JJ Drafting

174 Garden St, North Narrabeen, NSW, 210 PO Box 687, Dee Why, NSW, 2099 Mob. 0414 717 541 Email. jjdraft@tpg.com.au www.jjdrafting.com.au

| | 1 [| | | | |
|----|---------|------|-------|--------------|-----|
| | П | REV: | DATE: | DESCRIPTION: | F |
| , | Ιŀ | | | | П |
| | Ш | | | | Ш |
| | li | | | | П |
| 01 | Ш | | | | L |
| | \prod | | | | 1 |
| | П | | | | יוו |
| | П | | | | Ш |
| | Н | | | | П |
| | П | | | | Ш |
| | H | | | | 11 |

GROUND FLOOR PLAN

| PROJECT DETAILS: PROPOSED ALTERATIONS AND ADDITIONS 54 MONASH PARADE, DEE WHY | DATE |
|---|-------|
| DRAWING TITLE: | JOB I |

PROPOSED FLOOR PLANS


| ΓE: | DRAWN BY: |
|------------|-------------|
| 16/07/2019 | DB |
| 3 No: | CHECKED BY: |

716/19

DRAWING No: JJ **DA.03**

SCALE:

1:100 @ A3

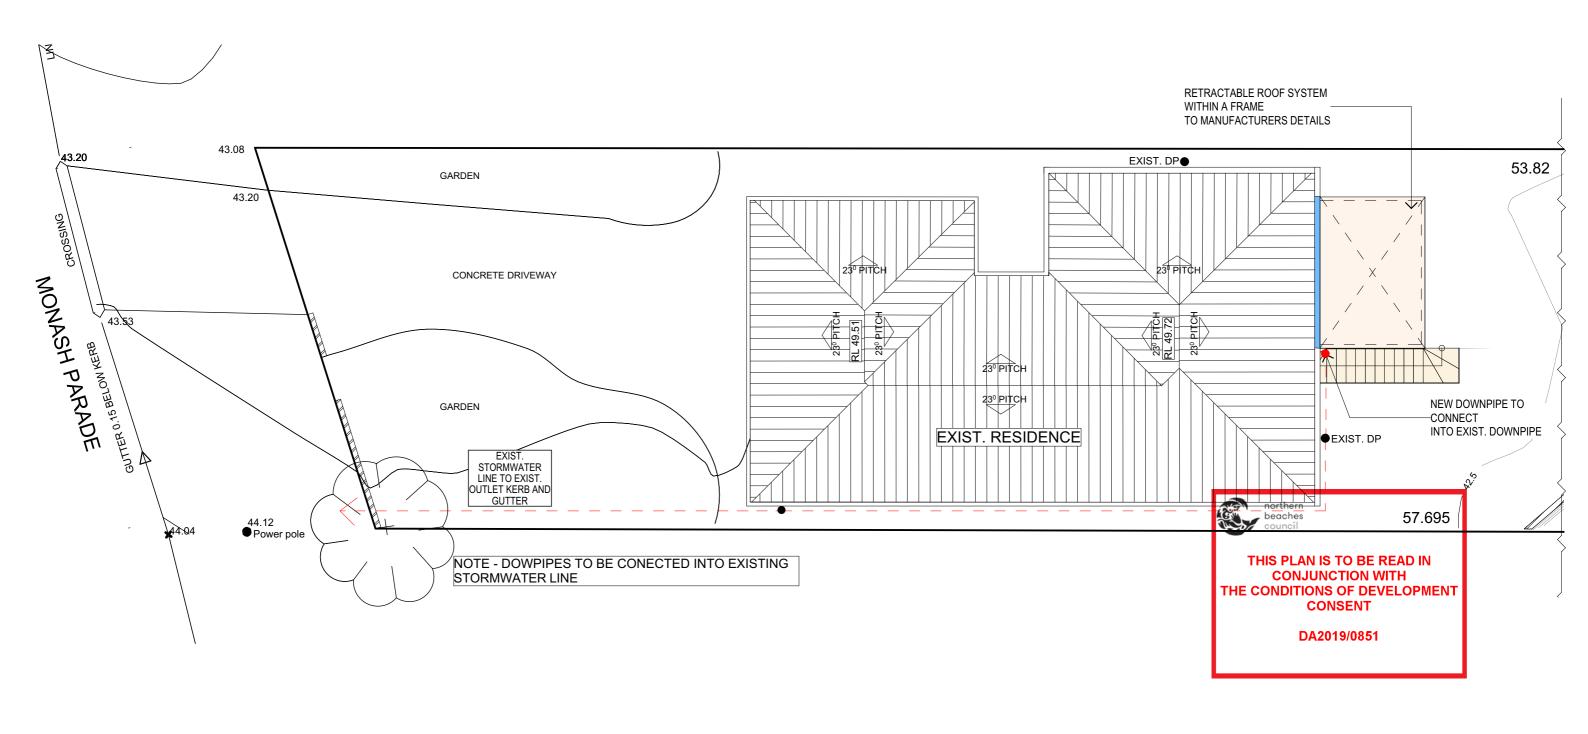

ROOF PLAN AND STORMWATER PLAN

TRUE NORTH:



- NOTES:

 All structures including stormwater & drainage to engineer's details.

 Do not obtain dimensions by scaling drawings.

 All dimensions are to be checked on site prior to starting work.

 These drawings are to be read in conjunction with all other consultant's drawings and specifications.

 All workmanship & materials shall be in accordance with the requirements of current editions including amendments of the relevant SAA Codes of Practice. The Building Code of Australia and

- All workmanship & materials shall be in accordance with the requirements of current editions including amendments of the relevant SAA Codes of Practice, the Building Code of Australia and local council requirements.
 New materials are to be used throughout unless otherwise noted.
 Concrete footings, slab, structural beams or any other structural members are to be designed by a practicing engineer.


JJ Drafting


174 Garden St, North Narrabeen, NSW, 210 PO Box 687, Dee Why, NSW, 2099 Mob. 0414 717 541 Email. jjdraft@tpg.com.au www.jjdrafting.com.au

| | KEV | DATE: | DESCRIPTION: | PRU |
|-----|-----|-------|--------------|-----|
| 1 | | | | |
| 101 | | | | |
| | | | | DRA |
| | | | | |

| | PROJECT DETAILS: PROPOSED ALTERATIONS AND ADDITIONS 54 MONASH PARADE, DEE WHY | DATE: 16/07/2019 |
|---|---|------------------|
| 1 | DRAWING TITLE: ROOF PLAN AND STORMWATER PLAN | JOB No: |

| | DRAWN BY: | SCALE: |
|----------|-------------|-------------|
| /07/2019 | DB | 1:100 @ A3 |
| | CHECKED BY: | DRAWING No: |
| 16/19 | JJ | DA.04 |

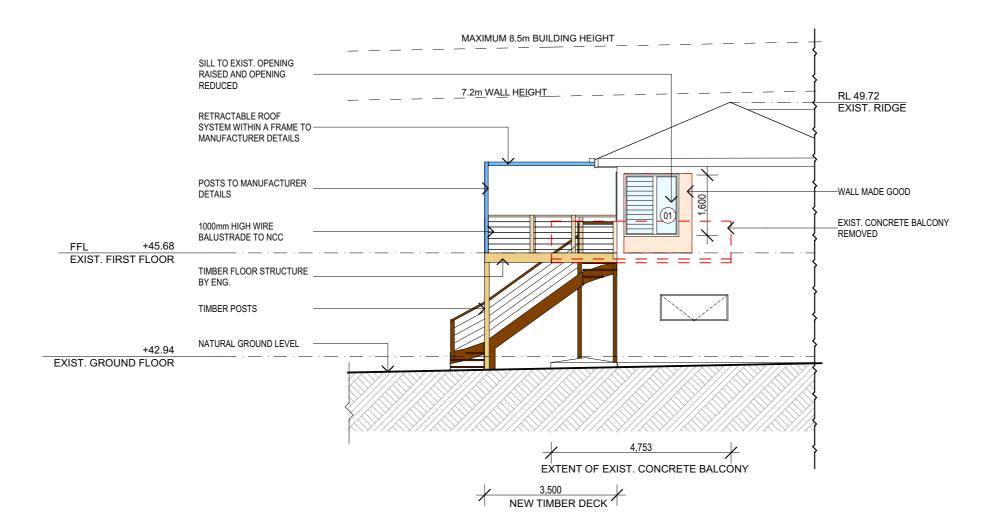

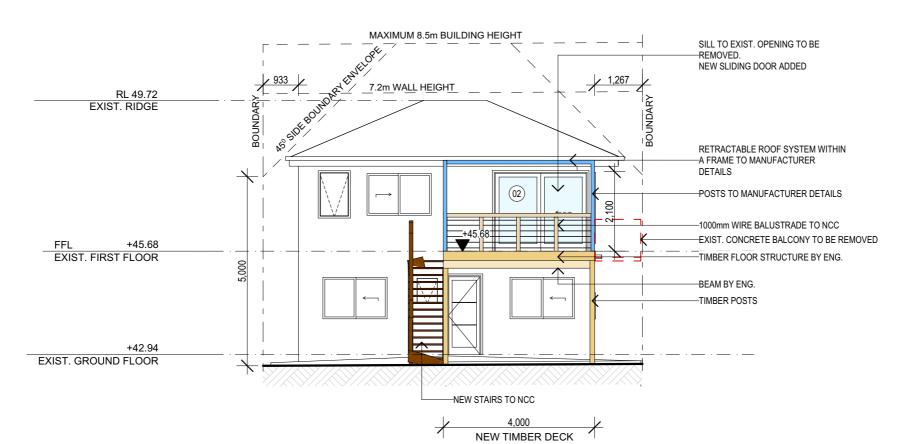



EAST ELEVATION

NORTH ELEVATION

| TRUE NORTH: | OTE |
|-------------|-----|

- All structures including stormwater & drainage to engineer's details.
 Do not obtain dimensions by scaling drawings.
 All dimensions are to be checked on site prior to starting work.
 These drawings are to be read in conjunction with all other consultant's drawings and
- specifications.

 All workmanship & materials shall be in accordance with the requirements of current editions
- including amendments of the relevant SAA Codes of Practice, the Building Code of Australia and local council requirements.

 New materials are to be used throughout unless otherwise noted.

 Concrete footings, slab, structural beams or any other structural members are to be designed by

JJ Drafting


174 Garden St, North Narrabeen, NSW, 210 PO Box 687, Dee Why, NSW, 2099 Mob. 0414 717 541 Email. jjdraft@tpg.com.au www.jjdrafting.com.au


| | REV: | DATE: | DESCRIPTION: | |
|-----|------|-------|--------------|---|
| 1 | | | | |
| 101 | | | | |
| | | | | Ī |
| | | | | |
| | | | | |

| PROJECT DETAILS: PROPOSED ALTERATIONS AND ADDITIONS 54 MONASH PARADE, DEE WHY | DAT |
|---|-----|
| DRAWING TITLE: | JOB |

NORTH & EAST ELEVATION

| ATE: 16/07/2019 | DRAWN BY: | SCALE: 1:100 @ A3 |
|--------------------|-------------|----------------------|
| | | |
| DB No: | CHECKED BY: | DRAWING No: |
| 716/19 | JJ | DA.05 |

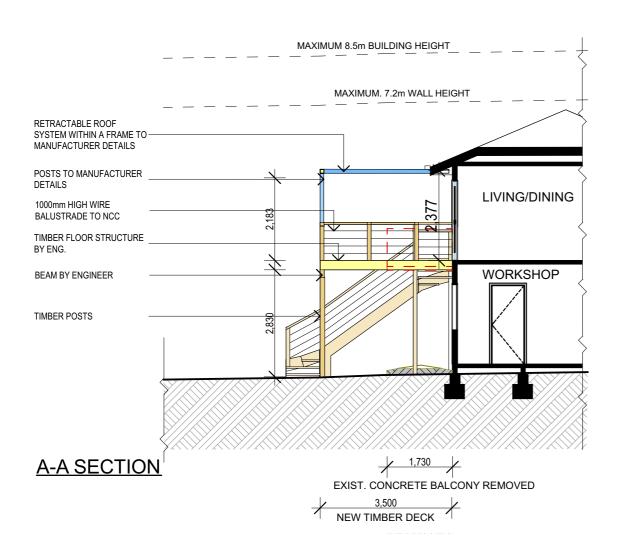

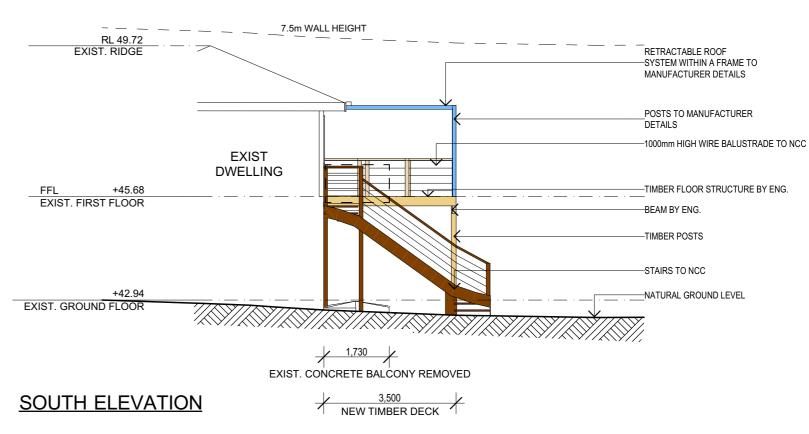

MAXIMUM 8.5m BUILDING HEIGHT

SPECIFICATION NOTES:

DOORS AND WINDOWS

- ALUMINIUM WINDOWS AND DOORS
- WEATHER STRIPPING IS TO BE PROVIDED TO ALL EXTERNAL WINDOWS AND DOORS

ROOFING

- RETRACTABLE ROOF SYSTEM ABOVE DECK TO MANUFACTURERS

BALUSTRADE

- 1000mm HIGH BALUSTRADE TO NCC
- THE HEIGHT OF BALUSTRADE TO NEW ENTRY DECK IS TO BE MEASURED AT 1m AND HAVE NO OPENINGS GREATER THAN 125mm. THE HEIGHT OF THE BALUSTRADE TO THE NEW STAIR
 CASES IS TO BE MEASURED A MINIMUM 865mm ABOVE THE NOSING LINE AND HAVE NO OPENINGS GREATER THAN 125mm

- TIMBER DECKING WITH ROUNDED EDGE & 3mm GAP

STORMWATER

- NEW DOWNPIPES TO BE CONNECTED INTO EXISTING STORMWATER LINE

GUTTERS AND DOWNPIPES

- COLORBOND GUTTERS AND DOWNPIPES
- MINIMUM SLOPE OF EAVES AND GUTTERS 1:200

FLASHING AND CAPPINGS

- SELECTION AND INSTALLATION OF METAL RAINWATER GOODS
- FLASH PROJECTIONS ABOVE THE ROOF WITH TWO PART FLASHINGS CONSISTING OF AN APRON FLASHING AND OVER FLASHING, WITH AT LEAST 100mm OVERLAP. - PROVIDE FOR INDEPENDENT MOVEMENT BETWEEN ROOF AND
- TERMITE CONTROL
- TO AS3660.1

TIMBER FRAMING

- USE TREATED TIMBER WHERE REQUIRED FOR DURABILITY
- DO NOT USE TIMBER UNSUITABLE FOR EXPOSURE TO MOISTURE IN EXPOSED LOCATION
- ALL WORKMANSHIP AND MATERIALS SHALL BE IN ACCORDANCE WITH AS1684 AND 1720 AS APPLICABLE
- PROVIDE STRUCTURE BRACING IN ACCORDANCE WITH AS1684
 PROVIDE STRUCTURE TIEDOWN IN ACCORDANCE WITH AS1684
- USE GALVANISED FIXINGS WHERE EXPOSED TO WEATHER
- ALL WORKMANSHIP AND MATERIALS SHALL BE IN ACCORDANCE WITH CURRENT EDITIONS OF THE AS3600
- FOOTINGS TO BE IN ACCORDANCE WITH AS1480
- ALL REINFORCEMENTS SHALL CONFORM TO AS1302, AS1303, AS1304

STAIR

- OPEN TIMBER RISER TO NCC

SMOKE ALARMS

- CONNECT TO CONSUMER MAINS POWER AND INSTALL TO AS1670.6. 1997 AND AS3786

(fire detection, warning control and intercom systems - systems design, installation and commissioning - smoke alarms) and as3786 -1996 (smoke alarms)

WASTE MANAGEMENT

- ALL WASTE SHALL BE TAKEN AWAY BY TRUCKS TO A SUITABLE LANDFILL OR RECYCLE DEPOT
- ALL WASTE SHALL BE COVERED DURING TRANSPORTATION
- WASTE GENERATED DURING CONSTRUCTION SHALL BE PLACED IN STEEL BINS AND TAKEN AWAY BY AN APPROVED CONTRACTOR TO A APPROVED LANDFILL SITE

SEDIMENT CONTROL

- A FILTER CLOTH SYSTEM SHALL BE INSTALLED TO STOP ANY SEDIMENT ENTERING COUNCILS STORMWATER SYSTEM



THIS PLAN IS TO BE READ IN **CONJUNCTION WITH** THE CONDITIONS OF DEVELOPMENT CONSENT

DA2019/0851

1:100 @ A3

TRUE NORTH:

NOTES:

- All structures including stormwater & drainage to engineer's details.
 Do not obtain dimensions by scaling drawings.
 All dimensions are to be checked on site prior to starting work.
 These drawings are to be read in conjunction with all other consultant's drawings and
- specifications.

 All workmanship & materials shall be in accordance with the requirements of current editions including amendments of the relevant SAA Codes of Practice, the Building Code of Australia and

New materials are to be used throughout unless otherwise noted.
 Concrete footings, slab, structural beams or any other structural members are to be designed by

JJ Drafting

174 Garden St, North Narrabeen, NSW, 210 PO Box 687, Dee Why, NSW, 2099 Mob. 0414 717 541 Email. jjdraft@tpg.com.au www.jjdrafting.com.au

| REV: | DATE: | DESCRIPTION: |
|------|-------|--------------|
| | | |
| | | |
| | | |
| | | |

| PROJECT DETAILS: PROPOSED ALTERATIONS AND ADDITIONS 54 MONASH PARADE, DEE WHY | DATE: 16/07/2019 | DRAWN BY: | SCALE: 1:100 @ A |
|---|-------------------|-------------|---------------------|
| DRAWING TITLE: ELEVATION, SECTION & BASIX | JOB No: 716/19 | CHECKED BY: | DRAWING No: |