

## Proposed Modified Works 04 54.55

- Existing deck to be rebuilt in steel framing (same size as original DA)
- Deck-to-garden stairs rotated 90 degrees and relocated to the east side of the deck.
- O3 Chamfer corner to be added to deck corner where stairs were before
- O4 Awning roof to be extended across the full width of the deck (same depth as original DA, foreseen in structural and hydraulic design)
- 05 New Skylight to Study
- O6 Fixed window above the double door in dining space to be relocated to living space + installed vertically
- O7 Addition of a small freestanding fireplace in the living room (Nectre N15)
- Workshop with storage to be added under the north section of the deck.
  - Same width as the deck section

+ modify ensuite window

- extending approx 55 cm out to the north below the front line of the existing deck
- sits well behind the north line of the buildings at Herbert Avenue numbers 48 and 50.
- 09 Internal changes to bedroom, robe and ensuite

## Site Calculations

Site 534.40 sq. metres

Existing Dwelling 82 sq. metres (15%) Proposed Addition 37 sq. metres

Total Combined Floor Space 119 sq. metres (22.3%)

Landscaping

Existing 370 sq. metres (69%) Proposed 347 sq. metres (64.9%)

COLLECT + DISCHARGE STORMWATER IN ACCORDANCE WITH HYDRAULIC ENGINEER'S PLAN

# **BASIX**

#### **RAINWATER TANK**

A rainwater tank of at least 1498 litres must be installed on the site. This rainwater tank must meet, and be installed in accordance with, the requirements of all applicable regulatory authorities. Configure the rainwater tank to collect rain runoff from at least 46 square metres of the roof area. Connect the rainwater tank to a tap located within 10 metres of the edge of the outdoor spa.

## Legend

Existing Dwelling

Proposed Additions (APPROVED)



Existing Palm Tree to be removed

### S4.55 APPLICATION TO MODIFY DA

All work to comply with B.C.A and relevant Australian Standards.

Do not scale off drawings. Builders and subcontractors should check and confirm all measurements on-site and discuss any inconsistencies with the owner before commencing work.

Any detailing not provided on these drawings, shall be resolved between the Owner and the Builder to the owners approval except any structural detailing and design which is to be supplied by a Structural Engineer.

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WILSHER	
DESIGN	_ ^
RESIDENTIAL BUILDING + GARDEN DESIGN PO BOX 394	
BRUNSWICK HEADS NSW 2483 paulwilsherdesign@gmail.com	F

		54.5	5 APPL		NIOM	ווטכ	TY DA
Project	PROPOSED ALTERATIONS + ADDITIONS	Drawing:	P	ROPOS	ED SITE	PL/	AN
At:	54 HERBERT AVE. NEWPORT 2106 Lot 147 / DP 13457	Date:	June	2020	Scale:	1:2	200
For:	Mr Tino Fibaek	Drawing N	lo.	DA.10	02		Issue: M/A

(5)

Install Interlinked hard-wired smoke alarms to comply with AS 3786 and in accordance with BCA-Part 3.7.2

Concrete Footings and removal of walls and existing structure to Engineer's Details. Floor, Wall and Roof Framing to be Timber - all to Aust. Standards (Timber Framing Code) or Engineer's Details

# **BASIX**

#### **LIGHTING**

There must be a minimum of 40% of new or altered light fixtures are fitted with fluorescent, compact fluorescent, or light-emitting-diode (LED) lamps.

#### **FIXTURES**

The applicant must ensure new or altered showerheads have a flow rate no greater than 9 litres per minute or a 3 star water rating.

The applicant must ensure new or altered toilets have a flow rate no greater than 4 litres per average flush or a minimum 3 star water rating.

The applicant must ensure new or altered taps have a flow rate no greater than 9 litres per minute or minimum 3 star water rating.


#### **OUTDOOR SWIMMING POOL**


The outdoor spa must not have a capacity greater than 3 kilolitres.

The owner must install a spa pump timer.

The owner must install an electric heat pump as the heating system for the outdoor spa

The spa must have a cover

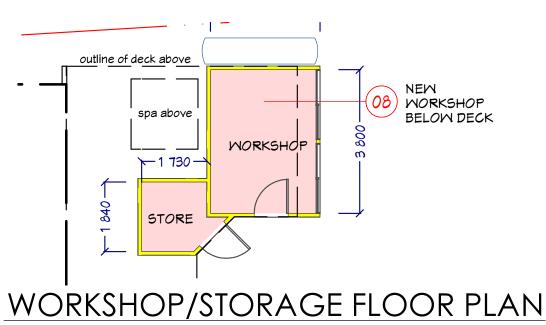

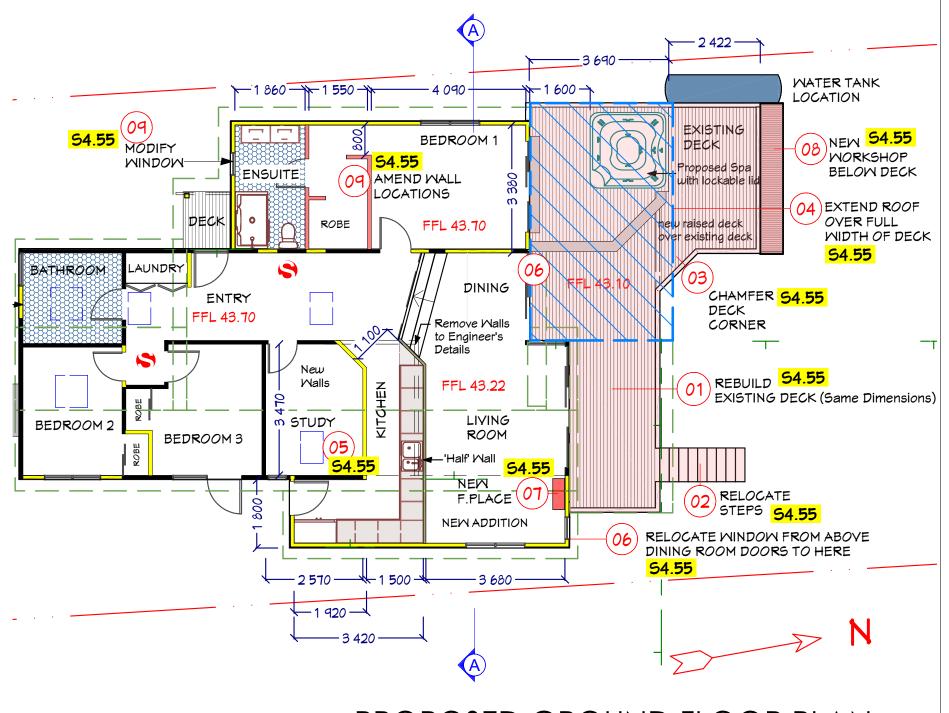

# PROPOSED GROUND FLOOR PLAN

NOTE: provide termite protection in accordance with AS 3660.1-2000

& moisture barrier to AS 2870.

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			\$4.55 AP	PLICATION PLICATION	N TO MO	DDIFY DA	
PAUL	Pr	oject: PROPOSED ALTERATIONS + ADDITIONS	Drawing:	OPOSED	FLOOR	PLANS	
DES	S I G N A		Date:		Scale:	1.100	
RESIDENTIAL B PO BOX 394	BUILDING + GARDEN DESIGN	Lot 147 / DP 13457	Jun	ne 2020	@ A3	1:100	
	design@gmail.com	or: Mr Tino Fibaek	Drawing No.	DA.100	)4	Issue:	






refers to window and door numbers in Basix Certificate which are to comply with the table below

Window No.	Shading Device	Frame and Glass Type
W1	none	timber or uPVC, single clear, (or U-value:5.71, SHGC: 0.66)
W2	none	timber or uPVC, single clear, (or U-value:5.71, SHGC: 0.66)
W3	none	timber or uPVC, single clear, (or U-value:5.71, SHGC: 0.66)
W4	none	timber or uPVC, single clear, (or U-value:5.71, SHGC: 0.66)
W5	eave/verandah/pergola/balcony>=450 mm	timber or uPVC, single clear, (or U-value:5.71, SHGC: 0.66)
W6	eave/verandah/pergola/balcony>=900 mm	timber or uPVC, single clear, (or U-value:5.71, SHGC: 0.66)
W7	eave/verandah/pergola/balcony>=450 mm	timber or uPVC, single clear, (or U-value:5.71, SHGC: 0.66)
W8	eave/verandah/pergola/balcony>=450 mm	timber or uPVC, single clear, (or U-value:5.71, SHGC: 0.66)
W9	none	timber or uPVC, single clear, (or U-value:5.71, SHGC: 0.66)
S1	none	timber. double clear/air fill, ( U-value:4.3, SHGC: 0.50)

## Approved Works @4

- PROPOSED NEW ADDITIONS
- 02 PROPOSED NEW ENTRY PORCH
- 03 PROPOSED SPA OVER EXISTING DECK
- PROPOSED INTERNAL ALTERATIONS
- 05 **NEW ROOF**
- 06 RE-USE EXISTING SKYLIGHT IN NEW ROOF
- 07 **NEW AWNING ROOF**
- NEW ST. STEEL CABLES TO BALUSTRADE

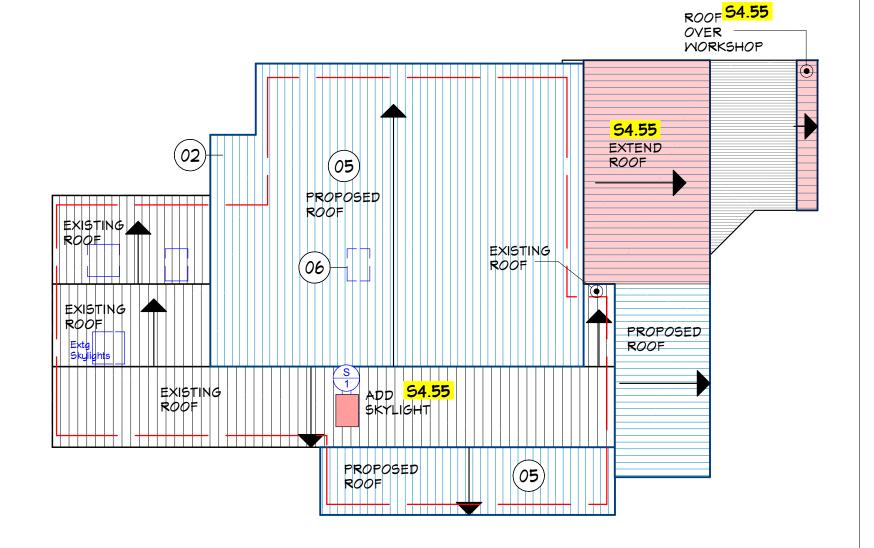

# BASIX

#### **INSULATION**

Construct the new or altered construction (floor(s), walls, and ceilings/roofs) in accordance with the specifications listed in the table below, except that a) additional insulation is not required where the area of new construction is less than 2m2, b) insulation specified is not required for parts of altered construction where insulation already exists.

Construction Type	Additional insulation required (R-value)	Other specifications
suspended floor with enclosed subfloor:framed (R0.7)	R0.8 (down) (or R1.50 including construction)	
external wall: framed (weatherboard, fibro, metal clad)	1.30 (or 1.70 including construction)	
flat ceiling, pitched roof: framed	ceiling: R1.45 (up), roof: foil backed blanket (75 mm)	medium (Solar absorptance 0.475 - 0.70)
raked ceiling, pitched/skillion roof: framed	ceiling: R1.74 (up), roof: foil backed blanket (75 mm)	medium (Solar absorptance 0.475 - 0.70)



DA.1005

M/A

# PROPOSED ROOF PLAN

Mr Tino Fibaek


#### \$4.55 APPLICATION TO MODIFY DA All work to comply with B.C.A and relevant Australian Standards. PROPOSED ALTERATIONS PROPOSED ROOF PLAN + ADDITIONS Do not scale off drawings. Builders and subcontractors should check and confirm all measurements on-site and discuss any inconsistencies with the 54 HERBERT AVE. NEWPORT 2106 owner before commencing work. 1:100 June 2020 RESIDENTIAL BUILDING + GARDEN DESIGN PO BOX 394 Lot 147 / DP 13457 Any detailing not provided on these drawings, shall be resolved between the BRUNSWICK HEADS NSW 2483 Owner and the Builder to the owners approval except any structural detailing and design which is to be supplied by a Structural Engineer. Drawing No. paulwilsherdesign@gmail.com T: 0418 637 567



#### **GLAZING**



refers to glazed window numbers in Basix Certificate which are to comply with the table on drawing DA.1004

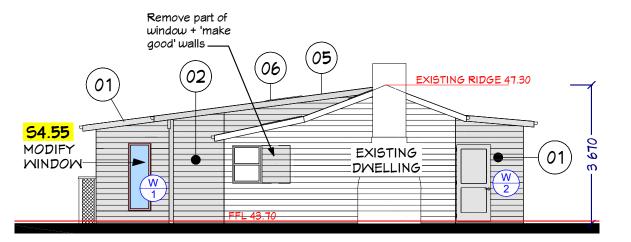

# Approved Works @4

- 01 PROPOSED NEW ADDITIONS
- 02 PROPOSED NEW ENTRY PORCH
- 03 PROPOSED SPA OVER EXISTING DECK
- 04 PROPOSED INTERNAL ALTERATIONS
- 05 **NEW ROOF**
- 06 RE-USE EXISTING SKYLIGHT IN NEW ROOF
- 07 **NEW AWNING ROOF**
- NEW ST. STEEL CABLES TO BALUSTRADE

All Cladding and Roofing to match existing


# SOUTH ELEVATION

#### NOTE:

Windows W1, W5, W7 and W9 are to be re-used from existing dwelling

Concrete Footings and removal of walls and existing structure to Engineer's Details.

Floor, Wall and Roof Framing to be Timber - all to Aust. Standards (Timber Framing Code) or Engineer's Details

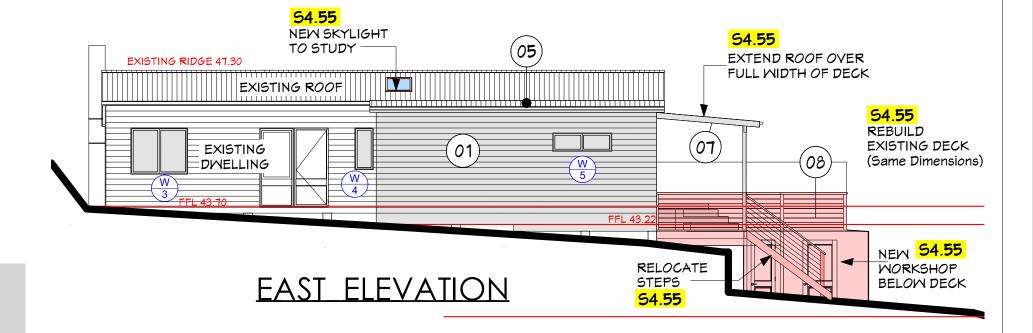

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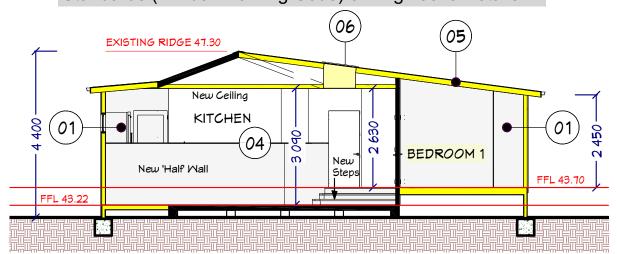
PAUL	Proje
WILSHER	
DESIGN	At:
RESIDENTIAL BUILDING + GARDEN DESIGN	
BRUNSWICK HEADS NSW 2483 paulwilsherdesign@gmail.com	For:

	\$4.55 APPLICATION TO MODIFY DA
Project: PROPOSED ALTERATIONS + ADDITIONS	Drawing: <b>ELEVATIONS</b>
<sup>At:</sup> 54 HERBERT AVE. NEWPORT 2106 Lot 147 / DP 13457	June 2020 Scale: 1:100

M/A


**DA.1006** Mr Tino Fibaek

Concrete Footings and removal of walls and existing structure to Engineer's Details.
Floor, Wall and Roof Framing to be Timber - all to Aust.
Standards (Timber Framing Code) or Engineer's Details



SECTION A - A

All Cladding and Roofing to match existing

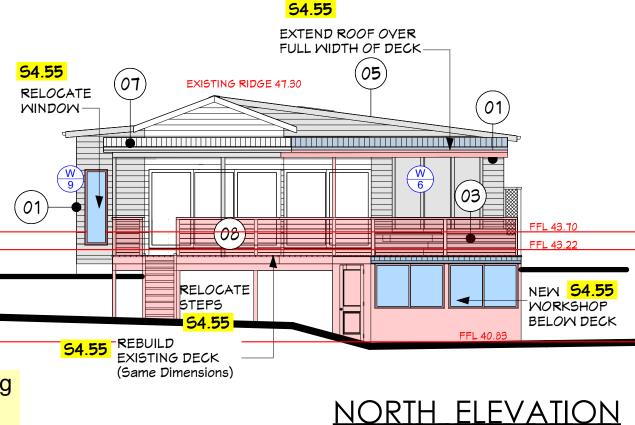

## Approved Works @4

- 01 PROPOSED NEW ADDITIONS
- 02 PROPOSED NEW ENTRY PORCH
- 03 PROPOSED SPA OVER EXISTING DECK
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- 05 NEW ROOF
- 06 RE-USE EXISTING SKYLIGHT IN NEW ROOF
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- 08 NEW ST. STEEL CABLES TO BALUSTRADE


#### NOTE:

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# BASIX

#### **GLAZING**

refers to glazed window numbers in Basix Certificate which are to comply with the table on drawing DA.1004

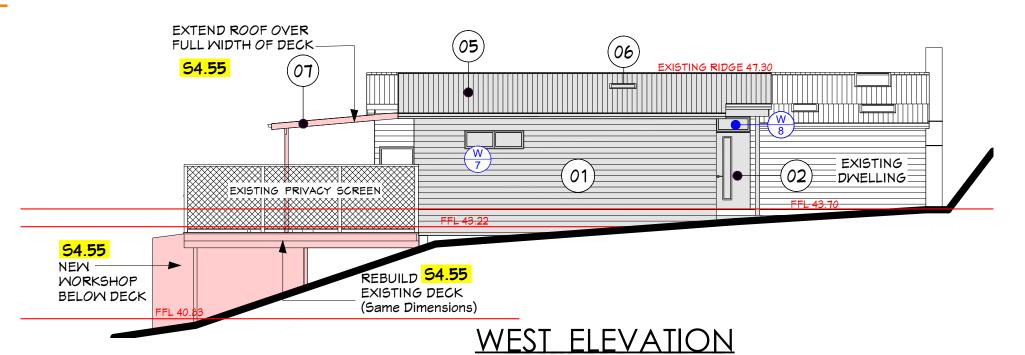

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