





- including amendments of the relevant SAA Codes of Practice, the Building Code of Australia and local council requirements.

 New materials are to be used throughout unless otherwise noted.

 Concrete footings, slab, structural beams or any other structural members are to be designed by

174 Garden St, North Narrabeen, NSW, 210 PO Box 687, Dee Why, NSW, 2099 Mob. 0414 717 541 Email. jjdraft@tpg.com.au www.jjdrafting.com.au

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	PROPOSED ALTERATIONS AND ADDITIONS 13 CAPUA PLACE, AVALON BEACH	DATE: NOVEMBER/2019	DRAWN BY:
	DRAWING TITLE:	JOB No:	CHECKED BY:
ł	GROUND FLOOR PLAN	752/19	JJ


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THIS PLAN IS TO BE READ IN **CONJUNCTION WITH** THE CONDITIONS OF DEVELOPMENT CONSENT

MOD2020/0476



FIRST FLOOR PLAN



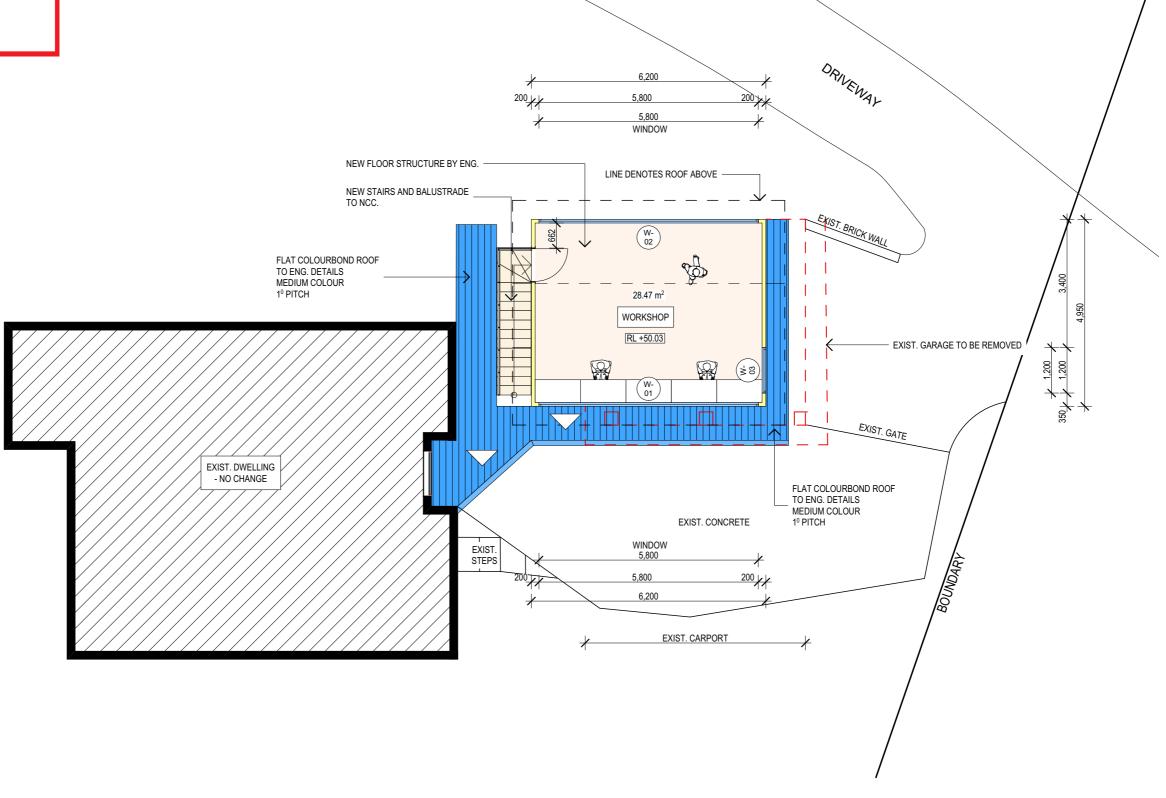

- NOTES:

 All structures including stormwater & drainage to engineer's details.

 Do not obtain dimensions by scaling drawings.

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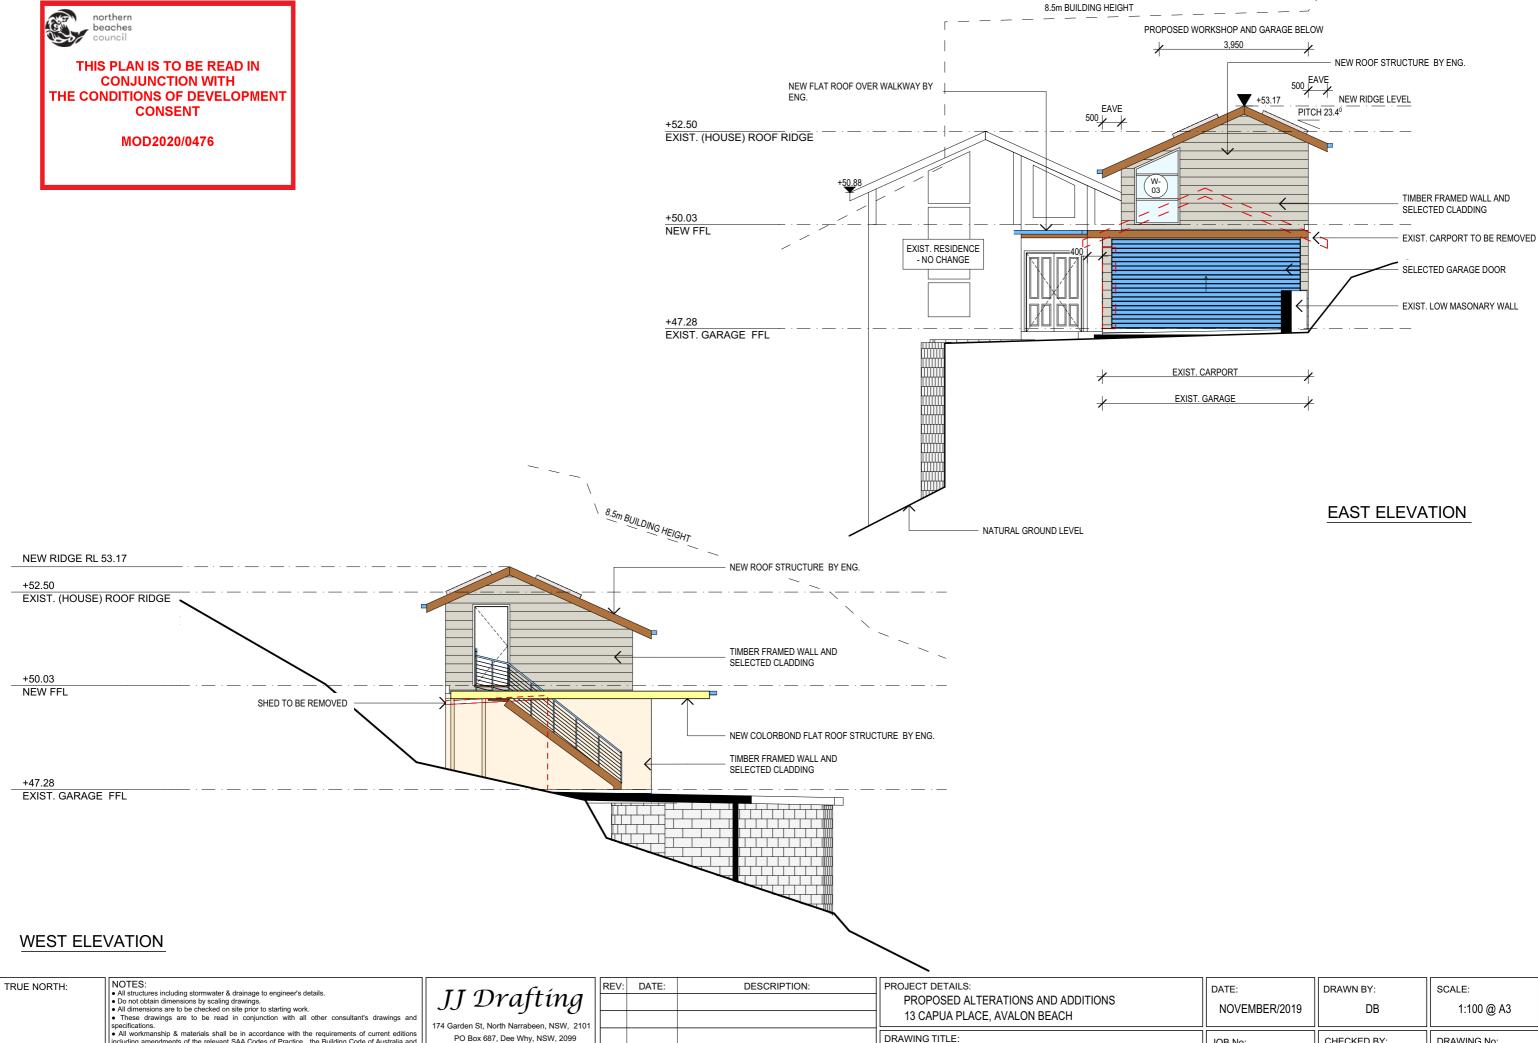
PROJECT DETAILS: PROPOSED ALTERATIONS AND ADDITIONS 13 CAPUA PLACE, AVALON BEACH			
DRAWING TITLE: FIRST FLOOR PLAN	JOB I		

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1:100 @ A3 DRAWING No:

DA.04


SCALE:



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REV:	DATE:	DESCRIPTION:	PROJECT DETAILS: PROPOSED ALTERATIONS AND ADDITIONS 13 CAPUA PLACE, AVALON BEACH	DATE: NOVEMBER/2019	DRAWN BY:	SCALE: 1:100 @ A3
			DRAWING TITLE: EAST & WEST ELEVATIONS	JOB No: 752/19	CHECKED BY:	DRAWING No: DA.05



EXTERNAL WALLS

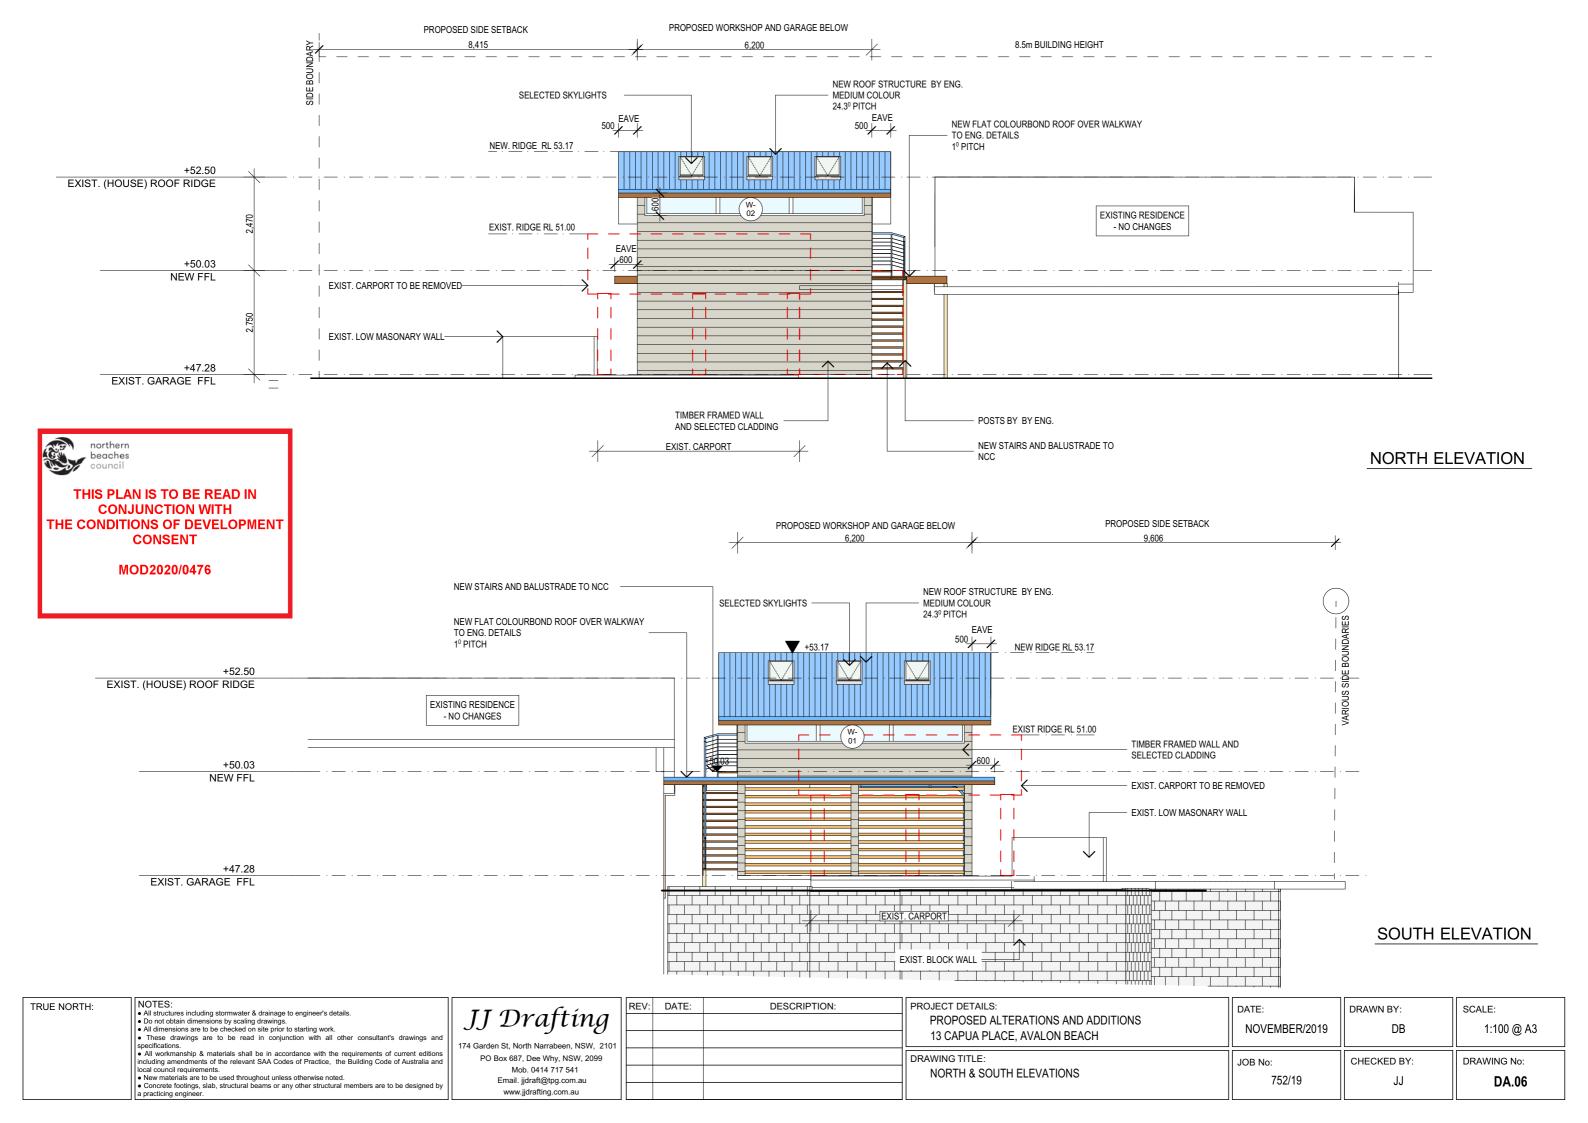- LIGHT FRAME WALLS FINISHED OFF WITH SELECTED CLADDING

DOORS AND WINDOWS

- ALUMINIUM FRAMED WINDOWS AND DOORS - WEATHER STRIPPING IS TO BE PROVIDED TO ALL EXTERNAL WINDOWS AND DOORS

- REINFORCED CONCRETE SLAB ON GROUND TO GROUND FLOOR - TIMBER FLOOR FRAMING TO BE FINISHED WITH T&G HARDWOOD FLOORING TO FIRST FLOOR

- COLORBOND ROOF CLADDING

STORMWATER

- NEW DOWNPIPES TO BE CONNECTED INTO EXISTING STORMWATER LINE

GUTTERS AND DOWNPIPES

FLASHING AND CAPPINGS

- COLORBOND GUTTERS AND DOWNPIPES

- MINIMUM SLOPE OF EAVES AND GUTTERS 1:200

- SELECTION AND INSTALLATION OF METAL RAINWATER GOODS REFER TO AS2180
- FLASH PROJECTIONS ABOVE THE ROOF WITH TWO PART FLASHINGS CONSISTING OF AN APRON FLASHING AND OVER FLASHING, WITH AT LEAST 100mm OVERLAP.
 - PROVIDE FOR INDEPENDENT MOVEMENT BETWEEN ROOF AND

TERMITE CONTROL

- TO AS3660.1

TIMBER FRAMING

- USE TREATED TIMBER WHERE REQUIRED FOR DURABILITY
- DO NOT USE TIMBER UNSUITABLE FOR EXPOSURE TO MOISTURE IN EXPOSED LOCATION
 ALL WORKMANSHIP AND MATERIALS SHALL BE IN ACCORDANCE
- WITH AS1684 AND 1720 AS APPLICABLE
 PROVIDE STRUCTURE BRACING IN ACCORDANCE WITH AS1684
- PROVIDE STRUCTURE TIEDOWN IN ACCORDANCE WITH AS1684
- USE GALVANISED FIXINGS WHERE EXPOSED TO WEATHER

- ALL WORKMANSHIP AND MATERIALS SHALL BE IN ACCORDANCE
- WITH CURRENT EDITIONS OF THE AS3600
 FOOTINGS TO BE IN ACCORDANCE WITH AS1480
 ALL REINFORCEMENTS SHALL CONFORM TO AS1302, AS1303,

INTERNAL LININGS

- PROVIDE PLASTERBOARD LINING

SMOKE DETECTORS/ALARMS:
- NCC VOL 2 PART 3.7.2, FIRE/SMOKE DETECTORS COMPLYING WITH THE REQUIREMENTS OF THE LOCAL GOVERNMENT ACT AND/OR STATE OR TERRITORY REGULATIONS

MUST BE FITTED IN THE LOCATIONS

REQUIRED AND APPROVED BY THE AUTHORITY AND SHALL BE INSTALLED IN ACCORDANCE WITH AS3786.

- INSTALLATIONS IN BUILDINGS OTHER THAN CLASS 1 AND 10 MUST BE INSTALLED AND MANAGED TO COMPLY

WITH NCC SPEC, E2,2a.

MULTIPLE ALARMS WITHIN HOUSES AND SOLE OCCUPANCY UNITS MUST BE HARD WIRED AND INTERCONNECTED.

WASTE MANAGEMENT

- ALL WASTE SHALL BE TAKEN AWAY BY TRUCKS TO A SUITABLE
- LANDFILL OR RECYCLE DEPOT

 ALL WASTE SHALL BE COVERED DURING TRANSPORTATION - WASTE GENERATED DURING CONSTRUCTION SHALL BE PLACED IN STEEL BINS AND TAKEN AWAY BY AN APPROVED CONTRACTOR TO A APPROVED LANDFILL SITE


SEDIMENT CONTROL

A FILTER CLOTH SYSTEM SHALL BE INSTALLED TO STOP ANY SEDIMENT ENTERING COUNCILS STORMWATER SYSTEM

TRUE NORTH:

ADDITIONS AND ALTERATIONS ARE TO BE READ IN CONJUNCTION AND COMPLY WITH THE BASIX CERTIFICATE, BUSHFIRE AND GEO **TECH REPORTS**



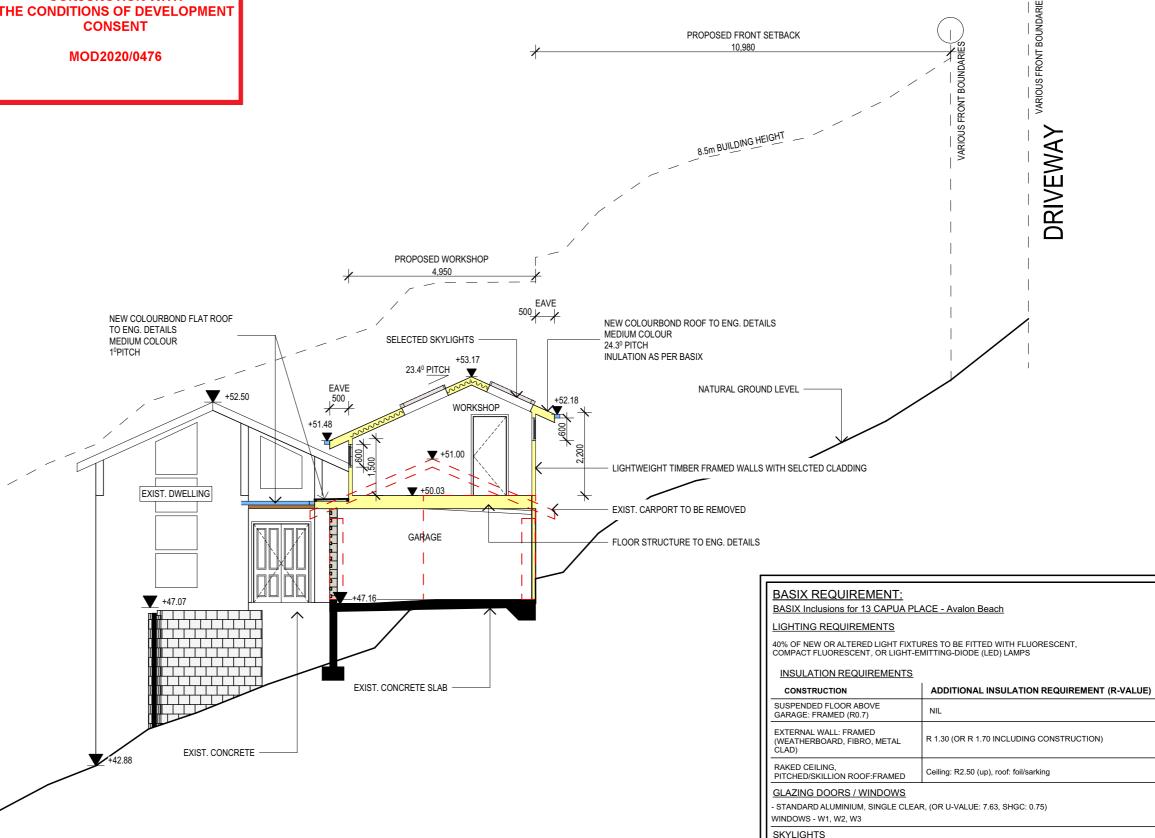

SECTION A-A

- TIMBER, low-E internal/argon fill/clear external, (or U-value: 2.5, SHGC: 0.456)

SKYLIGHTS - S1, S2, S3, S4, S5 NOTES: REV: DATE: JJ Drafting All structures including stormwater & drainage to engineer's details. Do not obtain dimensions by scaling drawings. All dimensions are to be checked on site prior to starting work. These drawings are to be read in conjunction with all other consultant's drawings and

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	DRAWING TITLE: SECTION & BASIX	JOB No: 752/19	CHECKED BY:	DRAWING No: DA.07

