# 33 MARLBOROUGH AVENUE, FRESHWATER, NSW, 2096

### SHEET LIST

00 - COVERPAGE

01 - SITE & ROOF PLAN

02 - GROUND PLAN

10 - ELEVATIONS

11 - ELEVATIONS

20 - SECTIONS

21 - SECTIONS

100 - PROPOSED 3D 200- SITE ANALYSIS

Pool and Spa	Show on DA Plans	Show on CC/CDC Plans & specs	Certifi Check
Rainwater tank			
The applicant must install a rainwater tank of at least 1662.5 litres on the site. This rainwater tank must meet, and be installed in accordance with, the requirements of all applicable regulatory authorities.	~	~	-
The applicant must configure the rainwater tank to collect rainwater runoff from at least 140 square metres of roof area.		~	V
The applicant must connect the rainwater tank to a tap located within 10 metres of the edge of the pool and outdoor spa.		~	V
Outdoor swimming pool			
The swimming pool must be outdoors.	~	~	V
The swimming pool must not have a capacity greater than 49 kilolitres.	~	~	V
The swimming pool must have a pool cover.		~	V
The applicant must install a pool pump timer for the swimming pool.		~	·
The applicant must install the following heating system for the swimming pool that is part of this development: electric heat pump.		~	V
Outdoor spa			
The spa must not have a capacity greater than 2 kilolitres.	~	~	
The spa must have a spa cover.		~	·
Pool and Spa	Show on DA Plans	Show on CC/CDC Plans & specs	Certif
The applicant must install a spa pump timer.		~	
The applicant must install the following heating system for the outdoor spa that is part of this development: electric heat pump.		~	
Fixtures and systems	Show on DA Plans	Show on CC/CDC Plans & specs	Certi
Hot water	DA FIGIIS	rialis & specs	Ciled
The applicant must install the following hot water system in the development: electric heat pump system that is eligible to create Renewable Energy Certificates under the (Commonwealth) Renewable Energy (Electricity) Regulations 2001 (incorporating Amendment Regulations 2005 (No. 2)).	~	<b>→</b>	
Lighting			
The applicant must ensure a minimum of 40% of new or altered light fixtures are fitted with fluorescent, compact fluorescent, or light- emitting-diode (LED) lamps.		~	
Fixtures			
The applicant must ensure new or altered showerheads have a flow rate no greater than 9 litres per minute or a 3 star water rating.		~	
		_	
The applicant must ensure new or altered toilets have a flow rate no greater than 4 litres per average flush or a minimum 3 star water rating.			





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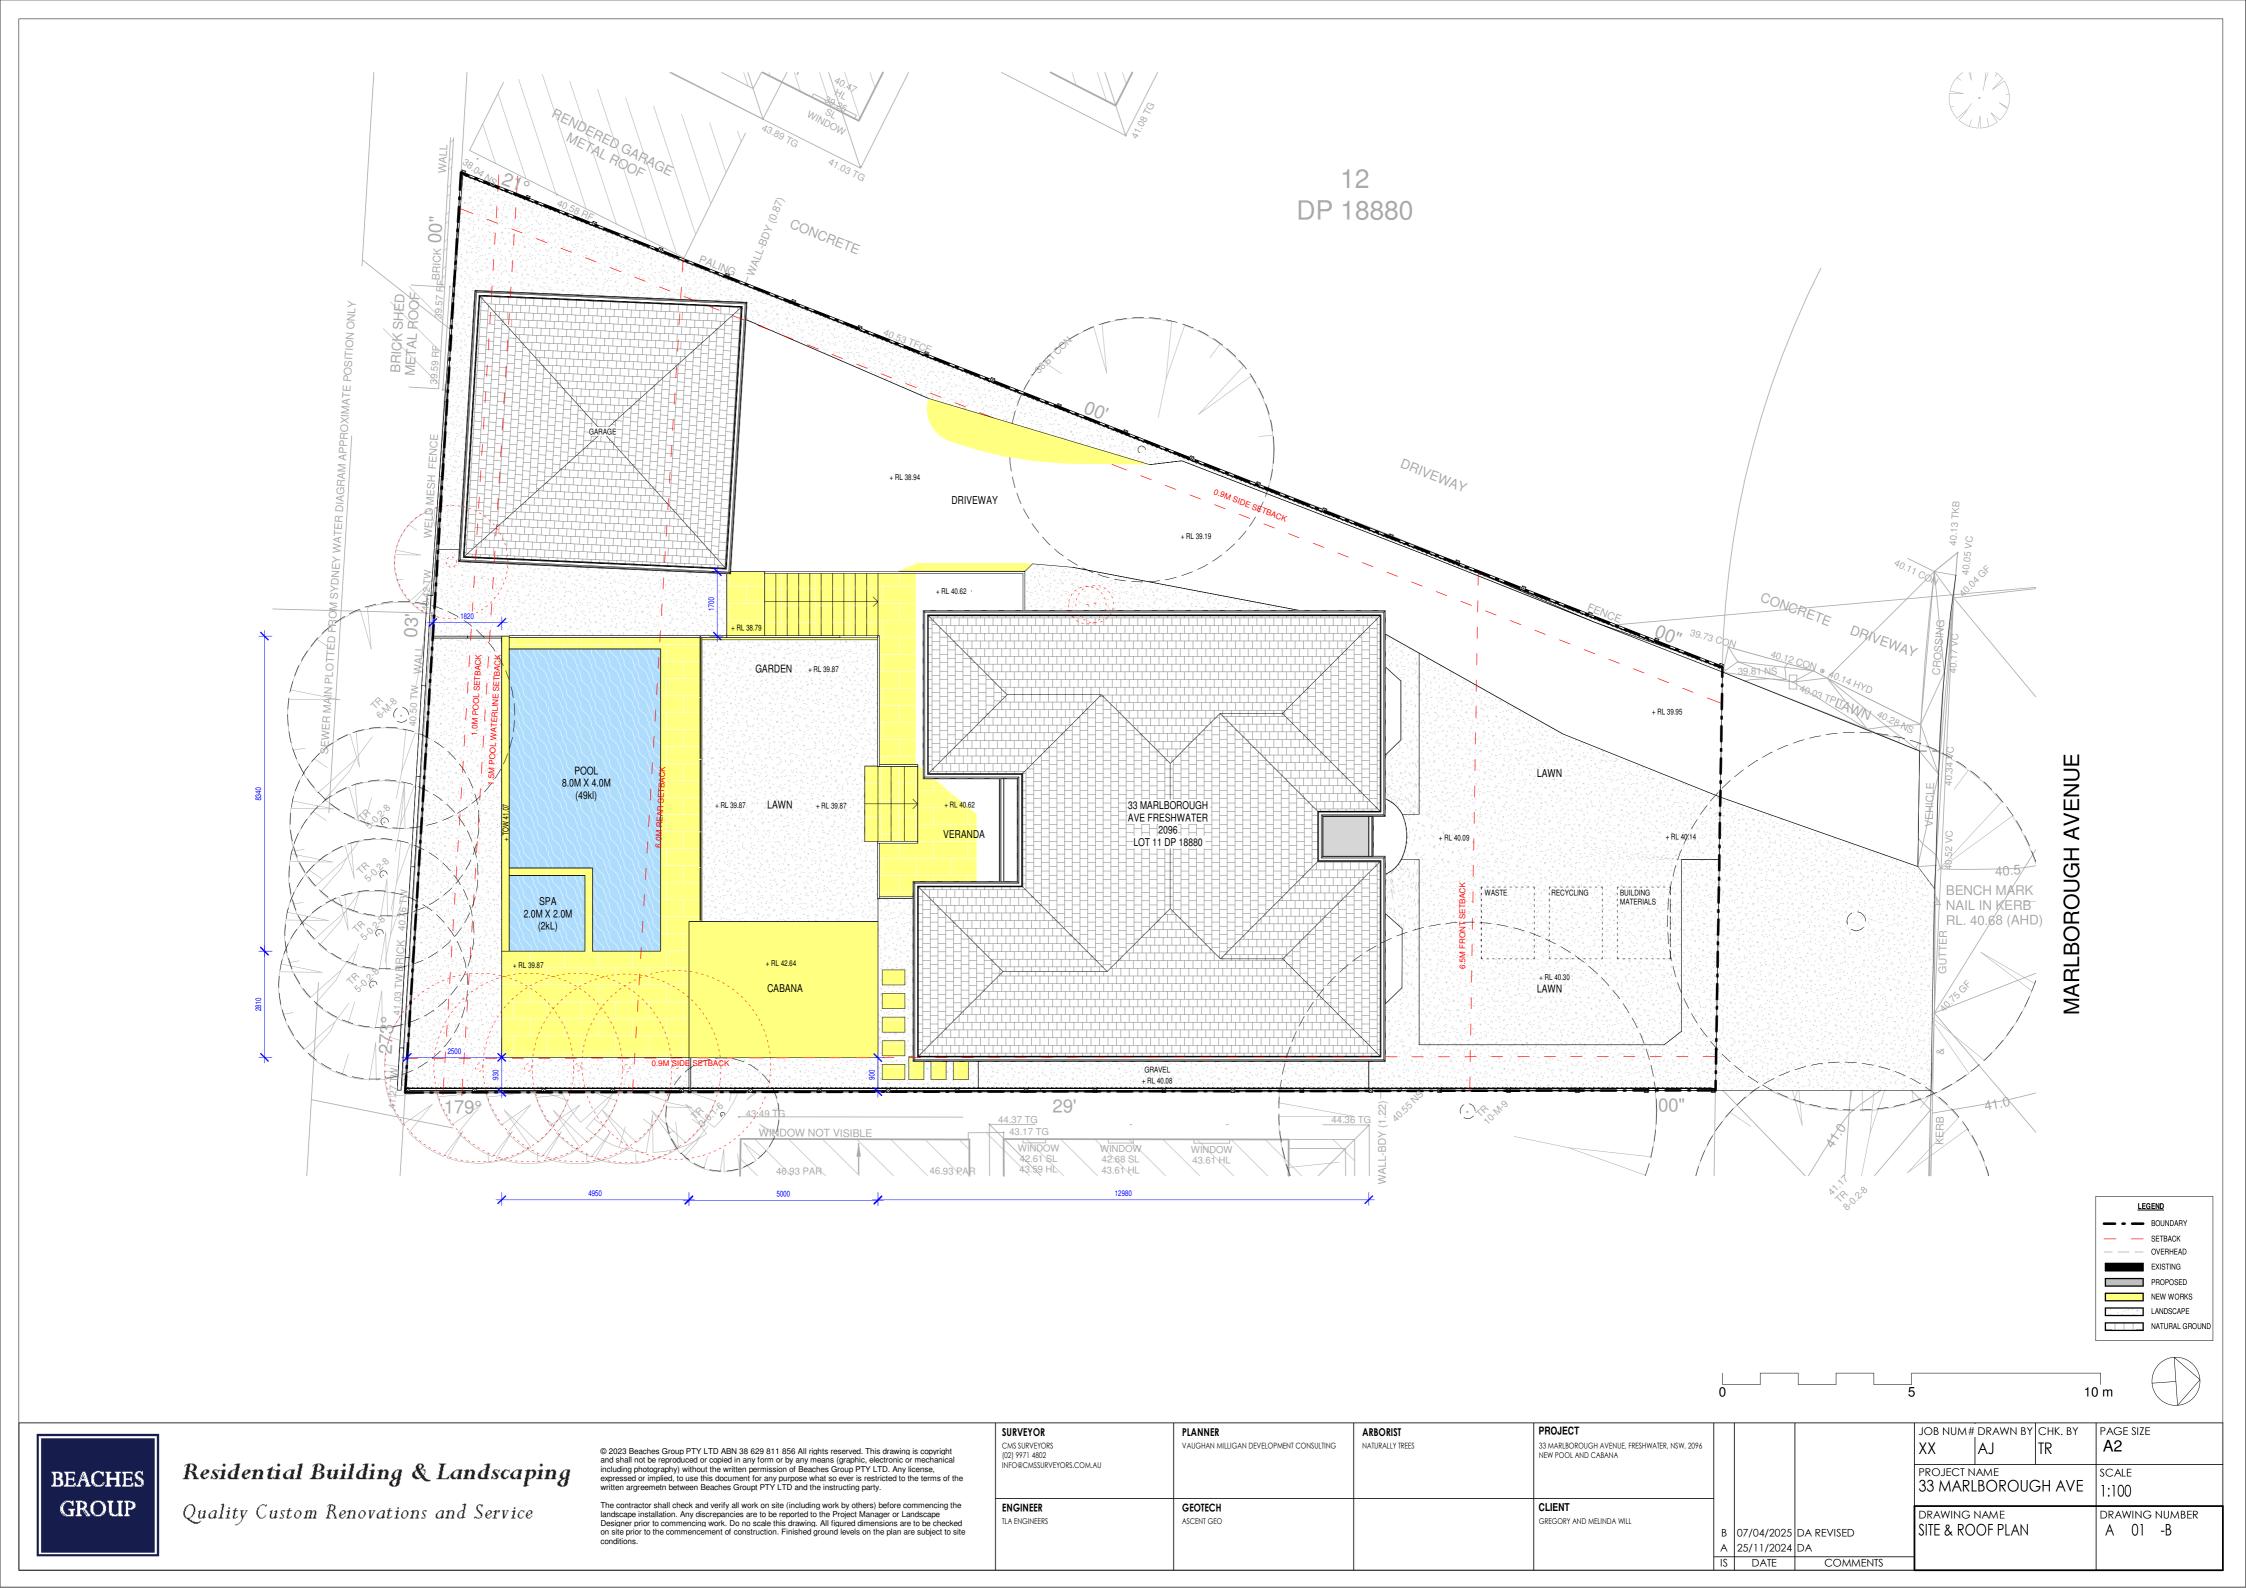
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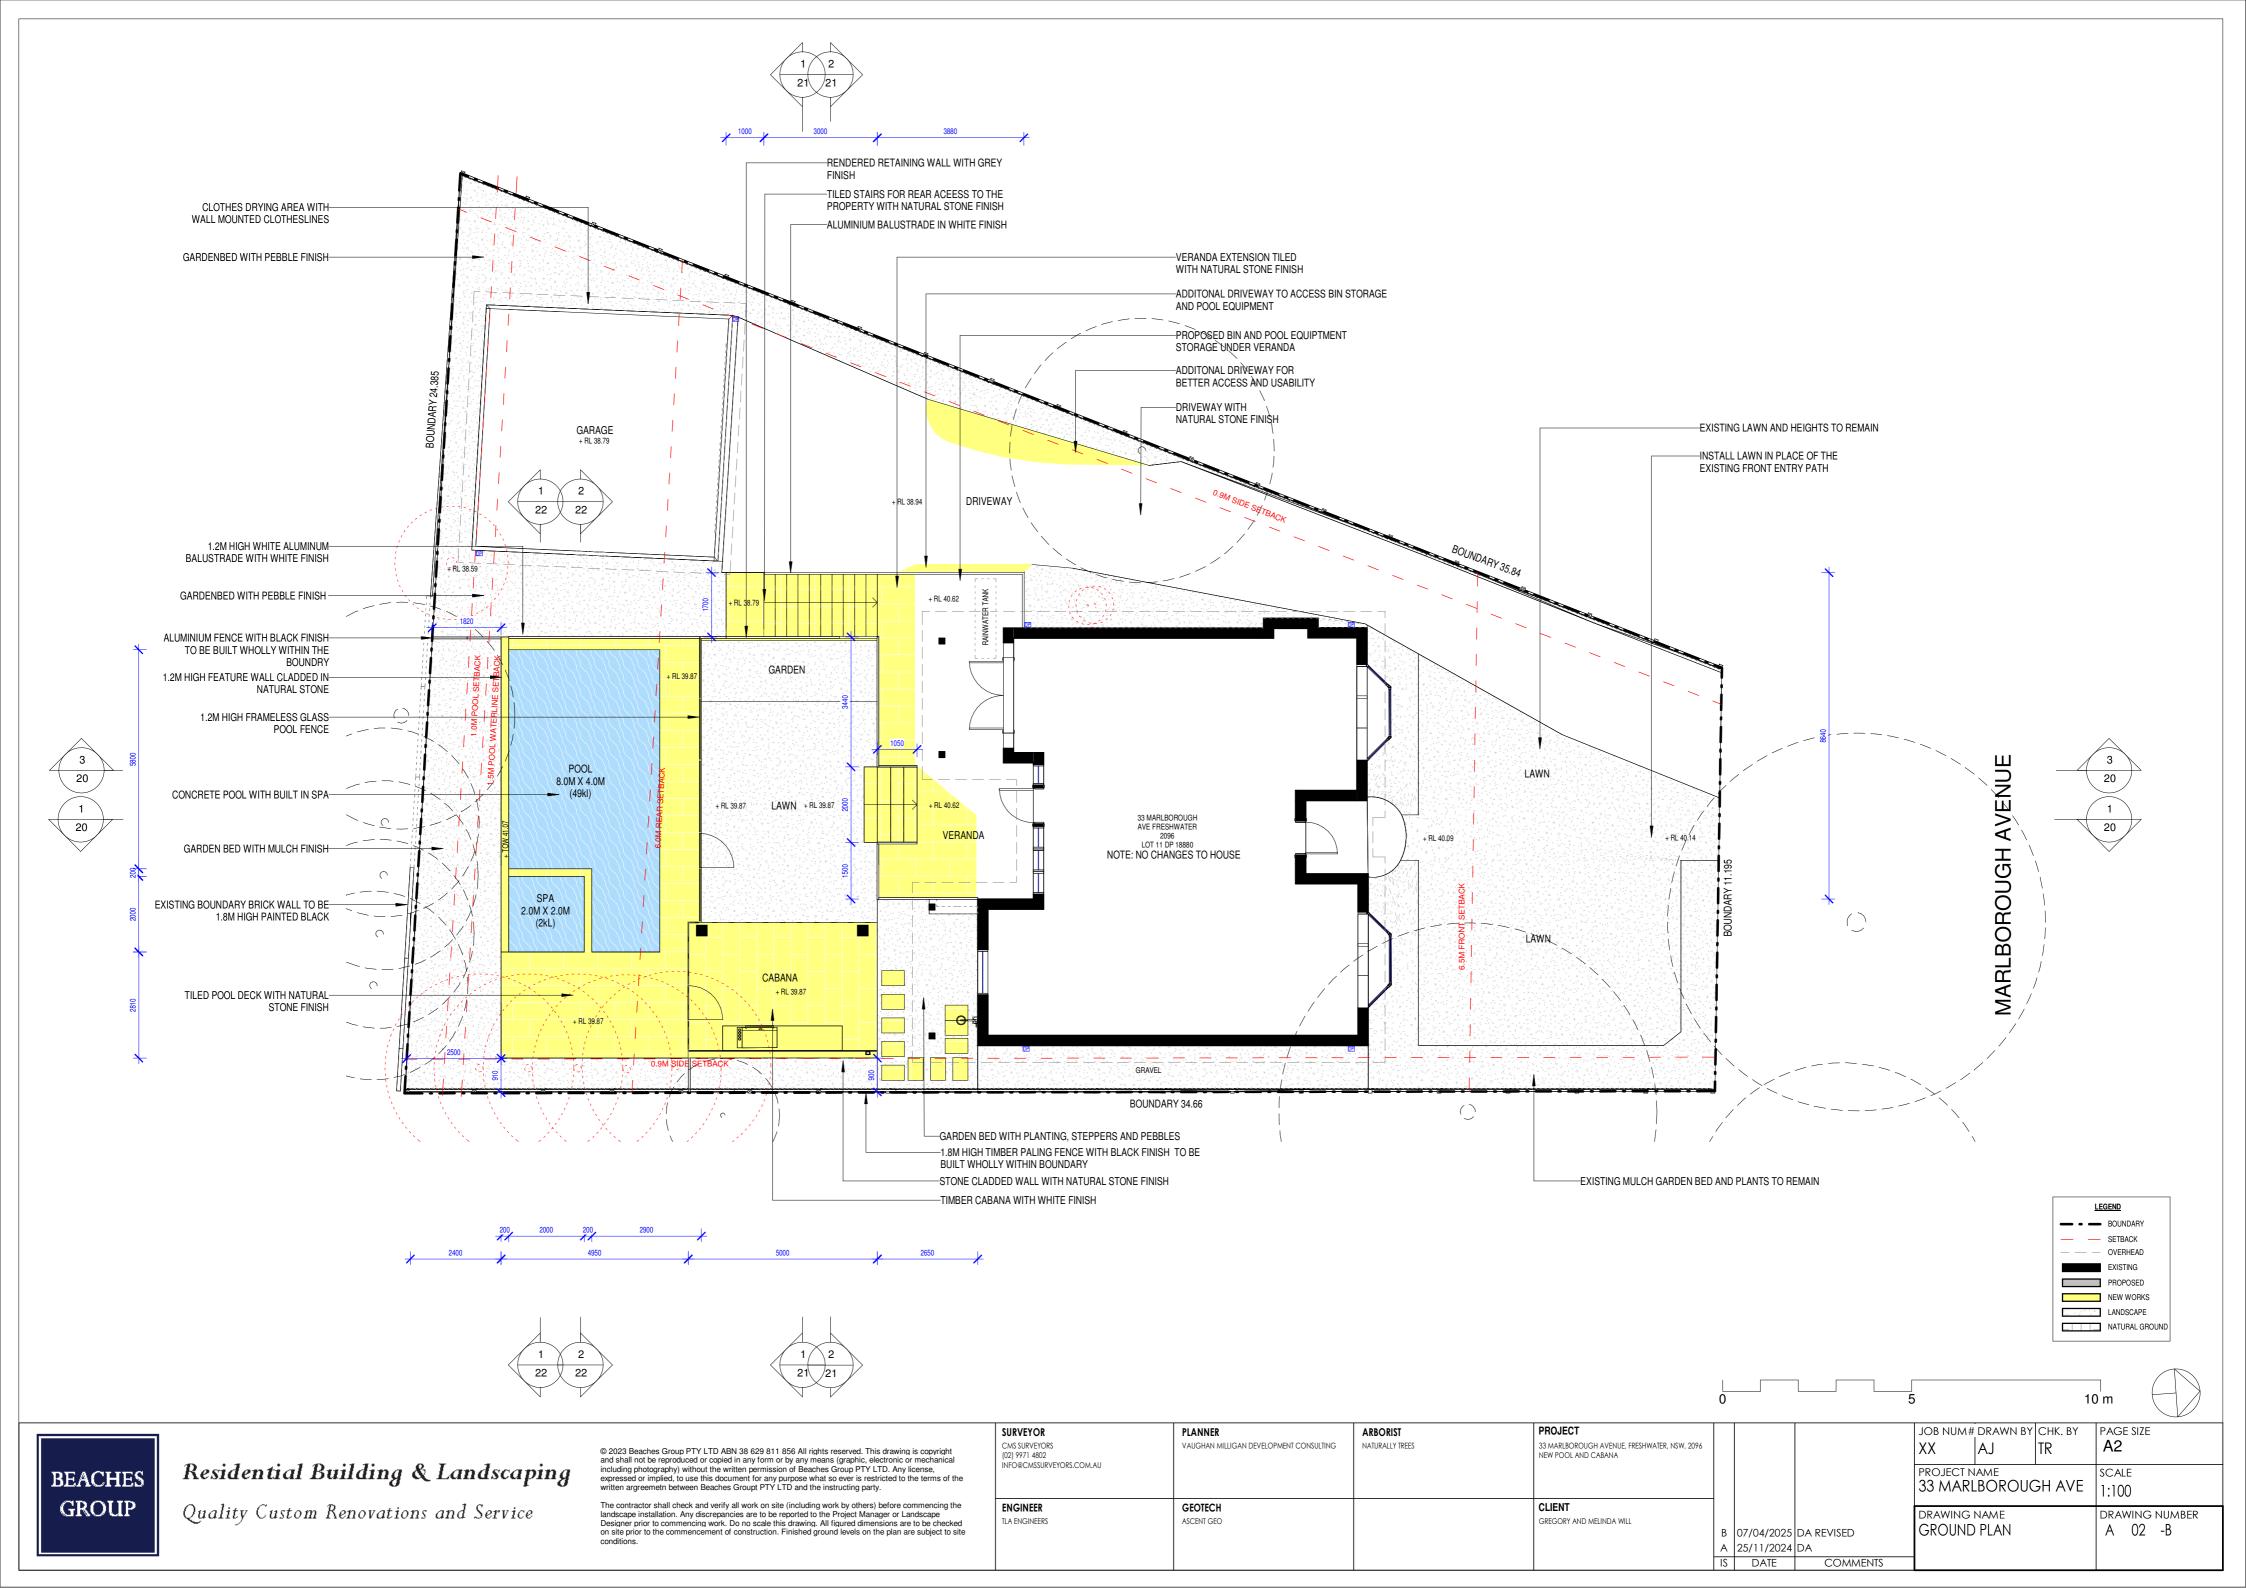
The contractor shall check and verify all work on site (including work by others) before commencing landscape installation. Any discrepancies are to be reported to the Project Manager or Landscape Designer prior to commencing work. Do no scale this drawing. All figured dimensions are to be chec on site prior to the commencement of construction. Finished ground levels on the plan are subject to


CMS SURVEYORS (02) 9971 4802 INFO@CMSSURVEYORS.COM.AU
ENGINEER
TLA ENGINEERS

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NEER	GEOTECH		CLIENT	
GINEERS	ASCENT GEO		GREGORY AND MELINDA WILL	


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NORTH ELEVATION



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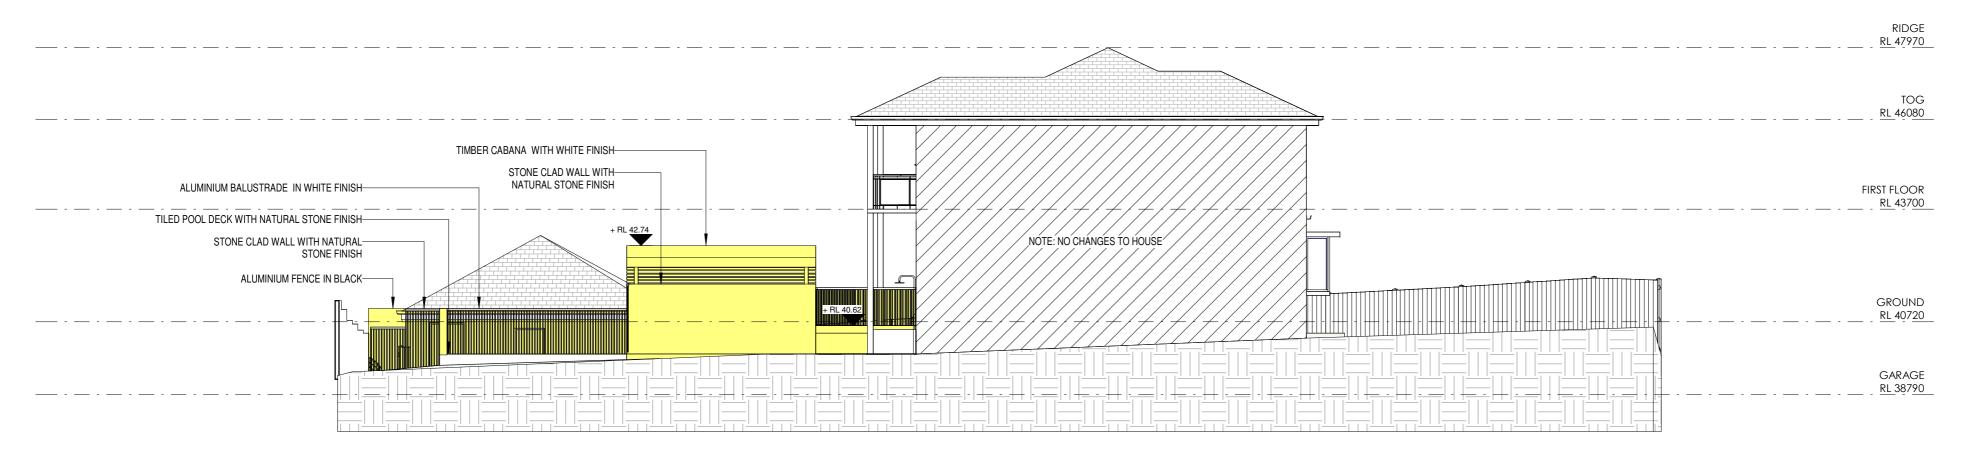
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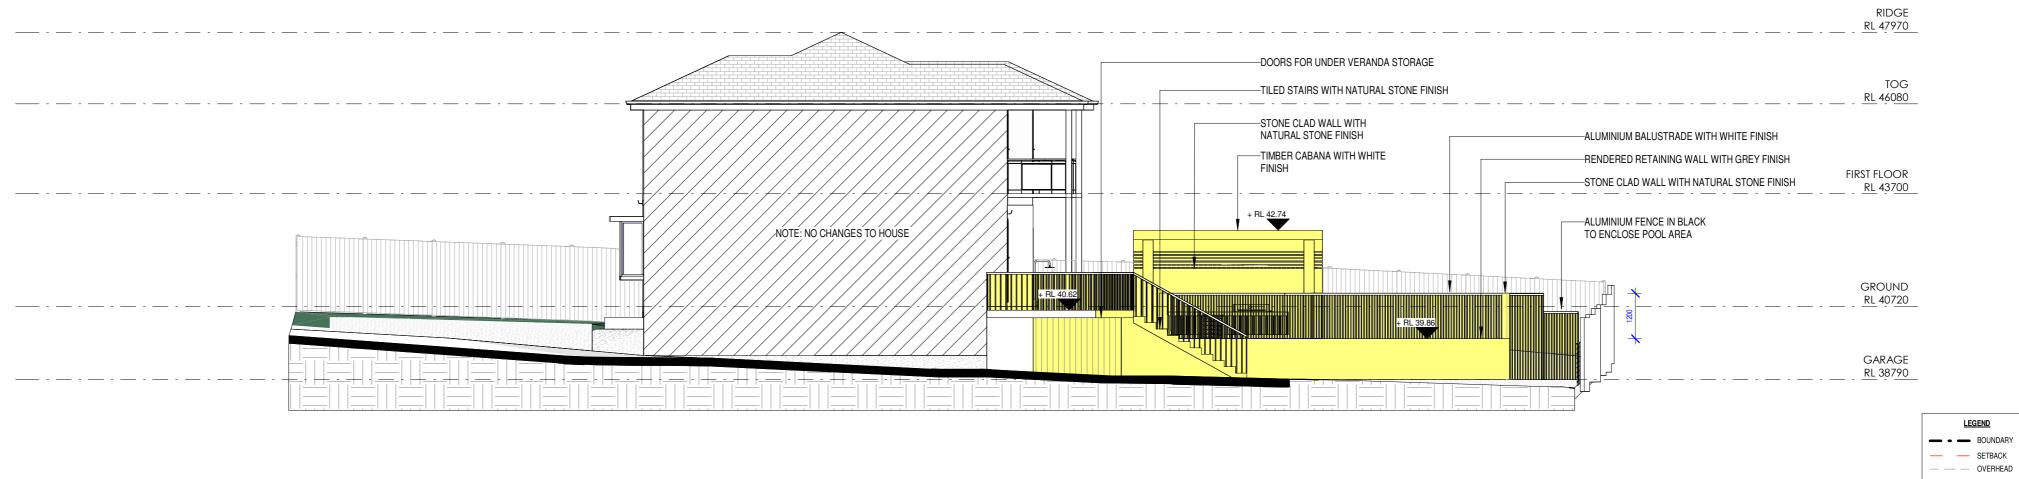
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	llation. Any discrepancies are to be reported to the Project Manager or Landscape
	o commencing work. Do no scale this drawing. All figured dimensions are to be checked
	he commencement of construction. Finished ground levels on the plan are subject to site
conditions.	
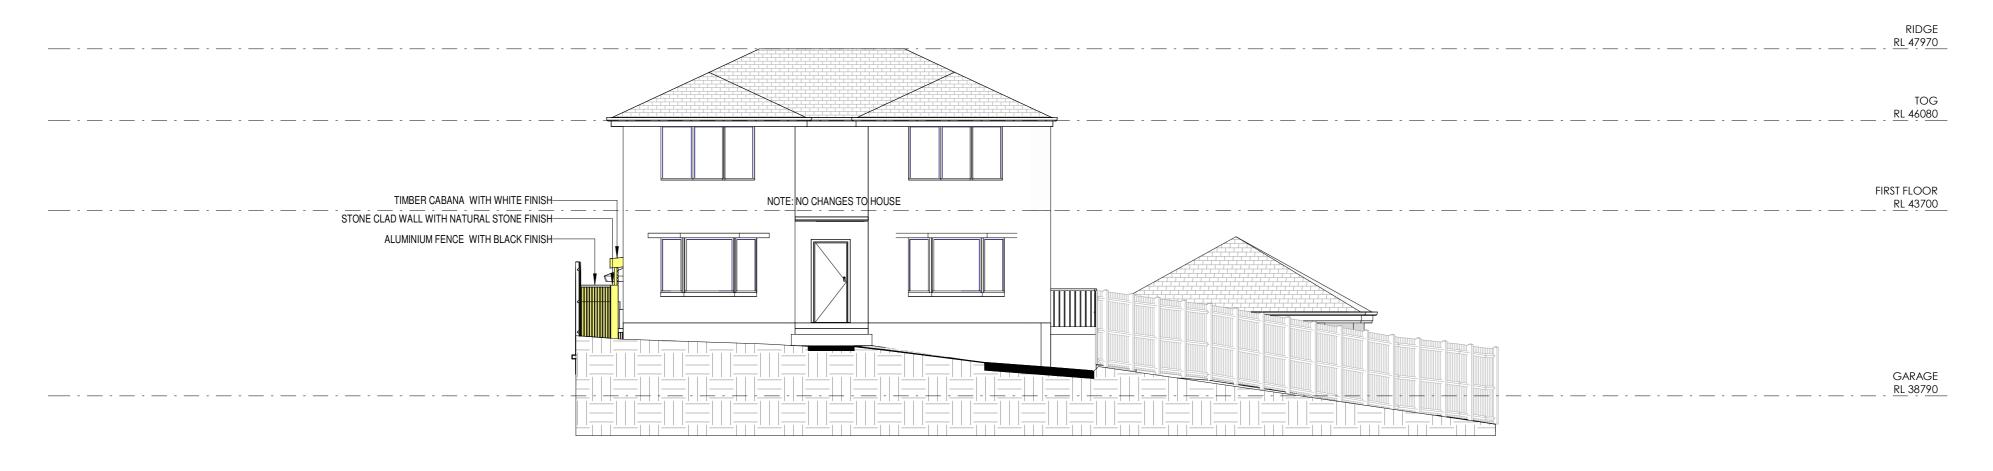
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INFO@CMSSURVEYORS.COM.AU			The House of Bridge				PROJECT N	l Name LBOROU(		SCALE 1:100
ENGINEER TLA ENGINEERS	GEOTECH ASCENT GEO		CLIENT GREGORY AND MELINDA WILL	1 1	07/04/2025 25/11/2024 DATE	DA REVISED			DRAWING NUMBER A 10 -B	

NEW WORKS
LANDSCAPE
NATURAL GROUND

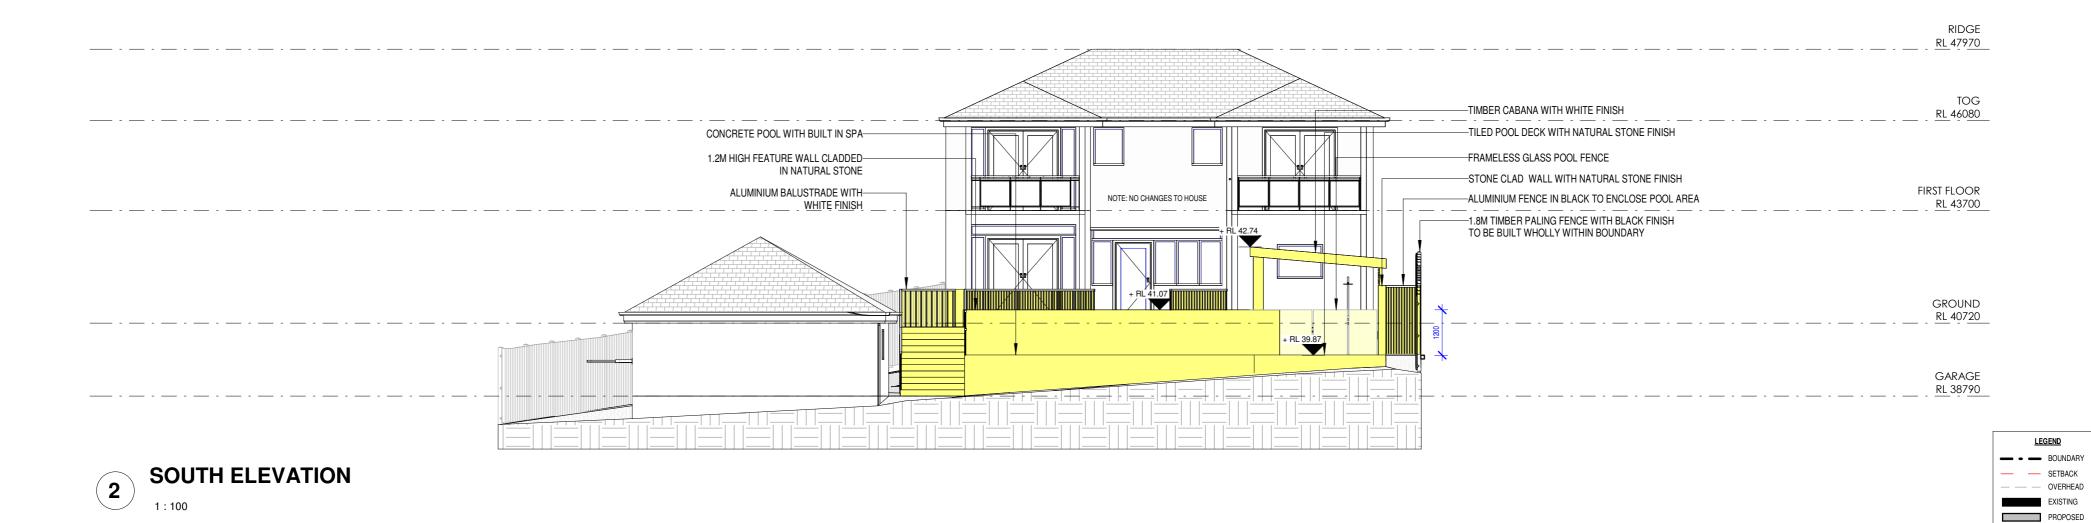

**EAST ELEVATION** 





**WEST ELEVATION** 



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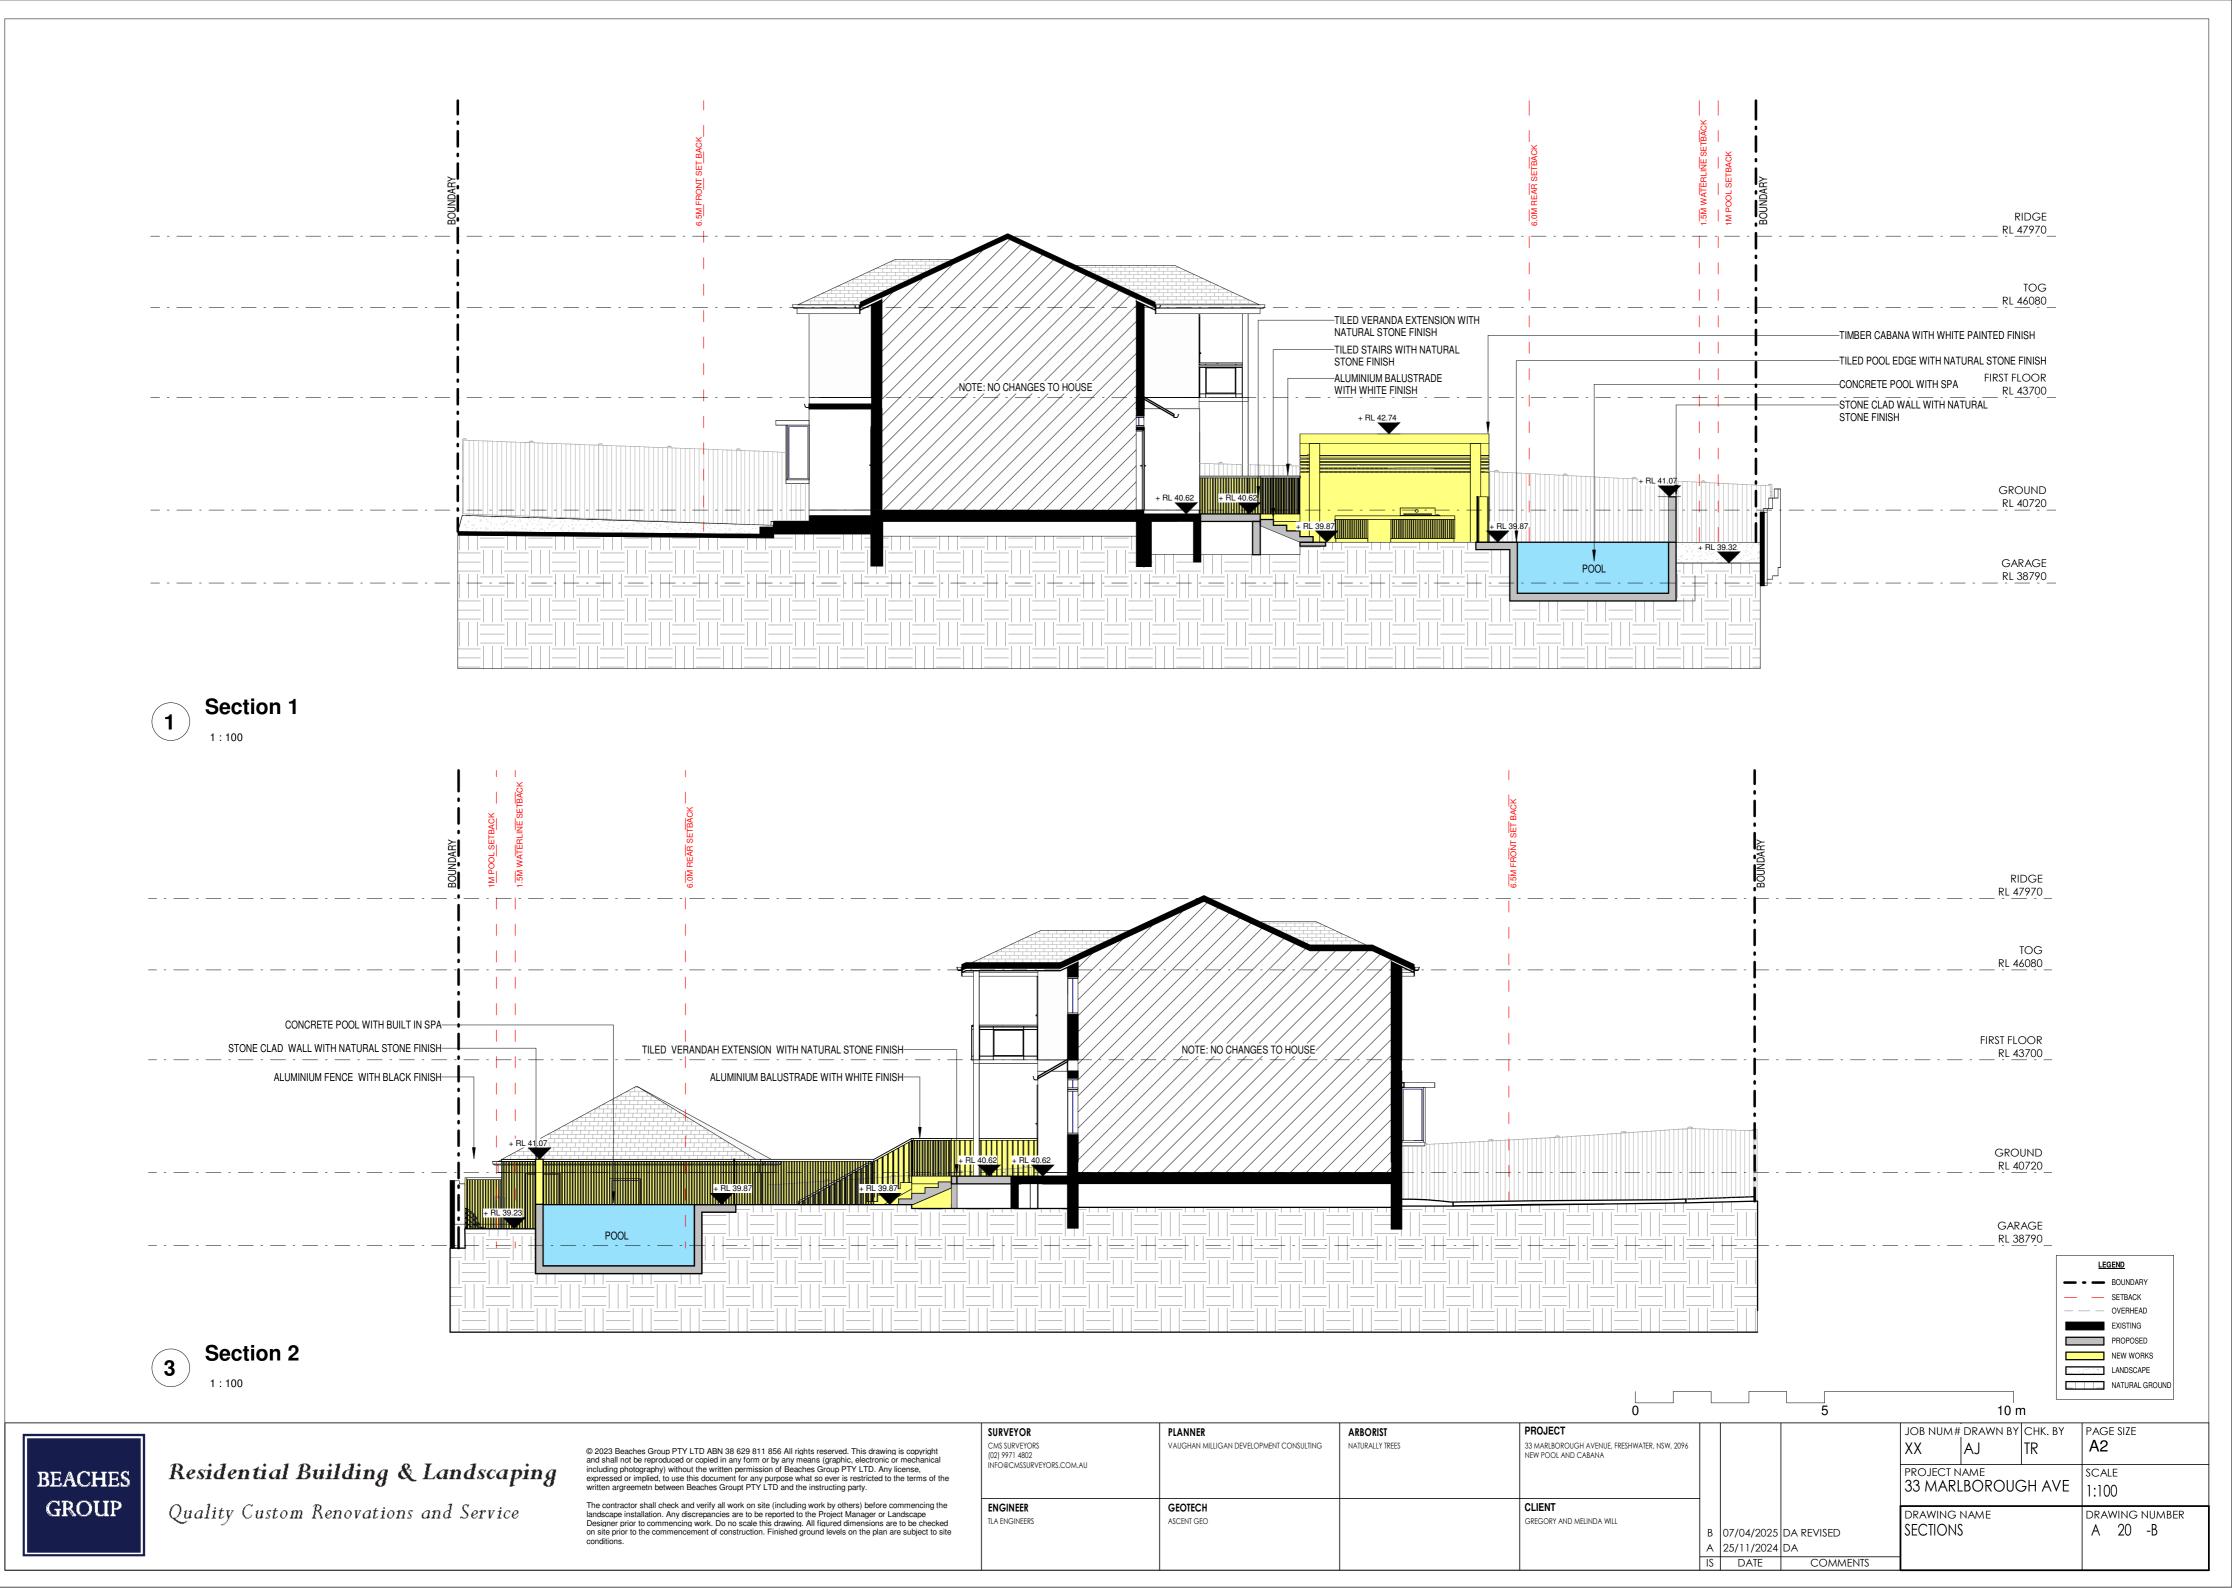
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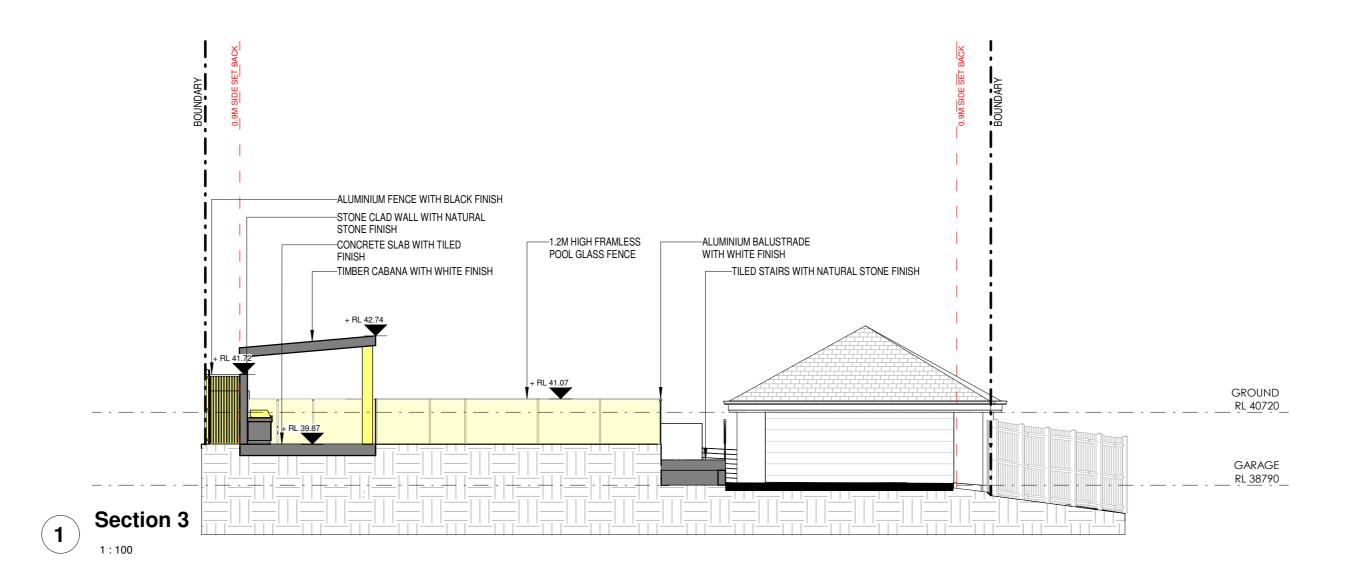
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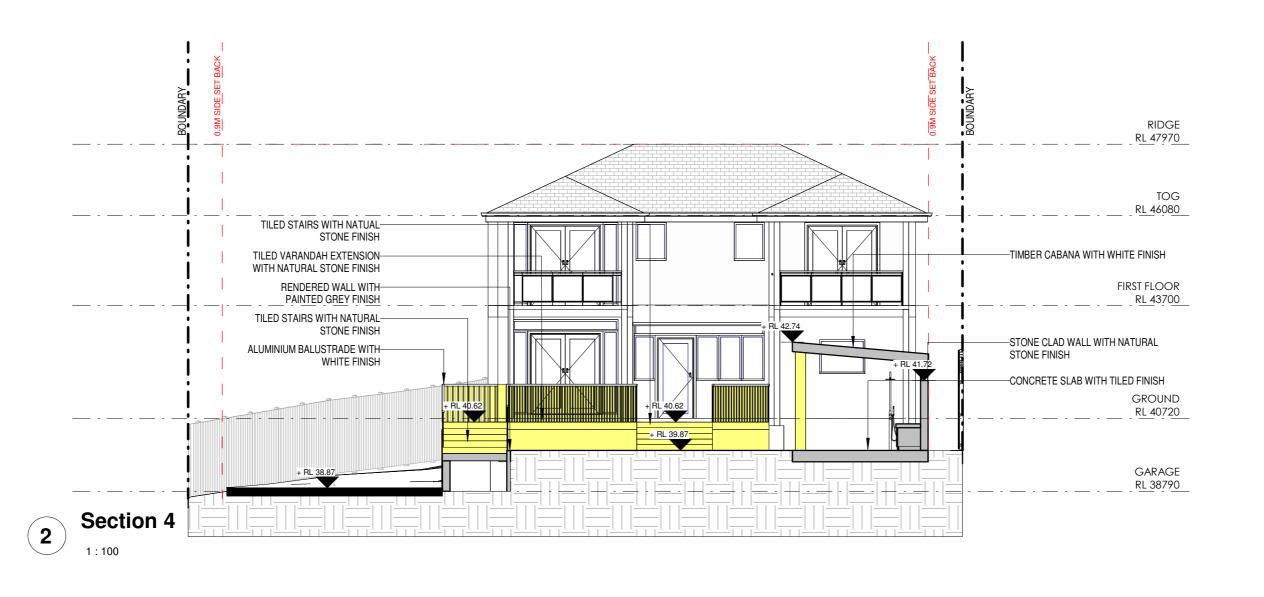
**LEGEND** 

PROPOSED NEW WORKS LANDSCAPE

NATURAL GROUND









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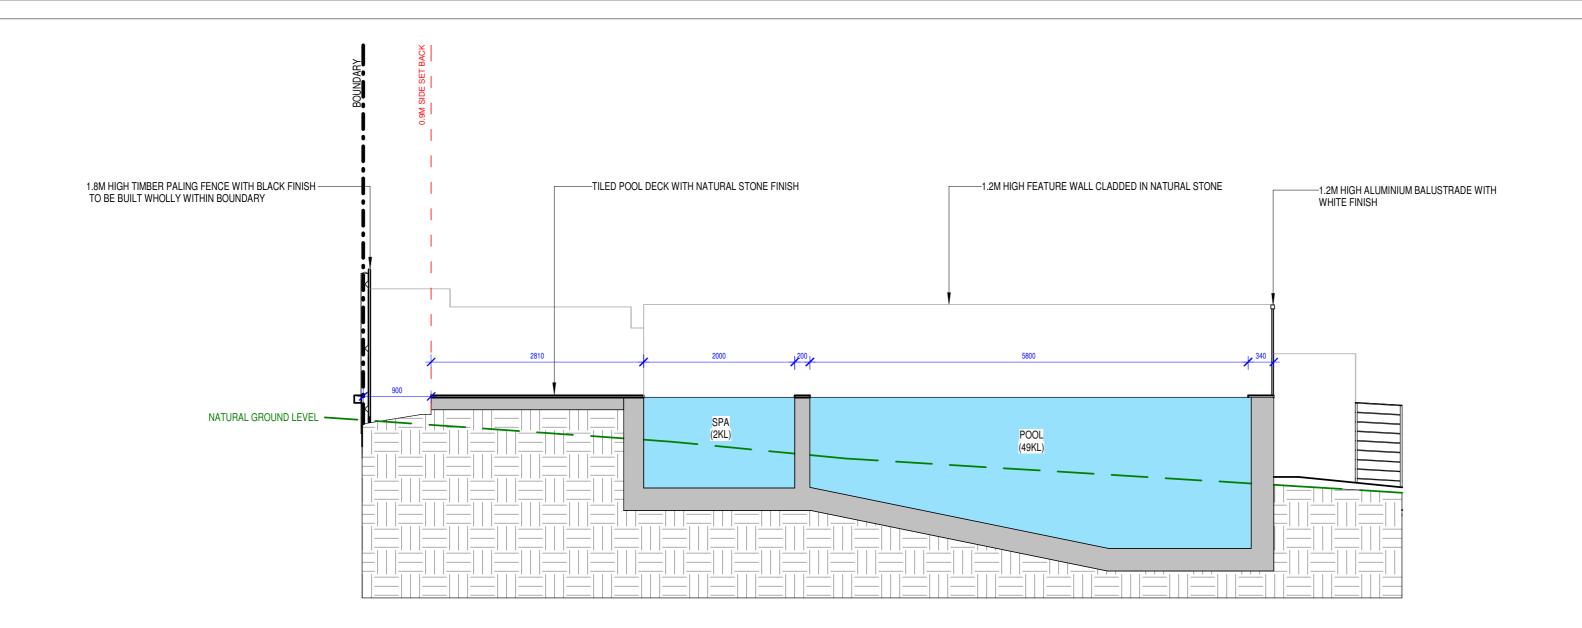
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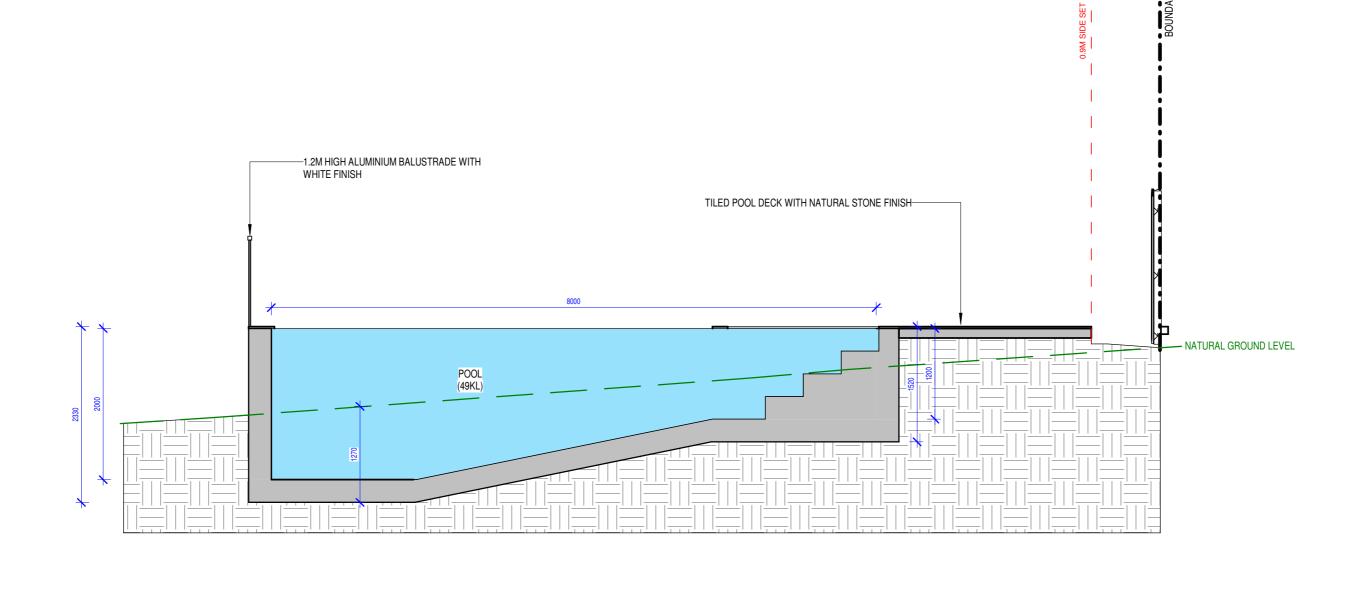
SETBACK
OVERHEAD
EXISTING
PROPOSED
NEW WORKS
LANDSCAPE
NATURAL GROUND



(1)

### Section 5

1:50





**BEACHES** 

GROUP

### Section 6

1 · 50

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LEGEND

BOUNDARY

SETBACK

OVERHEAD


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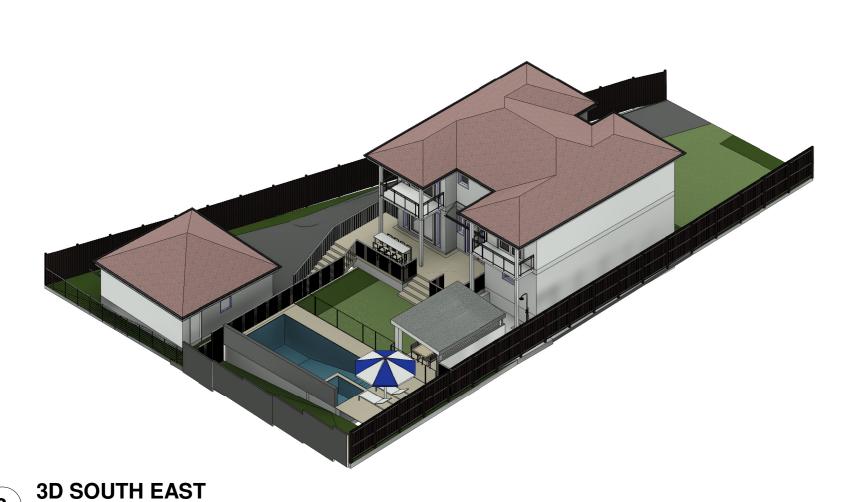
NEW WORKS

LANDSCAPE

NATURAL GROUND



**3D NORTH EAST** 

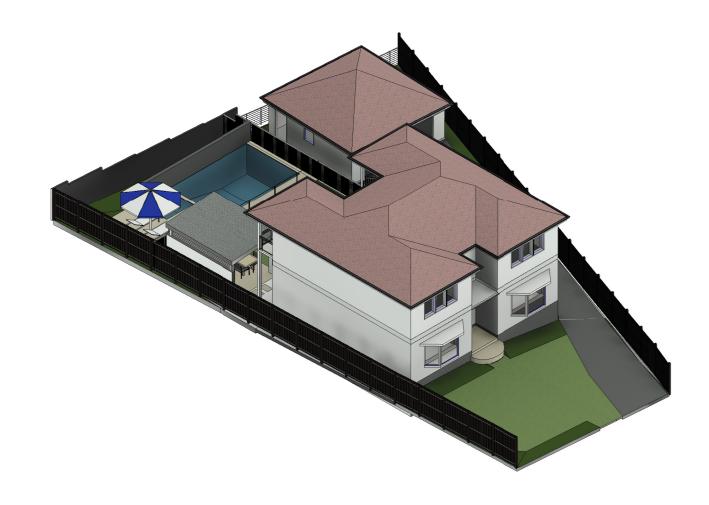

## **3D SOUTH WEST**

3D NORTH WEST

JOB NUM# DRAWN BY CHK. BY PAGE SIZE ARBORIST SURVEYOR CMS SURVEYORS (02) 9971 4802 INFO@CMSSURVEYORS.COM.AU 33 MARLBOROUGH AVENUE, FRESHWATER, NSW, 2096 NEW POOL AND CABANA VAUGHAN MILLIGAN DEVELOPMENT CONSULTING NATURALLY TREES A2 PROJECT NAME 33 MARLBOROUGH AVE SCALE 1:100 CLIENT ENGINEER GEOTECH DRAWING NUMBER A 100 -B DRAWING NAME TLA ENGINEERS ASCENT GEO GREGORY AND MELINDA WILL PROPOSED 3D B 07/04/2025 DA REVISED

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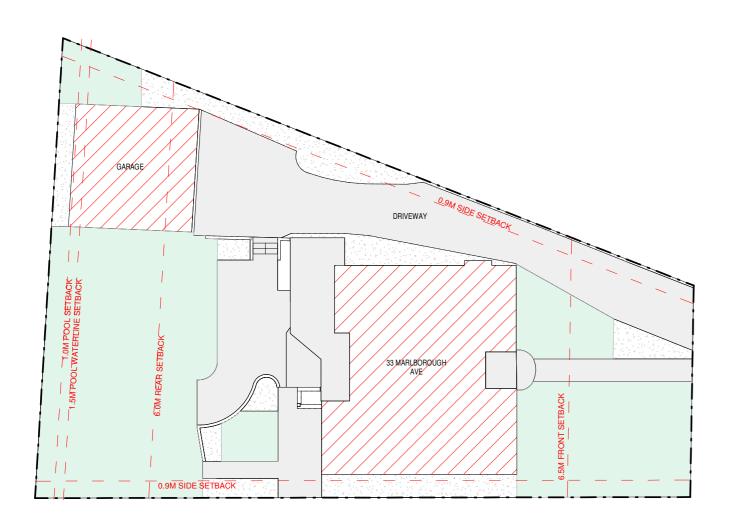
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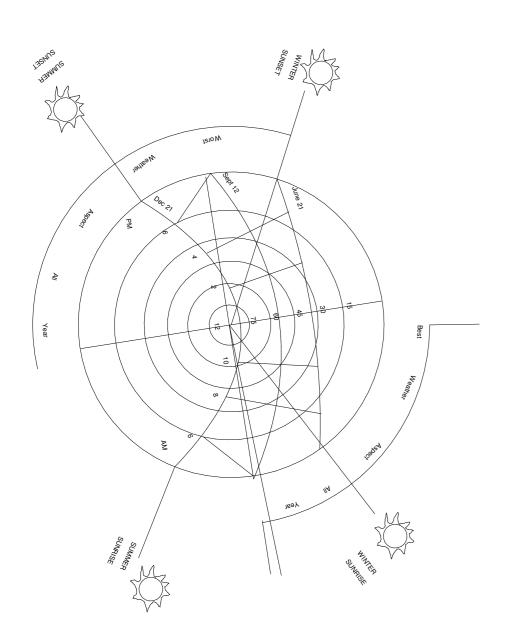
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### **GROUND EXISTING**



#### SITE ANALYSIS

- MAX HEIGHT


SITE AREA	609.6 M2
ZONE	R2
(EX) FLOOR AREA	N/A
(PRO) FLOOR AREA	N/A
(EX) FLOOR SPACE RATIO	N/A
(PRO) FLOOR SPACE RATIO	N/A
LANDSCAPE 40% REQ	243 M2 = 40%
(EX) LANDSCAPE	217 M2 = 35%
(PRO) LANDSCAPE	217 M2 = 35%
SETBACKS - (EX) FRONT - (PRO) FRONT - (EX) SIDE - (PRO) SIDE - (EX) REAR - (PRO) REAR	UNCHANGED UNCHANGED UNCHANGED UNCHANGED UNCHANGED UNCHANGED

N/A



# 2

### **GROUND PROPOSED**

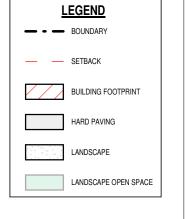



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