

BUSHFIRE REQUIREMENTS: Refer to bushfire assessment report and Australian Standards for BAL29.







EXTERNAL VIEW 1









EXTERNAL VIEW 2

2

4

6



EXTERNAL VIEW 4



EXTERNAL VIEW 6

FLOOR SC	FLOOR SCHEDULE		
CODE ID	DESCRIPTION		
F-EC	EXISTING floor structure with EXISTING carpet.		
F-ECON	EXISTING concrete slab structure with EXISTING		
	concrete finish.		
F-EP1	EXISTING floor structure with NEW tiles/paving.		
	Waterproof as required.		
F-ET1	EXISTING floor structure with NEW timber floorboards.		
F-ET2	EXISTING floor structure with NEW timber floorboards		
	over existing floorboards.		
F-ETL	EXISTING floor structure with EXISTING tile.		
F-ETL1	EXISTING floor structure with NEW tiles. Waterproof as		
	required.		
F-P1	NEW floor structure with NEW tiles/paving. Waterproof		
	as required. As per engineer's detail.		
F-T1	NEW floor structure with NEW timber floorboards. As		
1 - 1 1	per engineer's detail.		
F-TL1	NEW floor structure with NEW tiles. Waterproof as		
	required. As per engineer's detail.		

### WINDOW, DOOR & SKYLIGHT SCHEDULE CODE ID DESCRIPTION

	CODE ID	DESCRIPTION
		(D01, D02etc) NEW aluminium framed door.
	D01	Powdercoated. Refer to BASIX requirements. To
		comply with BAL 29 rating.
	DE	EXISTING door to remain. Make good as required.
	DN	NEW internal timber door, painted as specified.
	DN-JP	NEW internal joinery panel door, finish as specified.
	S01	(S01, S02etc) NEW skylight. Refer to BASIX
301		requirements.
		(W01, W02etc) NEW aluminium window.
	W01	Powdercoated. Refer to BASIX requirements. To com
		with BAL 29 rating.
	WE	EXISTING window to remain. Make good as required

<b>ROOF SCHI</b>	ROOF SCHEDULE			
CODE ID	DESCRIPTION			
DP	NEW downpipe, as specified.			
e-DP	EXISTING downpipe. Make g			
R-EM	EXISTING timber framed root			
	metal roof sheets. Keep and I			
R-ET	EXISTING timber framed root			
	roof tiles. Keep and Protect.			
	NEW timber framed roof struc			
R-M1	corrugated metal sheet, as sp			
	detail.			
R-T1	NEW timber framed roof struc			
	as specified. As per engineer			

WALL SCHE	WALL SCHEDULE			
CODE ID	DESCRIPTION			
P-ET	EXISTING timber post structure.			
P-T1	NEW (BAL 29 Hardwood) timber post structure.			
F - I I	Painted, as specified. As per engineer's detail.			
W-EST	EXISTING wall structure with EXISTING stone facing			
VV-LST	as specified.			
	NEW timber framed wall structure with NEW FC			
W-LW1	weatherboard cladding, as specified. As per engined			
	detail. To comply with BAL 29 rating.			
	NEW timber framed wall structure with NEW flat FC			
W-LW2	cladding, as specified. As per engineer's detail. To			
	comply with BAL 29 rating.			
W-ST1	NEW wall structure with NEW stone facing. As per			
VV-011	engineer's detail.			

# **CONN HOUSE DEVELOPMENT APPLICATION ISSUE B**

### LOUISE & MICK CONN 70 LANE COVE ROAD INGLESIDE NSW 2101

pecified. As per engineer's rating. ucture with NEW flat FC r engineer's detail. To

ucture with NEW FC

ture. mber post structure. er engineer's detail. th EXISTING stone facing,

ructure with NEW roof tiles, er's detail.

specified. As per engineer's

ucture with NEW

Protect. of structure with EXISTING

good as required. of structure with EXISTING

INSULATION:

CONSTRUCTION TO COMPLY WITH BAL 29. REFER TO

REFER TO SPECIFICATION FOR FLOOR, WALL, ROOF

STRUCTURAL:

REFER TO STRUCTURAL DRAWINGS FOR DETAILS.

REFER TO HYDRAULIC DRAWINGS FOR DETAILS.

ALL ROOFS CONNECTED TO STORMWATER SYSTEM. NEW GUTTERS AND DOWNPIPES IN LOCATIONS AS

BASIX:

REFER TO DA CONDITIONS.

ROOF STRUCTURE: TIMBER FRAMED ALL ROOFS TO BE SARKED AS SPECIFIED.

REFER TO BASIX FOR SUSTAINABILITY REQUIREMENTS.

## ACOUSTIC AND THERMAL INSULATION.

### ht. Refer to BASIX A29 SIX requirements.To comply GENERAL CONSTRUCTION NOTES . Make good as required. ROOFS:

SPECIFIED.

HYDRAULIC:

**BUSHFIRE:** 


BUSHFIRE REPORT

SECTION NAME


SECTION MAME	DRAWING NO.	DESCRIPTION
02 DEVELOPMENT	APPLICATION A3	
	A01	COVER PAGE
	A02	SCHEDULES
	A03	PERSPECTIVES 1
	A04	PERSPECTIVES 2
	A05	SURVEY-PART A
	A06	SURVEY-PART B
	A07	SITE PLAN
	A08	SITE ANALYSIS & LOCATION MAP
	A09	EXISTING PLANS 1
	A10	EXISTING PLANS 2
	A11	EXISTING ELEVATIONS
	A12	CELLAR
	A13	GROUND FLOOR-PART 1
	A14	GROUND FLOOR-PART 2
	A15	GROUND FLOOR-PART 3
	A16	LEVEL 1 PLAN
	A17	ROOF PLAN-PART 1
	A18	ROOF PLAN-PART 2
	A19	ELEVATION E1 & E2
	A20	ELEVATION E3 & E4
	A21	SECTION A & B
	A22	SECTION C & D
	A23	SECTION E
	A24	SHADOWS JUNE 21-9AM
	A25	SHADOWS JUNE 21-12NOON
	A26	SHADOWS JUNE 21-3PM
	A27	LANDCAPE DIAGRAMS
	A28	LANDCAPE CALCULATION

FINISHES SCHEDULE

DRAWING No. DESCRIPTION

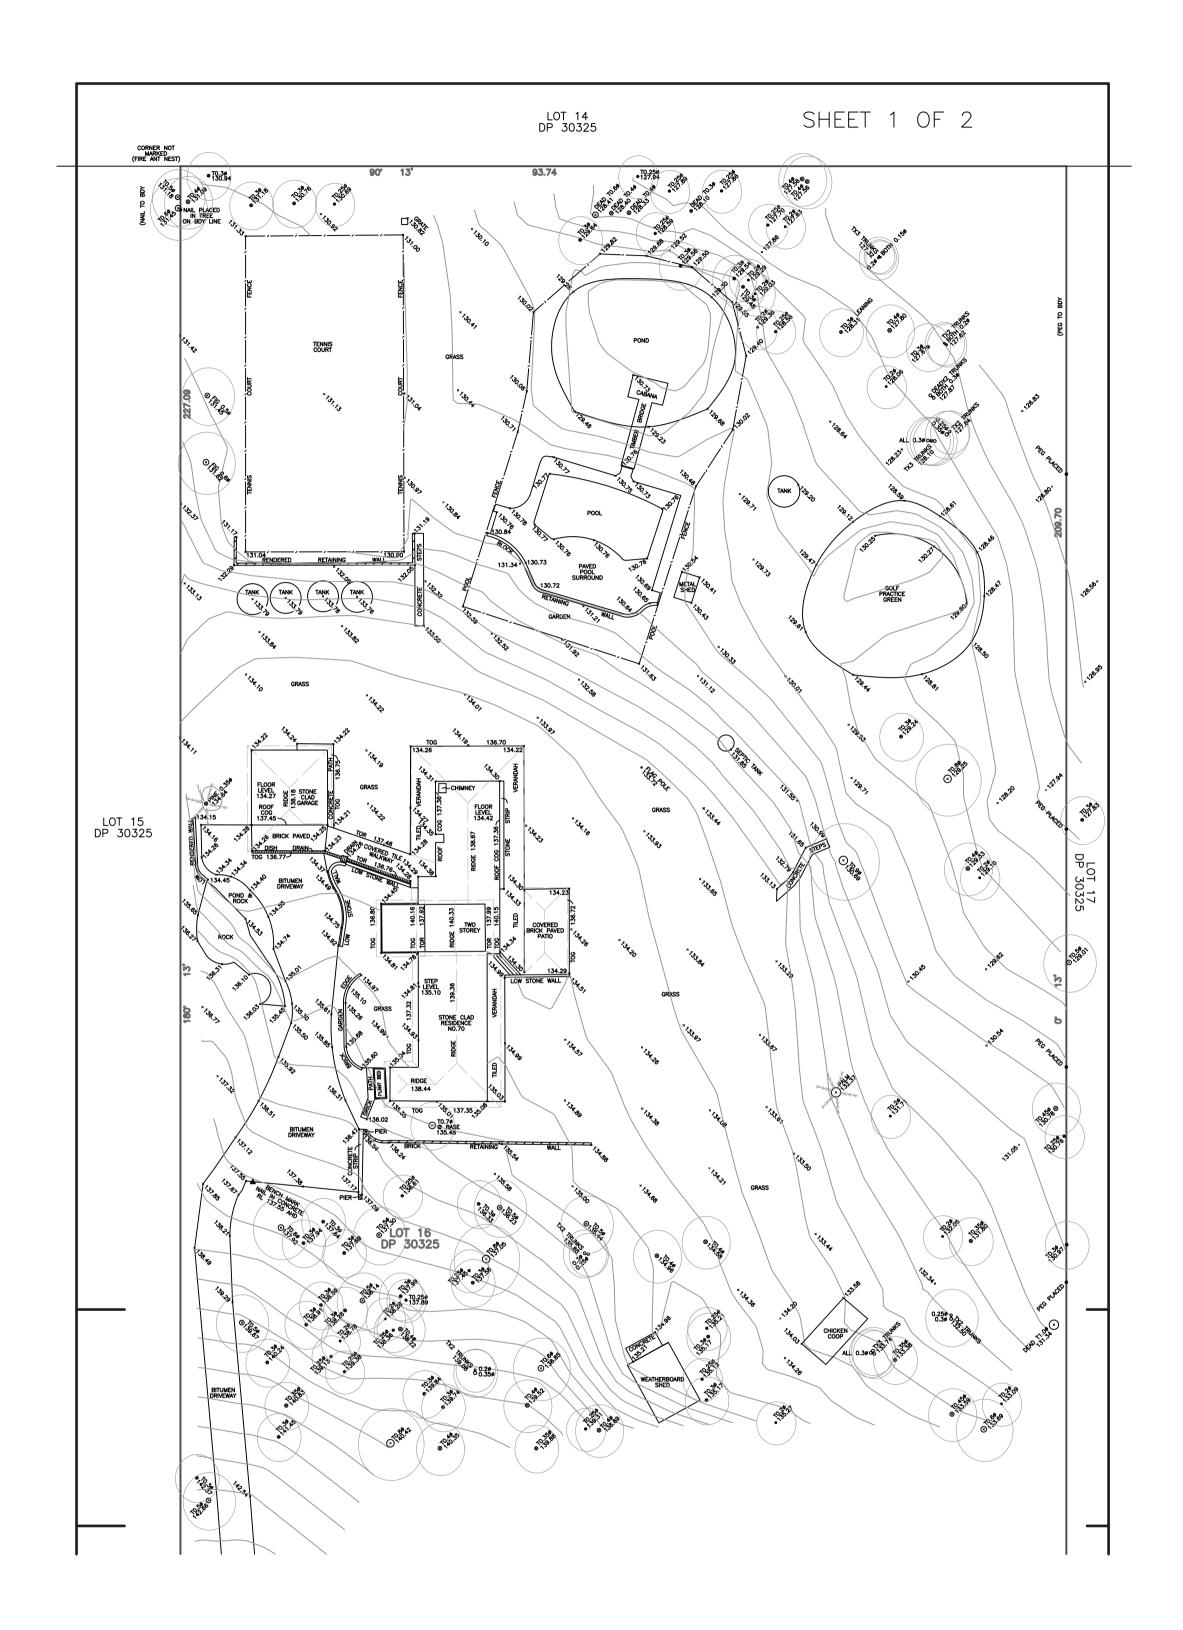

В	APPROX. POOL DEPTH, VOLUME AND POOL SECTION ADDED	11/03/2020
А	DEVELOPMENT APPLICATION ISSUE	02/03/2020
ID	DESCRIPTION	DATE

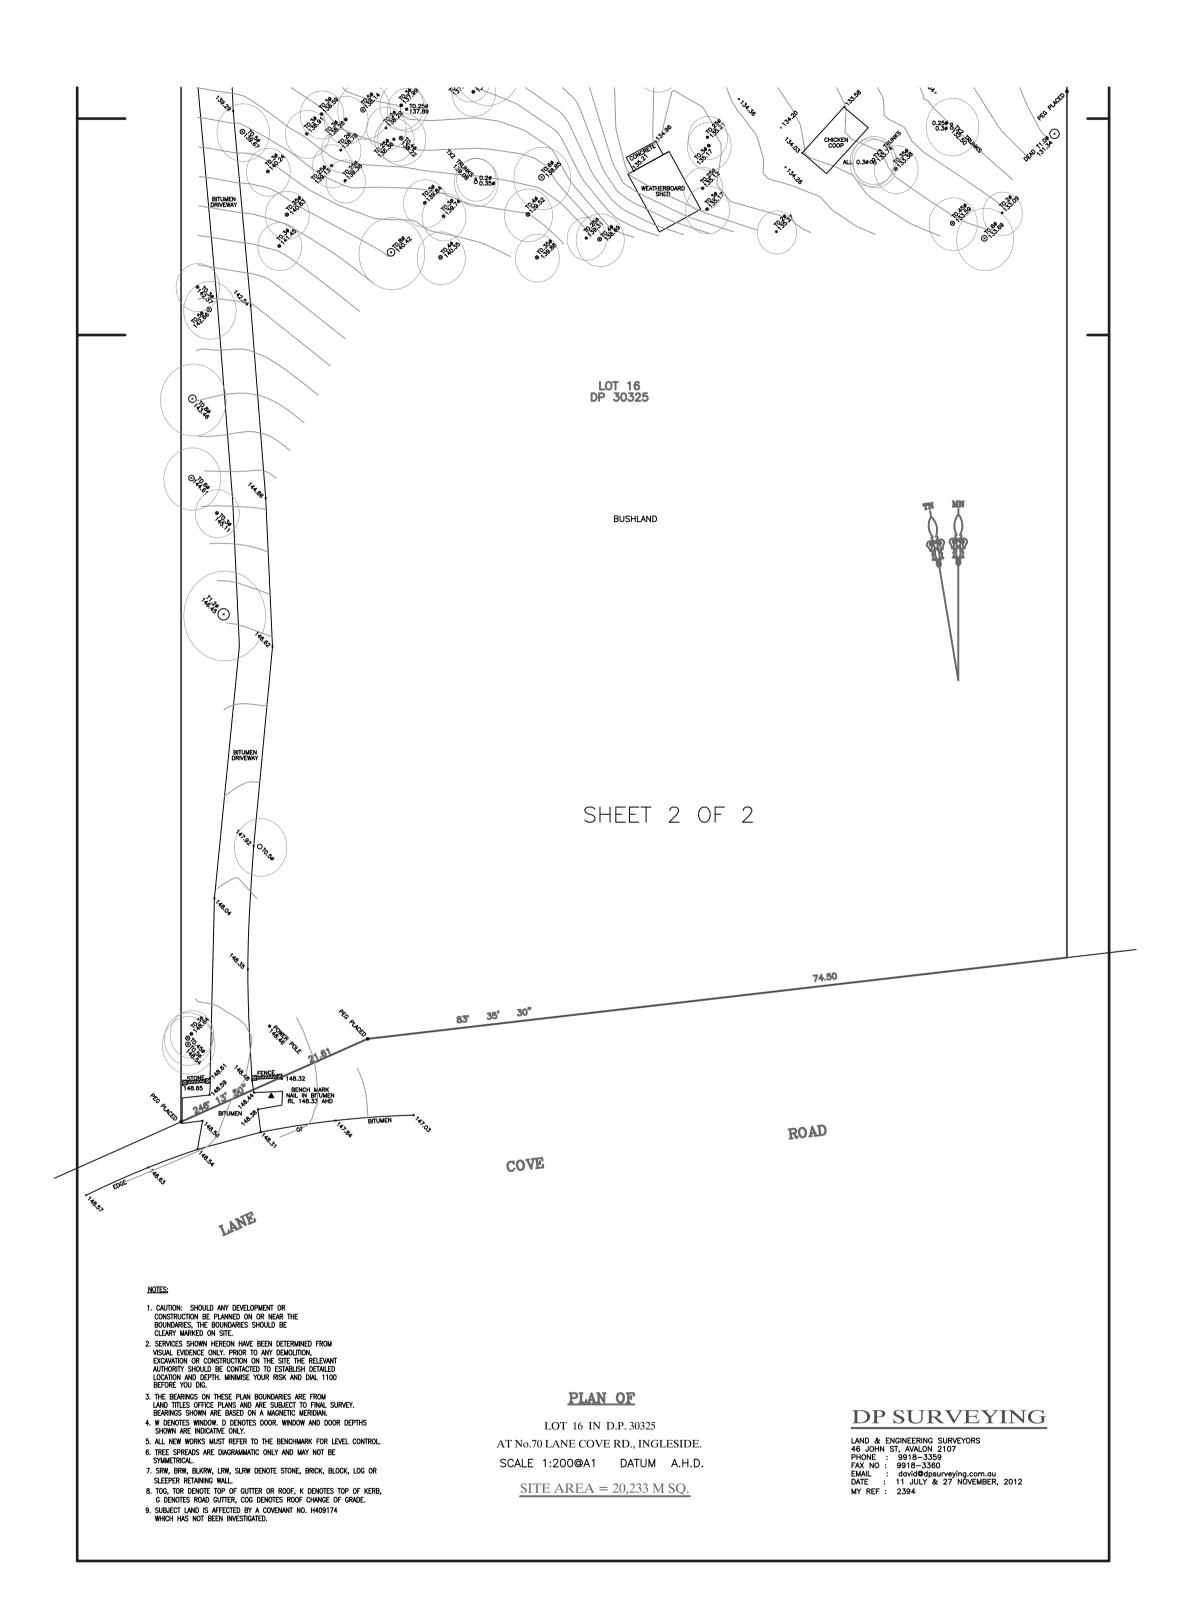

### IENT APPLICATION

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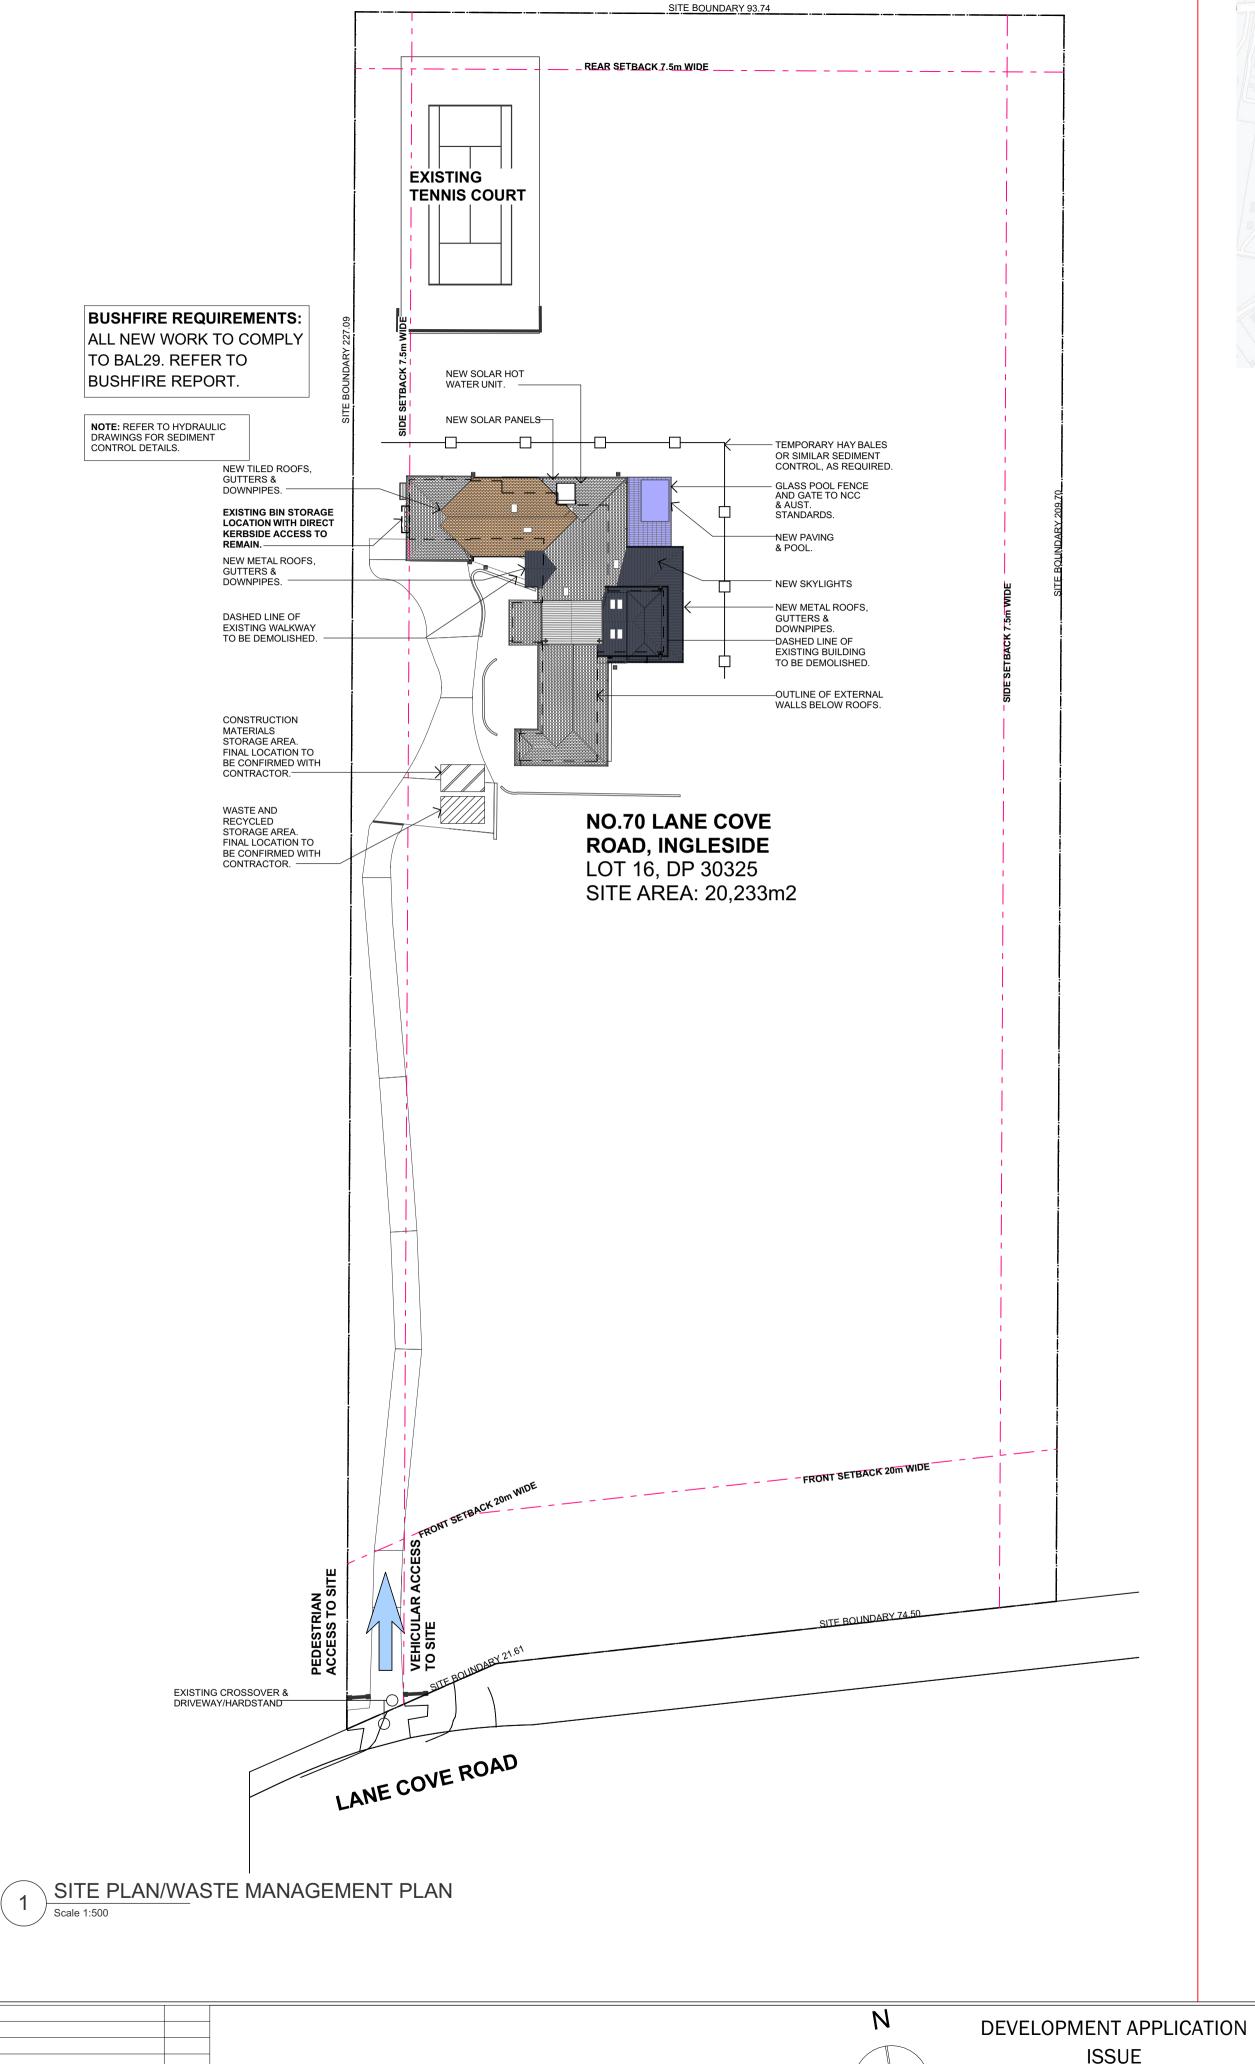
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70 LANE COVE ROAD INGLESIDE NSW 2101 SURVEY


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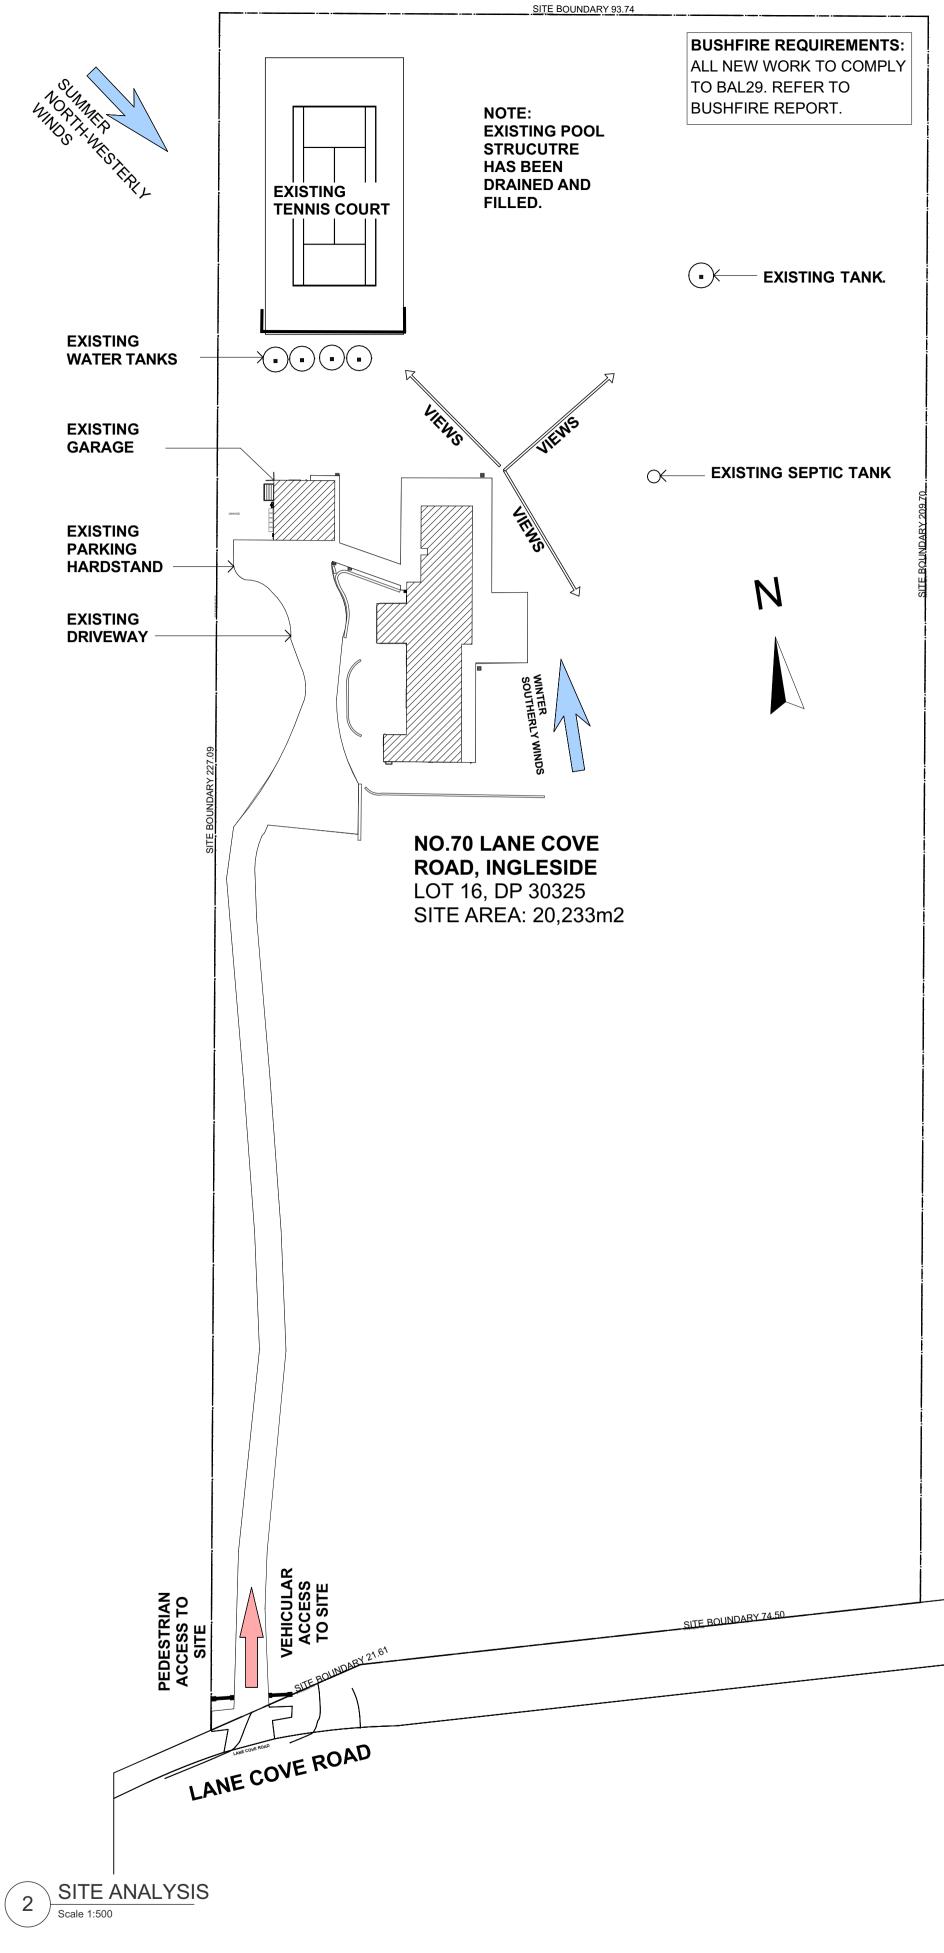
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DESCRIPTION	DATE
DEVELOPMENT APPLICATION ISSUE	02/03/2020
APPROX. POOL DEPTH, VOLUME AND POOL SECTION ADDED	11/03/2020








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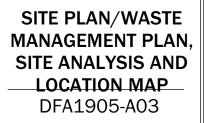
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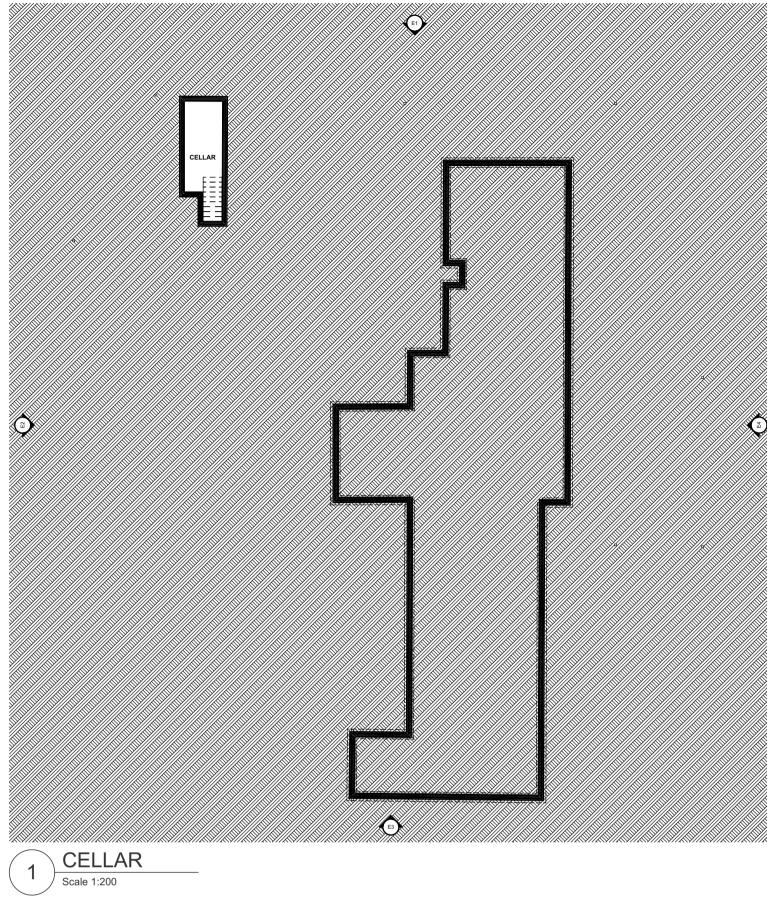
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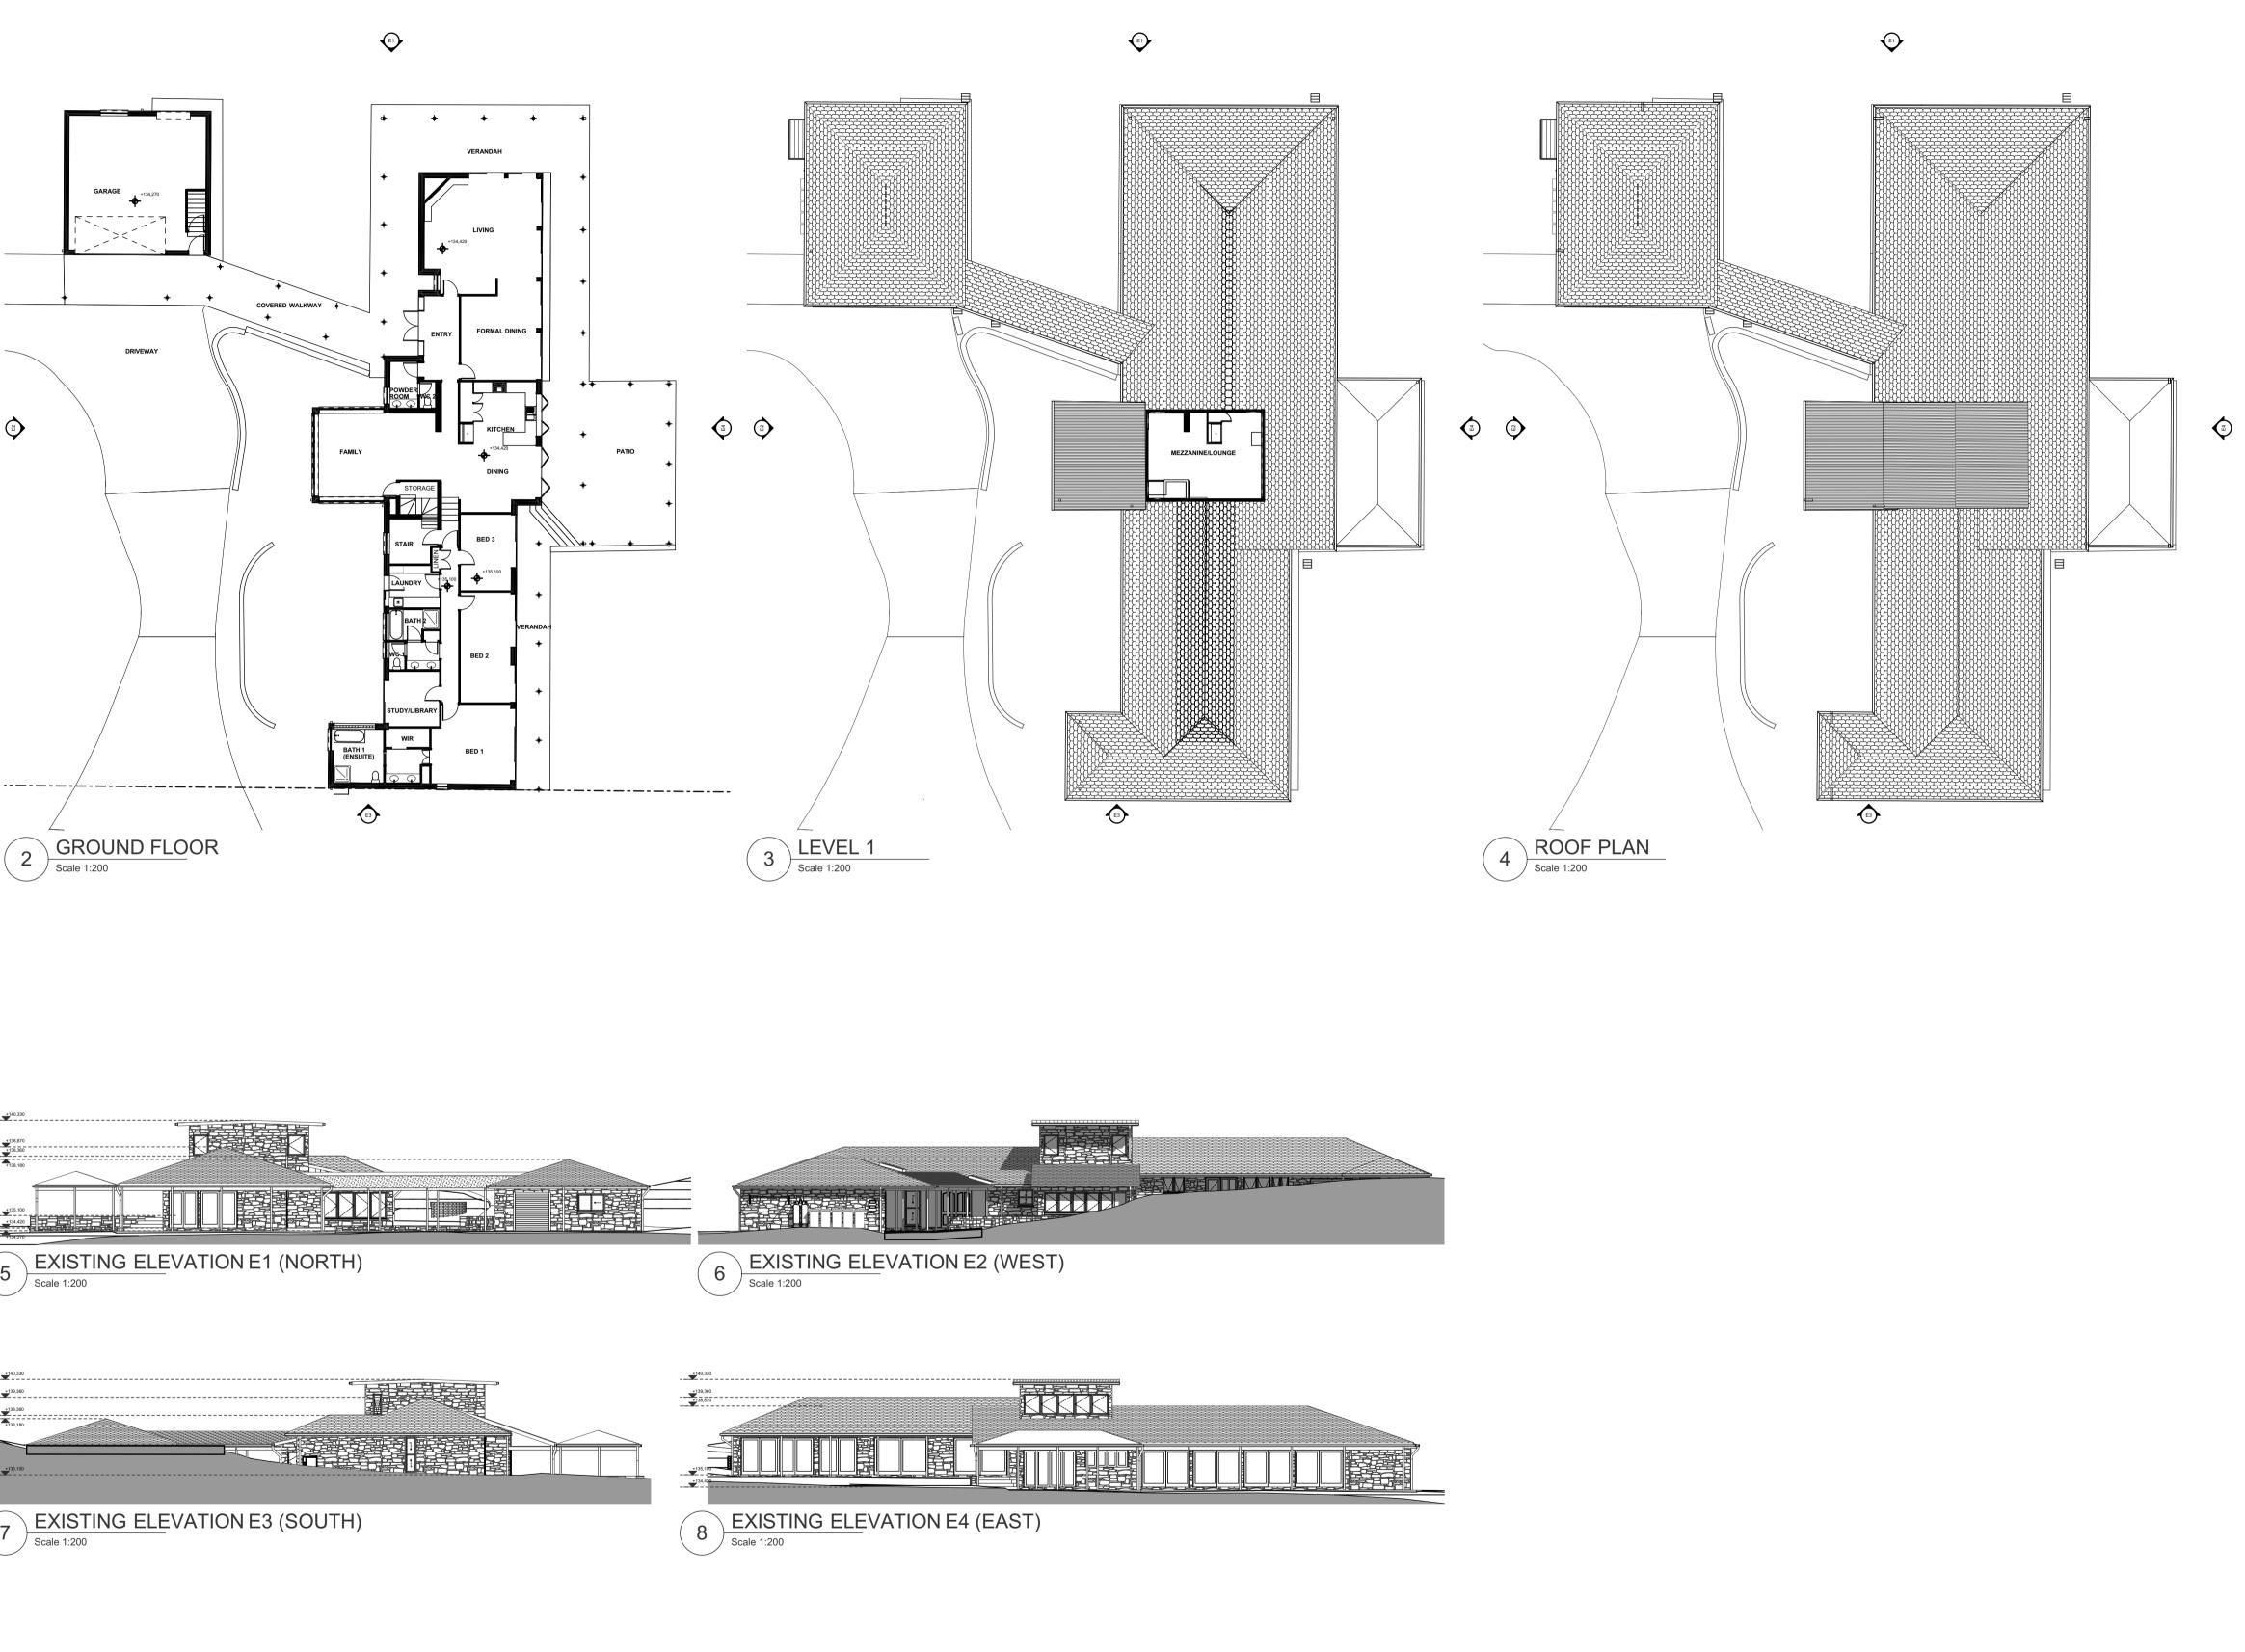
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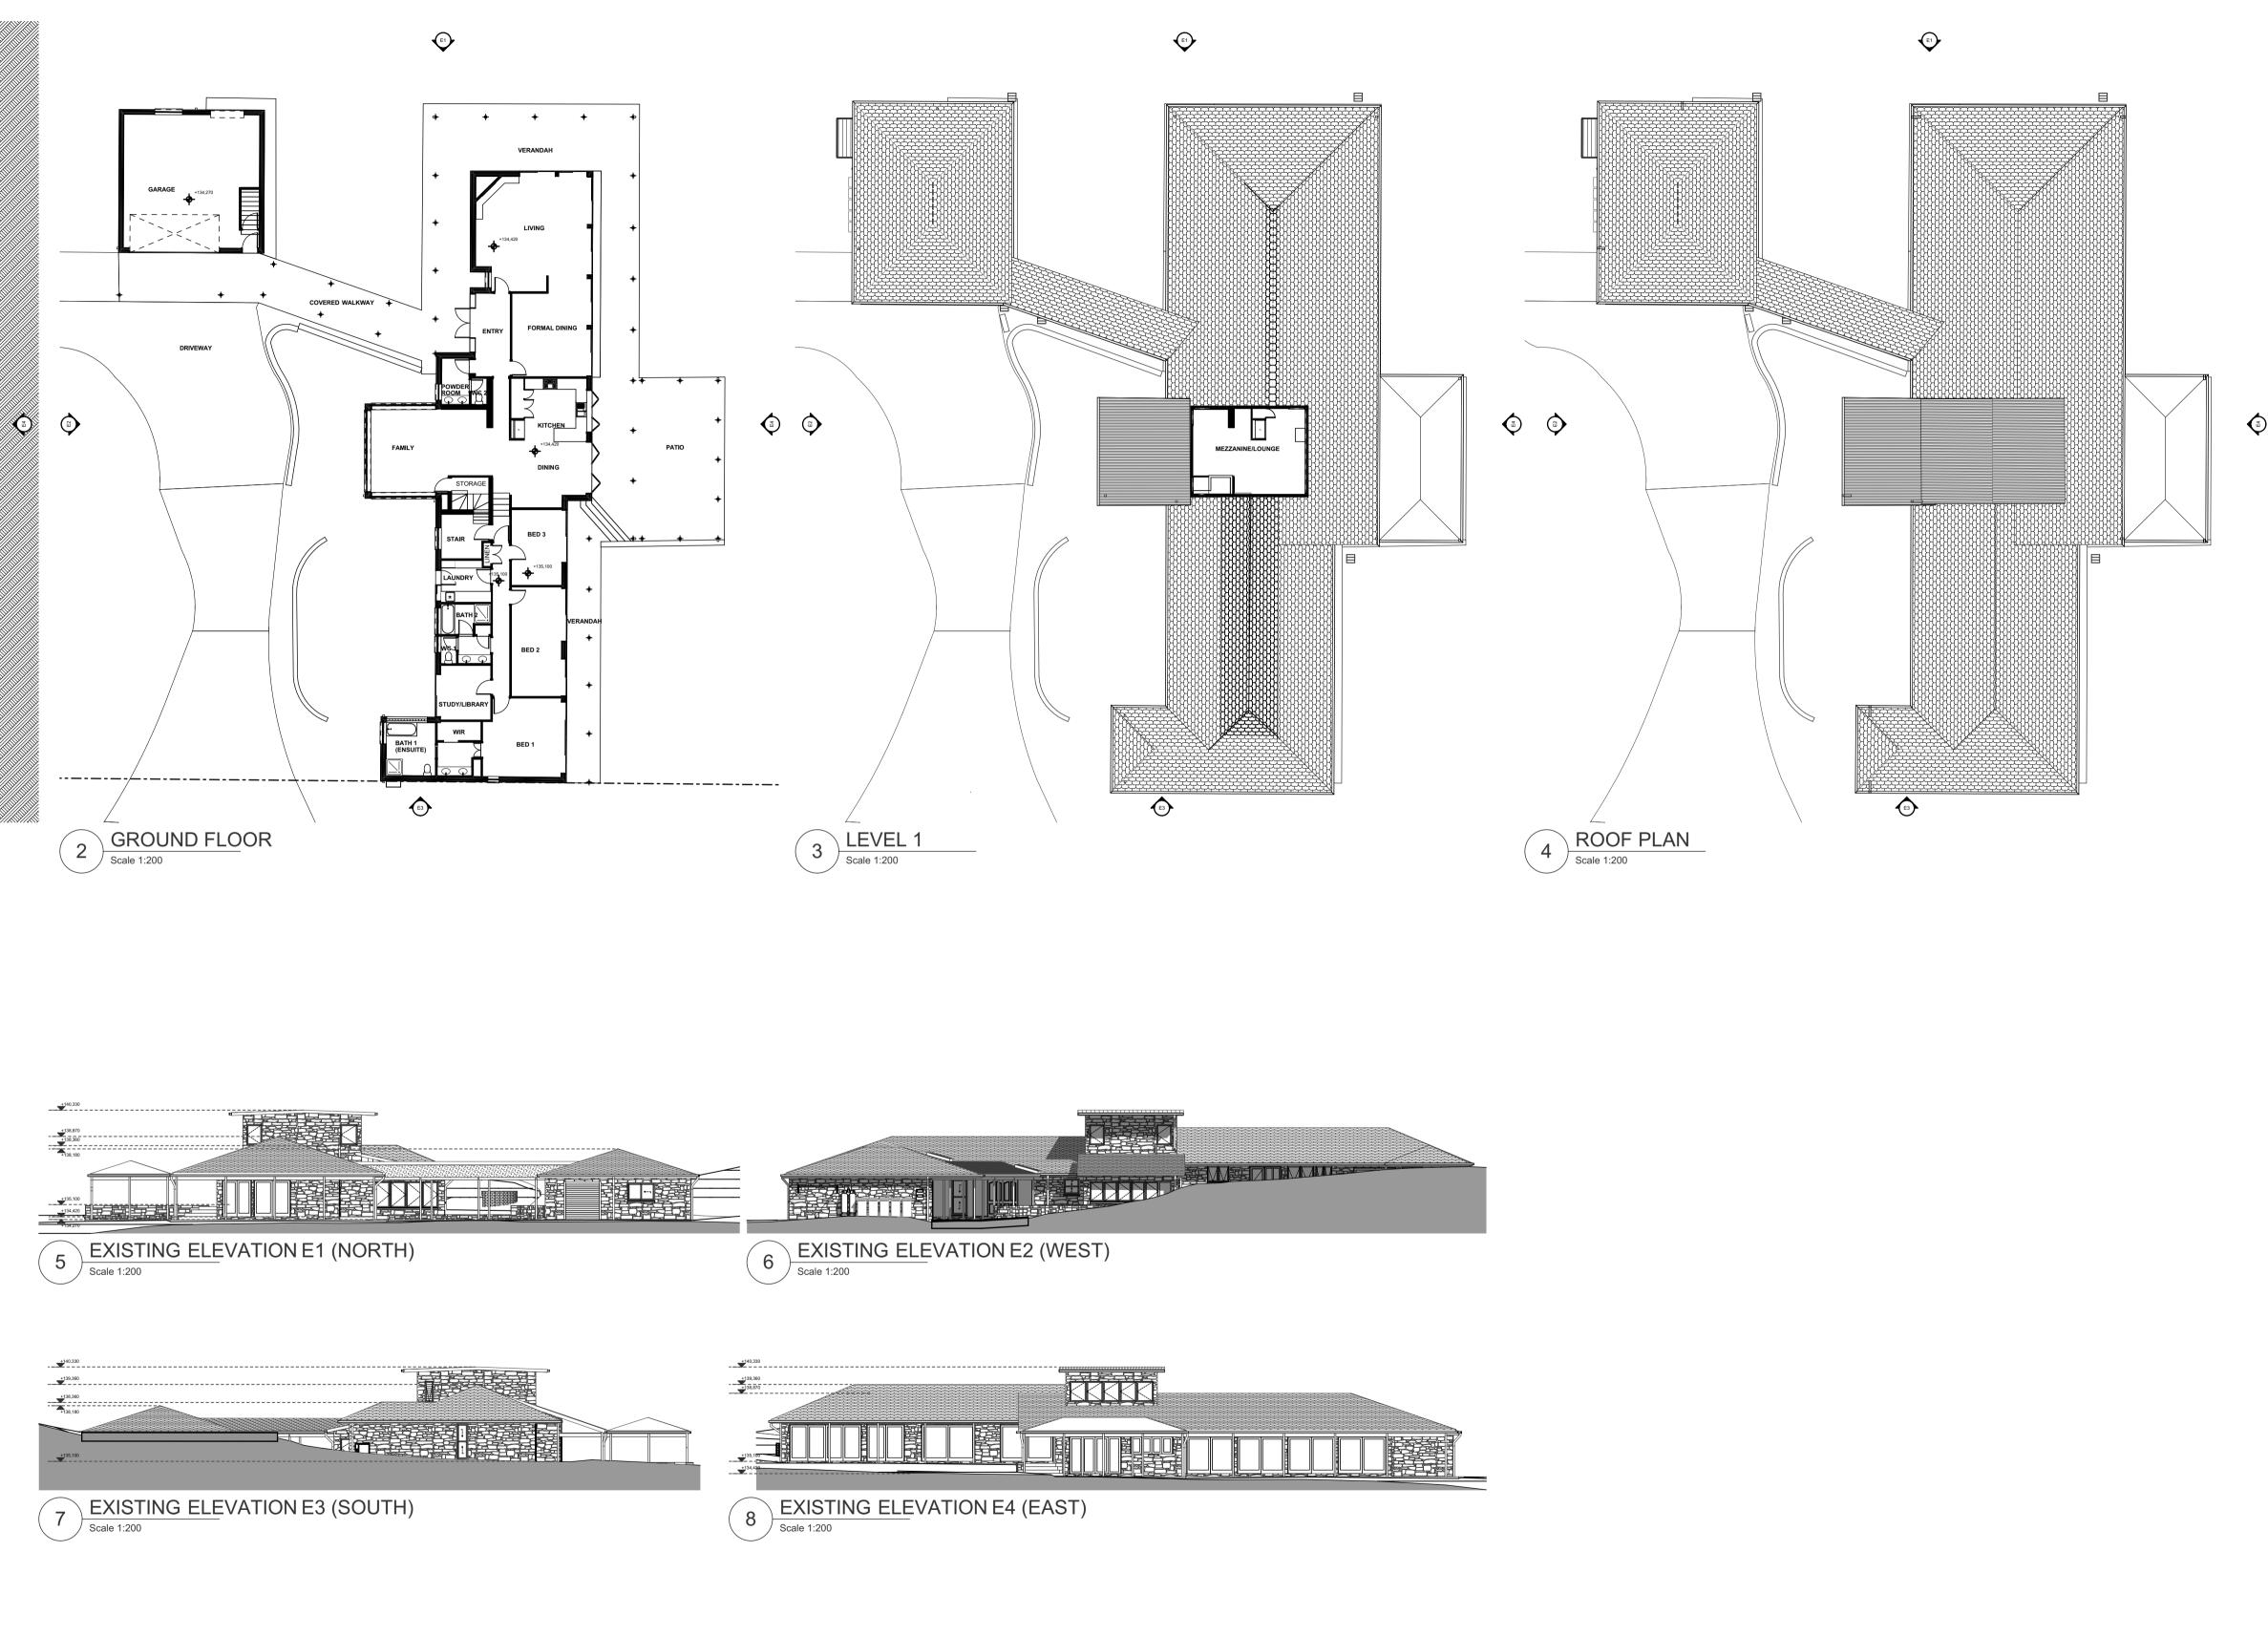
70 LANE COVE ROAD **INGLESIDE NSW 2101** 

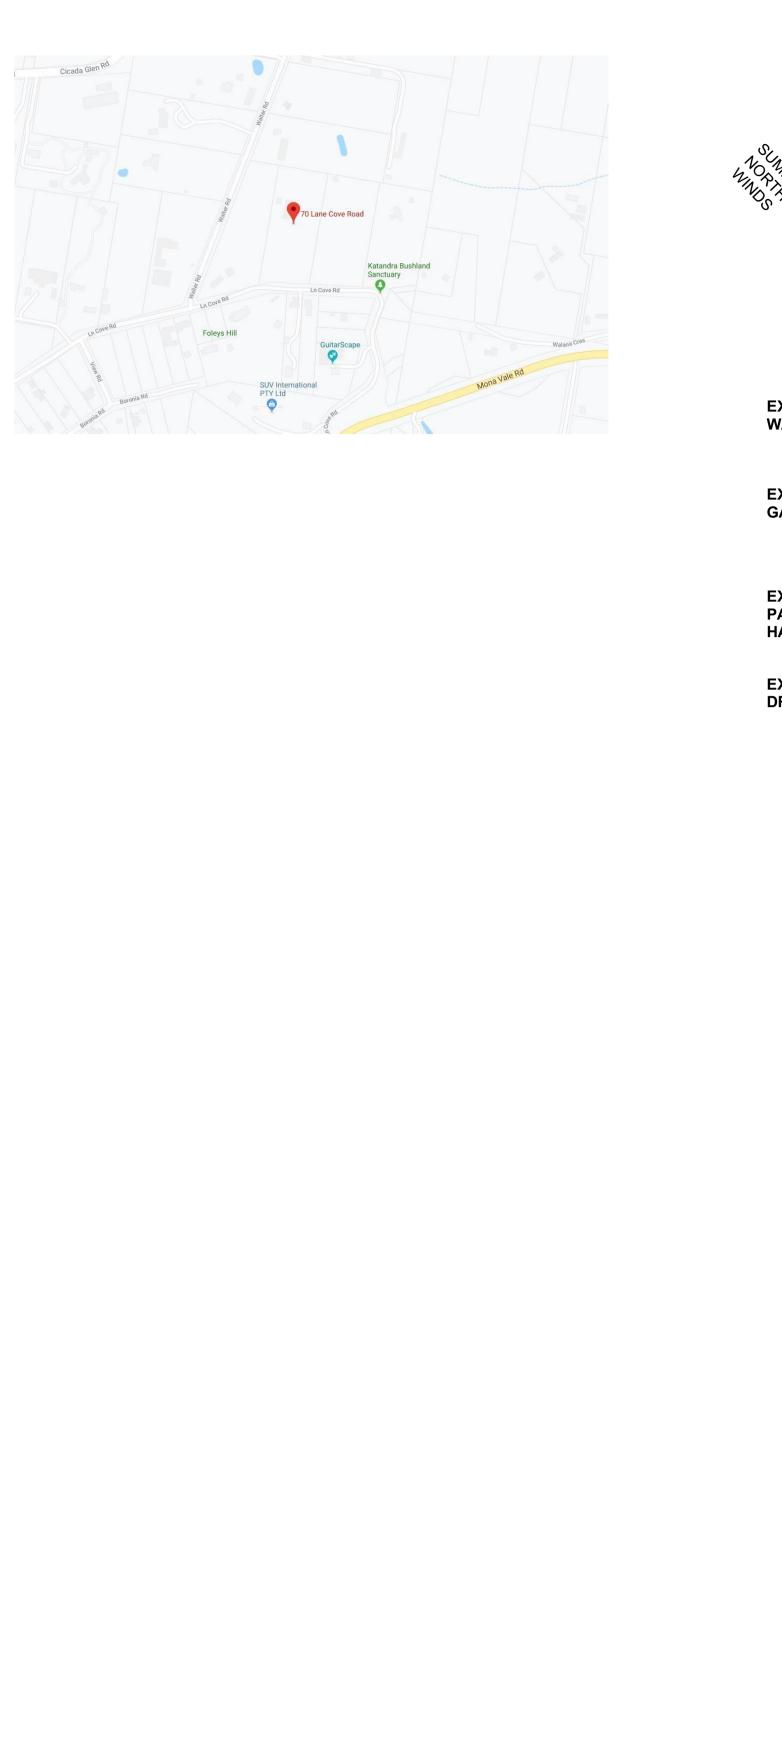

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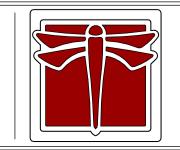

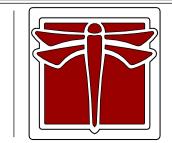
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A DEVELOPMENT APPLICATION ISSUE	02/03/2020
ID DESCRIPTION	DATE

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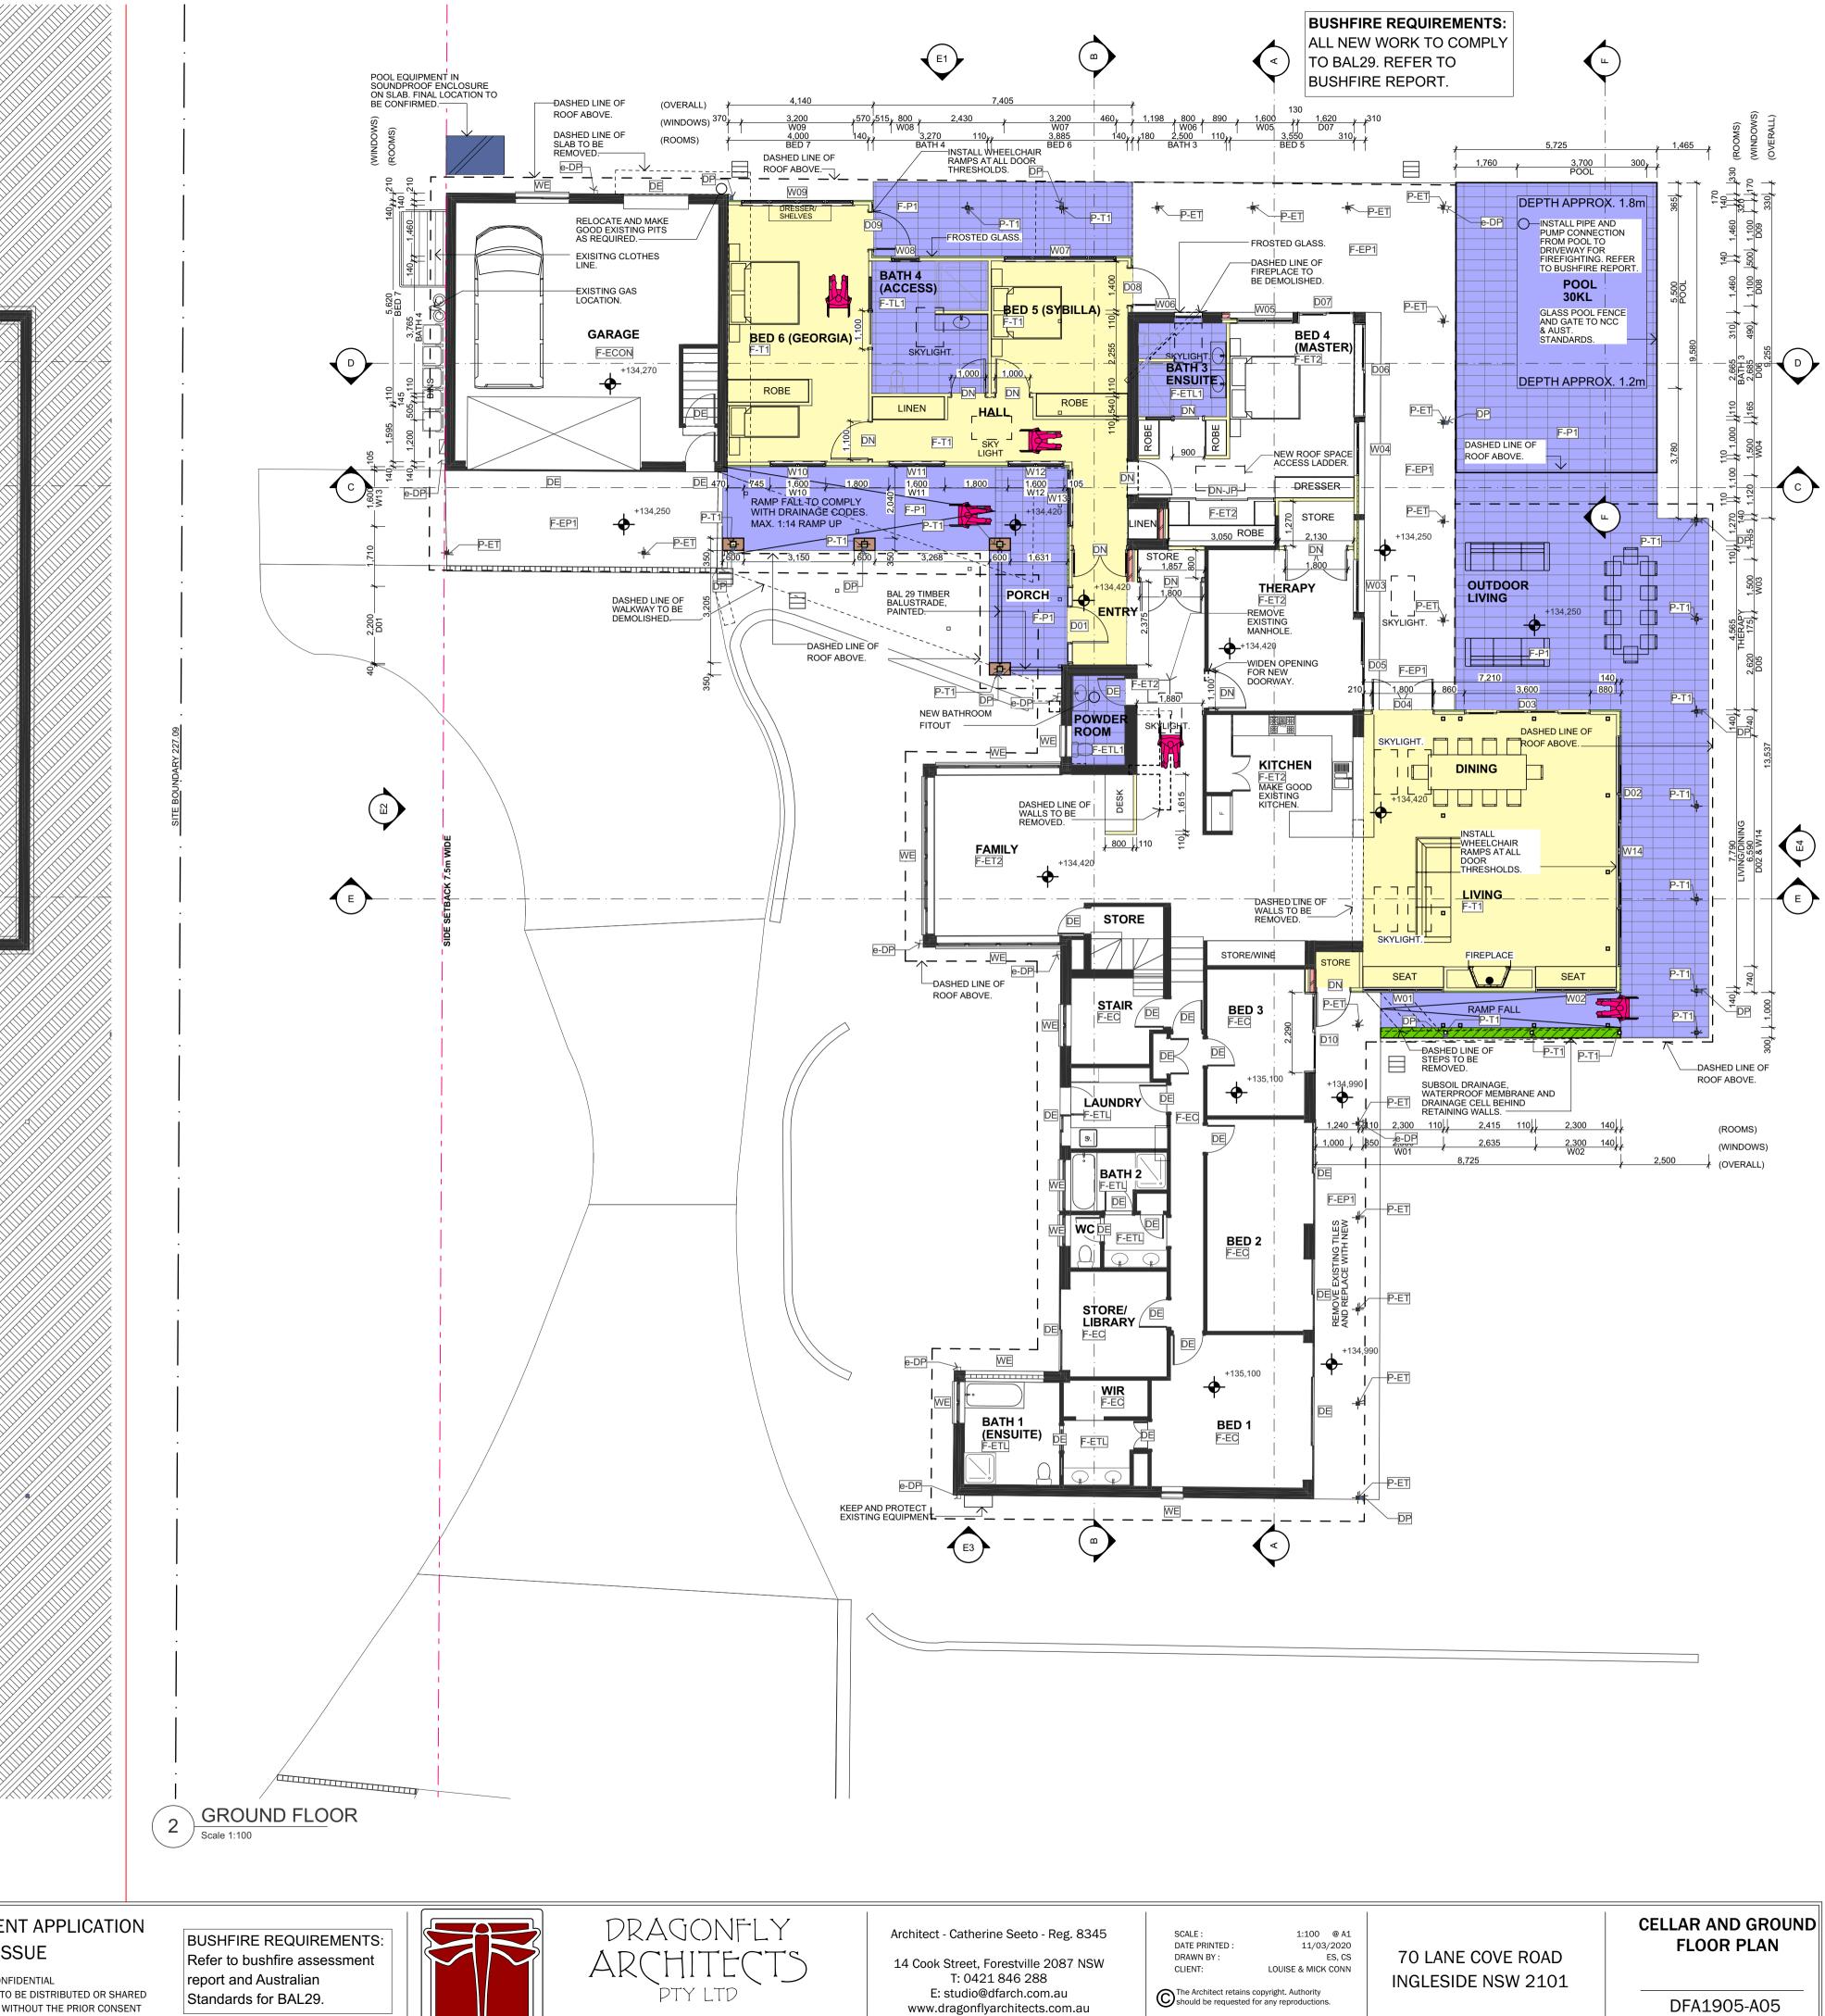
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70 LANE COVE ROAD **INGLESIDE NSW 2101**  EXISTING PLANS AND ELEVATIONS


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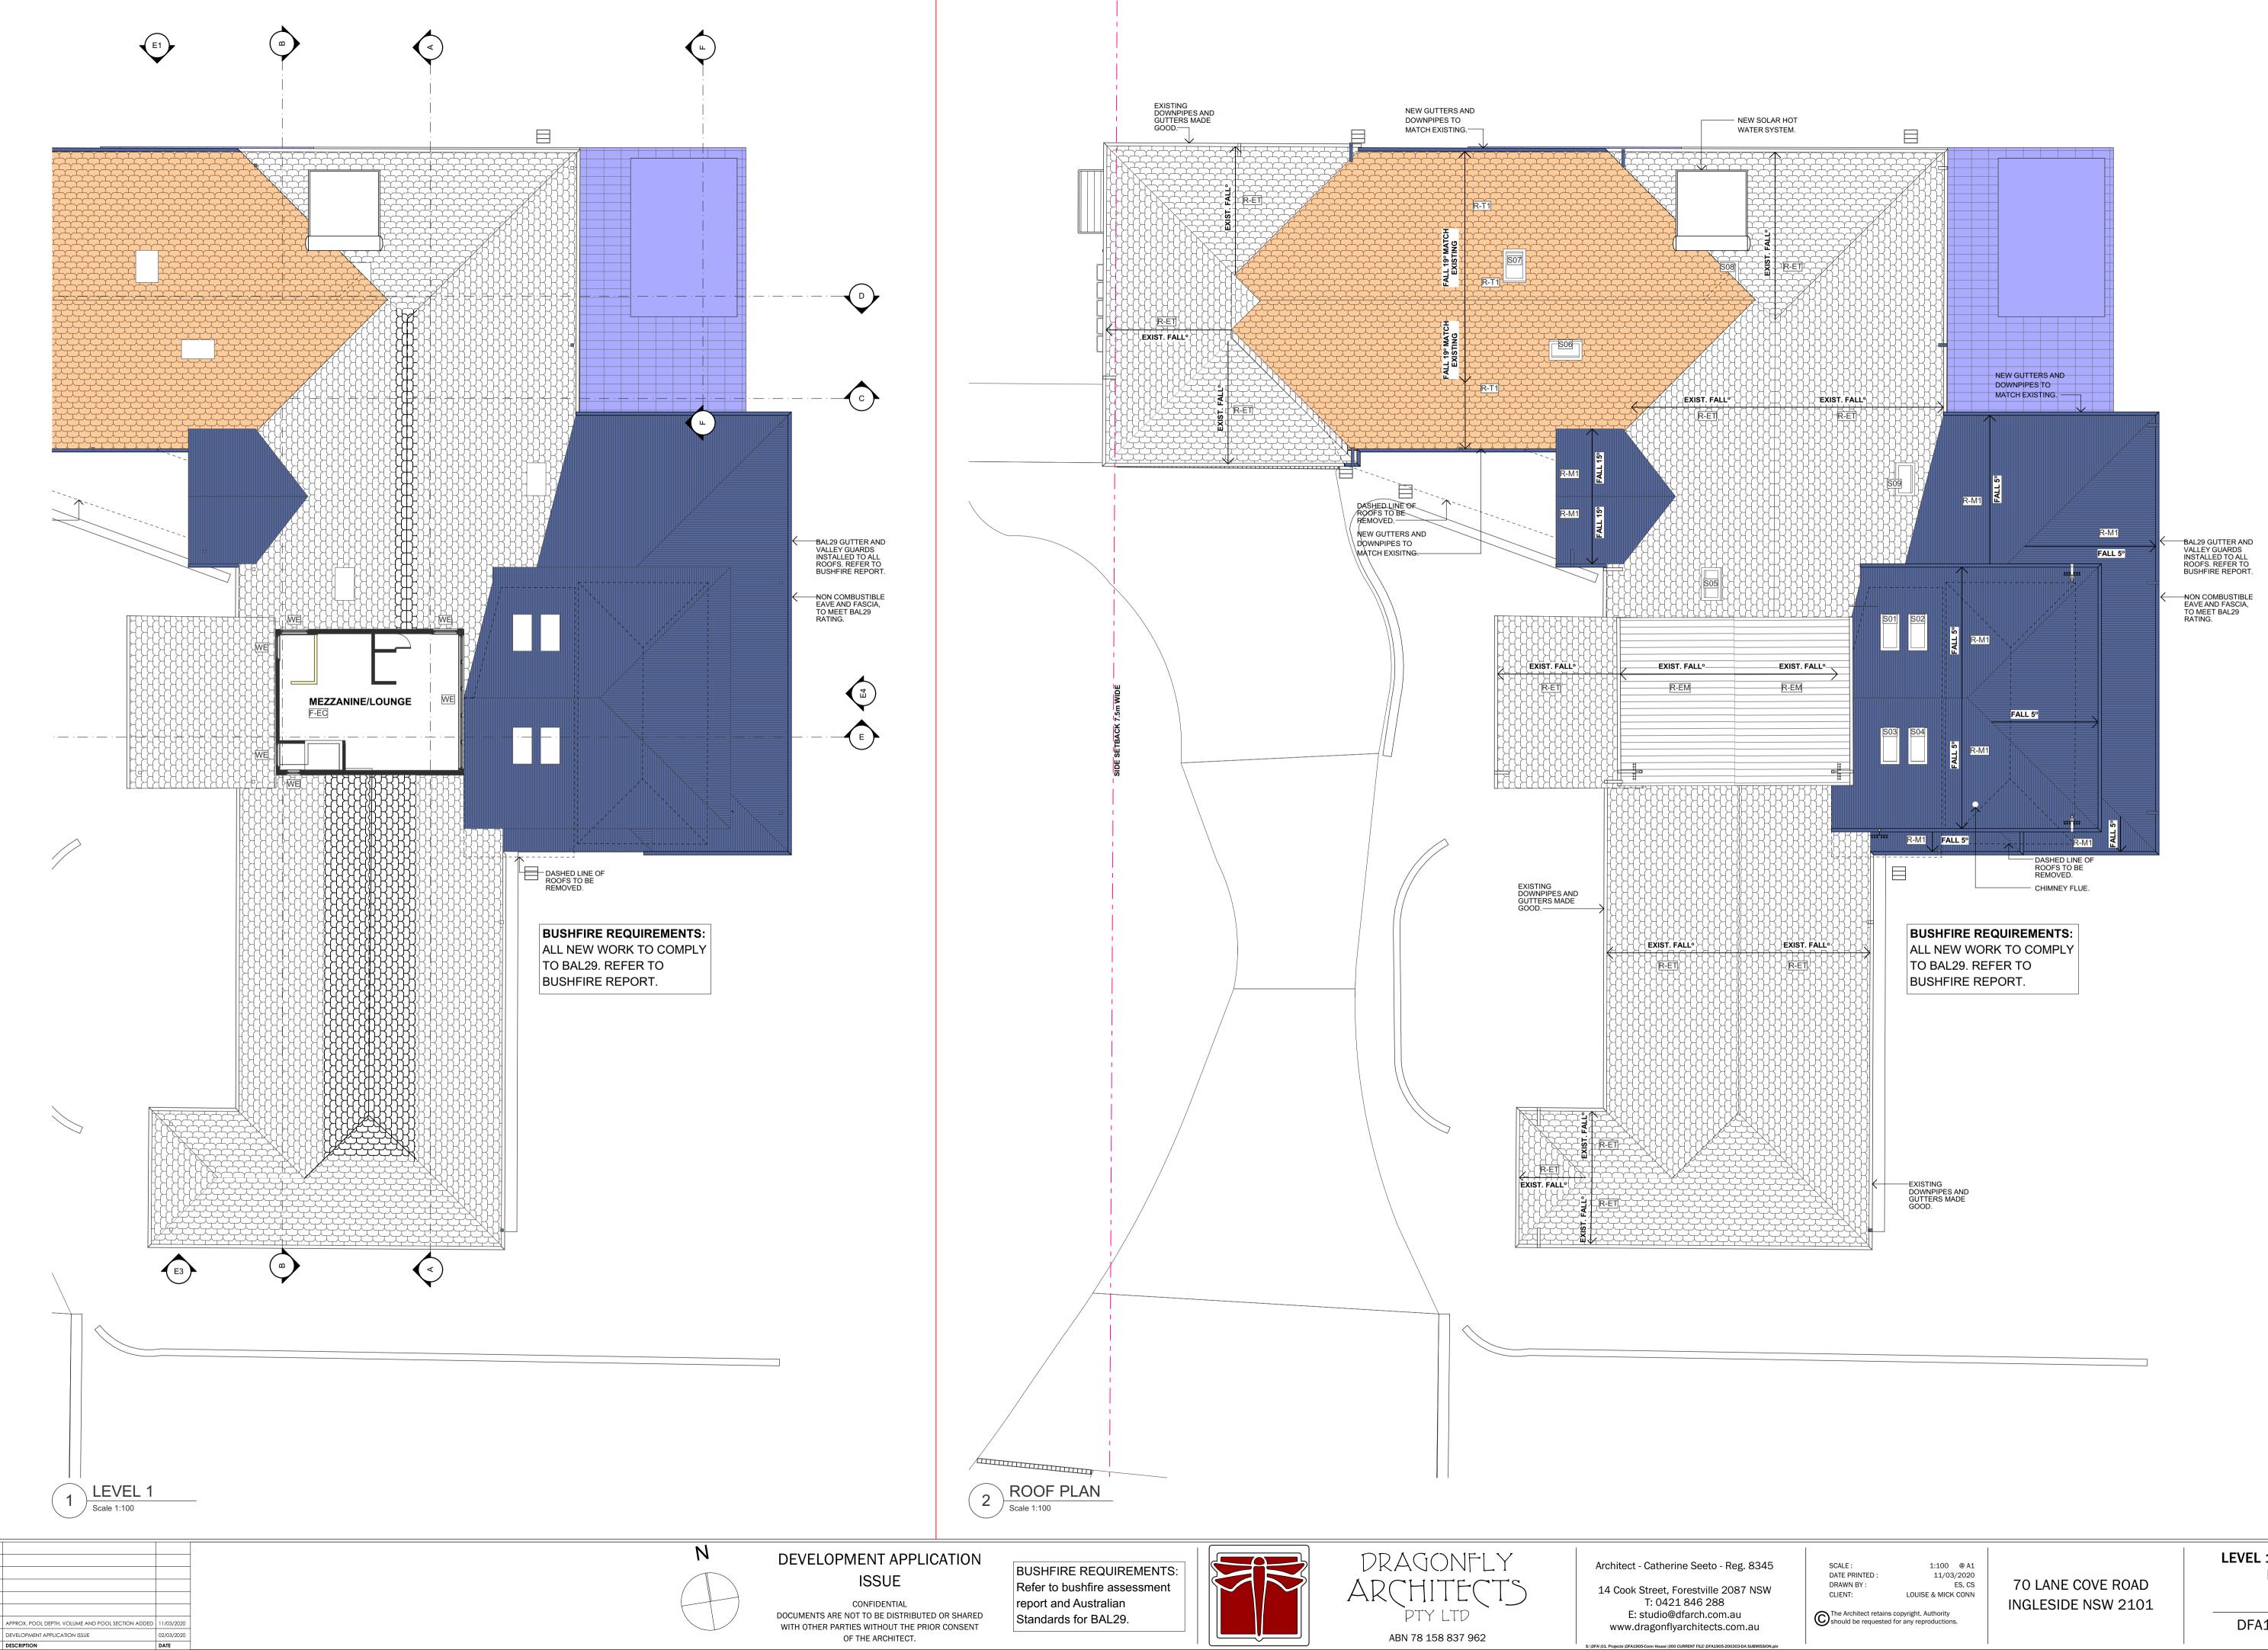


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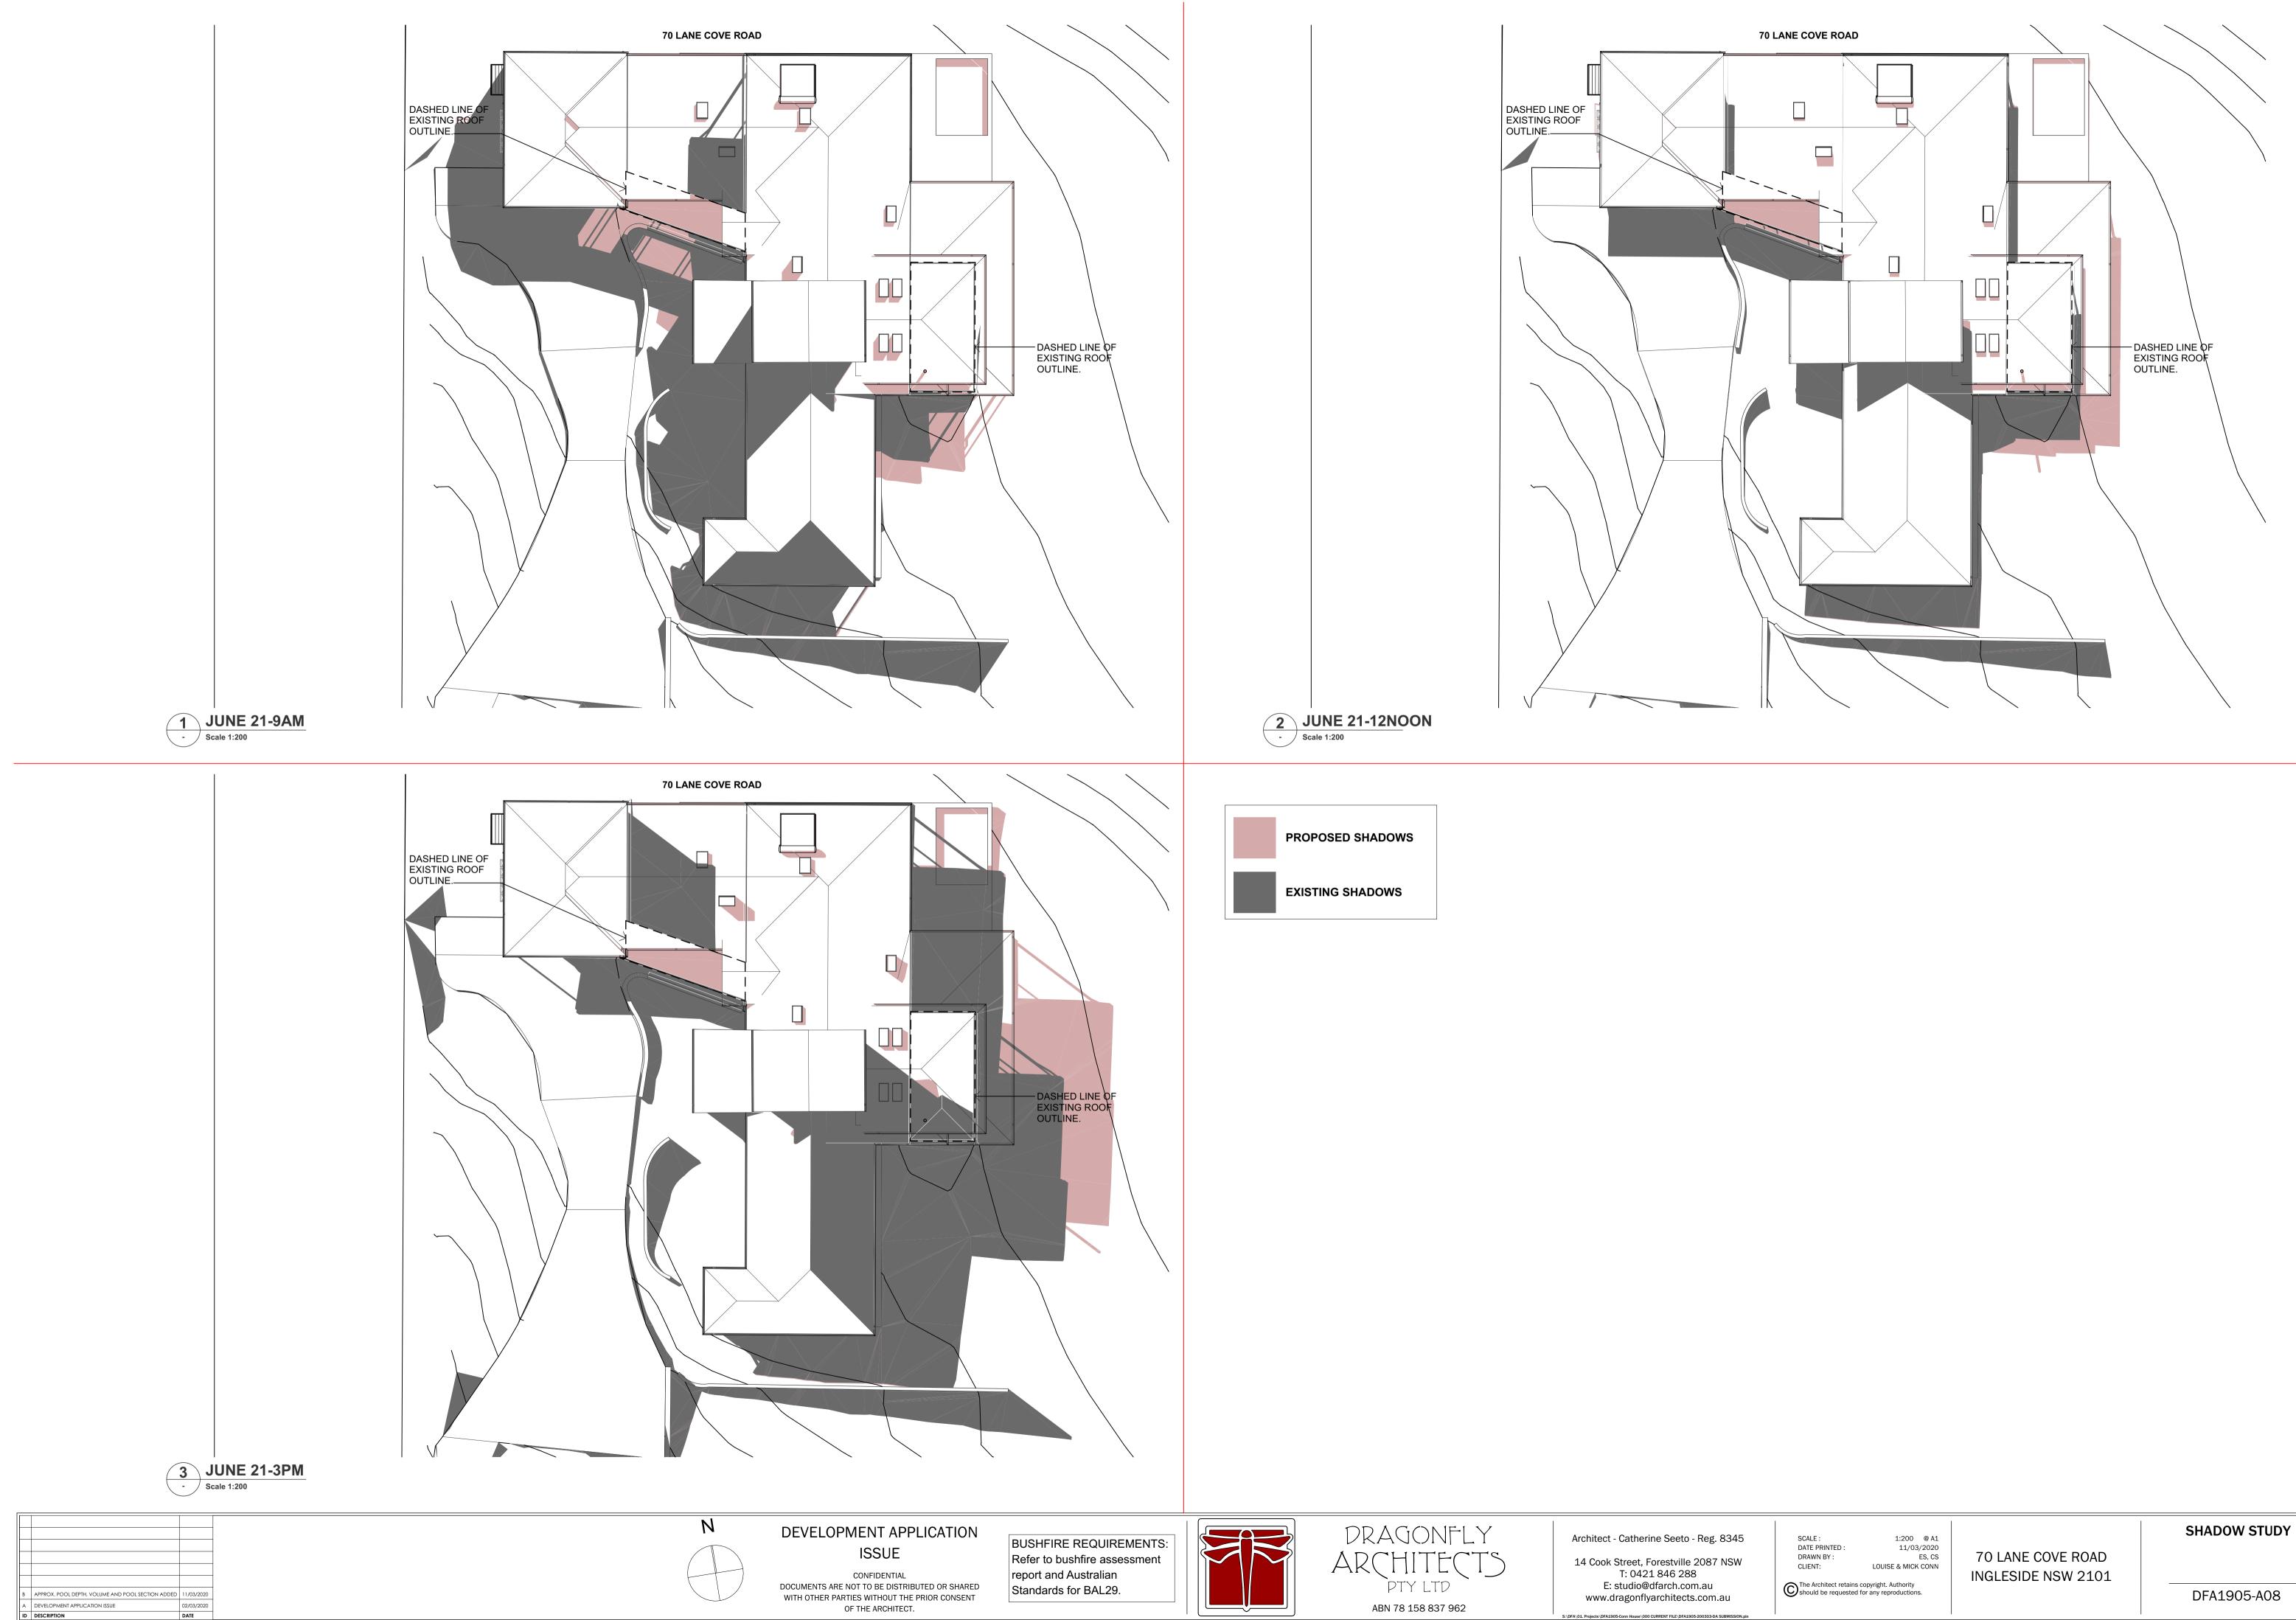


LEVEL 1 AND ROOF PLAN

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12 TOTAL AREA FORWARD OF THE BUILDING LINE 10,954.75 m <sup>2</sup>
1 LANDSCAPE AREAS-EXISTING


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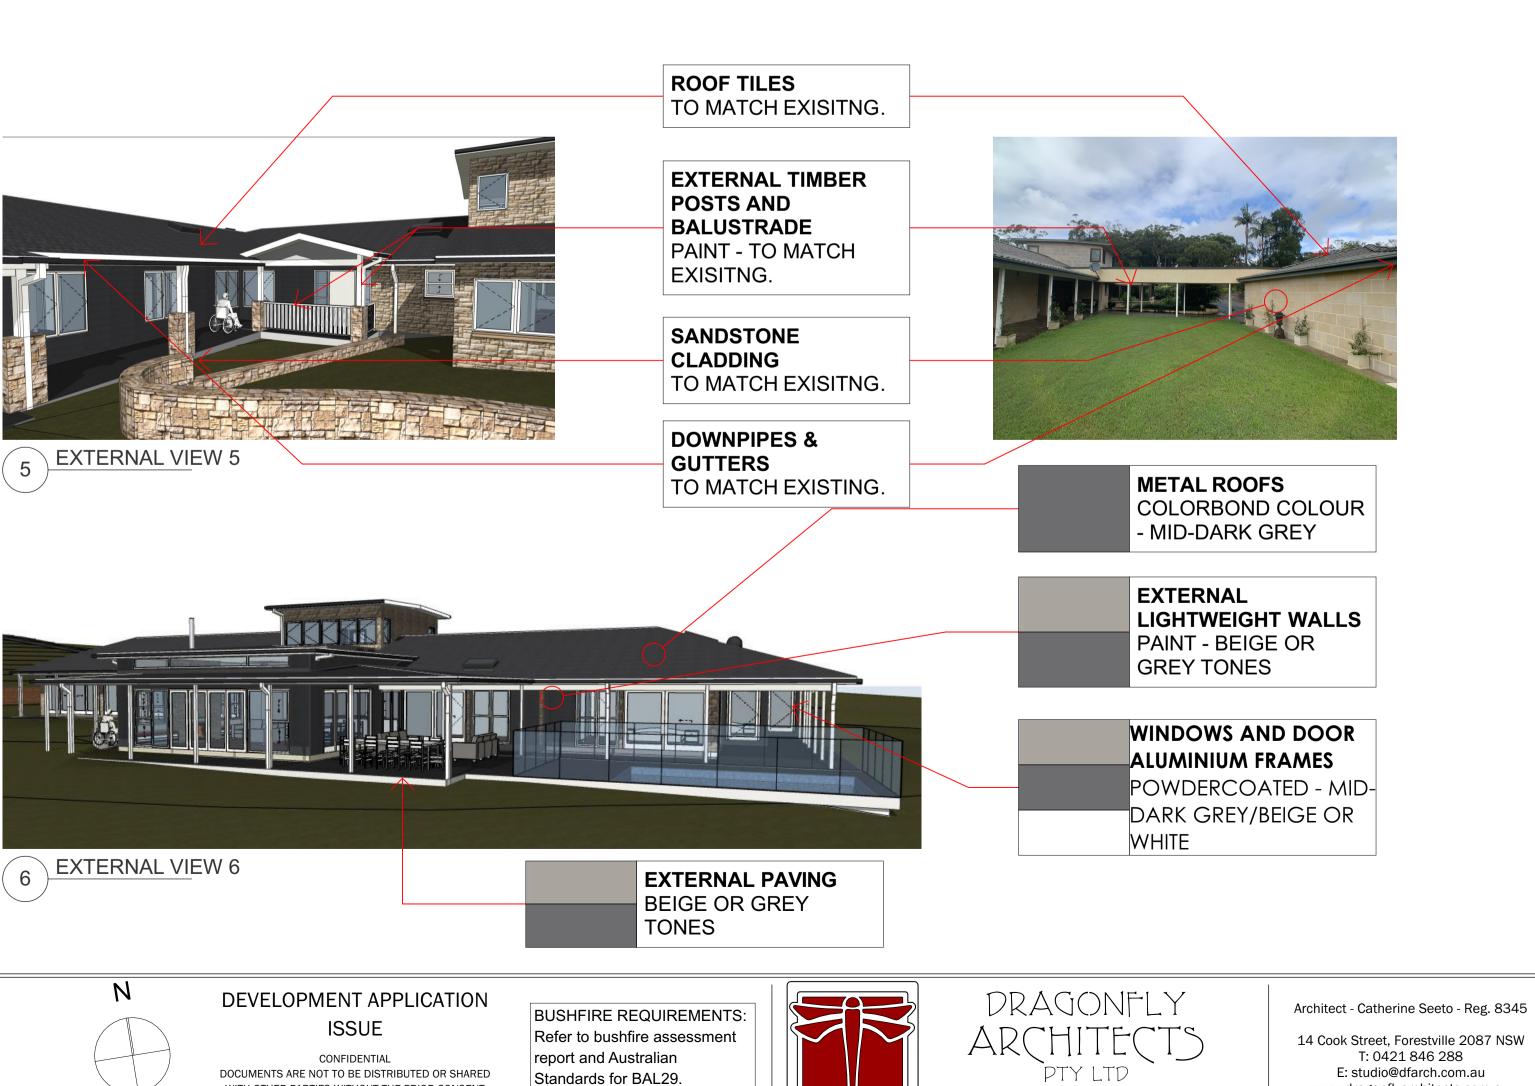
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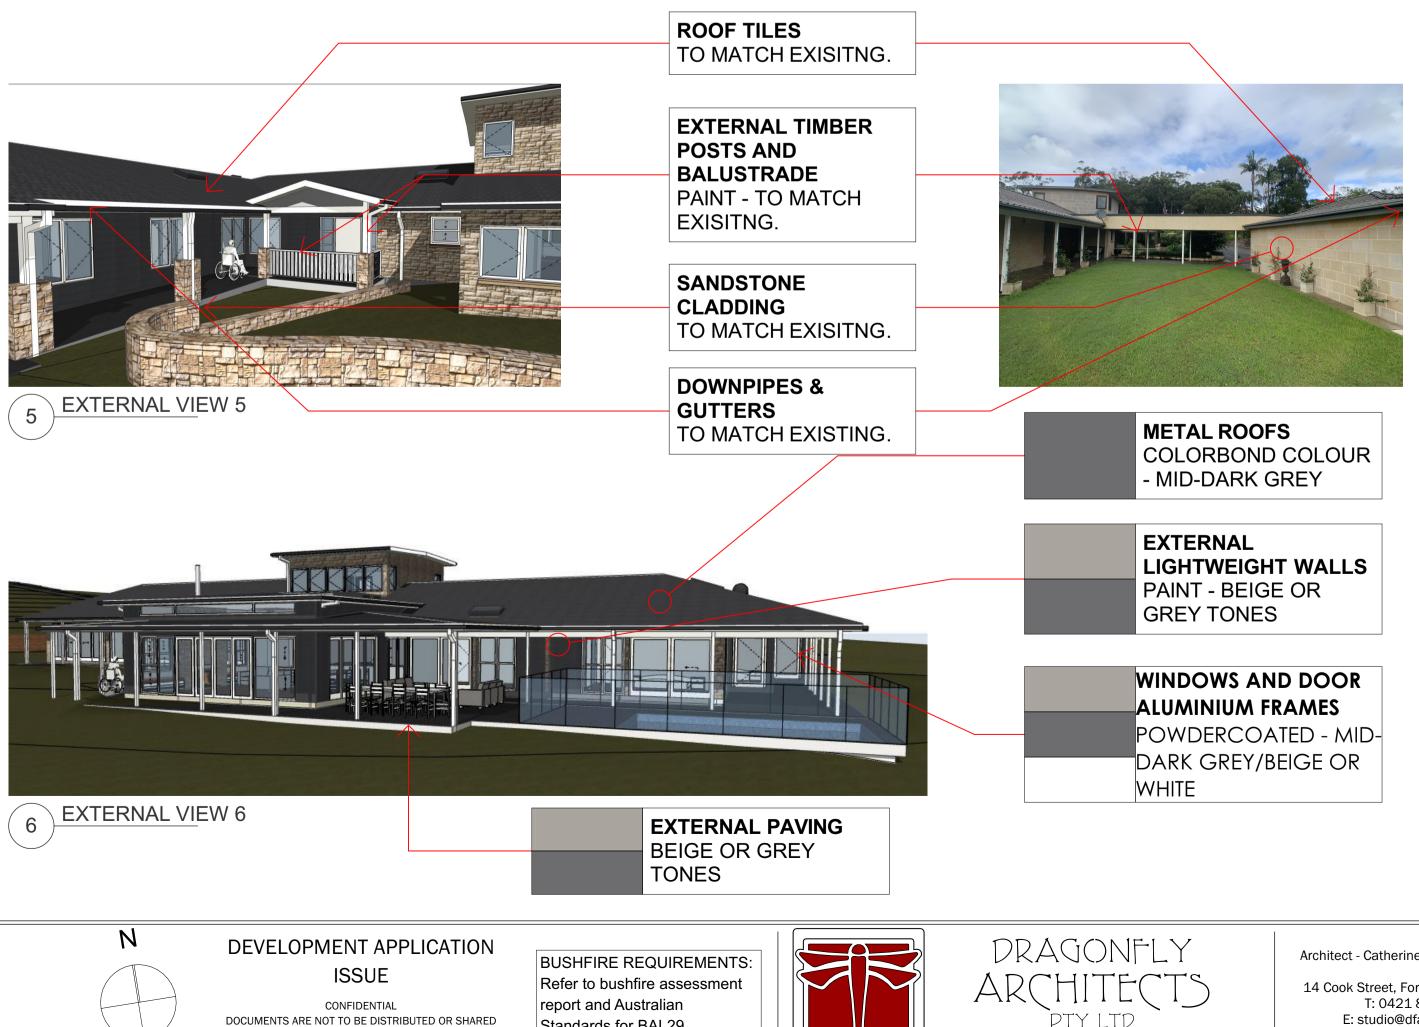
DESCRIPTION

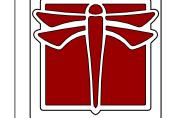	APE EXISTING- FRONT	
NAME	AREA	
L1	515.79	
L2	9,884.00	
	10,399.79 m <sup>2</sup>	
EXISTING LA	NDSCAPE (GENERAL	) - COMPLIES

LANDSCAPE EXISTING			
NAME AREA			
L1	515.79		
L2	9,884.00		
L3	8,296.83		
L4	181.94		
	18,878.56 m <sup>2</sup>		





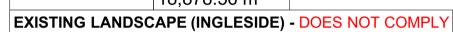

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		N
OL SECTION ADDED	11/03/2020	
	02/03/2020	
	DATE	

		NORTHERN BEACHES COUNCIL		
		PITTWATER 21 DCP-PART D6.8 - LANDSCAPED AREA -		
		NON-URBAN GENERAL (INGLESIDE LOCALITY)		
		TOTAL SITE IS 20,233m <sup>2</sup>		
		MIN LANDSCAPE REQUIRED IS 96% - 400m <sup>2</sup>		
		MIN. LANDSCAPE (0.96 X 20,233m <sup>2</sup> ) - 400m <sup>2</sup> = 19,023.68m <sup>2</sup>		
		MIN. REQUIRED SOFT LANDSCAPE = 19,023.68m <sup>2</sup>		
		VARIATIONS:		
		THE MINIMUM LANDSCAPED AREA MAY BE GREATER THAN STATED ABOVE, WHERE A SITE IS LOCATED ON ENVIRONMENTALLY SENSITIVE OR STEEPLY SLOPING LAND, OR WHERE ITS DEVELOPMENT POTIENTIAL IS RESTRICED IN SOME OTHER WAY.		
		DAMS, PONDS, ON-SITE DETENTION TANKS, THE WATER SURFACE AREA OF SWIMMING POOLS AND WATER TANKS, WASTE WATER TREATMENT SYSTEMS CAN BE INCLUDED AS LANDSCAPED AREA.		
LANDSCAPE PROPOSED-		DRIVEWAYS AND POUROUS OR SOFT SURFACE AREAS		
FRONT		THAT PERMIT THE INFILTRATION OF SURFACE WATER INTO THE SUBSTRATA CAN BE INCLUDED AS LANDSCAPED		
NAME	AREA	AREA. (NOTE THAT THE TENNIS COURT HAS A GRASS		
L1	515.79	SURFACE ON A SAND BED)		
L2	9,884.00	SHEDS WITH A MAXIMUM OF 200m <sup>2</sup> ARE PERMITTED IN		
	10,399.79 m²	ADDITION TO NON-LANDSCAPED AREAS PERMITTED.		
	NDSCAPE (GENERA			

LANDSCAPE AREAS PROPOSED

L1 L2 L3

14

 $( \cdot )$ 

L3

L2

2

Scale 1:1000

TOTAL AREA FORWARD OF THE BUILDING LINE 10,954.75 m<sup>2</sup>

	18,746.16 m²					
PROPOSED LANDSCAPE (INGLESIDE) - DOES NOT COMPLY						
NO CHANGE TO CO	OMPLIANCE FROM	EXISITNG.				

8,146.98 199.39

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### NORTHERN BEACHES COUNCIL PITTWATER 21 DCP-PART C1.1 - LANDSCAPING (GENERAL RESIDENTIAL)

TOTAL SITE IS 20,233m<sup>2</sup>

MIN LANDSCAPE REQUIRED IS 60% IN FRONT OF THE BUILDING FOR A SINGLE DWELLING. MIN. LANDSCAPE (0.60 X 10,954.75m<sup>2</sup>)= 6,572.85m<sup>2</sup>

MIN. REQUIRED SOFT LANDSCAPE IN FRONT OF THE BUILDING LINE =  $6,572.85m^2$ 

NORTHERN BEACHES COUNCIL PITTWATER 21 DCP-PART C1.7 - PRIVATE OPEN SPACE

NOTE: MINIMUM OF 80m<sup>2</sup> OF PRIVATE OPEN SPACE IS REQUIRED PER DWELLING. PRIVATE OPEN SPACE IS CALCULATED AT GROUND LEVEL WITH NO DIMENSION LESS THAN 3m.

**EXISTING PRIVATE OPEN SPACE -** COMPLIES

PROPOSED PRIVATE OPEN SPACE - COMPLIES

LANDSCAPE PLAN:

NOTE: A LANDSCAPING PLAN IS NOT REQUIRED BECUASE OF THE FOLLOWING:

1. The proposal does not cause any substantial change to the visual character of the site.

2. Existing vegetation and trees are to be retained.

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70 LANE COVE ROAD **INGLESIDE NSW 2101** 

LANDSCAPE CALCULATIONS AND **FINISHES SCHEDULE** 

DFA1905-A09

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