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DEVELOPMENT APPLICATION

ITEM DETAILS	DEVELOPMENT APPLICATION						
ADDRESS	133 FISHER ROAD NORTH, CROMER,	NSW 2099					
LOT & DP/SP	LOT 6 DP 788171						
COUNCIL	NORTHERN BEACHES COUNCIL (WARRINGAH)						
SITE AREA	547.6m²	,					
FRONTAGE	IRREGULAR 15.885m & 4.725m						
CONTROLS	PERMISSIBLE / REQUIRED	EXISTING	PROPOSED	COMPLIANCE			
CONTROLS	m / m² / %	m / m² / %	m / m² / %				
<u>LEP</u>							
LAND ZONING	R2 – LOW DENSITY RESIDENTIAL	R2	R2	YES			
MINIMUM LOT SIZE	600m²	547.6m ²	UNCHANGED	YES			
FLOOR SPACE RATIO	NOT IDENTIFIED	N/A	N/A	N/A			
MAXIMUM BUILDING HEIGHT	8.5m	6.060m	8.375m	YES			
HAZARDS							
DEVELOPMENT ON SLOPING LAND	AREA A – SLOPE LESS THAN 5 DEGREES	N/A	N/A	N/A			
DCP							
WALL HEIGHT	7.2m	3.1m	6.93m	YES			
NUMBER OF STOREYS	NOT IDENTIFIED	1	2	YES			
SIDE BOUNDARY ENVELOPE	4m		UNCHANGED	YES			
SIDE BOUNDARY SETBACKS	0.9m	N: 2.178m S: 4.288m W:13.666m	N:0.322m S: 2.163m W: UNCHANGED	NO YES YES			
FRONT BOUNDARY SETBACK	6.5m	DWELL: 10.202m DECK: 8.967m	UNCHANGED 7.767m	YES YES			
REAR BOUNDARY SETBACK	6.0m	4.633m	0.865m	NO			
LANDSCAPE OPEN SPACE	40% (219.04m²)	64% (349.18m²)	53% (287.94m²)	YES			
PRIVATE OPEN SPACE	60m²	113.71m²	UNCHANGED	YES			

SHEET NUMBER	SHEET NAME	DATE PUBLISHED
DA00	COVER	12/11/2020
DA01	NOTATION	12/11/2020
DA02	SITE ANALYSIS	12/11/2020
DA03	SITE / ROOF / SEDIMENT EROSION / WASTE MANAGEMENT / STORMWATER CONCEPT PLAN	12/11/2020
DA04	EXISTING GROUND FLOOR PLAN	12/11/2020
DA05	PROPOSED GROUND FLOOR PLAN	12/11/2020
DA06	PROPOSED FIRST FLOOR PLAN	12/11/2020
DA07	NORTH / EAST ELEVATION	12/11/2020
DA08	SOUTH / WEST ELEVATION	12/11/2020
DA09	LONG / CROSS SECTION	12/11/2020
DA10	AREA CALCULATIONS / SAMPLE BOARD	12/11/2020
DA11	WINTER SOLSTICE 9 AM	12/11/2020
DA12	WINTER SOLSTICE 12 PM	12/11/2020
DA13	WINTER SOLSTICE 3 PM	12/11/2020
DA14	POOL LONG / CROSS SECTION & PLAN	12/11/2020
DA15	BASIX COMMITMENTS	12/11/2020

133 FISHER ROAD NORTH, *CROMER NSW 2099*




NCC & AS COMPLIANCES SPECIFICATIONS

- EARTHWORKS PART 3.1.1 OF NCC
- EARTH RETAINING STRUCTURES PART 3.1.2 OF NCC
- DRAINAGE PART 3.1.3 OF NCC
- TERMITE-RISK MANAGEMENT PART 3.1.4 OF NCC
- FOOTINGS & SLAB PART 3.2 OF NCC INCLUDING AS 2870-2011
- MASONRY PART 3.3 OF NCC INCLUDING AS 3700:2018
- FRAMING PART 3.4 OF NCC
- SUB FLOOR VENTILATION PART 3.4.1 OF NCC
- ROOF CLADDING AND WALL-CLADDING PART 3.5 OF NCC
- GLAZING PART 3.6 OF NCC INCLUDING AS 1288
- FIRE SAFETY PART 3.7 OF NCC
- FIRE SEPARATION OF EXTERNAL WALLS PART 3.7.2 OF NCC
- FIRE PROTECTION OF SEPARATING WALLS AND FLOORS- PART 3.7.3 OF NCC
- SMOKE ALARMS PART 3.7.5 OF NCC
- WET AREAS AND EXTERNAL WATERPROOFING PART 3.8.1 OF NCC
- ROOM HEIGHTS PART 3.8.2 OF NCC
- FACILITIES PART 3.8.3 OF NCC
- LIGHT PART 3.8.4 OF NCC
- VENTILATION PART 3.8.5 OF NCC
- SOUND INSULATION PART 3.8.6 OF NCC
- STAIRWAYAND RAMP CONSTRUCTION PART 3.9.1 OF NCC
- BARRIERS AND HANDRAILS PART 3.9.2 OF NCC
- SWIMMING POOLS PART 3.10.1 OF NCC
- CONSTRUCTION IN BUSHFIRE PRONE AREAS PART 3.10.5 OF NCC
- FENCING & OTHER PROVISIONS REGS & AS1926.1 2012
- DEMOLITION WORKS AS 2601-2001 THE DEMOLITION OF STRUCTURES.
- WATERPROOFING OF WET AREAS TO COMPLY WITH AS $3740\mbox{-}2010$
- ALL PLUMBING & DRAINAGE WORK TO COMPLY WITH AS 3500:2018
- ALL PLASTERBOARD WORK TO COMPLY WITH AS 2588:2018
- ALL STRUCTURAL STEEL WORK TO COMPLY WITH AS 4100-1992 & AS 1554
- ALL CONCRETE WORK TO COMPLY WITH AS 3600:2018
- ALL ROOF SHEETING WORK TO COMPLY WITH AS 1562.1-2018
- ALL SKYLIGHTS TO COMPLY WITH AS 4285-2019
- ALL CERAMIC TILING TO COMPLY WITH AS 3958.1-2007 & 3958.2-1992
- ALL GLAZING ASSEMBLIES TO COMPLY WITH AS 2047-2014 & 1288
- ALL TIMBER RETAINING WALLS ARE TO COMPLY WITH AS 1720.1-2010,
- AS 1720.2-2006, AS 1720.4-2006, AS 1170.1-2002 & AS 1170.4-2007
- ALL RETAINING WALLS ARE TO COMPLY WITH 3700:2018 & AS 3600:2018 ALL CONSTRUCTION TO COMPLY WITH AS 3959:2018

NOTES

- APPROVED MEANS BY THE 'RELEVANT LOCAL AUTHORITY' OR COUNCIL
- THE OWNER WILL DIRECTLY PAYTHE FEES ASSOCIATED WITH THE FOLLOWING:
- BUILDING APPROVAL FROM COUNCIL, FOOTPATH AND KERB DEPOSITS WITH THE LOCAL COUNCIL, INSURANCE FEE TO BUILDING SERVICES CORPORATION, LONG SERVICE LEAVE SERVICE LEVY FEE AND APPROVAL FEE BY WATER AND SEWERAGE AUTHORITY. ALL OTHER FEES ARE TO BE PAID BY THE BUILDER. THE AMOUNT OF ANY LOCAL AUTHORITY DEPOSITS WHICH ARE FORFEITED DUE TO DAMAGE OR OTHER CAUSE WILL BE DEDUCTED FROM THE PAYMENTS DUE TO THE BUILDER.
- THE BUILDER IS TO PROVIDE AT HIS/HER OWN EXPENSE ADEQUATE PUBLIC RISK INSURANCE AND ARRANGE INDEMNIFICATION UNDER THE WORKERS COMPENSATION ACT. WORKS INSURANCE TO BE STATED IN THE CONTRACT CONDITIONS.
- ALL WORK TO BE CARRIED OUT IN A TRADESMEN LIKE MANNER AND IN ACCORDANCE WITH THE STANDARDS CODES AND REGULATIONS OF THE STANDARDS ASSOCIATION OF AUSTRALIA, BUILDING CODE OF AUSTRALIA AND ANY STATUTORY AUTHORITY HAVING JURISDICTION OVER THE WORK.
- ALL TENDERERS ARE TO VISIT THE SITE TO SATISFY THEMSELVES AS TO THE NATURE AND EXTENT OF THE WORKS, FACILITIES AVAILABLE AND DIFFICULTIES ENTAILED IN THE WORKS AS VARIATIONS WILL NOT BE ALLOWED DUE TO WORK ARISING OWING TO NEGLECT OF THIS CLAUSE.
- ALL WORK AND MATERIALS TO COMPLY WITH THE CURRENT AUSTRALIAN STANDARDS AT THE TIME OF COMMENCEMENT WERE APPLICABLE.
- THESE DRAWINGS SHALL BE READ IN CONJUNCTION WITH ALL STRUCTURAL AND OTHER CONSULTANTS DRAWINGS AND SPECIFICATIONS AND WITH ANY SUCH WRITTEN INSTRUCTIONS AS MAY BE ISSUED DURING THE COURSE OF THE CONTRACT.
- SET OUT DIMENSIONS SHOWN ON THIS DRAWING SHALL BE VARIFIED BY THE BUILDER ON SITE BEFORE COMMENCEMENT OF ANY WORK. DIMENSIONS SHOULD NOT BE OBTAINED BY SCALING THE DRAWINGS. USE ONLY FIGURED DIMENSIONS, ALL DIMENSIONS ARE IN MILLIMETRES.
- THE BUILDER IS TO ENSURE ALL CONSTRUCTION. LEVELS AND OTHER ITEMS COMPLY WITH THE CONDITIONS OF THE BUILDING APPROVAL.
- THE BUILDER IS TO COMPLY WITH ALL ORDINANCES, LOCAL AUTHORITY REGULATIONS AND THE REQUIREMENTS OF ALL SERVICES SUPPLY AUTHORITIES HAVING JURISDICTION OVER THE WORKS.
- ALL PLUMBING AND DRAINAGE WORK TO BE INSTALLED AND COMPLETED BY A LICENCED TRADESMAN AND IN ACCORDANCE WITH THE STATUTORY BODY HAVING AUTHORITY OVER THE WORKS. CONNECT ALL WASTE TO SYDNEY WATER SEWER LINE
- ALL NEW DOWNPIPES ARE TO BE CONNECTED TO THE EXISTING STORM WATER SYSTEM.
- ALL POWER AND STORMWATER OUTLET LOCATIONS SHALL BE DETERMINED ONSITE BY THE OWNER.
- SMOKE DETECTOR ALARM TO BE INSTALLED IN ACCORDANCE WITH AS3786 AND THE BUILDING CODE OF AUSTRALIA.
- ELECTRICAL WORK TO BE IN ACCORDANCE WITH SAA WIRING RULES AND BE DONE BY A LICENCED TRADESMAN
- ANY DETAILING IN ADDITION TO WHAT IS SUPPLIED SHALL BE RESOLVED BETWEEN THE OWNER AND THE BUILDER TO THE OWNERS APPROVAL, EXCEPT FOR ANY STRUCTURAL DETAILS OR DESIGN WHICH IS SUPPLIED BY THE ENGINEER.
- ALL TIMBER SIZES AND CONCRETE DETAILS TO BE CONFIRMED BY THE BUILDER PRIOR TO COMMENCEMENT OF ANY WORK.
- ALL STRUCTURAL WORK IS TO BE IN ACCORDANCE WITH THE STRUCTURAL DETAILS PREPARED BY A STRUCTURAL ENGINEER (i.e.) PIERS, FOOTINGS, CONCRETE SLABS, RETAINING WALLS, STEELWORK, FORMWORK, UNDERPINNING, ADDITIONAL STRUCTURAL LOADS, TIMBER FRAMING, WIND BRACING AND ASSOCIATED CONNECTIONS. BUILDER TO OBTAIN PRIOR TO FINALISING TENDER.
- ANY WORK INDICATED ON THE PLANS BUT NOT SPECIFIED, AND ANY ITEM NOT SHOWN ON THE PLAN WHICH IS OBVIOUSLY NECESSARY AS A PART OF CONSTRUCTION AND/OR FINISH IS TO BE CONSIDERED AS SHOWN AND SPECIFIED, AND IS TO BE DONE AS PART OF THE CONTRACT. VARIATIONS WILL NOT BE PERMITTED WITHOUT THE WRITTEN CONSENT OF THE OWNER.
- THE BUILDER SHALL PROVIDE SEDIMENT AND SILTRATION CONTROL MEASURES AS REQUIRED BY COUNCIL AND MAINTAIN THEM THROUGH THE DURATION OF THE WORKS.
- A LEGIBLE COPY OF THE PLANS BEARING APPROVAL STAMPS MUST BE MAINTAINED ON THE JOB AT ALL TIMES. HOURS OF CONSTRUCTION WILL BE RESTRICTED TO THE TIMES AS REQUIRED BY THE BUILDING APPROVAL.
- THE BUILDER IS TO ARRANGE FOR ALL INSPECTIONS REQUIRED BY THE AUTHORITIES AND LENDING INSTITUTIONS TO THEIR REQUIREMENTS.
- THE BUILDER IS TO OBTAIN APPROVAL FOR INTERUPTIONS TO EXISTING SERVICES AND MINIMISE THE DURATION AND NUMBER OF INTERUPTIONS. ANY INTERRUPTIONS WITH EXISTING SERVICES AND EQUIPMENT TO BE ATTENDED TO BY THE APPROPRIATELY SKILLED TRADESMEN.
- THE BUILDER SHALL RESTORE, REINSTATE OR REPLACE ANY DAMAGE CAUSED TO EXISTING STRUCTURES OR LANDSCAPING BY CONSTRUCTION WORK OR WORKMEN. PROVIDE PROTECTION TO EXISTING TREES TO REMAIN AS REQUIRED BY APPROVAL CONDITIONS.
- ALL BRICKWORK IS TO BE SELECTED BY OWNER AND IS TO COMPLY WITH AS1640
- ALL MASONRY TO COMPLY WITH AS3700
- ALL METALWORK AND FLASHING ITEMS NECESSARY TO SATISFACTORY COMLPETE WORK SHALL BE PROVIDED.
- ALL GUTTERS, DOWNPIPES TO BE COLORBOND.
- ALL TIMBER CONSTRUCTION TO BE IN ACCORDANCE WITH THE AUSTRALIAN STANDARD 1684 "TIMBER FRAMING CODE"
- ALL GLAZING INSTALLED TO COMPLY WITH AS1288, 2047 AND IN ACCORDANCE WITH MANUFACTURERS RECOMMENDATION
- ALL WALL AND CEILING LININGS TO BE PLASTERBOARD OR CEMENT RENDER AS SELECTED AND VILLA BOARD IN WET AREAS, TO COMPLY WITH THE RELEVANT AUSTRALIAN STANDARDS OR INSTALLED IN ACCORDANCE WITH MANUFACTURERS SPECIFICATION.
- ALL BATHROOMS AND WET AREAS TO BE ADEQUATELY WATERPROOFED TO MANUFACTURERS SPECIFATION AND AS3740 AND PART 3.8.1 OF THE BUILDING CODE OF AUSTRALIA HOUSING PROVISIONS
- STAIRS AND BALUSTRADES TO COMPLYWITH PART 3.9.1 & 3.9.2 OF THE BUILDING CODE OF AUSTRALIA HOUSING PROVISION.
- TERMITE PROTECTION MEASURES TO COMPLY WITH AS 3660 AND BE INSTALLED TO MANUFACTURERS SPECIFICATION.
- ANY DETAILING ADDITIONAL TO THAT SUPPLIED, SHALL BE RESOLVED BETWEEN THE OWNER AND THE BUILDER TO THE OWNERS APPROVAL. EXCEPT FOR ANY STRUCTURAL DETAILS OR DESIGN WHICH IS TO BE SUPPLIED BY THE STRUCTURAL ENGINEER.

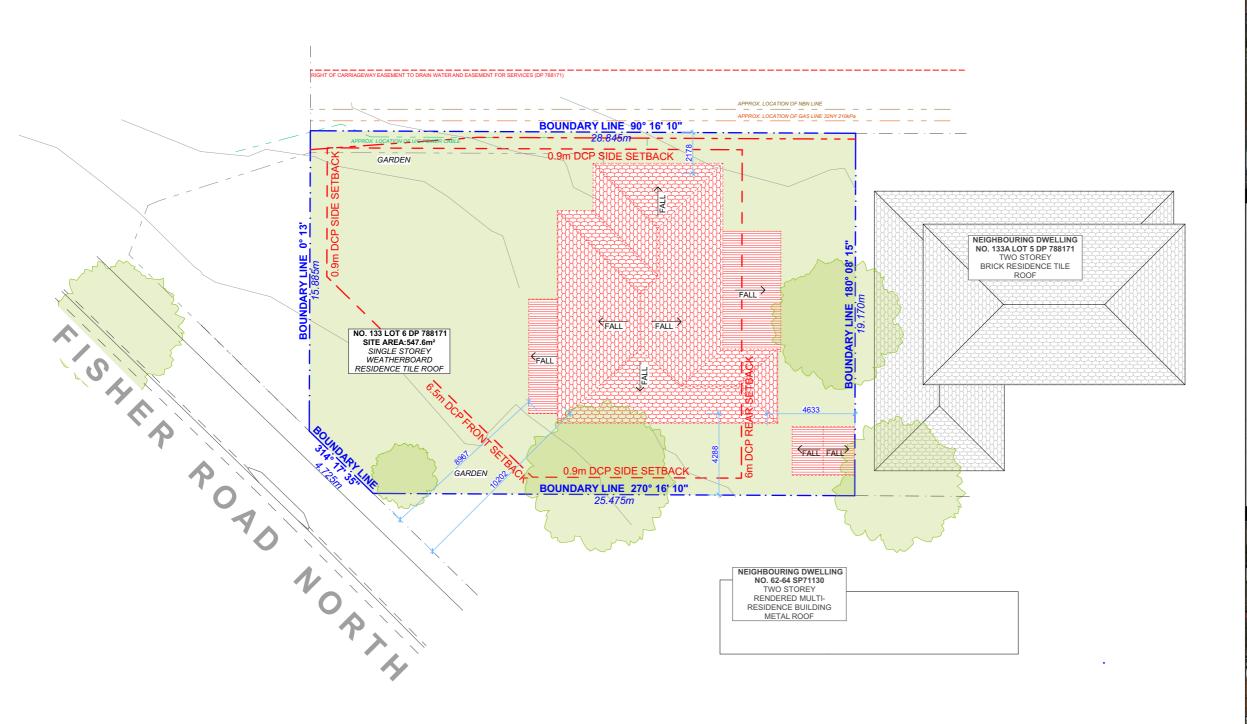



NOTE: ALL DEMOLISHED ELEMENTS TO ENG. SPECIFICATIONS AND AS. 2601 - 2001

REV. DATE



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u					dimensions on site prior to commencement of any work, creation of shop drawings, or fabrication of components.
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COMMENTS

DRWN NOTES

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EXISTING PROPOSED DEMOLISHED

CLIENT

PATRICK & GEMMA CROTTY

PROJECT ADDRESS 133 FISHER ROAD

NORTH, CROMER NSW

DRAWING NO.

DA02

DATE

Thursday, 12 November 2020


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SITE ANALYSIS





AERIAL MAP



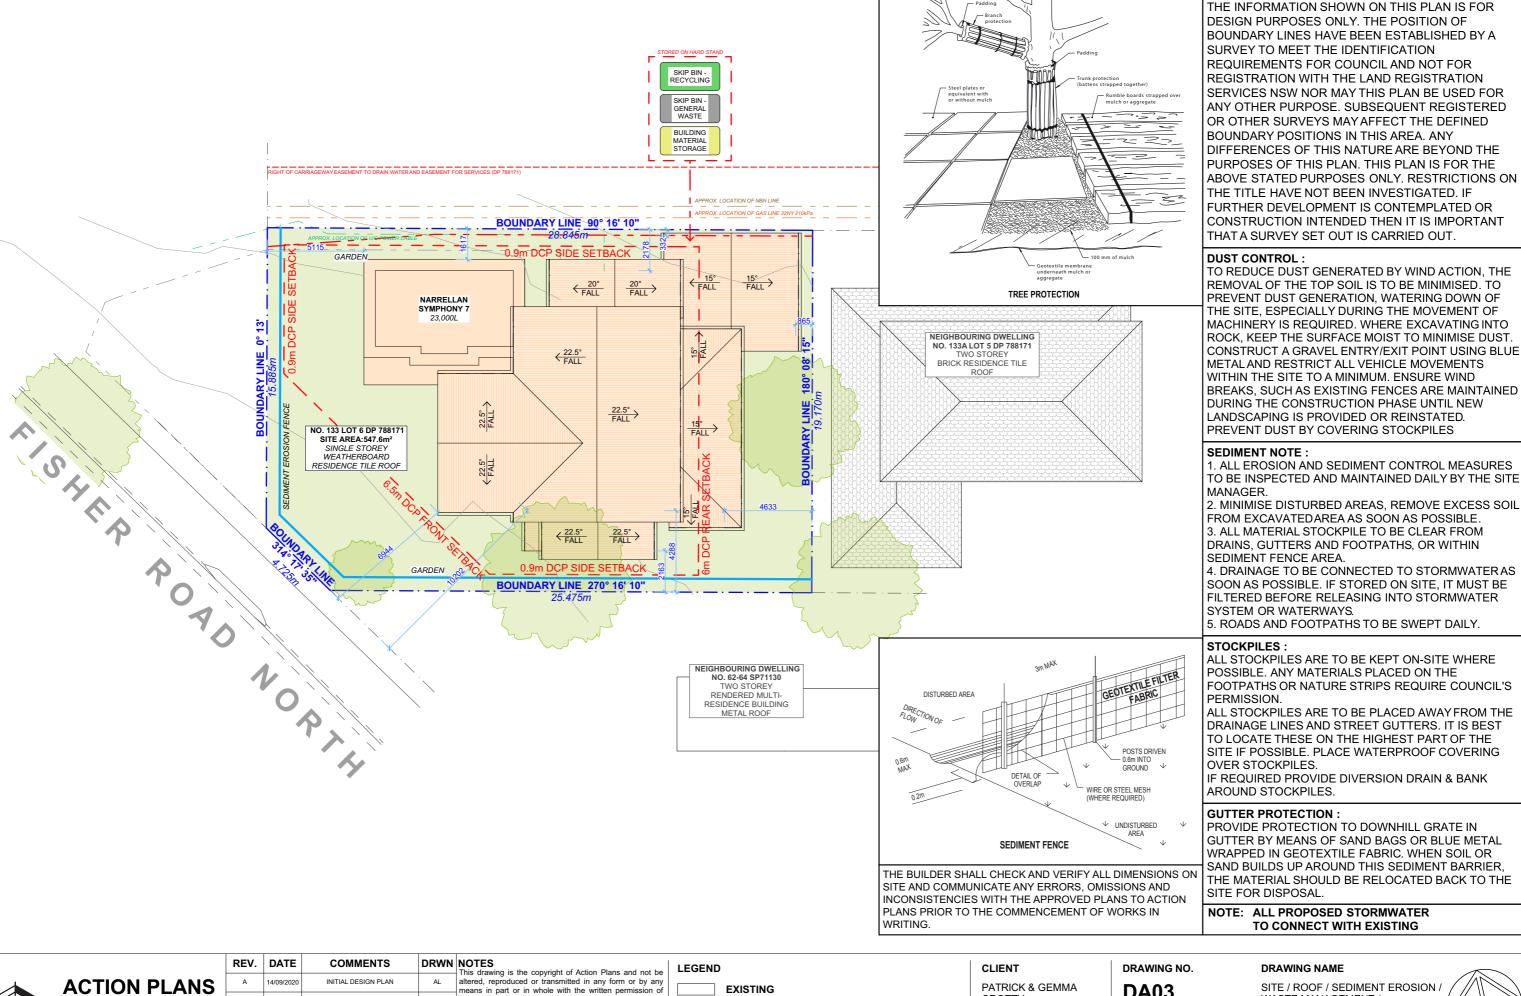

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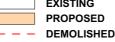
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PROJECT ADDRESS

133 FISHER ROAD NORTH, CROMER NSW 2099

DA03

DATE

Thursday, 12 November 2020 WASTE MANAGEMENT / STORMWATER CONCEPT PLAN

SCALE

1:200 @A3

NOTES REGARDING BOUNDARY



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133 FISHER ROAD


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NORTH, CROMER NSW

Thursday, 12

November 2020

1:100 @A3



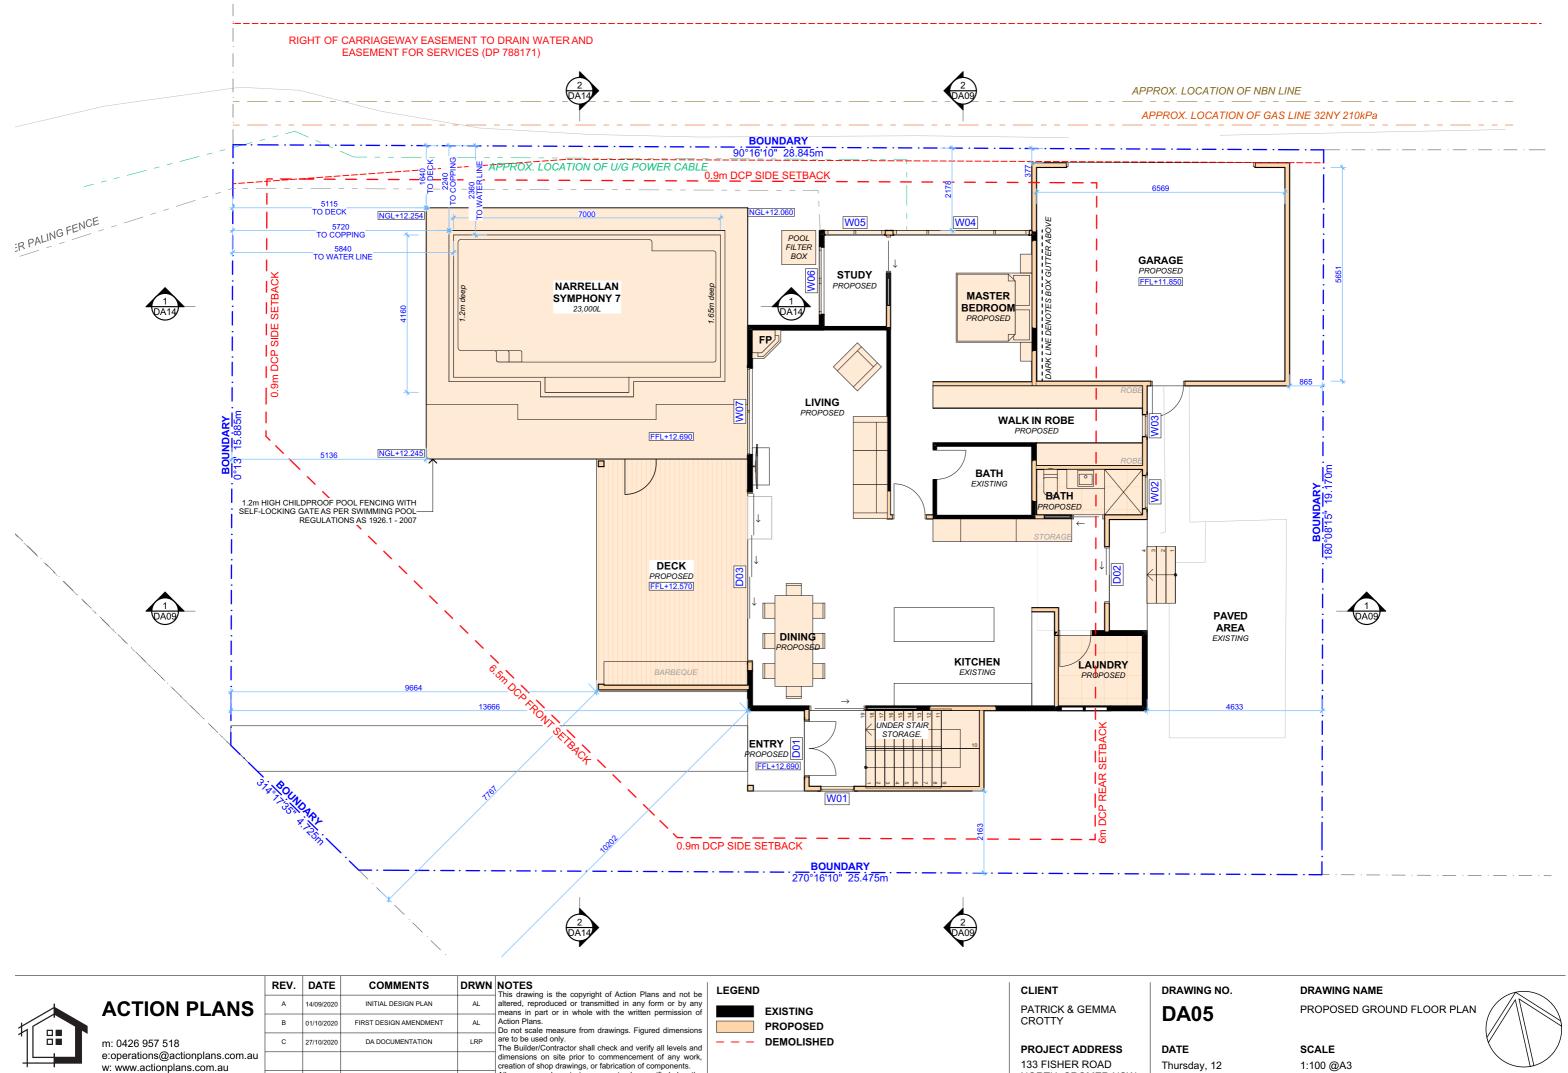

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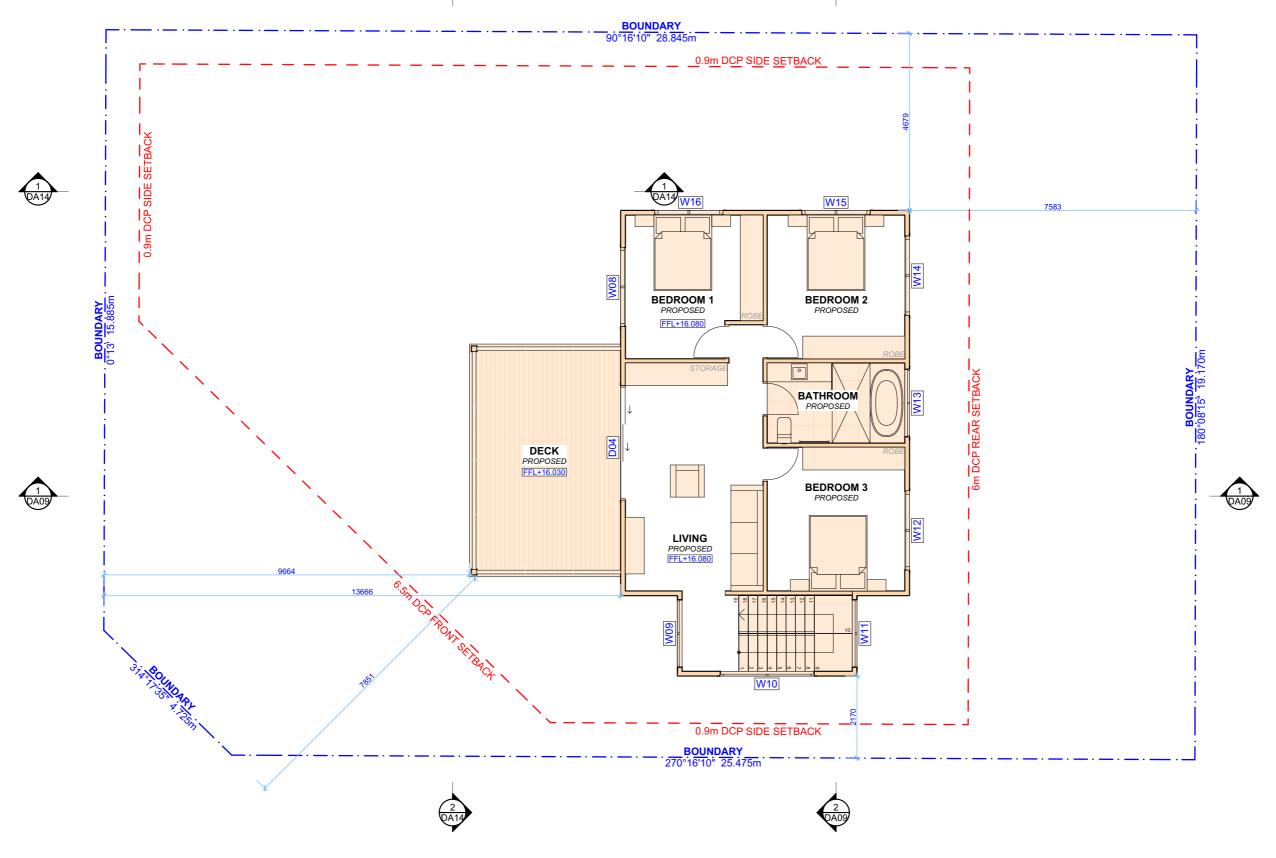
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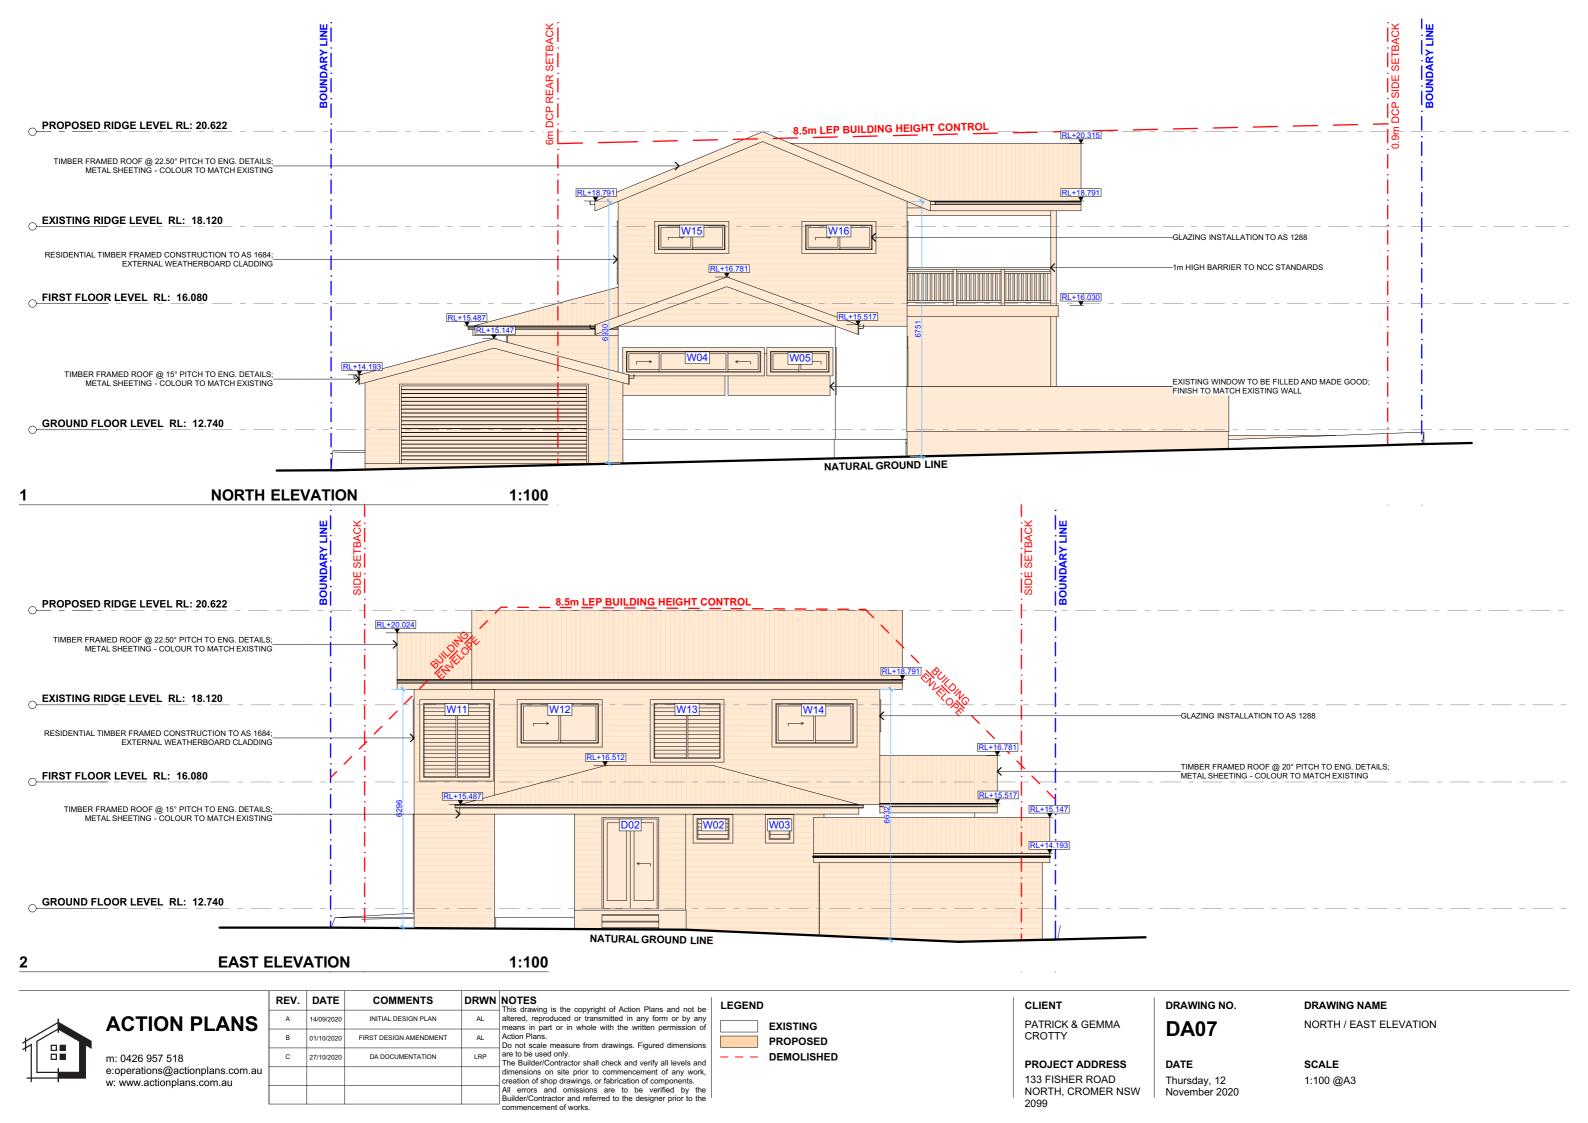
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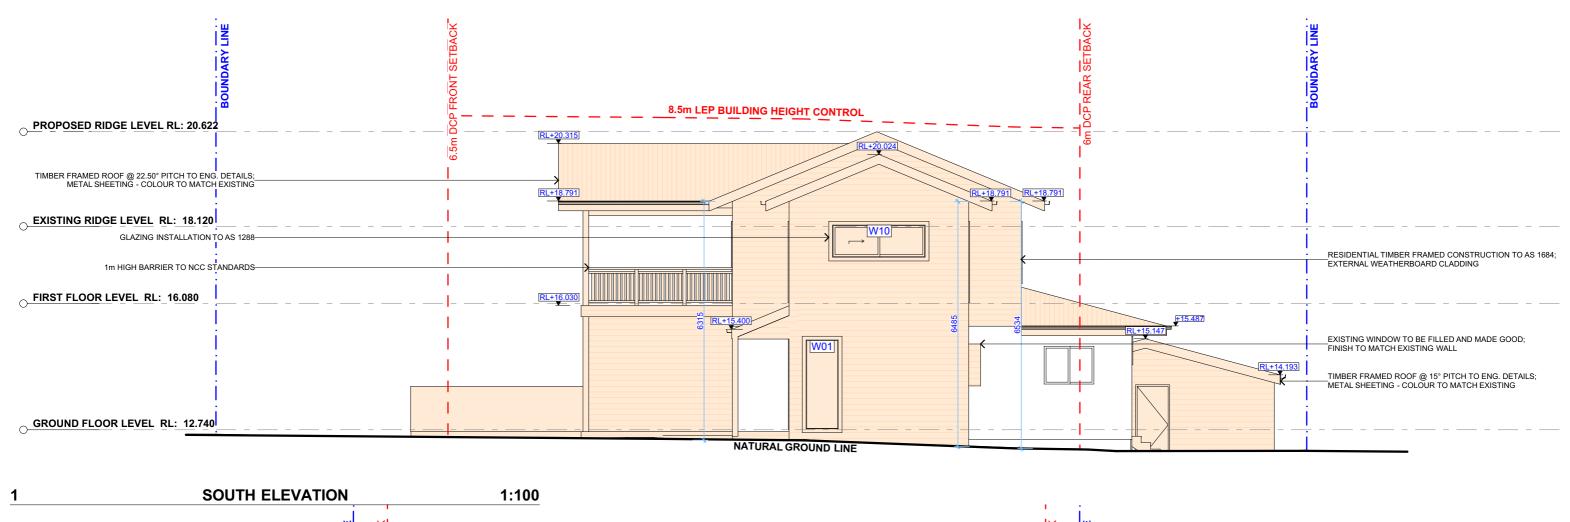
DA06


DATE	
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DRAWING NAME PROPOSED FIRST FLOOR PLAN








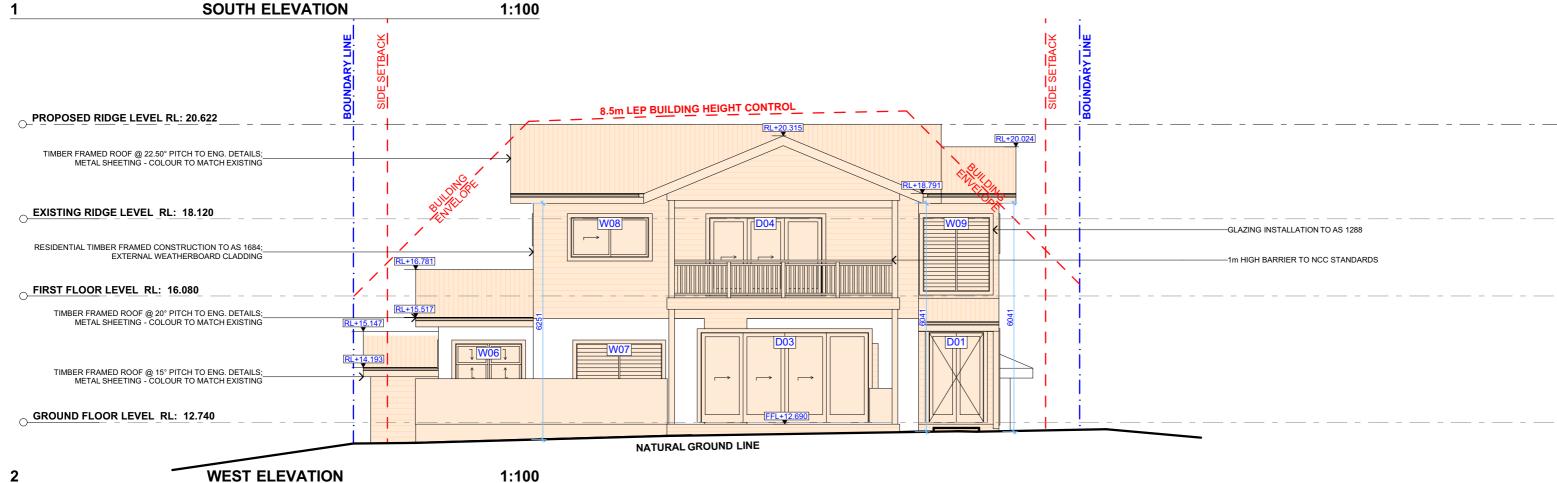

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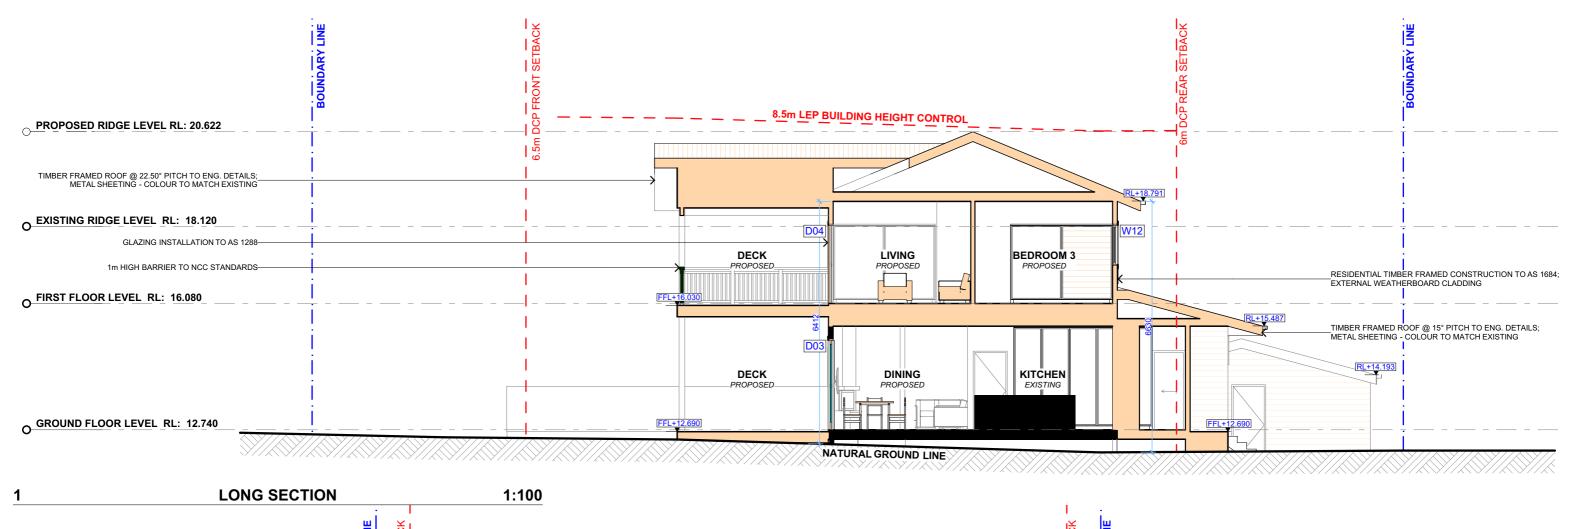
DA08

SCALE 1:100 @A3
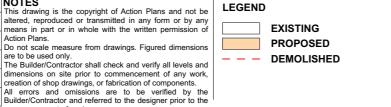
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SOUTH / WEST ELEVATION

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PROJECT ADDRESS

NORTH, CROMER NSW

133 FISHER ROAD

DA09


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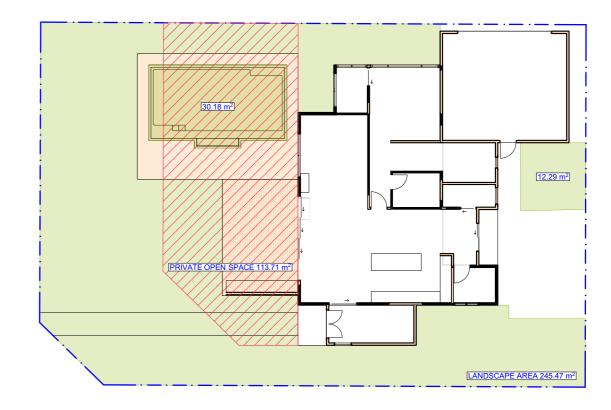
LONG / CROSS SECTION

DATE Thursday, 12 November 2020

SCALE 1:100 @A3

DRAWING NAME



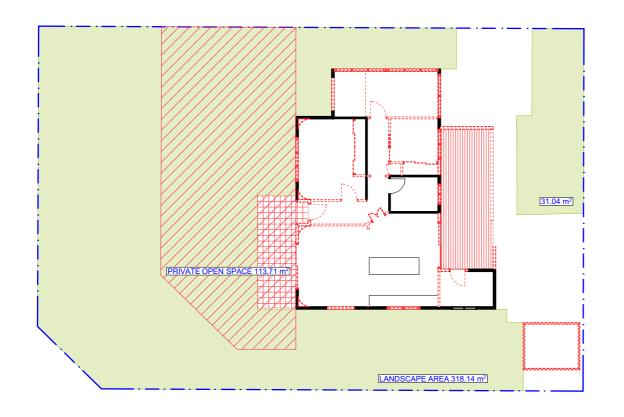


1 EXISTING AREA CALCULATIONS 1:200 2 PROPOSED AREA CALCULATIONS 1:200

MT-01
COLOURBOND METAL ROOF SHEETING
COLOUR TO BE CONFIRMED BY CLIENT
WHERE MARKED ON ELEVATION.



GL-01 1.2m HIGH CHILDPROOF POOL FENCING WITH SELF-LOCKING GATE AS PER SWIMMING POOL REGULATIONS AS 1926.1 - 2007

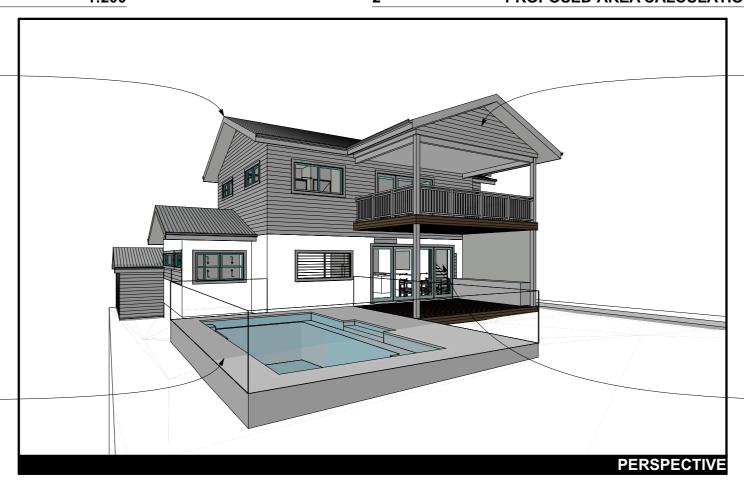

WB-01
PRIMELOK WEATHERBOARDS
PAINTED.
COLOUR TO BE CONFIRMED BY CLIENT
WHERE MARKED ON ELEVATION.

ASD
_ ALUMINIUM SLIDING DOOR FRAME
_ POWDERCOAT FINISH 'BLACK' OR SIMILAR
WHERE MARKED ON ELEVATION.

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LEGEND



LANDSCAPE AREA
PRIVATE OPEN SPACE

CLIENT

2099

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PROJECT ADDRESS 133 FISHER ROAD NORTH, CROMER NSW DRAWING NO.


DA10

DATE
Thursday, 12
November 2020

DRAWING NAME

AREA CALCULATIONS /
SAMPLE BOARD



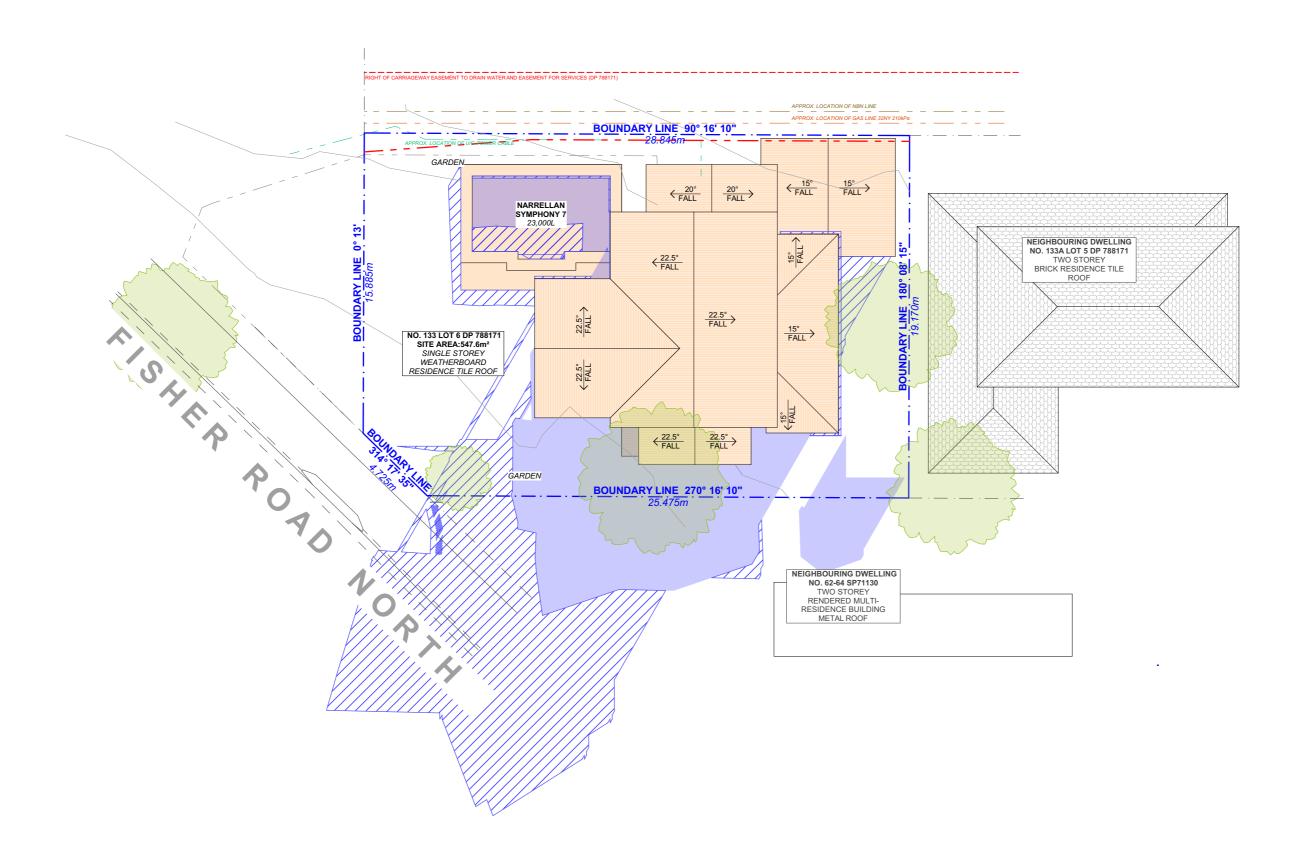




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LEGEND



CLIENT
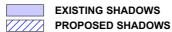
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PROJECT ADDRESS 133 FISHER ROAD NORTH, CROMER NSW DRAWING NO.

DA11

DATEThursday, 12


November 2020

SC 1:2

DRAWING NAME

WINTER SOLSTICE 9 AM



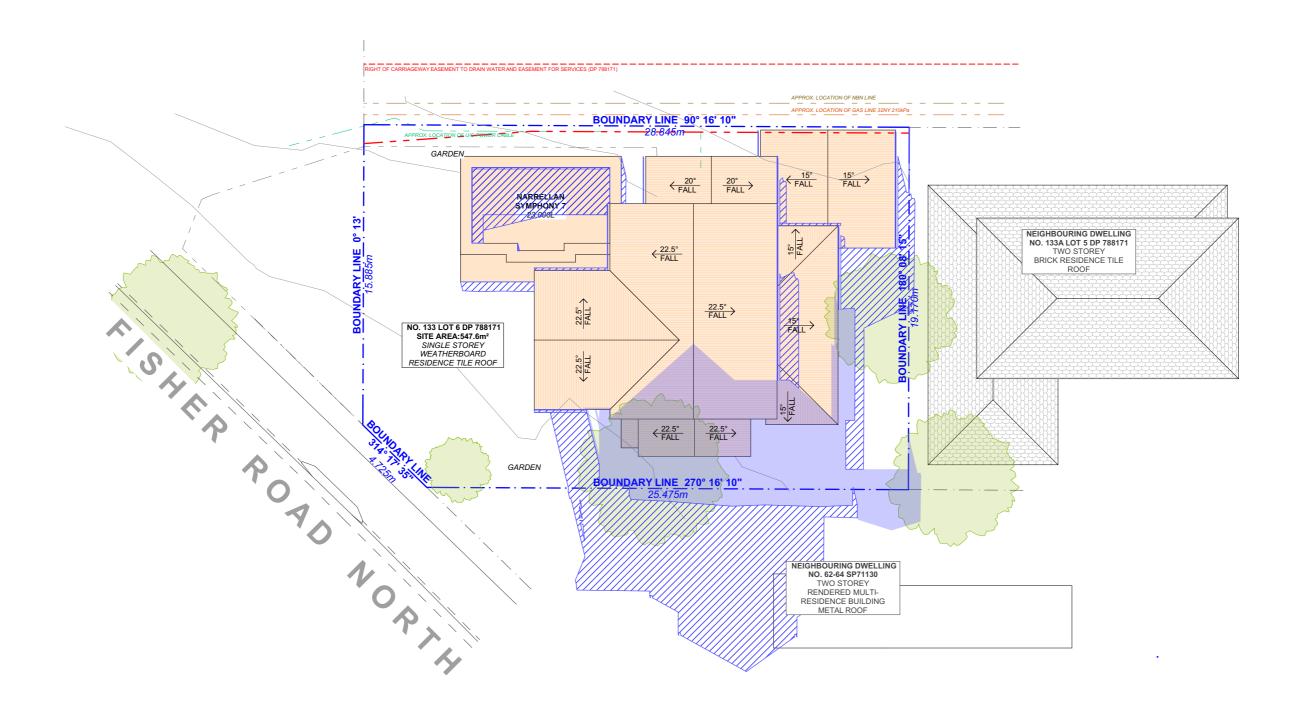




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LEGEND



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November 2020

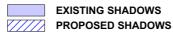
DA12

DATEThursday, 12

WINTER SOLSTICE 12 PM

DRAWING NAME



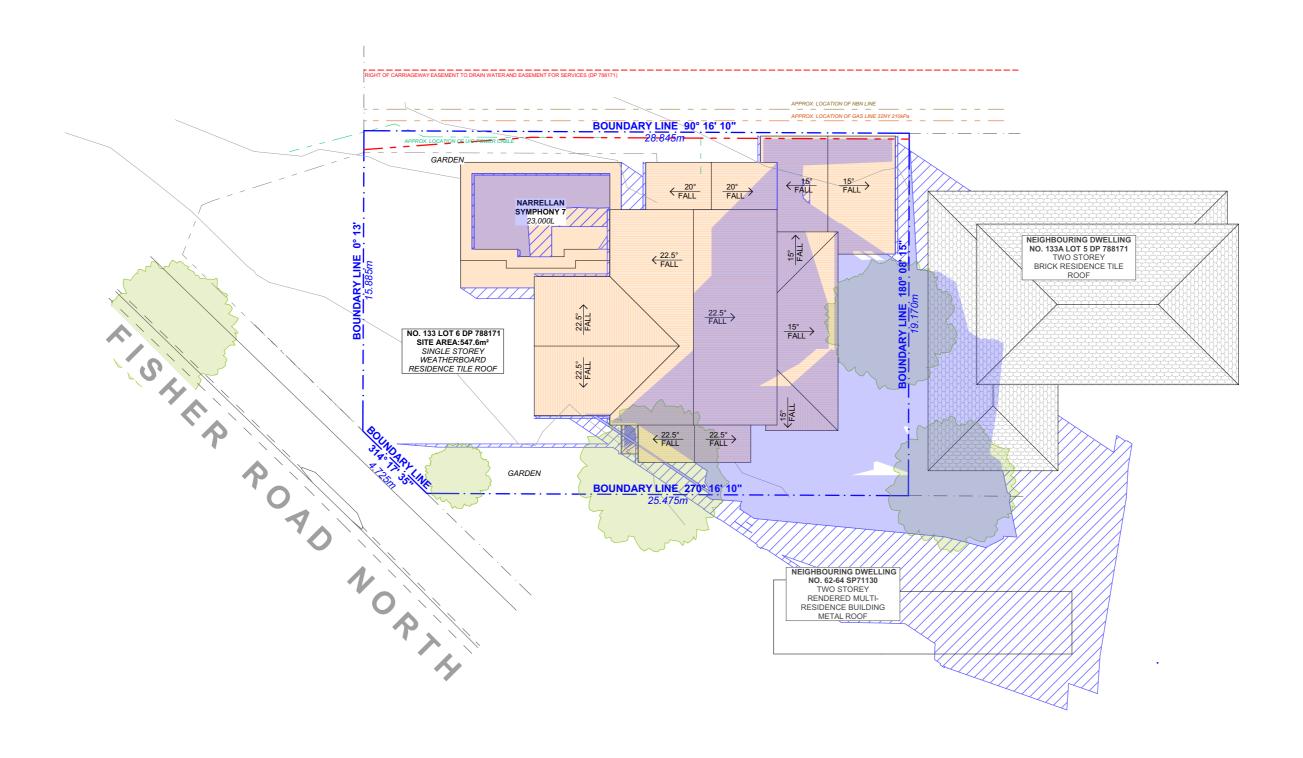




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REV.	DATE	COMMENTS	DRWN	NOTES
А	14/09/2020	INITIAL DESIGN PLAN	AL	This drawing is the copyright of Action Plans and not altered, reproduced or transmitted in any form or by a means in part or in whole with the written permission
В	01/10/2020	FIRST DESIGN AMENDMENT	AL	Action Plans. Do not scale measure from drawings. Figured dimensic
С	27/10/2020	DA DOCUMENTATION	LRP	are to be used only. The Builder/Contractor shall check and verify all levels a
				dimensions on site prior to commencement of any wo creation of shop drawings, or fabrication of components.
				All errors and omissions are to be verified by the Builder/Contractor and referred to the designer prior to the commencement of works.

LEGEND

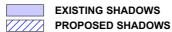

CLIENT

PATRICK & GEMMA CROTTY

PROJECT ADDRESS 133 FISHER ROAD NORTH, CROMER NSW DRAWING NO.

DA13


DATEThursday, 12

November 2020

DRAWING NAME

WINTER SOLSTICE 3 PM



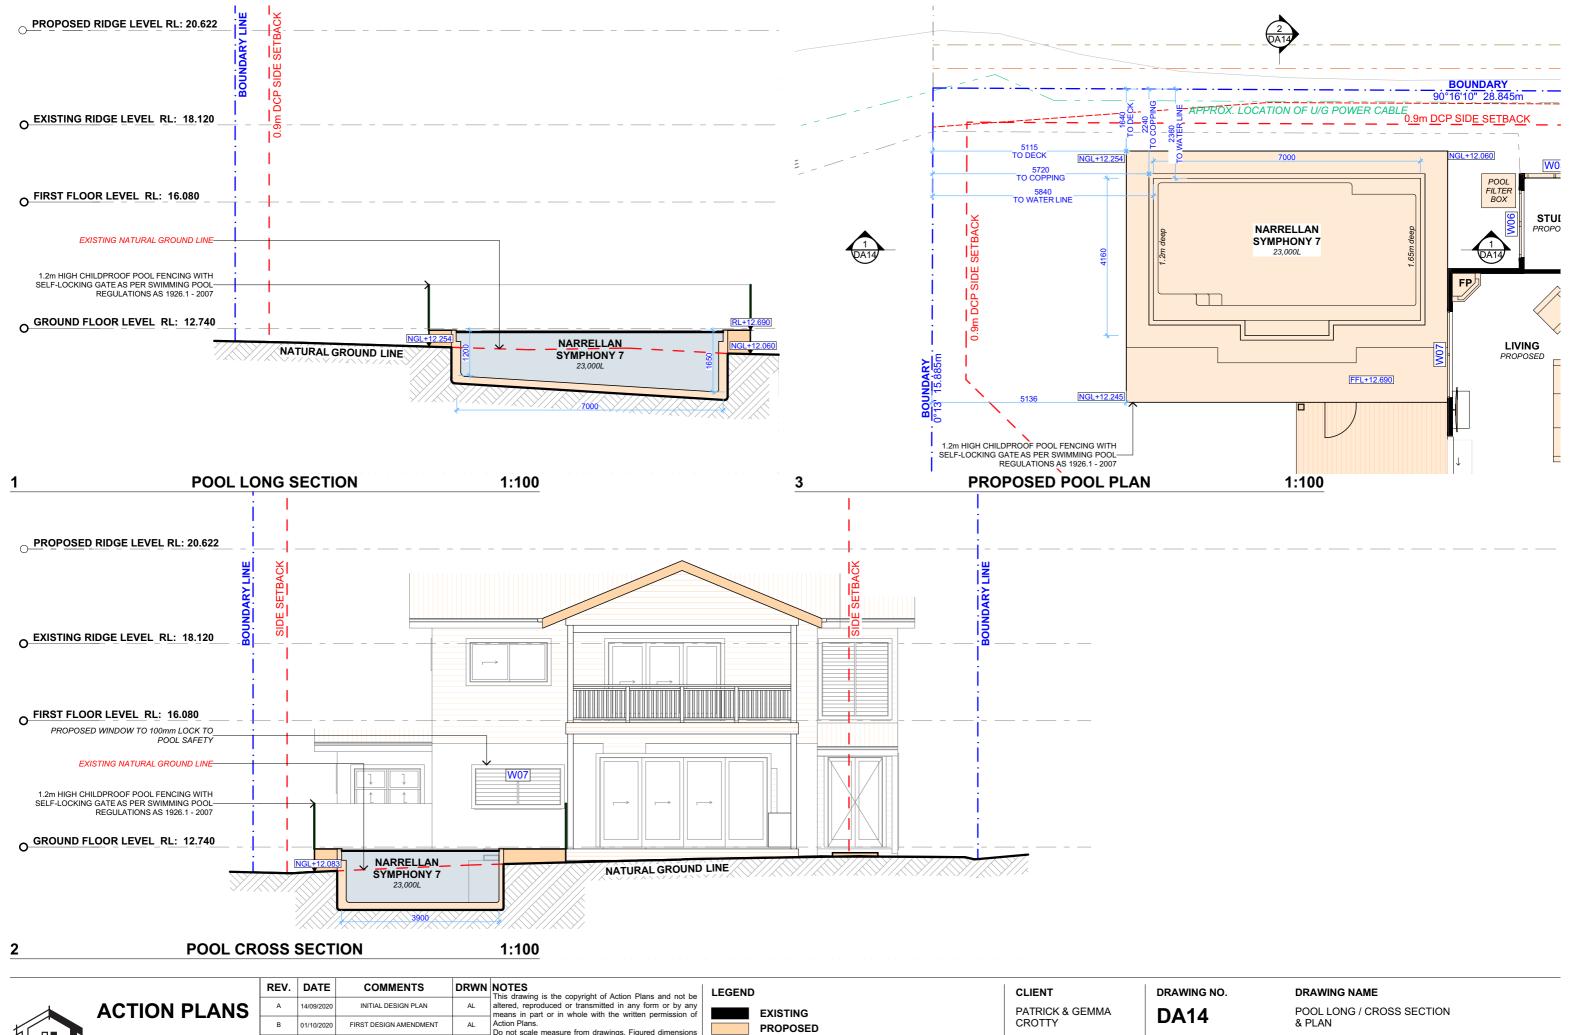




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	А	14/09/2020	INITIAL DESIGN PLAN	AL	altered, re
	В	01/10/2020	FIRST DESIGN AMENDMENT	AL	Action Pla
	С	27/10/2020	DA DOCUMENTATION	LRP	are to be The Build
u					dimension creation of

in part or in whole with the written permission of Plans. scale measure from drawings. Figured dimensions

dimensions on site prior to commencement of any work, creation of shop drawings, or fabrication of components. All errors and omissions are to be verified by the Builder/Contractor and referred to the designer prior to the encement of works.

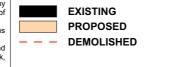

PROJECT ADDRESS 133 FISHER ROAD NORTH, CROMER NSW DATE Thursday, 12 November 2020

Building Sustainability Index www.basix.nsw.gov.au

Alterations and Additions

Certificate number: A395654

This certificate confirms that the proposed development will meet the NSW government's requirements for sustainability, if it is built in accordance with the commitments set out below. Terms used in this certificate, or in the commitments, have the meaning given by the document entitled 'BASIX Alterations and Additions Definitions' dated 06/10/2017 published by the Department. This document is available at www.basix.nsw.gov.au

Secretary
Date of issue: Wednesday, 28, October 2020
To be valid, this certificate must be lodged within 3 months of the date of issue.



Project address	
Project name	133 FISHER ROAD NORTH CROMER NSW 20
Street address	133 FISHER Road CROMER 2099
Local Government Area	Northern Beaches Council
Plan type and number	Deposited Plan 788171
Lot number	6
Section number	
Project type	
Dwelling type	Separate dwelling house
Type of alteration and addition	My renovation work is valued at \$50,000 or more and includes a pool (and/or spa).

Certificate Prepared by (please complete before submitting to Council or PCA)
Name / Company Name: Action Plans
ABN (if applicable): 17118297587

BASIX Certificate number: A395654 page 2 / 8

Pool and Spa	Show on DA Plans	Show on CC/CDC Plans & specs	Certifier Check
Outdoor swimming pool			
The swimming pool must be outdoors.	✓	✓	✓
The swimming pool must not have a capacity greater than 23 kilolitres.	✓	✓	✓
The swimming pool must have a pool cover.		✓	✓
The applicant must install a pool pump timer for the swimming pool.		✓	✓
The applicant must not incorporate any heating system for the swimming pool that is part of this development.		✓	✓

Fixtures and systems	Show on DA Plans	Show on CC/CDC Plans & specs	Certifier Check
Lighting			
The applicant must ensure a minimum of 40% of new or altered light fixtures are fitted with fluorescent, compact fluorescent, or light-emitting-diode (LED) lamps.		V	V
Fixtures			
The applicant must ensure new or altered showerheads have a flow rate no greater than 9 litres per minute or a 3 star water rating.		✓	✓
The applicant must ensure new or altered toilets have a flow rate no greater than 4 litres per average flush or a minimum 3 star water rating.		✓	~
The applicant must ensure new or altered taps have a flow rate no greater than 9 litres per minute or minimum 3 star water rating.		✓	

Construction			Show on DA Plans	Show on CC/CDC Plans & specs	Certifier Check
Insulation requirements					
The applicant must construct the new or altered the table below, except that a) additional insular is not required for parts of altered construction v	tion is not required where the area of new cons) in accordance with the specifications listed in truction is less than 2m2, b) insulation specified	~	✓	✓
Construction	Additional insulation required (R-value)	Other specifications			
concrete slab on ground floor.	nil				
suspended floor with enclosed subfloor: framed (R0.7).	R0.60 (down) (or R1.30 including construction)				
floor above existing dwelling or building.	nil				
external wall: framed (weatherboard, fibro, metal clad)	R1.30 (or R1.70 including construction)				
internal wall shared with garage: plasterboard (R0.36)	nil				
flat ceiling, pitched roof	ceiling: R2.25 (up), roof: foil/sarking	light (solar absorptance < 0.475)			

BASIX Certificate number: A395654

Glazing requirements							Show on DA Plans	Show on CC/CDC Plans & specs	Certifier Check
Windows ar	nd glazed d	oors							
The applicant must install the windows, glazed doors and shading devices, in accordance with the specifications listed in the table below. Relevant overshadowing specifications must be satisfied for each window and glazed door.								✓	✓
The following	requirements	must also	be satisfi	ed in relation	to each window and glazed door:			✓	~
Each window or glazed door with standard aluminium or timber frames and single clear or toned glass may either match the description, or, have a U-value and a Solar Heat Gain Coefficient (SHGC) no greater than that listed in the table below. Total system U-values and SHGCs must be calculated in accordance with National Fenestration Rating Council (INFRC) conditions.								✓	✓
Each window or glazed door with improved frames, or pyrolytic low-e glass, or clear/air gap/clear glazing, or toned/air gap/clear glazing mus have a U-value and a Solar Heat Gain Coefficient (SHGC) no greater than that listed in the table below. Total system U-values and SHGCs must be calculated in accordance with National Fneestration Rating Council (NFRC) conditions. The description is provided for information only. Alternative systems with complying U-value and SHGC may be substituted.								✓	✓
For projections described in millimetres, the leading edge of each eave, pergola, verandah, balcony or awning must be no more than 500 mm above the head of the window or glazed door and no more than 2400 mm above the sill.							✓	✓	~
Pergolas with	polycarbona	te roof or s	imilar tran	slucent mate	rial must have a shading coefficier	nt of less than 0.35.		✓	~
					e window or glazed door above whi ens must not be more than 50 mm.	ich they are situated, unless the pergola also		✓	~
Windows a	and glazed	doors g	lazing re	equiremer	nts		1		
Window / do no.	or Orientation	Area of glass inc. frame (m2)	Oversha Height (m)	Distance (m)	Shading device	Frame and glass type			
W01	S	2.16	0	0	eave/verandah/pergola/balcony >=450 mm	standard aluminium, single clear, (or U-value: 7.63, SHGC: 0.75)			
W02	E	0.54	0	0	eave/verandah/pergola/balcony >=900 mm	standard aluminium, single clear, (or U-value: 7.63, SHGC: 0.75)			
W03	E	0.36	0	0	eave/verandah/pergola/balcony >=900 mm	standard aluminium, single clear, (or U-value: 7.63, SHGC: 0.75)			

Planning, Industry & Environment Building Sustainability Index www.basix.nsw.gov.au

Glazing requi	Show on DA Plans	Show on CC/CDC Plans & specs	Certifier Check						
Window / door no.	Orientation	Area of glass inc. frame (m2)	Oversha Height (m)	Distance (m)	Shading device	Frame and glass type			
W04	N	2.16	0	0	eave/verandah/pergola/balcony >=600 mm	standard aluminium, single clear, (or U-value: 7.63, SHGC: 0.75)			
W05	N	0.96	0	0	eave/verandah/pergola/balcony >=600 mm	standard aluminium, single clear, (or U-value: 7.63, SHGC: 0.75)			
W06	W	1.98	0	0	eave/verandah/pergola/balcony >=750 mm	standard aluminium, single clear, (or U-value: 7.63, SHGC: 0.75)			
W07	W	2.33	0	0	eave/verandah/pergola/balcony >=750 mm	standard aluminium, single clear, (or U-value: 7.63, SHGC: 0.75)			
W08	W	2.31	0	0	eave/verandah/pergola/balcony >=750 mm	standard aluminium, single clear, (or U-value: 7.63, SHGC: 0.75)			
W09	W	3.6	0	0	eave/verandah/pergola/balcony >=750 mm	standard aluminium, single clear, (or U-value: 7.63, SHGC: 0.75)			
W10	S	2.25	0	0	eave/verandah/pergola/balcony >=450 mm	standard aluminium, single clear, (or U-value: 7.63, SHGC: 0.75)			
W11	E	3.6	0	0	eave/verandah/pergola/balcony >=750 mm	standard aluminium, single pyrolytic low-e, (U-value: 5.7, SHGC: 0.47)			
W12	E	2.31	0	0	eave/verandah/pergola/balcony >=750 mm	standard aluminium, single pyrolytic low-e, (U-value: 5.7, SHGC: 0.47)			
W13	E	2.7	0	0	eave/verandah/pergola/balcony >=750 mm	standard aluminium, single pyrolytic low-e, (U-value: 5.7, SHGC: 0.47)			
W14	E	2.31	0	0	eave/verandah/pergola/balcony >=750 mm	standard aluminium, single pyrolytic low-e, (U-value: 5.7, SHGC: 0.47)			
D01	W	3.6	0	0	eave/verandah/pergola/balcony >=900 mm	standard aluminium, single clear, (or U-value: 7.63, SHGC: 0.75)			
D02	E	3.6	0	0	eave/verandah/pergola/balcony >=900 mm	standard aluminium, single clear, (or U-value: 7.63, SHGC: 0.75)			

page 5 / 8 BASIX Certificate number: A395654 page 7 / 8

Glazing requirements								Show on CC/CDC Plans & specs	Certifier Check
Window / door	Orientation	Area of	Oversha	dowing	Shading device	Frame and glass type			
		glass inc. frame (m2)	Height (m)	Distance (m)					
D03	W	10.77	0	0	eave/verandah/pergola/balcony >=900 mm	standard aluminium, single clear, (or U-value: 7.63, SHGC: 0.75)			
D04	W	6.36	0	0	eave/verandah/pergola/balcony >=900 mm	standard aluminium, single clear, (or U-value: 7.63, SHGC: 0.75)			
W15	N	1.27	0	0	eave/verandah/pergola/balcony >=450 mm	standard aluminium, single pyrolytic low-e, (U-value: 5.7, SHGC: 0.47)			
W16	N	1.27	0	0	eave/verandah/pergola/balcony >=450 mm	standard aluminium, single pyrolytic low-e, (U-value: 5.7, SHGC: 0.47)			

BASIX Certificate number: A395654

Legend	
In these commitments, "applicant" means the person carrying out the development.	
Commitments identified with a *\" in the "Show on DA plans" column must be shown on the plans accompanying the development application if development application is to be lodged for the proposed development).	for the proposed development (if a
Commitments identified with a "\" in the "Show on CC/CDC plans & specs" column must be shown in the plans and specifications accompanyli certificate / complying development certificate for the proposed development.	ng the application for a construction

Commitments identified with a "\sqrt^" in the "Certifier check" column must be certified by a certifying authority as having been fulfilled, before a final occupation certificate for the levelopment may be issued.

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REV.	DATE	COMMENTS	DRWN
А	14/09/2020	INITIAL DESIGN PLAN	AL
В	01/10/2020	FIRST DESIGN AMENDMENT	AL
С	27/10/2020	DA DOCUMENTATION	LRP

NOTES

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The Builder/Contractor shall check and verify all levels and dimensions on site prior to commencement of any work, creation of shop drawings, or fabrication of components.

All errors and omissions are to be verified by the Builder/Contractor and referred to the designer prior to the commencement of works.

All window & door dimensions, orientation, glazing materials, opening types, frame types are to be confirmed by a suitably qualified person prior to the ordering of any such materials are to take place.

U value takes precedence over glazing type/colour in all cases.

all new glazing must meet the BASIX specified frame and glass type, OR meet the ecified U value and SHGC value.

CLIENT

PATRICK & GEMMA CROTTY

PROJECT ADDRESS 133 FISHER ROAD NORTH, CROMER NSW 2099

DRAWING NO.

November 2020

DA15

DRAWING NAME BASIX COMMITMENTS

DATE Thursday, 12