
2 MACPHERSON STREET, WARRIEWOOD

SUBDIVISION 000-SERIES CIVIL WORKS PACKAGE

DRAWING LIST

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COVER SHEET AND LOCALITY PLAN
          GENERAL NOTES
          GENERAL ARRANGEMENT PLAN
         TYPICAL SECTIONS SHEET 2 OF 2
          SITEWORKS AND STORMWATER PLAN SHEET 1
          SITEWORKS AND STORMWATER PLAN SHEET 2
          SITEWORKS DETAILS
         PAVEMENT PLAN
          MC01 CROSS SECTIONS SHEET 1
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         SERVICES AND UTILITIES COORDINATION PLAN
C080
          SEDIMENTATION AND EROSION CONTROL PLAN
C081
         SEDIMENTATION AND EROSION CONTROL DETAILS
         SEDIMENTATION AND EROSION CONTROL CALCULATIONS
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INTERNAL STORMWATER CATCHMENT PLAN

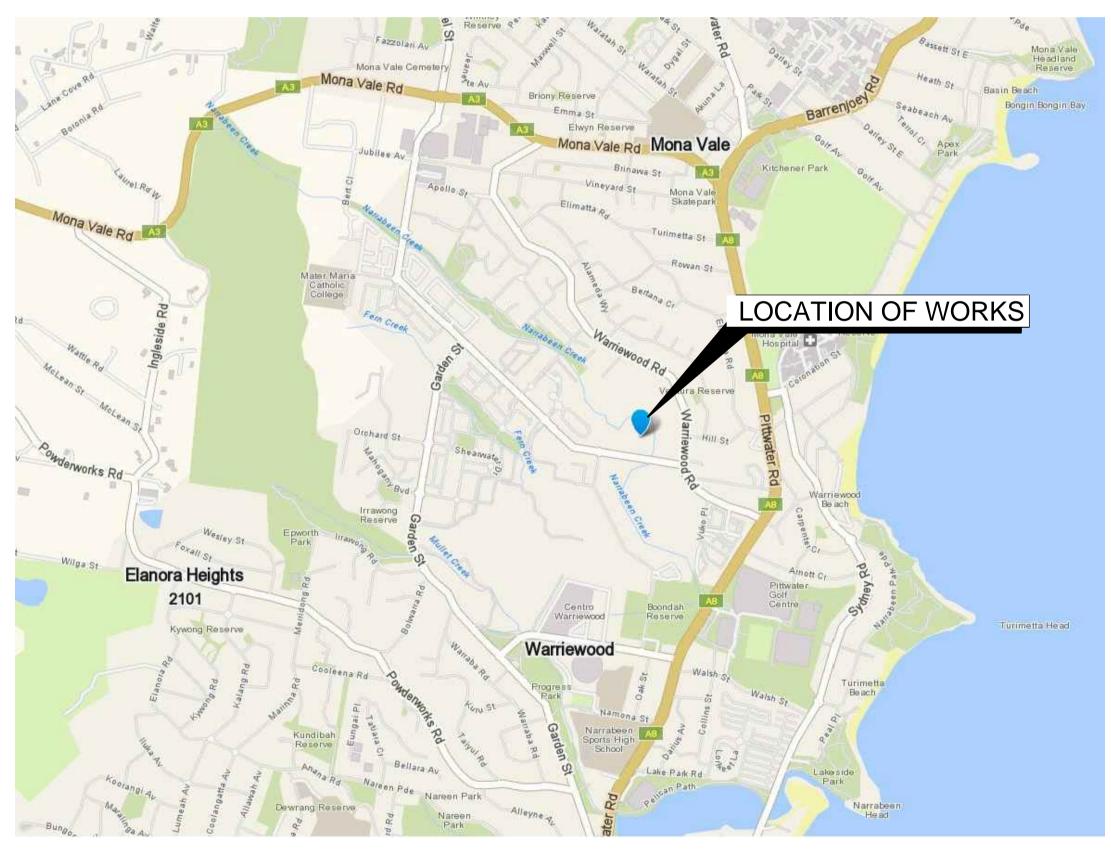

LOCALITY PLAN N.T.S

> NOTE: EXTENT OF WORKS IN THIS DRAWING PACKAGE IS BASED OF DA N03981

			Bar Scales	THIS DRAWING CANNOT BE COPIED OR REPRODUCED IN ANY FORM OR USED FOR ANY OTHER PURPOSE OTHER THAN THAT ORIGINALLY INTENDED	Client KARIMBLA CONSTRUCTION SERVICES (NSW) PTY LIMITED Level 11, 528 Kent Street, Sydney NSW 2000	Scales Grid Height Datum	MGA AHD	Drawn Designed Checked Approved	GJ GJ AT	Project MACPHERSON STREET WARRIEWOOD SUBDIVISION PACKAGE	Civil Engineers and Project Managers Level 7, 153 Walker Street North Sydney NSW 2060 ABN 96 130 882 405 Tel: 02 9439 1777 Fax: 02 9460 8413 www.atl.net.au info@atl.net.au
	ISSUED FOR APPROVAL	22-07-19		WITHOUT THE WRITTEN	Tel: (02) 9287 2888 Fax: (02) 9287 2777					Title	FOR APPROVAL A1
		17-07-19		PERMISSION OF AT&L	Email: info@design.meriton.com.au Internet: http://www.meriton.com.au					COVER SHEET AND	NOT TO BE USED FOR CONSTRUCTION
Α	ISSUED FOR APPROVAL	12-07-19			momet. http://www.memom.com.aa					LOCALITY PLAN	Drawing No. Project No. Issue
Issue	e Description	Date									C001 18-580 C
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SURVEY NOTES

- THE EXISTING SITE CONDITIONS SHOWN ON THE FOLLOWING DRAWINGS HAVE BEEN INVESTIGATED BY JBW SURVEYORS. BEING REGISTERED SURVEYORS. THE INFORMATION IS SHOWN TO PROVIDE A BASIS FOR DESIGN. AT & L DOES NOT GUARANTEE THE ACCURACY OR COMPLETENESS OF THE SURVEY BASE OR ITS SUITABILITY AS A BASIS FOR CONSTRUCTION DRAWINGS.
- SHOULD DISCREPANCIES BE ENCOUNTERED DURING CONSTRUCTION BETWEEN THE SURVEY DATA AND ACTUAL FIELD DATA, CONTACT AT & L.
- THE FOLLOWING NOTES HAVE BEEN TAKEN DIRECTLY FROM THE ORIGINAL SURVEY DOCUMENTS.
- THE INFORMATION SUPPLIED IN THIS DATA FILE IS SUPPLIED ON THE CONDITION THAT THESE GENERAL NOTES ARE ALWAYS STORED WITH THE SUPPLIED CAD DRAWING & IF THE DATA IS PROVIDED TO ANY PARTY ON ANY FORM OF HARD COPY OR COMPUTER MEDIA THEN THESE GENERAL NOTES WILL ALSO BE A PART OF THAT HARD MEDIA COPY OR COMPUTER MEDIA DATA.
- THE RECORDS OF THE SERVICE AUTHORITIES HAVE NOT BEEN INVESTIGATED ONLY THOSE SERVICES VISIBLE AT THE TIME OF SURVEY HAVE BEEN SHOWN.
- THE RECORDS OF THE SERVICE AUTHORITIES SHOULD BE INVESTIGATED AS TO THE LOCATION OF SERVICES PRIOR TO THE COMMENCEMENT OF ANY DETAILED DESIGN OR CONSTRUCTION WORKS.
- THE POSITION OF IMPROVEMENT AND FEATURES HAVE BEEN LOCATED FOR PLOTTING PURPOSES ONLY.
- IMPROVEMENTS AND FEATURES SHOWN ON OR NEAR THE BOUNDARIES ARE INDICATIVE ONLY.
- LEVELS ARE BASED ON AUSTRALIAN HEIGHT DATUM (AHD) THE ORIGIN OF

WHICH IS PM 55212, RL 4.641 AHD AS SUPPLIED BY SCIMS DATED

- THE BOUNDARIES HAVE NOT BEEN SURVEYED, DIMENSIONS HAVE BEEN COMPILED FROM THE SUBJECT DEPOSITED PLANS AND ARE SUBJECT TO FINAL SURVEY.
- THE BOUNDARIES SHOULD BE SURVEYED AND MARKED PRIOR TO THE COMMENCEMENT OF ANY CONSTRICTION WORK.
- CONTOURS SHOWN ARE AT 0.5 METRE INTERVALS.


9/12/2004.

CONCRETE NOTES

- 1. ALL WORKMANSHIP AND MATERIALS SHALL BE IN ACCORDANCE WITH AS 3600 CURRENT EDITION WITH AMENDMENTS, EXCEPT WHERE VARIED BY THE CONTRACT DOCUMENTS.
- 2. CONCRETE QUALITY ALL REQUIREMENTS OF THE CURRENT ACSE CONCRETE SPECIFICATION DOCUMENT 1 SHALL APPLY TO THE FORMWORK, REINFORCEMENT AND CONCRETE UNLESS NOTED OTHERWISE.

ELEMENT	AS 3600 F'c MPa	SPECIFIED	NOMINAL
	AT 28 DAYS	SLUMP	AGG. SIZE
VEHICULAR BASE KERBS, PATHS, AND PITS	32 32	60 80	20 20

- CEMENT TYPE SHALL BE (ACSE SPECIFICATION) TYPE SL
- PROJECT CONTROL TESTING SHALL BE CARRIED OUT IN ACCORDANCE WITH AS 1379.
- 3. NO ADMIXTURES SHALL BE USED IN CONCRETE UNLESS APPROVED IN WRITING BY AT & L.
- 4. CLEAR CONCRETE COVER TO ALL REINFORCEMENT FOR DURABILITY SHALL BE 40mm TOP AND 70mm FOR EXTERNAL EDGES UNLESS NOTED OTHERWISE.
- 5. ALL REINFORCEMENT SHALL BE FIRMLY SUPPORTED ON MILD STEEL PLASTIC TIPPED CHAIRS, PLASTIC CHAIRS OR CONCRETE CHAIRS AT NOT GREATER THAN 1m CENTRES BOTH WAYS. BARS SHALL BE TIED AT ALTERNATE INTERSECTIONS.
- 6. THE FINISHED CONCRETE SHALL BE A DENSE HOMOGENEOUS MASS, COMPLETELY FILLING THE FORMWORK, THOROUGHLY EMBEDDING THE REINFORCEMENT AND FREE OF STONE POCKETS. ALL CONCRETE INCLUDING SLABS ON GROUND AND FOOTINGS SHALL BE COMPACTED AND CURED IN ACCORDANCE WITH R.T.A. SPECIFICATION R83.
- 7. REINFORCEMENT SYMBOLS:
- N DENOTES GRADE 450 N BARS TO AS 1302 GRADE N
- R DENOTES 230 R HOT ROLLED PLAIN BARS TO AS 1302
- SL DENOTES HARD-DRAWN WIRE REINFORCING FABRIC TO AS 1304 NUMBER OF BARS IN GROUP _ BAR GRADE AND TYPE
 - 17 N 20 250
 - NOMINAL BAR SIZE IN mm SPACING IN mm
- THE FIGURE FOLLOWING THE FABRIC SYMBOL SL IS THE REFERENCE NUMBER FOR FABRIC TO AS 1304.
- 8. FABRIC SHALL BE LAPPED IN ACCORDANCE WITH THE FOLLOWING DETAIL:

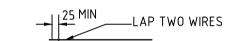

SITEWORKS NOTES

- 1. ORIGIN OF LEVELS:- REFER SURVEY NOTES.
 - 2. CONTRACTOR MUST VERIFY ALL DIMENSIONS AND EXISTING LEVELS ON SITE PRIOR TO COMMENCEMENT OF WORK. ANY DISCREPANCIES TO BE REPORTED TO AT & L.
 - 3. MAKE SMOOTH CONNECTION WITH EXISTING WORKS.
 - 4. ALL TRENCH BACKFILL MATERIAL SHALL BE COMPACTED TO THE SAME DENSITY AS THE ADJACENT MATERIAL.
 - 5. ALL SERVICE TRENCHES UNDER VEHICULAR PAVEMENTS SHALL BE BACKFILLED WITH SAND TO 300mm ABOVE PIPE. WHERE PIPE IS UNDER PAVEMENTS BACKFILL REMAINDER OF TRENCH TO UNDERSIDE OF PAVEMENT WITH SAND OR APPROVED GRANULAR MATERIAL COMPACTED IN 150mm LAYERS TO MINIMUM 98% MODIFIED MAXIMUM DRY DENSITY IN ACCORDANCE WITH AS 1289 5.2.1. (OR A DENSITY INDEX OF NOT LESS THAN 75)
 - 6. PROVIDE 10mm WIDE EXPANSION JOINTS BETWEEN BUILDINGS AND ALL CONCRETE OR UNIT PAVEMENTS.
 - 7. ASPHALTIC CONCRETE SHALL CONFORM TO RMS SPECIFICATION R116.
 - 8. ALL BASECOURSE MATERIAL SHALL BE IGNEOUS ROCK QUARRIED MATERIAL TO COMPLY WITH RMS FORM 3051 (UNBOUND), RMS FORM 3052 (BOUND) COMPACTED TO MINIMUM 98% MODIFIED DENSITY IN ACCORDANCE WITH AS 1289 5.2.1 FREQUENCY OF COMPACTION TESTING SHALL NOT BE LESS THAN 1 TEST PER 50m³ OF BASECOURSE MATERIAL PLACED.
 - 9. ALL SUB-BASE COURSE MATERIAL SHALL BE IGNEOUS ROCK QUARRIED MATERIAL TO COMPLY WITH RMS FORM 3051, 3051.1 AND COMPACTED TO MINIMUM 98% MODIFIED DENSITY IN ACCORDANCE WITH A.S 1289 5.2.1 FREQUENCY OF COMPACTION TESTING SHALL NOT BE LESS THAN 1 TEST PER 50m³OF SUB-BASE COURSE MATERIAL PLACED.
 - 10. AS AN ALTERNATIVE TO THE USE OF IGNEOUS ROCK AS A SUB-BASE MATERIAL IN (9) A CERTIFIED RECYCLED CONCRETE MATERIAL COMPLYING WITH RMS FORM 3051 AND 3051.1 WILL BE CONSIDERED. SUBJECT TO MATERIAL SAMPLES AND APPROPRIATE CERTIFICATIONS BEING PROVIDED TO THE SATISFACTION OF AT & L.
 - I. SHOULD THE CONTRACTOR WISH TO USE A RECYCLED PRODUCT THIS SHALL BE CLEARLY INDICATED IN THEIR TENDER AND THE PRICE DIFFERENCE BETWEEN AN IGNEOUS PRODUCT AND A RECYCLED PRODUCT SHALL BE CLEARLY INDICATED.
 - 12. WHERE NOTED ON THE DRAWINGS THAT WORKS ARE TO BE CARRIED BY OTHERS, (eg. ADJUSTMENT OF SERVICES), THE CONTRACTOR SHALL BE RESPONSIBLE FOR THE CO-ORDINATION OF THESE WORKS.
 - 13. CIVIL WORKS TO BE CONSTRUCTED IN ACCORDANCE WITH CITY OF BOTANY BAY COUNCIL CIVIL WORKS SPECIFICATIONS 2013. WHERE ANY AMBIGUITY BETWEEN AT&L SPECIFICATIONS AND COUNCIL SPECIFICATIONS EXIST, COUNCIL SPECIFICATIONS TAKES PRECEDENCE.
 - 14. INSPECTIONS ARE TO BE UNDERTAKEN IN ACCORDANCE WITH AN APPROVED INSPECTION REGISTER.

EXISTING UNDERGROUND SERVICES

THE LOCATIONS OF UNDERGROUND SERVICES SHOWN IN THIS SET OF

AND MAY NOT BE AS CONSTRUCTED OR ACCURATE.

AT & L CAN NOT GUARANTEE THAT THE SERVICES

HAND EXCAVATION WHERE NECESSARY.

SITE AT ALL TIMES.

SURFACE LEVELS.

TO COMMENCEMENT OF EXCAVATION WORKS.

INFORMATION SHOWN ON THESE DRAWINGS ACCURATELY

INFORMATION SHOWN FROM ANY CAUSE WHATSOEVER.

DRAWINGS HAVE BEEN PLOTTED FROM SURVEY INFORMATION AND SERVICE

ONLY TO SHOW THE APPROXIMATE POSITIONS OF ANY KNOWN SERVICES

INDICATES THE PRESENCE OR ABSENCE OF SERVICES OR THEIR LOCATION

CONTRACTORS SHALL TAKE DUE CARE WHEN EXCAVATING ONSITE INCLUDING

CONTRACTORS ARE TO CONTACT THE RELEVANT SERVICE AUTHORITY PRIOR

AND WILL ACCEPT NO LIABILITY FOR INACCURACIES IN THE SERVICES

CONTRACTORS ARE TO UNDERTAKE A SERVICES SEARCH, PRIOR TO COMMENCEMENT OF WORKS ON SITE. SEARCH RESULTS ARE TO BE KEPT ON


AL SURFACE LIDS/FITTINGS TO BE ADJUSTED TO SUIT FINISHED

AUTHORITY INFORMATION. THE SERVICE INFORMATION HAS BEEN PREPARED

JOINTING NOTES

PEDESTRIAN PAVEMENT JOINTS

- 1. ALL PEDESTRIAN PAVEMENTS ARE TO BE JOINTED AS FOLLOWS. (U.N.O)
- 2. EXPANSION JOINTS ARE TO BE LOCATED WHERE POSSIBLE AT TANGENT POINTS OF CURVES AND ELSEWHERE AT MAX. 6.0m CENTRES.
- 3. WEAKENED PLANE JOINTS ARE TO BE LOCATED AT A MAX. SPACING OF 1.5 x WIDTH OF THE PAVEMENT.
- 4. WHERE POSSIBLE JOINTS SHOULD BE LOCATED TO MATCH KERBING AND OR ADJACENT PAVEMENT JOINTS.
- 5. PEDESTRIAN PAVEMENT JOINT DETAIL.

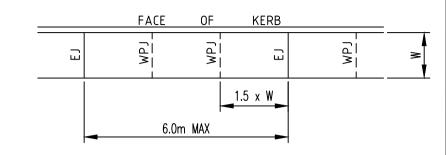

- VEHICULAR PAVEMENT JOINTS
- 6. ALL VEHICULAR PAVEMENTS TO BE JOINTED AS FOLLOWS. (U.N.O)
- 7. KEYED CONSTRUCTION JOINTS SHOULD GENERALLY BE LOCATED AT A MAX OF 6.0m CENTRES
- 8. SAWN JOINTS SHOULD GENERALLY BE LOCATED AT A MAX OF 6.0m CENTRES WITH DOWELED EXPANSION JOINTS AT MAX 18.0m CENTRES
- 9. VEHICULAR PAVEMENT JOINT DETAIL.

DEJ	FACE	OF LS	KERB 日	SJ		
		KJ			 	0.0m MAX
	i	6.0m MAX				
	-	18.0m MAX				

EROSION AND SEDIMENT CONTROL NOTES

GENERAL INSTRUCTIONS

- 1. THE SITE SUPERINTENDENT/ENGINEER WILL ENSURE THAT ALL SOIL AND WATER MANAGEMENT WORKS ARE LOCATED AS DOCUMENTED.
- 2. ALL WORK SHALL BE GENERALLY CARRIED OUT IN ACCORDANCE WITH a. LOCAL AUTHORITY REQUIREMENTS b. EPA REQUIREMENTS
- c. NSW DEPARTMENT OF HOUSING MANUAL "MANAGING URBAN STORMWATER, SOILS AND CONSTRUCTION", 4th EDITION, MARCH
- 3. MAINTAIN THE EROSION CONTROL DEVICES TO THE SATISFACTION OF THE SUPERINTENDENT AND THE LOCAL AUTHORITY.
- 4. WHEN STORMWATER PITS ARE CONSTRUCTED, PREVENT SITE RUNOFF ENTERING UNLESS SEDIMENT FENCES ARE ERECTED AROUND PITS.
- 5. CONTRACTOR IS TO ENSURE ALL EROSION & SEDIMENT CONTROL DEVICES ARE MAINTAINED IN GOOD WORKING ORDER AND OPERATE EFFECTIVELY. REPAIRS AND OR MAINTENANCE SHALL BE UNDERTAKEN AS REQUIRED, PARTICULARLY FOLLOWING STORM EVENTS.

LAND DISTURBANCE

- 6. WHERE PRACTICAL, THE SOIL EROSION HAZARD ON THE SITE WILL BE KEPT AS LOW AS POSSIBLE. TO THIS END, WORKS SHOULD BE UNDERTAKEN IN THE FOLLOWING SEQUENCE:
- (A) INSTALL A SEDIMENT FENCE ALONG THE BOUNDARIES AS SHOWN ON PLAN. REFER DETAIL.
- (B) CONSTRUCT STABILISED CONSTRUCTION ENTRANCE TO LOCATION AS DETERMINED BY SUPERINTENDENT/ENGINEER. REFER
- (C) INSTALL SEDIMENT TRAPS AS SHOWN ON PLAN.
- (D) UNDERTAKE SITE DEVELOPMENT WORKS IN ACCORDANCE WITH THE ENGINEERING PLANS. WHERE POSSIBLE, PHASE DEVELOPMENT SO THAT LAND DISTURBANCE IS CONFINED TO AREAS OF WORKABLE SIZE.

EROSION CONTROL

- 7. DURING WINDY WEATHER, LARGE, UNPROTECTED AREAS WILL BE KEPT MOIST (NOT WET) BY SPRINKLING WITH WATER TO KEEP DUST UNDER CONTROL.
- 8. FINAL SITE LANDSCAPING WILL BE UNDERTAKEN AS SOON AS POSSIBLE AND WITHIN 20 WORKING DAYS FROM COMPLETION OF CONSTRUCTION ACTIVITIES.

SEDIMENT CONTROL

- 9. STOCKPILES WILL NOT BE LOCATED WITHIN 2 METRES OF HAZARD AREAS, INCLUDING LIKELY AREAS OF CONCENTRATED OR HIGH VELOCITY FLOWS SUCH AS WATERWAYS. WHERE THEY ARE BETWEEN 2 AND 5 METRES FROM SUCH AREAS, SPECIAL SEDIMENT CONTROL MEASURES SHOULD BE TAKEN TO MINIMISE POSSIBLE POLLUTION TO DOWNSLOPE WATERS, E.G. THROUGH INSTALLATION OF SEDIMENT FENCING.
- 10. ANY SAND USED IN THE CONCRETE CURING PROCESS (SPREAD OVER THE SURFACE) WILL BE REMOVED AS SOON AS POSSIBLE AND WITHIN 10 WORKING DAYS FROM PLACEMENT.
- 11. WATER WILL BE PREVENTED FROM ENTERING THE PERMANENT DRAINAGE SYSTEM UNLESS IT IS RELATIVELY SEDIMENT FREE, I.E. THE CATCHMENT AREA HAS BEEN PERMANENTLY LANDSCAPED AND/OR ANY LIKELY SEDIMENT HAS BEEN FILTERED THROUGH AN APPROVED STRUCTURE.
- 12. TEMPORARY SOIL AND WATER MANAGEMENT STRUCTURES WILL BE REMOVED ONLY AFTER THE LANDS THEY ARE PROTECTING ARE REHABILITATED.

OTHER MATTERS

- 13. ACCEPTABLE RECEPTORS WILL BE PROVIDED FOR CONCRETE AND MORTAR SLURRIES, PAINTS, ACID WASHINGS, LIGHT-WEIGHT WASTE MATERIALS AND LITTER.
- 14. ANY EXISTING TREES WHICH FORM PART OF THE FINAL LANDSCAPING PLAN WILL BE PROTECTED FROM CONSTRUCTION ACTIVITIES BY:
- (A) PROTECTING THEM WITH BARRIER FENCING OR SIMILAR MATERIALS INSTALLED OUTSIDE THE DRIP LINE
- (B) ENSURING THAT NOTHING IS NAILED TO THEM
- (C) PROHIBITING PAVING, GRADING, SEDIMENT WASH OR PLACING OF STOCKPILES WITHIN THE DRIP LINE EXCEPT UNDER THE FOLLOWING CONDITIONS.
- (I) ENCROACHMENT ONLY OCCURS ON ONE SIDE AND NO CLOSER TO THE TRUNK THAN EITHER 1.5 METRES OR HALF THE DISTANCE BETWEEN THE OUTER EDGE OF THE DRIP LINE AND THE TRUNK, WHICH EVER IS THE GREATER
- (II) A DRAINAGE SYSTEM THAT ALLOWS AIR AND WATER TO CIRCULATE THROUGH THE ROOT ZONE (E.G. A GRAVEL BED) IS PLACED UNDER ALL FILL LAYERS OF MORE THAN 300 MILLIMETRES DEPTH

Title

(III) CARE IS TAKEN NOT TO CUT ROOTS UNNECESSARILY NOR TO COMPACT THE SOIL AROUND THEM.

BEFORE YOU DIG

CONTRACTOR SHALL CALL; DIAL BEFORE YOU DIG 1100 PRIOR TO COMMENCEMENT OF WORK TO OBTAIN ALL CURRENT SERVICE AUTHORITY PLANS

Bar Scales ISSUED FOR APPROVAL 22-07-1 17-07-1 ISSUED FOR APPROVAL ISSUED FOR APPROVAL 12-07-1 Date Description 100mm on Original

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Level 11, 528 Kent Street, Sydney NSW 2000 Tel: (02) 9287 2888 Fax: (02) 9287 2777 Email: info@design.meriton.com.au Internet: http://www.meriton.com.au

NTS GJ Designed GJ Checked MGA ΑT Height Approved AHD Datum

Scales

WARRIEWOOD **SUBDIVISION** PACKAGE

GENERAL NOTES

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Civil Engineers and Project Managers

Drawing No. Project No. Issue 18-580

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North Sydney NSW 2060


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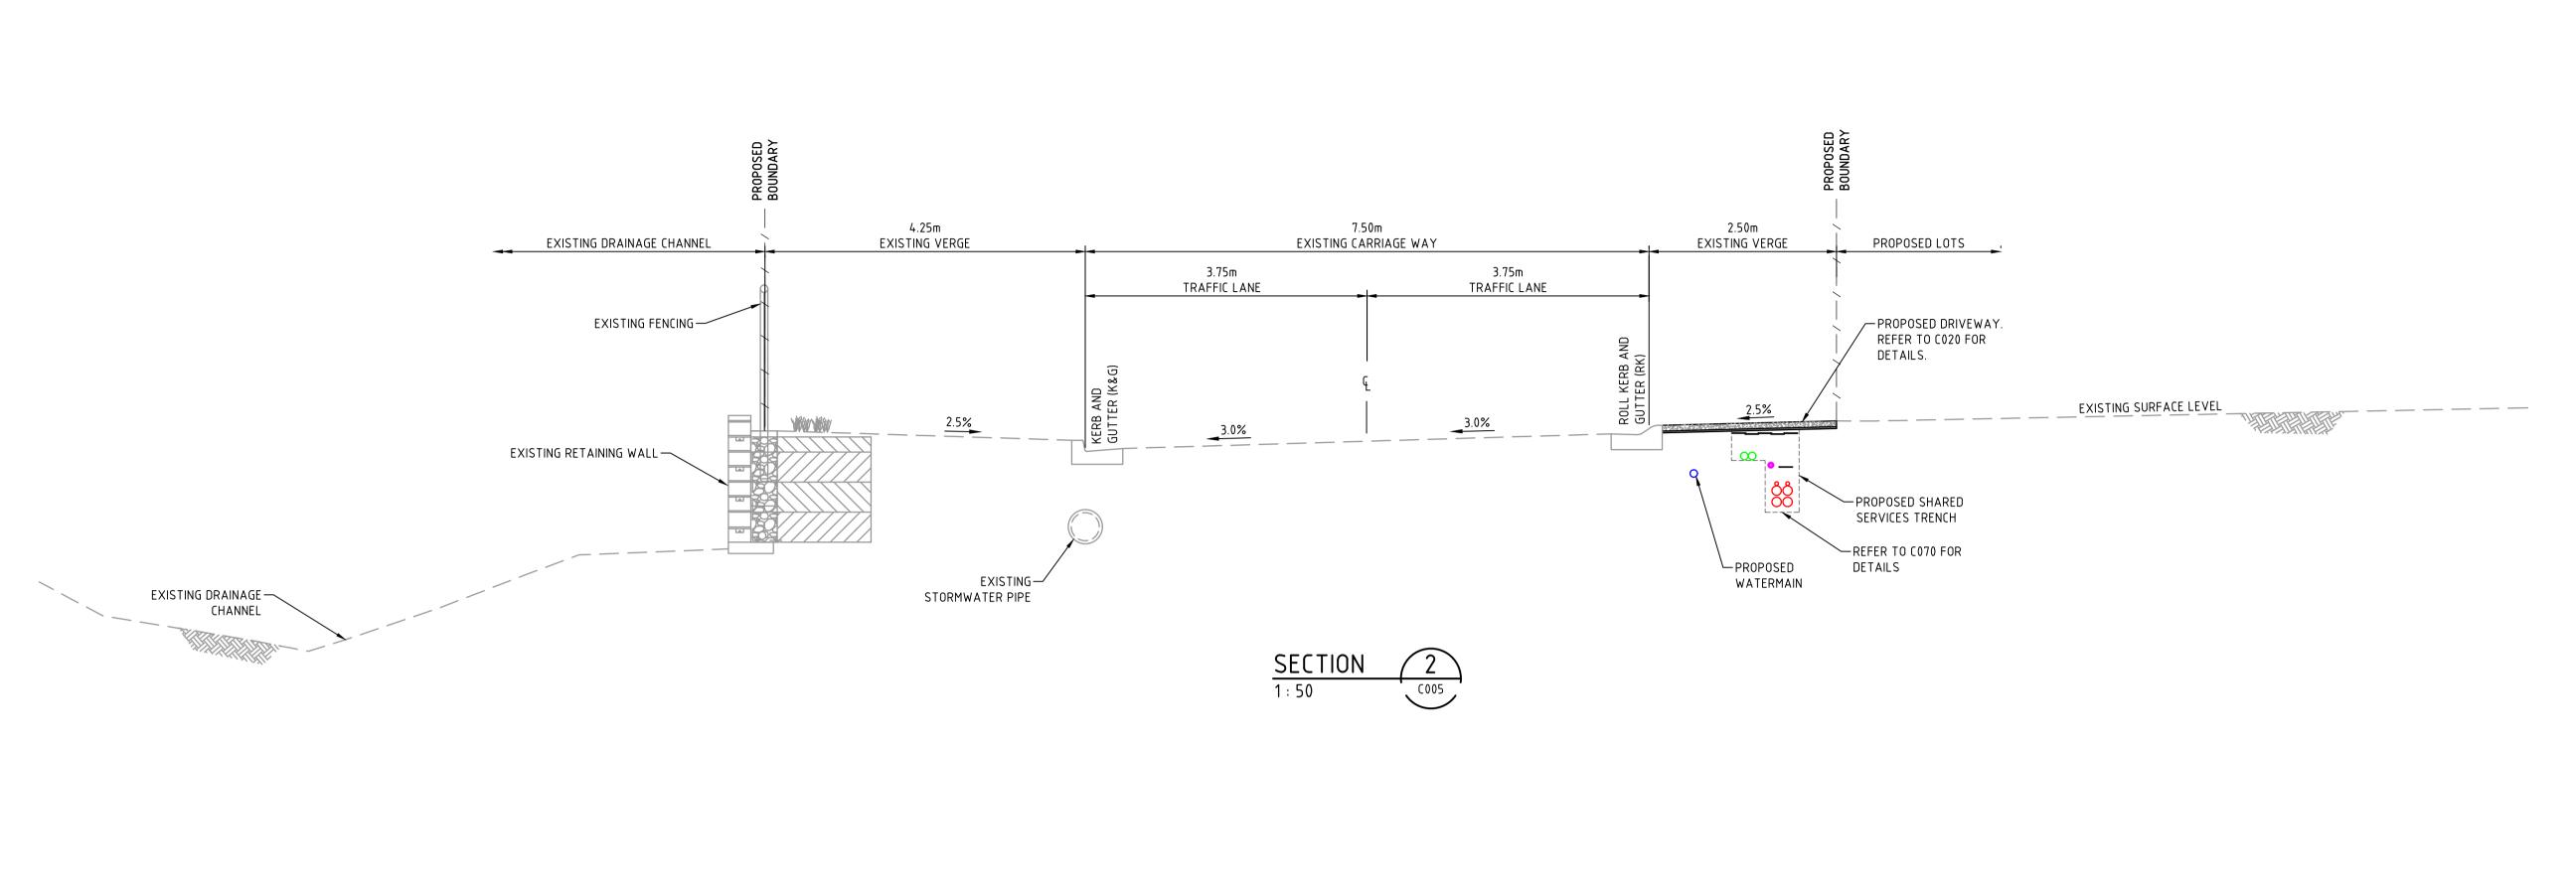
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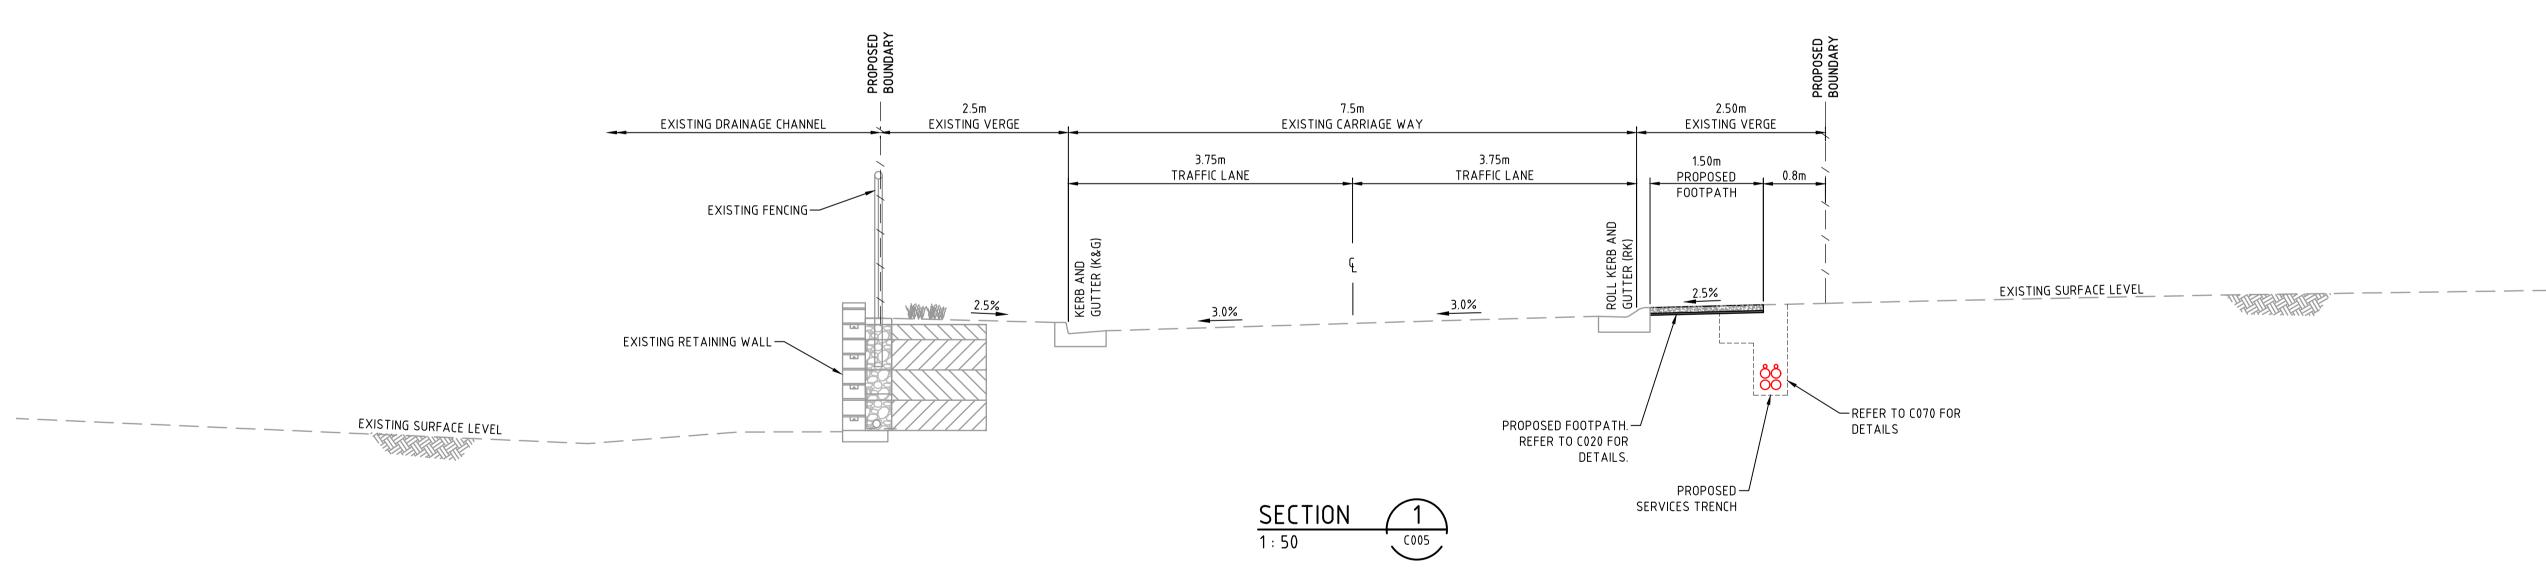
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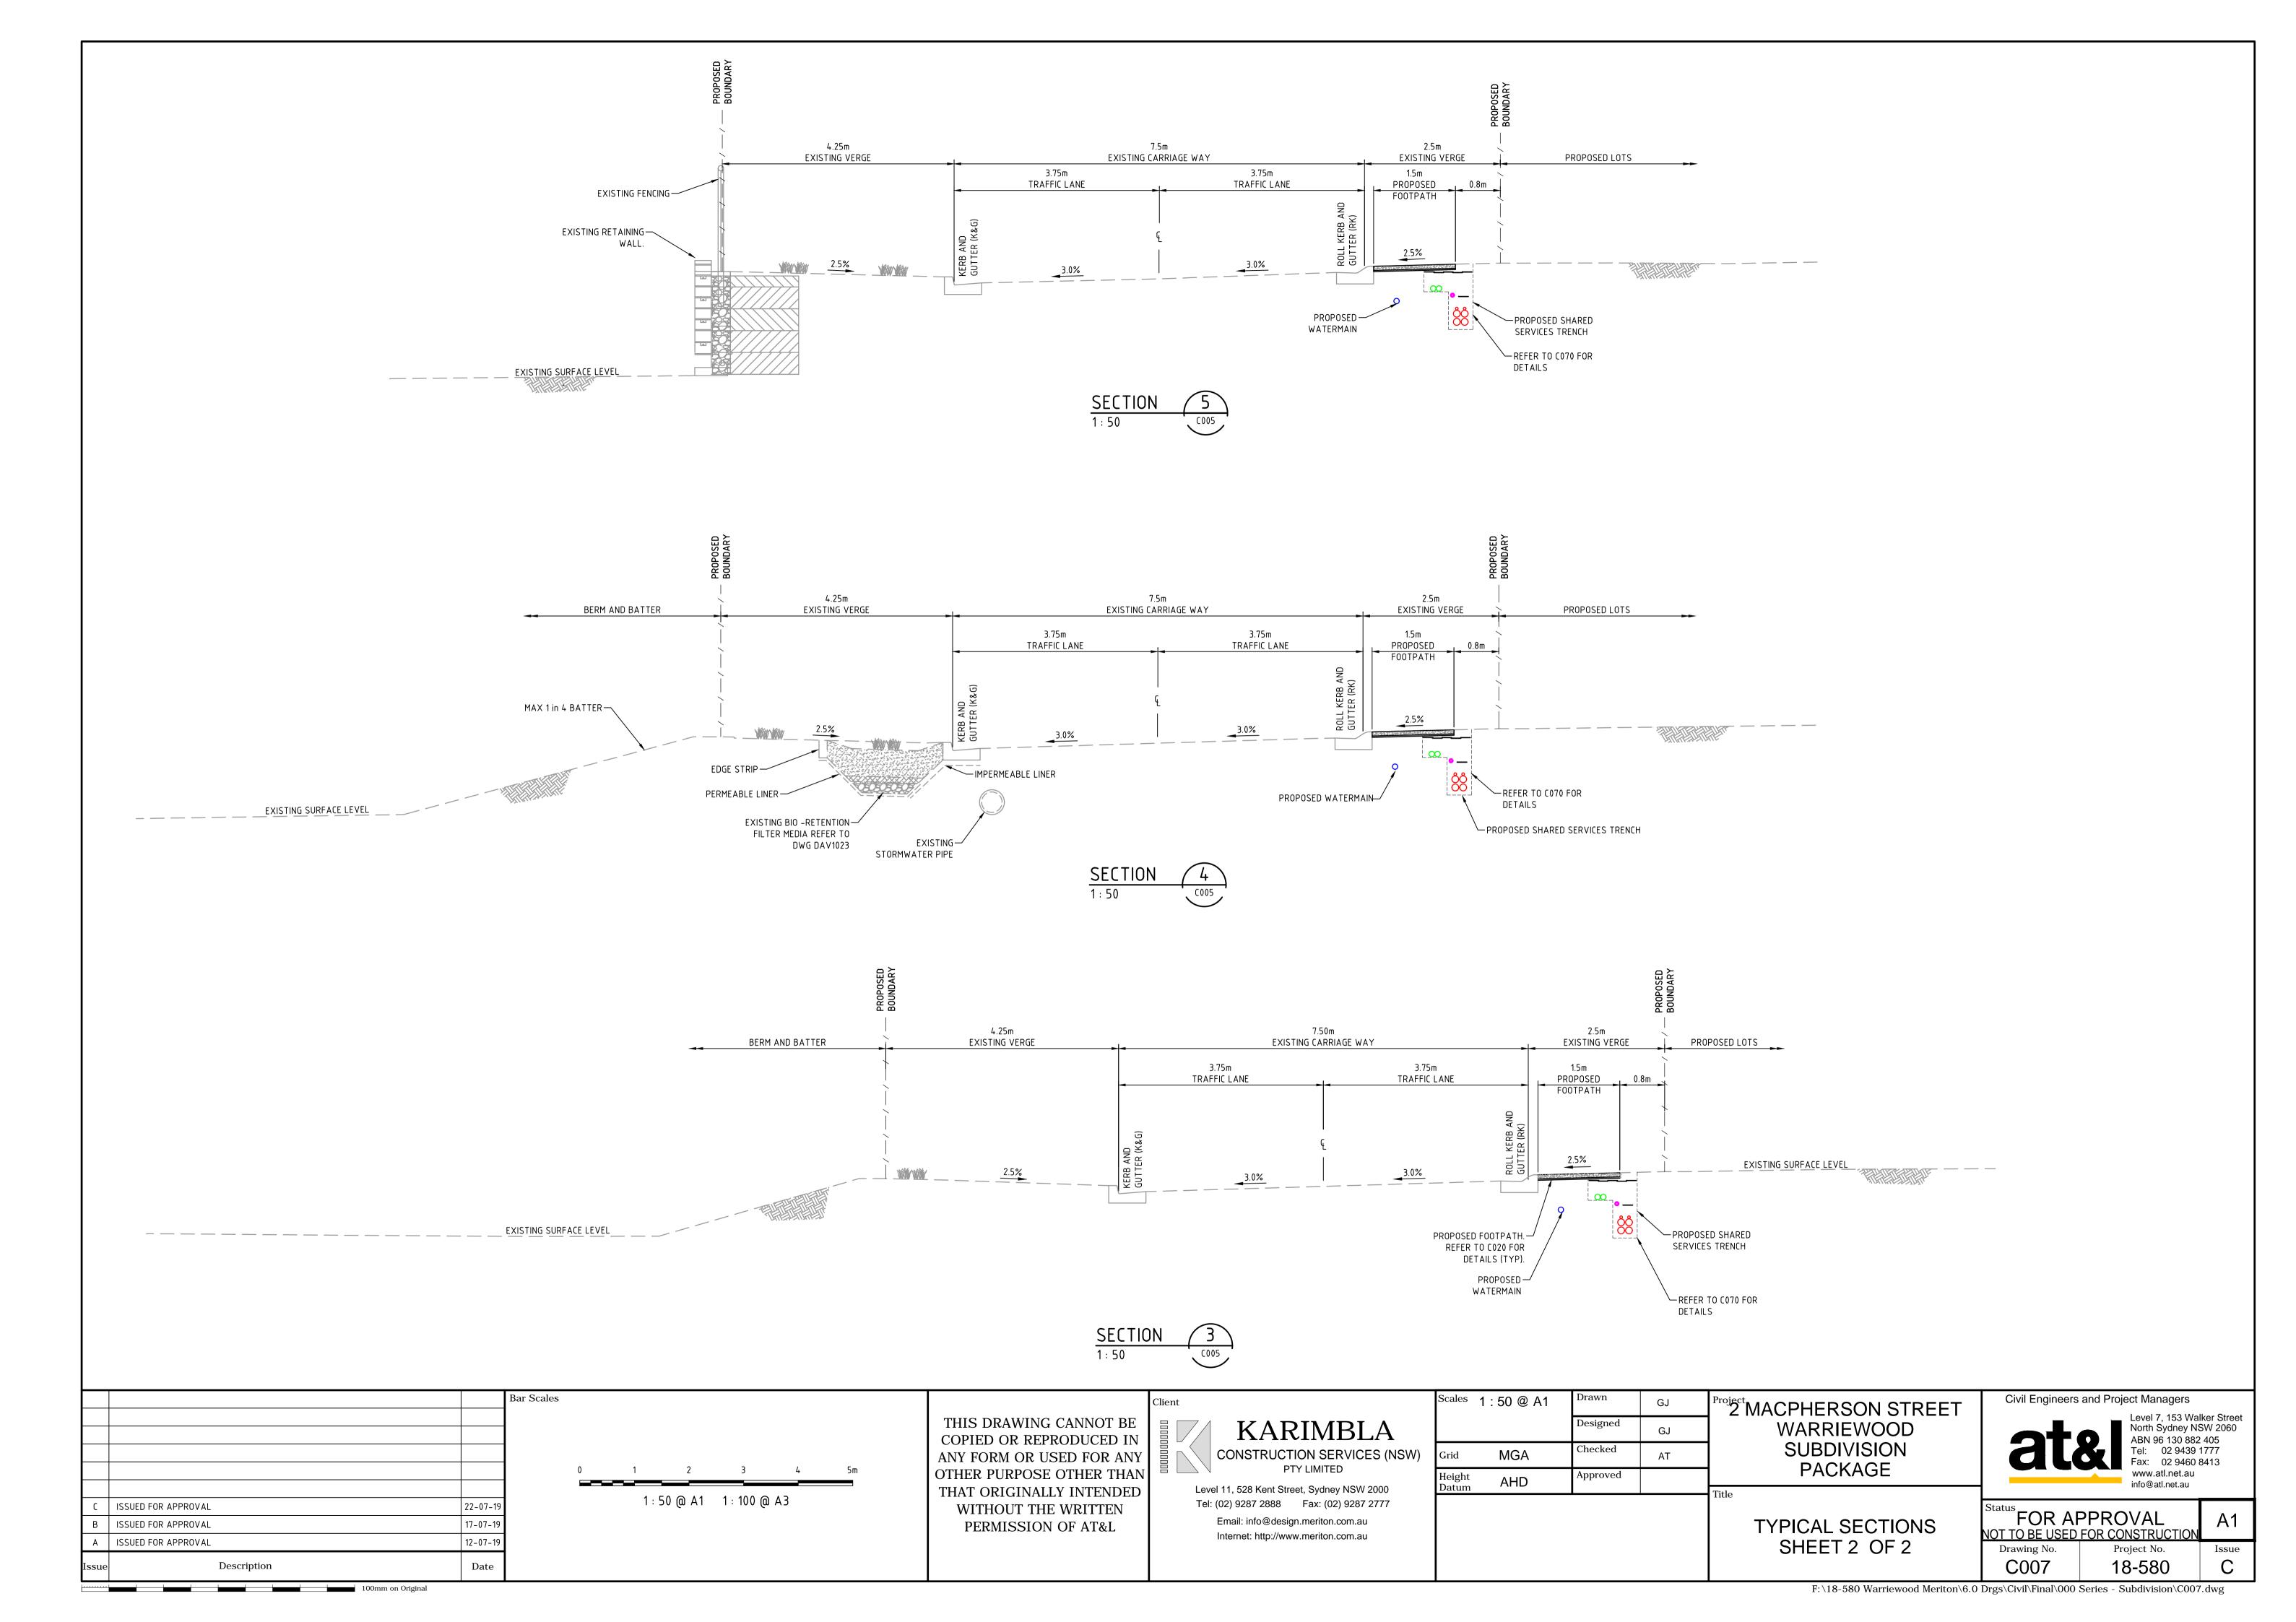
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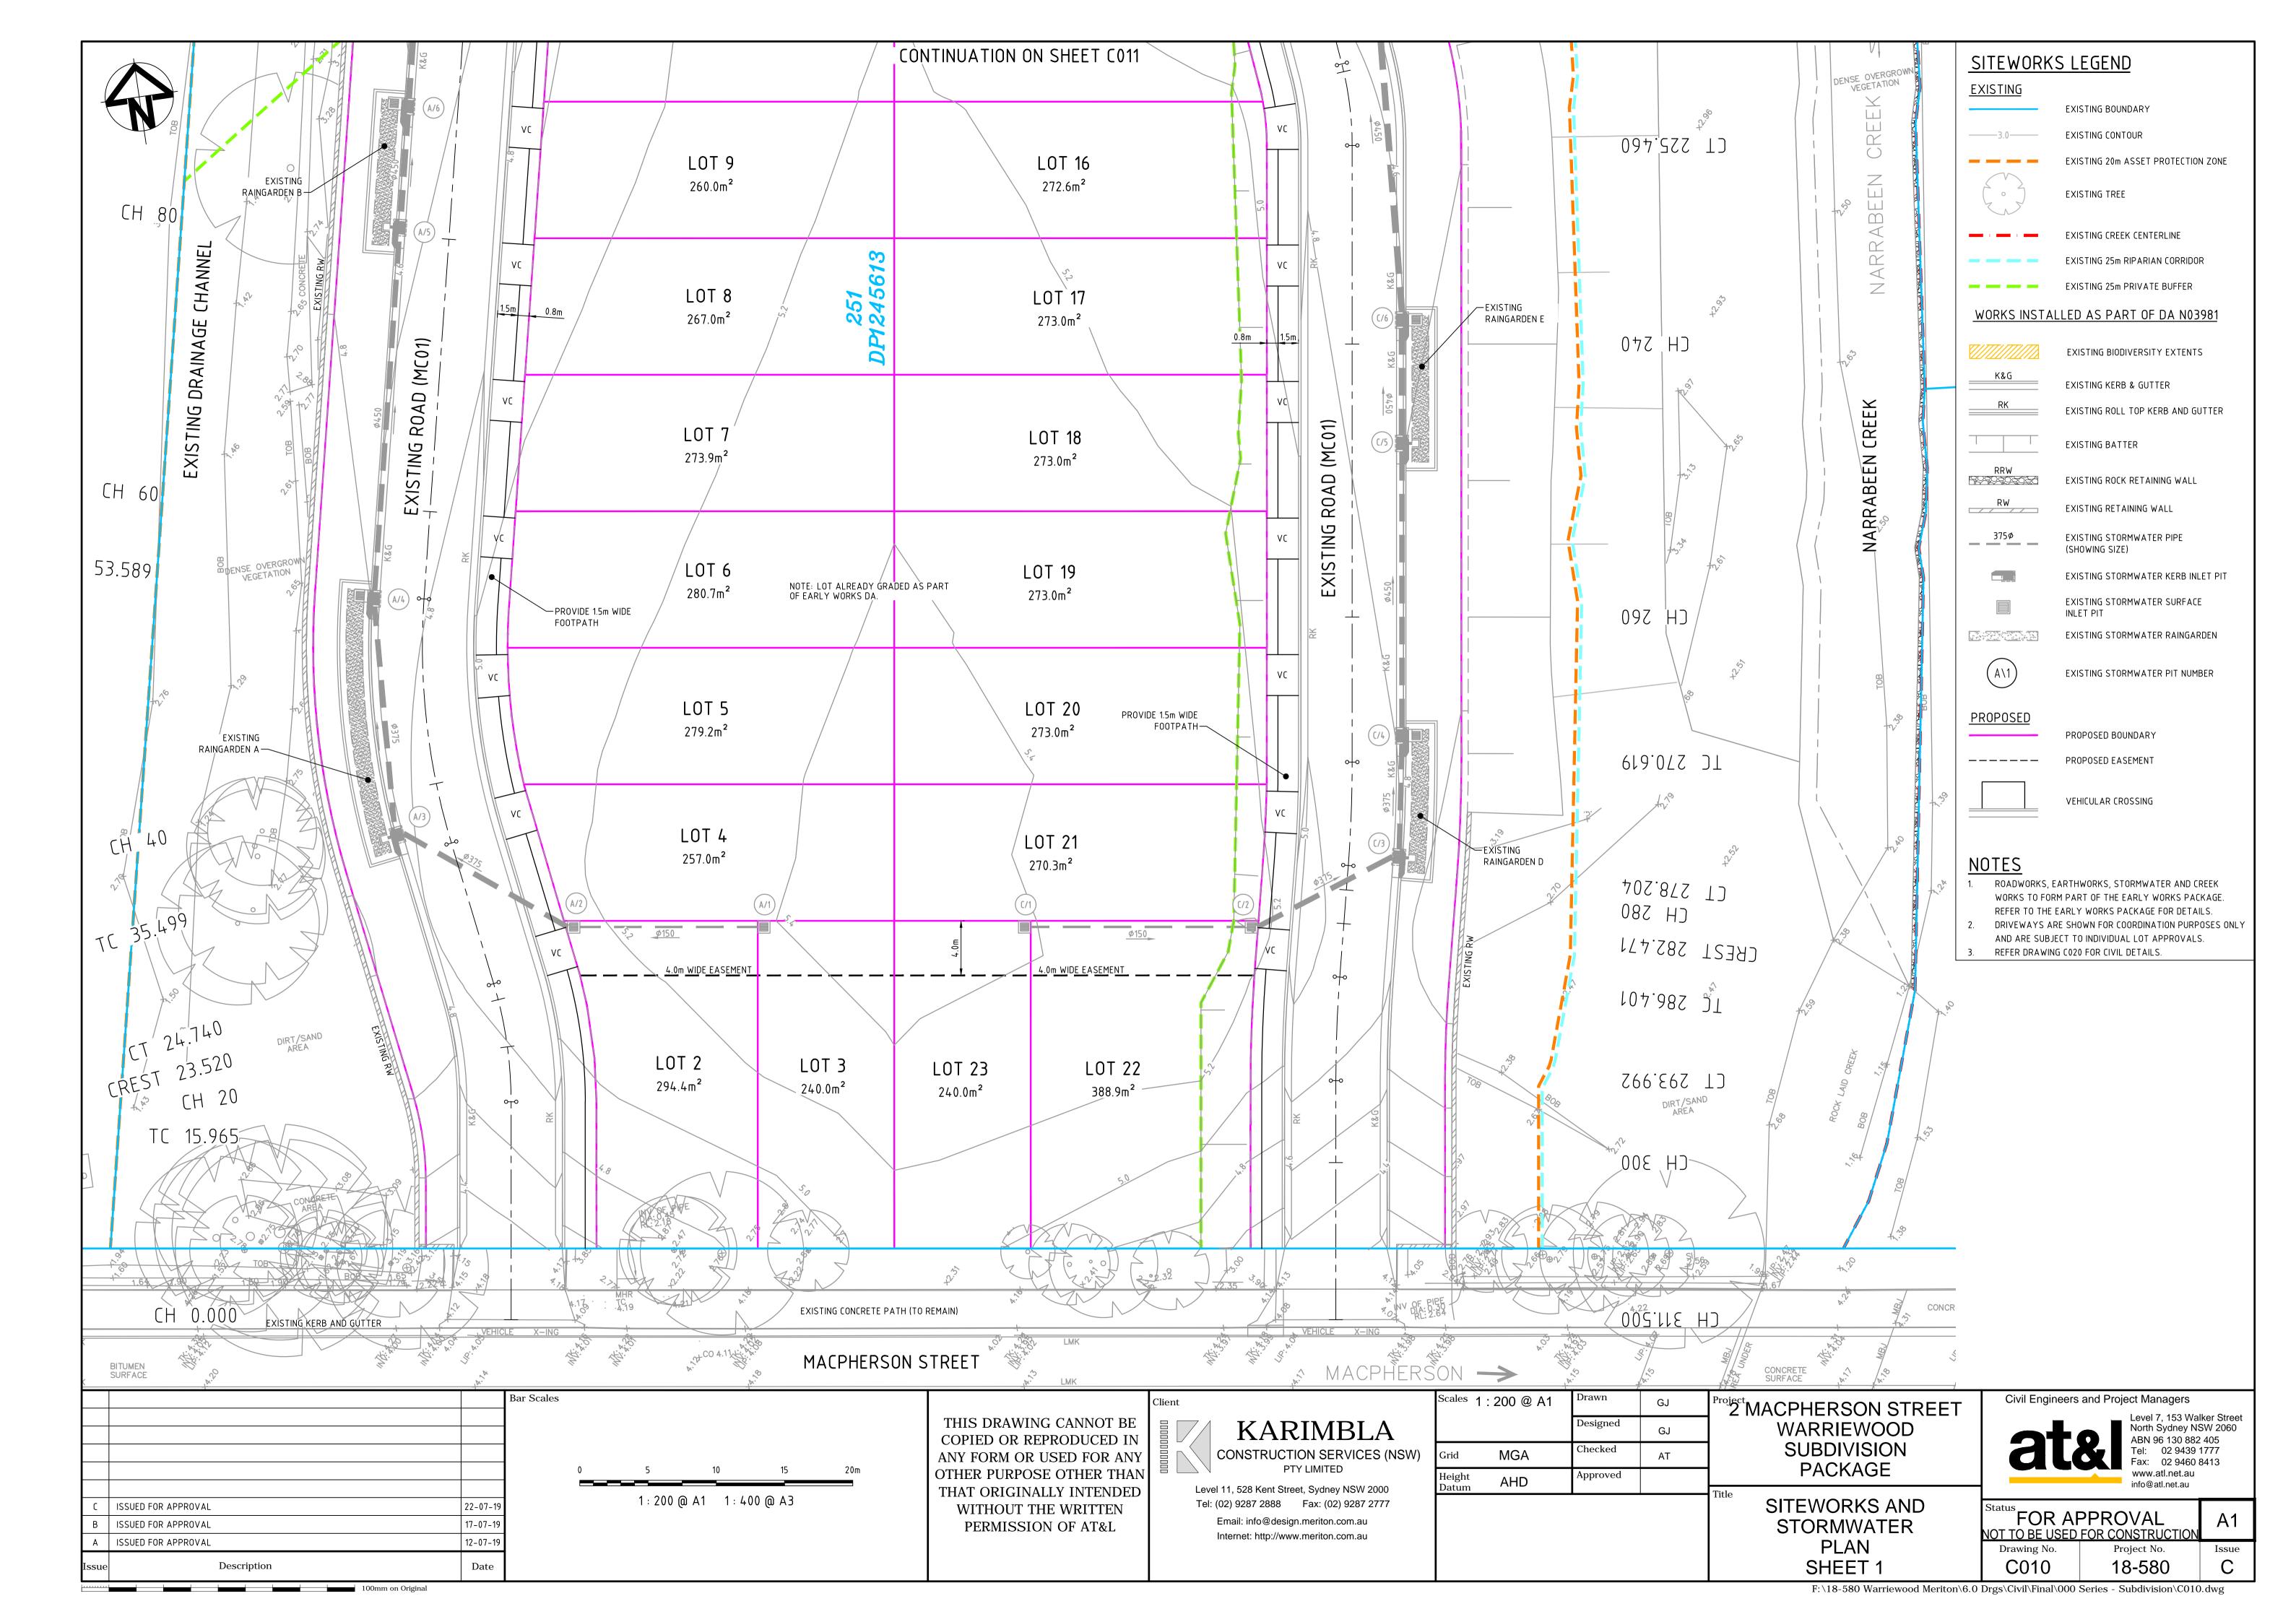








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	7-07-19 5-07-19 2-07-19 Date	1:50 @ A1 1:100 @ A3	WITHOUT THE WRITTEN PERMISSION OF AT&L	Tel: (02) 9287 2888 Fax: (02) 9287 2777 Email: info@design.meriton.com.au Internet: http://www.meriton.com.au				SHEET 1 OF 2	FOR APPROVAL NOT TO BE USED FOR CONSTRUCTIO Drawing No. Project No. C006 18-580 Drgs\Civil\Final\000 Series - Subdivision\C00	Issue D




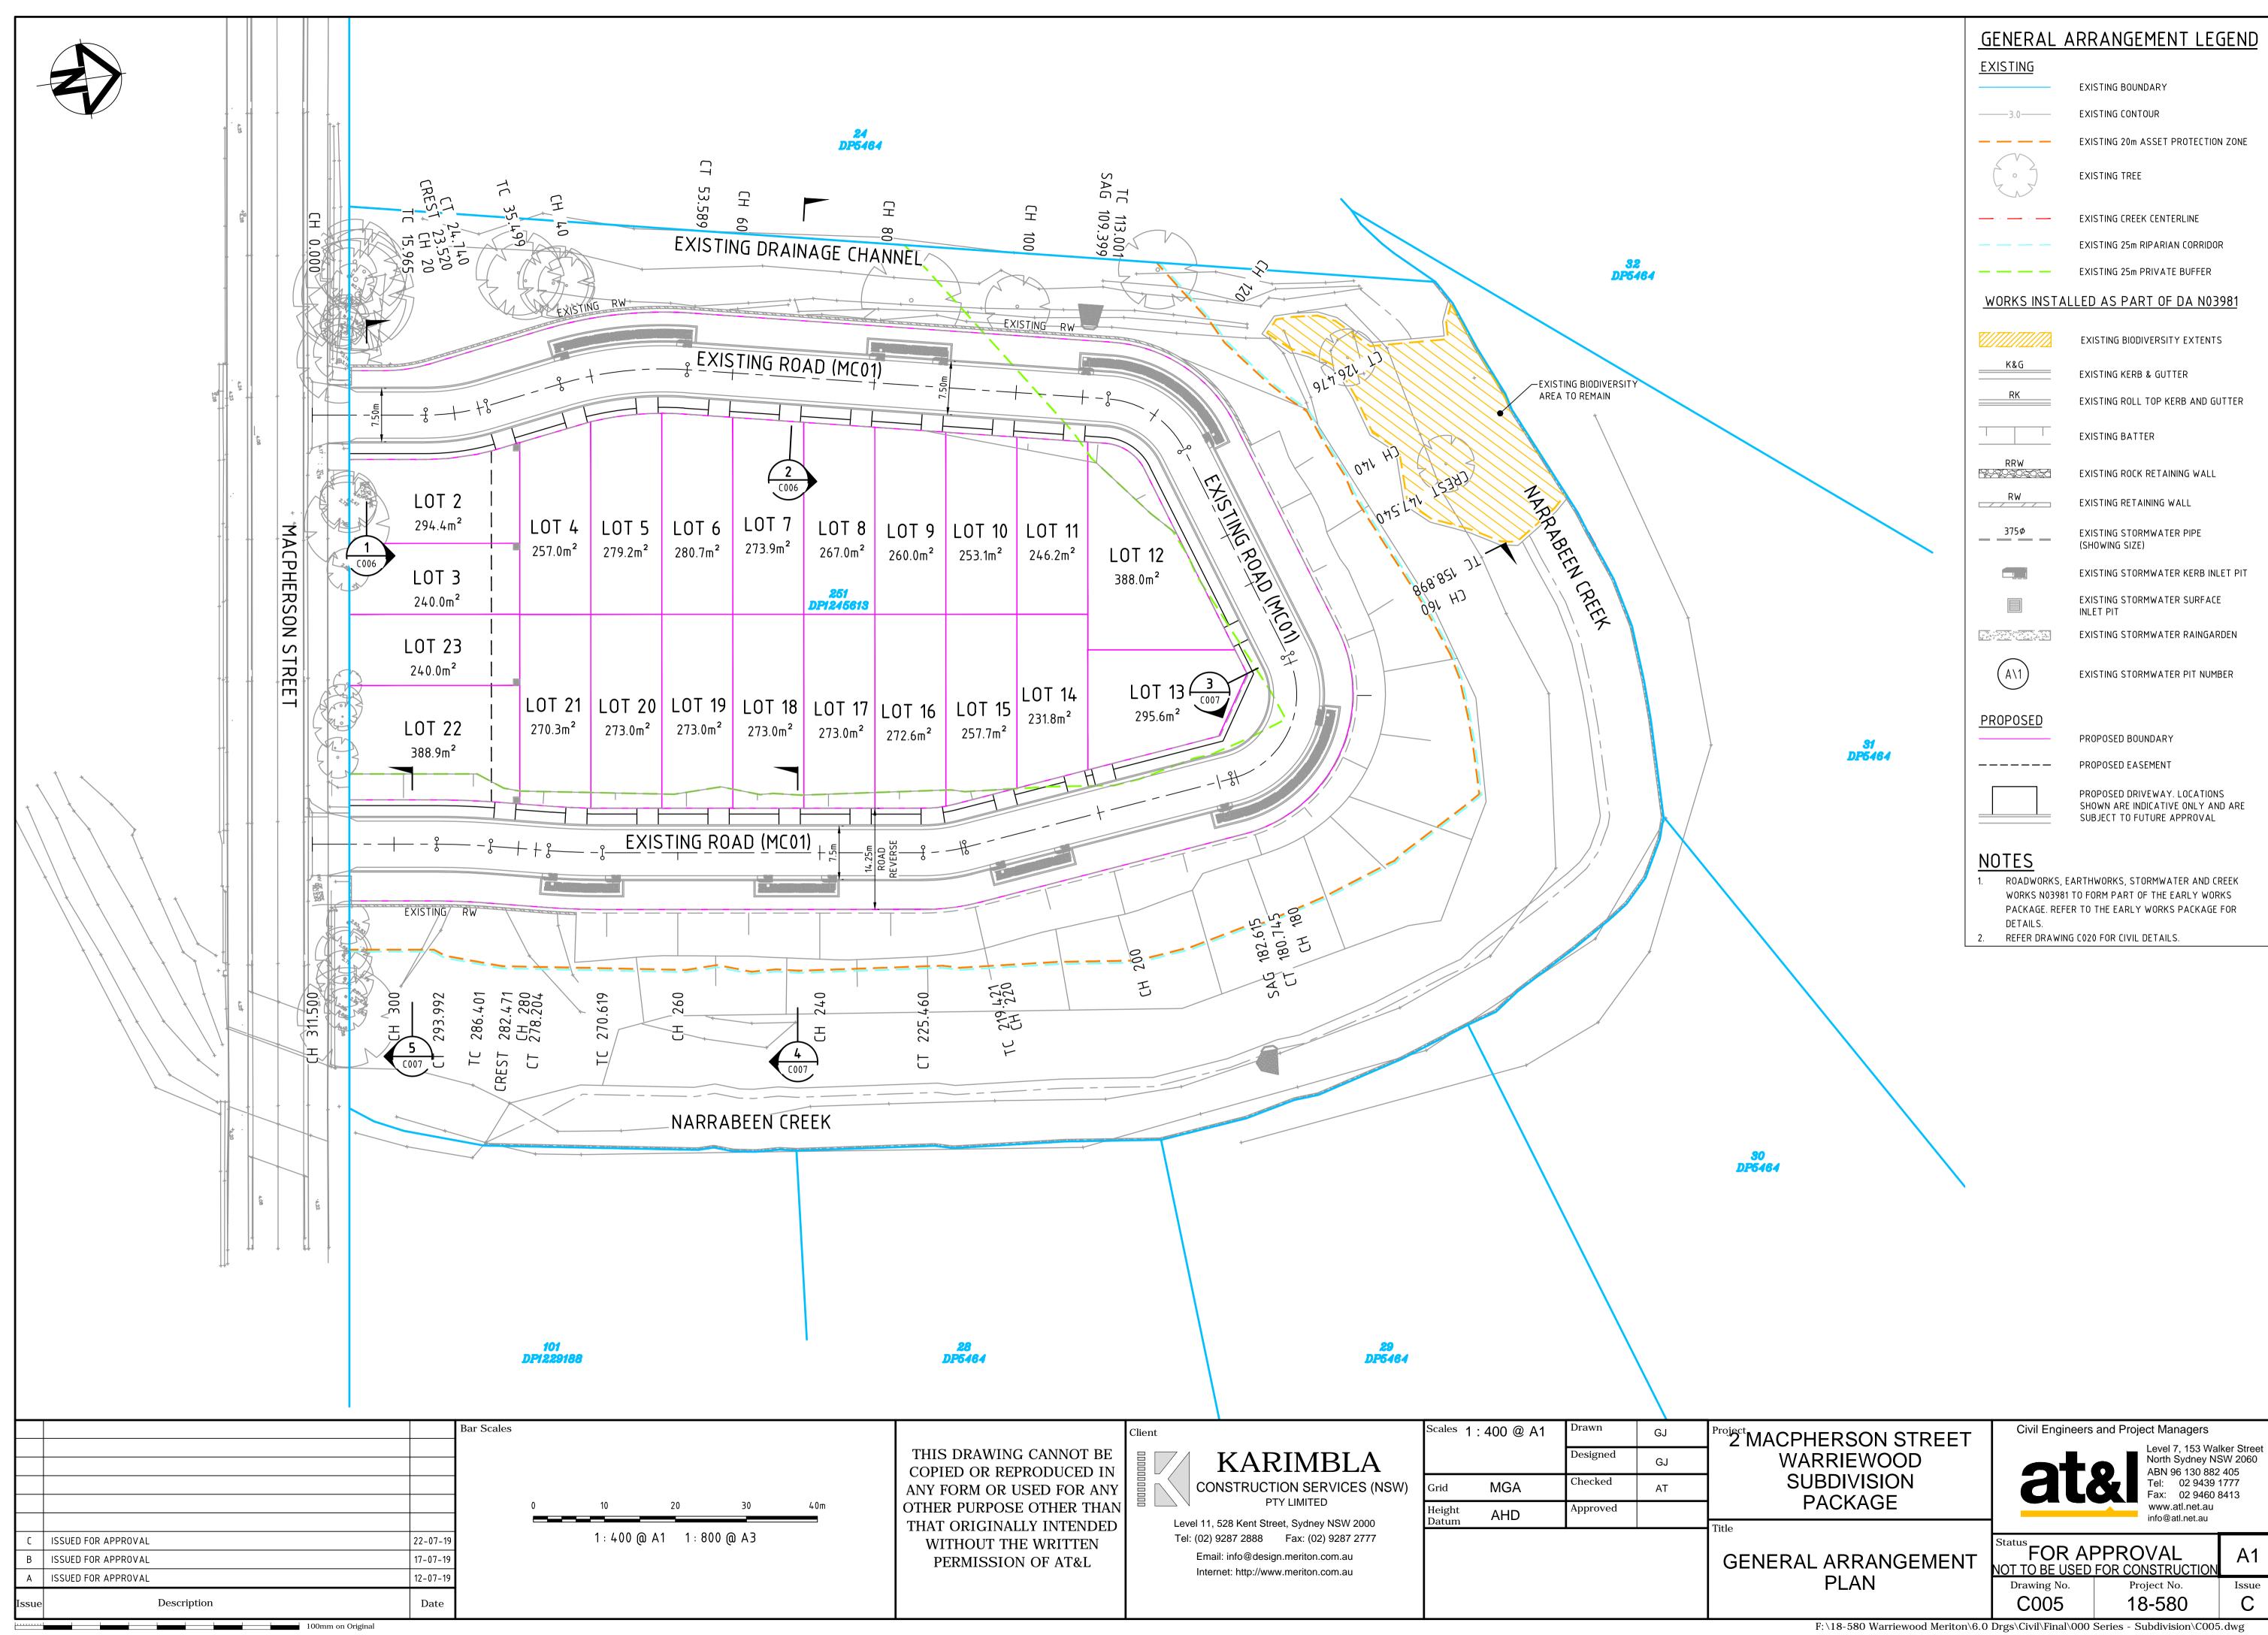

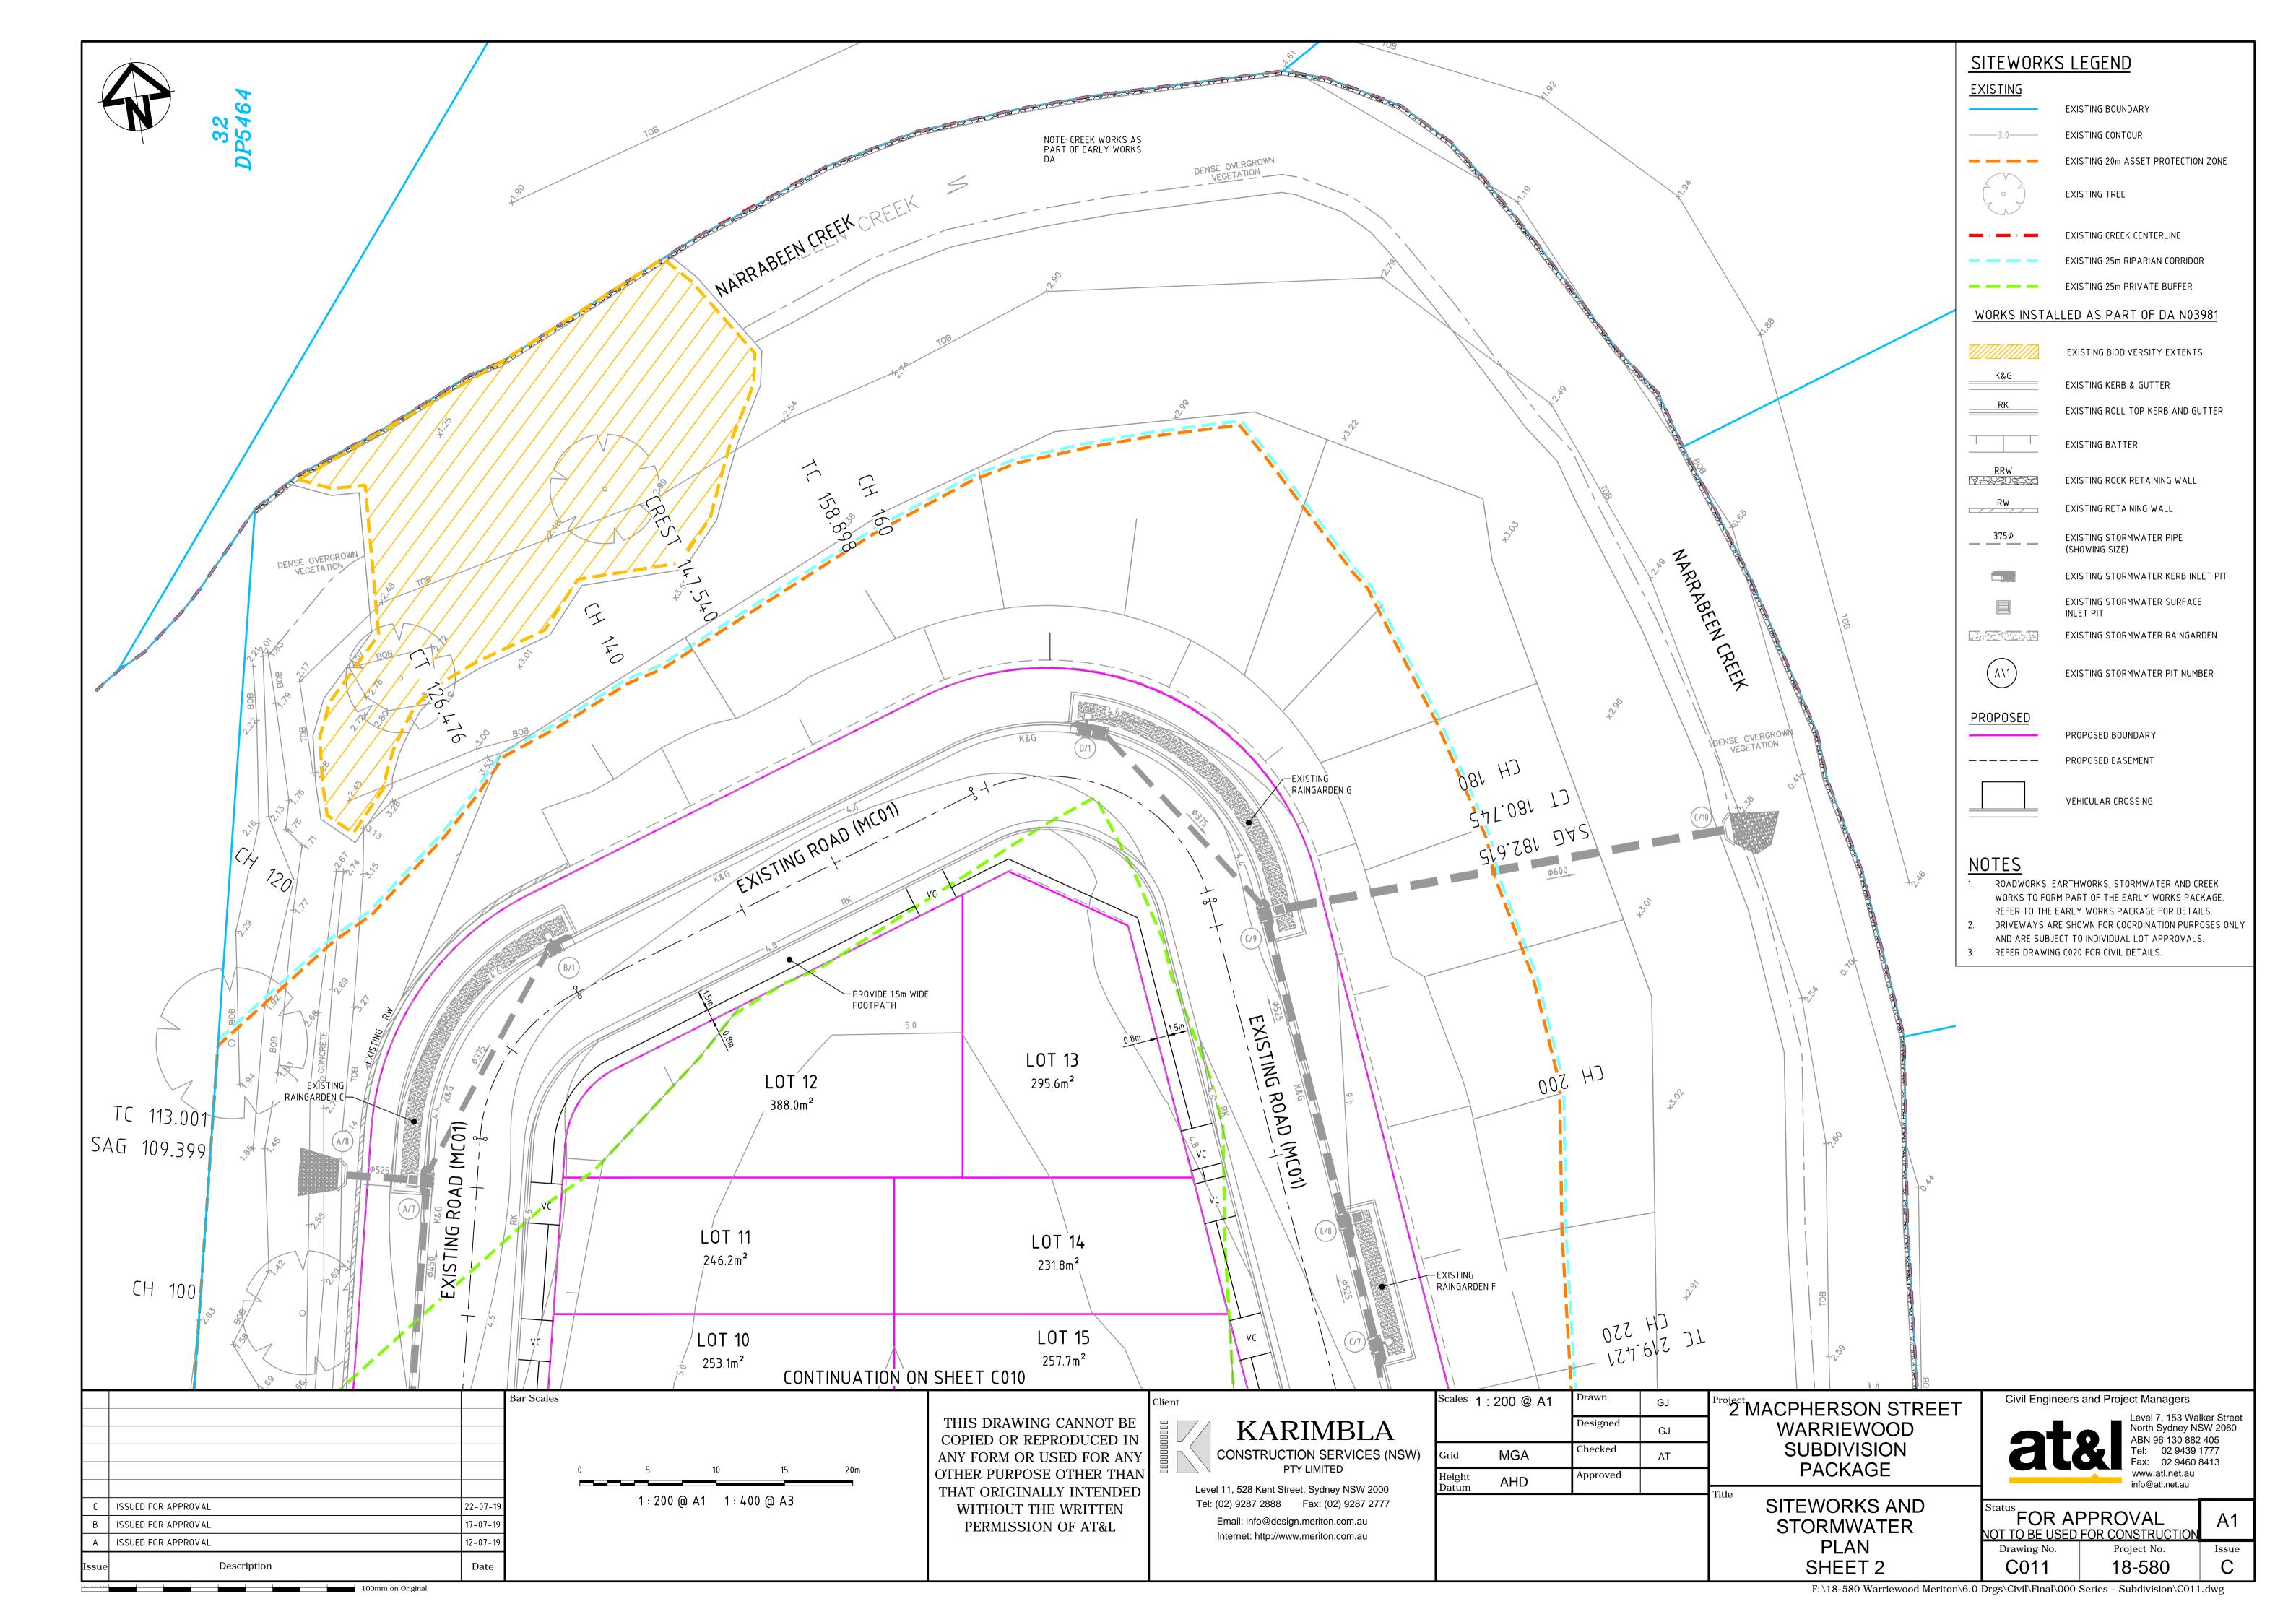


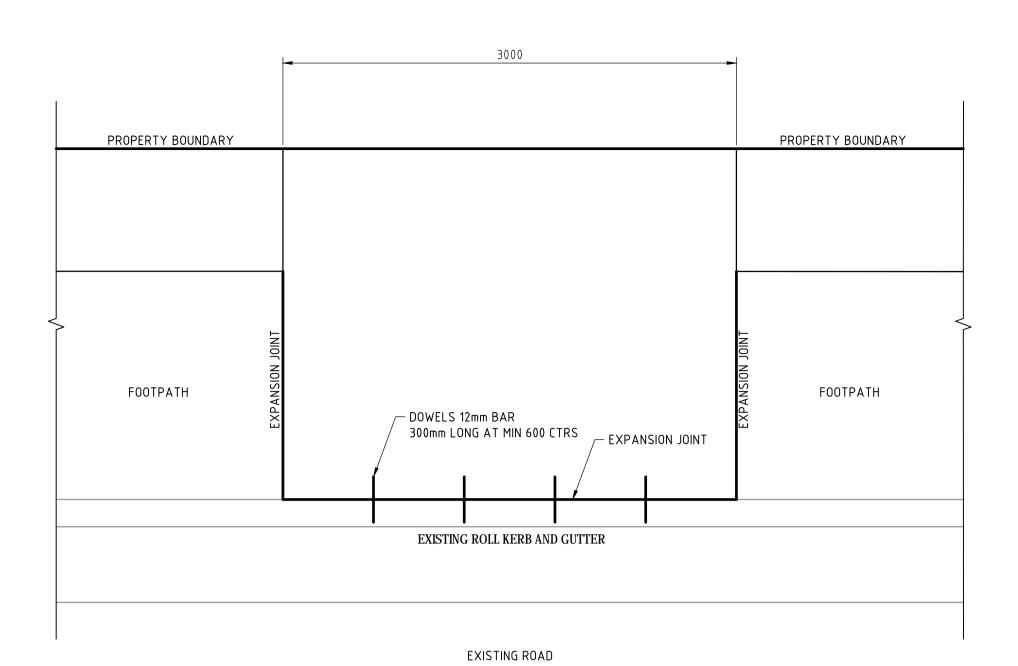

PROPOSED DRIVEWAY PLAN

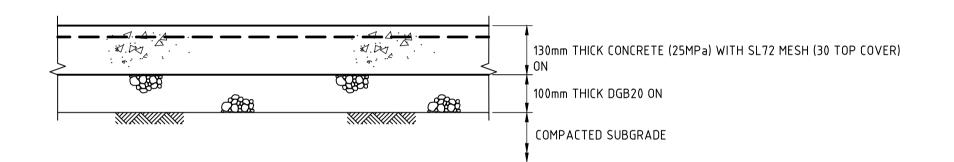


PROPOSED DRIVEWAY PAVEMENT DETAIL

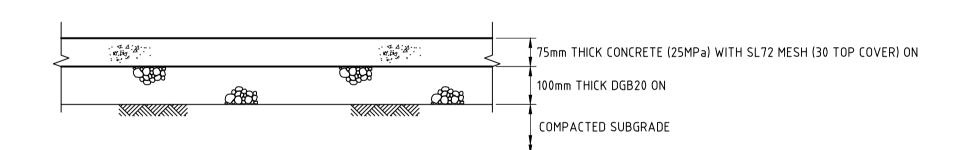

PROPOSED FOOTPATH PAVEMENT DETAIL

REFER TO DRAWING CO2 FOR JOINT DETAILS

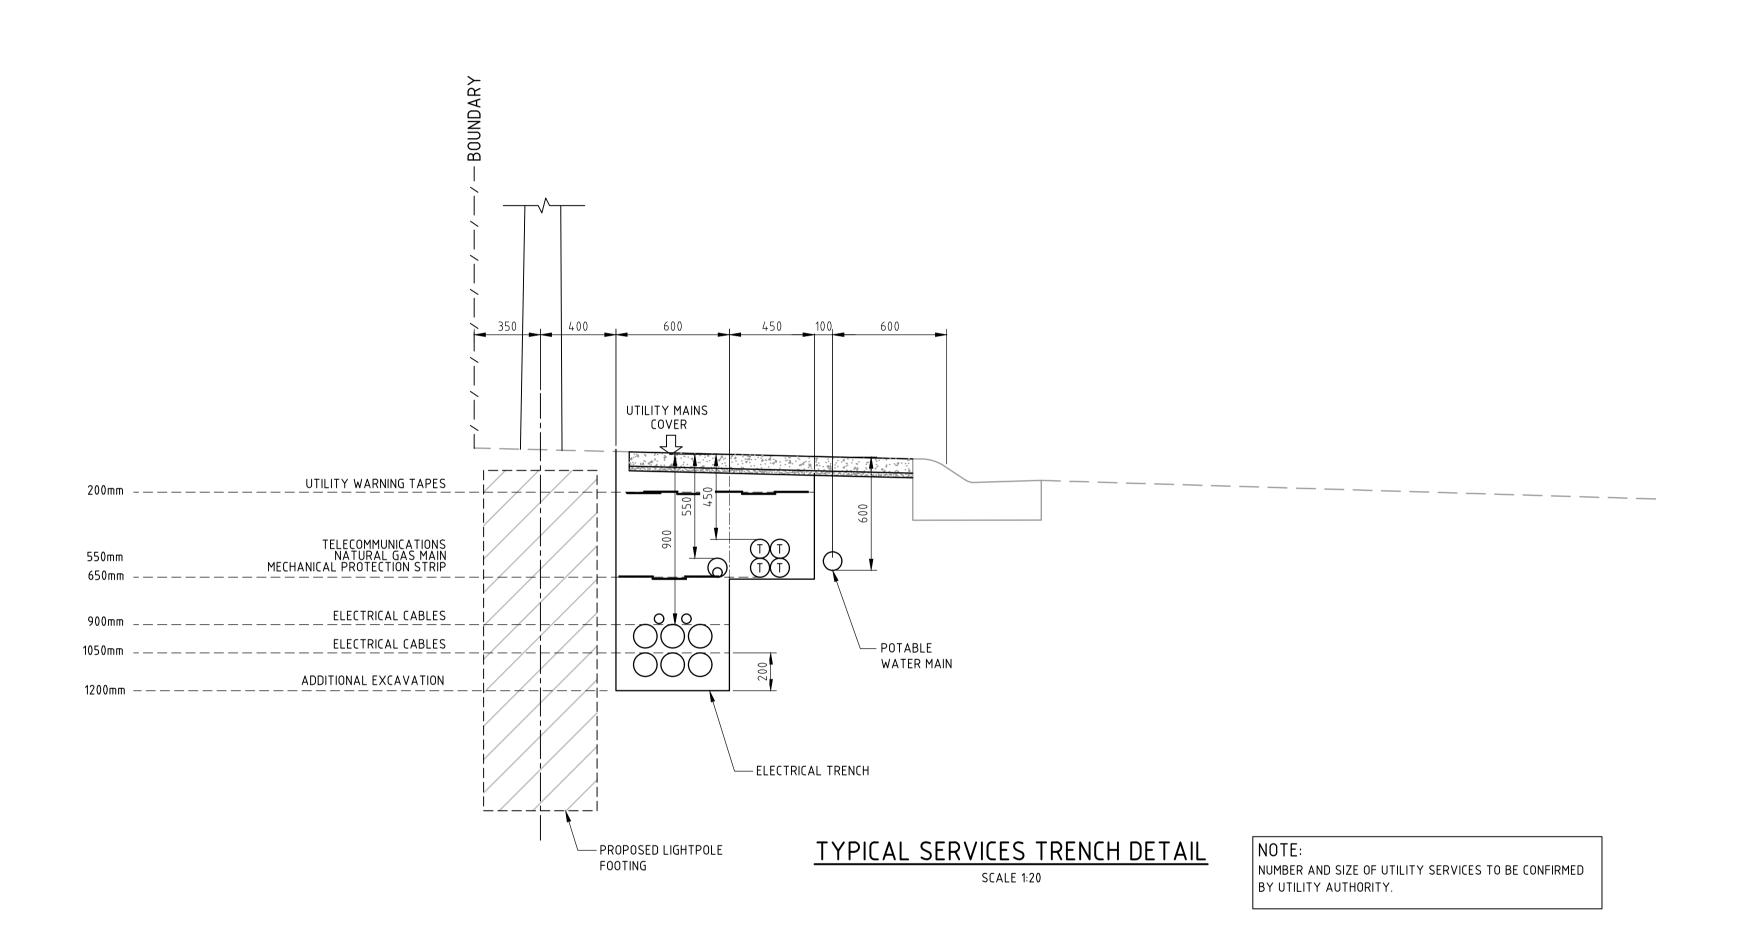

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Height Datum	AHD	Approved		
Datum				Title

^{roject}MACPHERSON STREET WARRIEWOOD SUBDIVISION PACKAGE

SITEWORKS


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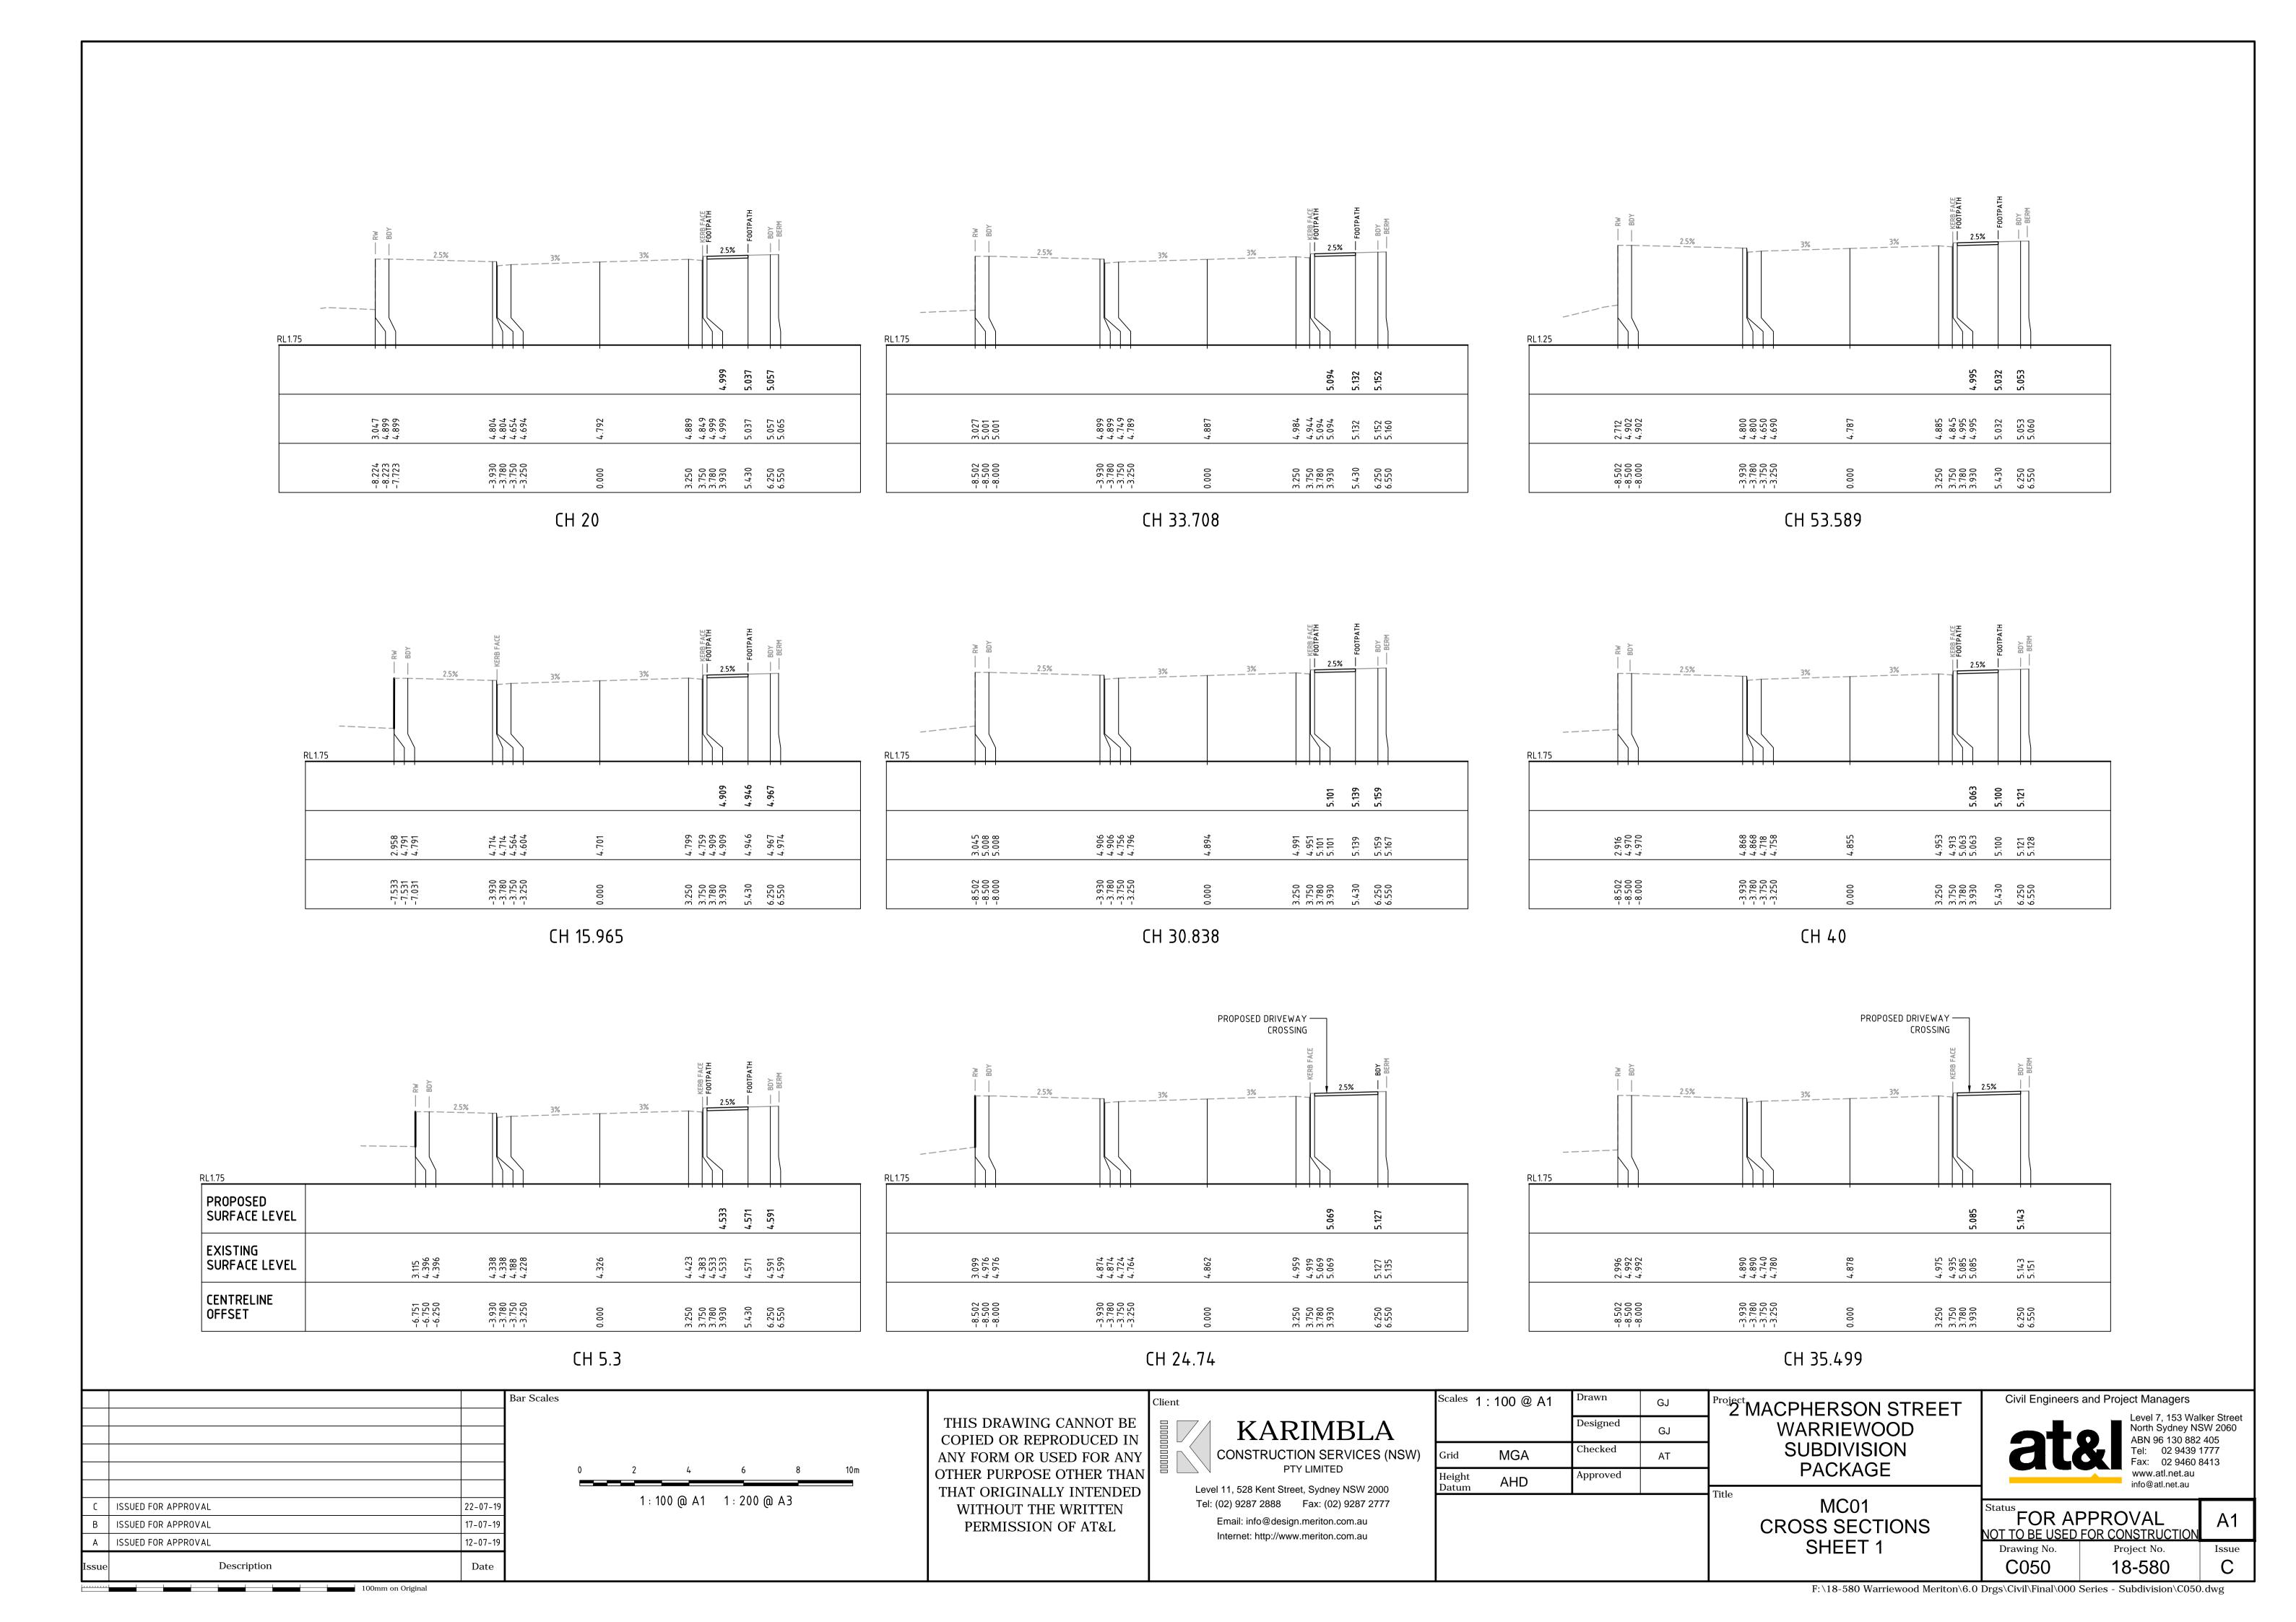
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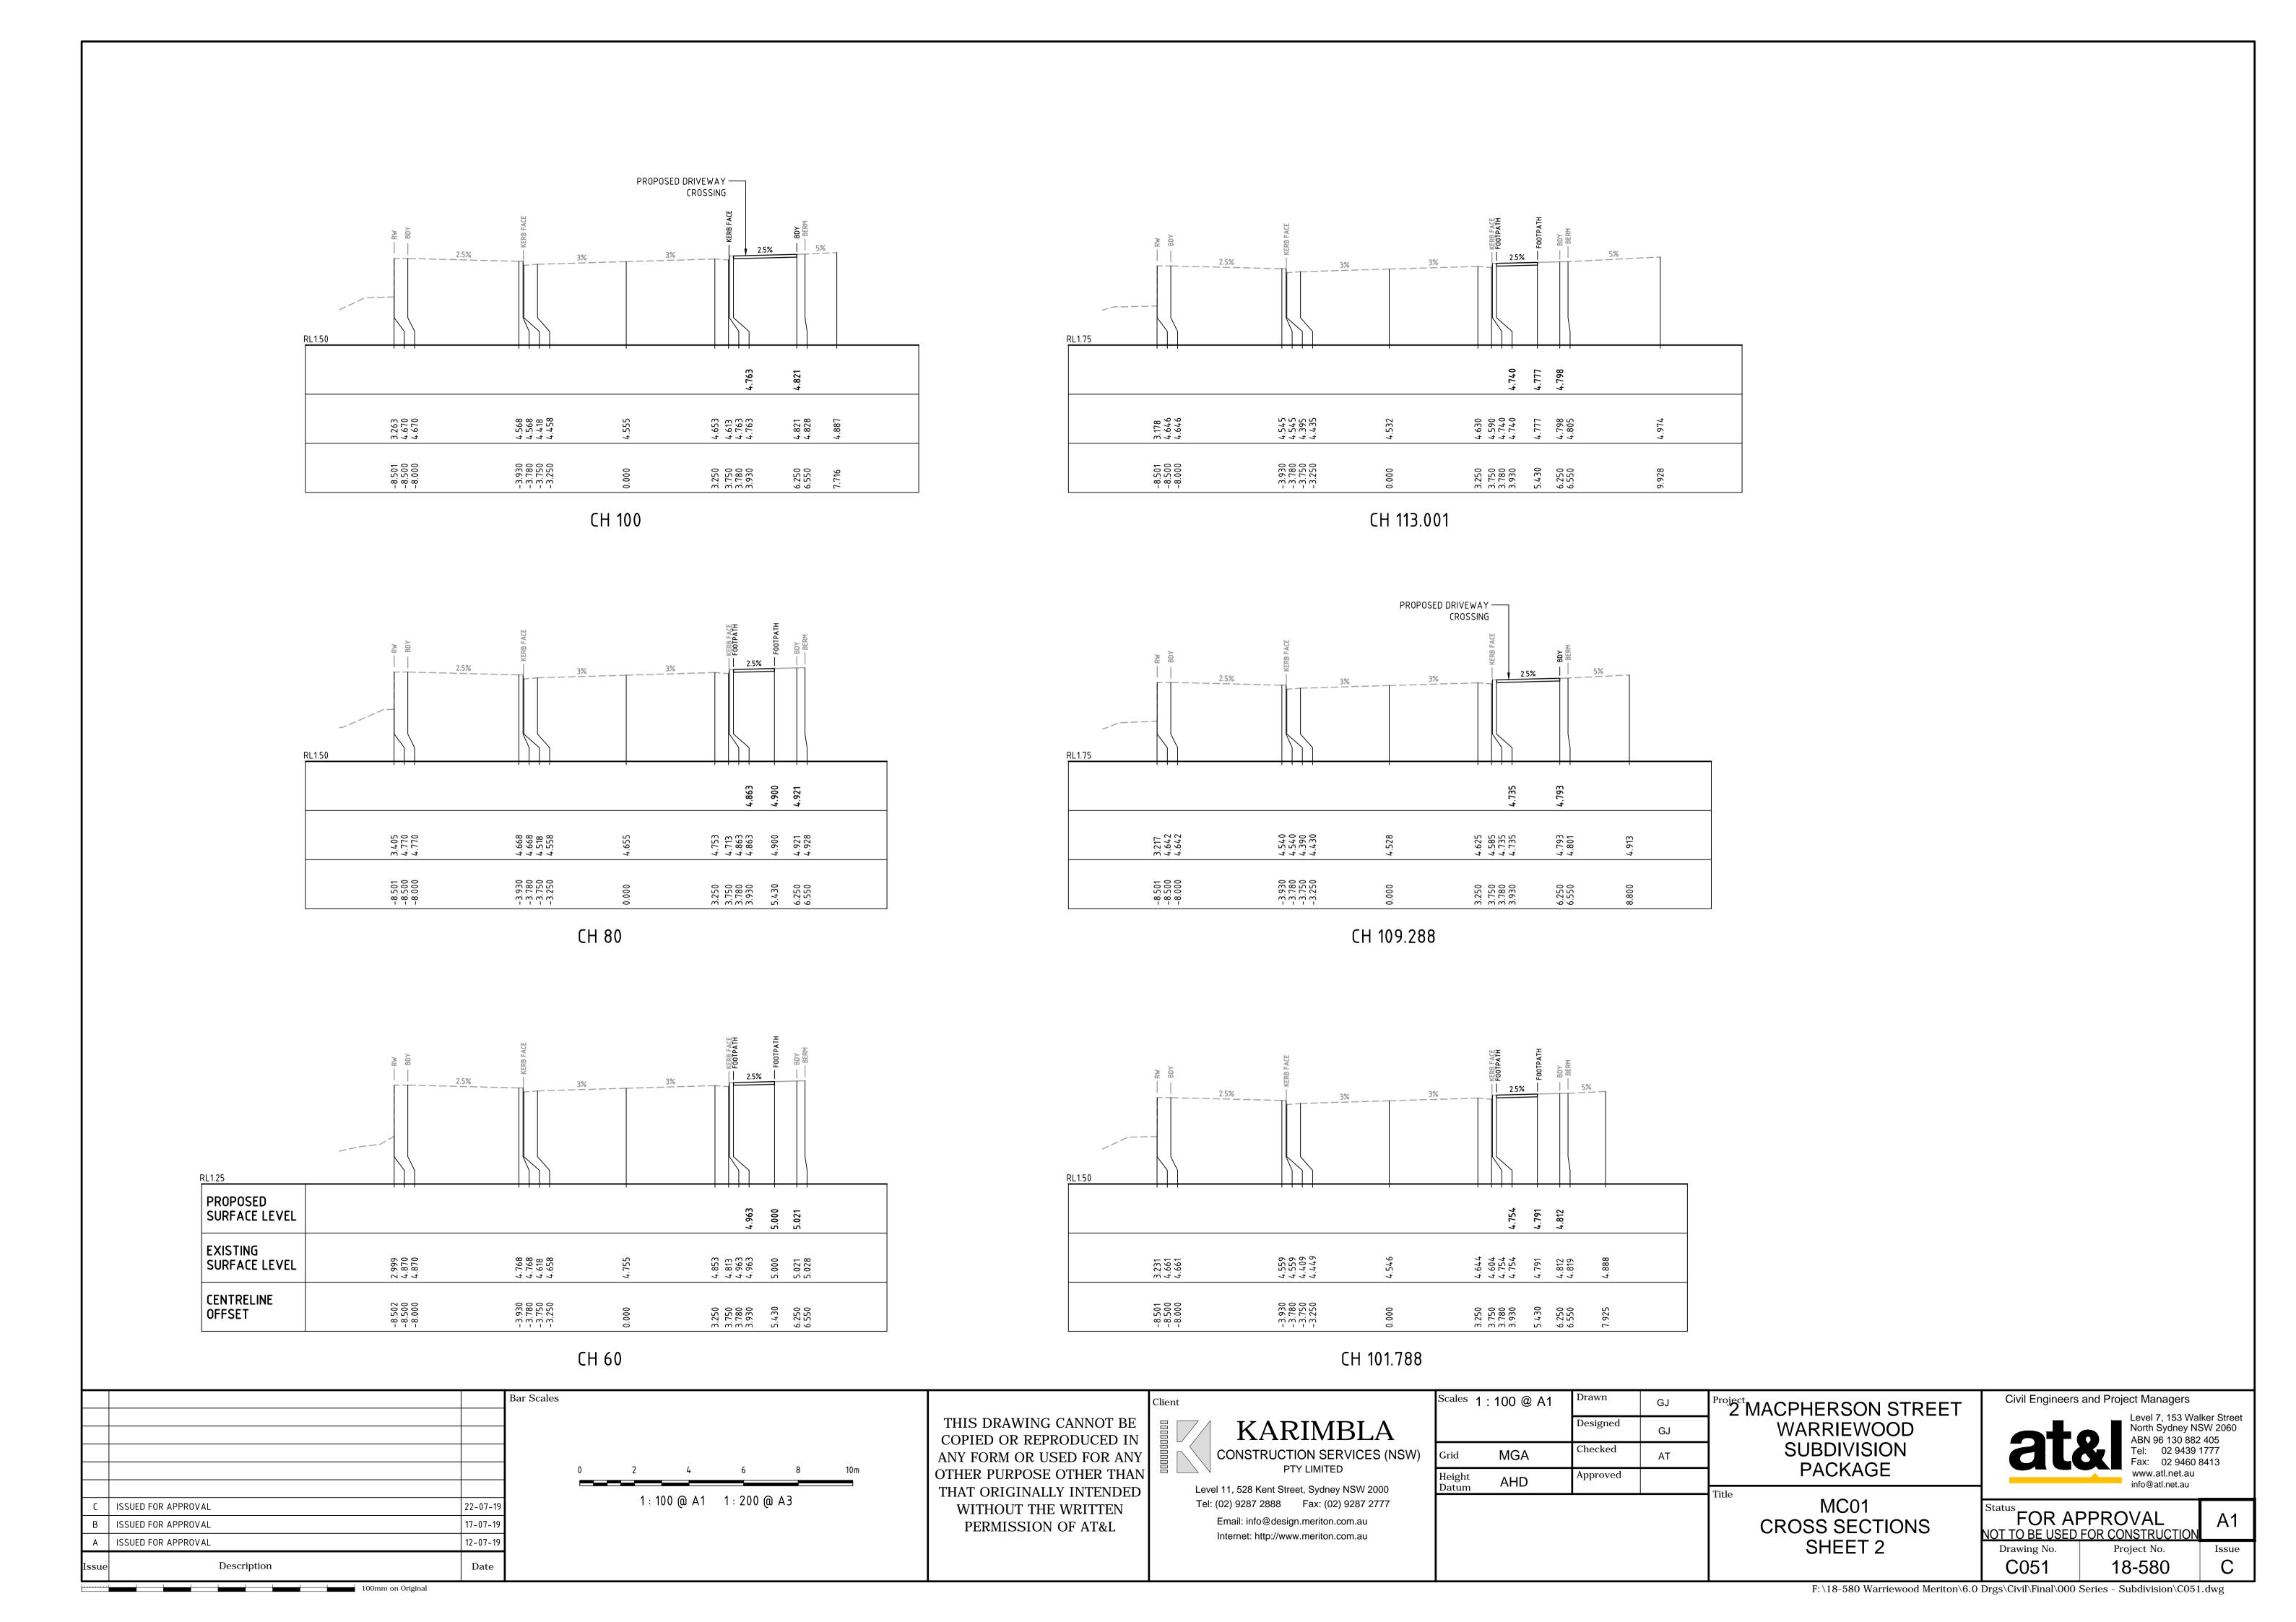
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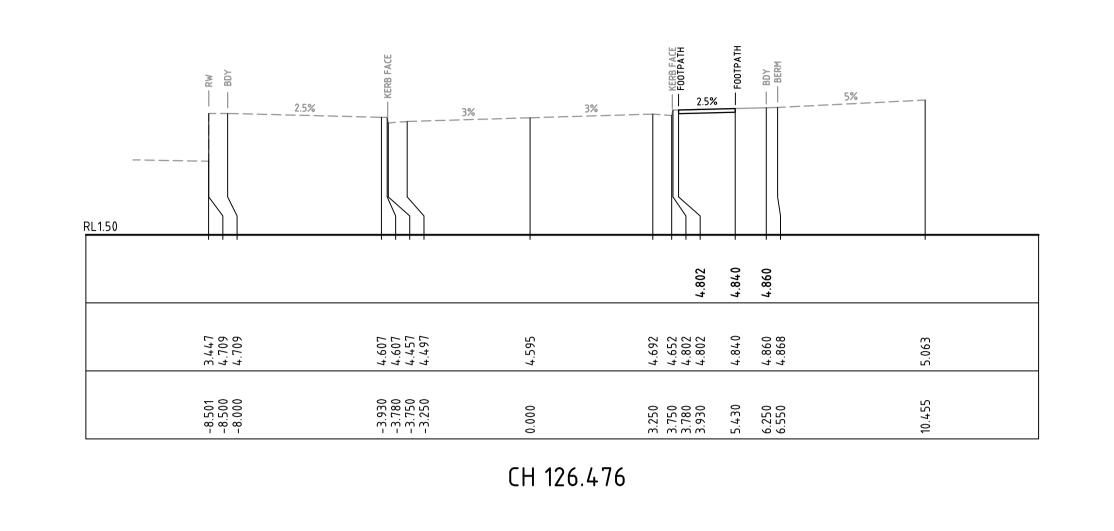
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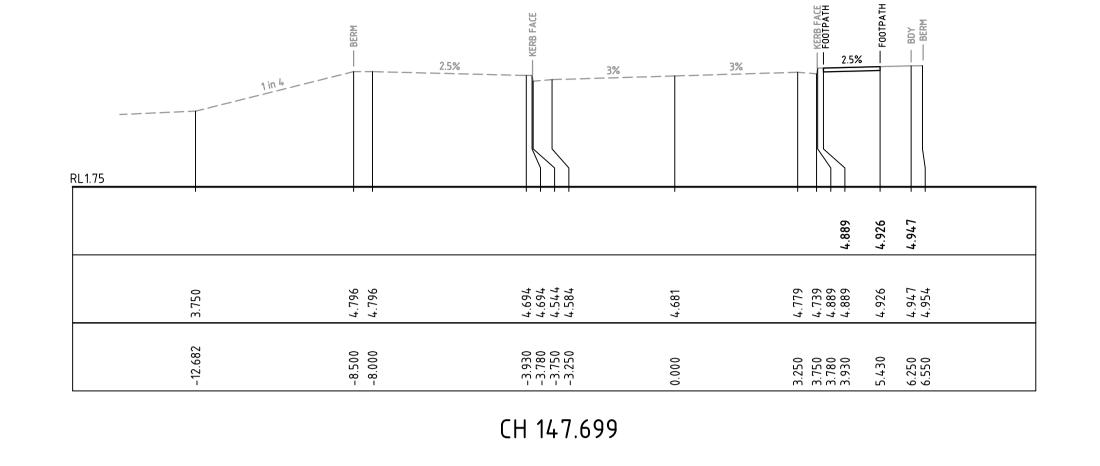
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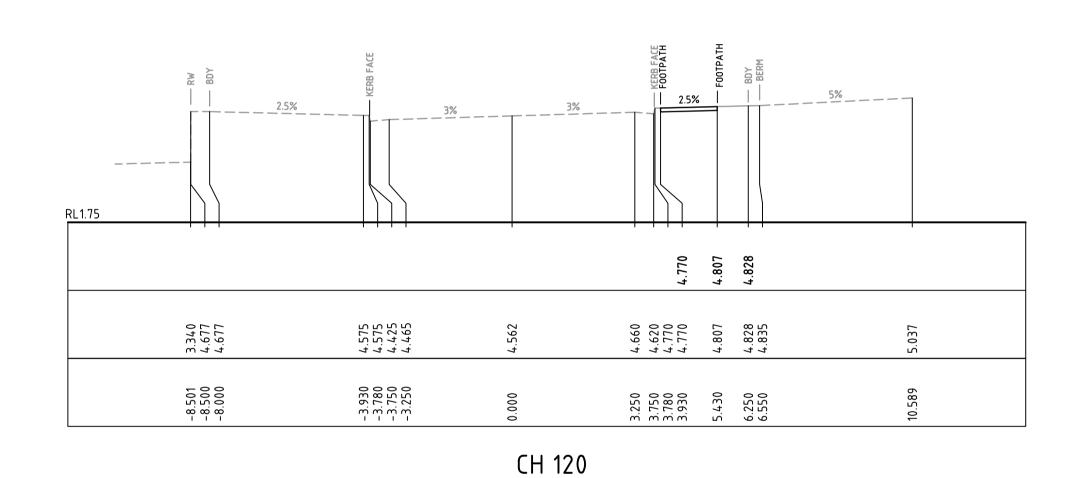













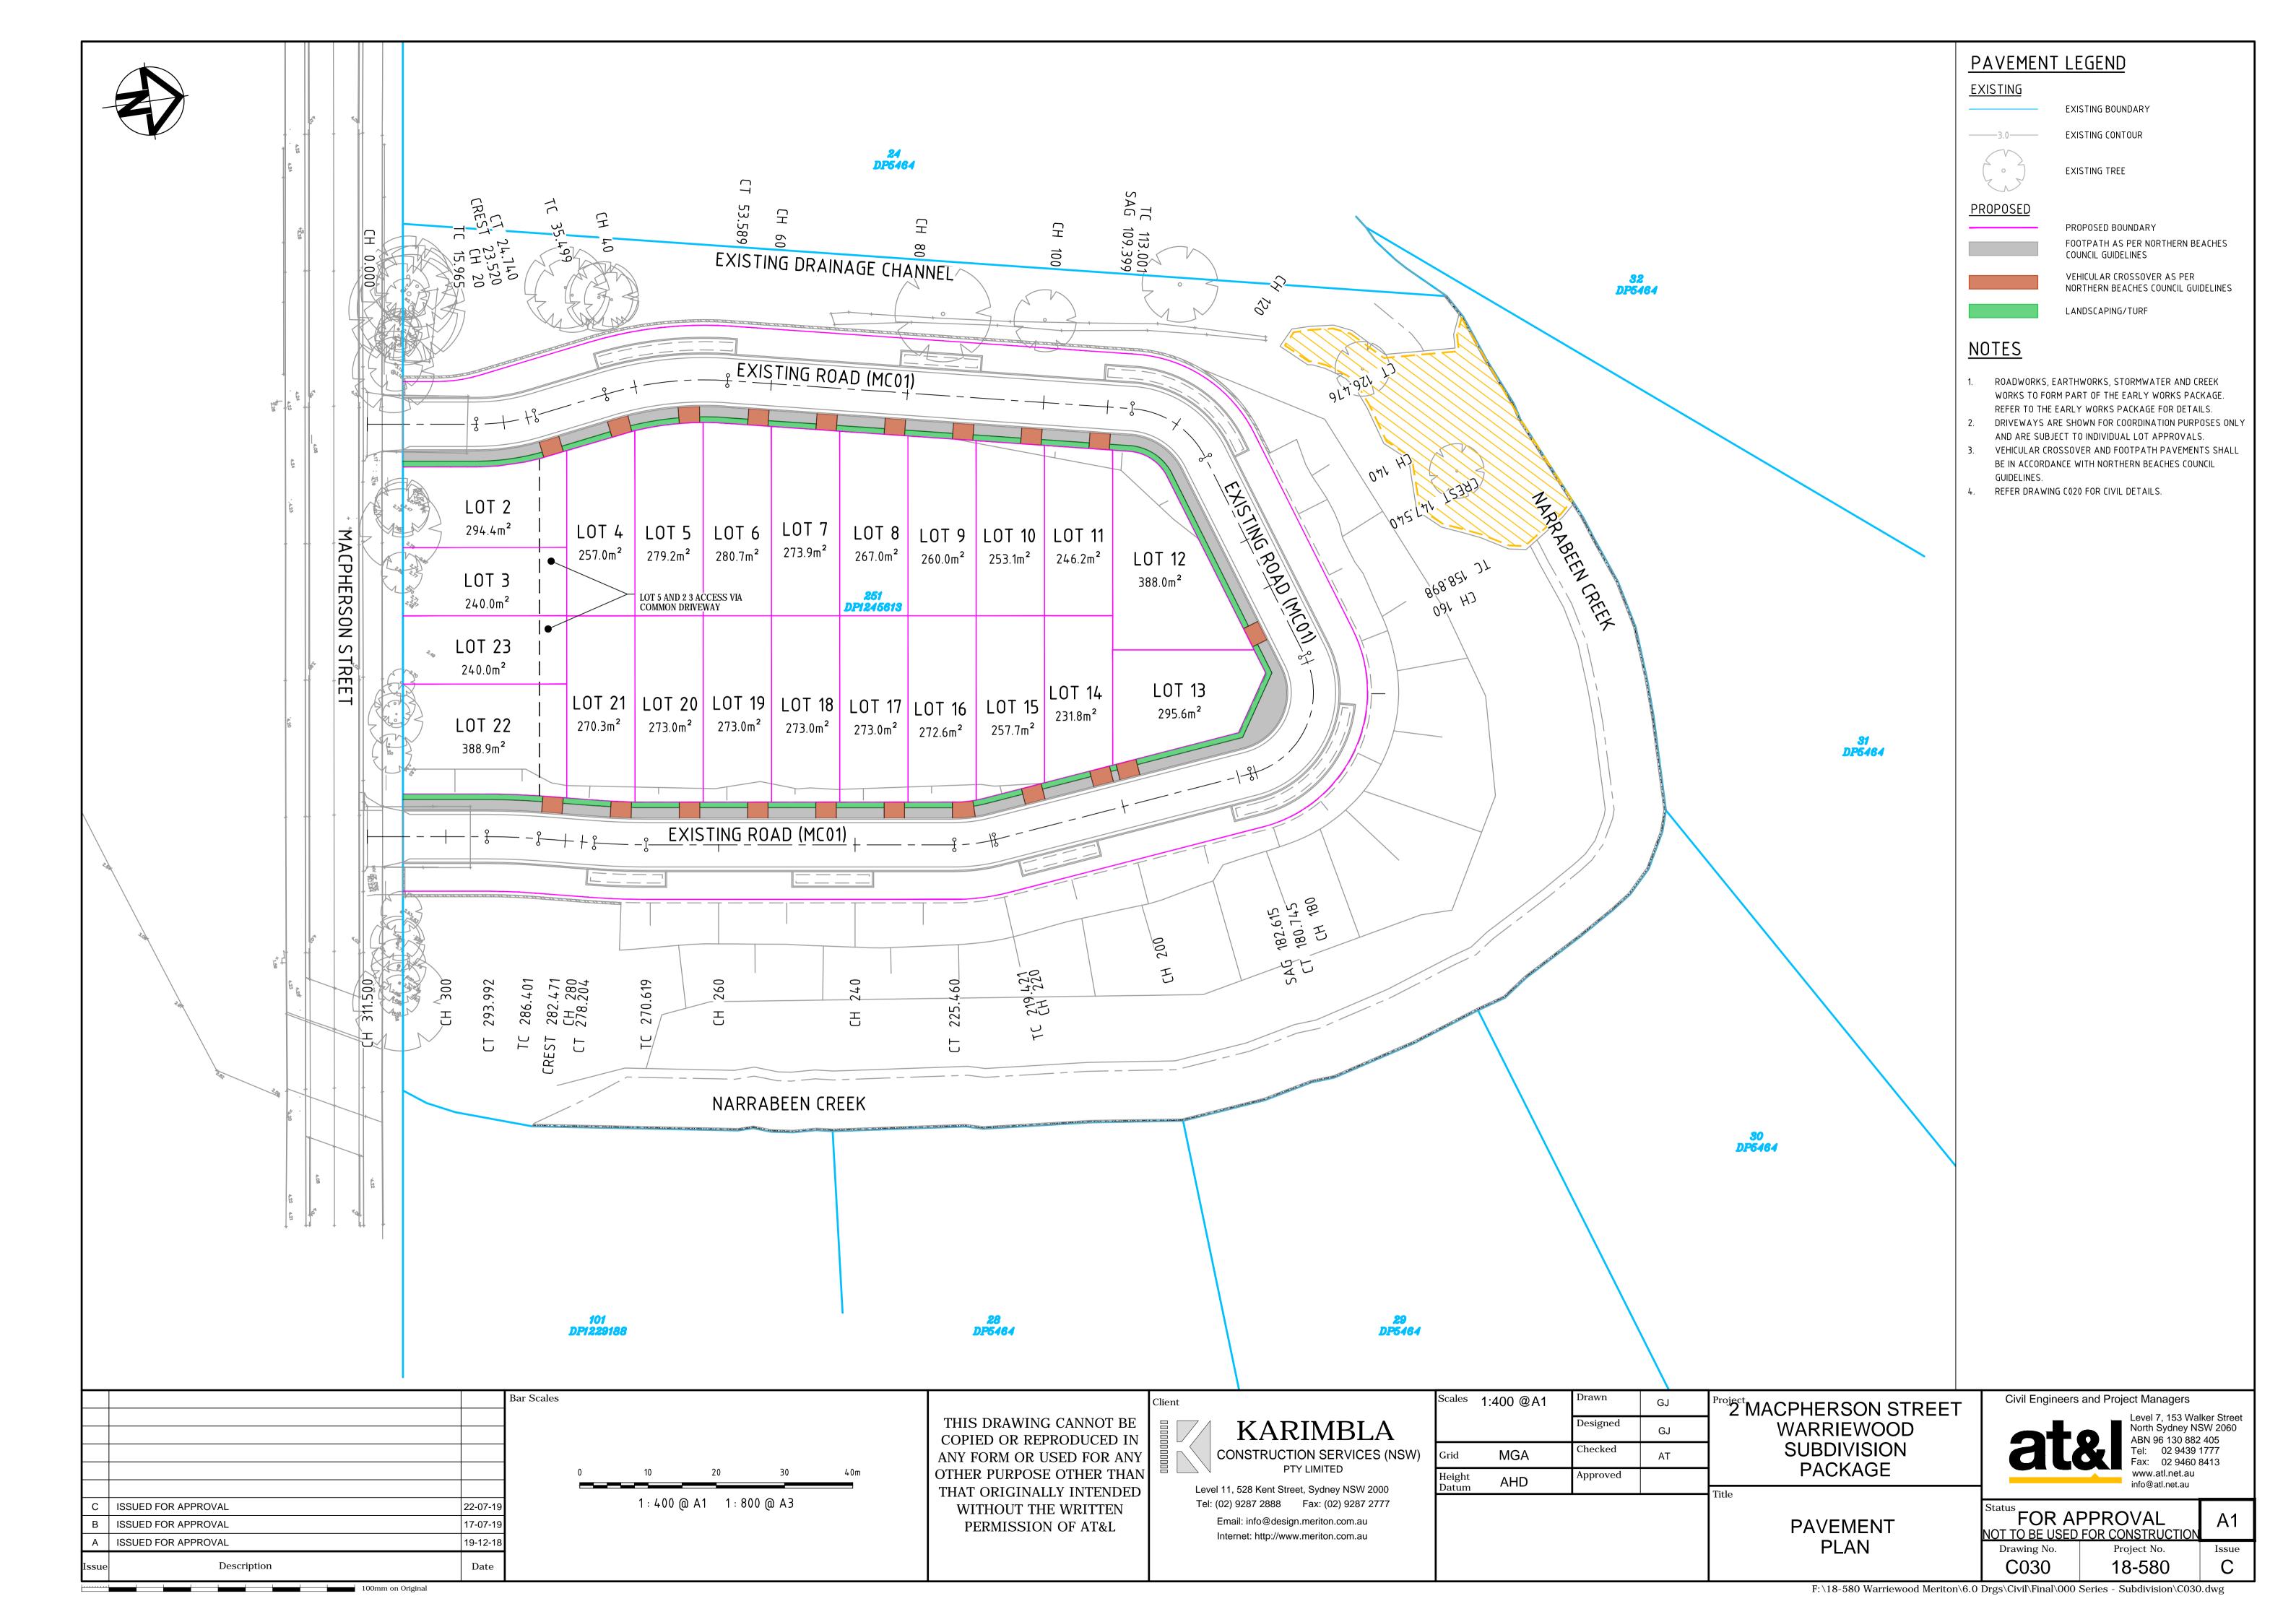

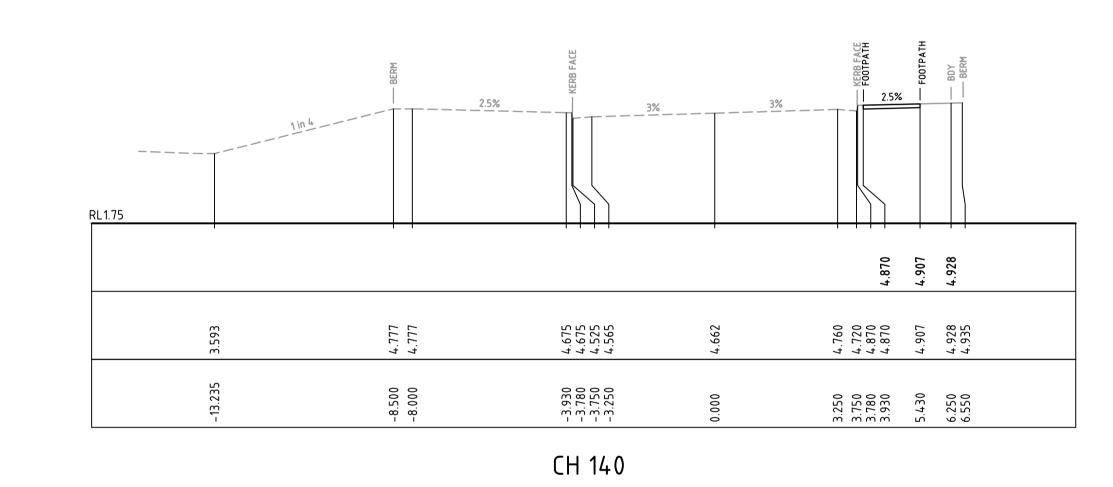

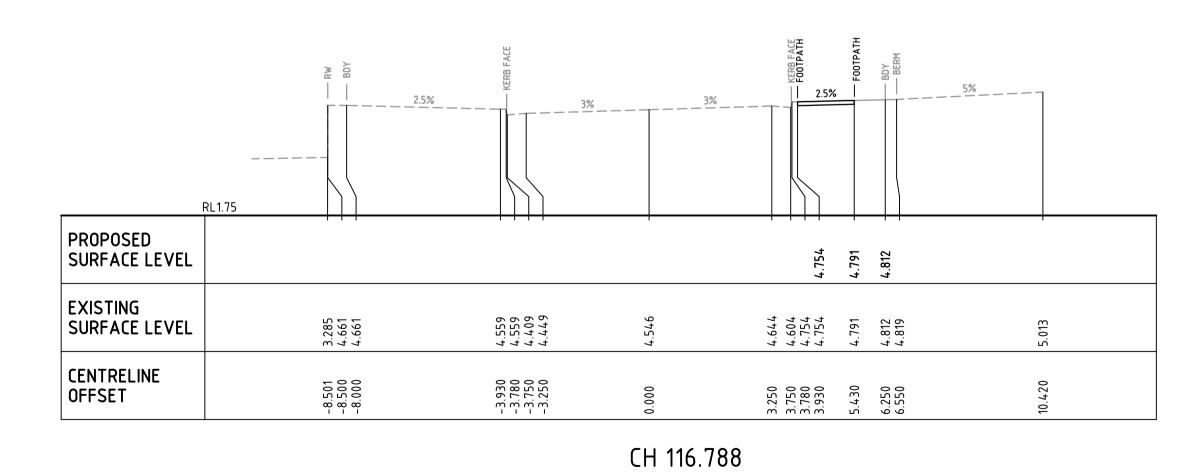

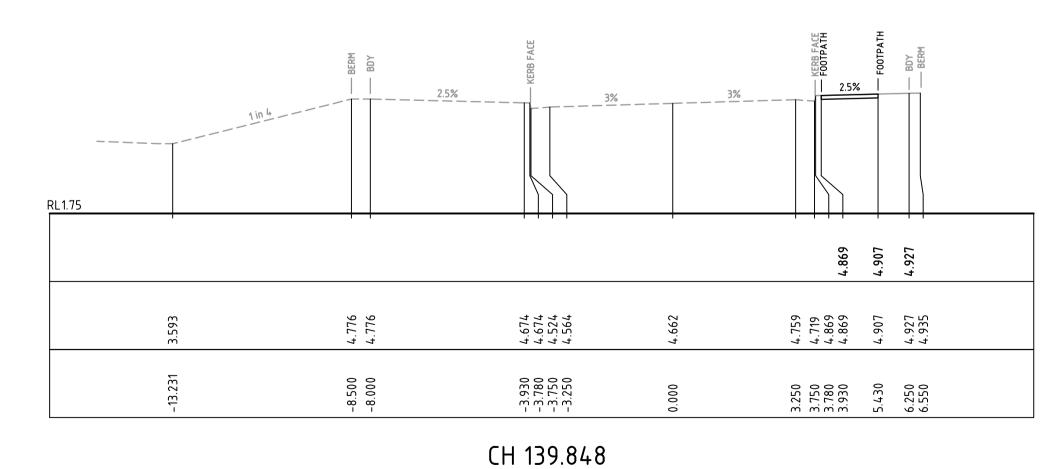

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Fax: 02 9460 8413
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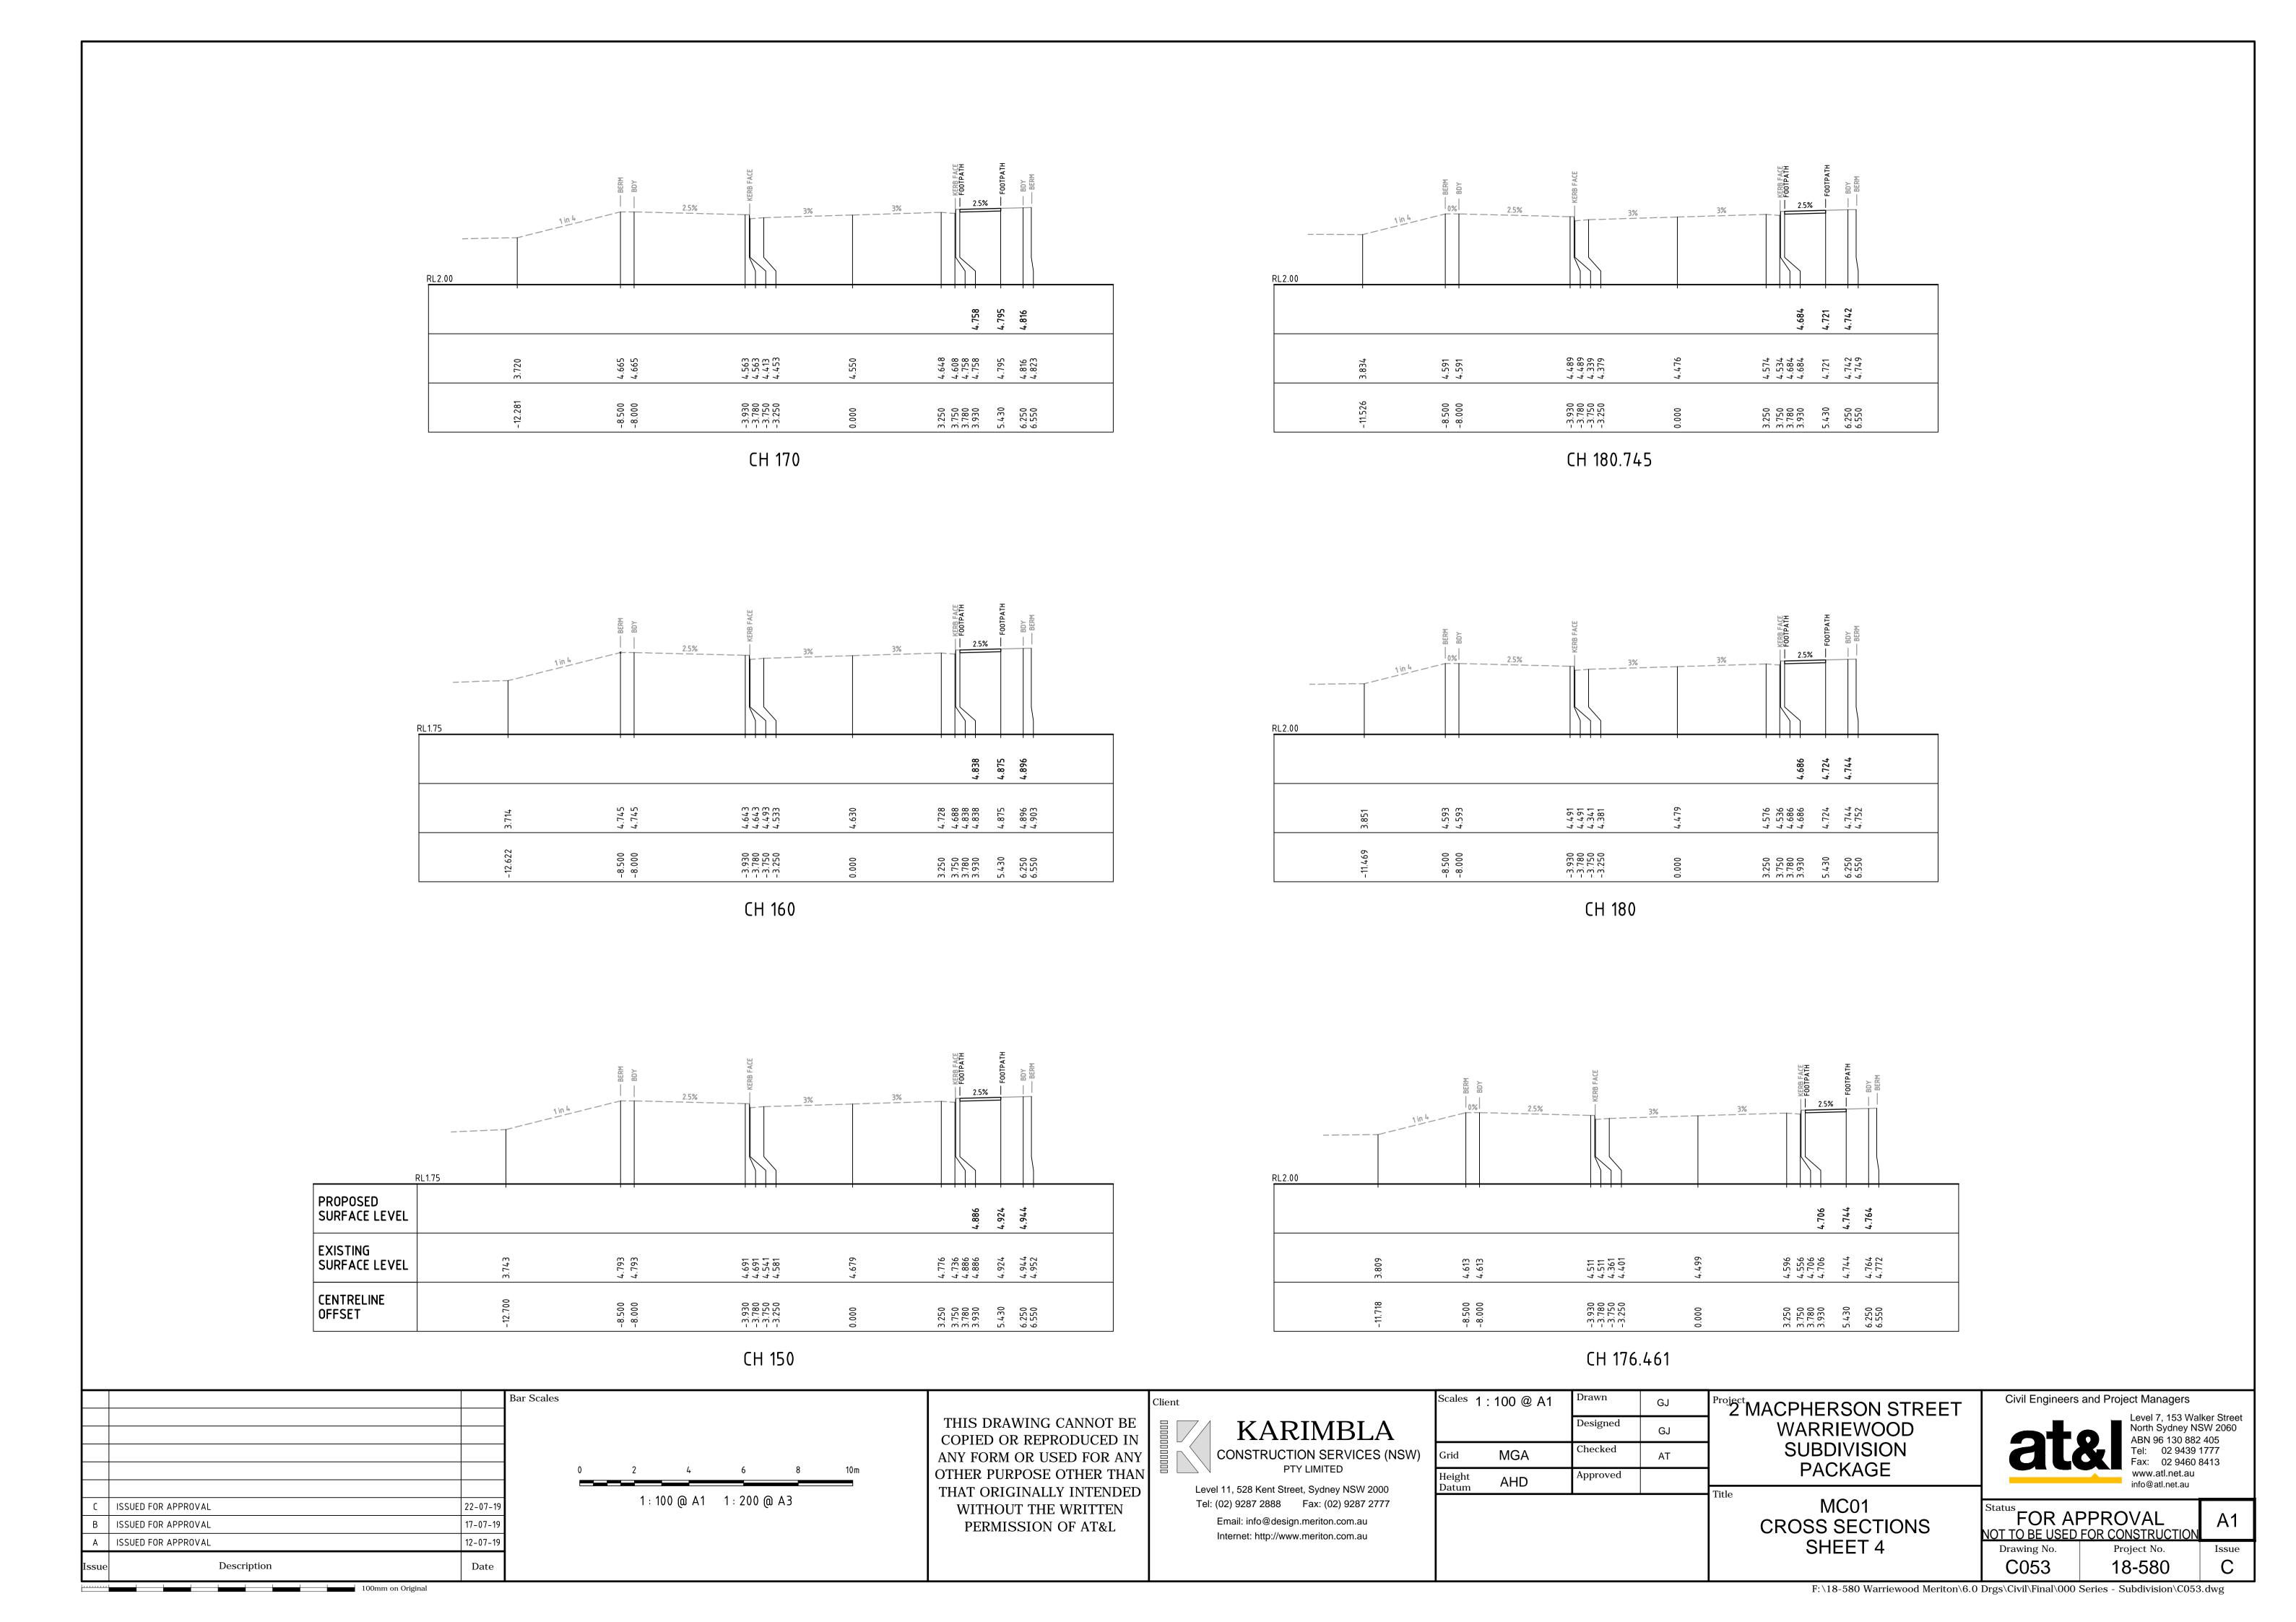
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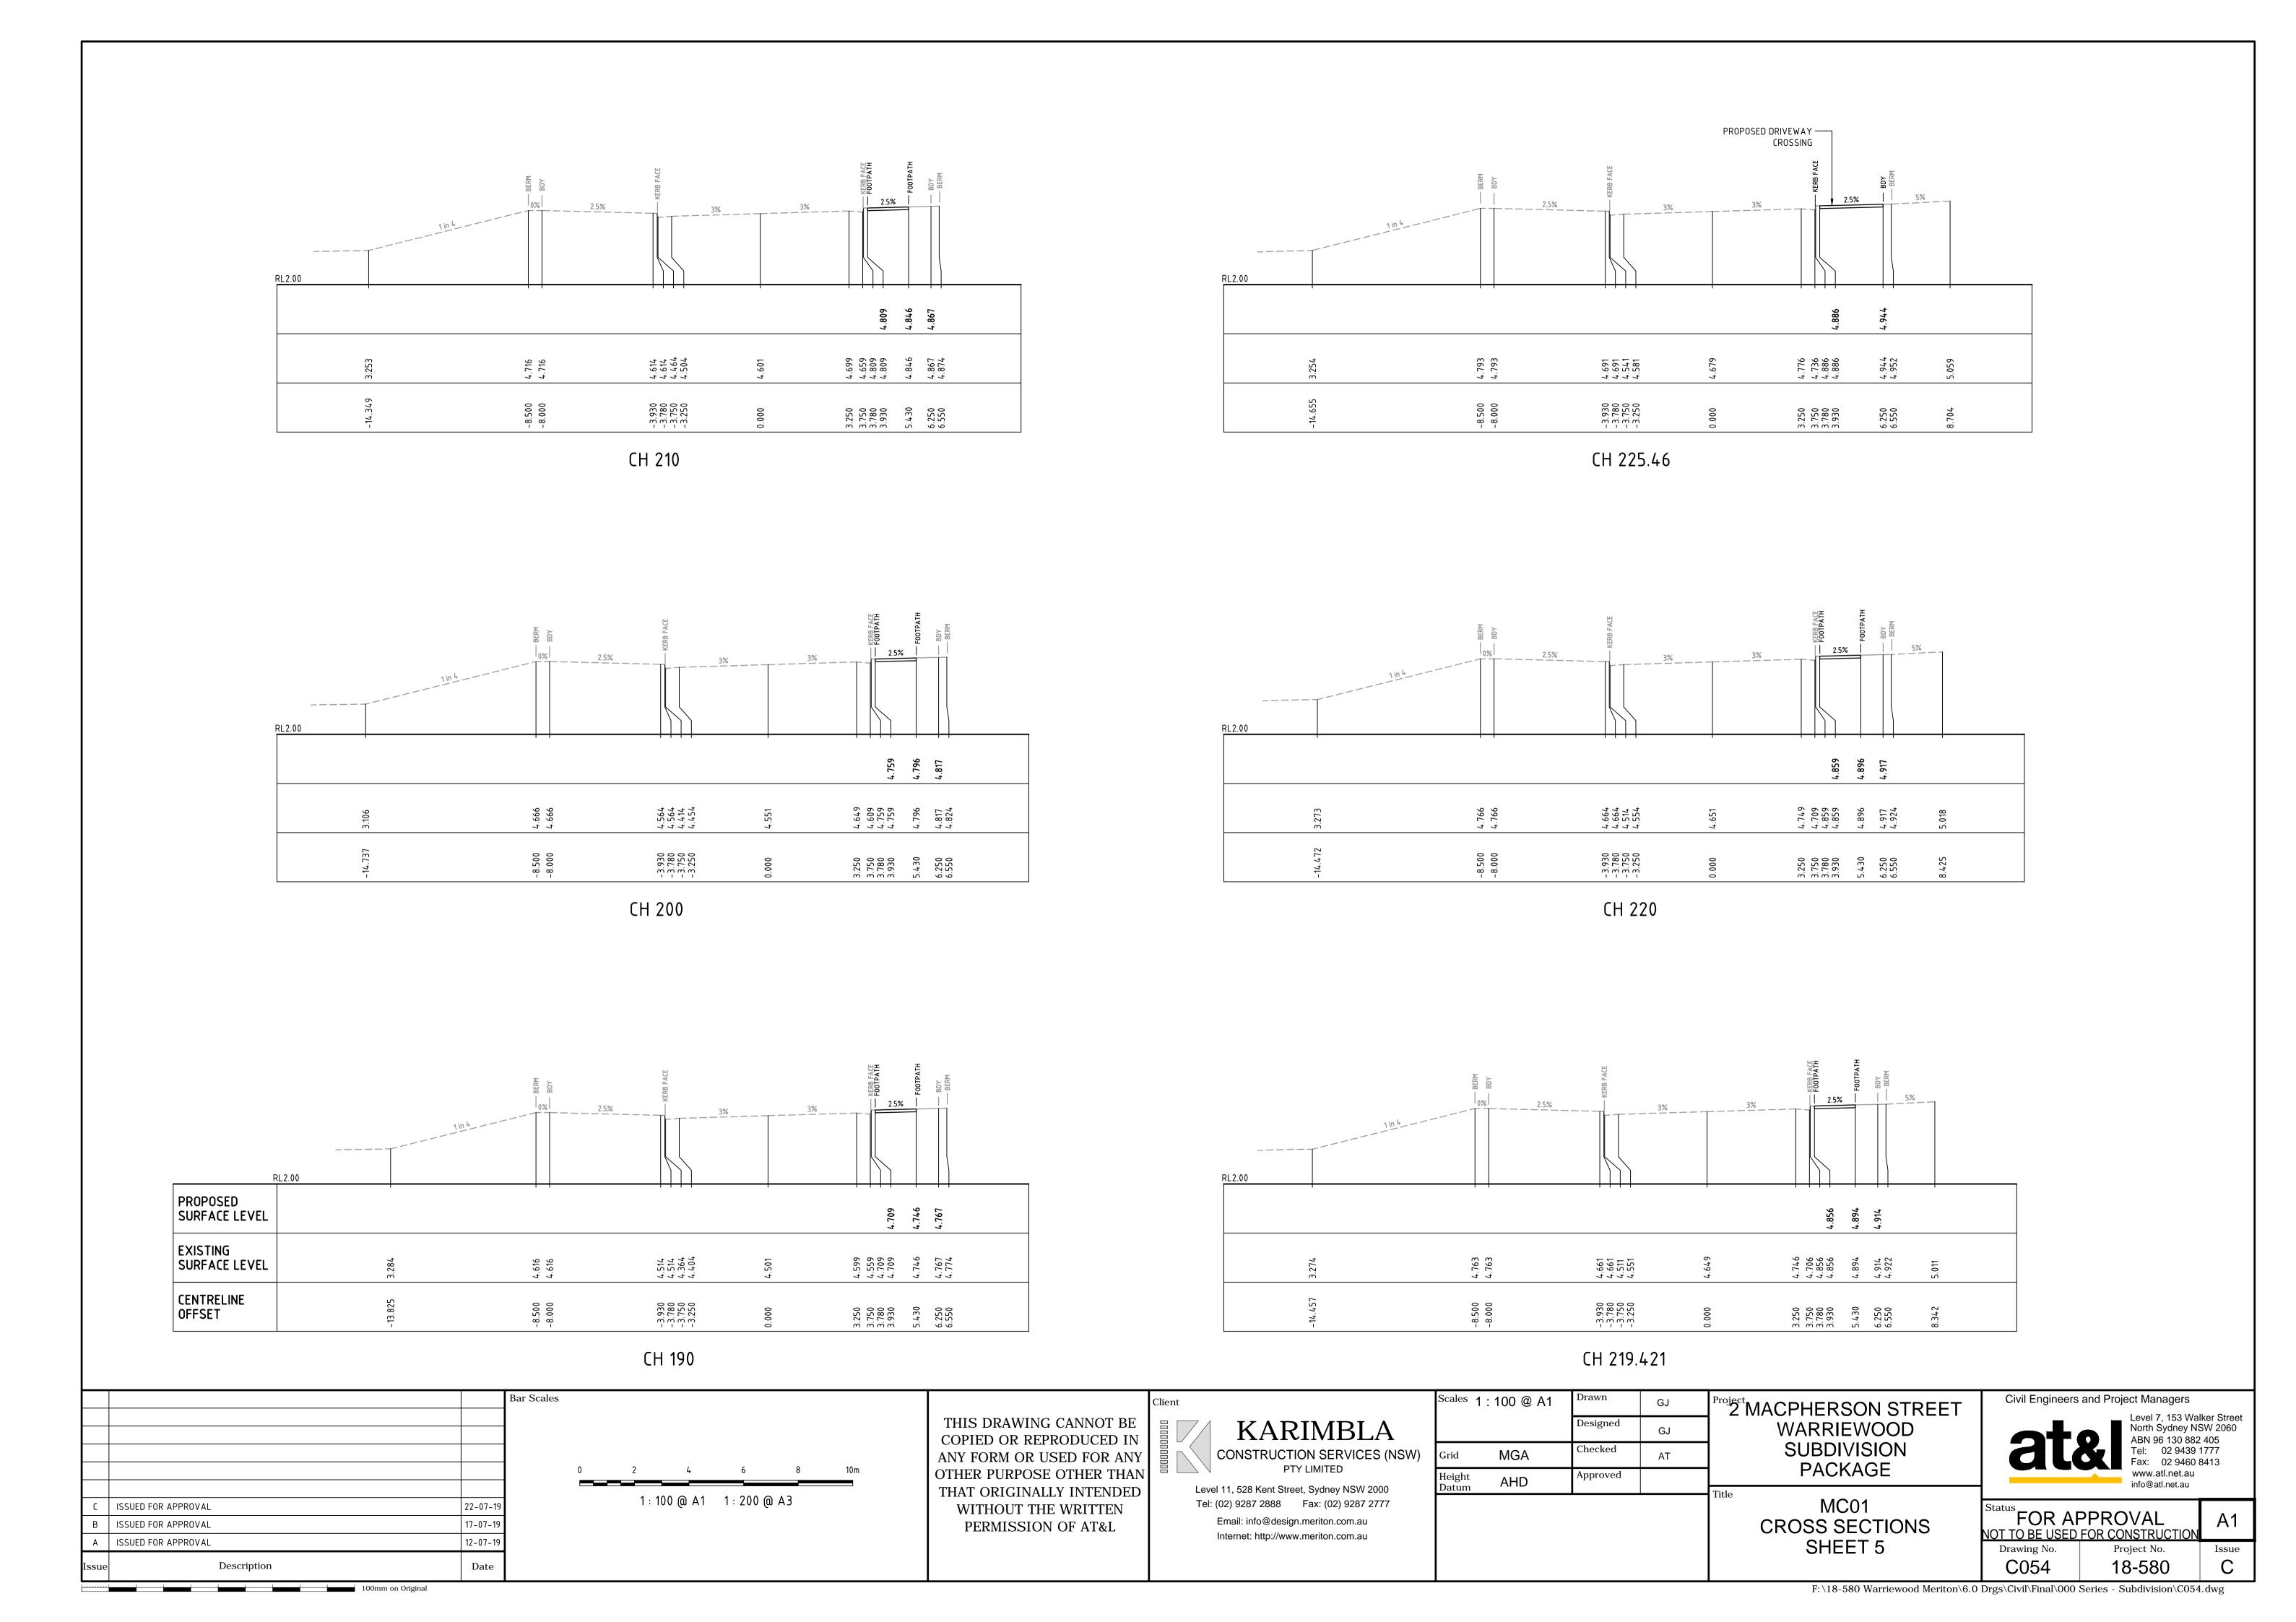
Project No.


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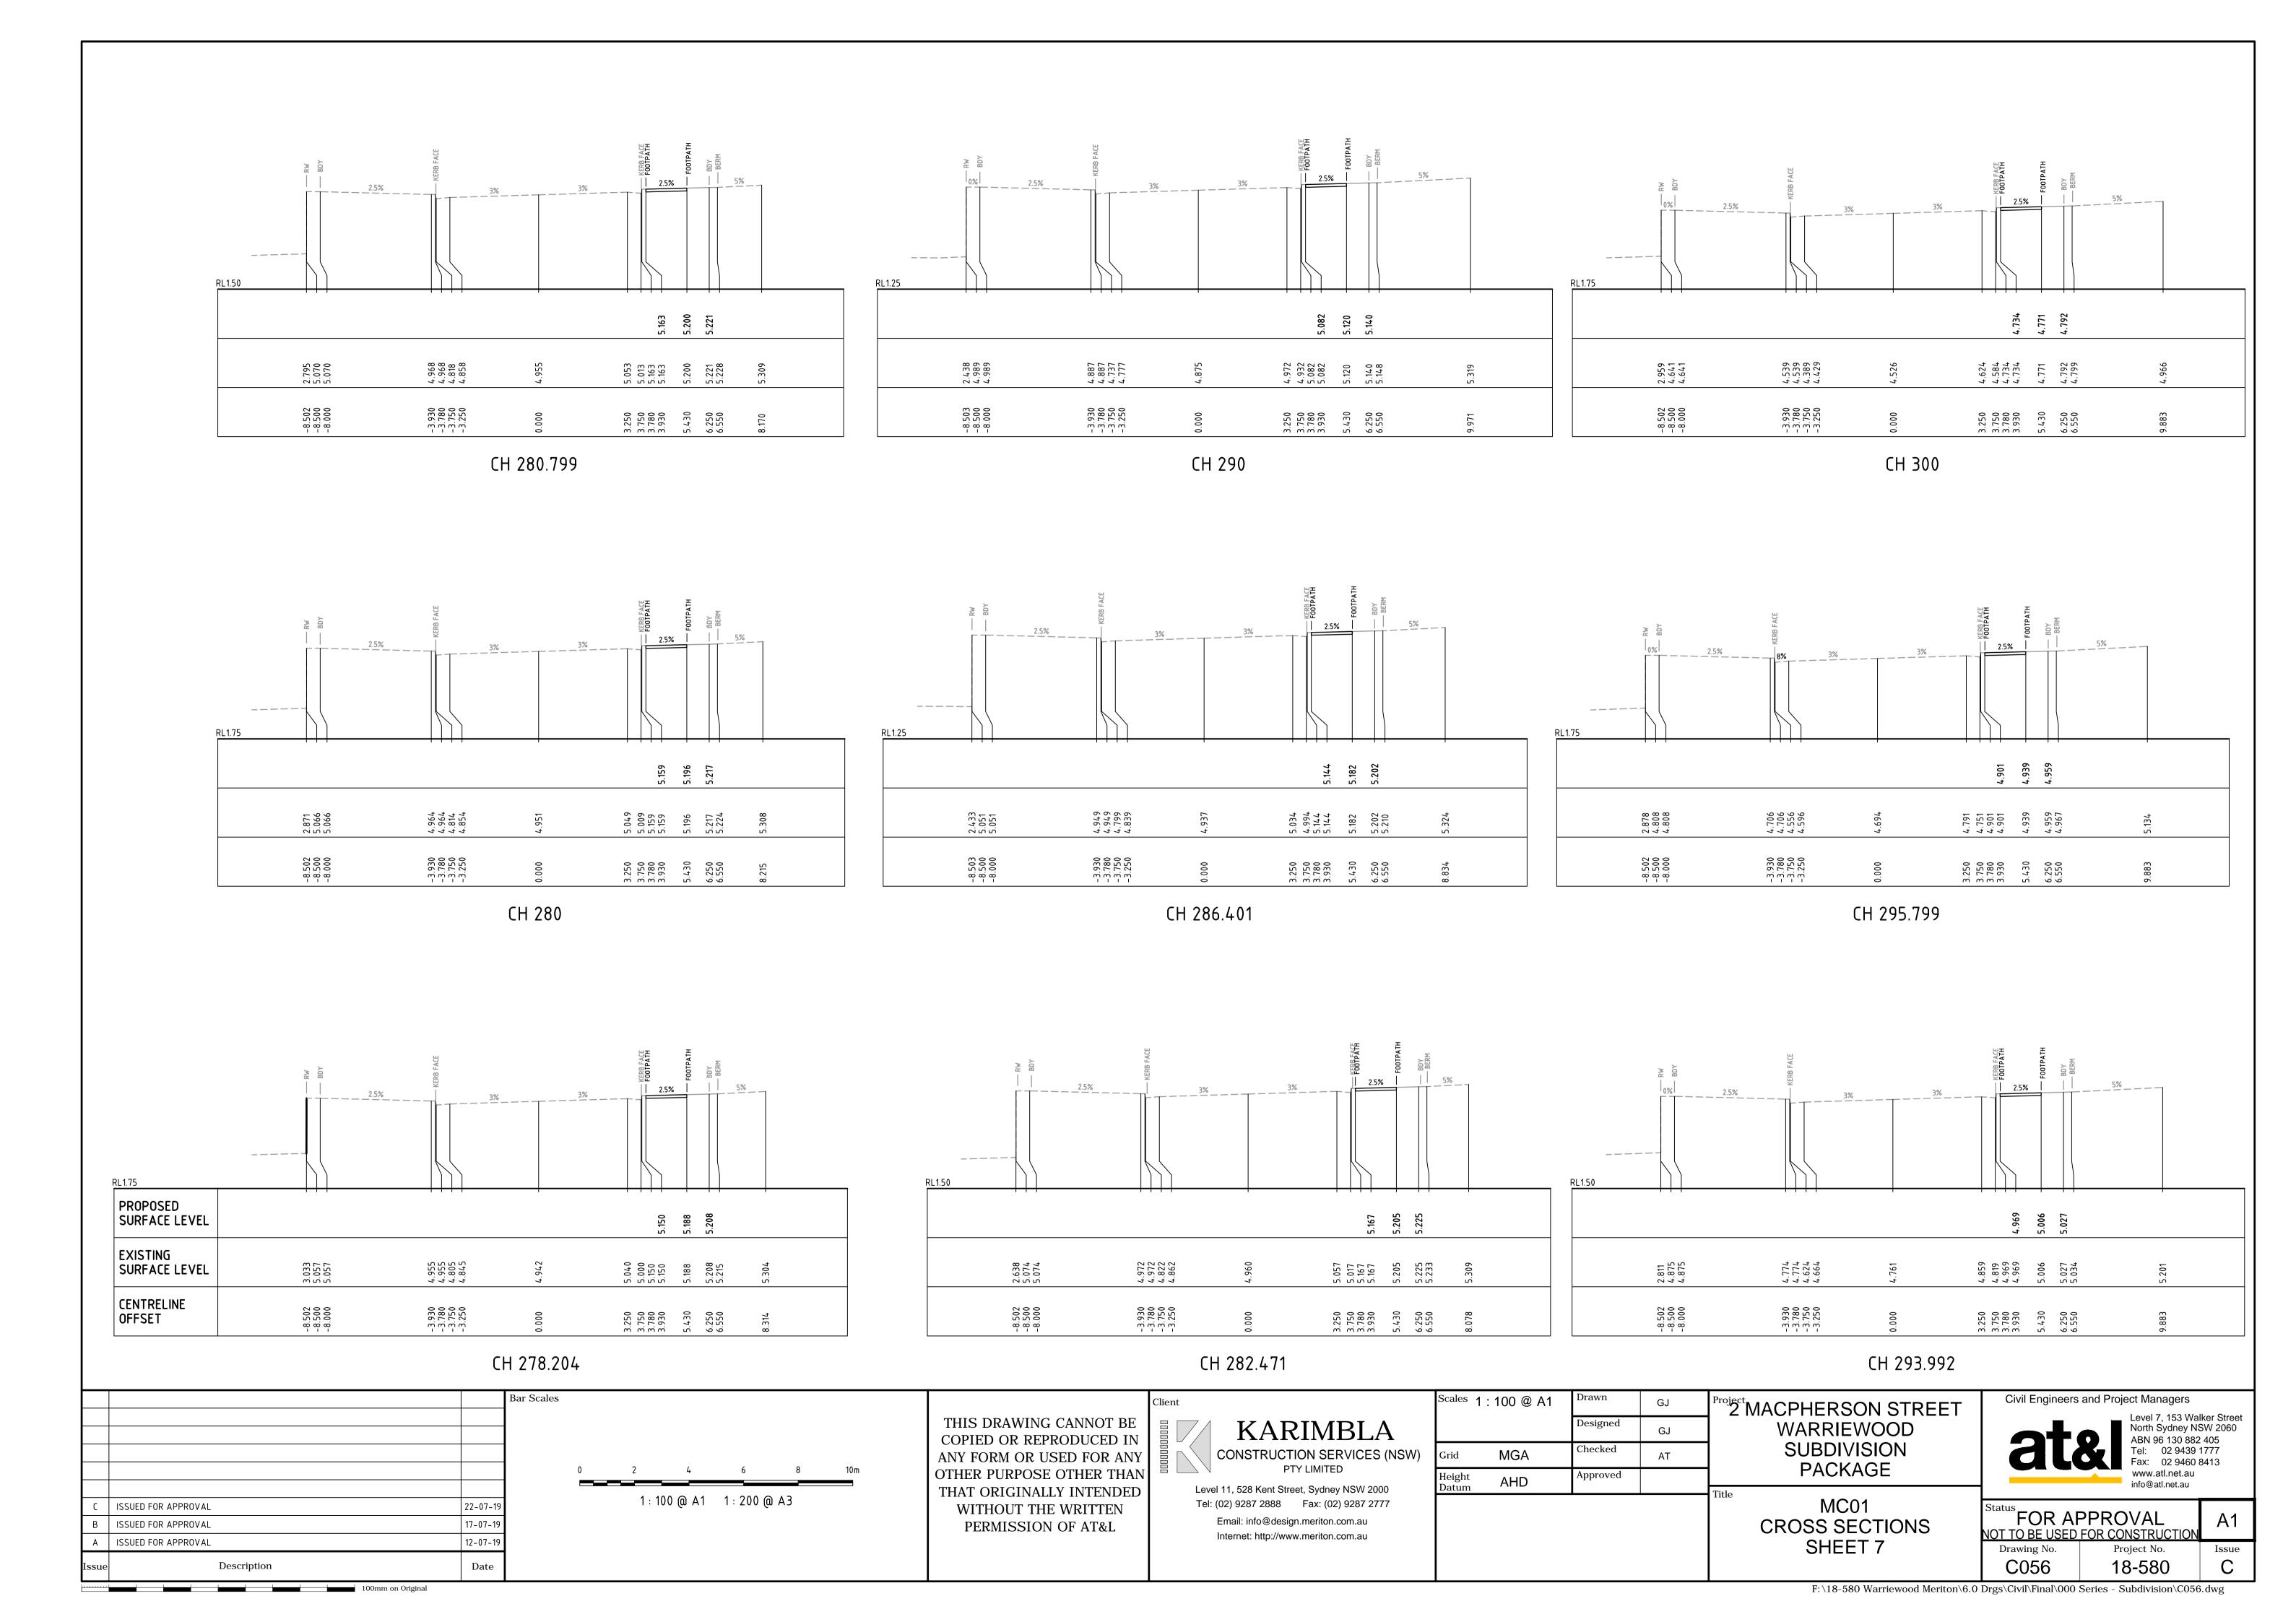
Civil Engineers and Project Managers


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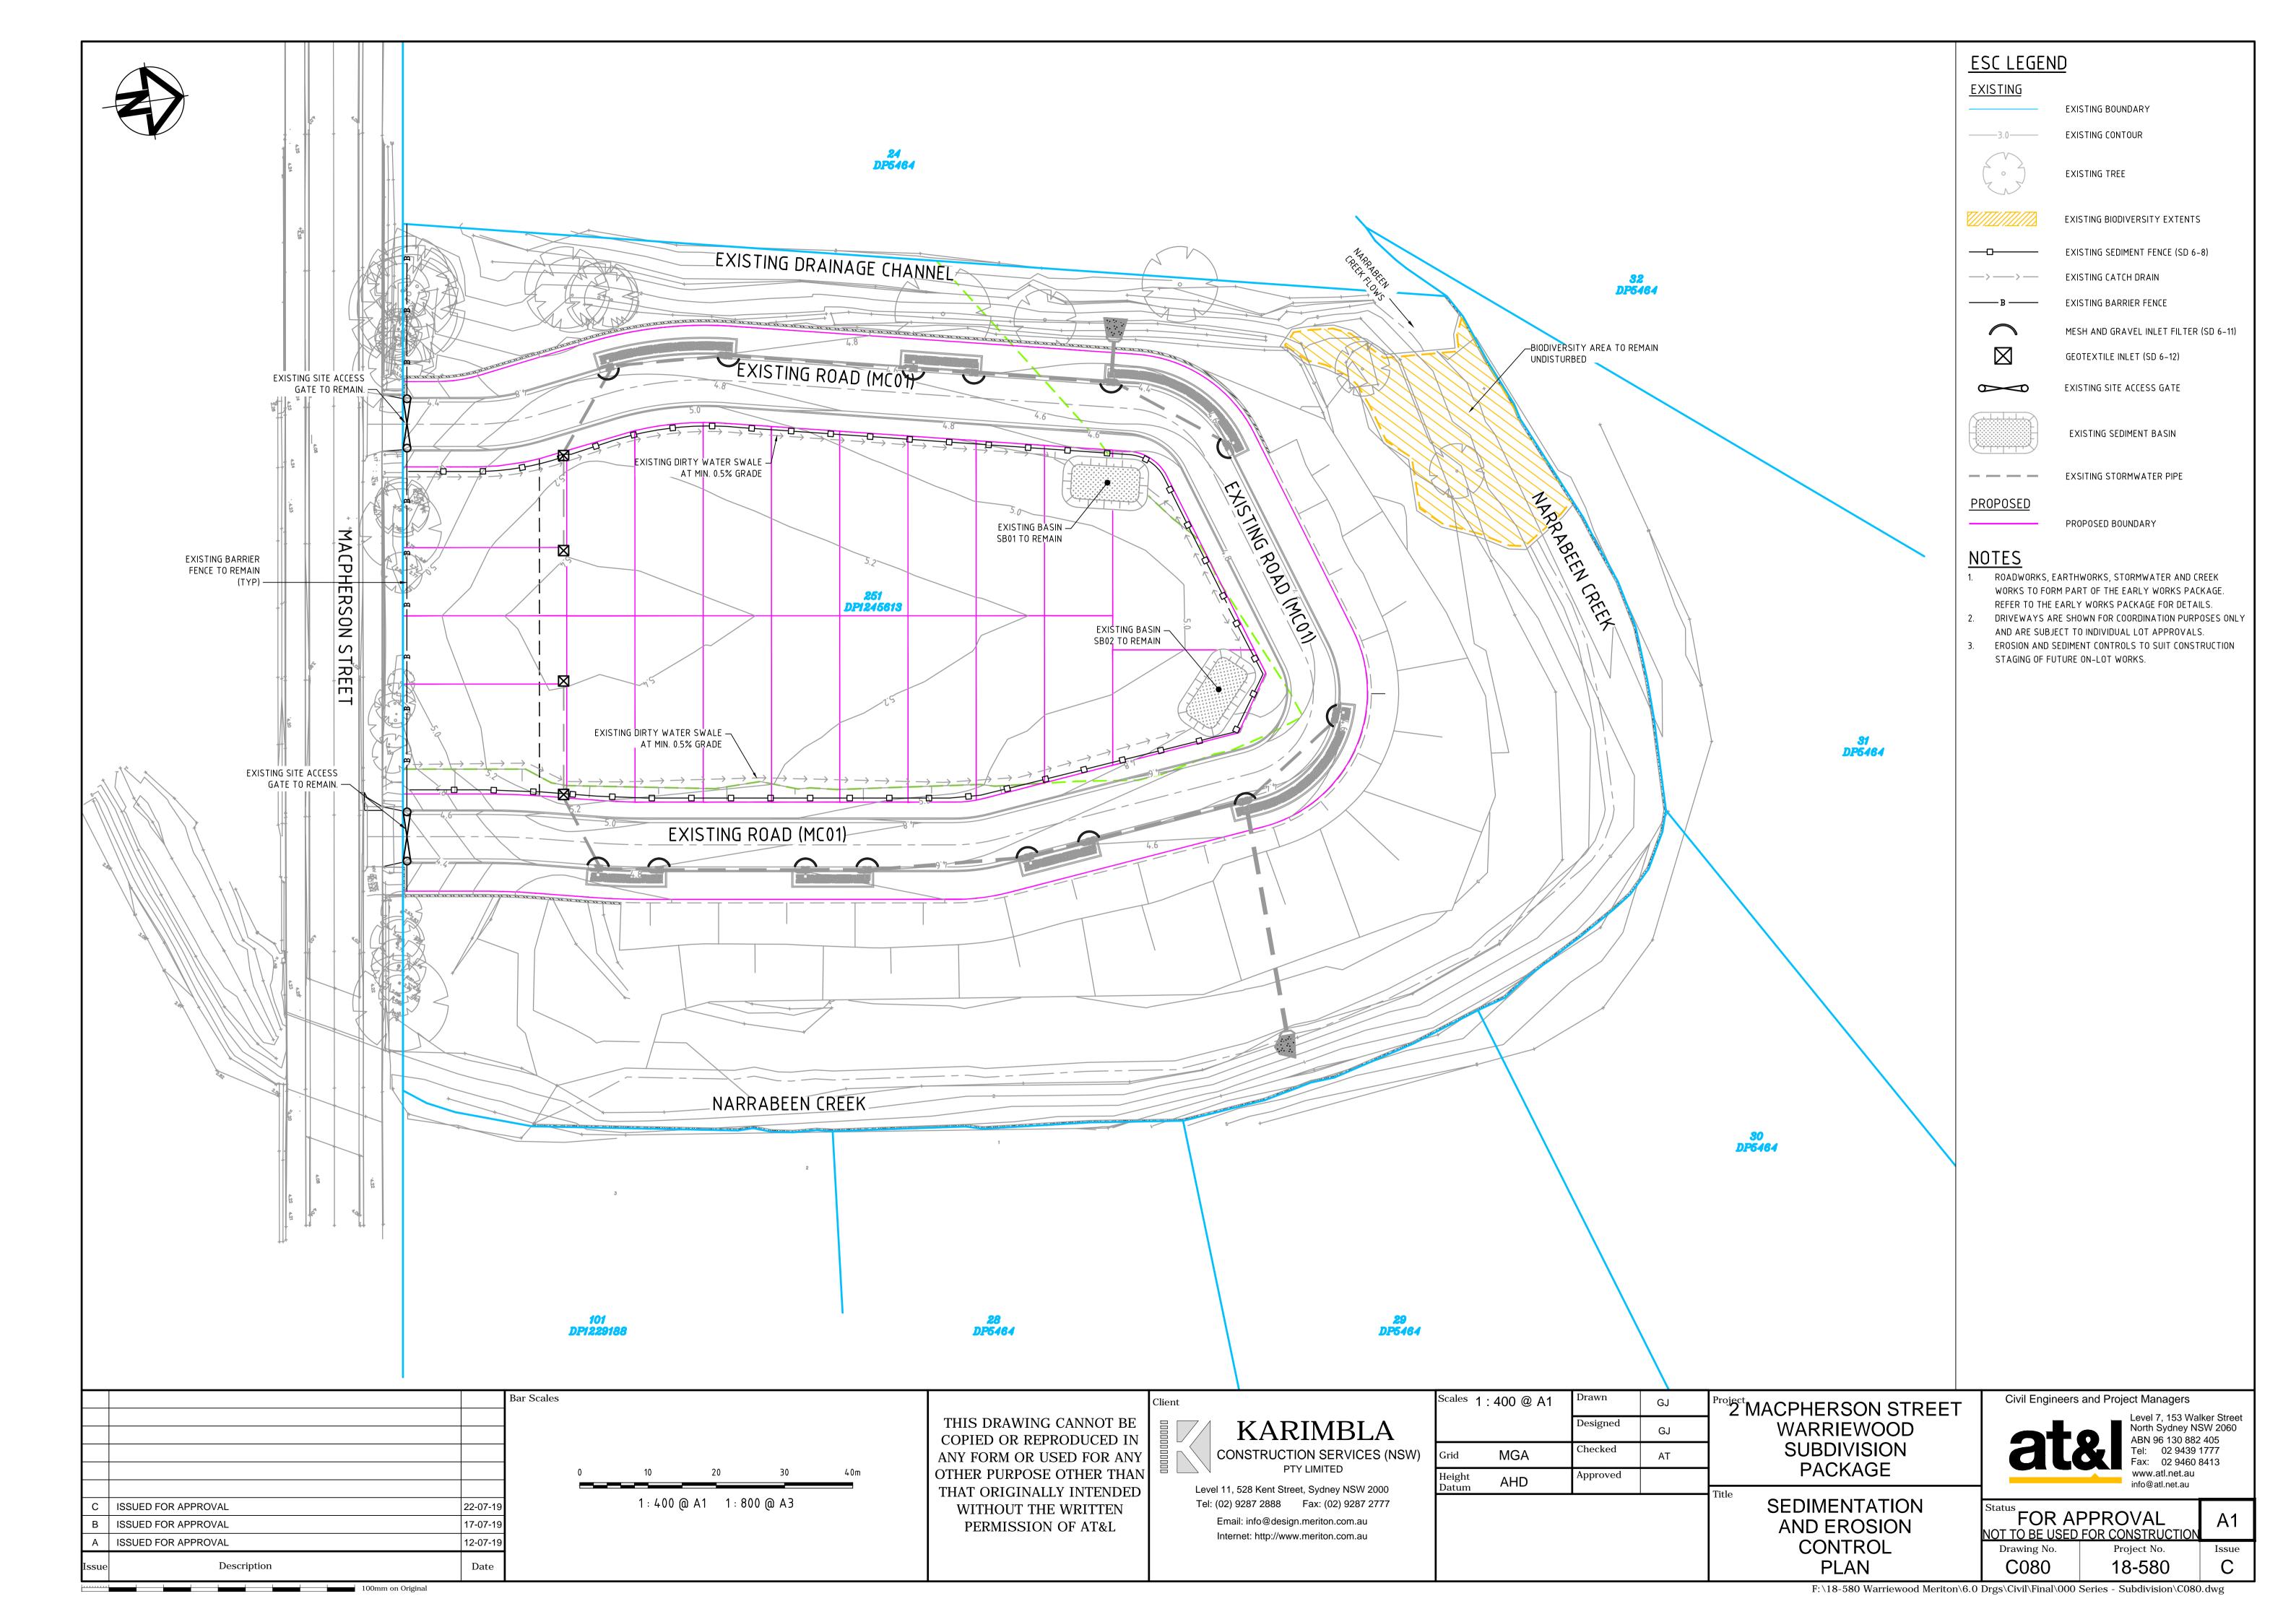











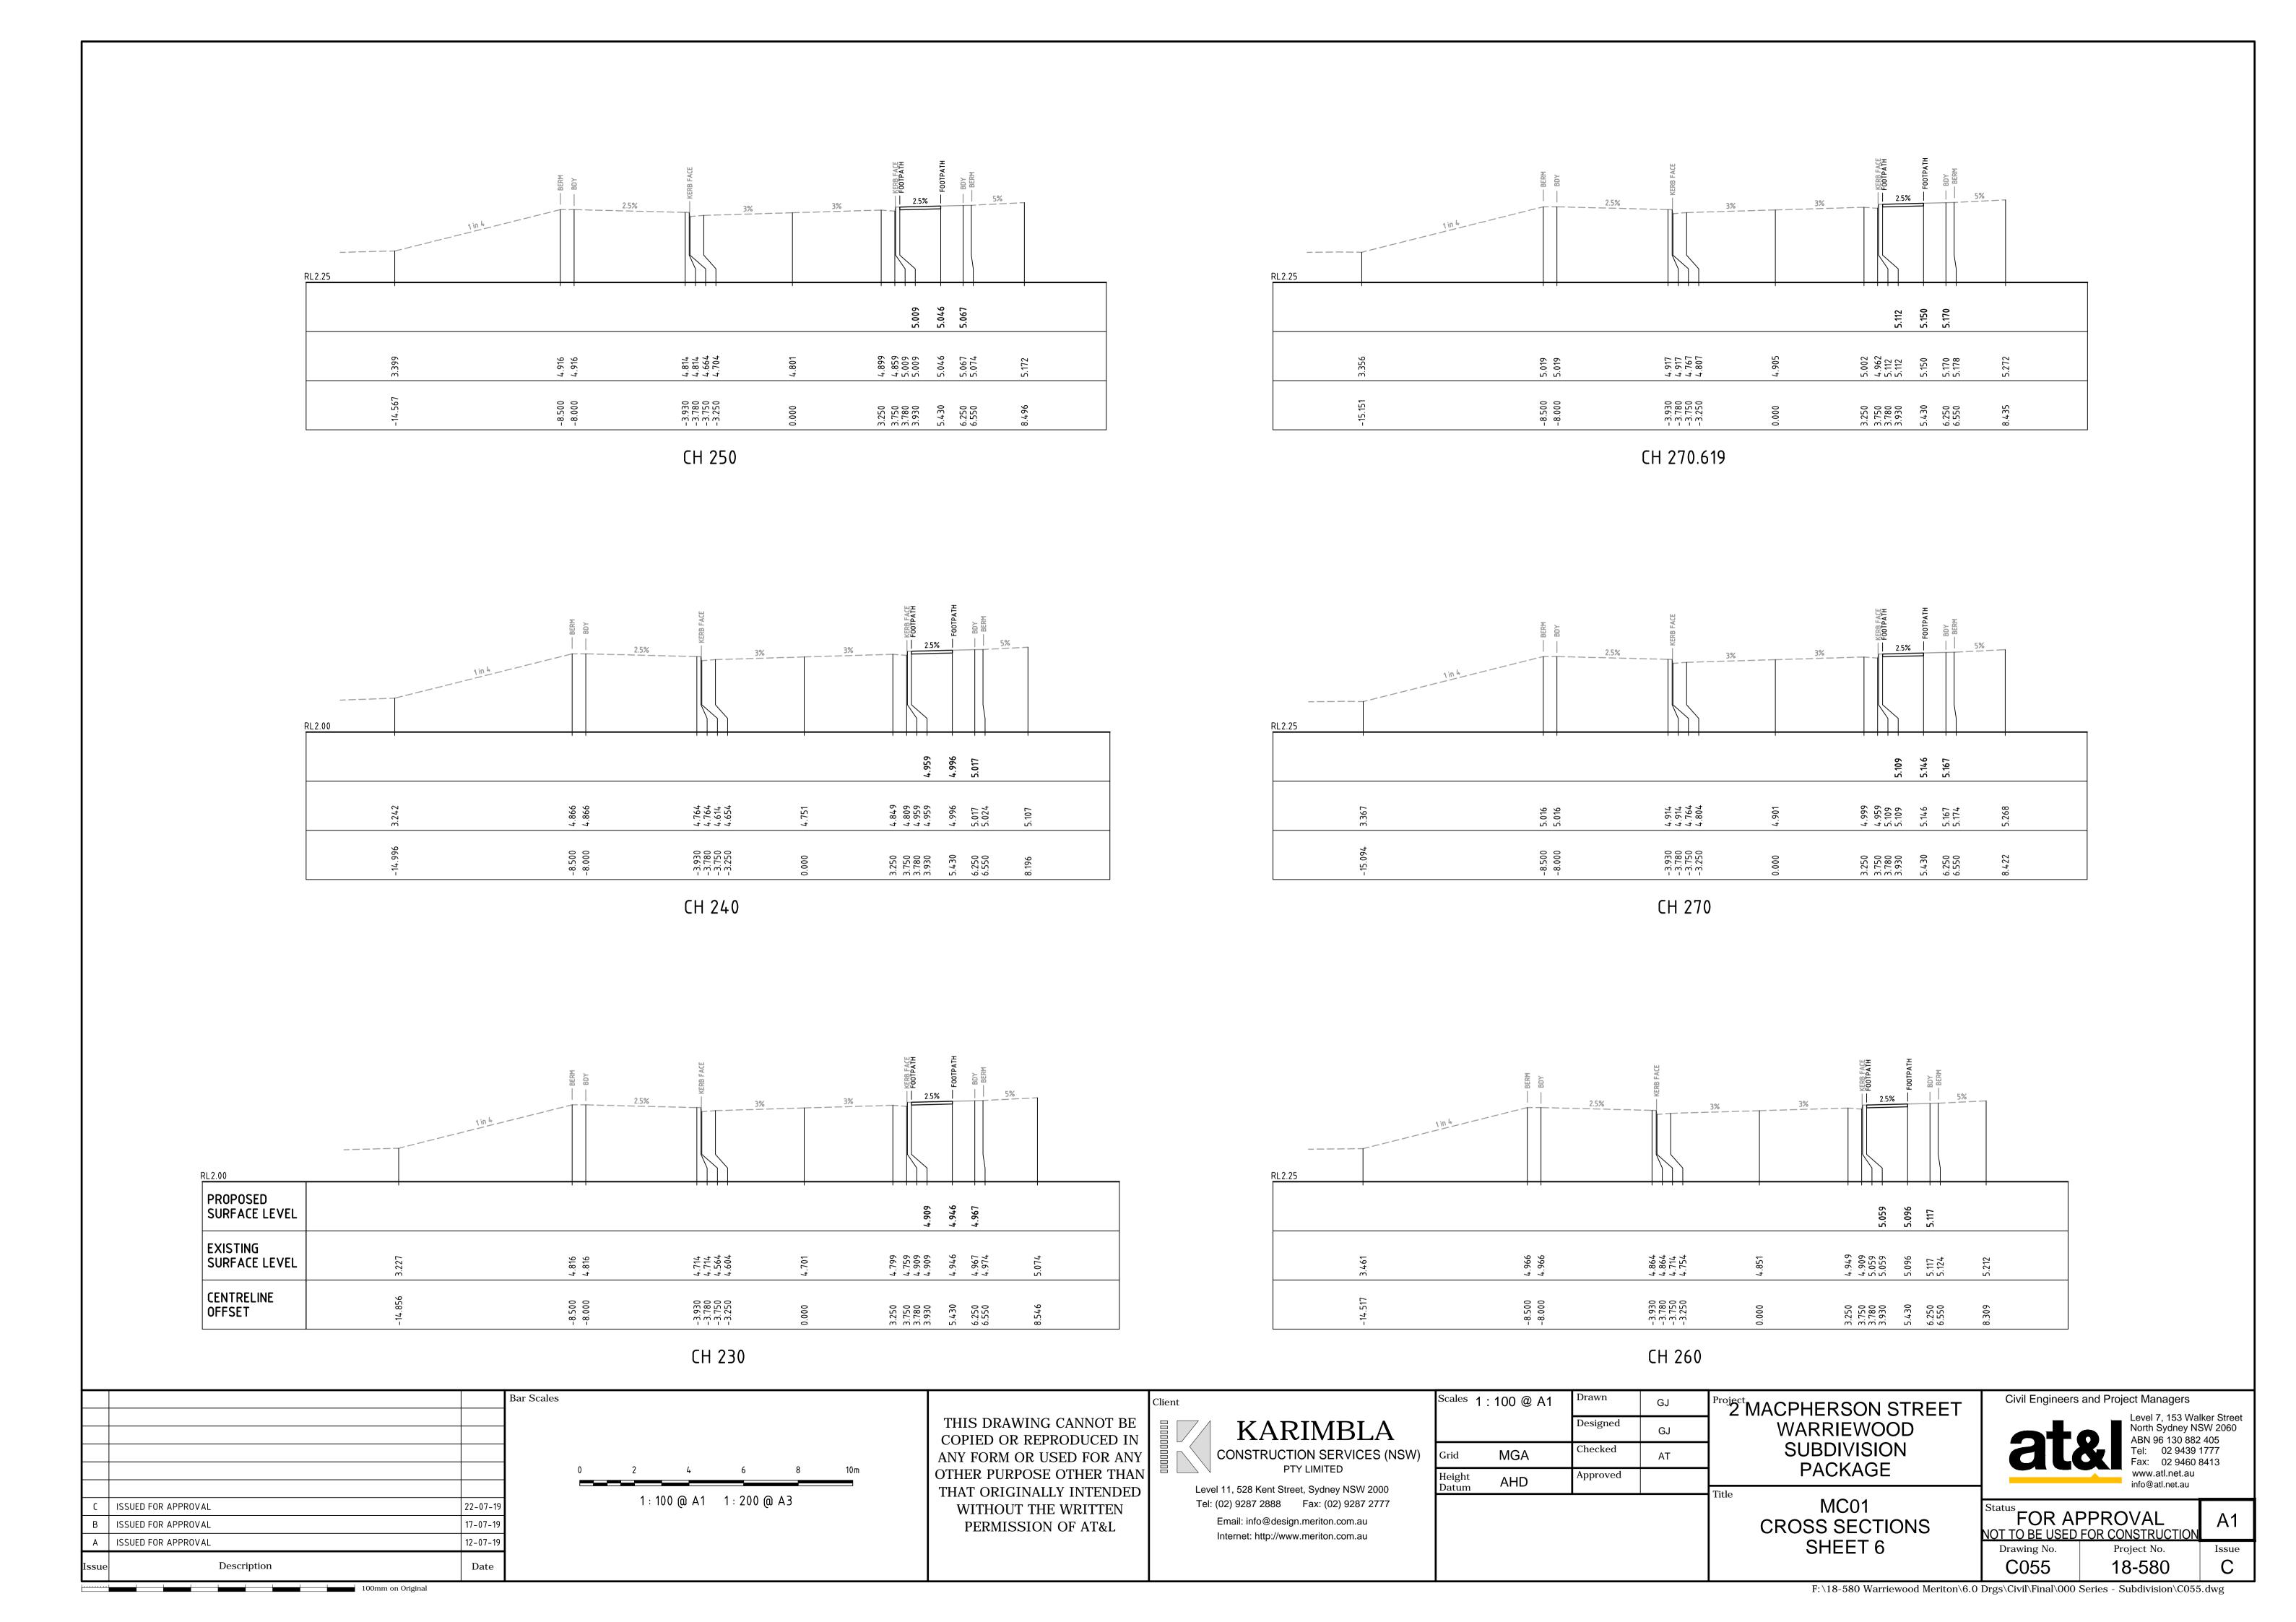

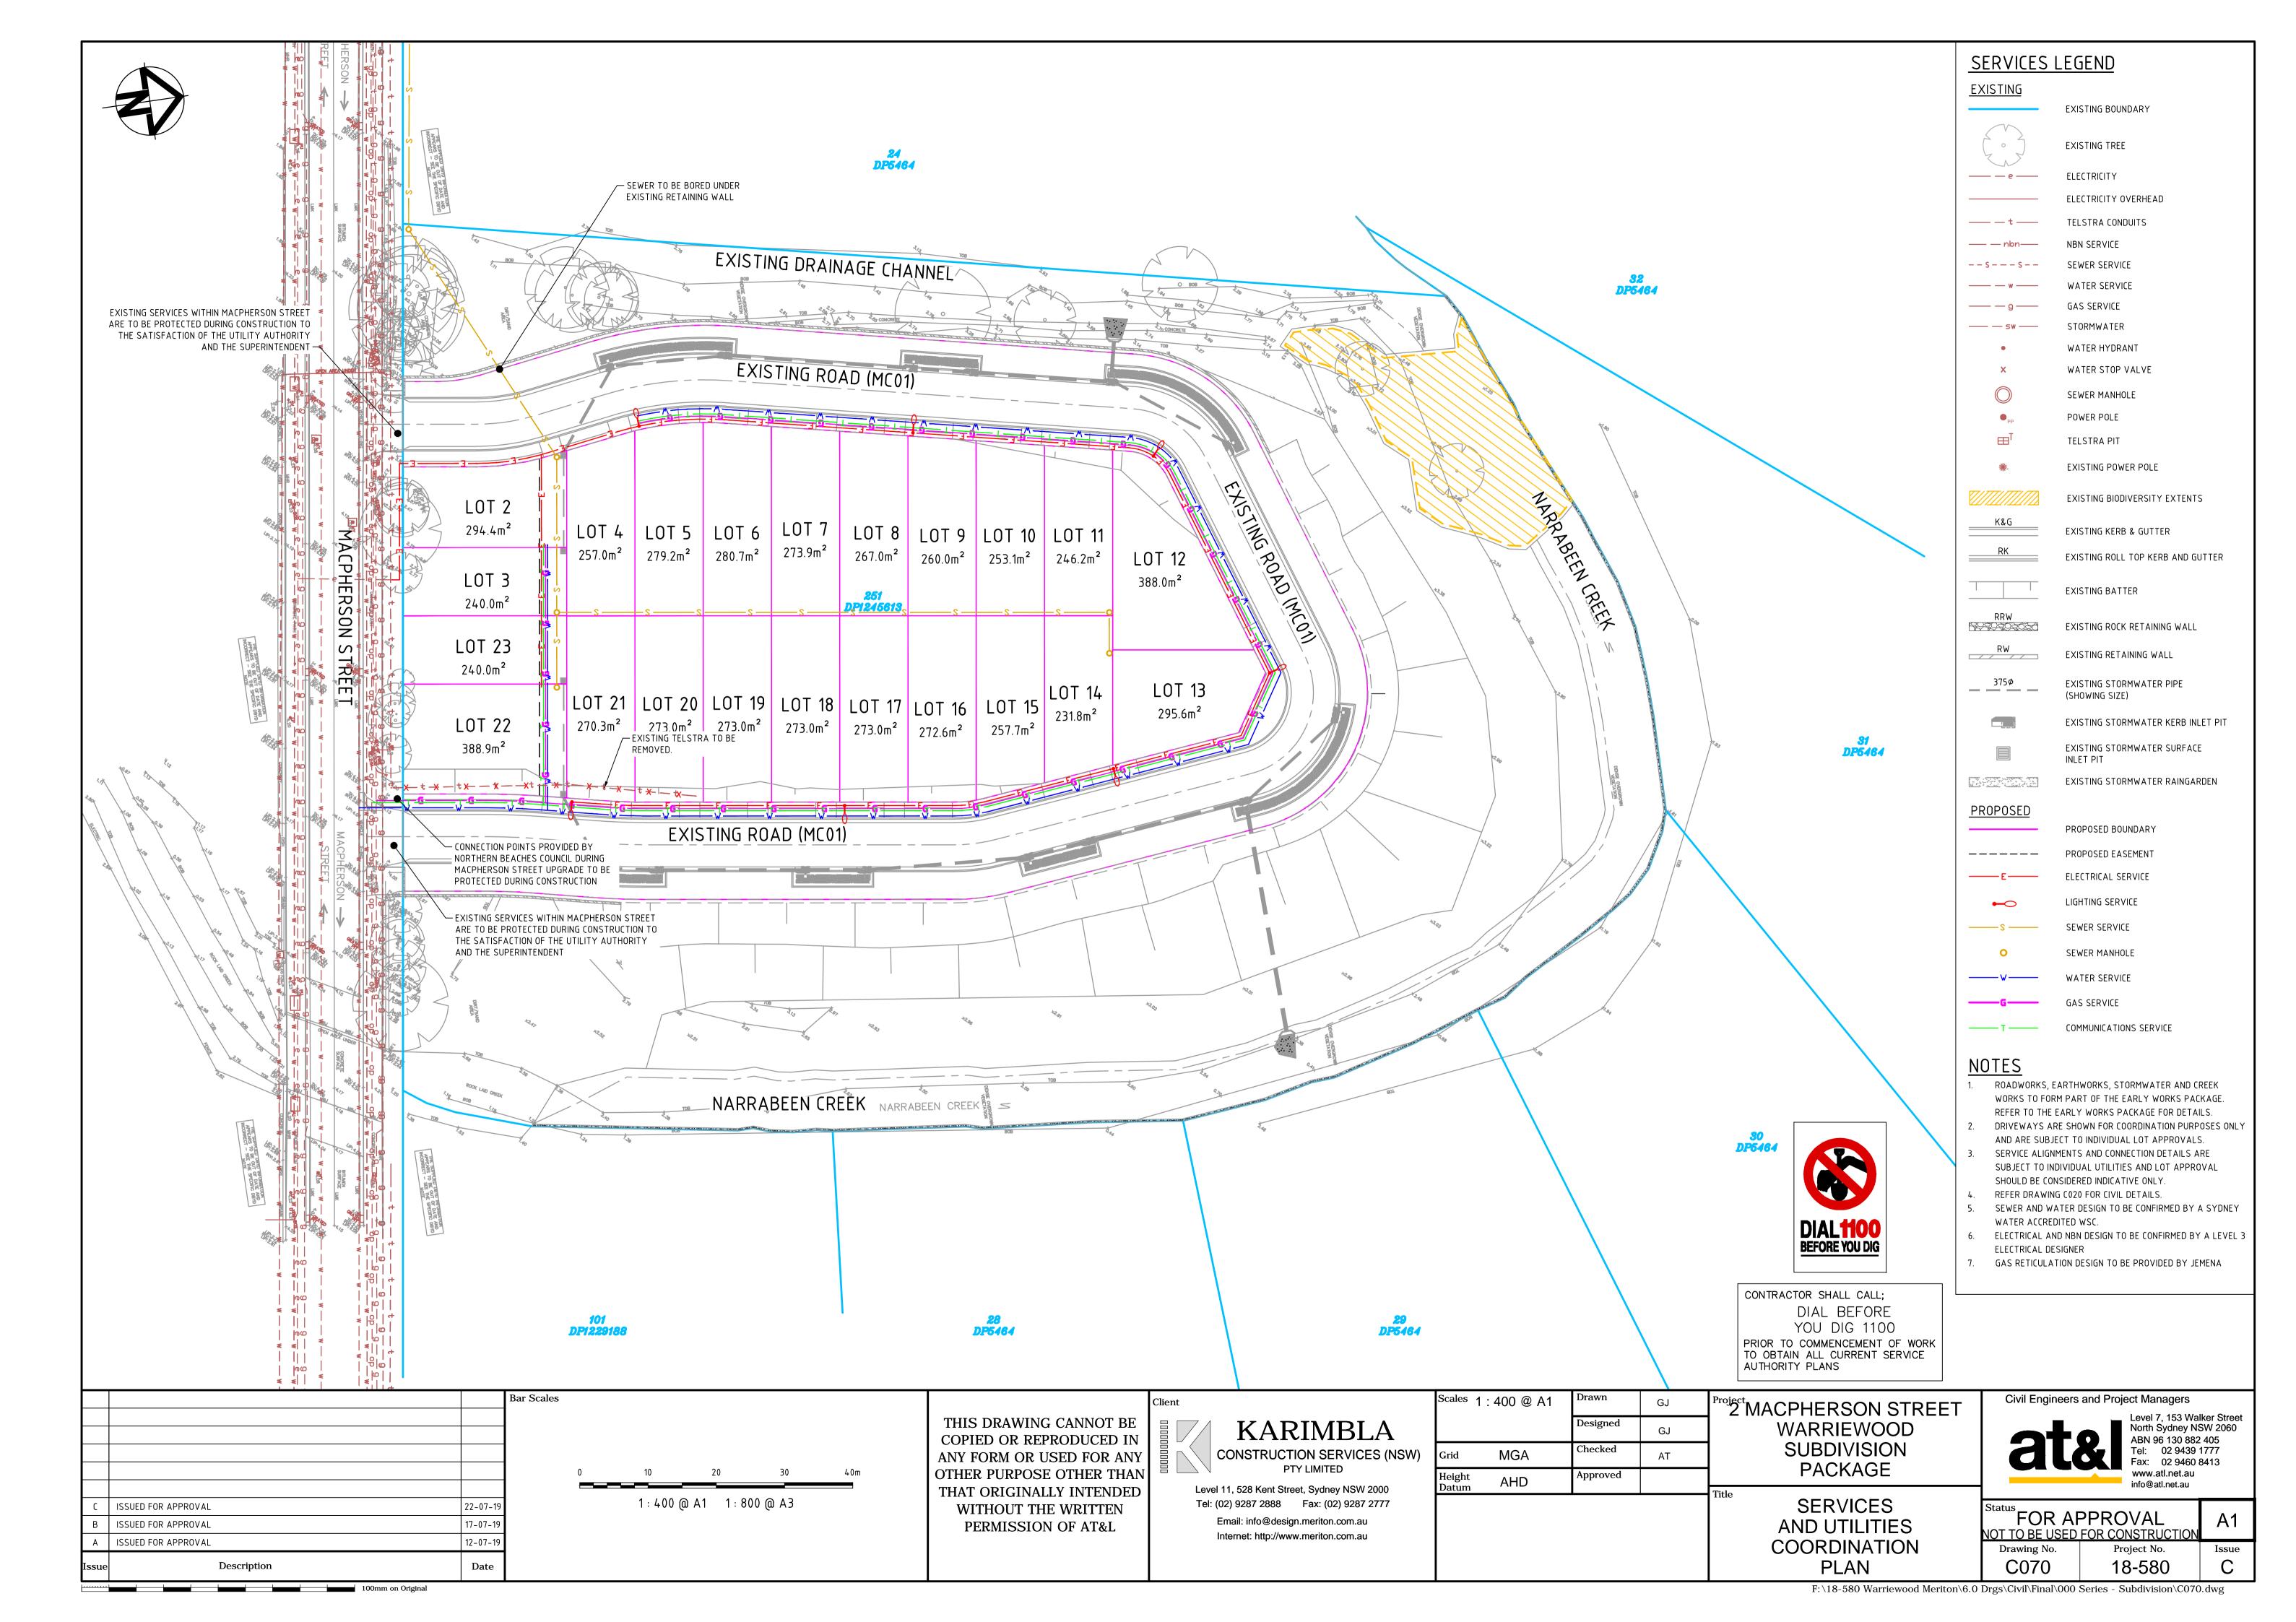

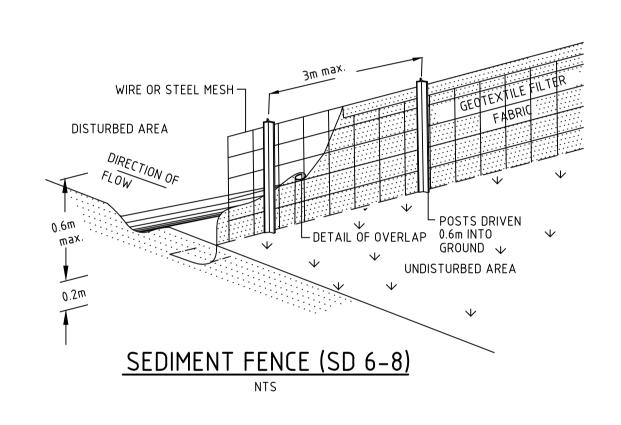


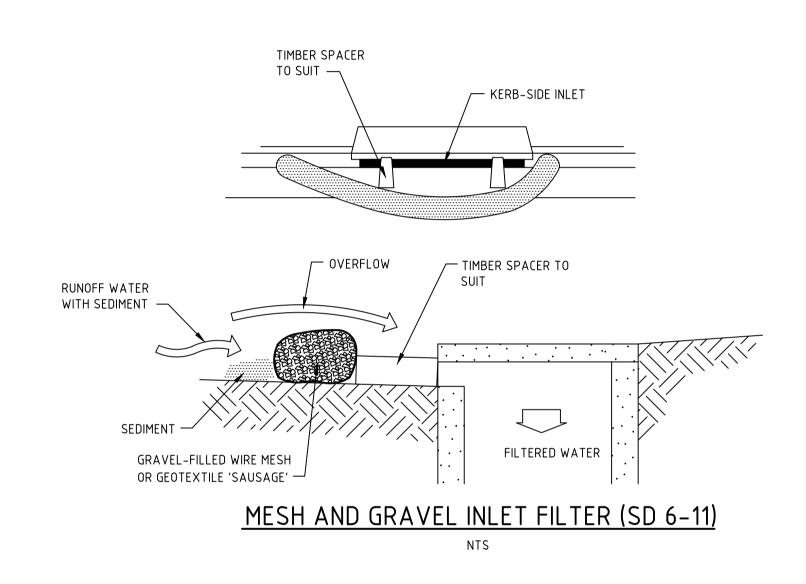

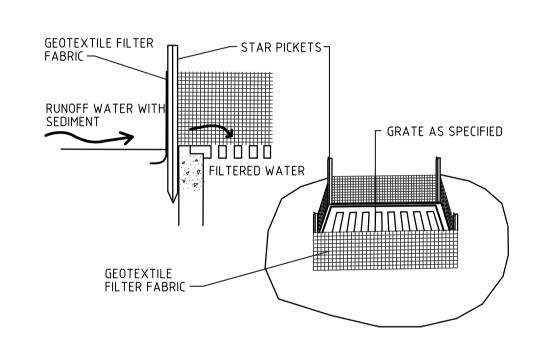

GEOTEXTILE FILTER PIT SURROUND (SD 6-12)
NTS

			Bar Scales
С	ISSUED FOR APPROVAL	22-07-19	
В	ISSUED FOR APPROVAL	17-07-19	
Α	ISSUED FOR APPROVAL	12-07-19	
Issue	Description	Date	

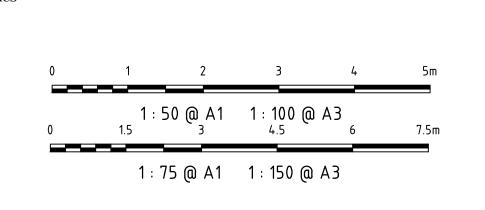

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Client	
	KARIMBLA CONSTRUCTION SERVICES (NSW) PTY LIMITED

Level 11, 528 Kent Street, Sydney NSW 2000
Tel: (02) 9287 2888 Fax: (02) 9287 2777
Email: info@design.meriton.com.au
Internet: http://www.meriton.com.au

Scales	AS SHOWN	Diawii	GJ	P
		Designed	GJ	
Grid	MGA	Checked	АТ	
Height Datum	AHD	Approved		T
		·		

2 MACPHERSON STREET	
WARRIEWOOD	
SUBDIVISION	
PACKAGE	

SEDIMENTATION AND EROSION CONTROL DETAILS

Civil Engineers and Proj	ect Managers
at&l	Level 7, 153 Walker St North Sydney NSW 200 ABN 96 130 882 405 Tel: 02 9439 1777 Fax: 02 9460 8413 www.atl.net.au info@atl.net.au

FOR AI	A1	
Drawing No.	Project No.	Issue
C081	18-580	С

SITE DATA

Oite and			Site	Do so o alco
Site area	1	2		Remarks
Total catchment area (ha)	0.29	0.32		
Disturbed catchment area (ha)	0.29	0.32		
Soil analysis				
% sand (faction 0.02 to 2.00 mm				Soil texture should be assessed thro
% silt (fraction 0.002 to 0.02 mm)				mechanical dispersion only. Disper
% clay (fraction finer than 0.002 mm)				agents (e.g. Calgon) should not be ι
Dispersion percentage				E.g. enter 10 for dispersion of 10%
% of whole soil dispersible				See Section 6.3.3(e)
Soil Texture Group				See Section 6.3.3(c), (d) and (e)
Rainfall data	1 5	I = I		Con Continue C 2 4 (d) and (n)
Design rainfall depth (days)	5	5		See Sections 6.3.4 (d) and (e)
Design rainfall depth (percentile)	85	85		See Sections 6.3.4 (f) and (g)
x-day, y-percentile rainfall event	44	44		See Section 6.3.4 (h)
Rainfall intensity: 2-year, 6-hour storm	13.5	13.5		See IFD chart for the site
RUSLE Factors				
Rainfall erosivity (R-factor)	3960	3960		Automatic calculation from above da
Soil erodibility (K-factor)	0.007	0.007		
Slope length (m)	80	80		
Slope gradient (%)	5	5		RUSLE data can be obtained from
Length/gradient (LS -factor)	1.19	1.19		Appendix es A, B and C
Erosion control practice (P -factor)	1.2	1.2		
Ground cover (C-factor)	1	1		
Calculations				
Soil loss (t/ha/yr)	40	40		
Soil Loss Class	1	1		See Section 4.4.2(b)
Soil loss (m³/ha/yr)	30	30	- 	000 0000011 4.4.2(b)
Sediment basin storage volume, m ³	2	2		See Sections 6.3.4(i) and 6.3.5 (e)

PEAK FLOW CALCULATIONS

 1 yr,tc
 0.9
 0.036
 0.039

 5 yr,tc
 0.95
 0.061
 0.067

 10 yr,tc
 1
 0.072
 0.079

 20 yr,tc
 1.05
 0.086
 0.095

 50 yr,tc
 1.15
 0.110
 0.121

 100 yr,tc
 1.2
 0.127
 0.140

Peak fl	ow calcu	lations,	1						
Site	Α	A tc		Rainfall intensity, I, mm/hr					C
Site	(ha)	(mins)	1 yr,tc	5 _{yr,tc}	10 yr,tc	20 yr,tc	50 yr,tc	100 yr,tc	C ₁₀
1	0.29	5	98.1	159	178	204	237	262	0.5
2	0.32	5	98.1	159	178	204	237	262	0.5
Peak fl	ow calcu	lations,	2						
4.5.	Frequency			Peak	flows		,		

Comment

TOTAL BASIN VOLUME

Total B	asin Vo	lume								
	Q _{tc, 0.25}	Q _{tc. 0.25} Area	1 - 1 ' 1	Settling Sediment storage	Total basin	Basin shape				
Site	(m ³ /s)	factor	area (m²)	zone (m)	volume (m³)	volume (m³)	volume (m³)	L:W Ratio	Length (m)	Width (m)
1	0.018	4100	73	0.6	44	2	46	3	14.8	4.9
2	0.020	4100	81	0.6	48	2	50	3	15.5	5.2
								,		
								Ì		
		1	•						•	l

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	Scales	NTS	Drawn	GJ	Pr
			Designed	GJ	
)	Grid	MGA	Checked	AT	
	Height Datum	AHD	Approved		L
	Datum				Ti

Project MACPHERSON STREET
WARRIEWOOD
SUBDIVISION
PACKAGE

SEDIMENTATION
AND EROSION
CONTROL
CALCULATIONS

Civil Engineers and Project Managers

Level 7, 153 Walker Street
North Sydney NSW 2060

ABN 96 130 882 405
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www.atl.net.au
info@atl.net.au

Status FOR APPROVAL A1
NOT TO BE USED FOR CONSTRUCTION

Drawing No. Project No. Issue

C082 18-580 C

ISSUED FOR APPROVAL

ISSUED FOR APPROVAL

ISSUED FOR APPROVAL

Description


Bar Scales


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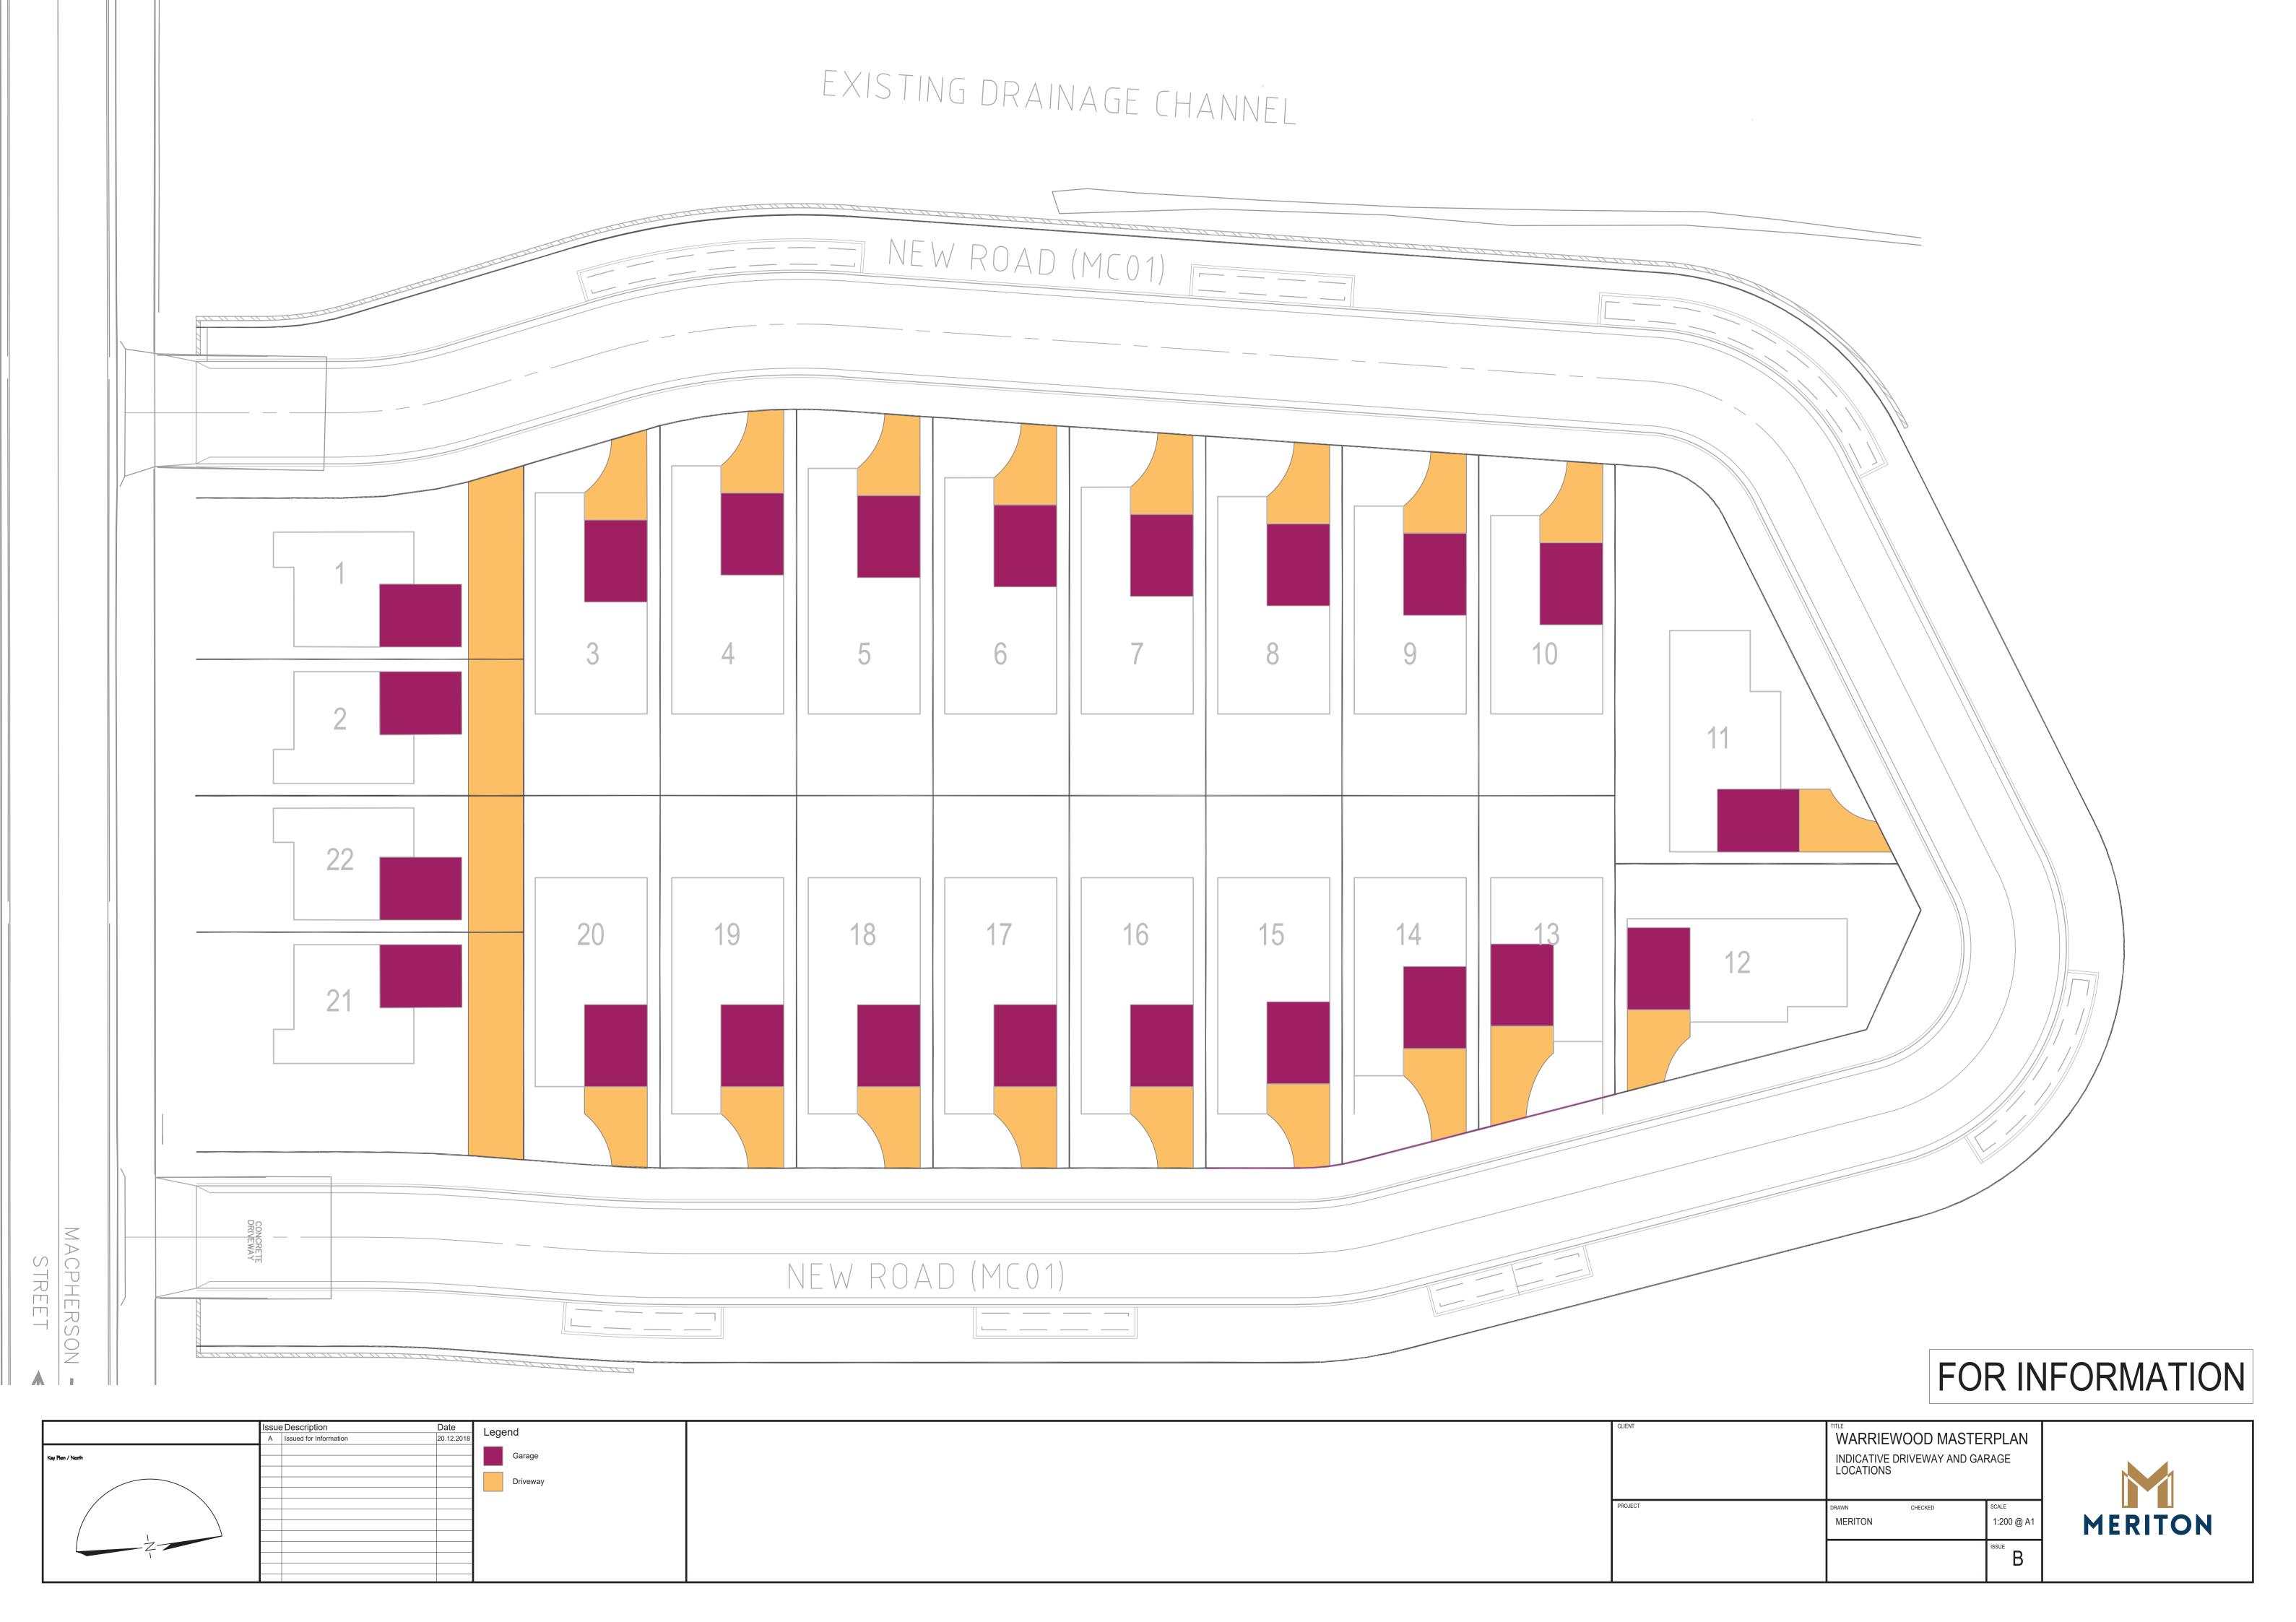
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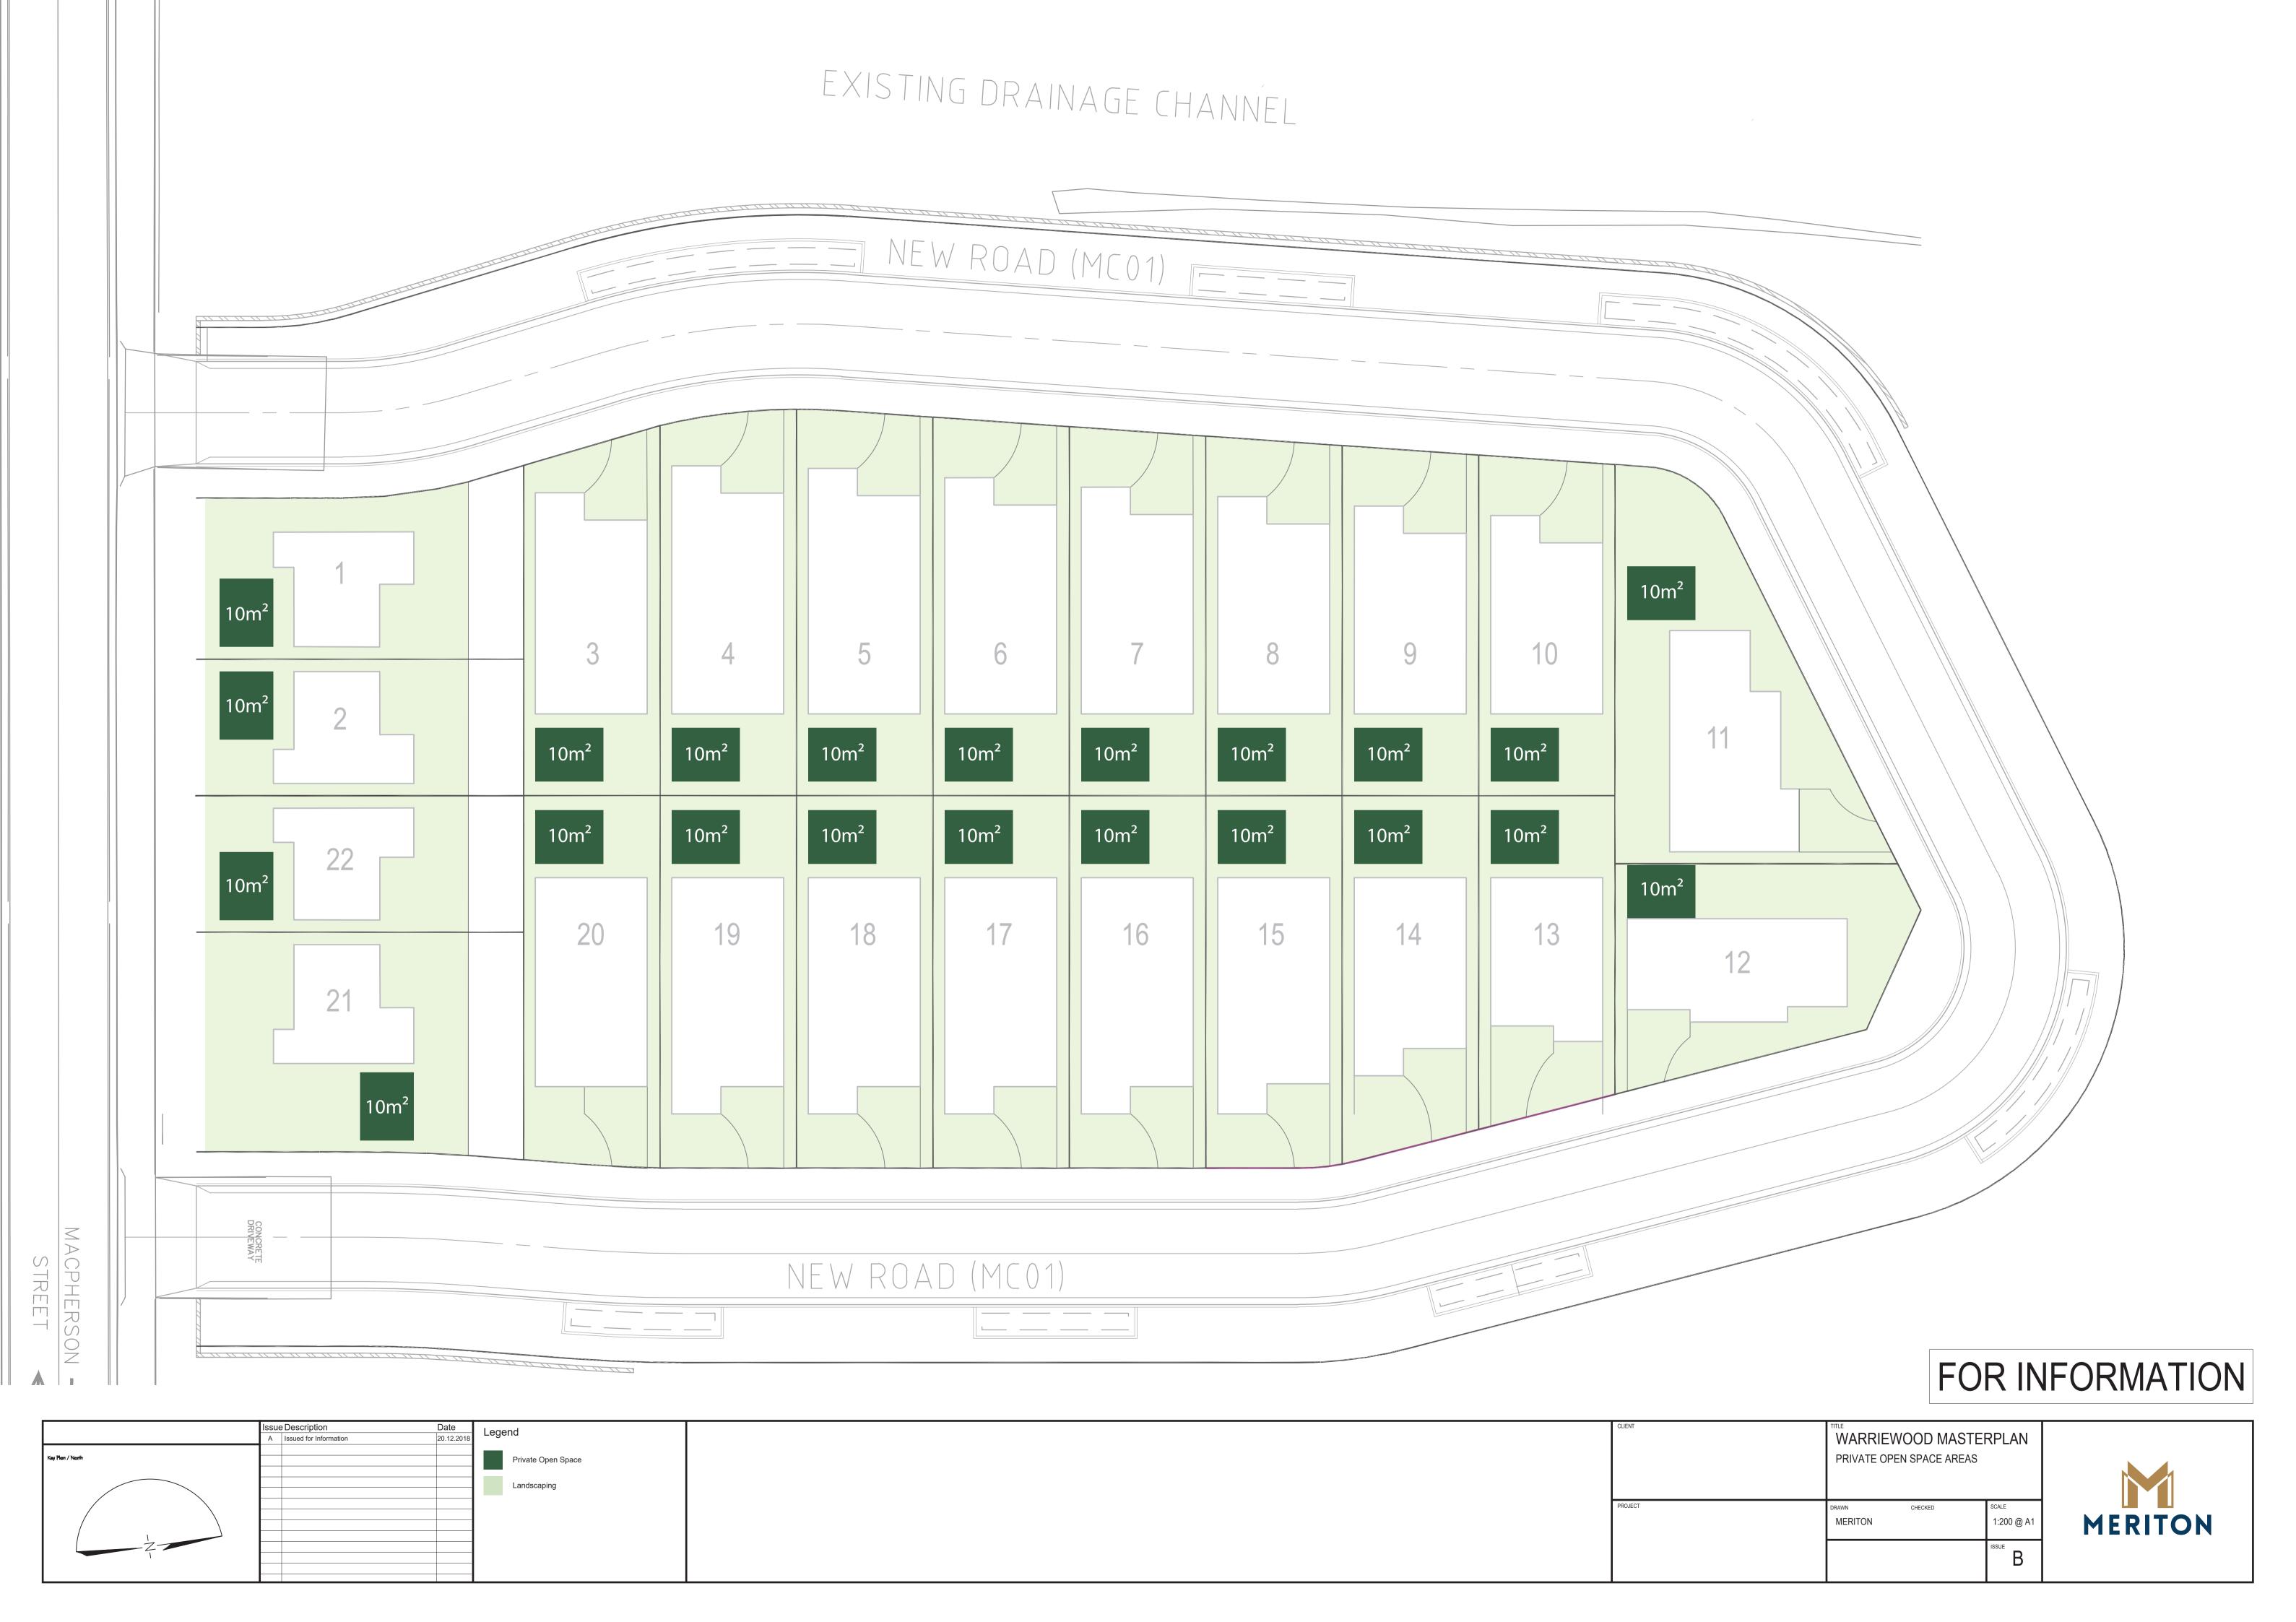
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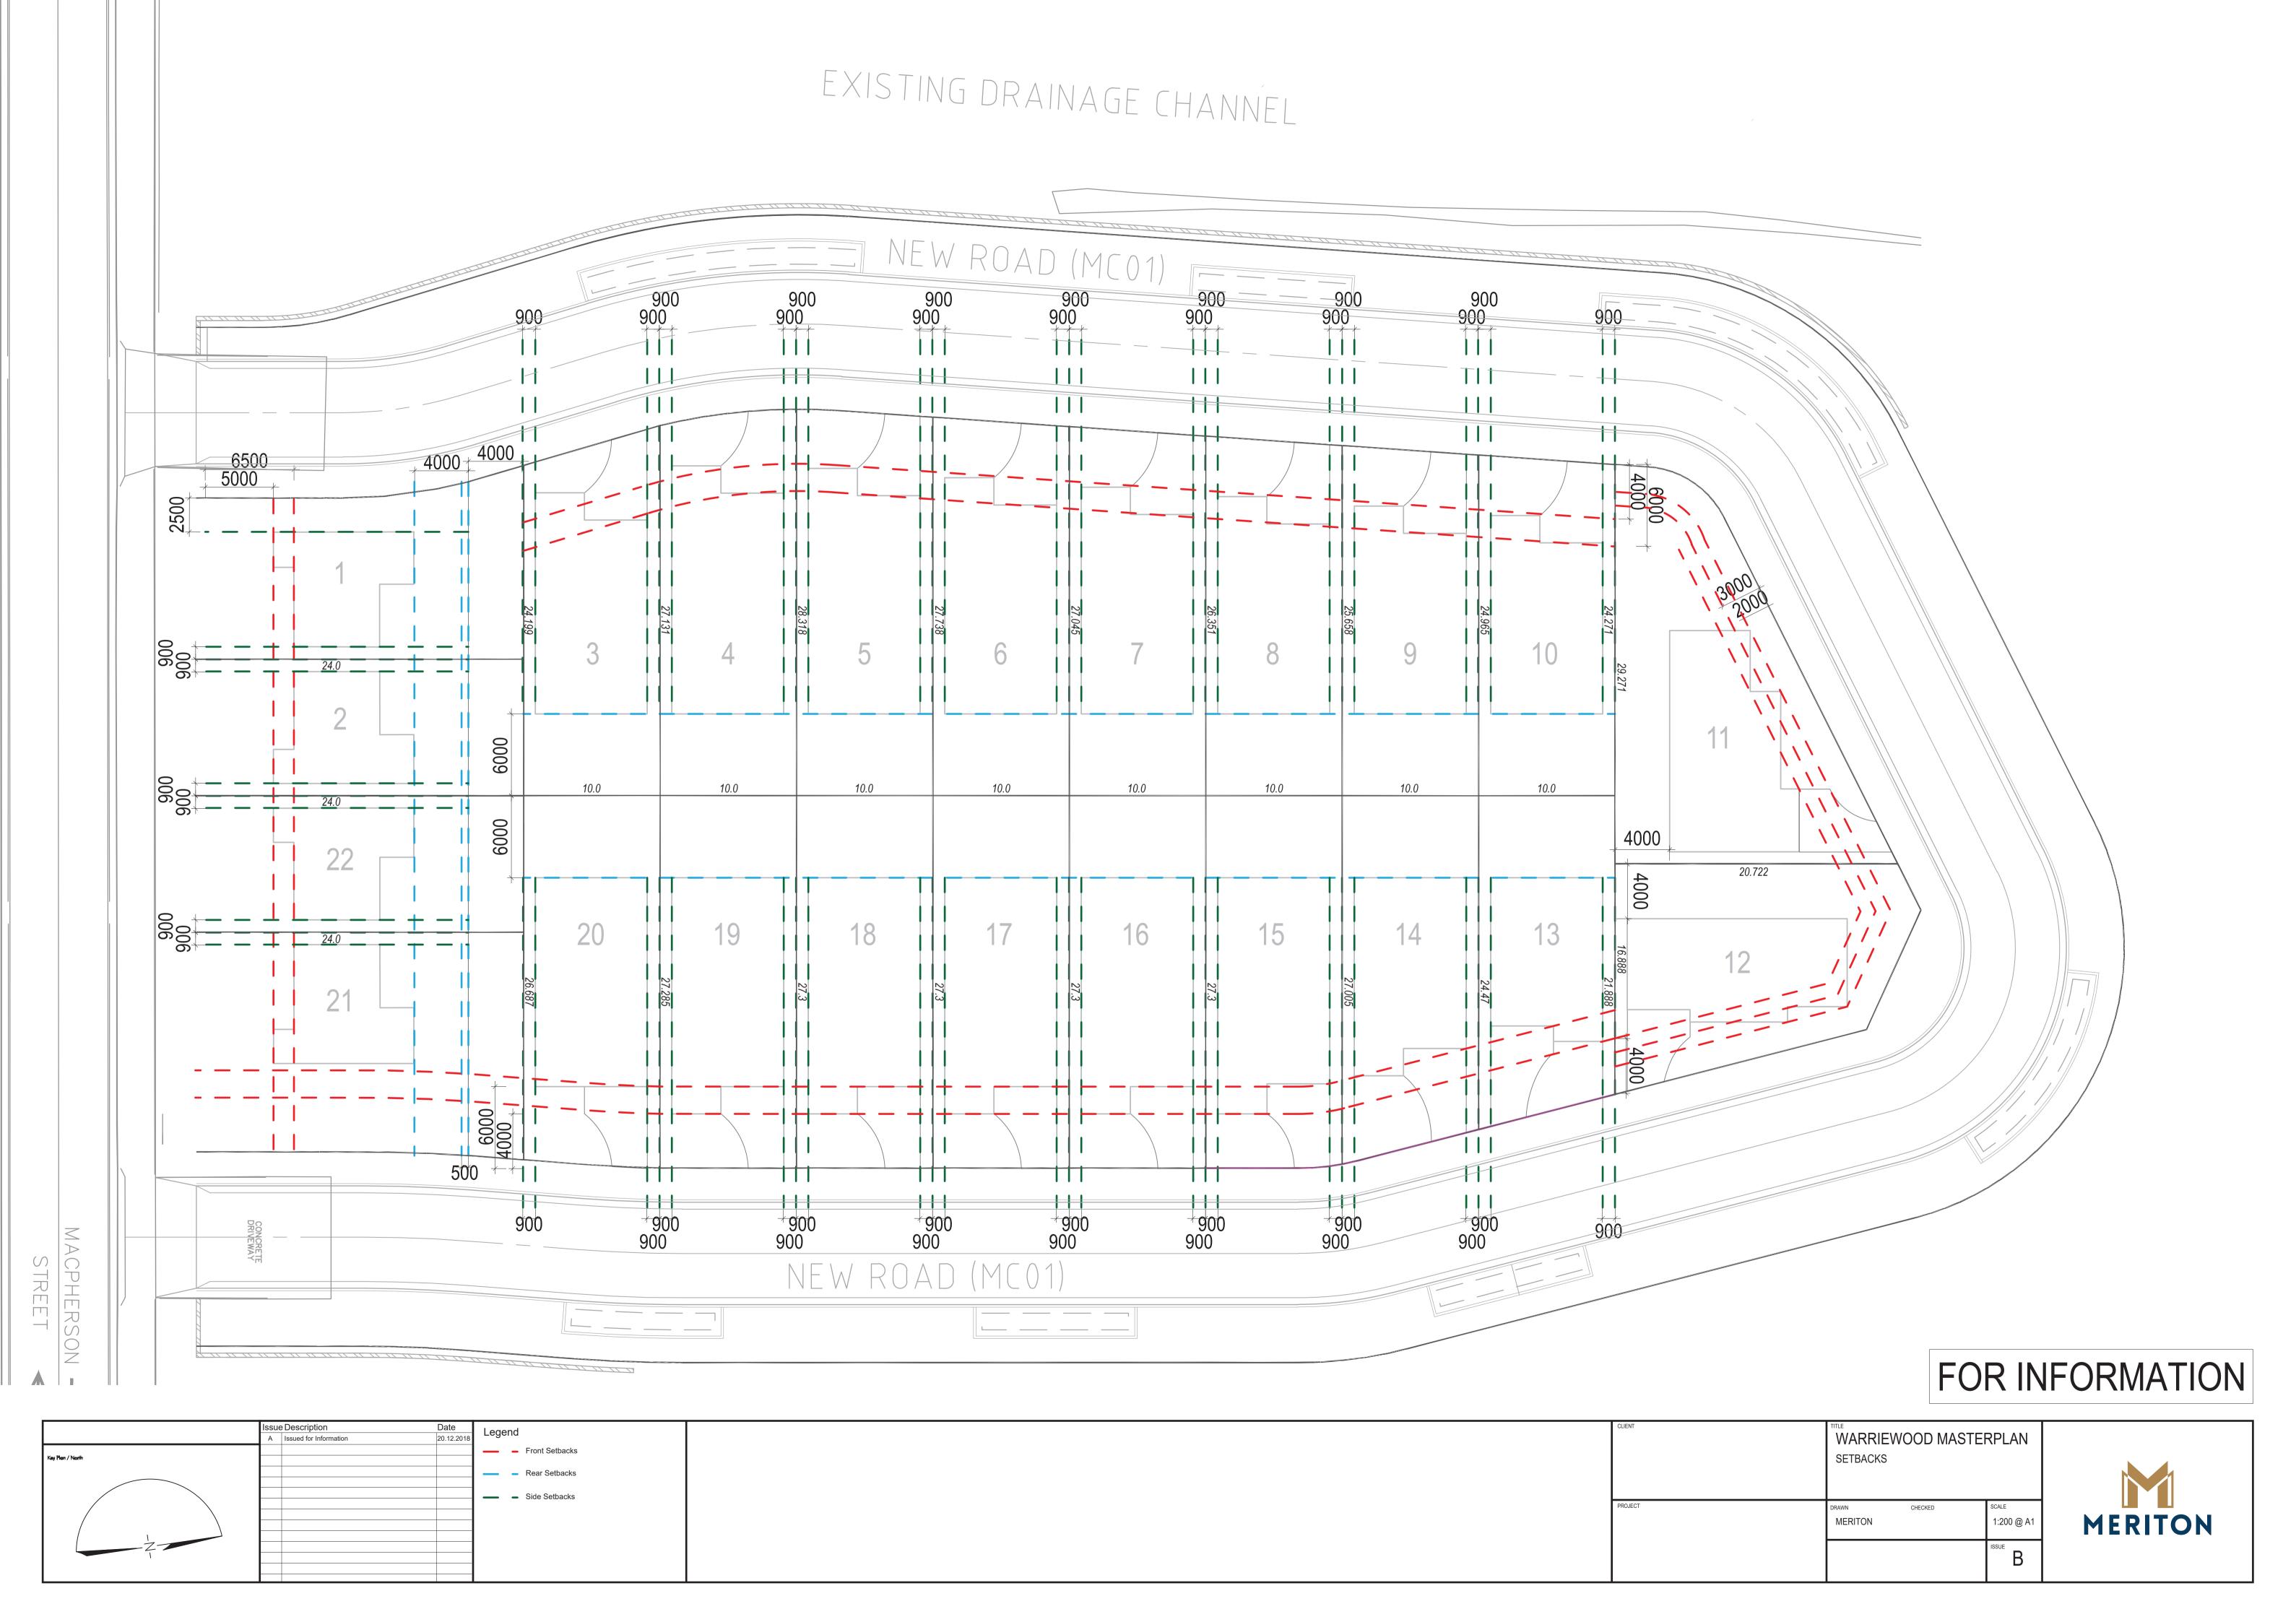
Date







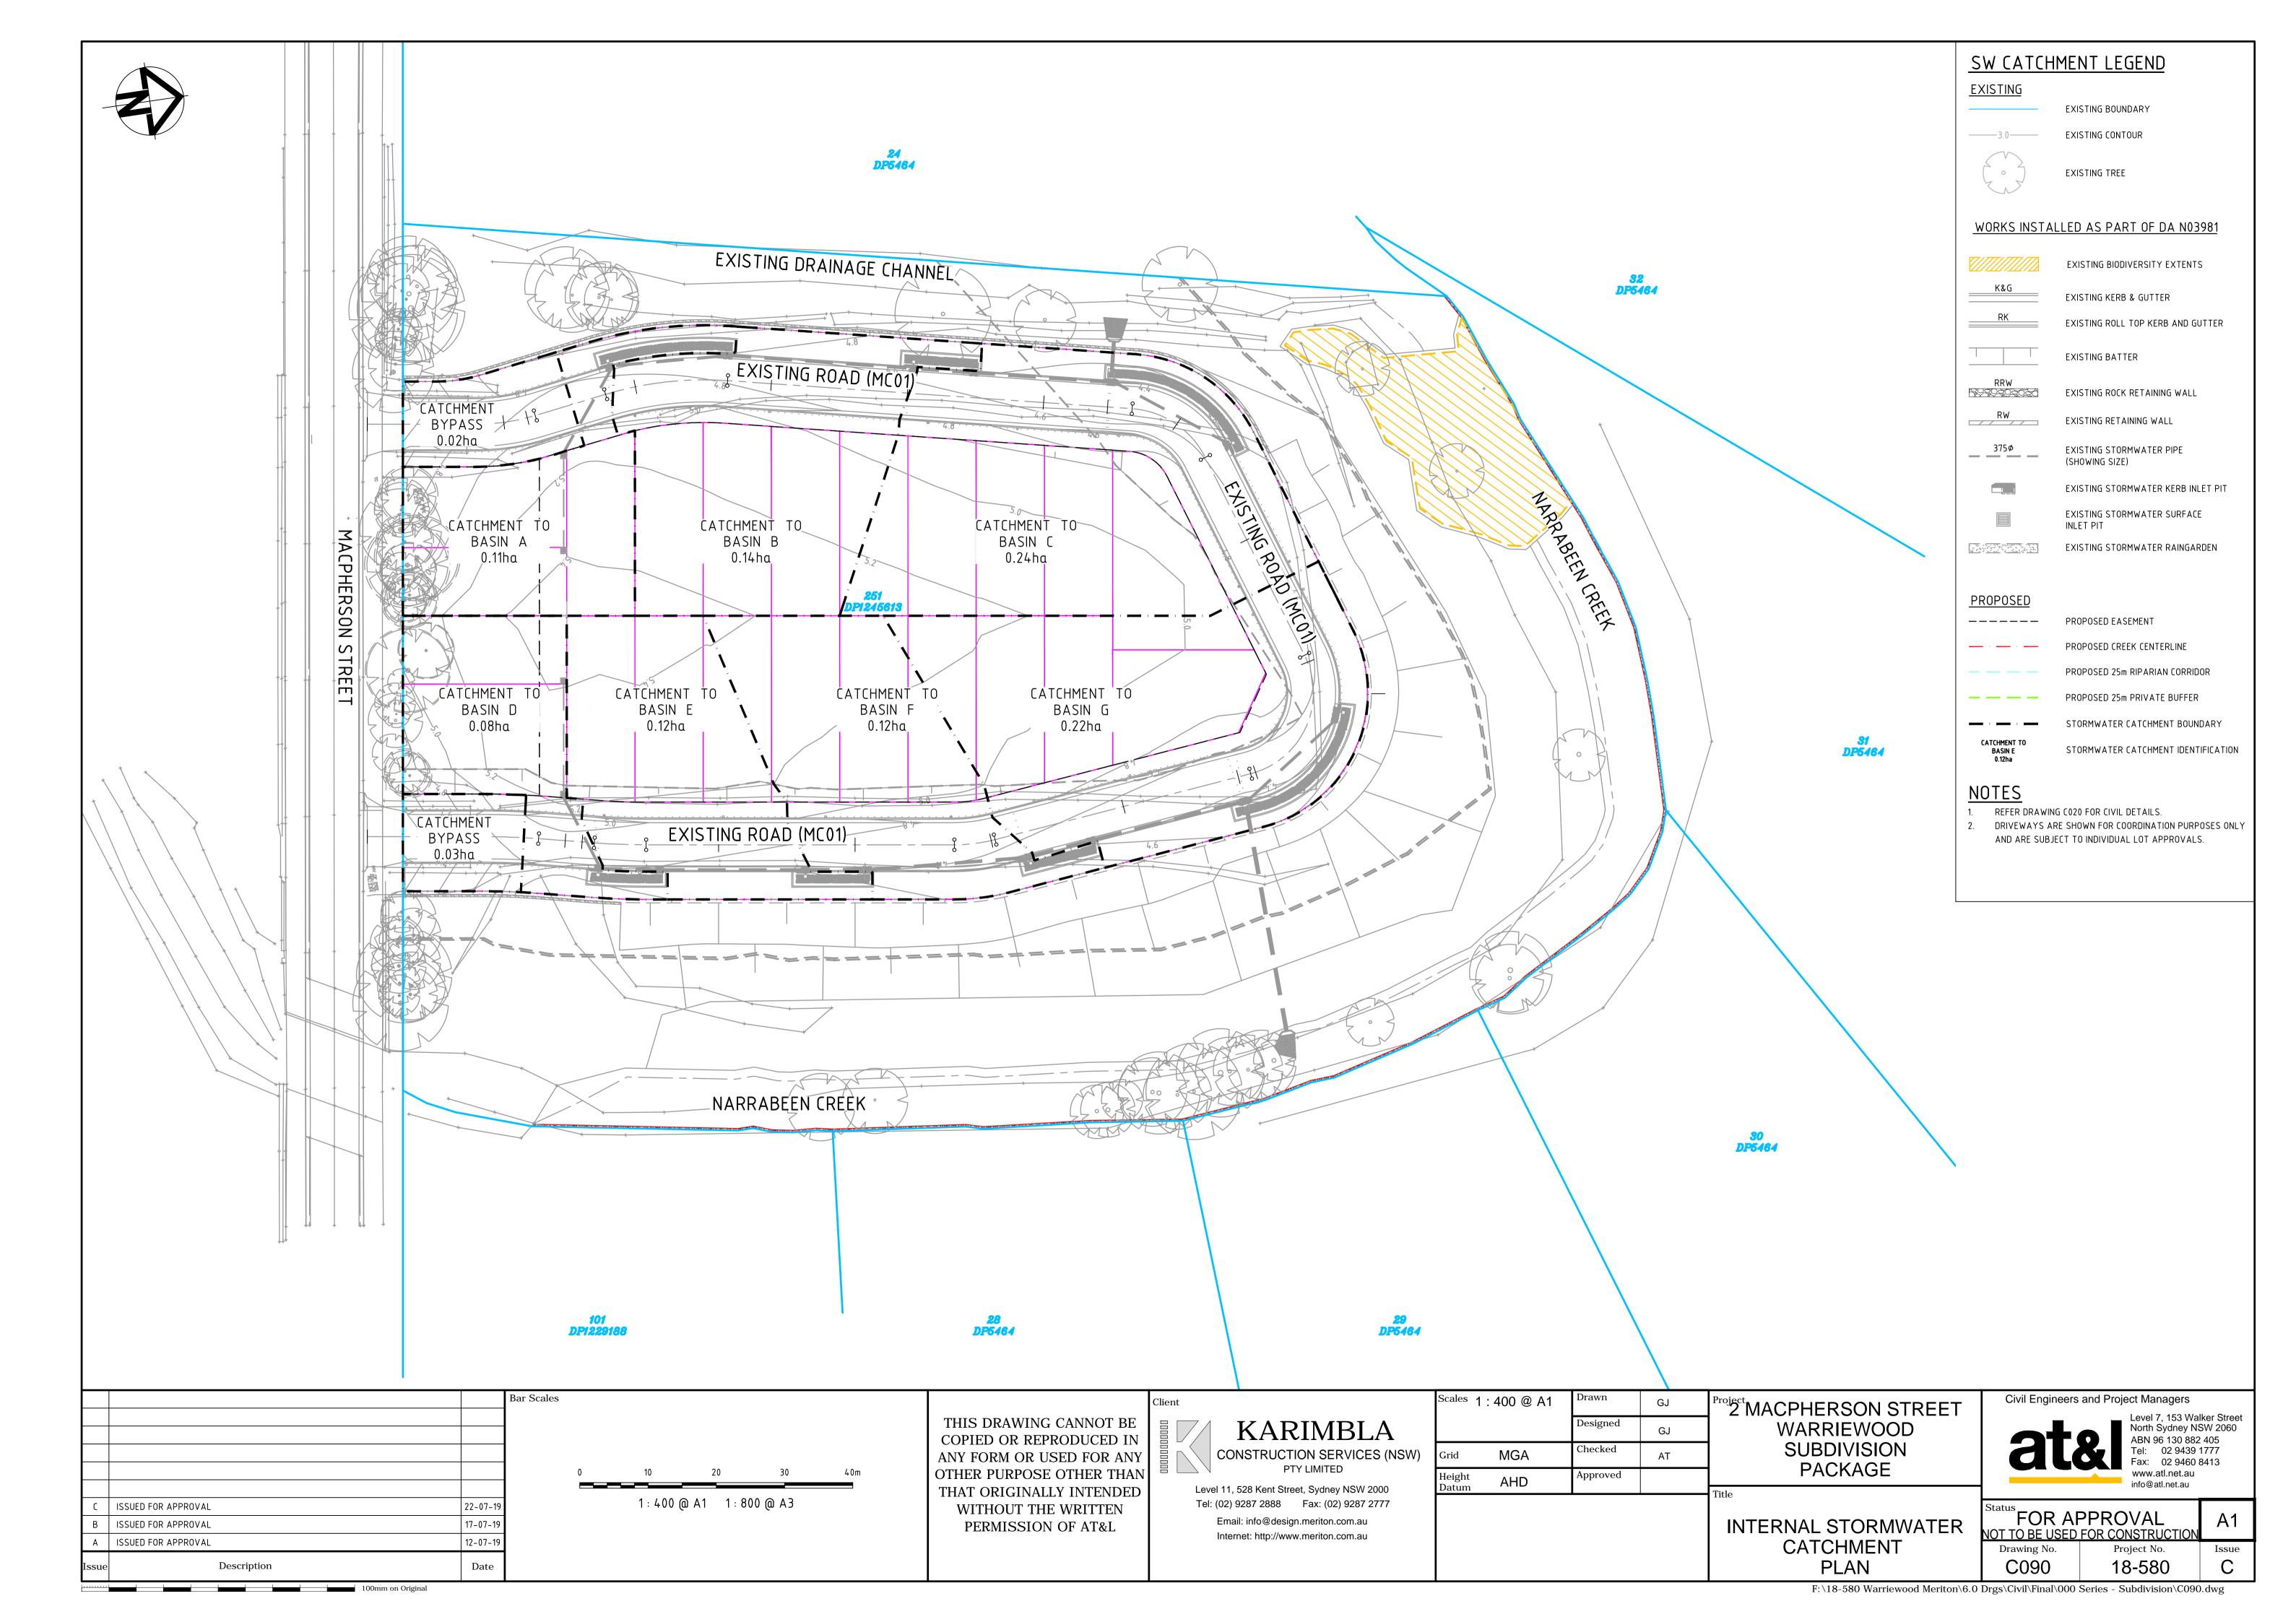

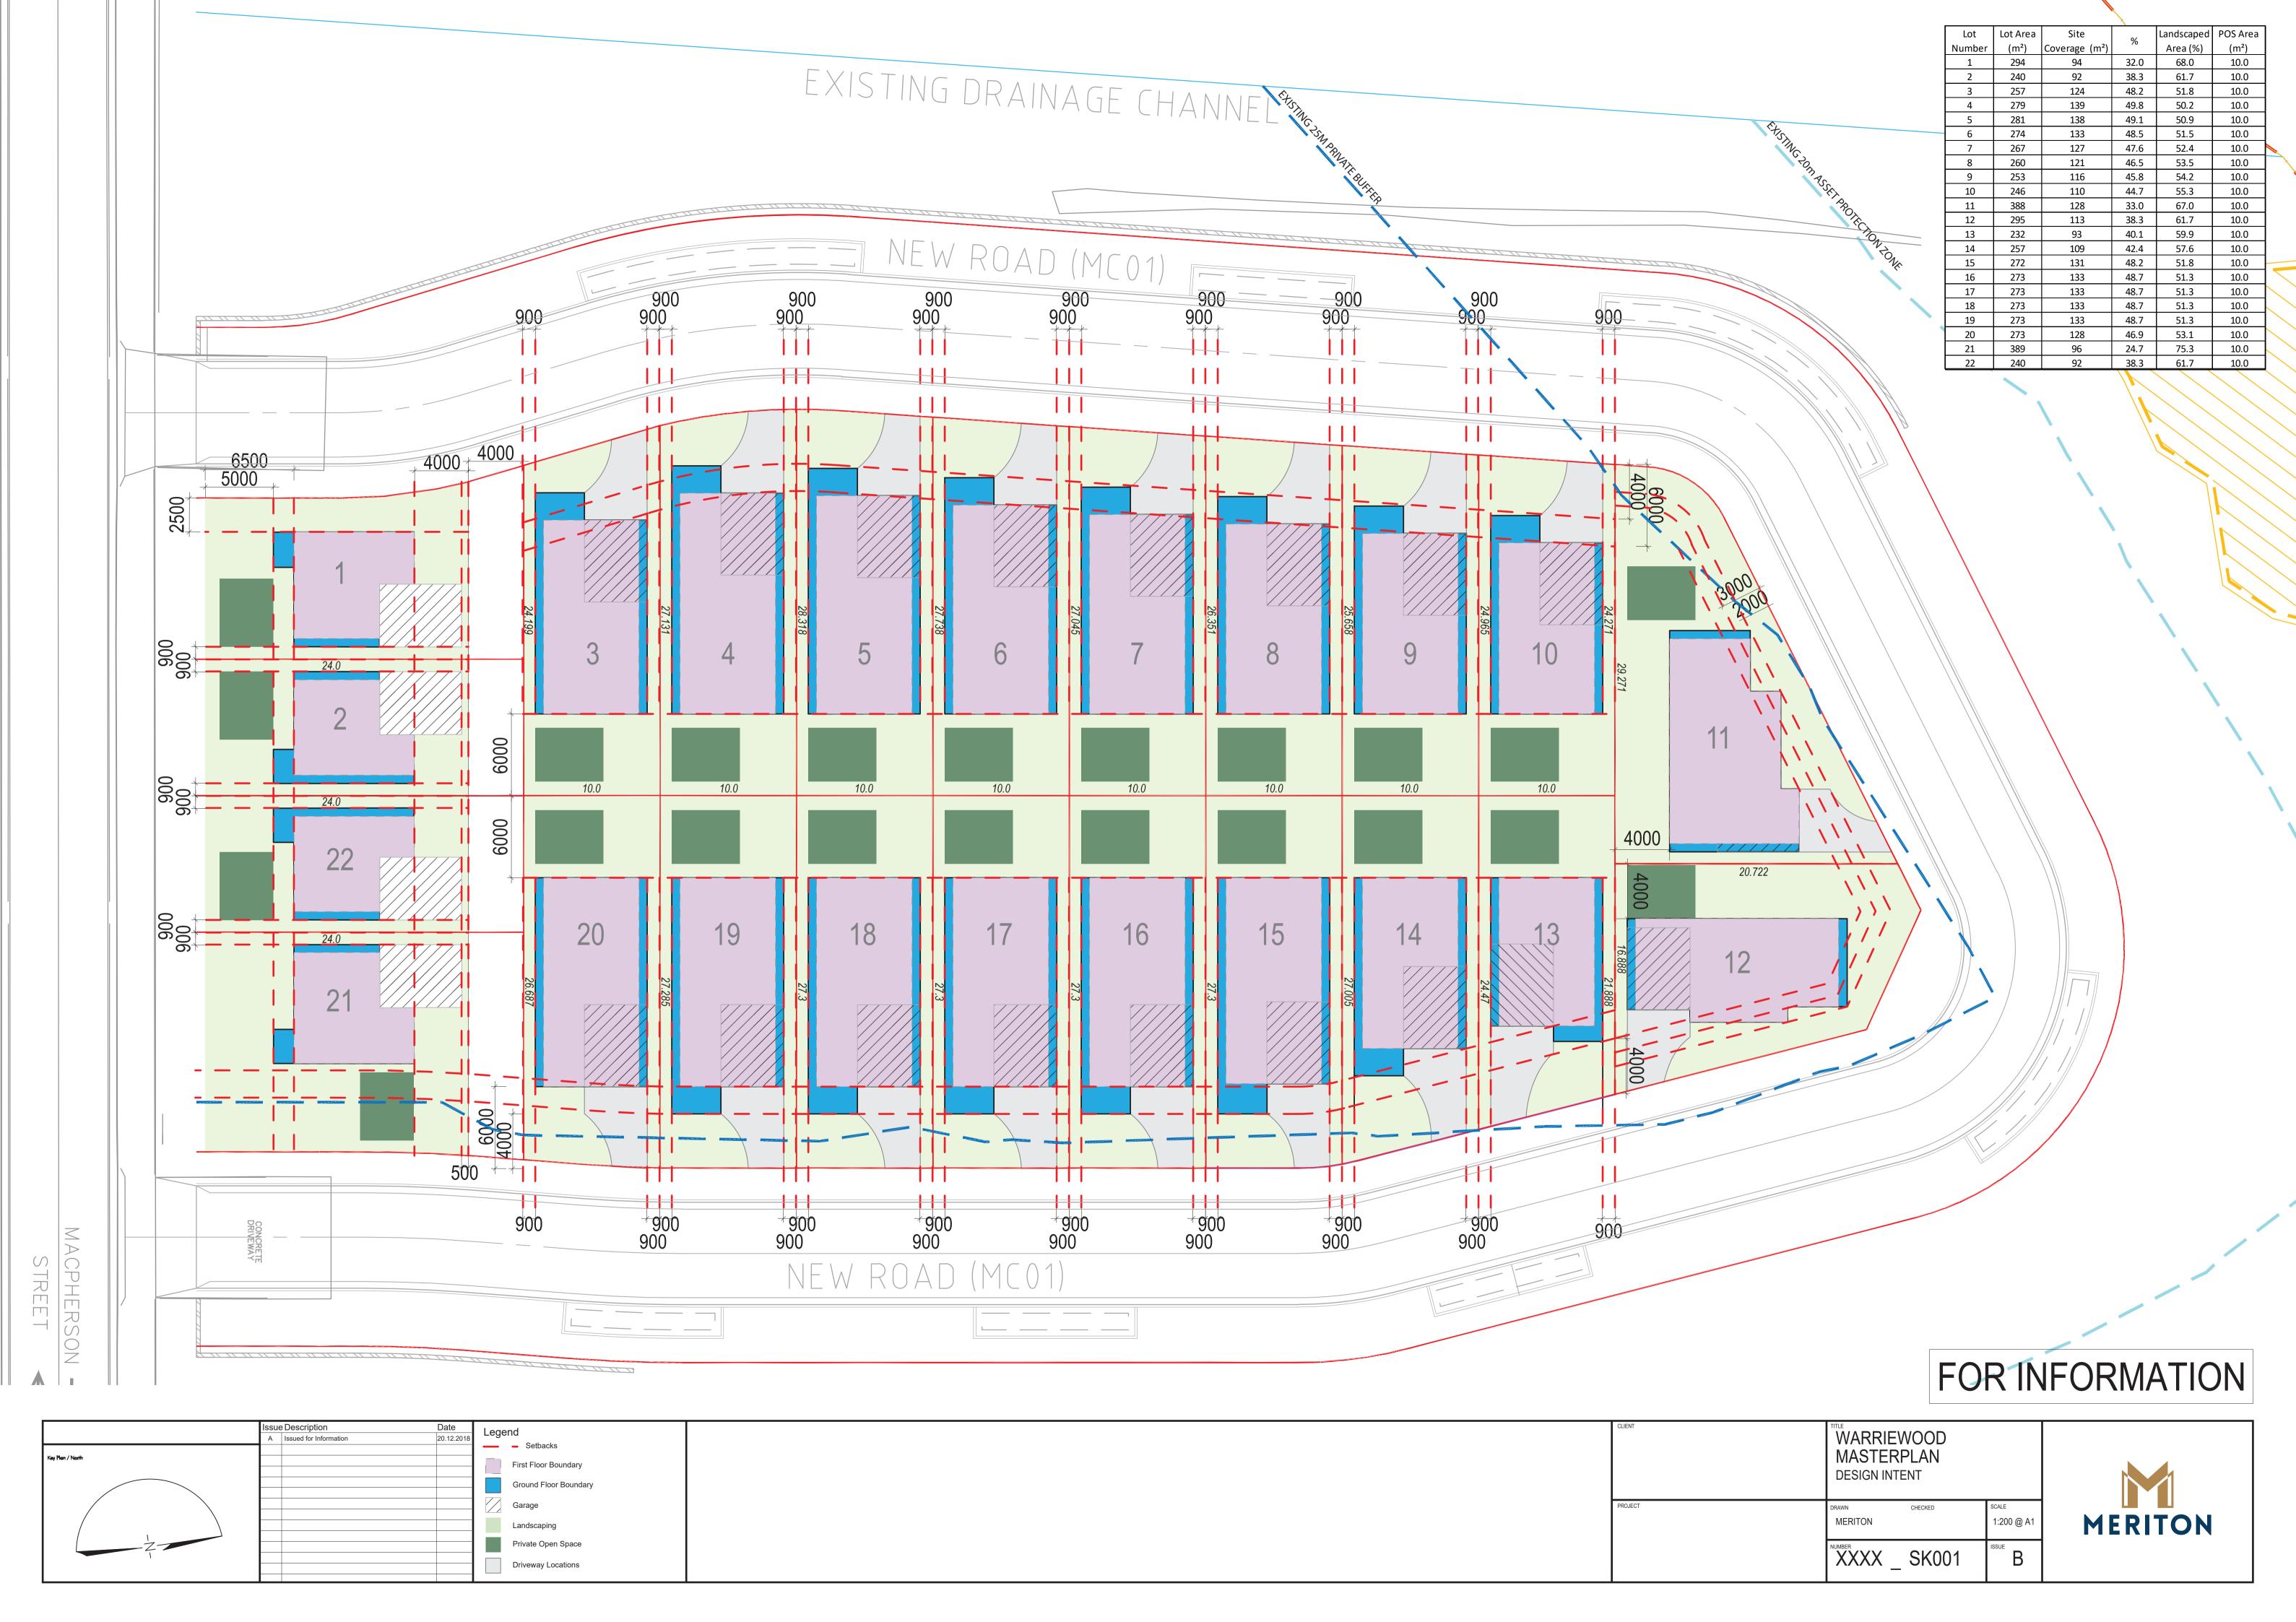


2 MACPHERSON STREET, WARRIEWOOD SUBDIVISION LANDSCAPE DEVELOPMENT APPLICATION

DRAWING REGISTER


DWG NO.	DRAWING NAME	SCALE	SIZE	ISSUE
L000	COVER SHEET, LEGEND, PLANT SCHEDULE & DRAWING REGISTER	NTS	A1	Α
L201	LANDSCAPE PLAN	1:200	A1	Α
L202	LANDSCAPE PLAN	1:200	A1	Α
L900	LANDSCAPE SECTION & DETAILS	AS SHOWN	A1	Α

PLANT SCHEDULE

STREETSCAPE	PLANTING						
PLANT CODE	BOTANICAL NAME	COMMON NAME	MATURITY HEIGHT AND SPREAD (m)	SUPPLY HEIGHT AND SPREAD (m)	CONTAINER SIZE	DENSITY/ m²	QTY
TREES							
TRI Iau	Tristaniopsis laurina Tuscious'	Water Gum	12m x 5m	4.5m x 2.5m	200L	as shown	21
	•		,			SUBTOTAL	21
Grasses							
LOM kat	Lomandra katrinus	Lomandra	0.8m x 0.8m	na	150mm	as shown	189
DIA cae	Dianella caerulea	Flax Lily	0.5m x 0.5m	na	150mm	as shown	189
			·			SUBTOTAL	378

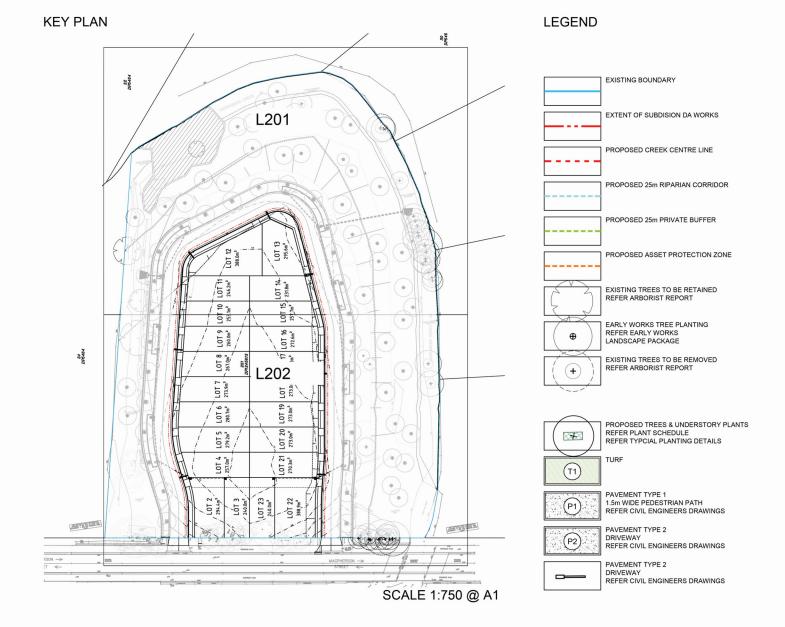

GENERAL LANDSCAPE NOTES

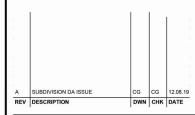


2 MACPHERSON ST,

WARRIEWOOD SUBDIVISION DA

LANDSCAPE **COVER PAGE**

DATE: 21.09.18 PROJECT NO: N/A	SCALE: AS SHOWN DRAWN BY: AS SHOWN	L000	A
APPROVED AND S	IGNED ON BEHLAF OF	NORTH	



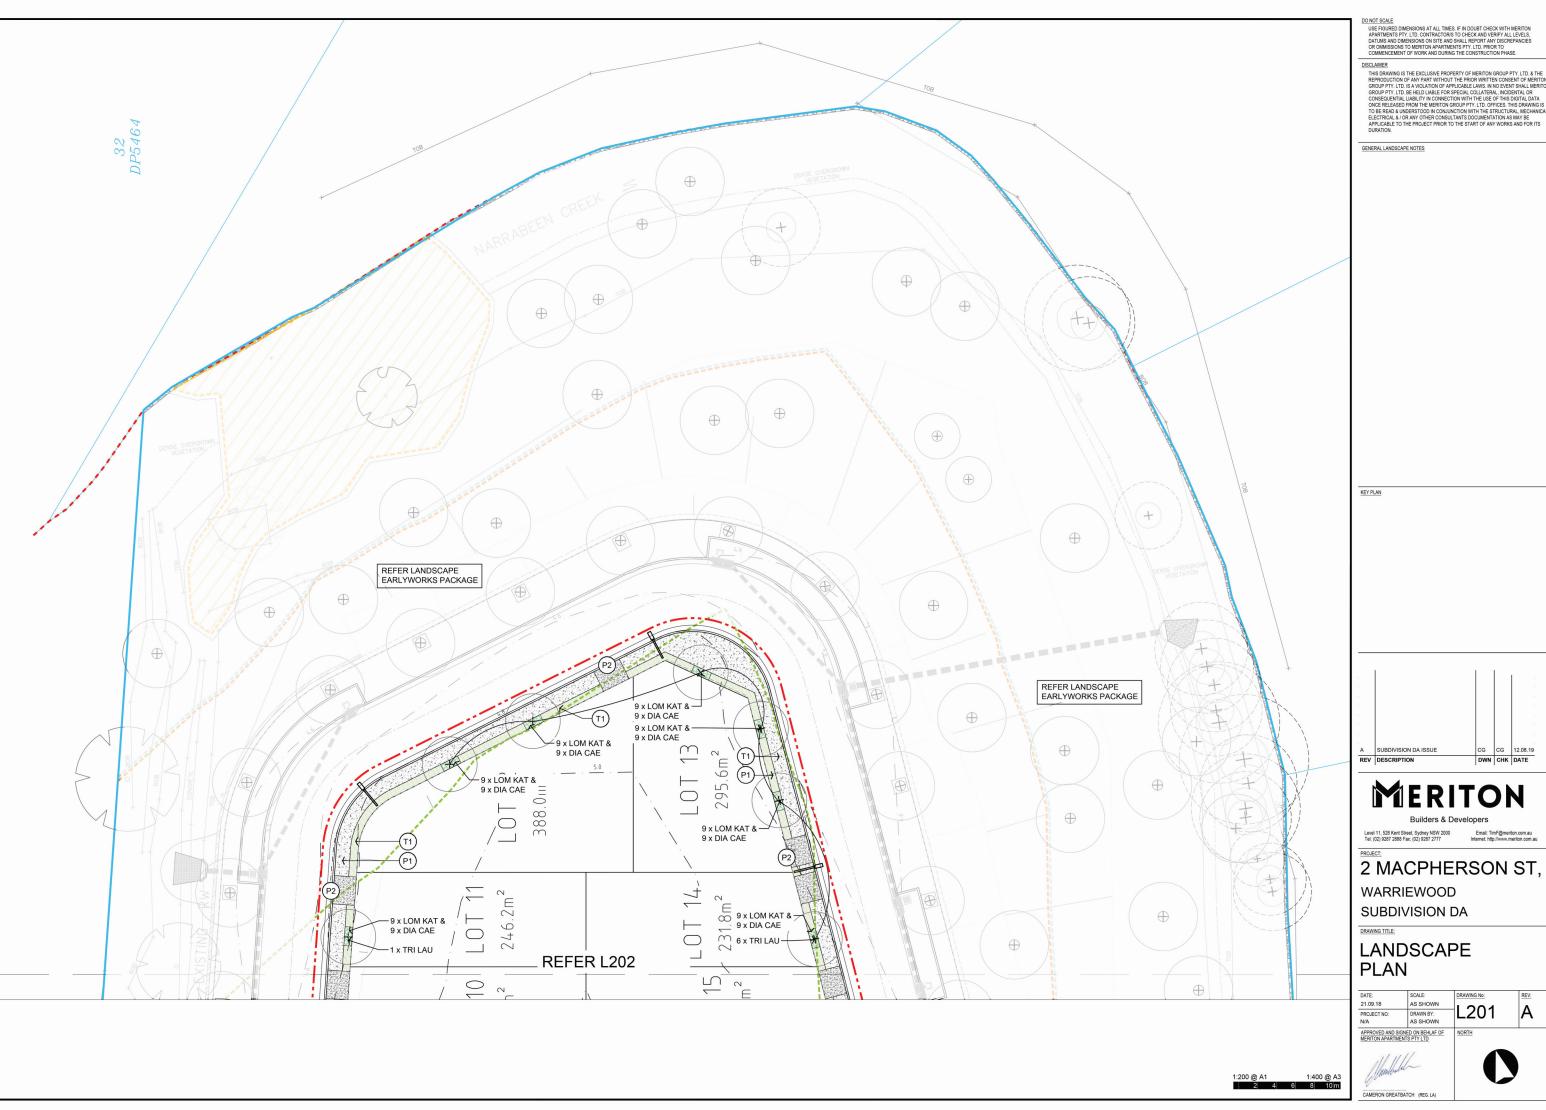



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WARRIEWOOD


SUBDIVISION DA

LANDSCAPE

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DATE: 21.09.18	SCALE: AS SHOWN	DRAWING No:	REV:
PROJECT NO: N/A	DRAWN BY: AS SHOWN	⊤L201	Α





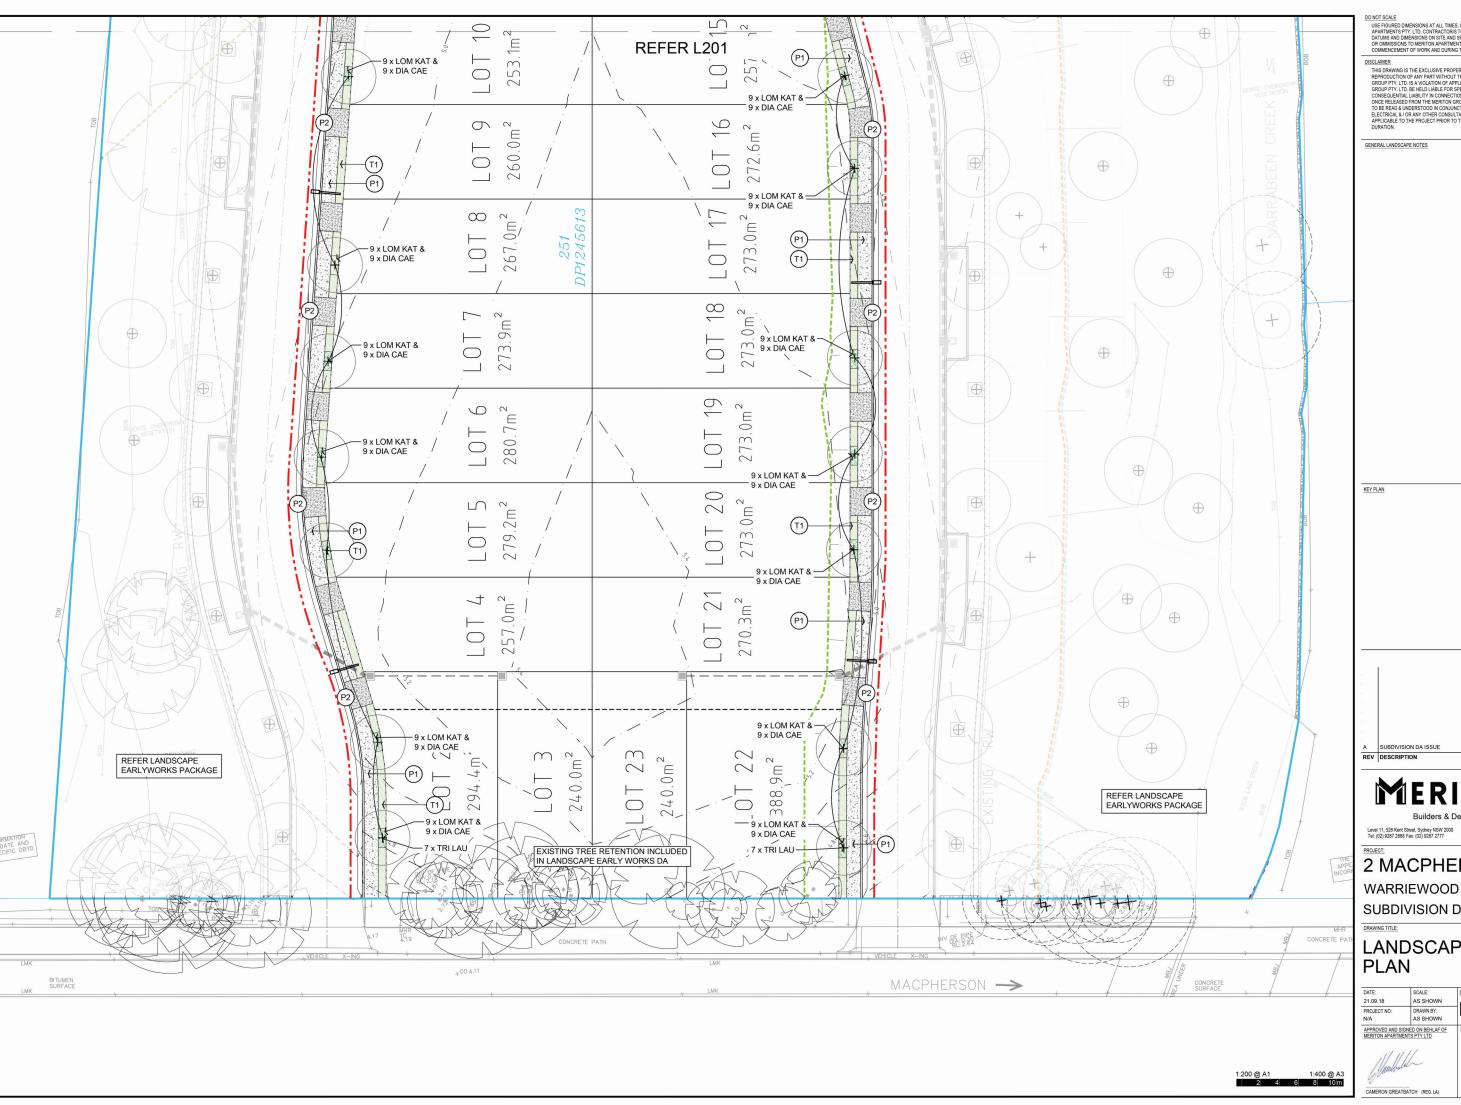

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SUBDIVISION DA ISSUE

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2 MACPHERSON ST,


SUBDIVISION DA

LANDSCAPE DI ANI

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DATE:	SCALE:	DRAWING No:
21.09.18	AS SHOWN	1 000
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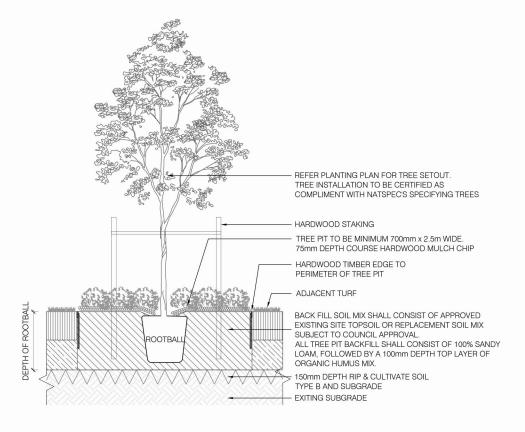
AS SHOWN



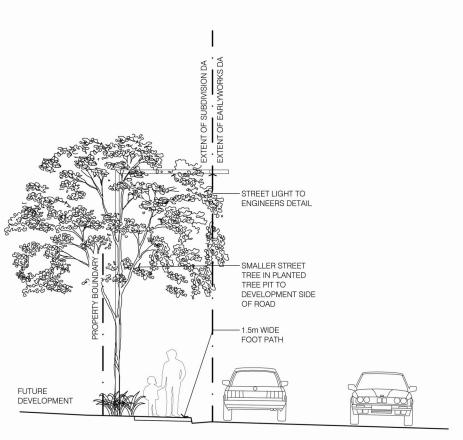

NEW ROAD (REFER ENGINEERS DRAWINGS)

01 TYPICAL LANDSCAPE SECTION
- SCALE 1:50 @ A1; 1:100 @ A3



02 TYPICAL TREE IN TURF DETAIL - SCALE 1:20 @ A1; 1:40 @ A3 DO NOT SCALE

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GENERAL LANDSCAPE NOTES

KEY PLAN

REV	DESCRIPTION	DWN	снк	DATE
Α	SUBDIVISION DA ISSUE	CG	CG	12.08.19

MERITON

Builders & Developers

Level 11, 526 Kent Street, Sydney NSW 20 Tel: (02) 9287 2888 Fax: (02) 9287 2777

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DRAWING TITLE:

LANDSCAPE DETAILS

21.09.18	AS SHOWN	1 000
PROJECT NO: N/A	DRAWN BY: AS SHOWN	L900
APPROVED AND SIGNED ON BEHLAF OF MERITON APARTMENTS PTY LTD		NORTH

CAMERON GREATBATCH (REG. LA)