#### DRAWING SCHEDULE

DRAWING NO.	DRAWING DESCRIPTION	SCALE/SIZE		
A00	COVER PAGE & SITE CALCULATIONS	NO SCALE / A3		
	DRAWING / DOCUMENT SCHEDULE			
A01	EXISTING GROUND FLOOR PLAN	1:100 / A3		
A02	EXISTING NORTH & EAST ELEVATIONS	1:100 / A3		
A03	EXISTING SOUTH & WEST ELEVATIONS	1:100 / A3		
A04	SITE ANALYSIS PLAN	1:200 / A3		
A05	PROPOSED SITE PLAN / ROOF PLAN	1:150 / A3		
A06	PROPOSED GROUND FLOOR PLAN	1:100 / A3		
A07	PROPOSED NORTH ELEVATION	1:100 / A3		
A08	PROPOSED EAST ELEVATION	1:100 / A3		
A09	PROPOSED SOUTH ELEVATION	1:100 / A3		
A10	PROPOSED WEST ELEVATION	1:100 / A3		
A11	PROPOSED SECTION AA	1:100 / A3		
A12	PROPOSED SECTION BB	1:100 / A3		
A13	CONCEPT STORMWATER PLAN	1:200 / A3		
A14	SEDIMENT CONTROL PLAN	1:200 / A3		
A15	3D RENDERINGS SHEET	NO SCALE / A3		
A16	EXTERNAL COLOUR & FINISHES SCHEDULE	NO SCALE / A3		
A17	A4 NOTIFICATION PLAN	1:200 / A4		
	SITE PLAN			
A18	A4 NOTIFICATION PLAN	1:200 / A4		
	PROPOSED ELEVATIONS			

### SITE CALCULATIONS

LOT 101 DP 32253	
AREA OF SITE 834.70s	qm
EXISTING GROUND FLOOR AREA 110.19s	qm
PROPOSED GROUND FLOOR AREA 55.64sq	m
TOTAL GROUND FLOOR AREA 165.83s	qm
EXISTING SITE COVERAGE ( DWELLING, POOL, PERGOLA ) 341.14s	qm (40.7%)
PROPOSED SITE COVERAGE ( DWELLING, POOL, PERGOLA, ADDITION) 424.36s	qm (50.07%)
PROPOSED SOFT LANDCAPING AREA 412.64s	qm (49.93%)

### DOCUMENT SCHEDULE

NO.	DOCUMENT DESCRIPTION	SIZE
1	APPLICATION FORM	A4
2	DEVELOPMENT APPLICATION CHECKLIST	A4
3	BASIX REPORT	A4
5	STATEMENT OF ENVIRONMENTAL EFFECTS	A4
6	DESIGNERS COSTING	A4
7	BUILDERS COSTING	A4
8	OWNERS CONSENT	A4
9	WASTE MANAGEMENT PLAN	A4



### SITE LOCATION PLAN (NTS)



		LEGEND		FLOOR LEVELS
الب الب	¥120.51	EXISTING SITE LEVEL	0000	PROPOSED LANDSCAPING
	x118.10	PROPOSED SITE LEVEL		
	•	RELATIVE SPOT LEVEL	21	NEW ROOF PITCH
		EXISTING WALLS		NEW LAWN AREA
		NEW STUD WALLS		
		NEW MASONRY WALLS		NEW PAVED AREA
		EXISTING WALLS/ ELEMENTS TO BEDEMOLISHED		NEW POOL AREA
ACCREDITED		SITE SECTION CUT LINES	FFL	FINISHED FLOOR LEVEL
ACCREDITED		SITE SETBACK LINES	V.11717	AREA TO BE FILLED WITH EARTH
		TREE PROTECTION ZONE		AREA TO BE FILLED WITH EARTH
BUILDING DESIGNER	Ŵ	EXISTING TREES TO BE RETAINED & PROTECTED		EXISTING GROUND LINE TO BE ALTERED

#### SITE CALCULATIONS

LOT 101 DP 32253	
AREA OF SITE	834.70sqm
EXISTING GROUND FLOOR AREA	110.19sqm
PROPOSED GROUND FLOOR AREA	55.64sqm
TOTAL GROUND FLOOR AREA	165.83sqm
EXISTING SITE COVERAGE ( DWELLING, POOL, PERGOLA )	341.14sqm (40.7%)
PROPOSED SITE COVERAGE (DWELLING, POOL, PERGOLA, ADDITION)	424.36sqm (50.07%)
PROPOSED SOFT LANDCAPING AREA	412.64sqm (49.93%)

SPECIFICATION
•••=•••••••••
THE BUILDER IS TO COMPLY WITH THE BO
AS APPLICABLE AND AUSTRALIAN STAND
PROVIDE ALL LABOUR AND MATERIALS TO
INCLUDE ANY ITEMS OBVIOUSLY INTENDE
ALTHOUGH NOT ACTUALLY SHOWN OR D
THIS DRAWING TO BE READ IN CONJUNC
STRUCTURAL ENGINEERS DRAWINGS, AN
MAY BE ISSUED DURING THE COURSE OF
ALL DIMENSIONS ARE IN MILLIMETERS. D
ALL GROUND LEVELS SHOULD BE VERIFI
WORKMANSHIP IN EACH TRADE TO BE IN
CURRENT BUILDING PRACTICE AND MATE
MATCH EXISTING WHERE APPLICABLE.
TIMBER FRAMING AND ROOFIN
TIE-DOWNS AS REQUIRED TO COMPLY W
TIMBER FRAMING CODE. FLOOR AND RO
REQUIRED, TO MANUFACTURERS DETAIL
FOUNDATIONS, CONCRETE FL
AND STRUCTURAL SUPPORTS
AS SHOWN ON PLANS AND ENGINEERING
CONCRETE TO AS3600. UNDER FLOO
TO PREVENT TERMITE INFESTATION.
TIMBER FLOORING TO BE CONCRE
AREA APPROVED FLOORING WHERE NEO
WINDOWS TO SIZES SHOWN ON PLAN
AS REQUIRED.
DOORS. FIX STANDARD 2040mm X 820
PLANS OPENING OD SUDING

mm OR WIDTHS AS SHOWN ON PLANS OPENING OR SLIDING. PLANS OPENING OR SLIDING. ROOFING As SHOWN ON PLANS, MINIMUM PITCH TO SUITE TYPE OF MATERIAL, FIXED TO MAKERS RECOMMENDATION. SARKING AND INSULATION AS REQUIRED. EAVES. PROVIDE FLAT FIBRE SHEETING INTO FASCIA BEADED EDGE OR BARGE BOARD ON GABLES WHERE REQUIRED.

EDGE OR BARGE BOARD ON GABLES WHERE REQUIRED. PLUMBING. ALL PLUMBING TO COMPLY WITH THE LOCAL AUTHORITY AND IS TO BE CARRIED OUT BY A LICENCED PLUMBER. ALL PIPING TO BE IN PVC TUBING AND WELL FASTENED. ELECTRICAL. PROVIDE SUPPLY TO POWER AND LICHT OUTLETS IN ACCORDANCE WITH SUPPLY AUTHORITY. POSITIONED AS INDICATED FOR LIGHT AND POWER POINTS, ETC AS INDICATED BY OWNER. HARD-WIRED SMOKE DETECTORS TO BE INSTALLED TO ENSURE THE BUILDING CAN BE EVACUATED IN AN EMERGORY. INTERNAL LININGS TO BE GYPENCY BI ASTERBOARD MININUM INTERNAL LININGS TO BE GYPROCK PLASTERBOARD MINIMUM 10mm THICKNESS. FIX AND JOINT IN THE NORMAL MANNER. ALL JOINTS TO BE TAPED AND SET. INSTALL COVE CORNICE AND 2 VENTS TO KITCHEN, BATHROOM AND LAUNDRY.

1	DEVELOPMENT APPLICATION	15.11.2
ISSUE	REVISION DESCRIPTION	DATE
<sup>Chent:</sup> MS	BARBI HOFMOCKE	EL

### BUILDING SPECIFICATION AND LEGEND

BCA AND ORDINANCES IDARDS. THE BUILDER TO TO COMPLETE THE WORKS. ED AND NECESSARY,

DED AND NECESSARY, DESCRIBED. CTION WITH THE SPECIFICATION, AND ANY OTHER DOCUMENT THAT

F CONSTRUCTION. OO NOT SCALE DIMENSIONS

FIED BY A QUALIFIED SURVEYOR. IN CONFORMITY WITH TERIALS AND FINISH TO

ING, INCLUDING BRACING AND WITH AS1684 -OOF TRUSSES, WHERE

#### OORS

NG DETAIL AS2870 AS APPLICABLE. OR AREAS TO BE TREATED

ETE IN GARAGE & TILED IN WET CESSARY.

N OR TO MATCH EXISTING

WALL AND FLOOR TILING. SUITABLY PREPARE ALL FLOOR VALL AND FLOOR TILLING. SUITABLY PREPARE ALL FLOO SURFACES ENSURING THAT ALL JOINTS ARE SEALED. GRADE FLOORS EVENLY TO APPROPRIATE FLOOR WASTE IF NOT TO AN EXTERNAL DOOR. SELECTED TILES AS REQUIRED AS ARRANGED WITH OWNER.

WITH OWNER. PAINTING. FOLLOW PAINT MANUFACTURERS INFORMATION FOR ALL ASPECTS OR EXTERIOR AND INTERIOR COATINGS, CARRIED OUT TO OWNERS REQUIREMENTS.


OUT TO OWNERS REQUIREMENTS. BRICKWORK TO BE BUILT UP TO THE REQUIRED HEIGHT, LEVEL. STRAIGHT AND PUMB WITH JOINTS AND PERPENDS NOMINAL 10mm AND DAMP COURSED IN THE NORMAL MANNER. BRICK VENEER TO HAVE 38mm CAVITY BONDED TO STUDS WITH GALV. TES 1 METRE APART EVERY FOURTH COURSE. INSTALL BIRD WIRE TO PREVENT ACCESS BY VERMIN INTO CAVITES. ENGAGED PIERS TO BE 110mm BRICKWORK AT 1800mm C. AND TO AUSTRALLAN STANDARD 3700. DOUBLE BRICK WALLS TO HAVE 50mm CAVITY AND FOUR BRICK TIS PER SQUARE METRE BUILT INTO WALLS. UNDER FLOOR BRICK PIERS TO BE 230mm X 230mm UP TO 1.5m HIGH USUALLY AT 1.8m C. ON 400mm X 400mm X 200mm HIGH CONCRETE PADS. BRICKWORK OVER OPENINGS TO BE SUPPORTED ON GALV. MILD STELL LINTELS. AS2159-1995 FOR GALV. COATINGS. TIMBER POST SUPPORTS TO BE BOLFD TO GALV. STEEL BASES 25mm CLEAR OF PATIO. BALUSTRADING TO COMPLY WITH PART 3.9.2 BCA 89 VOLZ. ANY OPENINGS IN THE BALUSTRADING SHOULD NOT PERMIT A 125mm SPHERE TO PASS THROUGH IT.


STAIR CONSTRUCTION TO COMPLY WITH PART 3.9.1 BCA96 VOL2 INCLUDING GEOMETRY AND CONSTRUCTION REQUIREMENTS. EAVES GUTTERING. QUAD OR FASCIA GUTTERING AS REQUIRED DIRECTED TO STREET IN APPROVED DRAINAGE LINES OR DISPOSED OF TO COUNCIL REQUIREMENTS.

#### NOTES

BUILDER MUST CHECK DIMENSIONS ON SITE IN PRIORITY TO FIGURED DIMENSIONS. IF A MINIMUM TO A BOUNDARY IS CRITICAL AND THE BOUNDARY IS NOT CERTAIN A CHECK SURVEY IS DESIRABLE.

LEVELS SHOWN ARE REASONABLY ACCURATE. THE BUILDER EVECS SHOWEN ARE RESONABLE ACCONDITIONS. WILDER SHOULD VISIT THE SITE AND CHECK CONDITIONS. WILERE STORM WATER TRENCHES ARE REQUIRED, SIZE TO BE 600mm X 600mm X 1000mm LONG FOR EACH 15 SQUARE METRES OF ROOF AREA. POSITION FOR MAXIMUM SOAKAGE WHERE POSSIBLE ALL STORM WATER WORKS TO MEET THE REQUIREMENTS OF PT.3.1.2 OF THE BCA AND AS3500.3.2. INSTALL AGRI PIPE DRAINS WHERE BCA AND ASSOLUTE. INFORMATION AND THE DIVING WHENE NECESSARY TO PREVENT SEPAGE WATER INTRUSION. ALL TERMITE TREATMENT TO BE CARRIED OUT IN ACCORDANCE WITH AS 3660. SMOKE DETECTORS TO BE INSTALLED AND CONNECTED TO AS3786

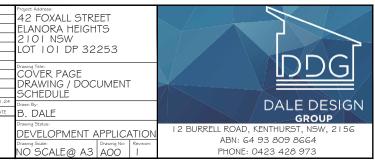

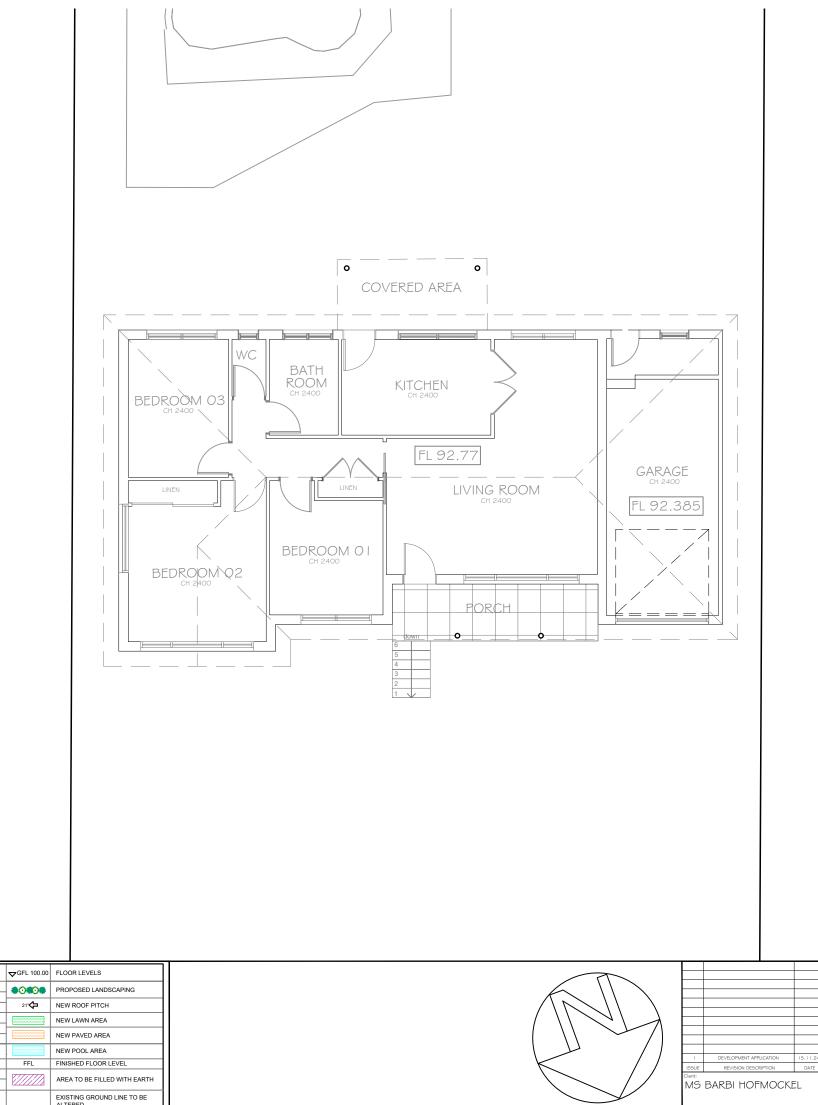

	LEGEND	<b>▽</b> GFL 100.00	FLOOR LEVELS
* <sup>120,01</sup>	EXISTING SITE LEVEL		PROPOSED LANDSCAPING
x118.10	PROPOSED SITE LEVEL		
•	RELATIVE SPOT LEVEL	21%	NEW ROOF PITCH
	EXISTING WALLS		NEW LAWN AREA
	NEW STUD WALLS		
	NEW MASONRY WALLS		NEW PAVED AREA
	EXISTING WALLS/ ELEMENTS TO BEDEMOLISHED		NEW POOL AREA
	SITE SECTION CUT LINES	FFL	FINISHED FLOOR LEVEL
	SITE SETBACK LINES	V.11111	AREA TO BE FILLED WITH EAF
	TREE PROTECTION ZONE		AREA TO BE FILLED WITH EAP
(i)	EXISTING TREES TO BE RETAINED & PROTECTED		EXISTING GROUND LINE TO B ALTERED
		EXISTING SITE LEVEL     EXISTING SITE LEVEL     RELATIVE SPOT LEVEL     EXISTING WALLS     NEW STUD WALLS     NEW MASONRY WALLS     EXISTING WALLS/ ELEMENTS     TO BEDEMOLISHED     SITE SETDACK LINES     SITE SETDACK LINES     TREE PROTECTION ZONE	KING SITE LEVEL     KELATIVE SPOT LEVEL     KELATIVE SPOT LEVEL     KELATIVE SPOT LEVEL     KELATIVE SPOT LEVEL     KEW STUD WALLS     KEW MASONRY WALLS     KEW SCONRY WALLS     SITE SETENCE LEMENTS     TO BEDEMOLISHED     SITE SETENCY LINES     FFL     SITE SETENCY LINES     TREE PROTECTION ZONE


Project Address: 42 FOXALL STREET ELANORA HEIGHTS 2101 NSW LOT 101 DP 32253 Drawing Title: EXISTING GROUND FLOOR PLAN 11.24 Drawing Dy: ATE B. DALE DREVEL OPMENT APPLICATION	DDG DALE DESIGN GROUP 12 BURRELL ROAD, KENTHURST, NSW, 2156
Drawing Status: DEVELOPMENT APPLICATION Drawing Scale: I :   OO @ A3   AO	




### **NORTH ELEVATION**




# EAST ELEVATION

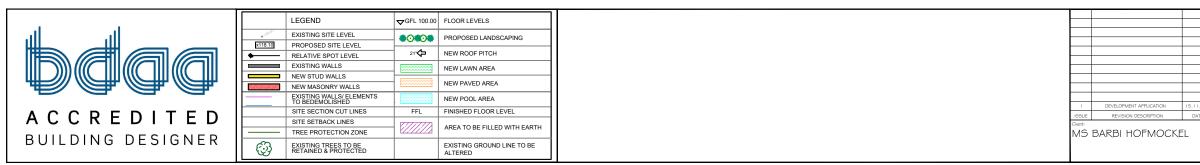

	Proget Address: 42 FOXALL STREET ELANORA HEIGHTS 2101 NSW LOT 101 DP 32253	
	Drawing Title: EXISTING NORTH ELEVATION EXISTING EAST ELEVATION	
1.24 (TE	Drawm By: B. DALE	DALE DESIGN
	Drawing Status: DEVELOPMENT APPLICATION Drawing Scale: 1:100@A3 A02 1	12 BURRELL ROAD, KENTHURST, NSW, 2156 ABN: 64 93 809 8664 PHONE: 0423 428 973

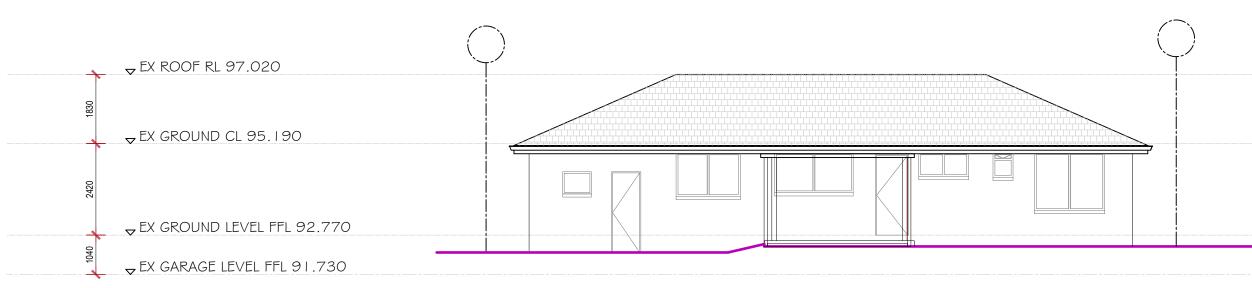


### **SOUTH ELEVATION**

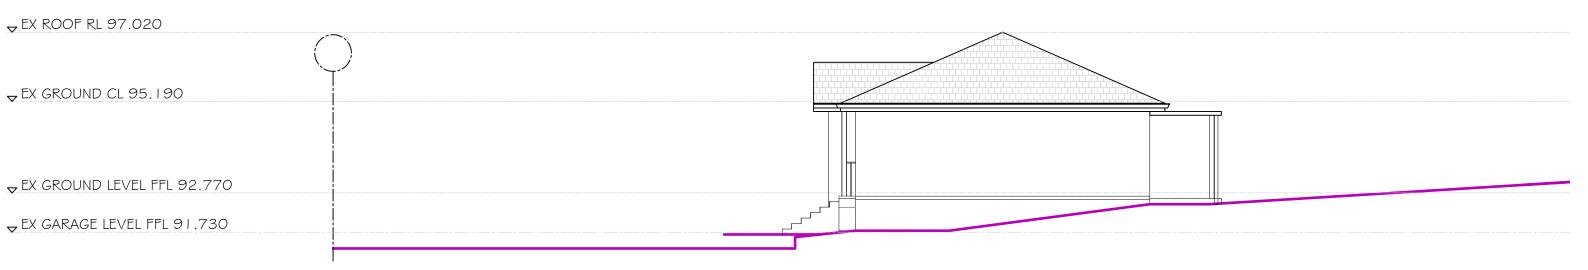


## **WEST ELEVATION**


	<u> </u>						-	
	1	LEGEND	<b>▽</b> GFL 100.00	FLOOR LEVELS			Project Address: 42 FOXALL STREET	
ال ال	* <sup>120.61</sup>	EXISTING SITE LEVEL	0000	PROPOSED LANDSCAPING			ELANORA HEIGHTS	
	x118.10	PROPOSED SITE LEVEL					2101 NSW	1
		RELATIVE SPOT LEVEL	21%	NEW ROOF PITCH			LOT 101 DP 32253	
DØQQ		EXISTING WALLS		NEW LAWN AREA			Drawing Title:	
		NEW STUD WALLS		NEW PAVED AREA			EXISTING SOUTH ELEVATION	$\sim$
		NEW MASONRY WALLS		NEW PAVED AREA			EXISTING WEST ELEVATION	
		EXISTING WALLS/ ELEMENTS TO BEDEMOLISHED		NEW POOL AREA		DEVELOPMENT APPLICATION 15.11.24		7
ACCDEDITED	1	SITE SECTION CUT LINES	FFL	FINISHED FLOOR LEVEL	31,000		Drawn By: B. DALE	
ACCREDITED	1	SITE SETBACK LINES	VIIIIA	AREA TO BE FILLED WITH EARTH	Contraction Contractio	Contraction of the second seco		
PILL DINC DESIGNED		TREE PROTECTION ZONE	V.I.I.I.A	AREA TO BE FILLED WITH EARTH	MS B.	BARBI HOFMOCKEL	Drawing Status: DEVELOPMENT APPLICATION	12
BUILDING DESIGNER	E E B	EXISTING TREES TO BE RETAINED & PROTECTED		EXISTING GROUND LINE TO BE			Drawing Scale: Drawing No: Revision:	H
	19	RETAINED & PROTECTED		ALTERED			1:100 @ A3   A02   I	

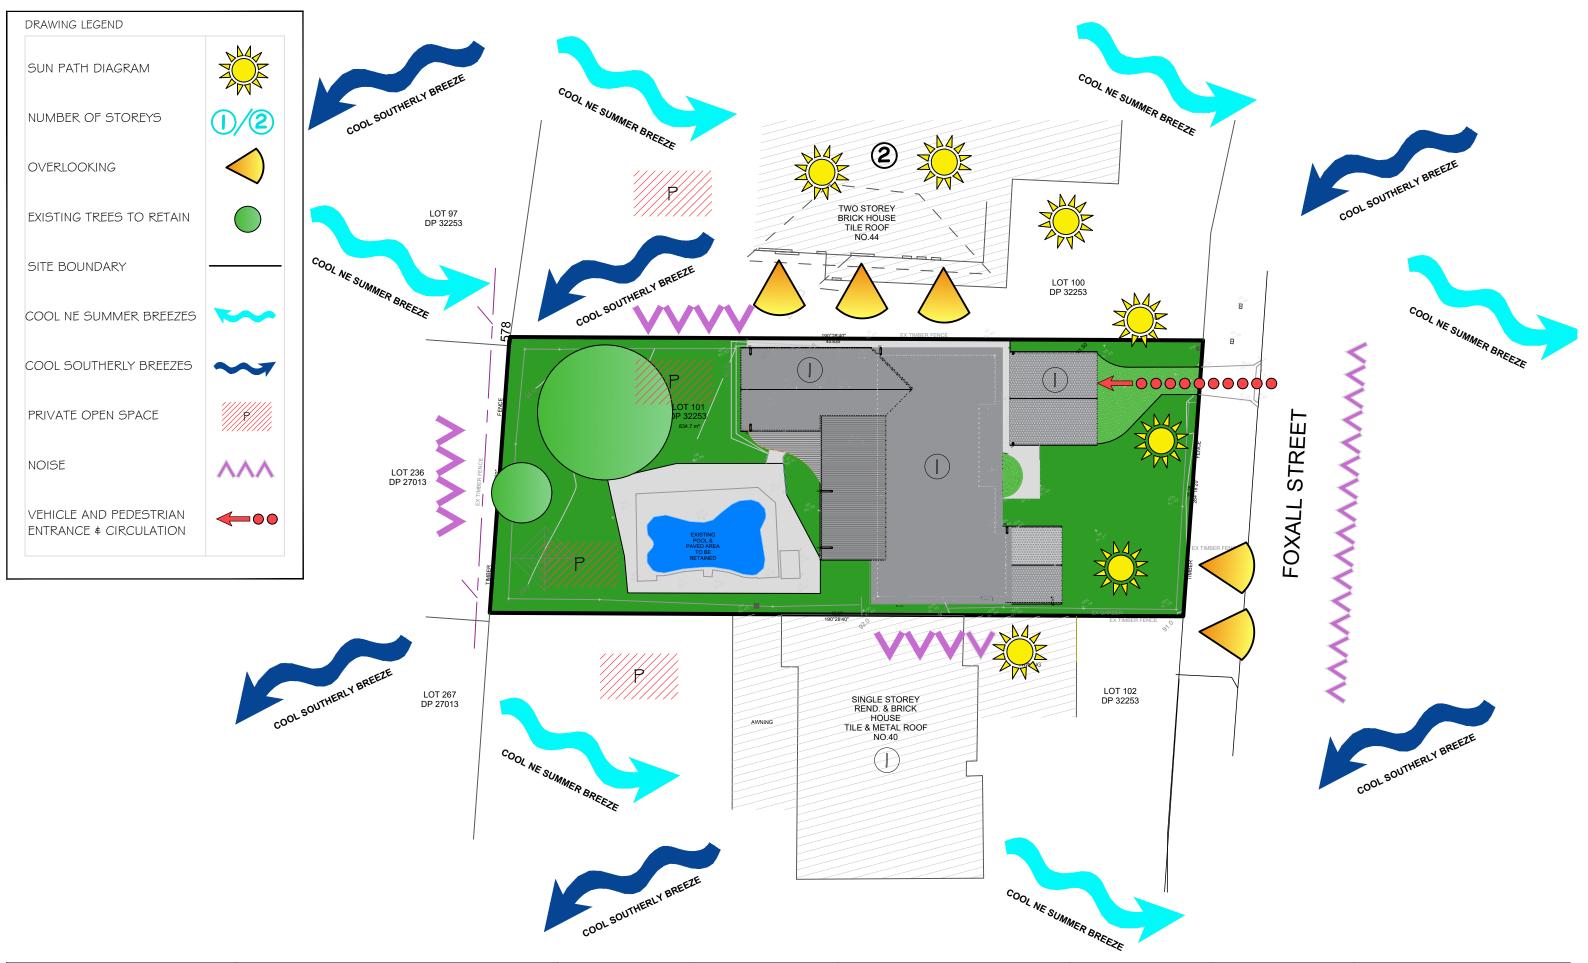

		LEGEND	<b>▽</b> GFL 100.00	FLOOR LEVELS		SITE CALCULATIONS		
الد الد	*' <sup>20,6'</sup>	EXISTING SITE LEVEL		PROPOSED LANDSCAPING	1	LOT 101 DP 32253		
	x118.10	PROPOSED SITE LEVEL				LOT 101 DP 32255		
	•	RELATIVE SPOT LEVEL	21%	NEW ROOF PITCH		AREA OF SITE	834.70sqm	
		EXISTING WALLS		NEW LAWN AREA		EXISTING GROUND FLOOR AREA	110.19sqm	
		NEW STUD WALLS			11			
		NEW MASONRY WALLS		NEW PAVED AREA		PROPOSED GROUND FLOOR AREA	55.64sqm	
		EXISTING WALLS/ ELEMENTS TO BEDEMOLISHED		NEW POOL AREA		TOTAL GROUND FLOOR AREA	165.83sqm	
		SITE SECTION CUT LINES	FFL	FINISHED FLOOR LEVEL	11		044 445 (40 70()	
ACCREDITED		SITE SETBACK LINES	V177777		11	EXISTING SITE COVERAGE ( DWELLING, POOL, PERGOLA )	341.14sqm (40.7%)	
		TREE PROTECTION ZONE		AREA TO BE FILLED WITH EARTH		PROPOSED SITE COVERAGE (DWELLING, POOL, PERGOLA, ADDITION)	424.36sqm (50.07%)	\
BUILDING DESIGNER	0	EXISTING TREES TO BE RETAINED & PROTECTED		EXISTING GROUND LINE TO BE ALTERED		PROPOSED SOFT LANDCAPING AREA	412.64sqm (49.93%)	
								1

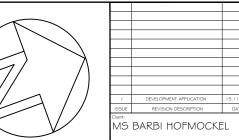

Project Address: 42 FOXALL STREET ELANORA HEIGHTS 2101 NSW LOT 101 DP 32253							
Drawny Title: SITE ANALYSIS PLAN	DALE DESIGN GROUP						
Drawing Status: DEVELOPMENT APPLICATION Drawing Scale: 1:250 @ A3 A04 1	LO RURREU ROAD KENTHURGT NEW OLEC						

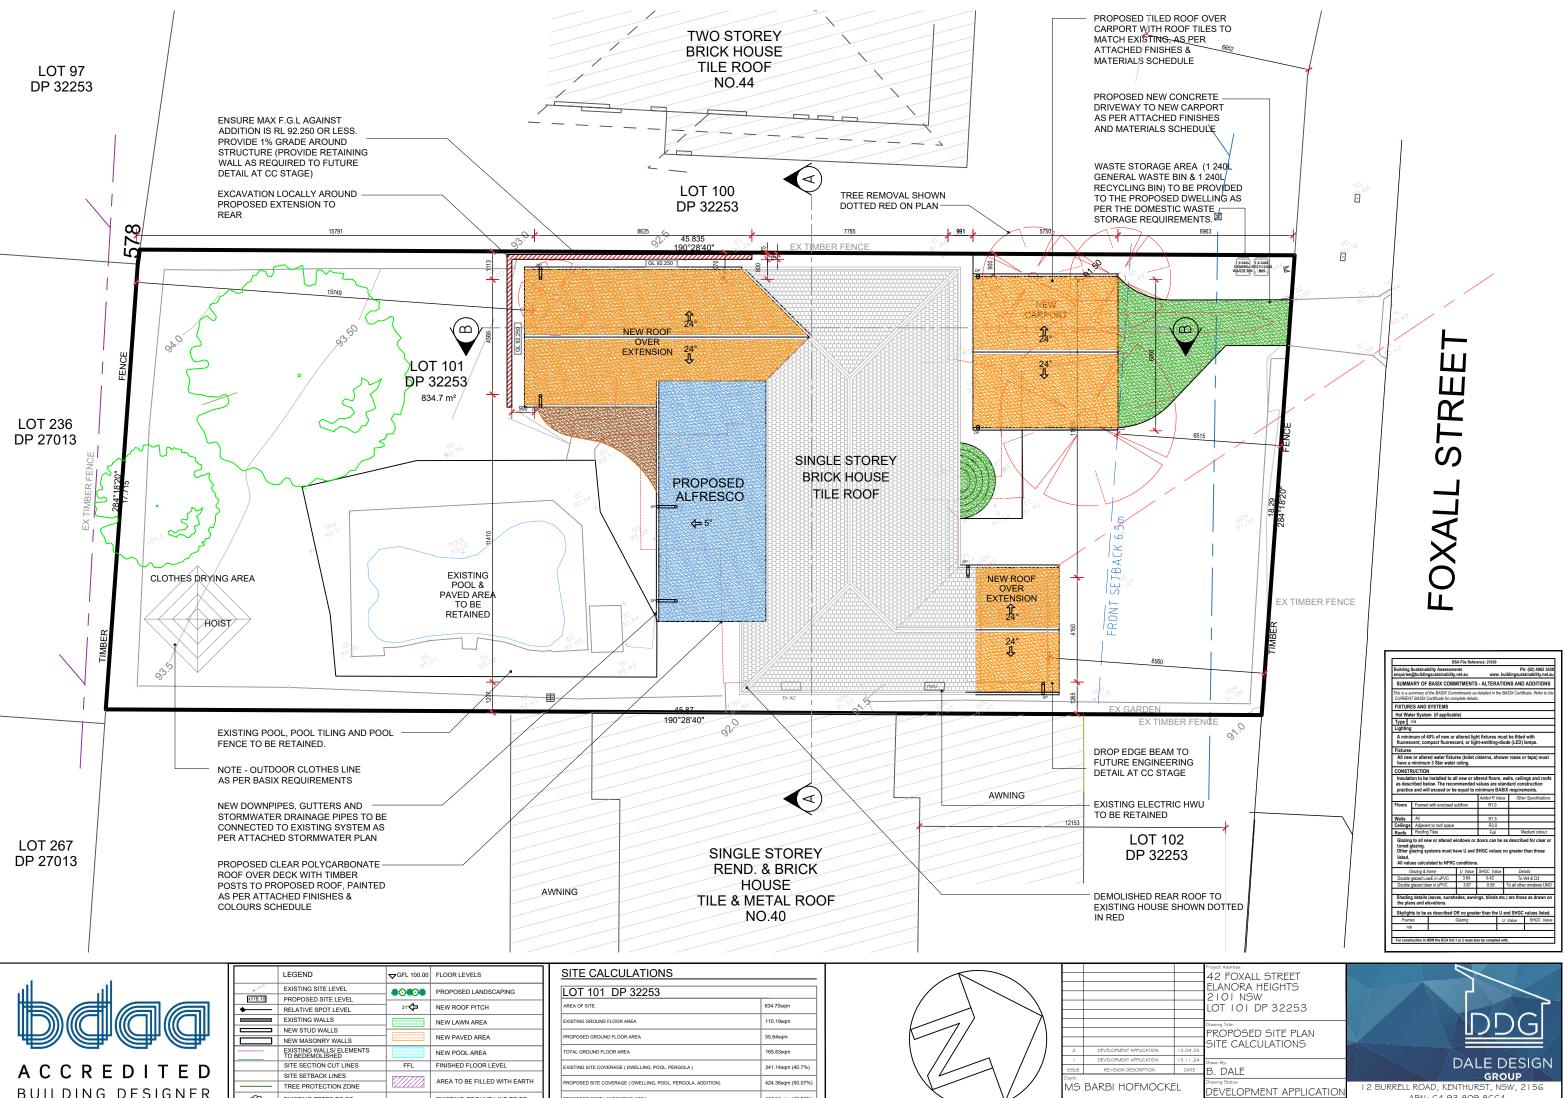


BUILDING DESIGNER

*120.01	EXISTING SITE LEVEL		PROPOSED LANDSCAPING	LOT 101 DP 32253		$\langle \rangle$		1	
x118.10	PROPOSED SITE LEVEL								
•	RELATIVE SPOT LEVEL	21*	NEW ROOF PITCH	AREA OF SITE	834.70sqm	$1 \sim 1$	_		
	EXISTING WALLS		NEW LAWN AREA	EXISTING GROUND FLOOR AREA	110.19sqm	$\lambda = \lambda$			
	NEW STUD WALLS			PROPOSED GROUND FLOOR AREA	55.64sqm	′ /\			
	NEW MASONRY WALLS		NEW PAVED AREA	PROPOSED GROUND FLOOR AREA	55.64sqm	/			
	EXISTING WALLS/ ELEMENTS TO BEDEMOLISHED		NEW POOL AREA	TOTAL GROUND FLOOR AREA	165.83sqm	. //		2	2 DEVELOPMENT APPLICATION
	SITE SECTION CUT LINES	FFL	FINISHED FLOOR LEVEL	EXISTING SITE COVERAGE ( DWELLING, POOL, PERGOLA )	341.14sqm (40.7%)	$\neg$ $  $		ISSUE	I DEVELOPMENT APPLICATION
	SITE SETBACK LINES	V.//////						Chent:	Client:
	TREE PROTECTION ZONE	([]]])	AREA TO BE FILLED WITH EARTH	PROPOSED SITE COVERAGE ( DWELLING, POOL, PERGOLA, ADDITION)	424.36sqm (50.07%)			MS	MS BARBI HOFMO
63	EXISTING TREES TO BE RETAINED & PROTECTED		EXISTING GROUND LINE TO BE	PROPOSED SOFT LANDCAPING AREA	412.64sqm (49.93%)	V			
C.S.	RETAINED & PROTECTED		ALTERED						

ABN: 64 93 809 8664 PHONE: 0423 428 973

ng Scale: 150@A3 A05 2

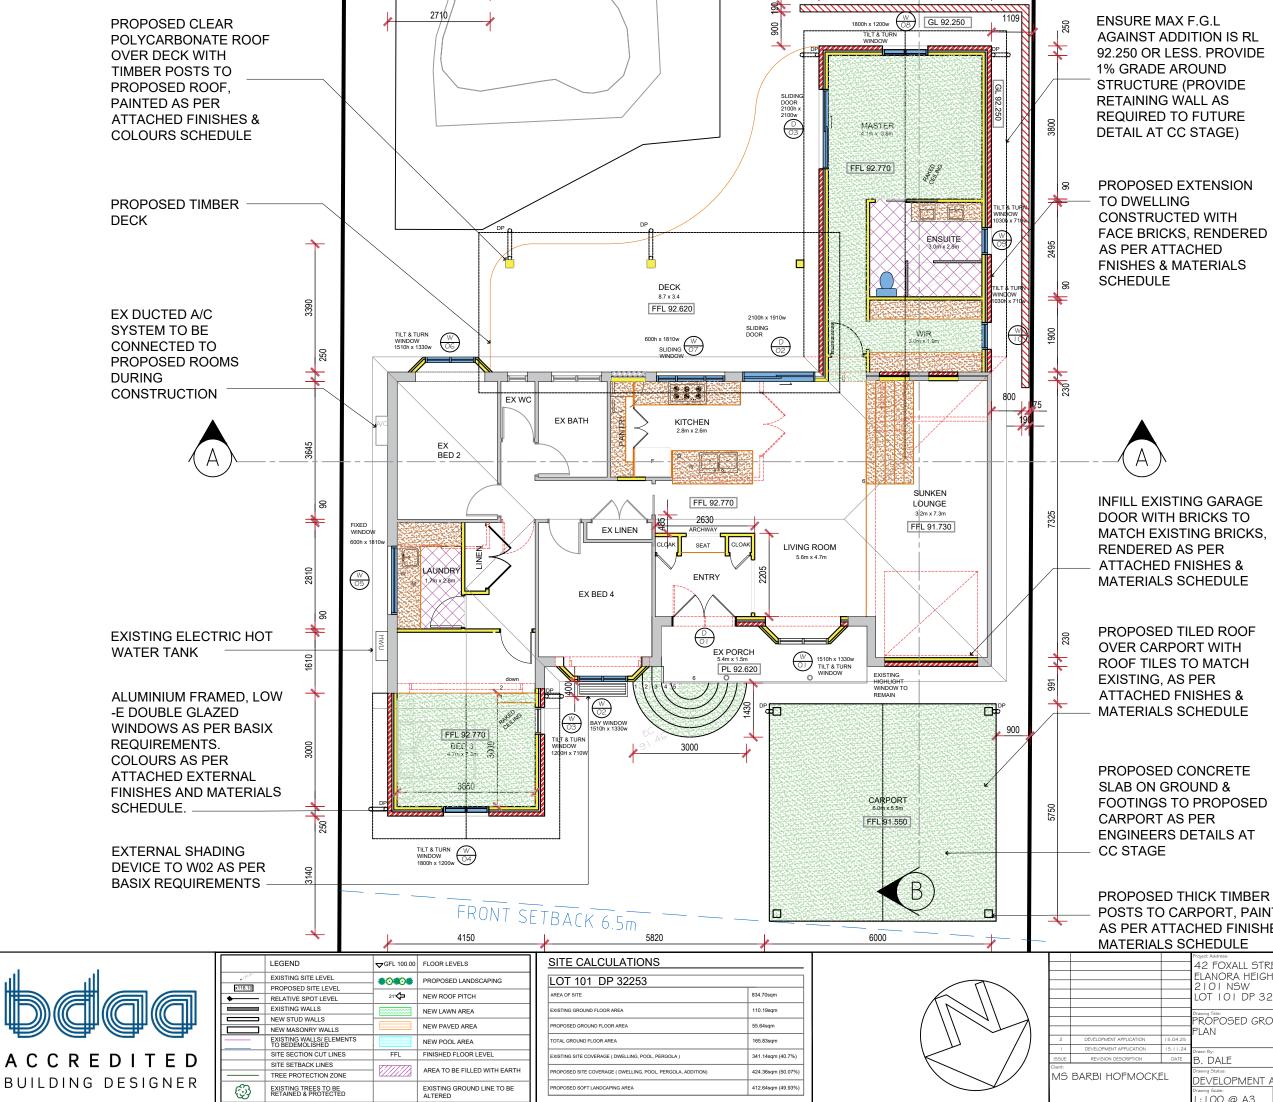

92.250 OR LESS. PROVIDE

FACE BRICKS, RENDERED


**INFILL EXISTING GARAGE** MATCH EXISTING BRICKS,

FOOTINGS TO PROPOSED

# POSTS TO CARPORT, PAINTED

CHED FINISHES & CHEDULE	For construction in NSW the BCA Vol 1 or 2 must also be complied with.			
Project Address: 42 FOXALL STREET ELANORA HEIGHTS 2101 NSW LOT 101 DP 32253				
Drawing Title: PROPOSED GROUND FLOOR PLAN				
Drawn By: B. DALE	DALE DESIGN GROUP			
Drawing Skatus: DEVELOPMENT APPLICATION Drawing Scale: 1:100 @ A3 A06 2	I 2 BURRELL ROAD, KENTHURST, NSW, 2156 ABN: 64 93 809 8664 PHONE: 0423 428 973			



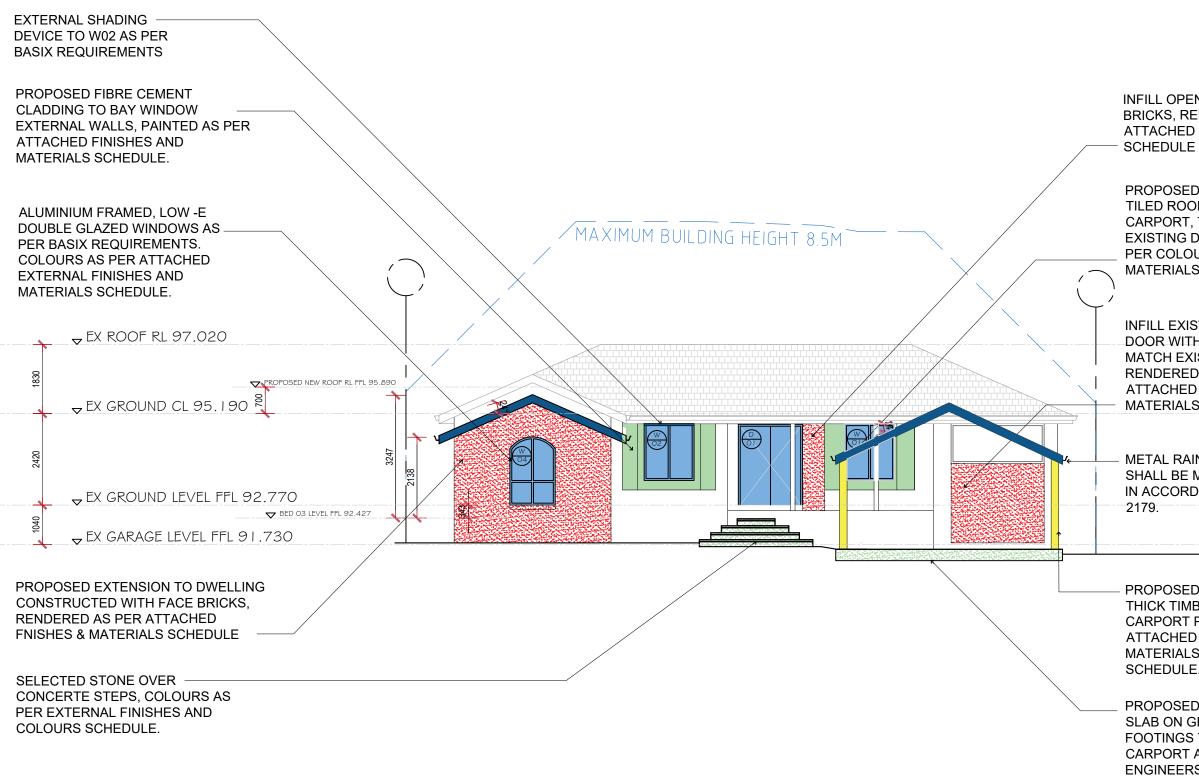

### **NORTH ELEVATION**

		LEGEND	<b>▽</b> GFL 100.00	FLOOR LEVELS	1	SITE CALCULATIONS				
lli. Ili	* <sup>120.51</sup>	EXISTING SITE LEVEL		PROPOSED LANDSCAPING	11	LOT 101 DP 32253				
	×118.10	PROPOSED SITE LEVEL RELATIVE SPOT LEVEL	21*	NEW ROOF PITCH		AREA OF SITE	834.70sqm			<u> </u>
		EXISTING WALLS		NEW LAWN AREA		EXISTING GROUND FLOOR AREA	110.19sqm			-
		NEW STUD WALLS NEW MASONRY WALLS		NEW PAVED AREA		PROPOSED GROUND FLOOR AREA	55.64sqm			
		EXISTING WALLS/ ELEMENTS TO BEDEMOLISHED		NEW POOL AREA		TOTAL GROUND FLOOR AREA	165.83sqm	_	DEVELOPMENT APPLICATION	15 11 24
ACCREDITED		SITE SECTION CUT LINES	FFL	FINISHED FLOOR LEVEL		EXISTING SITE COVERAGE ( DWELLING, POOL, PERGOLA )	341.14sqm (40.7%)	ISSUE	REVISION DESCRIPTION	DATE
		SITE SETBACK LINES TREE PROTECTION ZONE		AREA TO BE FILLED WITH EARTH		PROPOSED SITE COVERAGE ( DWELLING, POOL, PERGOLA, ADDITION)	424.36sqm (50.07%)	Chent:	6 BARBI HOFMOCK	
BUILDING DESIGNER	(i)	EXISTING TREES TO BE RETAINED & PROTECTED		EXISTING GROUND LINE TO BE ALTERED		PROPOSED SOFT LANDCAPING AREA	412.64sqm (49.93%)			

INFILL OPENINGS WITH FACE BRICKS, RENDERED AS PER ATTACHED FNISHES & MATERIALS SCHEDULE


PROPOSED TERRACOTTA TILED ROOF OVER CARPORT, TO MATCH EXISTING DWELLING AS PER COLOURS & MATERIALS SCHEDULE

INFILL EXISTING GARAGE DOOR WITH BRICKS TO MATCH EXISTING BRICKS, RENDERED AS PER ATTACHED FNISHES & MATERIALS SCHEDULE


METAL RAINWATER GOODS SHALL BE MANUFACTURED IN ACCORDANCE WITH AS

PROPOSED 200 X 200 APPROX THICK TIMBER POSTS TO CARPORT PAINTED AS PER ATTACHED EXTERNAL MATERIALS AND FINISHES SCHEDULE.


PROPOSED CONCRETE SLAB ON GROUND & FOOTINGS TO PROPOSED CARPORT AS PER ENGINEERS DETAILS AT CC STAGE

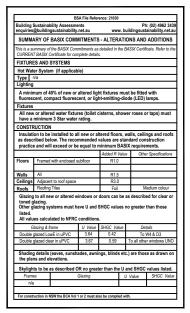

42 FOXALL STREET ELANORA HEIGHTS 2101 NSW LOT 101 DP 32253	
Proveng Tate: PROPOSED NORTH ELEVATION	DDG
<sup>24</sup> Drawn By: TE B. DALE	DALE DESIGN GROUP
Drawing Status: DEVELOPMENT APPLICATION Drawing Scale: 1 : 1 00 @ A3 A07 I	1.2 BUPPELL POAD KENTHURST NGW 2150

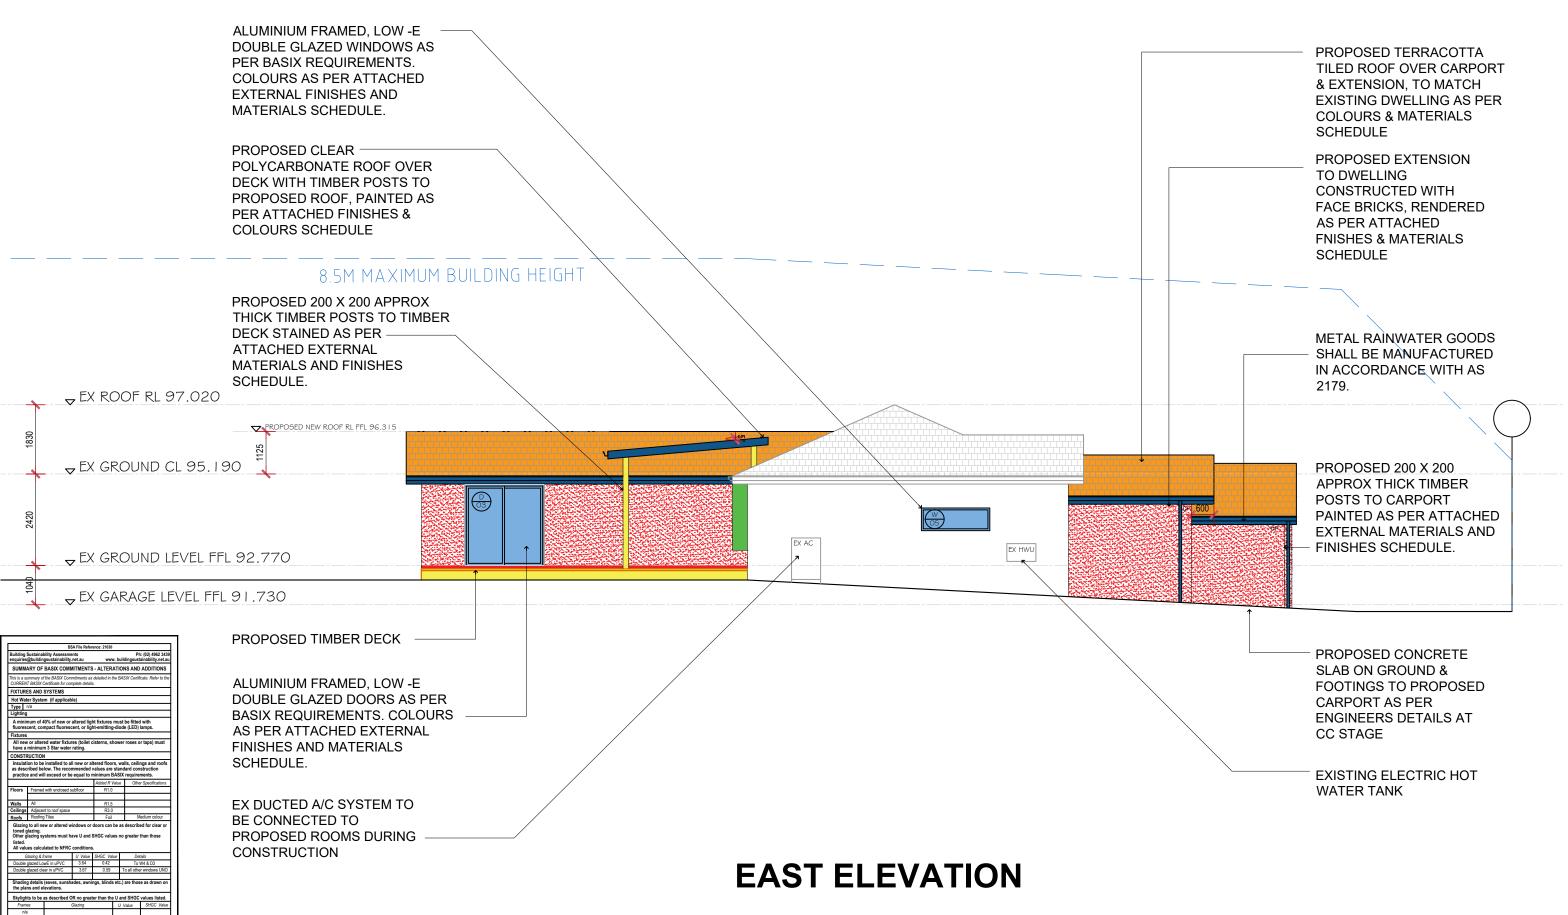

		LEGEND	<b>▽</b> GFL 100.00	FLOOR LEVELS	SITE CALCULATIONS				Project Address: 42 FOXALL STREET	
all all	* <sup>120.51</sup> x118.10	EXISTING SITE LEVEL PROPOSED SITE LEVEL		PROPOSED LANDSCAPING	LOT 101 DP 32253		-		ELANORA HEIGHTS 2101 NSW	
	•	RELATIVE SPOT LEVEL	21*	NEW ROOF PITCH	AREA OF SITE	834.70sqm			LOT 101 DP 32253	
		EXISTING WALLS NEW STUD WALLS		NEW LAWN AREA	EXISTING GROUND FLOOR AREA	110.19sqm			Drawing Title: PROPOSED EAST	
		NEW MASONRY WALLS		NEW PAVED AREA	PROPOSED GROUND FLOOR AREA	55.64sqm			ELEVATION	
		EXISTING WALLS/ ELEMENTS TO BEDEMOLISHED		NEW POOL AREA	TOTAL GROUND FLOOR AREA	165.83sqm	-			
		SITE SECTION CUT LINES	FFL	FINISHED FLOOR LEVEL	EXISTING SITE COVERAGE ( DWELLING, POOL, PERGOLA )	341.14sqm (40.7%)	8	SUE REVISION DESCRIPTION DATE		DALE DESIGN
ACCKLDIILD				AREA TO BE FILLED WITH FARTH		424 36cam (50 07%)	Che			GROUP
BUULDING DESIGNED		TREE PROTECTION ZONE			PROPOSED SITE COVERAGE (DWELLING, POOL, PERSOLA, ADDITION)	424.303qiii (30.0176)	I N	15 BARBI HOFMOCKEL		12 BURRELL ROAD, KENTHURST, NSW, 2156
BUILDING DESIGNER	EXISTING TREES TO BE RETAINED & PROTECTED         EXISTING GROUND LINE TO BE ALTERED         PROPOSED	PROPOSED SOFT LANDCAPING AREA	412.64sqm (49.93%)			Drawing Scale: Drawing No: Revision:	ABN: 64 93 809 8664 PHONE: 0423 428 973			
ACCREDITED BUILDING DESIGNER		NEW MASONRY WALLS EXISTING WALLS' ELEMENTS TO BEDEMOLISHED SITE SECTION CUT LINES SITE SETBACK LINES TREE PROTECTION ZONE	FFL           Ø	NEW POOL AREA FINISHED FLOOR LEVEL AREA TO BE FILLED WITH EARTH EXISTING GROUND LINE TO BE	TOTAL GROUND FLOOR AREA EXISTING SITE COVERAGE ( DWELLING, POOL, PERGOLA ) PROPOSED SITE COVERAGE ( DWELLING, POOL, PERGOLA, ADDITION)	165.83sqm           341.14sqm (40.7%)           424.36sqm (50.07%)	is Cor N	I DEVELOPMENT APPLICATION IS.II.24 SUE REVISION DESCRIPTION DATE		DAL 12 BURRELL ROAD, KENTHURS ABN: 64 93 809

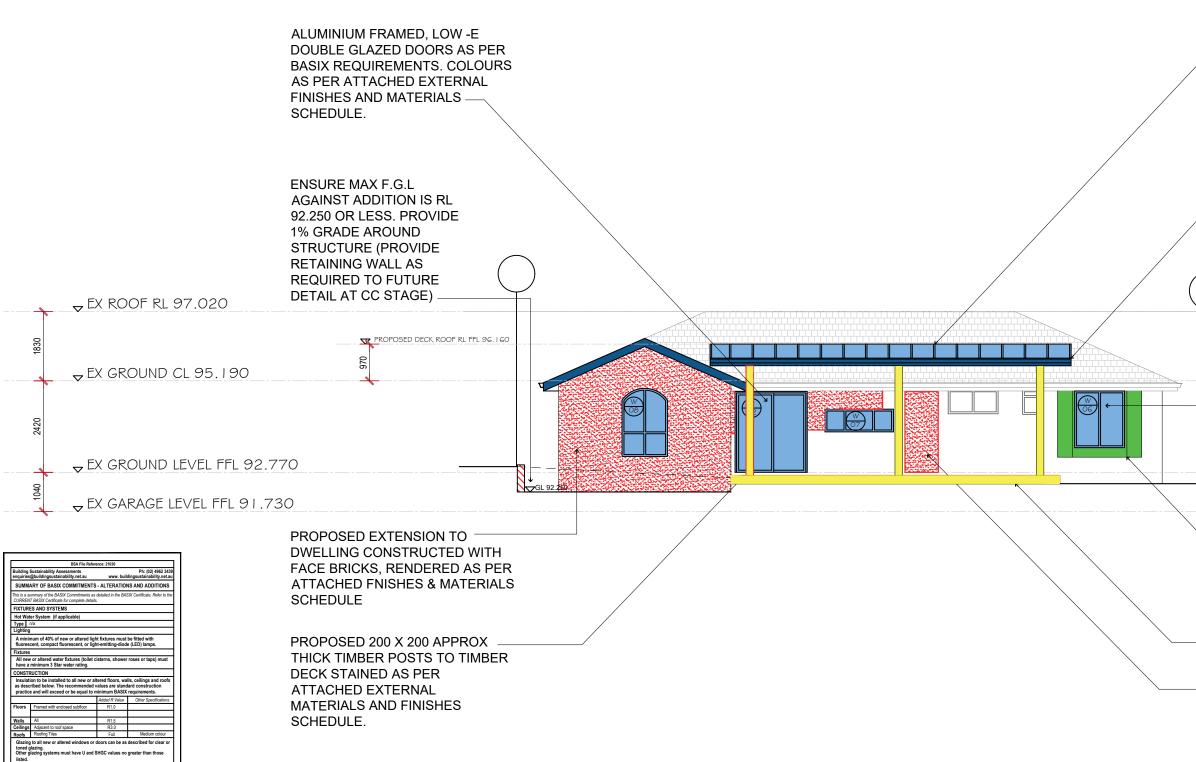

### SOUTH ELEVATION



scribed OR no greater than the U and SHGC values listed Glazing U Value SHGC Val


	LEGEND	<b>▽</b> GFL 100.00	FLOOR LEVELS		
* <sup>120,61</sup>	EXISTING SITE LEVEL		PROPOSED LANDSCAPING		
x118.10	PROPOSED SITE LEVEL				
•	RELATIVE SPOT LEVEL	21*	NEW ROOF PITCH		
	EXISTING WALLS		NEW LAWN AREA		
	NEW STUD WALLS				
	NEW MASONRY WALLS		NEW PAVED AREA		
	EXISTING WALLS/ ELEMENTS TO BEDEMOLISHED		NEW POOL AREA		
	SITE SECTION CUT LINES	FFL	FINISHED FLOOR LEVEL		
	SITE SETBACK LINES	VIIIIA	AREA TO BE FILLED WITH FARTH		
	TREE PROTECTION ZONE		AREA TO BE FILLED WITH EARTH		
(i)	EXISTING TREES TO BE RETAINED & PROTECTED		EXISTING GROUND LINE TO BE ALTERED		

SITE CALCULATIONS	
LOT 101 DP 32253	
AREA OF SITE	834.70sqm
EXISTING GROUND FLOOR AREA	110.19sqm
PROPOSED GROUND FLOOR AREA	55.64sqm
TOTAL GROUND FLOOR AREA	165.83sqm
EXISTING SITE COVERAGE ( DWELLING, POOL, PERGOLA )	341.14sqm (40.7%)
PROPOSED SITE COVERAGE (DWELLING, POOL, PERGOLA, ADDITION)	424.36sqm (50.07%)
PROPOSED SOFT LANDCAPING AREA	412.64sqm (49.93%

2	DEVELOPMENT APPLICATION	15.0
1	DEVELOPMENT APPLICATION	15.1
ISSUE	REVISION DESCRIPTION	DA
<sup>Chent:</sup> MS	BARBI HOFMOCKE	ĒL

	PROPOSED CLEAR POLYCARBONATE ROOF OVER DECK WITH TIMBER POSTS TO PROPOSED ROOF, PAINTED AS PER ATTACHED FINISHES & COLOURS SCHEDULE
$\bigcirc$	METAL RAINWATER GOODS SHALL BE MANUFACTURED IN ACCORDANCE WITH AS 2179.
	ALUMINIUM FRAMED, LOW -E DOUBLE GLAZED WINDOWS AS PER BASIX REQUIREMENTS. COLOURS AS PER ATTACHED EXTERNAL FINISHES AND MATERIALS SCHEDULE.
	PROPOSED FIBRE CEMENT CLADDING TO BAY WINDOW EXTERNAL WALLS, PAINTED AS PER ATTACHED FINISHES AND MATERIALS SCHEDULE.
	PROPOSED TIMBER DECK INFILL OPENINGS WITH FACE BRICKS, RENDERED AS PER ATTACHED FNISHES & MATERIALS SCHEDULE

	Made Address 42 FOXALL STREET ELANORA HEIGHTS 2101 NSW LOT 101 DP 32253	
25	Drawng Tele: PROPOSED SOUTH ELEVATION	
.24 E	Drawn By: B. DALE	DALE DESIGN GROUP
	Drawing Status: DEVELOPMENT APPLICATION Drawing Scale: 1:100 @ A3 A09 2	I 2 BURRELL ROAD, KENTHURST, NSW, 2156 ABN: 64 93 809 8664 PHONE: 0423 428 973

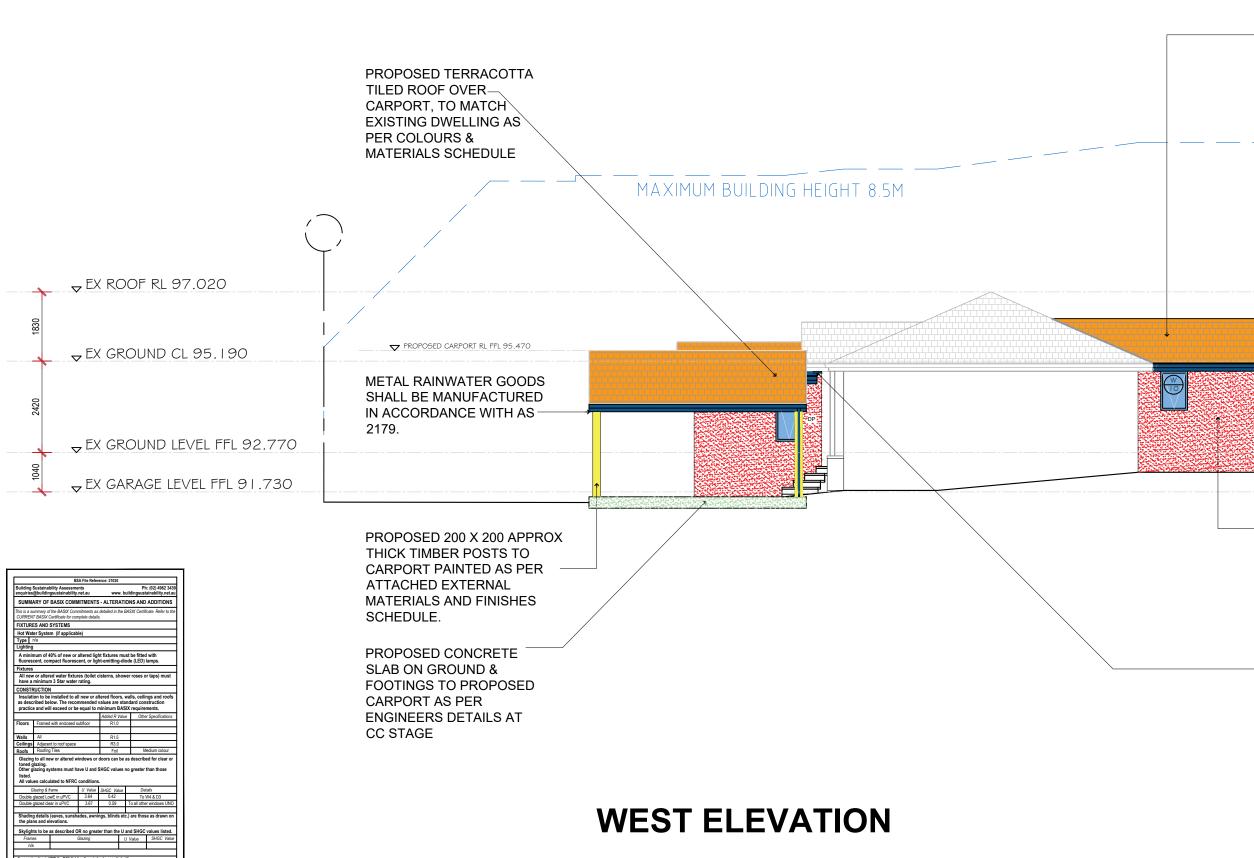

		LEGEND	<b>▽</b> GFL 100.00	FLOOR LEVELS	SITE CALCULATIONS			42 FOXALL STREET	
all all	* <sup>120.61</sup>	EXISTING SITE LEVEL		PROPOSED LANDSCAPING	LOT 101 DP 32253			ELANORA HEIGHTS	
bdaa	×118.10	PROPOSED SITE LEVEL RELATIVE SPOT LEVEL	215	NEW ROOF PITCH	AREA OF SITE	834.70sqm		LOT 101 DP 32253	
		EXISTING WALLS		NEW LAWN AREA	EXISTING GROUND FLOOR AREA	110.19sqm		Drawing Title:	
DØØØ		NEW STUD WALLS NEW MASONRY WALLS		NEW PAVED AREA	PROPOSED GROUND FLOOR AREA	55.64sqm		PRÖPOSED WEST	DDG
		EXISTING WALLS/ ELEMENTS TO BEDEMOLISHED		NEW POOL AREA	TOTAL GROUND FLOOR AREA	165.83sqm	2 DEVELOPMENT APPLICATION	15.04.25	
ACCREDITED		SITE SECTION CUT LINES	FFL	FINISHED FLOOR LEVEL	EXISTING SITE COVERAGE ( DWELLING, POOL, PERGOLA )	341.14sqm (40.7%)	I DEVELOPMENT APPLICATION ISSUE REVISION DESCRIPTION	DATE B. DALE	DALE DESIGN
		SITE SETBACK LINES TREE PROTECTION ZONE		AREA TO BE FILLED WITH EARTH	PROPOSED SITE COVERAGE (DWELLING, POOL, PERGOLA, ADDITION)	424.36sqm (50.07%)	MS BARBI HOFMOCK	CEL Drawing Status:	I 2 BURRELL ROAD, KENTHURST, NSW, 2156
BUILDING DESIGNER	ÊB	EXISTING TREES TO BE RETAINED & PROTECTED		EXISTING GROUND LINE TO BE	PROPOSED SOFT LANDCAPING AREA	412.64sqm (49.93%)		DEVELOPMENT APPLICATION Drawing Scale: Drawing No: Revision:	ABN: 64 93 809 8664
	S.			ALTERED	5			1:100@A3 A10 2	PHONE: 0423 428 973


PROPOSED TERRACOTTA TILED ROOF OVER CARPORT, TO MATCH EXISTING DWELLING AS PER COLOURS & MATERIALS SCHEDULE

ALUMINIUM FRAMED, LOW -E DOUBLE GLAZED WINDOWS AS PER BASIX REQUIREMENTS. COLOURS AS PER ATTACHED EXTERNAL FINISHES AND MATERIALS SCHEDULE.

PROPOSED EXTENSION TO DWELLING CONSTRUCTED WITH FACE BRICKS, RENDERED AS PER **ATTACHED FNISHES &** MATERIALS SCHEDULE

EXTERNAL SHADING DEVICE TO W02 AS PER BASIX REQUIREMENTS

ENSURE MAX F.G.L AGAINST ADDITION IS RL 92.250 OR LESS. PROVIDE 1% GRADE AROUND STRUCTURE (PROVIDE **RETAINING WALL AS REQUIRED TO FUTURE** DETAIL AT CC STAGE)

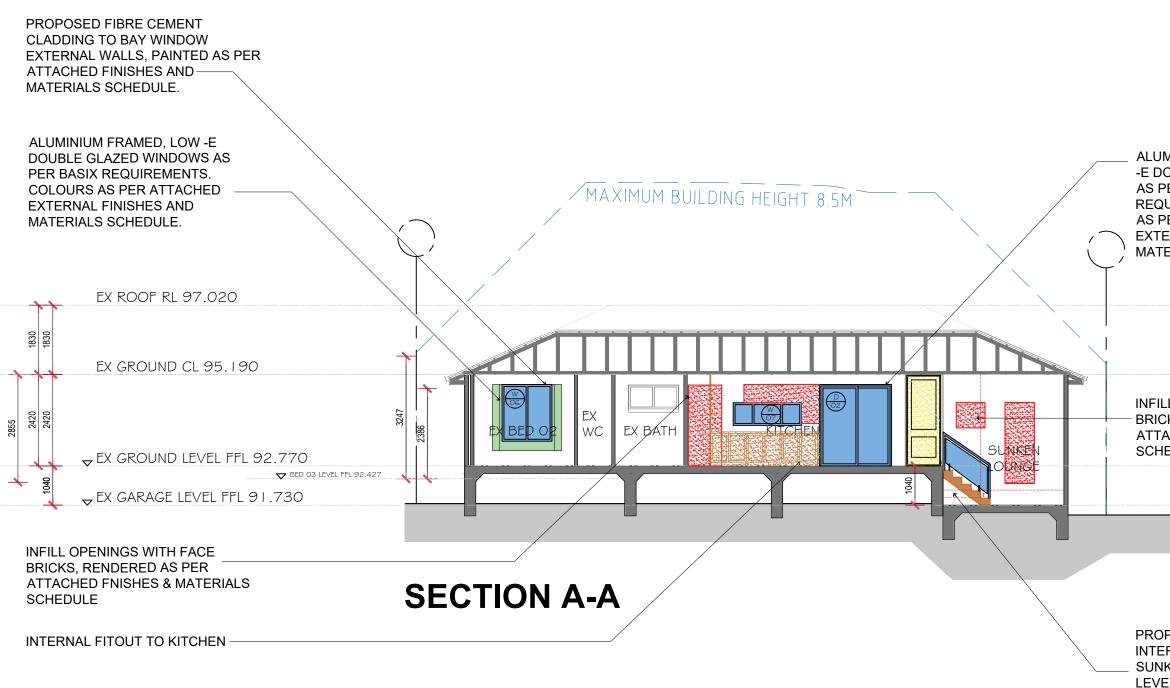


										_
		LEGEND	<b>▽</b> GFL 100.00	FLOOR LEVELS		SITE CALCULATIONS				+
الب الب	*120.51	EXISTING SITE LEVEL		PROPOSED LANDSCAPING	11	LOT 101 DP 32253				-
	x118.10	PROPOSED SITE LEVEL			41			-		-
	•	RELATIVE SPOT LEVEL	21*	NEW ROOF PITCH		AREA OF SITE	834.70sqm	_		-
DAAA		EXISTING WALLS		NEW LAWN AREA	1	EXISTING GROUND FLOOR AREA	110.19sqm	-		+
		NEW STUD WALLS			11					-
		NEW MASONRY WALLS		NEW PAVED AREA		PROPOSED GROUND FLOOR AREA	55.64sqm			-
		EXISTING WALLS/ ELEMENTS TO BEDEMOLISHED		NEW POOL AREA	1	TOTAL GROUND FLOOR AREA	165.83sqm		DEVELOPMENT APPLICATION	15.1
		SITE SECTION CUT LINES	FFL	FINISHED FLOOR LEVEL	11	EXISTING SITE COVERAGE (DWELLING, POOL, PERGOLA)	341.14sam (40.7%)	-		- 1.5.1
ACCREDITED		SITE SETBACK LINES			11		041.140qiii (40.170)	ISSUE	REVISION DESCRIPTION	
<b>NOOREDITED</b>				AREA TO BE FILLED WITH EARTH		PROPOSED SITE COVERAGE (DWELLING, POOL, PERGOLA, ADDITION)	424.36sam (50.07%)	Chent:		
		TREE PROTECTION ZONE				PROFOSED SHE COVERAGE (DWEELING, FOOL, FERGUEA, ADDITION)	424.303qm (30.0776)	MS	BARBI HOFMOCK	EL
BUILDING DESIGNER	63	EXISTING TREES TO BE RETAINED & PROTECTED		EXISTING GROUND LINE TO BE ALTERED	11	PROPOSED SOFT LANDCAPING AREA	412.64sqm (49.93%)			
	G			ALIERED						


ALUMINIUM FRAMED, LOW -E DOUBLE GLAZED DOORS AS PER BASIX REQUIREMENTS. COLOURS AS PER ATTACHED EXTERNAL FINISHES AND MATERIALS SCHEDULE.

### INFILL OPENINGS WITH FACE BRICKS, RENDERED AS PER ATTACHED FNISHES & MATERIALS SCHEDULE

POSED TIMBER STEPS
RNALLY TO LINK
KEN LOUNGE TO MAIN
EL

Building S	Sustainability Assessme	nts		Pł	n: (02) 4962 343
	@buildingsustainability.		www. b		
SUMMA	ARY OF BASIX COMM	NITMENTS	- ALTERAT	IONS AND	ADDITIONS
	mmary of the BASIX Com FBASIX Certificate for con			BASIX Certifi	icate. Refer to th
FIXTURE	S AND SYSTEMS				
Hot Wat	er System (if applicab	le)			
Type r	i/a				
Lighting					
	num of 40% of new or cent, compact fluoresc				
Fixtures					
	or altered water fixtur		isterns, show	ver roses o	or taps) must
	minimum 3 Star water	rating.			
CONSTR					
	on to be installed to al				
	ribed below. The recor				
practice	and will exceed or be	equal to	ninimum BAS		
			Added R Valu	e Othe	er Specifications
			R10		
Floors	Framed with enclosed s	uptioor	1(1.0		
Floors		ubtioor			
Walls	All	UDRIOOF	R1.5		
Walls Ceilings	All Adjacent to roof space	ublicor	R1.5 R3.0		
Walls Ceilings Roofs	All Adjacent to roof space Roofing Tiles		R1.5 R3.0 Foil		ledium colour
Walls Ceilings Roofs Glazing toned g Other g listed.	All Adjacent to roof space Roofing Tiles to all new or altered w	indows or ave U and	R1.5 R3.0 Foil doors can be SHGC values	as describ	ed for clear or
Walls Ceilings Roofs Glazing toned g Other gi listed. All valu G	All Adjacent to roof space Roofing Tiles to all new or altered w lazing, azing systems must hi es calculated to NFRC lazing & frame	indows or ave U and	R1.5 R3.0 Foil doors can be SHGC values	as describ no greater De	ed for clear or than those tails
Walls Ceilings Roofs Glazing toned g Other gi listed. All valu G	All Adjacent to roof space Roofing Tiles to all new or altered w lazing. azing systems must hi es calculated to NFRC	indows or ave U and conditions	R1.5 R3.0 Foil doors can be SHGC values	as describ no greater De	ed for clear or than those
Walls Ceilings Roofs Glazing toned g Other g listed. All valu G Double g	All Adjacent to roof space Roofing Tiles to all new or altered w lazing, azing systems must hi es calculated to NFRC lazing & frame	indows or ave U and conditions U Value	R1.5 R3.0 Foil doors can be SHGC values	as describ no greater Dei To	ed for clear or than those tails
Walls Ceilings Roofs Glazing toned g Other g listed. All valu G Double g Double g Double g Shading the plar	All Adjacent to roof space Rooting Tiles to all new or altered w lazing. azing systems must h es calculated to NFRC lazing & fame jazed LowE in uPVC jazed clear in uPVC details (caves, sunsh, s and elevations.	indows or ave U and conditions <u>U Value</u> 3.64 3.67 ades, awni	R1.5 R3.0 Foil doors can be SHGC values	as describ no greater To ' To all othe c.) are thos	ed for clear or than those tails W4 & D3 er windows UNC se as drawn or
Walls Ceilings Roofs Glazing toned g Other g listed. All valu G Double g Double g Shading the plar Skylight	All Adjacent to roof space Rooting Tiles to all new or altered w azing, systems must h es calculated to NFRC during 6 fame jazzed LowE in uPVC jazzed clear in uPVC details (eaves, sunth and elevations. Its to be as described C	indows or ave U and <u>Conditions</u> <u>U Value</u> <u>3.64</u> <u>3.67</u> ades, awni	R1.5 R3.0 Foil doors can be SHGC values SHGC values 0.42 0.59 ngs, blinds et ier than the U	as describ no greater Dev To all othe c.) are thos	ed for clear or than those tails W4 & D3 er windows UNC se as drawn or values listed.
Walls Ceilings Roofs Glazing toned g Other g listed. All valu G Double g Double g Double g Shading the plar	All Adjacent to roof space Roofing Tiles to all new or altered w lazing. Azing systems must h es calculated to NFRC lazing d fame jazed clow in uPVC details (caves, sunsh is and elevations. Is to be as described of s	indows or ave U and conditions <u>U Value</u> 3.64 3.67 ades, awni	R1.5 R3.0 Foil doors can be SHGC values SHGC values 0.42 0.59 ngs, blinds et ier than the U	as describ no greater To ' To all othe c.) are thos	ed for clear or than those tails W4 & D3 er windows UNC se as drawn or

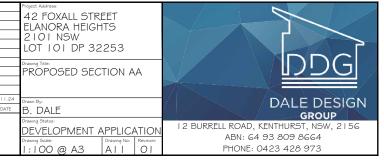

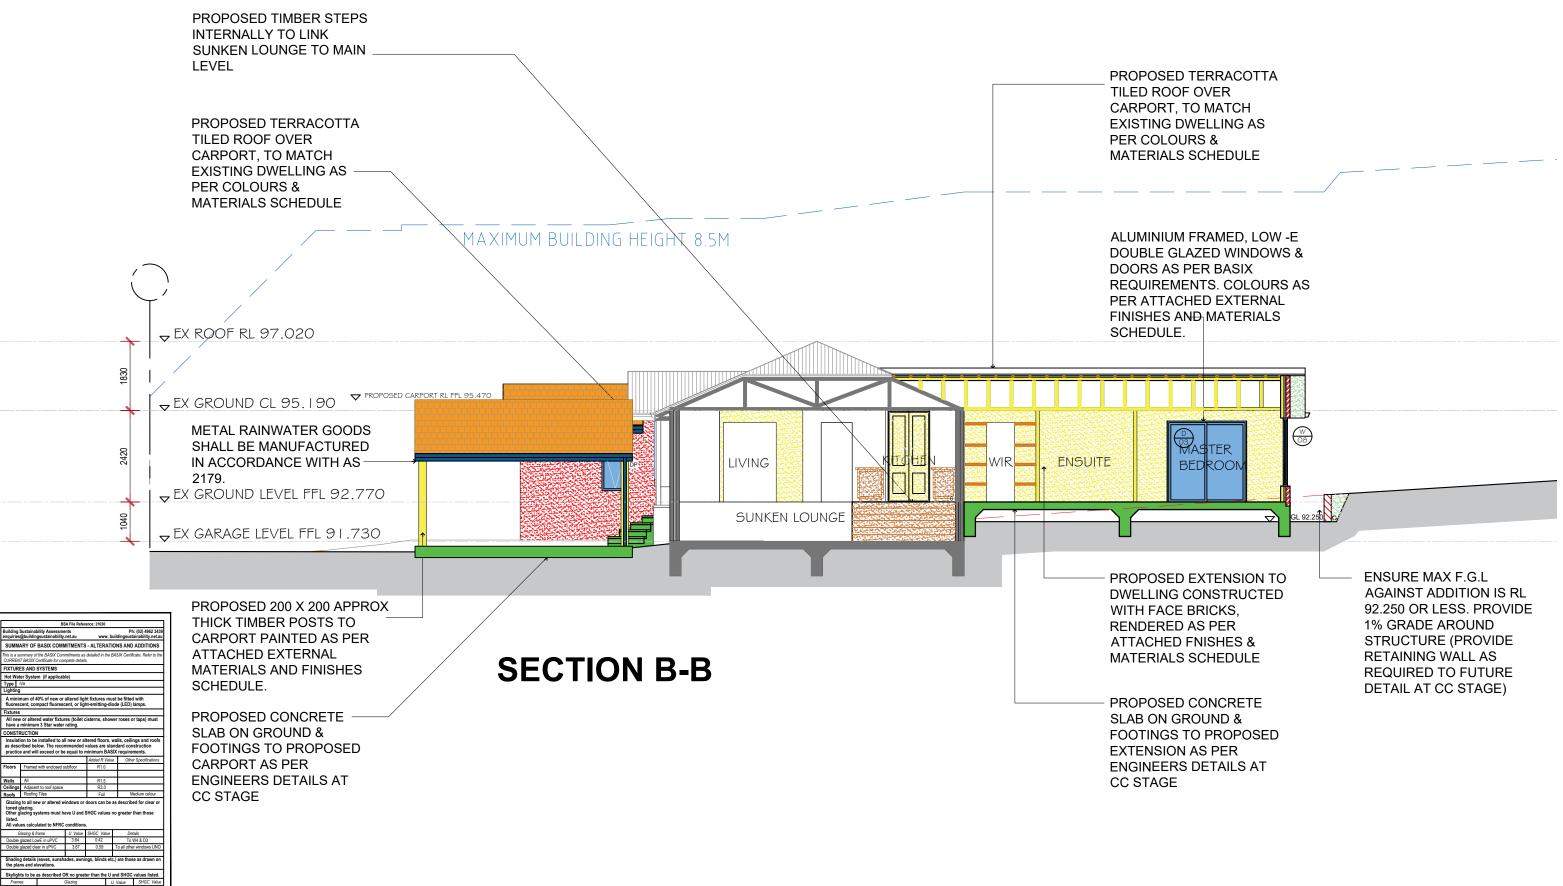



		LEGEND	<b>▽</b> GFL 100.00	FLOOR LEVELS		SITE CALCULATIONS				
	* <sup>120.61</sup>	EXISTING SITE LEVEL		PROPOSED LANDSCAPING		LOT 101 DP 32253				
	×118.10	PROPOSED SITE LEVEL RELATIVE SPOT LEVEL	21*	NEW ROOF PITCH		AREA OF SITE	834.70sqm			
		EXISTING WALLS NEW STUD WALLS		NEW LAWN AREA		EXISTING GROUND FLOOR AREA	110.19sqm			
$\mathbf{P} \mathbf{P} \mathbf{P} \mathbf{P} \mathbf{P}$		NEW MASONRY WALLS		NEW PAVED AREA	P	PROPOSED GROUND FLOOR AREA	55.64sqm			
		EXISTING WALLS/ ELEMENTS TO BEDEMOLISHED		NEW POOL AREA		TOTAL GROUND FLOOR AREA	165.83sqm	2	DEVELOPMENT APPLICATION DEVELOPMENT APPLICATION	
ACCREDITED		SITE SECTION CUT LINES SITE SETBACK LINES	FFL	FINISHED FLOOR LEVEL		EXISTING SITE COVERAGE ( DWELLING, POOL, PERGOLA )	341.14sqm (40.7%)	ISSUE	REVISION DESCRIPTION	N DATE
		TREE PROTECTION ZONE		AREA TO BE FILLED WITH EARTH		PROPOSED SITE COVERAGE (DWELLING, POOL, PERGOLA, ADDITION)	424.36sqm (50.07%)	MS	BARBI HOFMC	OCKEL
BUILDING DESIGNER	(i)	EXISTING TREES TO BE RETAINED & PROTECTED		EXISTING GROUND LINE TO BE ALTERED		PROPOSED SOFT LANDCAPING AREA	412.64sqm (49.93%)			
	~		1	, and the second s				1		

42 FOXALL ELANORA HI 2101 NSW LOT 101 DF	EIGHTS	
Drawing Title: PROPOSED 25 24 Drawin By: TE B. DALE	SECTION BB	DALE DESIGN GROUP
Drawing Status: DEVELOPME Drawing Scale: 1:100 @ A3	NT APPLICATION	12 BURRELL ROAD KENTHURST NOW 2150



Building Senguiries	Sustainability Assessm @buildingsustainability	ents /.net.au	www.b	Pł uildingsust	h: (02) 4962 3439 tainability.net.au
	ARY OF BASIX COM				
	mmary of the BASIX Cor TBASIX Certificate for co			BASIX Certif	icate. Refer to the
FIXTURE	S AND SYSTEMS				
	er System (if applica	ble)			
.,,,,,,,,,,,,,,,,,,,,,,,,,,,,,,,,,,,,,,	va				
Lighting					
	num of 40% of new or cent, compact fluores				
Fixtures					
All new have a	or altered water fixtu minimum 3 Star wate	res (toilet or rating.	isterns, show	ver roses o	or taps) must
CONSTR	UCTION				
as desc	on to be installed to a ribed below. The reco	mmended	values are sta	andard con	struction
practice	and will exceed of b	e equal to r	Added R Valu		ments. ar Specifications
Floors	Framed with enclosed	subfloor	R10	e one	" opcomediatins
				1	
Walls	All		R1.5		
Ceilings	Adjacent to roof space		R3.0		
Roofs	Roofing Tiles		Foil	Medium co	
toned g Other g listed. All valu	lazing systems must I es calculated to NFRC	nave U and	SHGC values	no greater	than those
	lazing & frame	U Value	SHGC Value		tails
	glazed LowE in uPVC	3.64	0.42		W4 & D3
	glazed clear in uPVC	3.67	0.59	To all othe	ar windows UNO
	details (eaves, suns	nades, awni	ngs, blinds et		
Double shading the plan Skyligh Frame	ts and elevations.	OR no great Glazing		and SHGC U Value	SHGC Value
Double Shading the plan Skyligh	ts and elevations.				

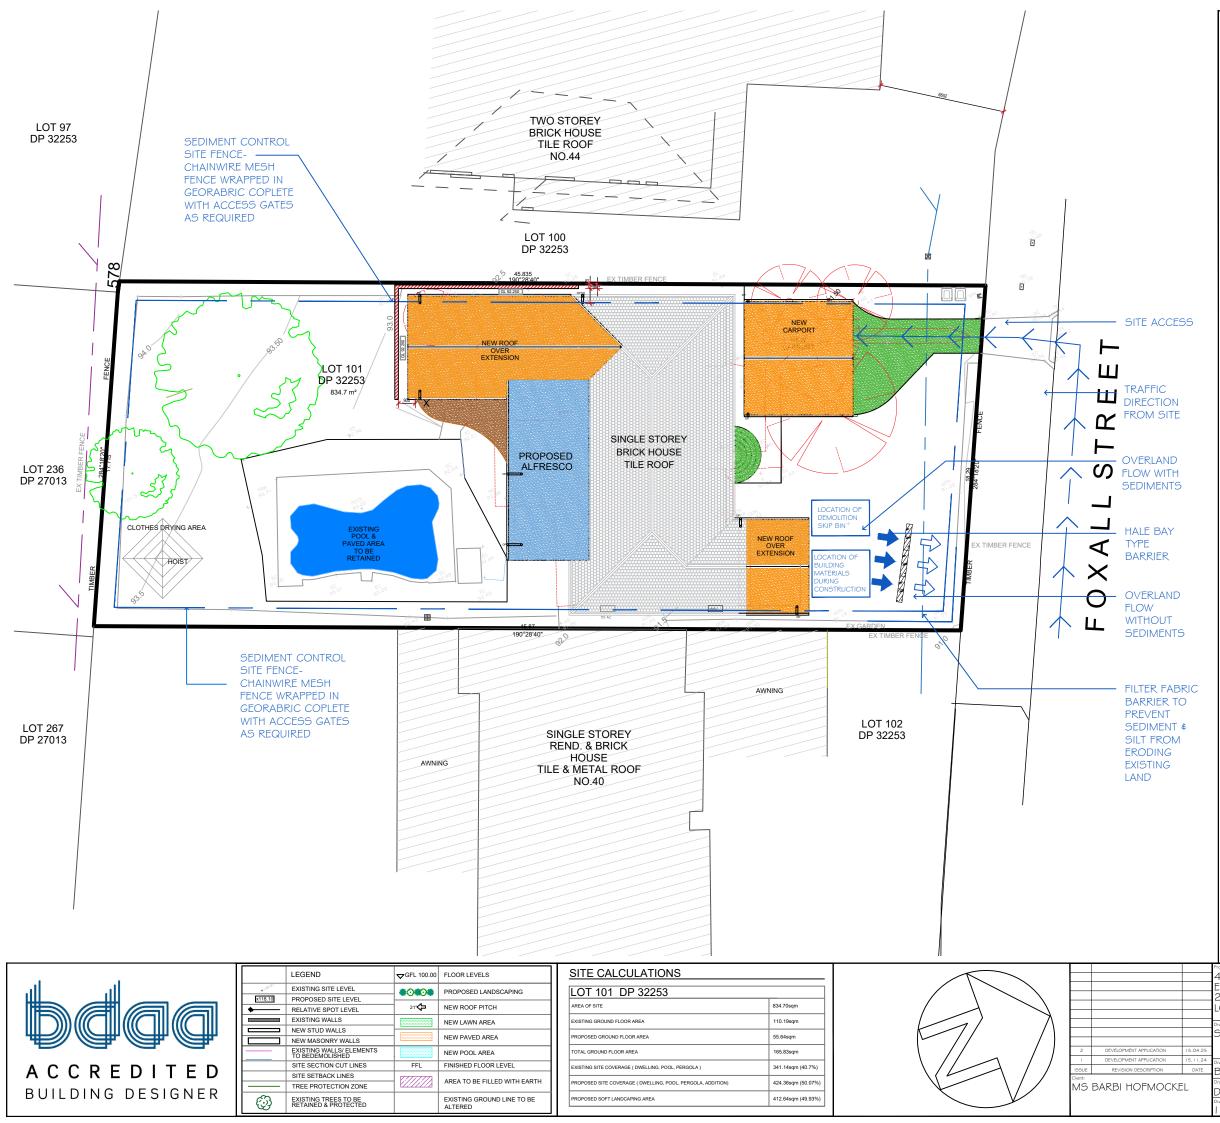

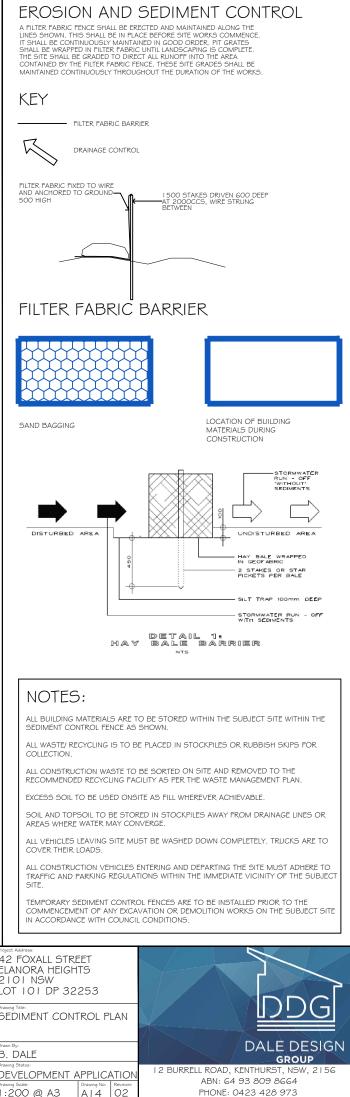

PHONE: 0423 428 973



	LEGEND			42 FOXALL STREET	
الت الت	* 100 EXISTING SITE LEVEL	PROPOSED LANDSCAPING		ELANORA HEIGHTS	
	RELATIVE SPOT LEVEL	21 DIEW ROOF PITCH		LOT 101 DP 32253	
DØØØ	EXISTING WALLS	NEW LAWN AREA		Drawing Title: PHOTORENDERINGS SHEET	DDG
	NEW MASONRY WALLS	NEW PAVED AREA			×
	EXISTING WALLS/ ELEMENTS     TO BEDEMOLISHED     SITE SECTION CUT LINES	NEW POOL AREA           FFL         FINISHED FLOOR LEVEL	I DEVELOPMENT APPLICATION 15.1	.24 Drawn By:	DALE DESIGI
ACCREDITED	SITE SETBACK LINES		Client:	B. DALE	GROUP
BUILDING DESIGNER		EXISTING GROUND LINE TO BE	MS BARBI HOFMOCKEL	DEVELOPMENT APPLICATION	12 BURRELL ROAD, KENTHURST, NSW, 2156 ABN: 64 93 809 8664
	EXISTING TREES TO BE RETAINED & PROTECTED	ALTERED		NO SCALE@ A3 A15 01	PHONE: 0423 428 973

POLYCARBONATE SHEETING ON TIMBER FRAME

PROPOSED TERRACOTTA ROOF TILES TO EXTENSION

TERRACOTTA ROOF TILES IN MONIER "EARTH" OR SIMILAR TO MATCH EXISTING ROOF TILES

### PROPOSED FACE BRICK MASONRY WALLS TO EXTENSION


FACE BRICK TO MATCH EXISTING BRICKWORK, IN MIDLAND "RED BRICK" SMOOTH OR SIMILAR





HARDWOOD THICK TIMBER HARDWOOD POSTS TO CARPORT AND TIMBER DECK

HARDWOOD TIMBER POSTS APPROX 200 X 200mm STAINED SIMILAR TO PHOTO

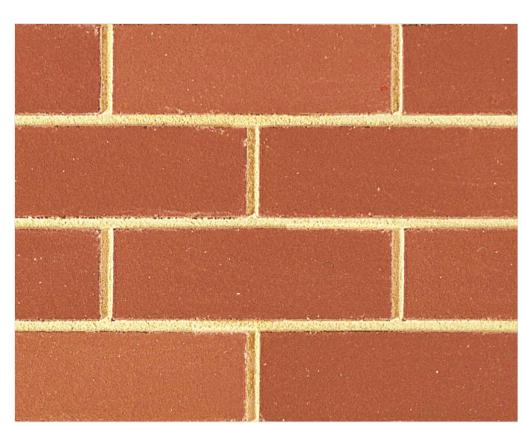

### HARDWOOD TIMBER DECKING TO PROPOSED READ DECK

HARDWOOD TIMBER TBA, STAINED CHARCOAL OR SIMILAR AS PER PHOTO



1	DEVELOPMENT APPLICATION	15.11.
ISSUE	REVISION DESCRIPTION	DAT
<sub>Chent:</sub> MS	BARBI HOFMOCKE	ĒL

### NEW ALUMINIUM WINDOWS & DOORS FRAMES, DOWNPIPES & FASCIA BOARD

POWDERCOATED / PAINTED IN DULUX "VIVID WHITE" OR SIMILAR TO MATCH EXISTING FRAMES, FASCIA BOARD AND DOWNPIPES


*Dulux* ₁w Vivid White ™


PROPOSED CONCRETE DRIVEWAY

LIGHT GREY TONE TO MATCH EXISTING DRIVEWAY CONCRETE

		LEGEND		FLOOR LEVELS
11. 11.	*120 <sup>.01</sup>	EXISTING SITE LEVEL		PROPOSED LANDSCAPING
	x118.10	PROPOSED SITE LEVEL		
	•	RELATIVE SPOT LEVEL	21	NEW ROOF PITCH
		EXISTING WALLS		NEW LAWN AREA
	_	NEW STUD WALLS		
		NEW MASONRY WALLS		NEW PAVED AREA
		EXISTING WALLS/ ELEMENTS TO BEDEMOLISHED		NEW POOL AREA
ACCREDITED		SITE SECTION CUT LINES	FFL	FINISHED FLOOR LEVEL
ACCREDITED		SITE SETBACK LINES	V.777777	AREA TO BE FILLED WITH EARTH
		TREE PROTECTION ZONE		AREA TO BE FILLED WITH EARTH
BUILDING DESIGNER	Ô	EXISTING TREES TO BE RETAINED & PROTECTED		EXISTING GROUND LINE TO BE ALTERED

42 FOXALL STREET ELANORA HEIGHTS 2101 NSW LOT 101 DP 32253	
Drawing Title: EXTERNAL COLOURS & FINISHES ECHEDULE	BGG
B. DALE	DALE DESIGN GROUP
Drawing Status: DEVELOPMENT APPLICATION Drawing Scale: NO SCALE@ A3 A16 01	I 2 BURRELL ROAD, KENTHURST, NSW, 2156 ABN: 64 93 809 8664 PHONE: 0423 428 973

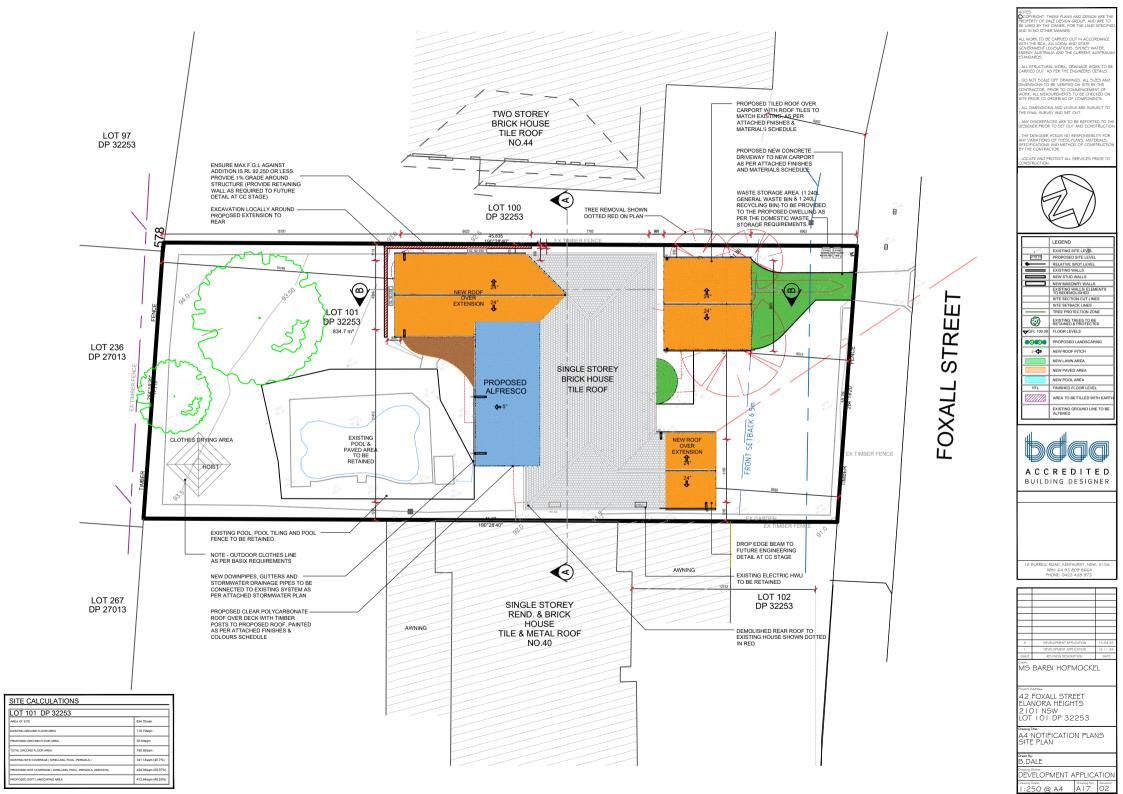

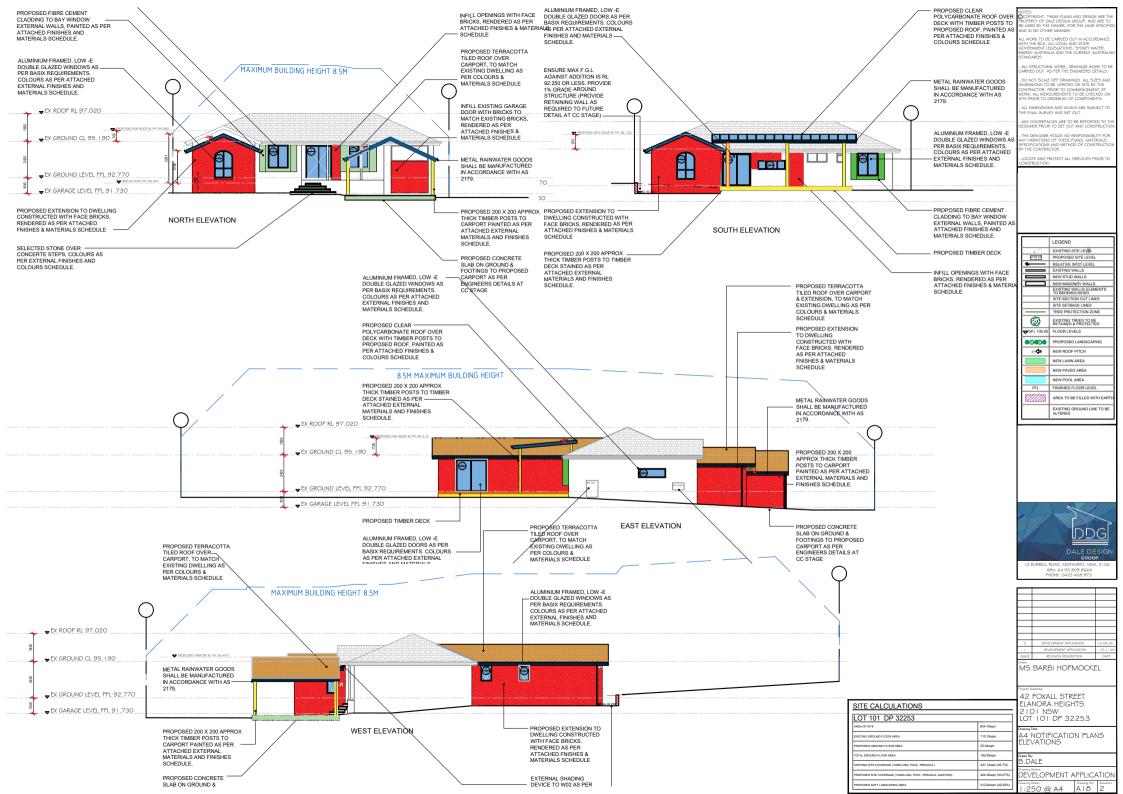



Project Address:	
42 FOXALL STREET ELANORA HEIGHTS 2101 NSW LOT 101 DP 32253	7
A DALE DES	] GN
D. DALL         GROUP           Drawing Status:         12 BURRELL ROAD, KENTHURST, NSW, 2           DEVELOPMENT APPLICATION         12 BURRELL ROAD, KENTHURST, NSW, 2           Drawing Scale:         1300 @ A3           1:300 @ A3         A 1 9           01         PHONE: 0423 428 973	56