DRAWING LIST	
DRAWING NO.	DRAWING LIST
000	COVER PAGE
005	BASIX COMMITMENT
010	LOCATION PLAN
020	CUT&FILL PLAN
050	SITE ANALYSIS
120	LOW GROUND FLOOR PLAN
130	GROUND FLOOR PLAN
140	ROOF PLAN
200	ELEVATION
210	ELEVATION
300	SECTION
500	SHADOW DIAGRAM
510	SHADOW DIAGRAM
600	AREA CALCULATION
700	EXTERNAL FINISH SCHEDULE



DEVELOPMENT APPLICATION PROPOSED DWELLING AT LOT 03, 10 FERN CREEK ROAD, WARRIEWOOD

PREPARED FOR

			SUMMERY NOTES WITH BASIX CERTIFICATE)						
	•		cate # 1266847S						
WATER No hot water reticulation required									
Fixtures	All shower heads	All toilets	All kitchen taps	All bathrooms taps					
Rating	3 Star(>4.5 But<=6L/Min)	4 star	5 star	5 star					
Alternate water sour	ce								
Rain Water Tank	Туре	Size	Roof area connected	Connections					
	Individual RWT	2000L	100 m2	Outdoor tap for landscape only					
Swimming pool									
	Volume	Heated	Cover	Shaded					
ENERGY									
Hot water	Туре		Rating						
1	ndividual, gas instantaneou	S	5 star						
Mech. Ventilation	System		Operation Control						
Bath	Indiv. fan, ducted to facade	or roof	Manual Switch On/Off						
L'dry	Indiv. fan, ducted to facade	or roof	Manual Switch On/Off						
Kitchen	Indiv. fan, ducted to facade	or roof	Manual Switch On/Off						
Cooling System	Туре		Living areas	Bed rooms					
	1 Phase Air conditioning: D	ay / Night Zoned	2.5 star (average zone)	2.5 star (average zone)					
Heating System	Туре		Living areas	Bed rooms					
	1 Phase Air conditioning: D	ay / Night Zoned	2.5 star (average zone)	2.5star (average zone)					
Artificial Lighting	Primary type of artificial I	ighting is fluoresce	ent or light emitting diode (LE	D)					
	No. of Bed rms & study	No. of Living	Each Kitchen, Bath / Toilet	L'dry & Hallway					
	All	All	Yes	Yes					
Others	Indoor private Cloth Line		Not Required						
	Outdoor or sheltered Clot		Yes						
	Well ventilated Fridge spa	ace	Yes						
	Kitchen Cook top / Oven		Gas Cook top + Electric Oven						
THERMAL	As per thermal simulat	ion carried out b	y assessor						
(refer assessor's	External Wall Insulatio								
stamped drawings)	Ceiling Insulation: R4.5								
			n Colour (SA 0.475 - 0.7) + S	SS Foil (R1.3)					
		•	tint U=6.6 SHGC =0.441 - 0	,					
	All External doors & w								
	Eaves / shading as per		 						



This drawing is the copyright of PTI Architecture Pty Ltd and may not be altered, reproduced or transmitted in any form or by any means, in part or in whole without the written permission of PTI Architecture Pty Ltd.

Contractors to verify all dimensions on site before any shop drawings or work is commenced.

DEVELOPMENT APPLICATION SURVEY ISSUE

DESCRIPTION

BY CHK DATE REV


DESCRIPTION

BY CHK DATE

DL KC/PI 08.11.21 CLIENT
DL GF/PI 11.11.21 SKYCORP AUSTRALIA

LOT03,10 FERN CREEK ROAD, WARRIEWOOD

DRAWING
BASIX COMMITMENT

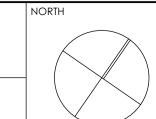


	DRAWN	CHECKED
>	DL, KC	PI / KC
	PROJECT No P563	SCALE @A1



LOCATION PLAN

		NOTE				Α	4	DEVELOPMENT APPLICATION	DL	KC/P	08.11.2	.1 CLIENT
ARCHITECTURE Tourism + Residential	Main Office: Level 2, 68 Sophia Street, Surry Hills NSW 2010 Parramatta Office: Level 15, Deloitte Building, 60 Station Street, Parramatta NSW 2150 + 61 2 9283 0860 www.ptiarchitecture.com.au Nominated Registered Architect: Peter Israel (reg no 5064) ABN 90 050 071 022	 Contractors to verify all dimensions on site before any shop drawings or work is commenced. Figured dimensions to be taken in preference to scaled dwgs. This drawing is to be read in conjunction with the specification and engineers drawings. 				В	3	SURVEY ISSUE	DL	GF/PI	11.11.2	SKYCORP AUSTRALIA
		This drawing is the copyright of PTI Architecture Pty Ltd and may not be altered, reproduced or transmitted in any form or by any means, in part or										
		in whole without the written permission of PTI Architecture Pty Ltd.	REV	DESCRIPTION	BY CHK	DATE	REV	DESCRIPTION	BY	СНК	DATI	E

P56	DA	1:1000@A	1 B	
DL, K		PI / KO	2	
DRAWN		CHECKED		

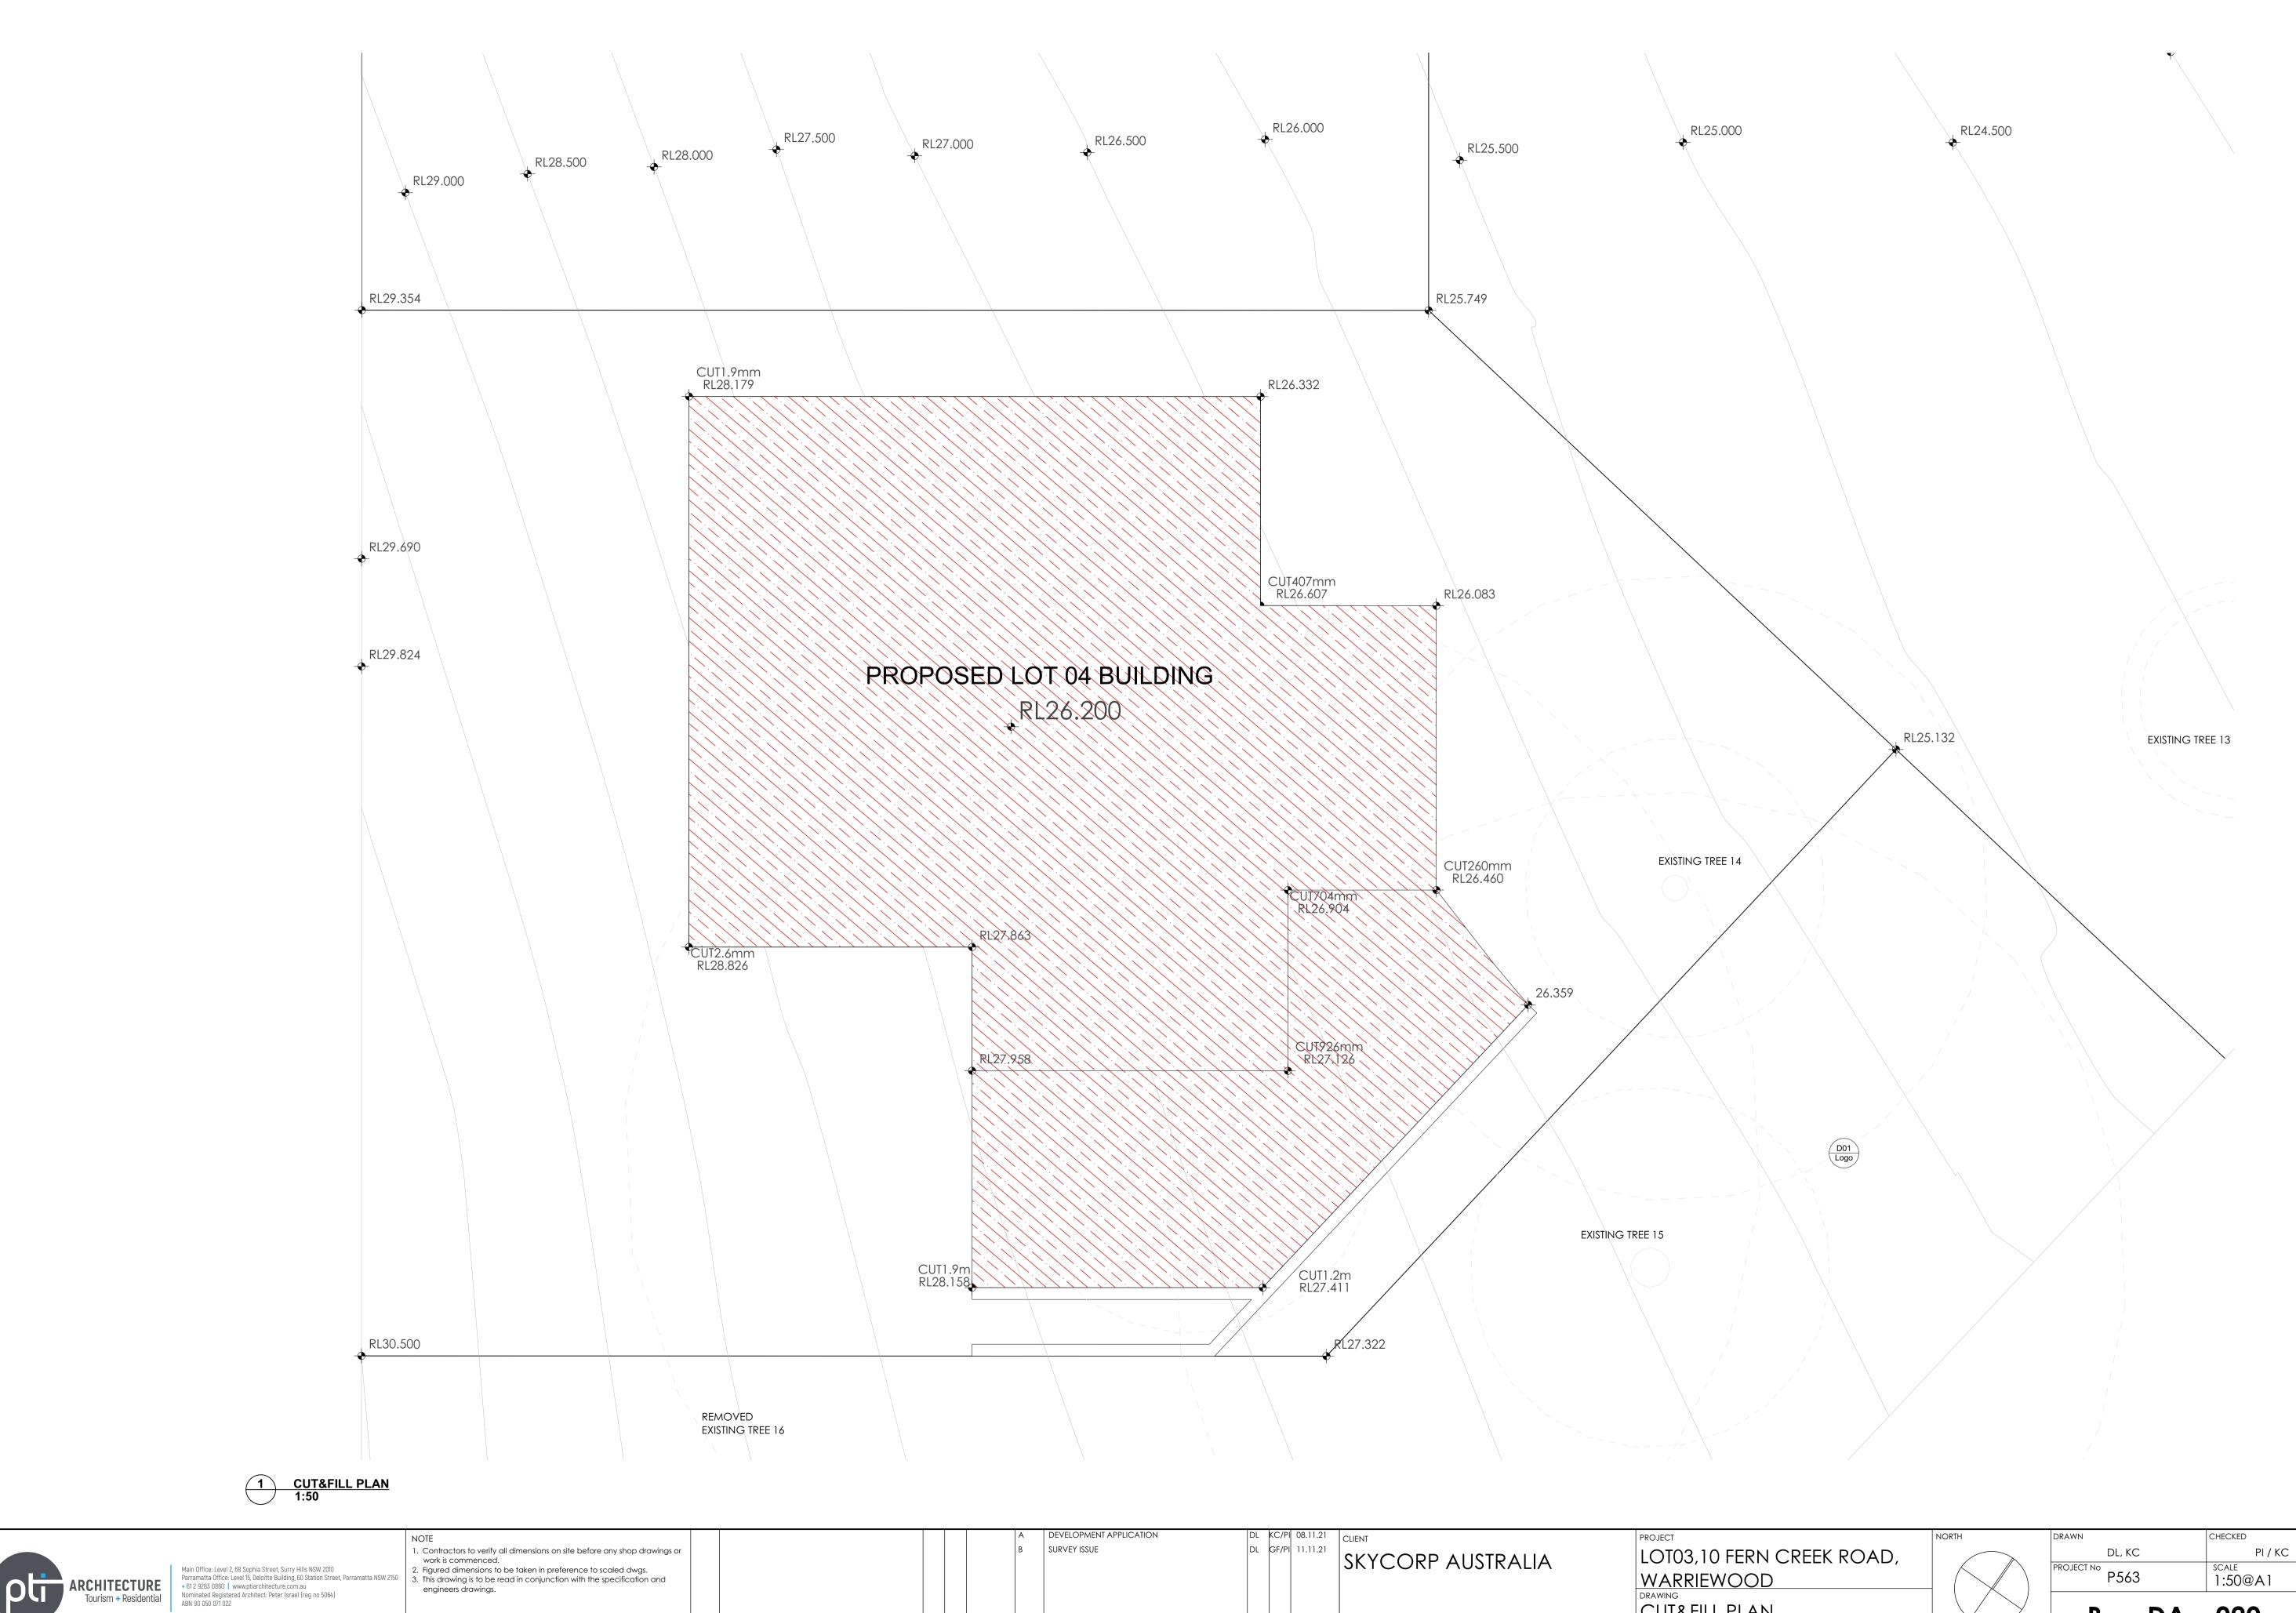

BY CHK DATE REV

DESCRIPTION


DESCRIPTION

BY CHK DATE

engineers drawings.

This drawing is the copyright of PTI Architecture Pty Ltd and may not be altered, reproduced or transmitted in any form or by any means, in part or in whole without the written permission of PTI Architecture Pty Ltd.

CUT&FILL PLAN

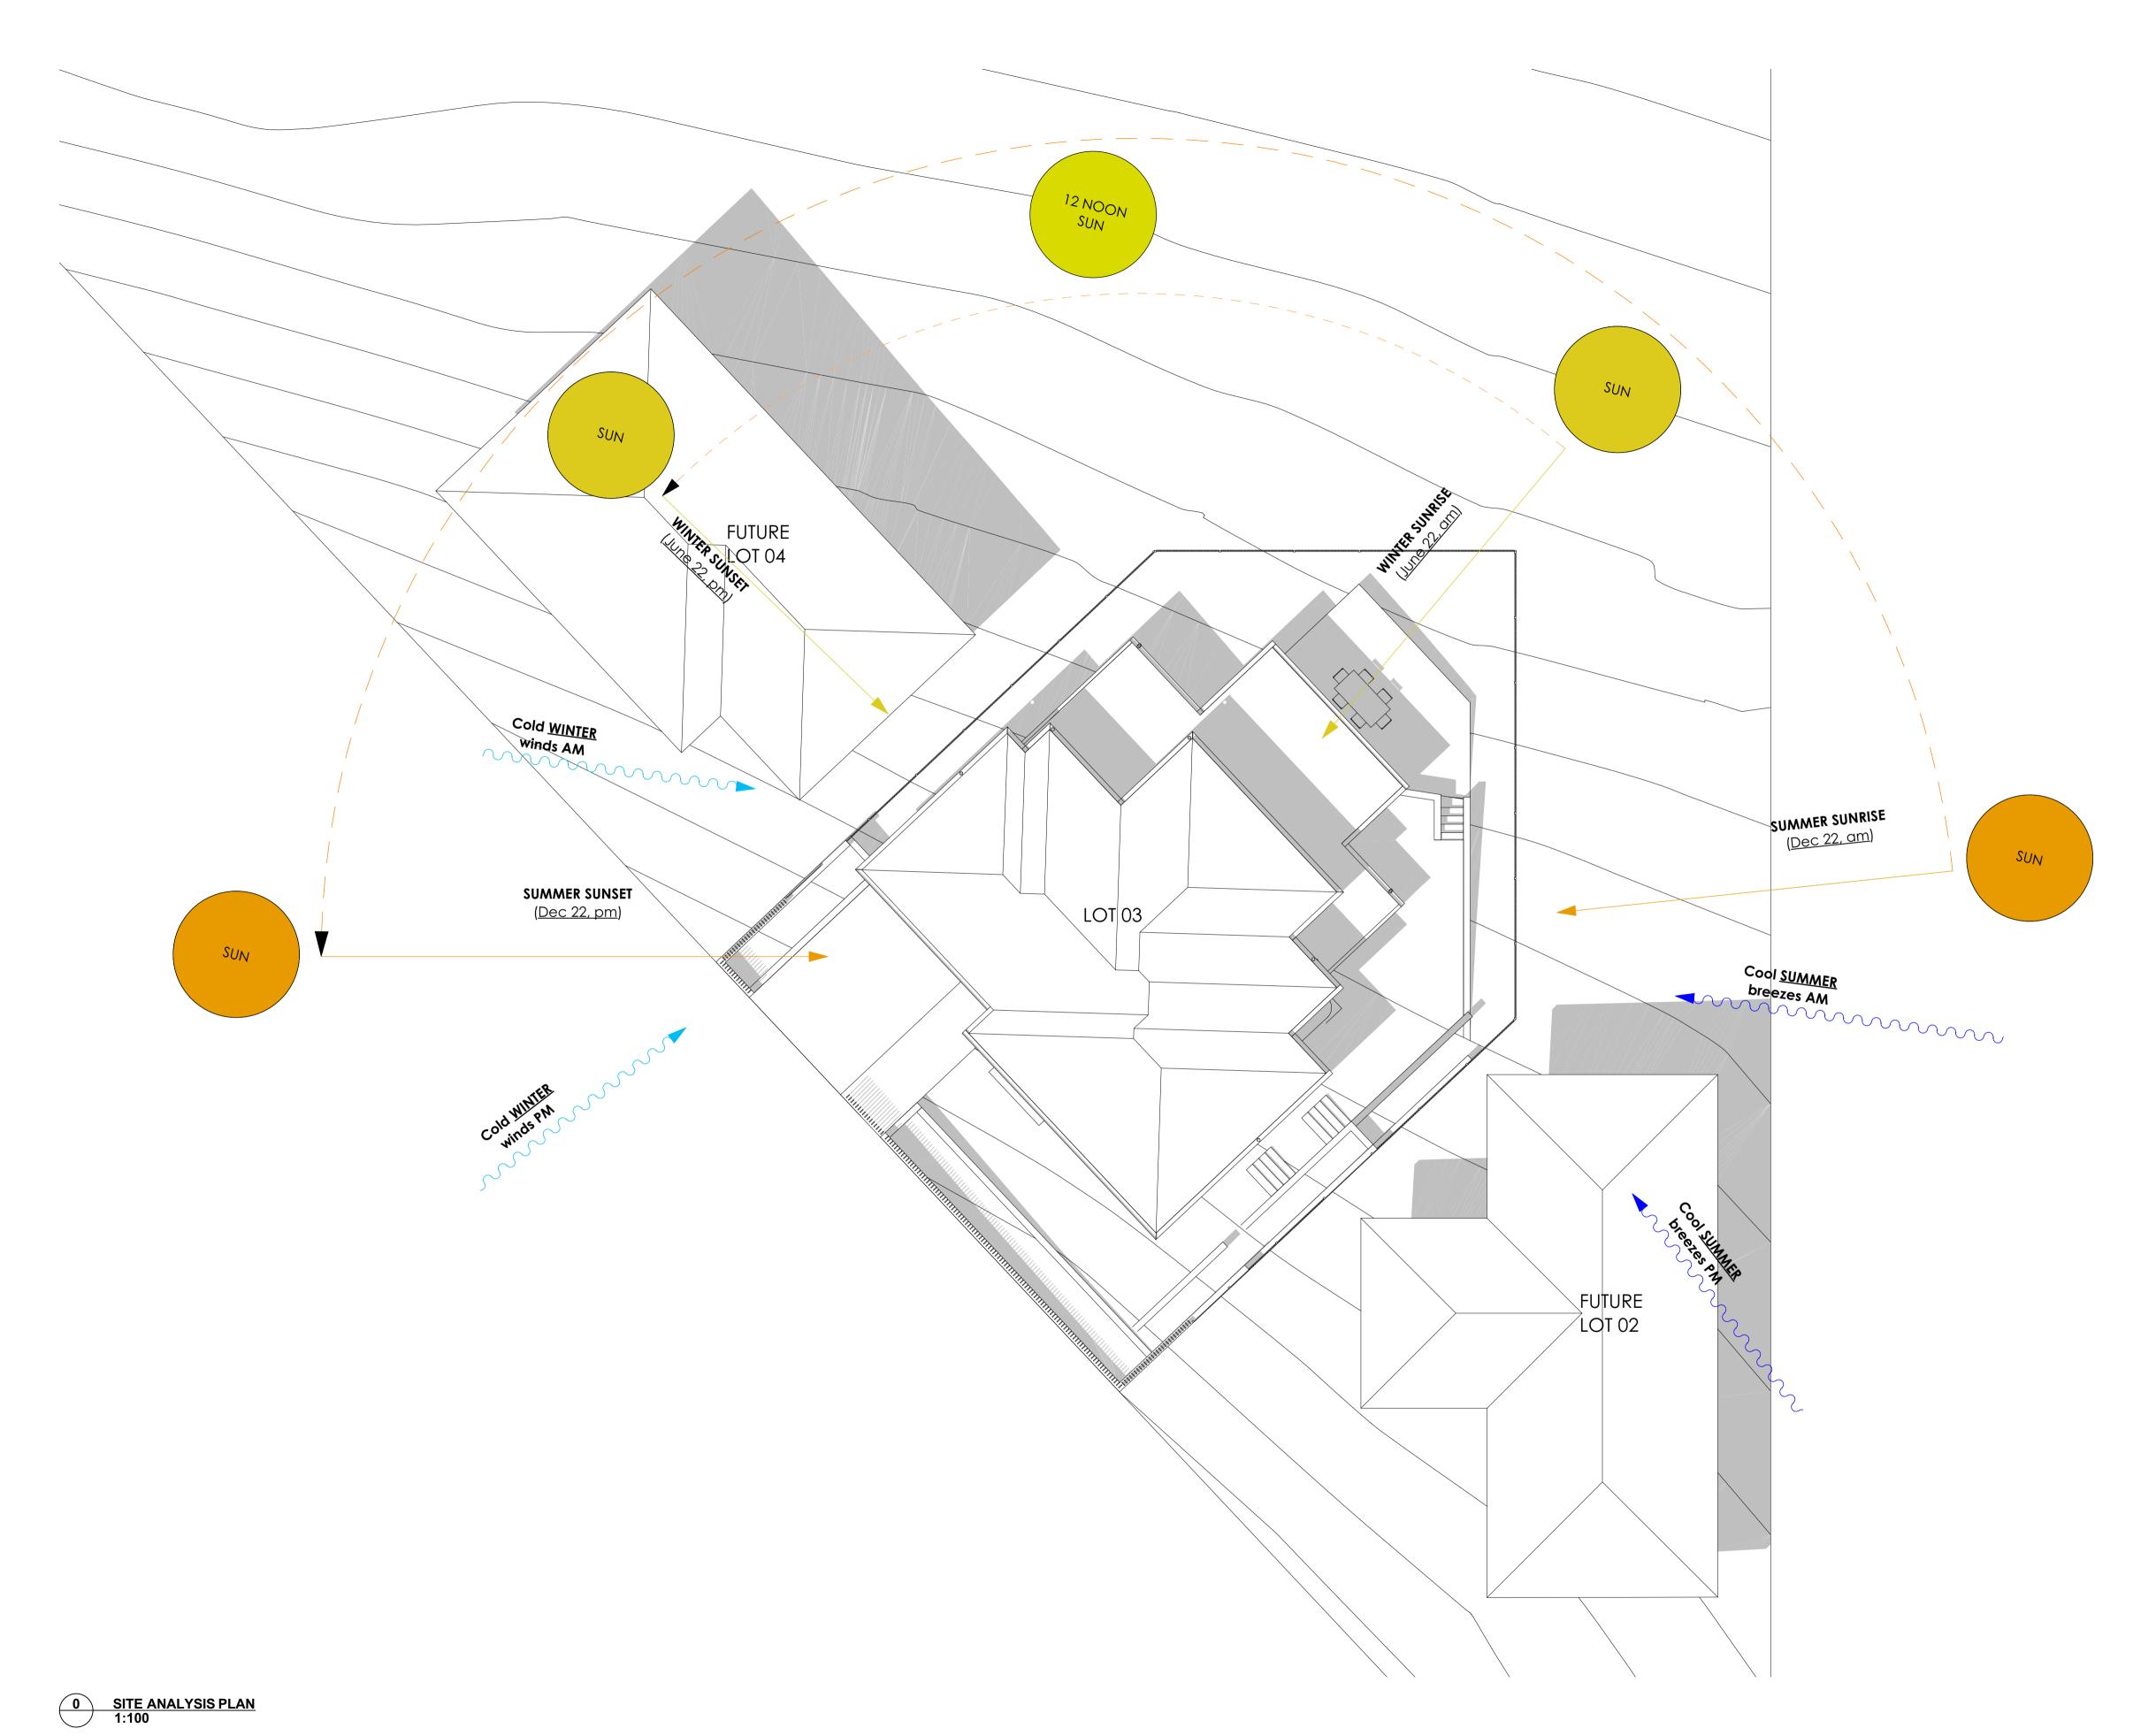

Main Office: Level 2, 68 Sophia Street, Surry Hills NSW 2010
Parramatta Office: Level 15, Deloitte Building, 60 Station Street, Parramatta NSW 2150
+ 61 2 9283 0860 | www.ptiarchitecture.com.au
Nominated Registered Architect: Peter Israel (reg no 5064)
ABN 90 050 071 022

 Contractors to verify all dimensions on site before any shop drawings or work is commenced. 2. Figured dimensions to be taken in preference to scaled dwgs.
3. This drawing is to be read in conjunction with the specification and engineers drawings.

This drawing is the copyright of PTI Architecture Pty Ltd and may not be altered, reproduced or transmitted in any form or by any means, in part or in whole without the written permission of PTI Architecture Pty Ltd.

DESCRIPTION

BY CHK DATE REV

DL KC/PI 08.11.21 CLIENT DL GF/PI 11.11.21 DEVELOPMENT APPLICATION SURVEY ISSUE SKYCORP AUSTRALIA

BY CHK DATE


DESCRIPTION


LOT03,10 FERN CREEK ROAD, WARRIEWOOD
DRAWING
SITE ANALYSIS

DRTH	DRAWN
	DL, KC
	PROJECT No P563
	B DA

PROJECT No P563 SCALE 1:100@A1	
DL, KC PI / KC	
DRAWN CHECKED	




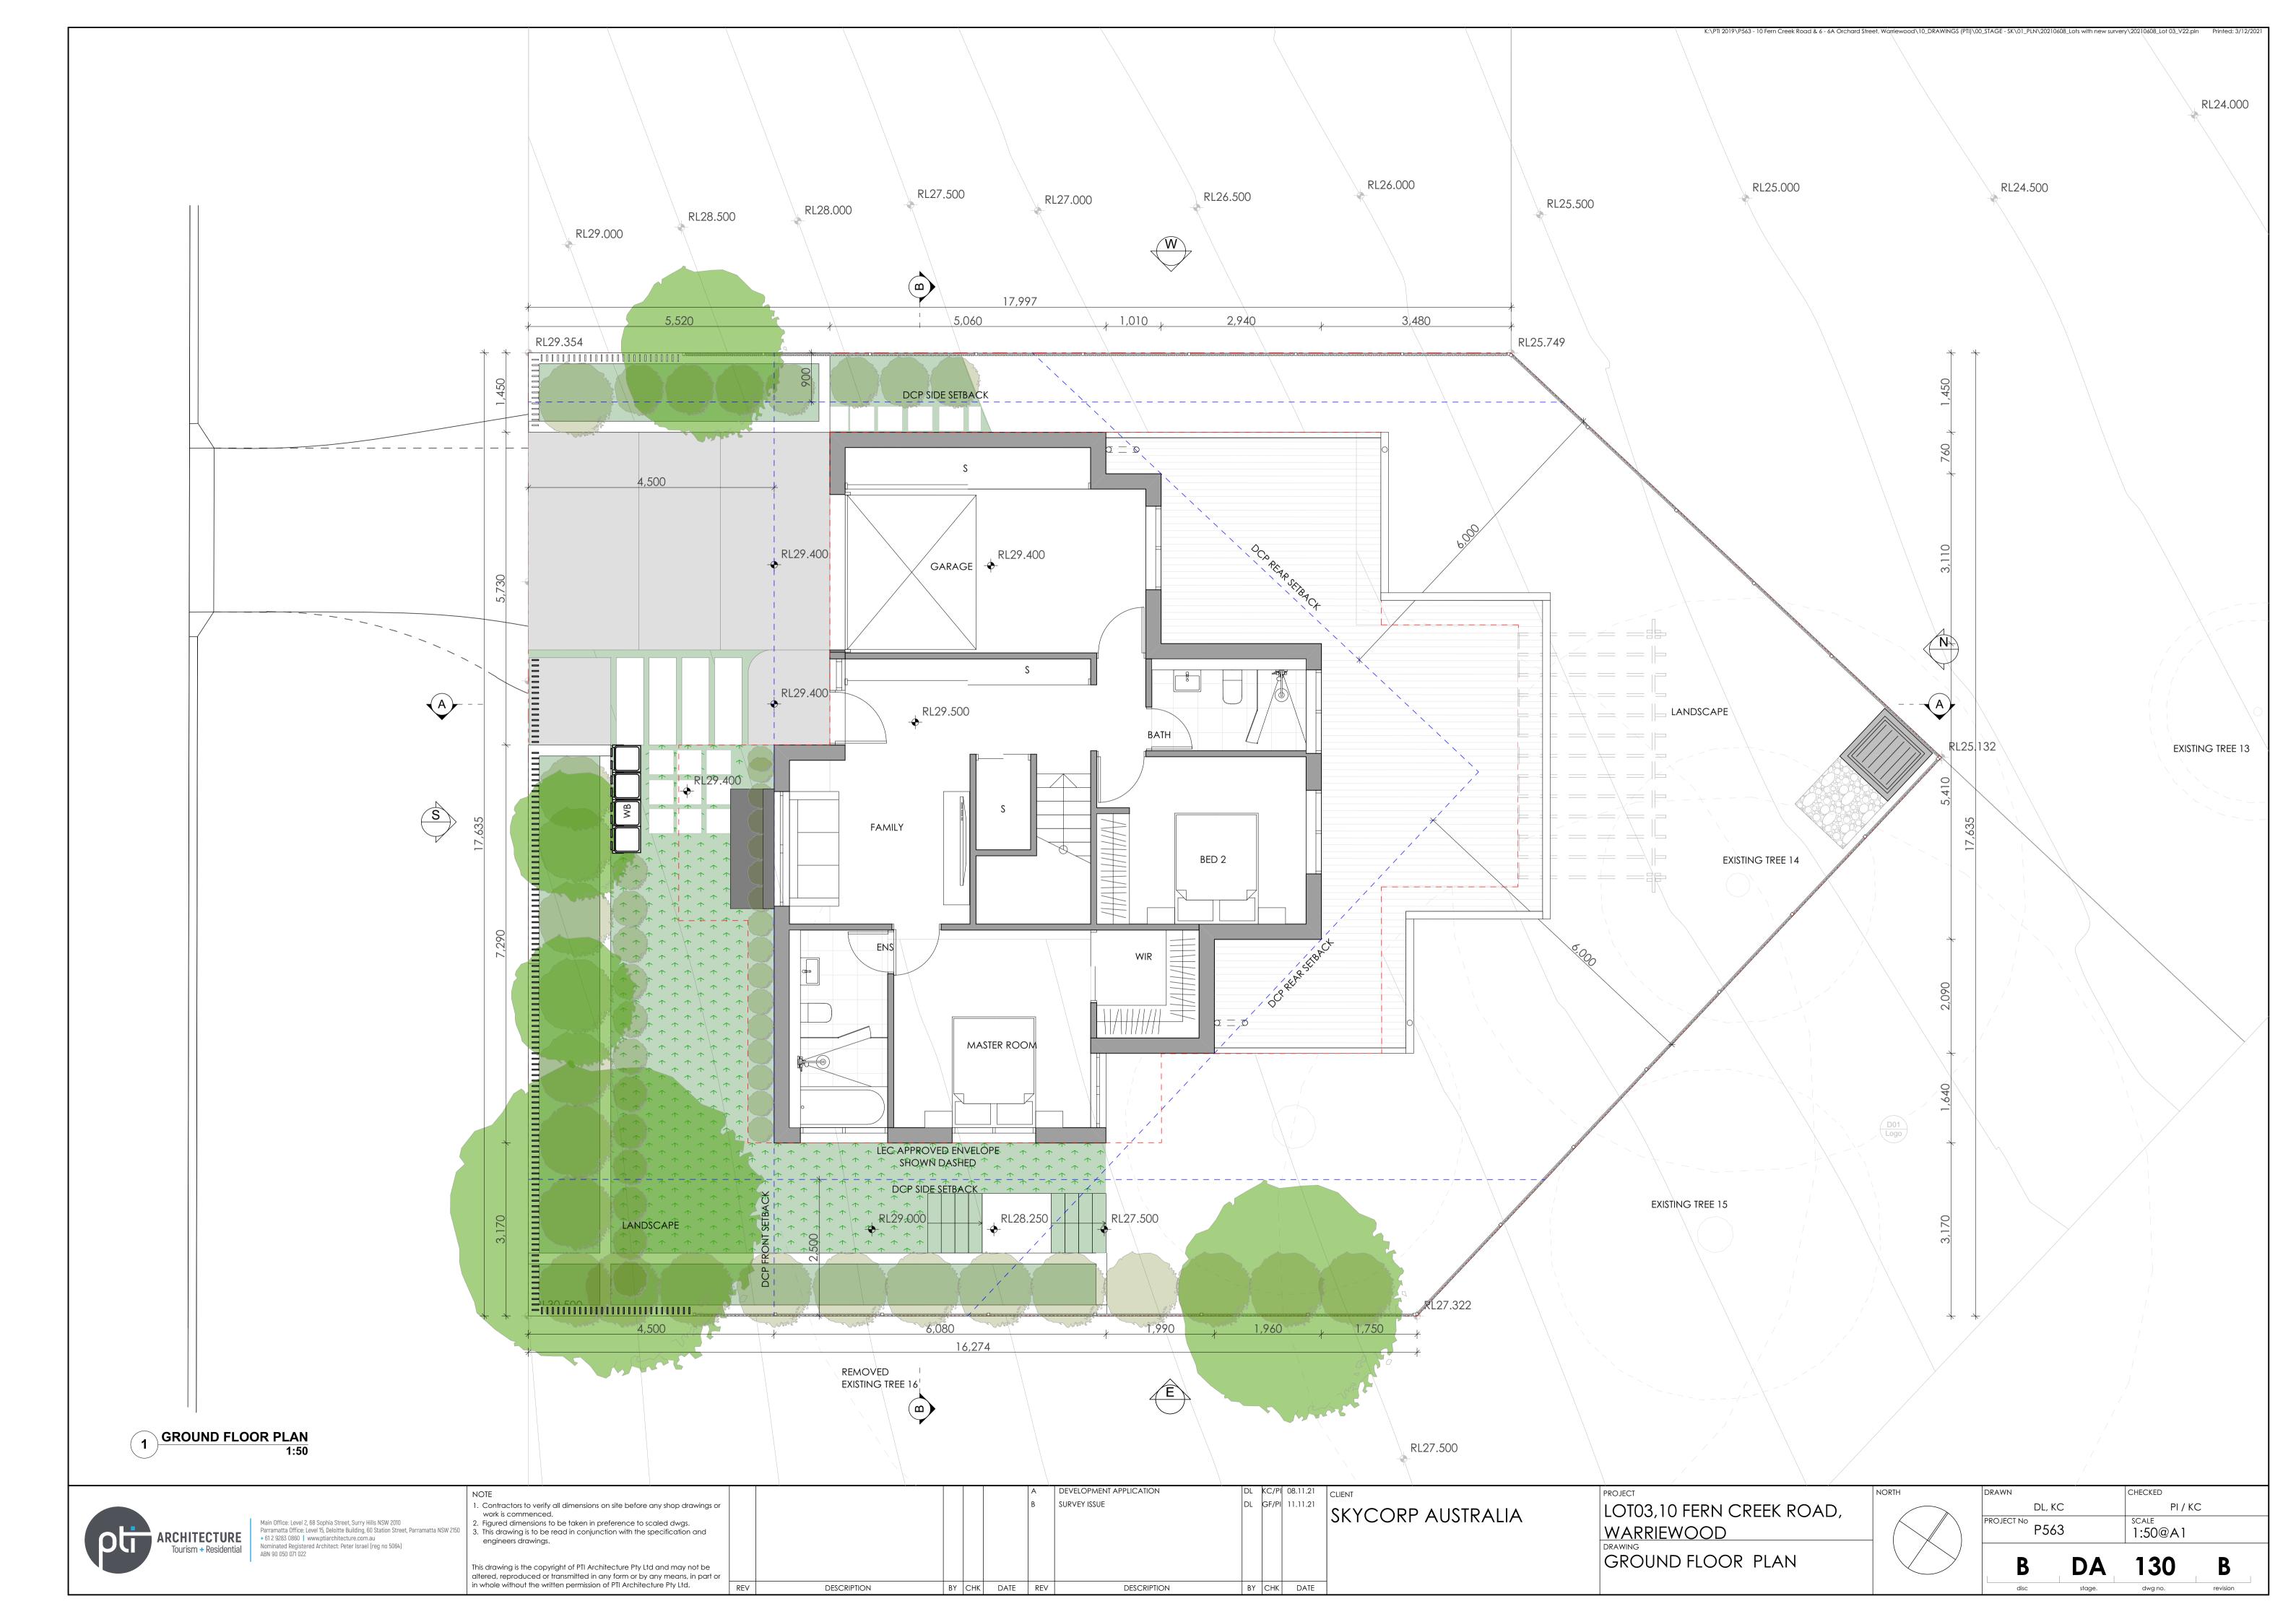


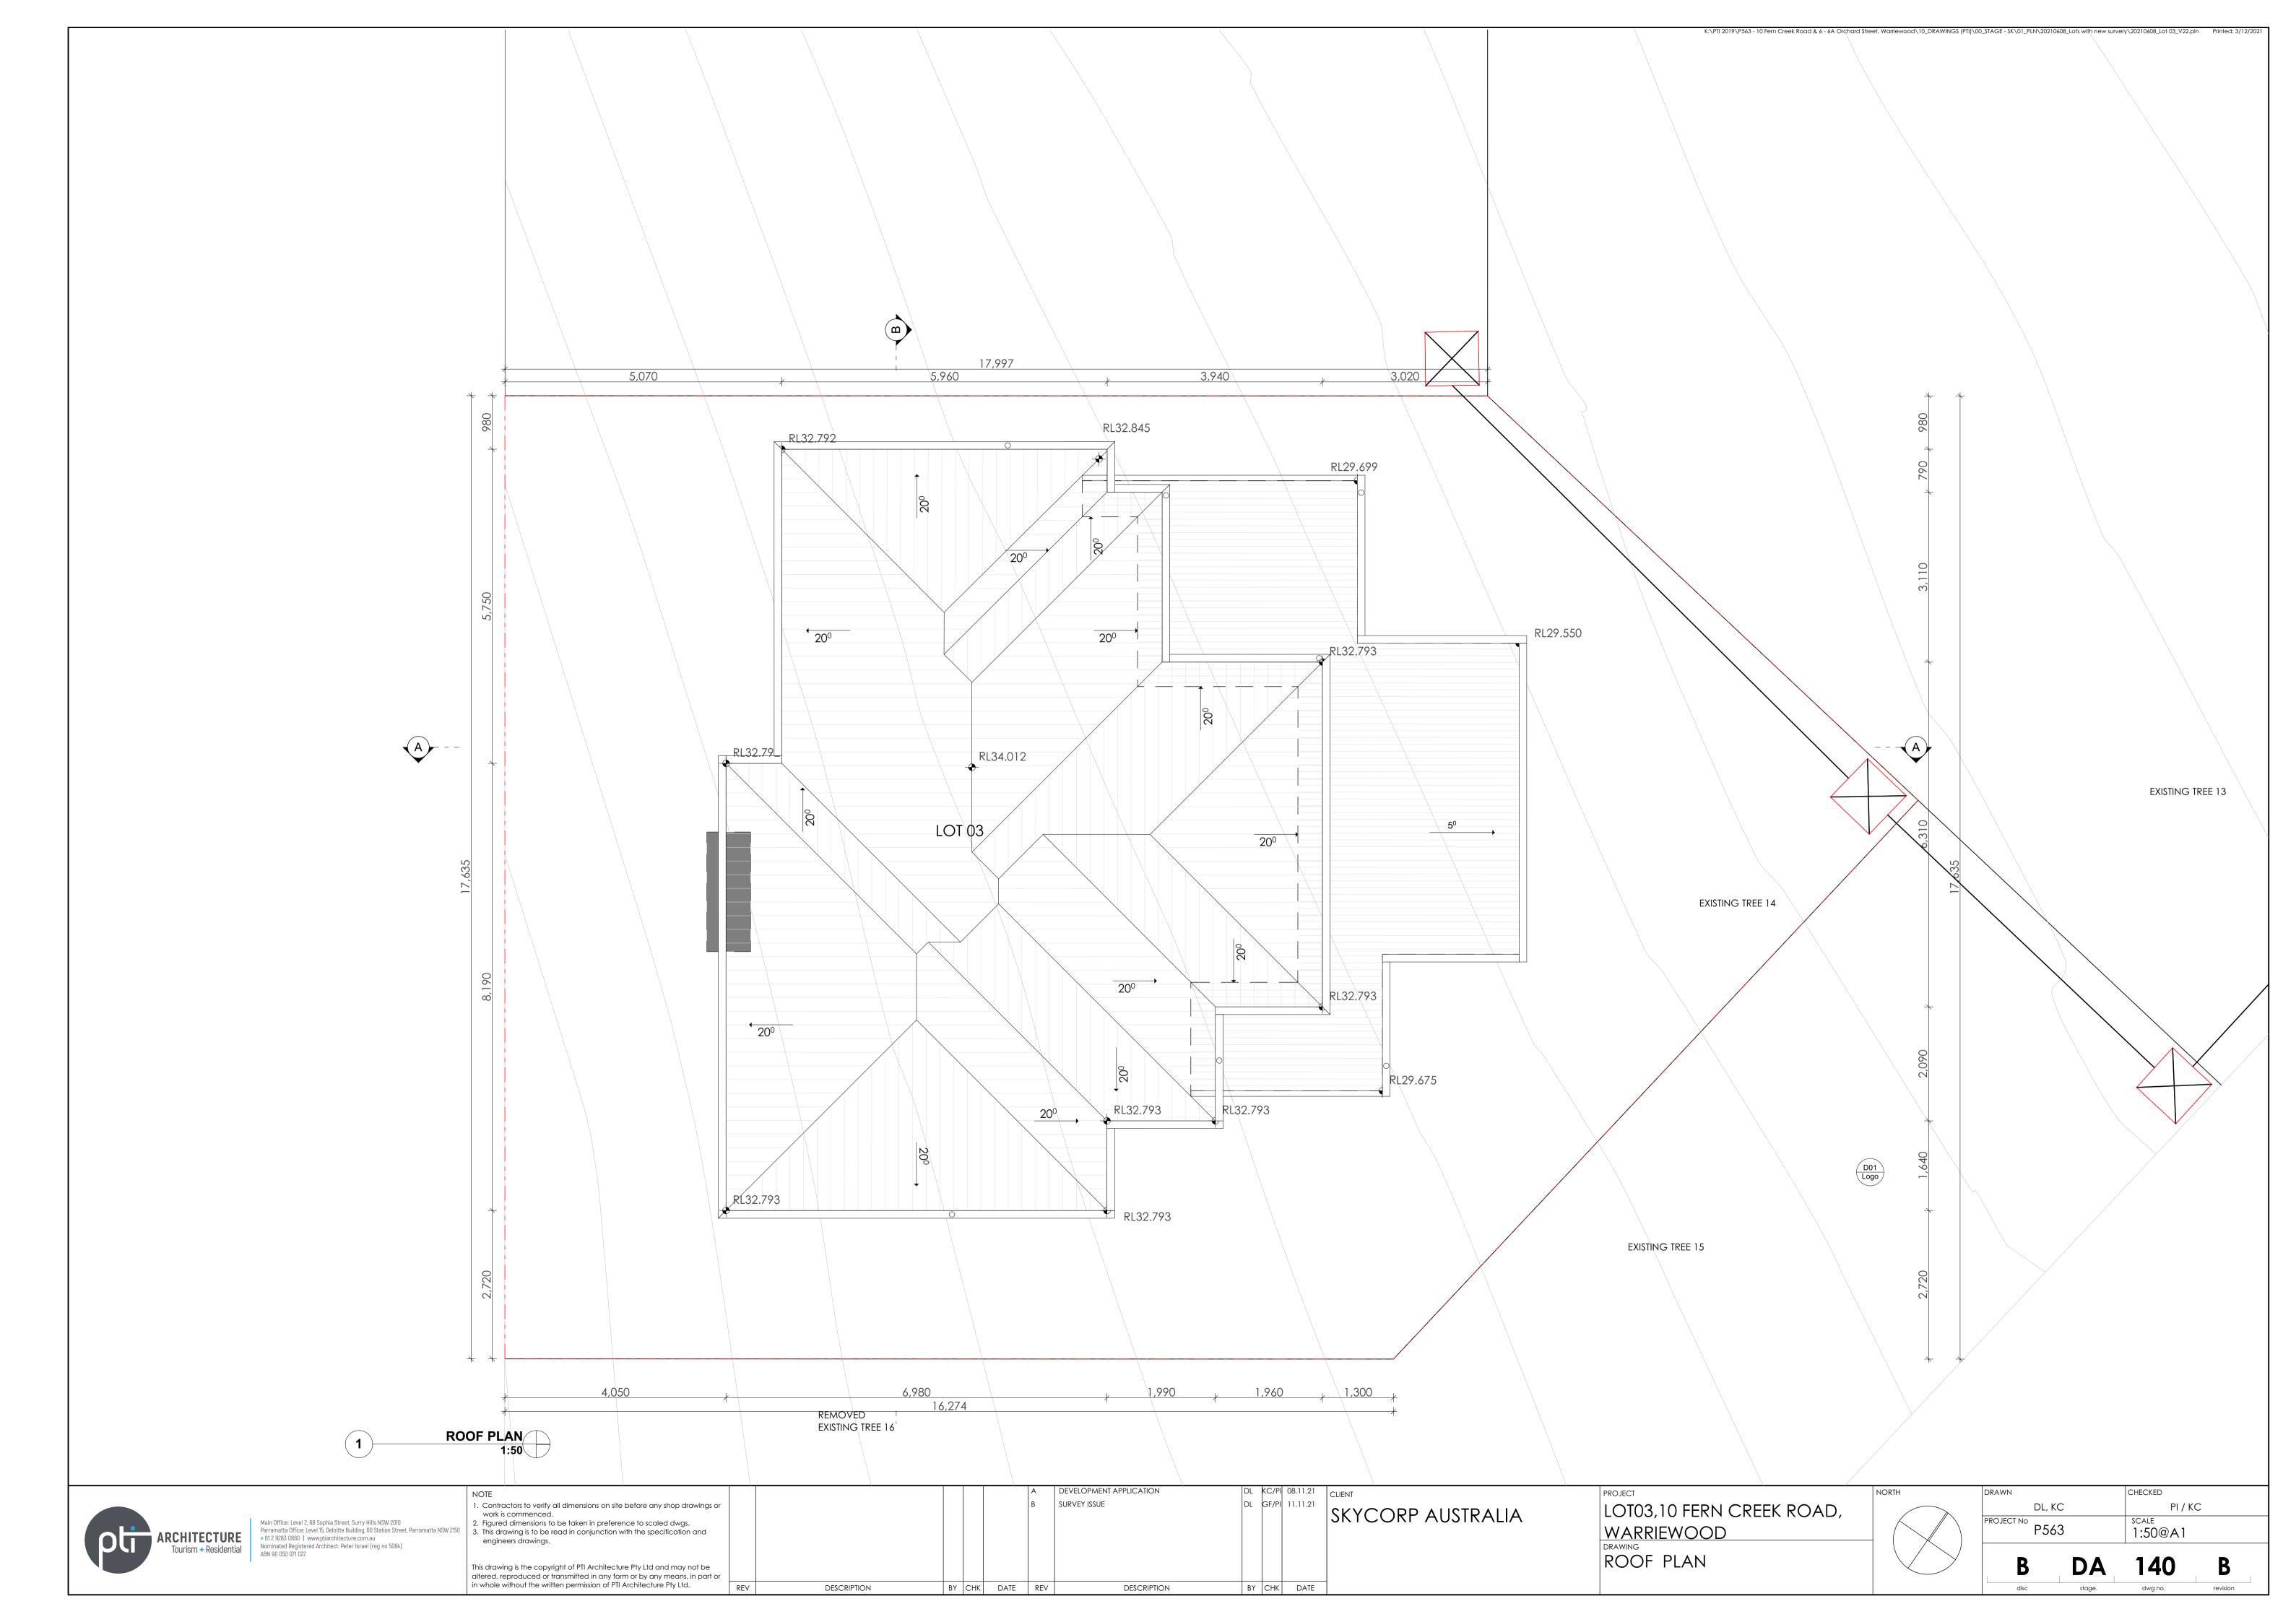







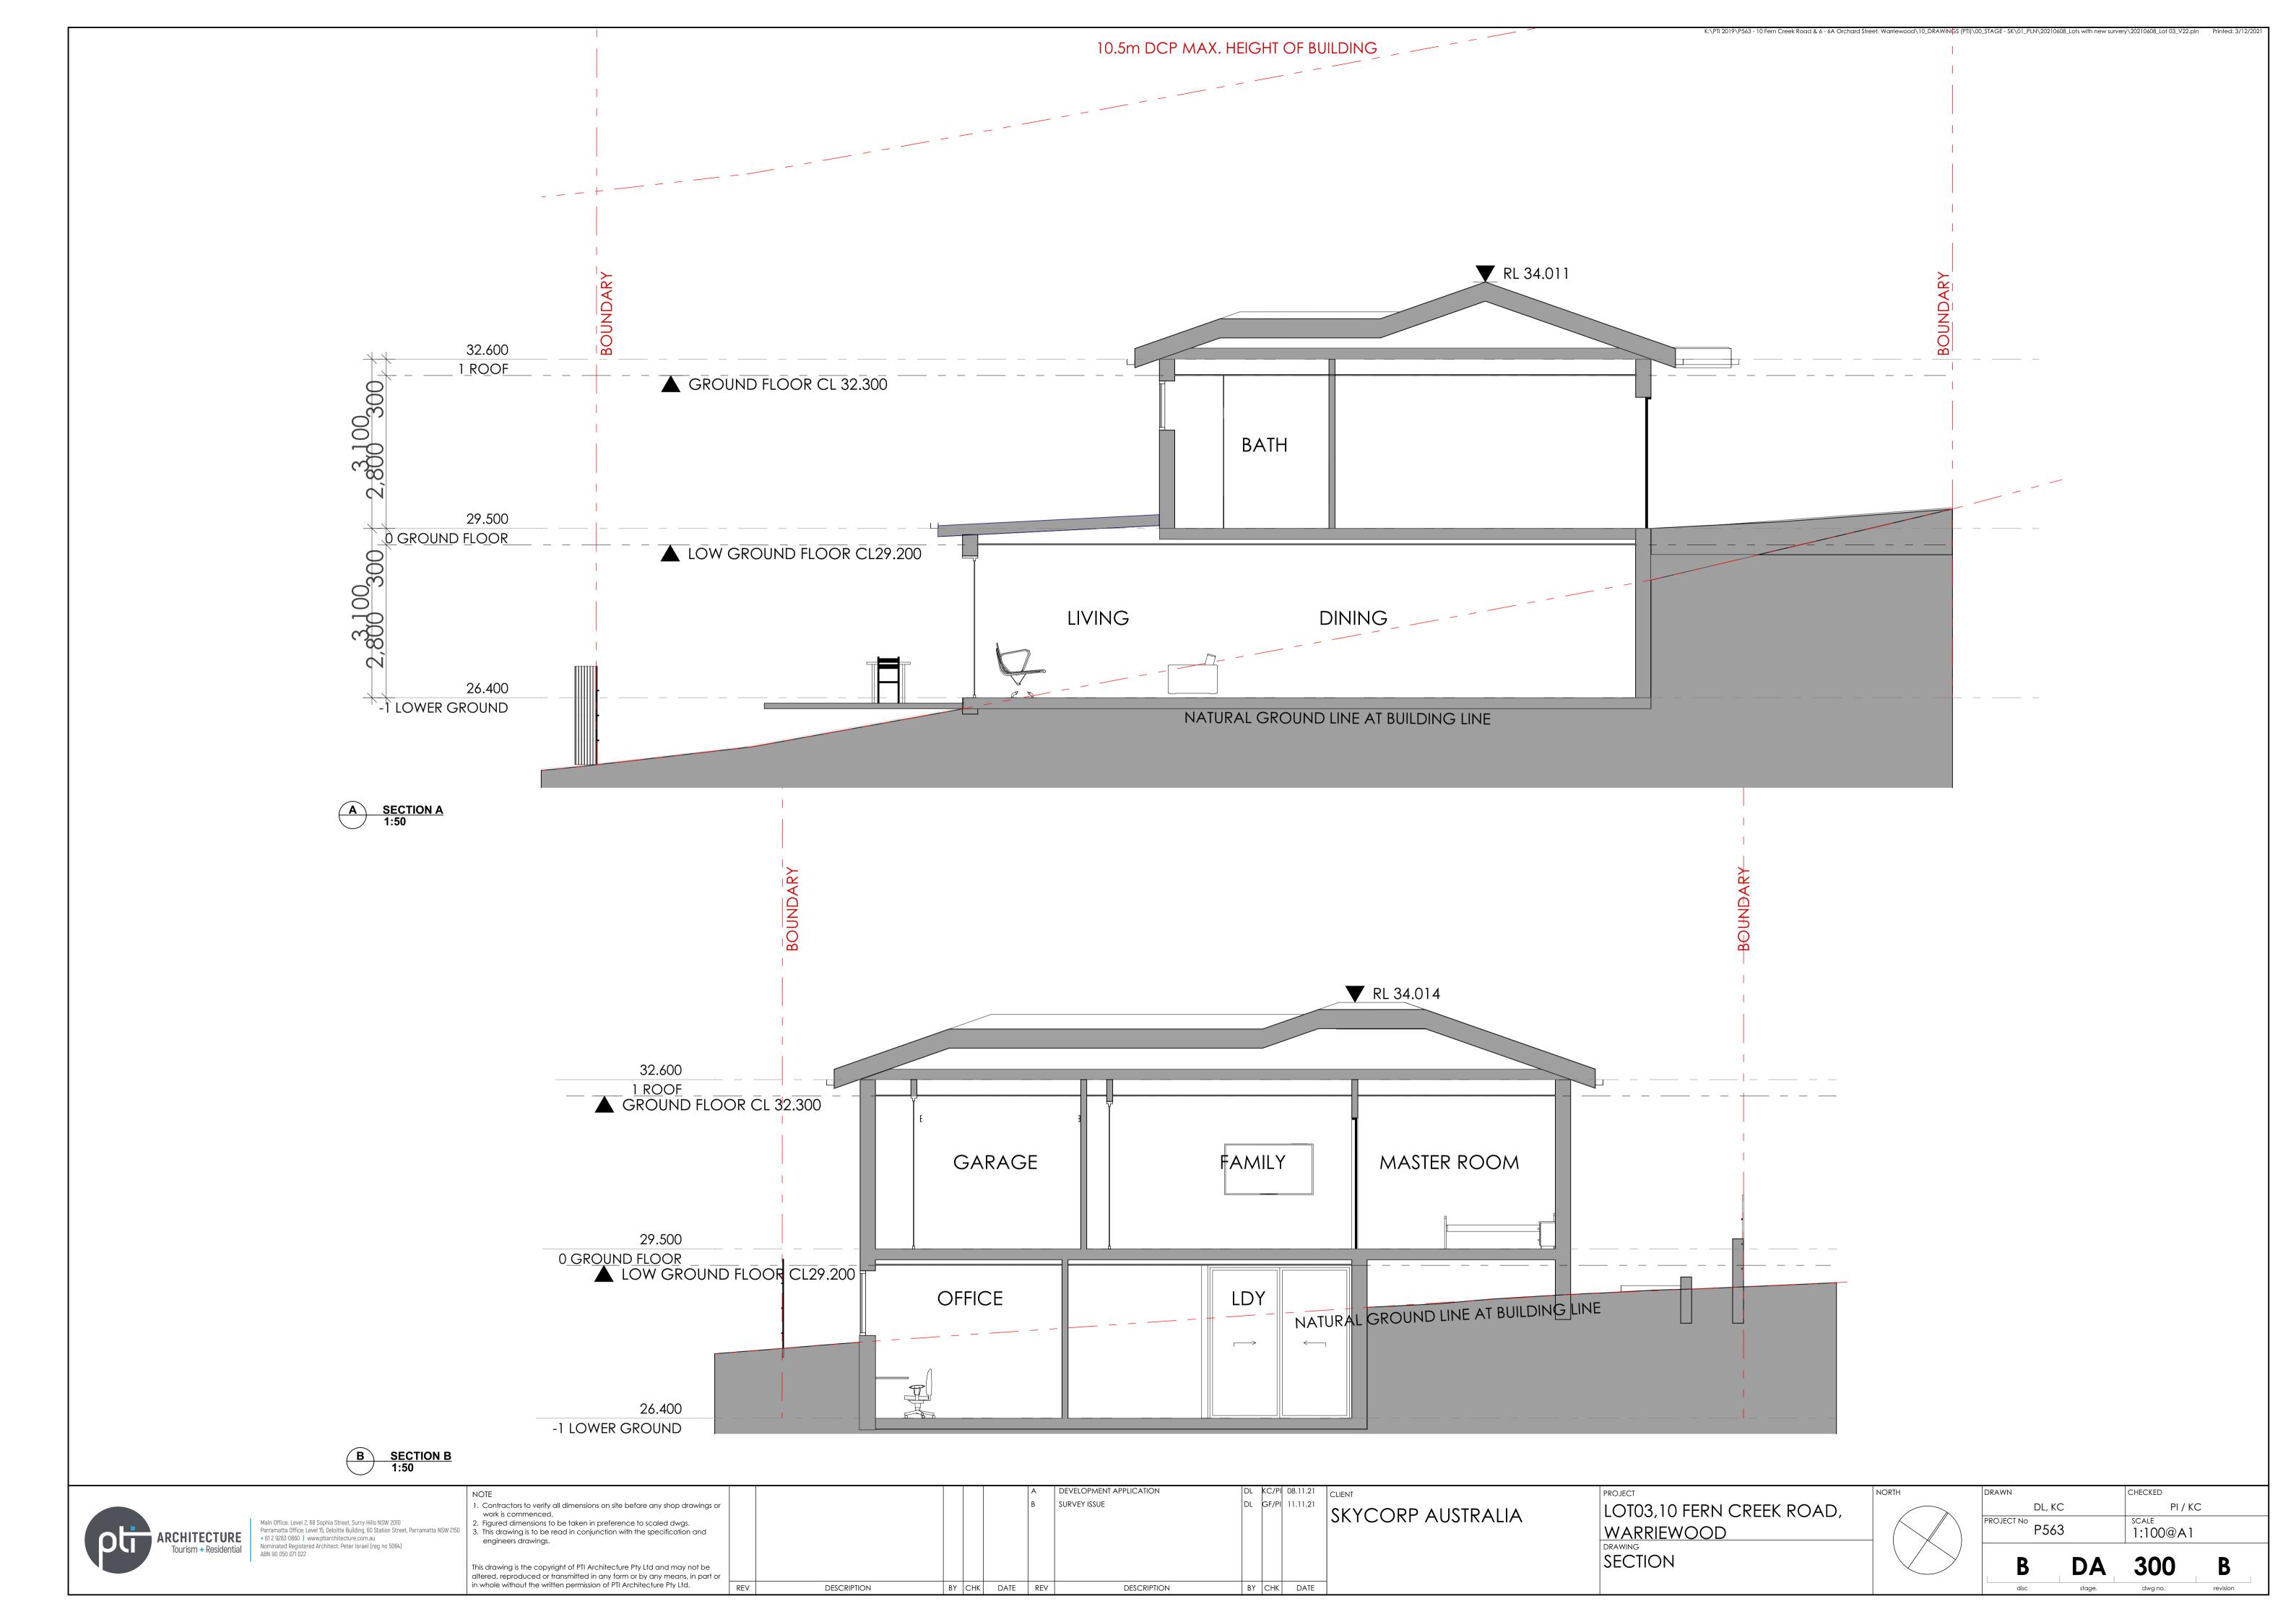

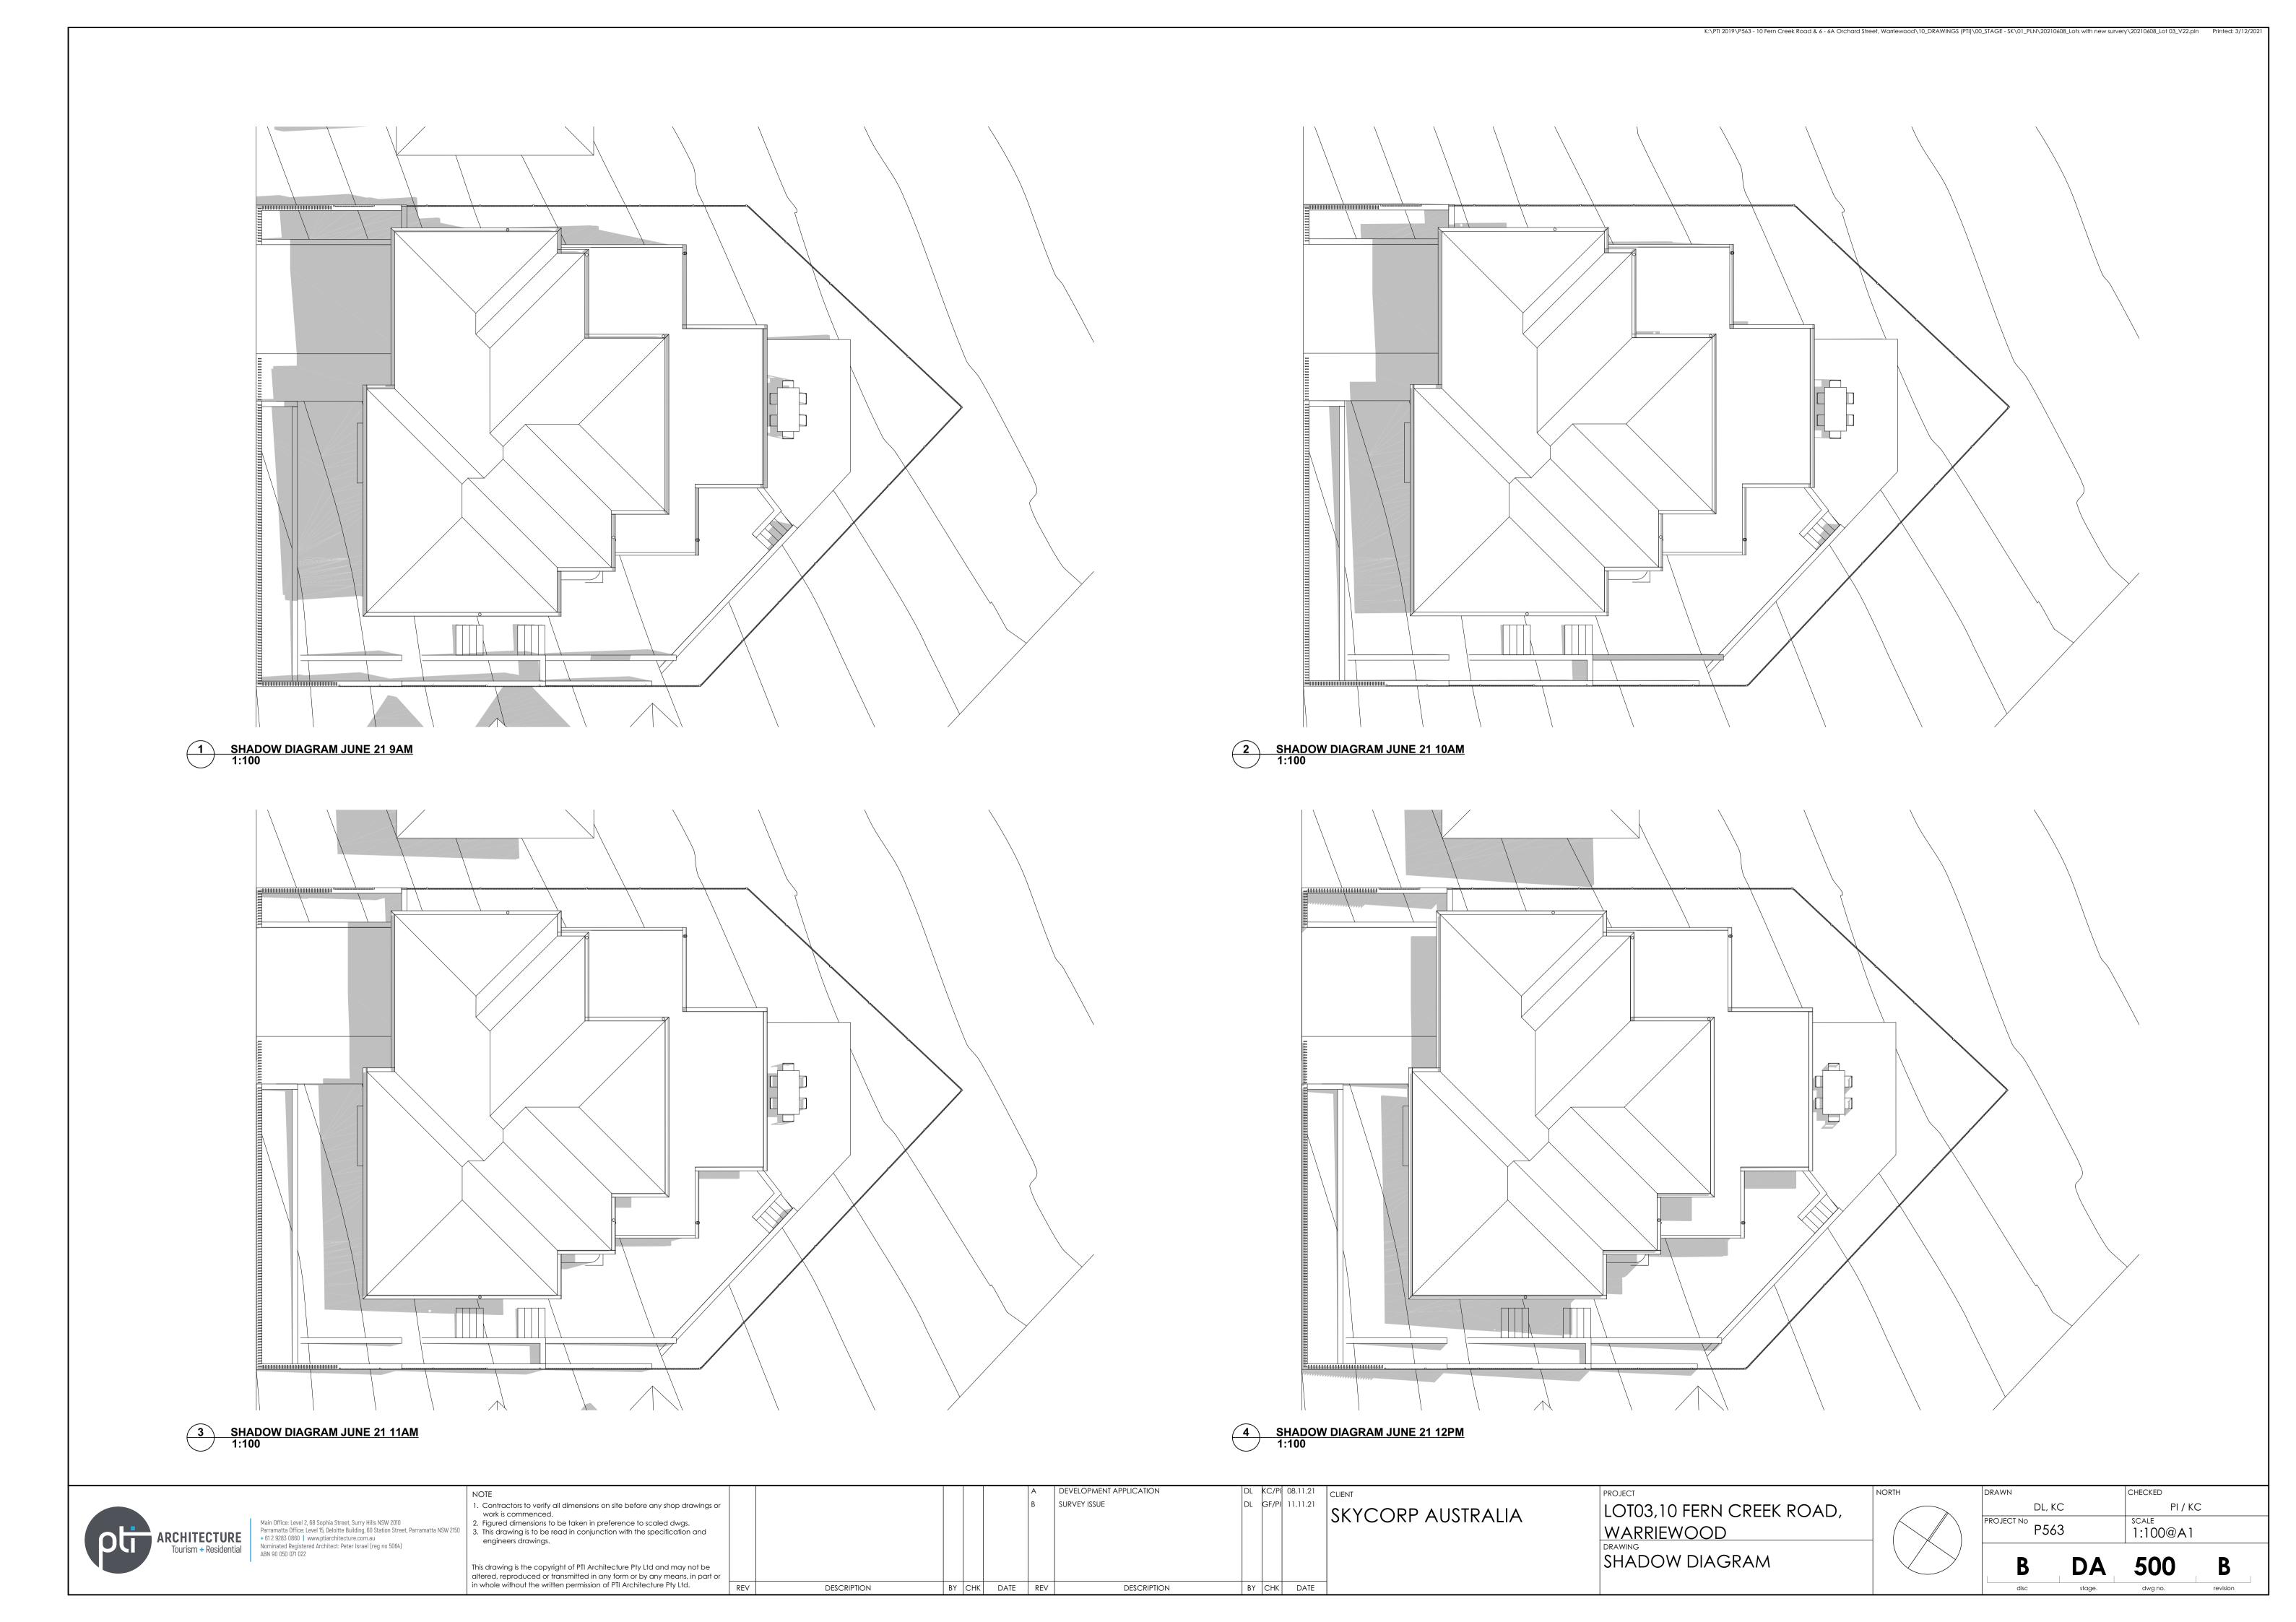

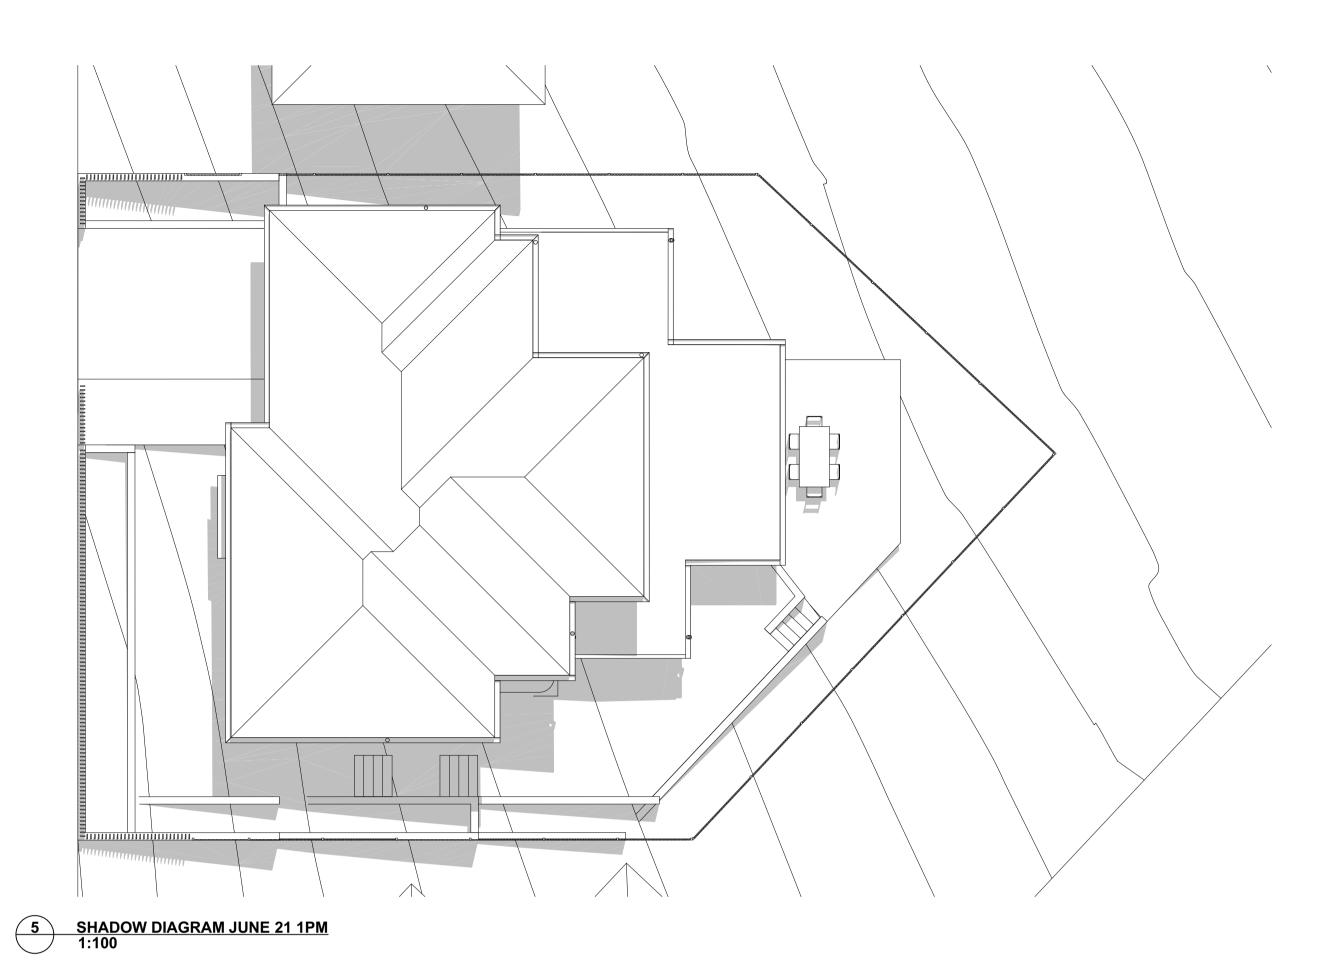

6 SHADOW DIAGRAM JUNE 21 2PM 1:100

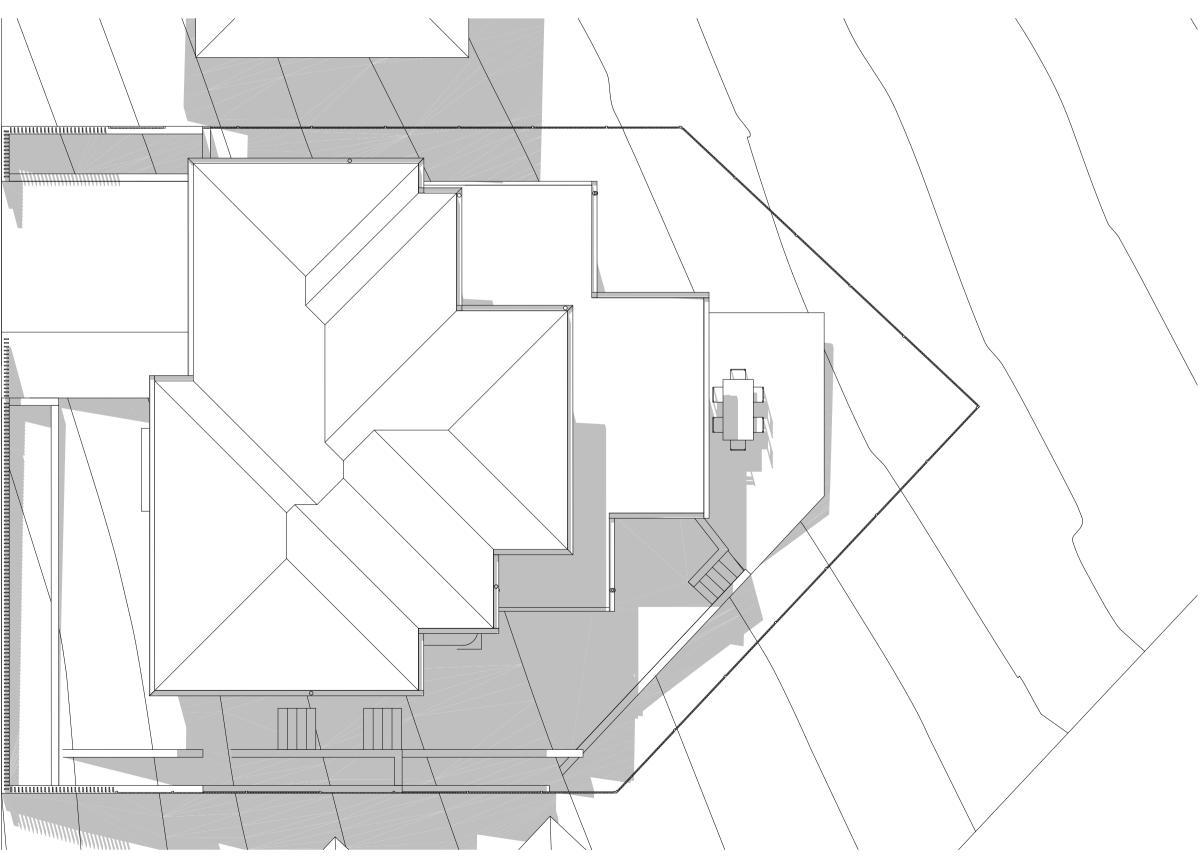

7 SHADOW DIAGRAM JUNE 21 3PM 1:100


DL KC/PI 08.11.21 CLIENT DL GF/PI 11.11.21 DEVELOPMENT APPLICATION CHECKED SURVEY ISSUE Contractors to verify all dimensions on site before any shop drawings or work is commenced. LOT03,10 FERN CREEK ROAD, DL, KC PI / KC SKYCORP AUSTRALIA Main Office: Level 2, 68 Sophia Street, Surry Hills NSW 2010
Parramatta Office: Level 15, Deloitte Building, 60 Station Street, Parramatta NSW 2150
+ 61 2 9283 0860 | www.ptiarchitecture.com.au Figured dimensions to be taken in preference to scaled dwgs.
 This drawing is to be read in conjunction with the specification and ° P563 WARRIEWOOD DRAWING 1:100@A1 ARCHITECTURE
Tourism + Residential engineers drawings. Nominated Registered Architect: Peter Israel (reg no 5064)
ABN 90 050 071 022 SHADOW DIAGRAM This drawing is the copyright of PTI Architecture Pty Ltd and may not be altered, reproduced or transmitted in any form or by any means, in part or in whole without the written permission of PTI Architecture Pty Ltd. BY CHK DATE REV DESCRIPTION BY CHK DATE DESCRIPTION


PROJECT INFORMATION - DEVELOPMENT APPLICATION		
SITE AREA (LOT 04) 378.1 m ²	m/m²	COMPLIANCE
PERMISSABLE GFA	N/A	Υ
PROPOSED GFA	165.78m ²	
LOT WIDTH AT FRONT BUILDING LINE	17.6m	Y
LANDSCAPE		
required landscaping area (45% of site area)	170.1m ²	Υ
PROPOSED LANDSCAPING TOTAL AREA	188.83m ²	
PROPOSED COMPLIANT LANDSCAPE AREA	157.28m ²	
PROPOSED NON COMPLIANT LANDSCAPE AREA	31.55m ²	
PRIVATE OPEN SPACE		
REQUIRED PRIVATE OPEN SPACE	24m ²	Υ
PROPOSED PRIVATE OPEN SPACE	24.02m ²	
	· · · · · · · · · · · · · · · · · · ·	


PROPOSED SITE AREA PROPOSED GROSS FLOOR AREA PROPOSED ARTICULATON ZONE PROPOSED PRIVATE OPEN SPACE PROPOSED COMPLIANT LANDSCAPE AREA

PROPOSED AREA EXCLUDED

PROPOSED NON COMPLIANT LANDSCAPE AREA

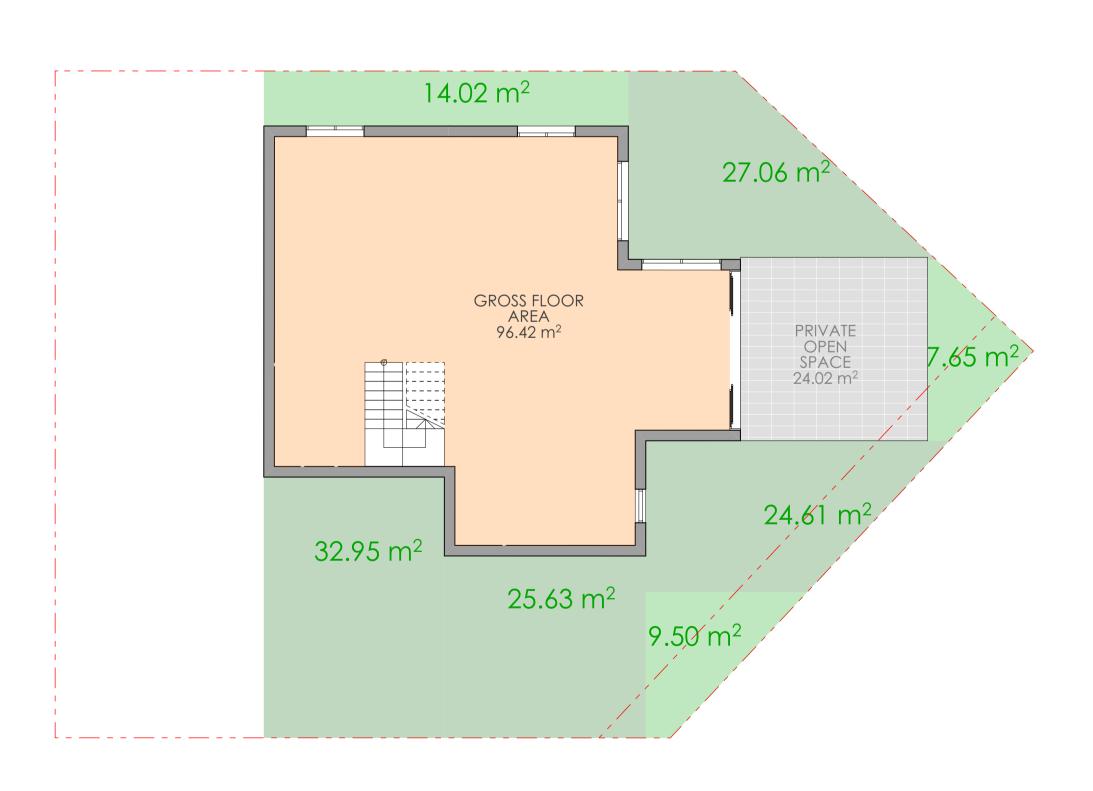

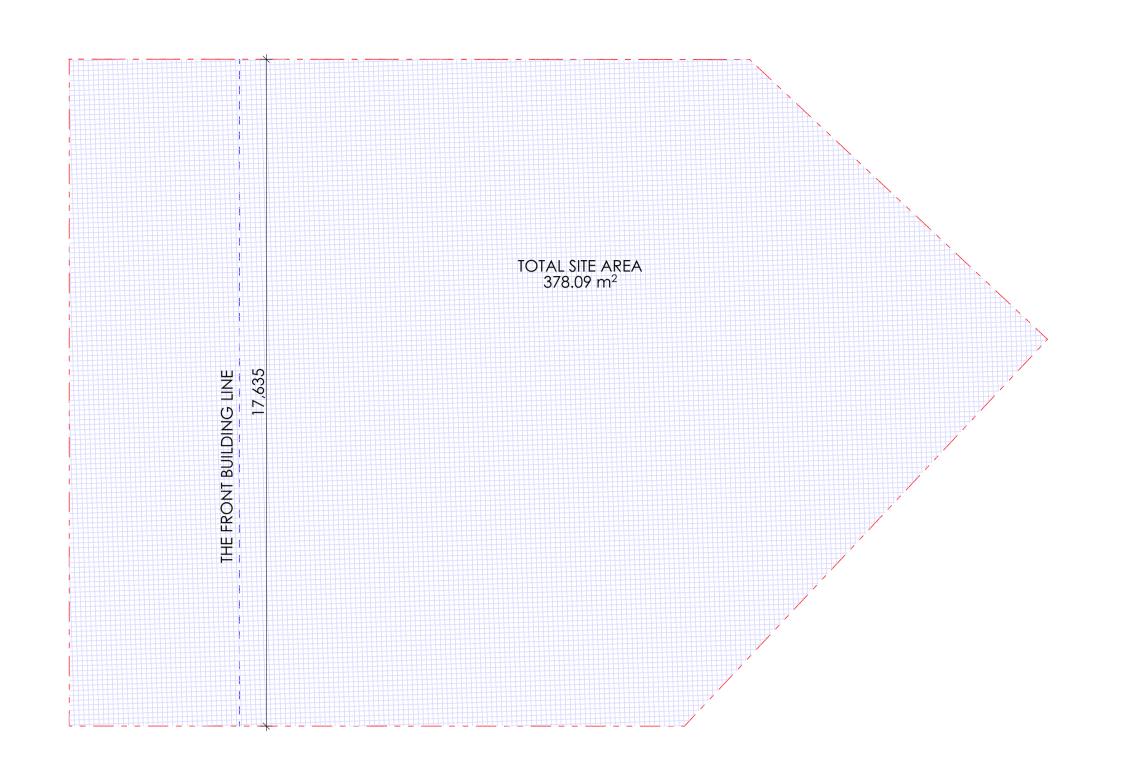

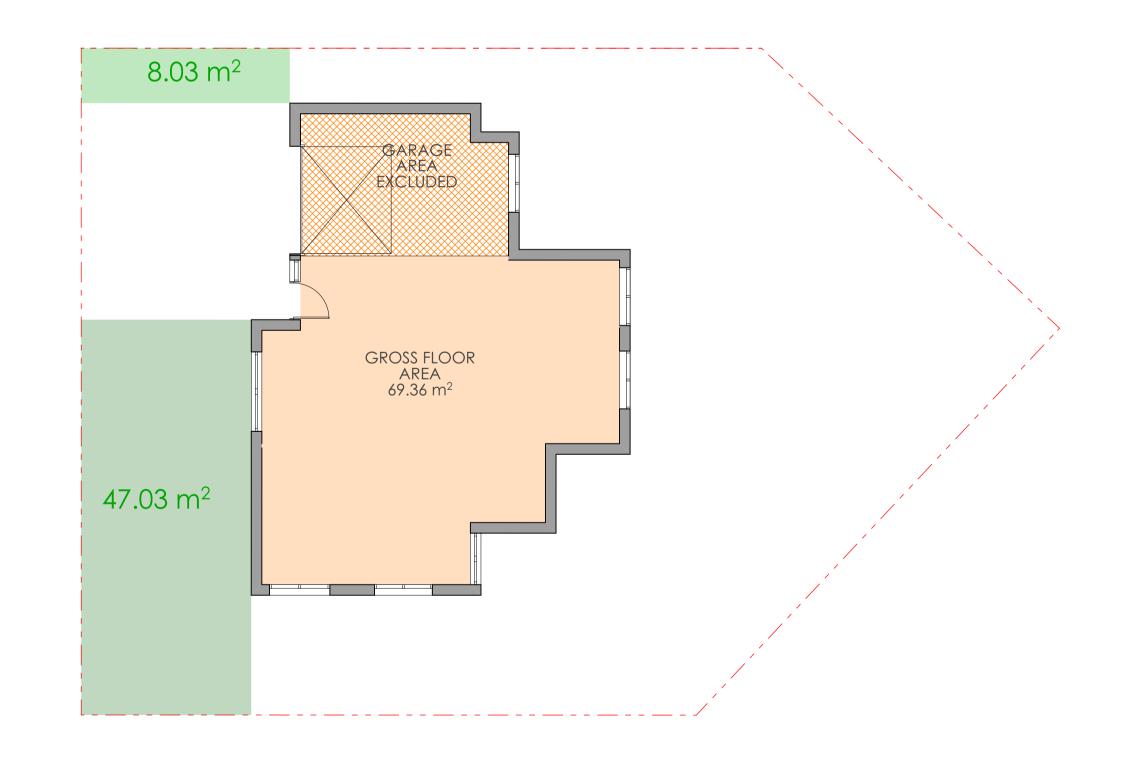

LOW GROUND FLOOR AREA PLAN 1:100

GROUND FLOOR AREA PLAN 1:100



ARCHITECTURE
Tourism + Residential

Main Office: Level 2, 68 Sophia Street, Surry Hills NSW 2010
Parramatta Office: Level 15, Deloitte Building, 60 Station Street, Parramatta NSW 2150
+ 61 2 9283 0860 | www.ptiarchitecture.com.au
Nominated Registered Architect: Peter Israel (reg no 5064)
ABN 90 050 071 022

NOTE
Contractors to verify all dimensions on site before any shop drawings work is commenced.
Figured dimensions to be taken in preference to scaled dwgs.
This drawing is to be read in conjunction with the specification and engineers drawings.

 NOTE Contractors to verify all dimensions on site before any shop drawings or work is commenced. Figured dimensions to be taken in preference to scaled dwgs. This drawing is to be read in conjunction with the specification and engineers drawings.
This drawing is the copyright of PTI Architecture Pty Ltd and may not be altered, reproduced or transmitted in any form or by any means, in part or in whole without the written permission of PTI Architecture Pty Ltd.

S 31	REV	DESCRIPTION	BY	СНК	DATE	REV	DESCRIPTION
oe art or							
b							
igs or						В	SURVEY ISSUE
						Α	DEVELOPMENT APPLICATION

DL KC/PI 08.11.21 CLIENT DL GF/PI 11.11.21 SKYCORP AUSTRALIA

BY CHK DATE

ROJECT	NOI
OT03,10 FERN CREEK ROAD,	
WARRIEWOOD	
RAWING	
AREA CALCULATION	

TH	DRA
	PRO

В	DA	600	В	
PROJECT No P56	3	SCALE 1:100@A1		
DL, K	С	PI / KC		
DRAWN		CHECKED		



BY CHK DATE



ARCHITECTURE
Tourism + Residential

Main Office: Level 2, 68 Sophia Street, Surry Hills NSW 2010
Parramatta Office: Level 15, Deloitte Building, 60 Station Street, Parramatta NSW 2150
+ 61 2 9283 0860 | www.ptiarchitecture.com.au
Nominated Registered Architect: Peter Israel free no 5001
ABN 90 050 071 000

Contractors to verify all dimensions on site before any shop drawings or work is commenced.

2. Figured dimensions to be taken in preference to scaled dwgs.
3. This drawing is to be read in conjunction with the specification and engineers drawings.

This drawing is the copyright of PTI Architecture Pty Ltd and may not be altered, reproduced or transmitted in any form or by any means, in part or in whole without the written permission of PTI Architecture Pty Ltd.

					Α	DEVELOPMENT APPLICATION
					В	SURVEY ISSUE
REV	DESCRIPTION	BY	CHK	DATE	REV	DESCRIPTION

DL	KC/PI	08.11.21	CLIENT
DL	GF/PI	11.11.21	SKYCORP AUSTRALIA


PROJECT
LOT03,10 FERN CREEK ROAD,
WARRIEWOOD
DRAWING
EXTERNAL FINISH SCHEDULE


	В	DA
	PROJECT No P563	
	DL, KC	
NORTH	DRAWN	

CHECKED

PI / KC


1:100, 1:500@A1

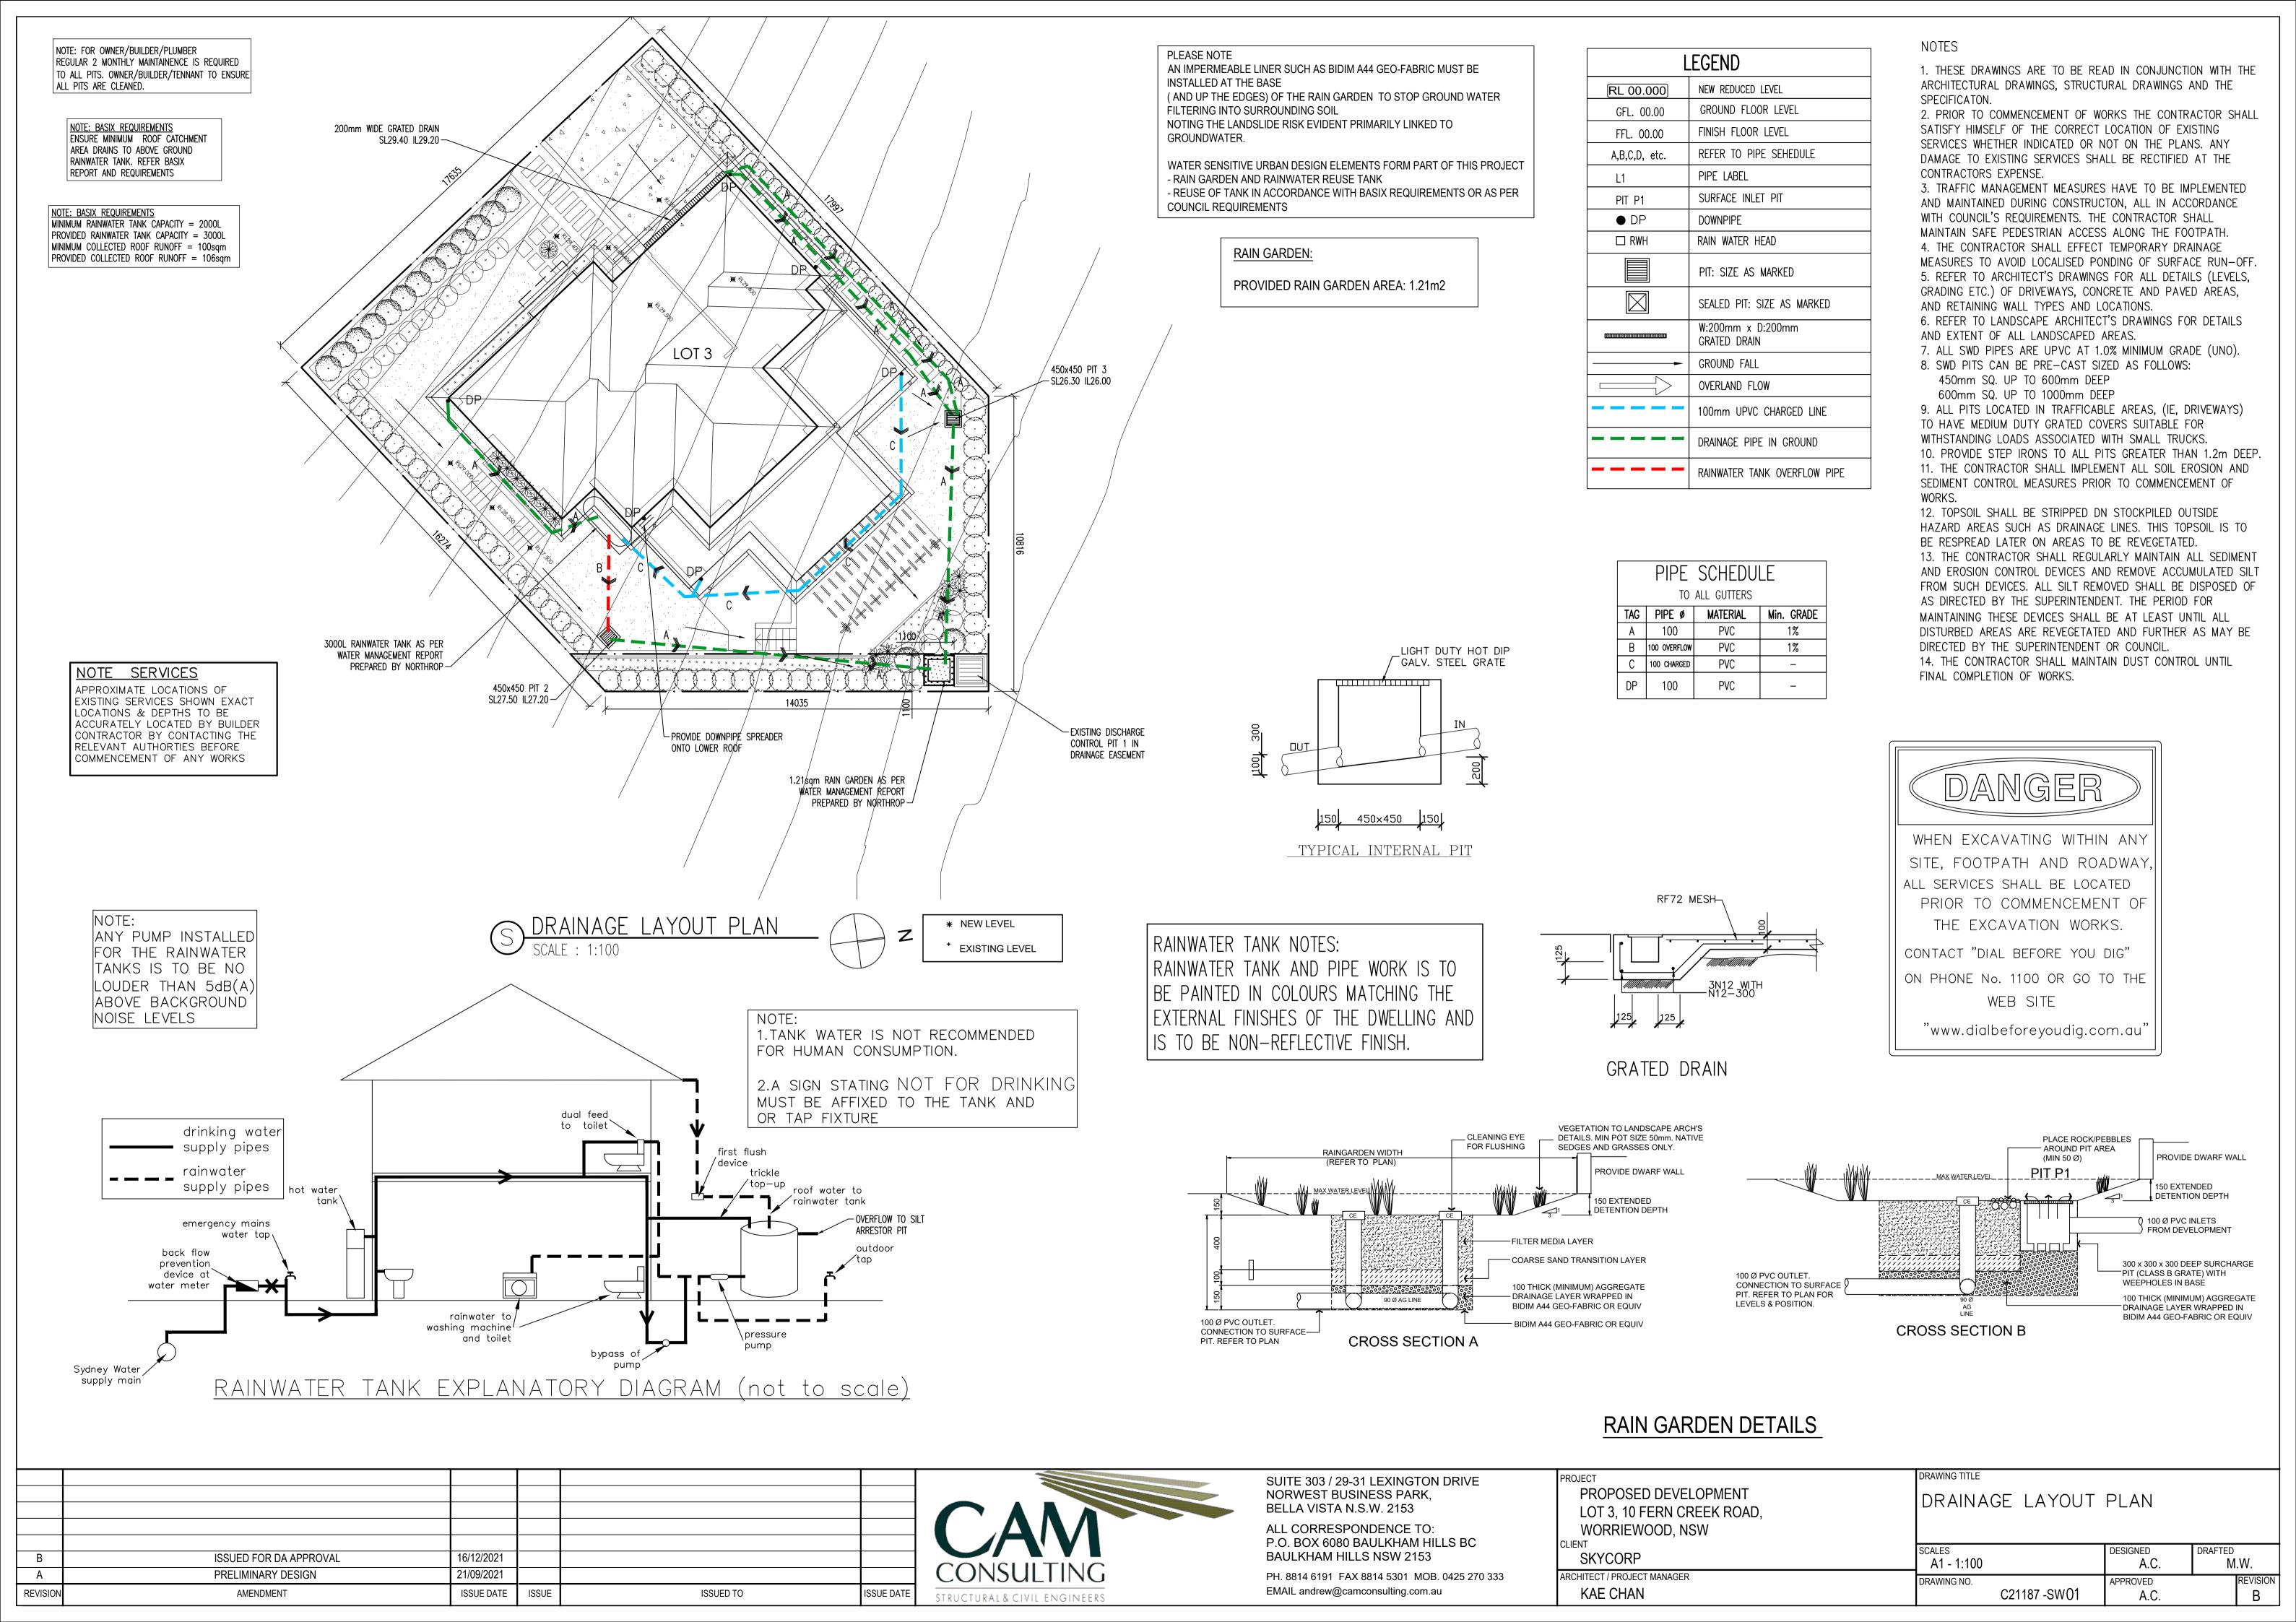


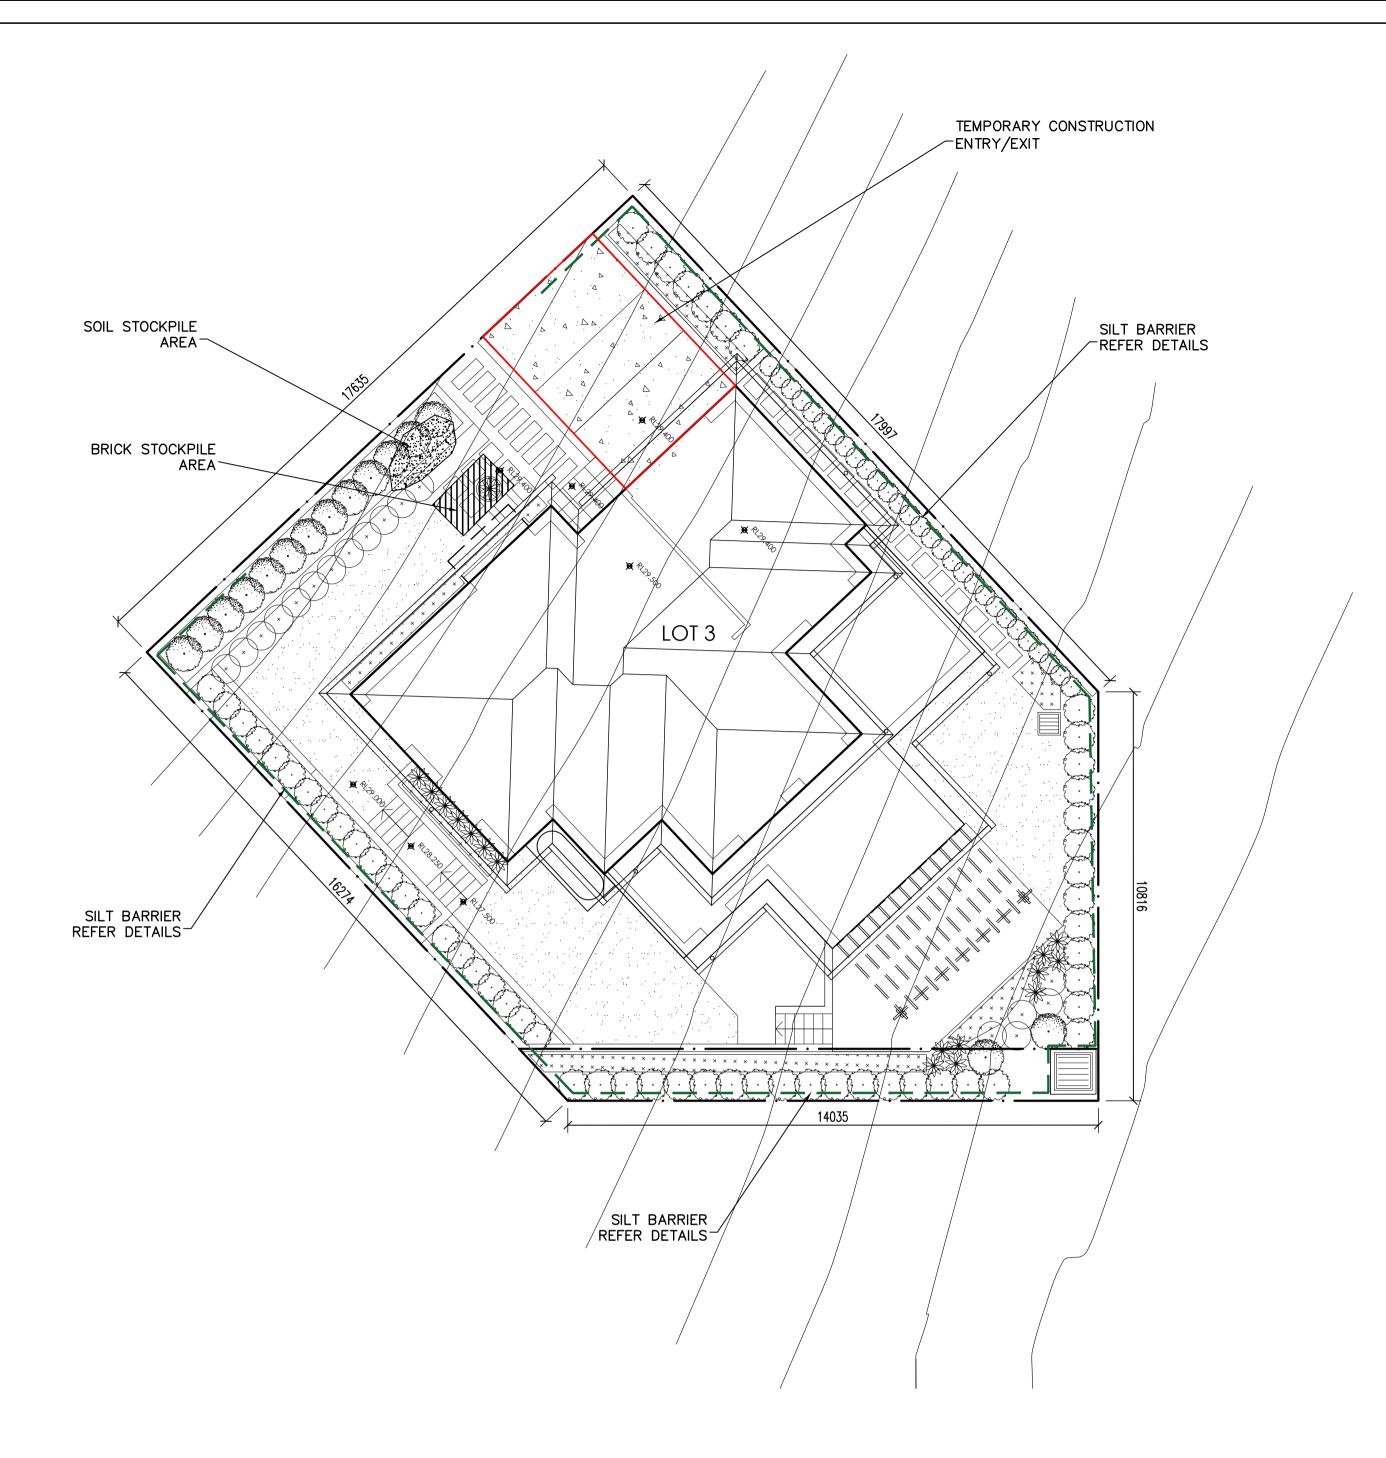







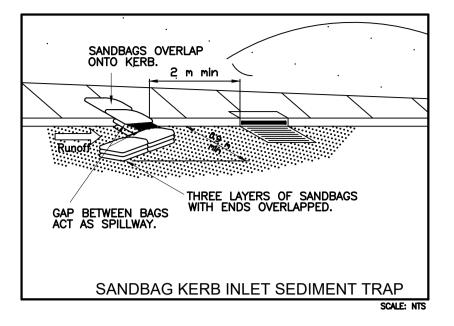

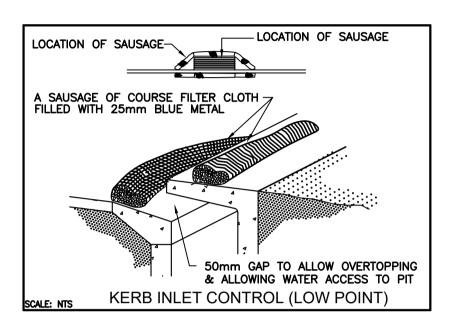

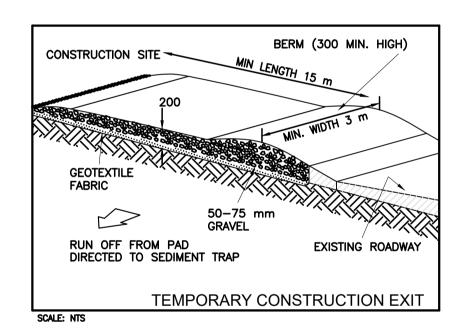

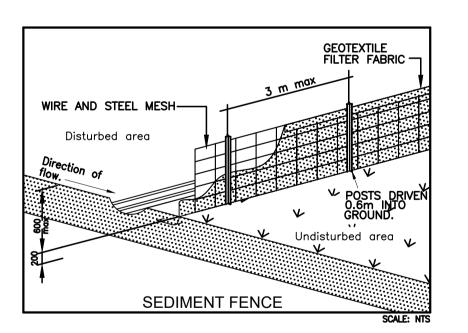

SOIL EROSION CONTROL INSTRUCTIONS


- EARTH BATTERS WILL BE CONSTRUCTED WITH AS LOW AS A GRADIENT AS PRACTICABLE BUT NO STEEPER, UNLESS OTHERWISE NTOED, THAN:

 -2(H):1(V) WHERE SLOPE LENGTH LESS THAN 12 METRES
 -2.5(H):1(V) WHERE SLOPE LENGTH BETWEEN 12 & 16 METRES
 -3(H):1(V) WHERE SLOPE LENGTH BETWEEN 16 & 20 METRES
 -4(H):1(V) WHERE SLOPE LENGTH GREATER THAN 20 METRES
- ALL WATERWAYS, DRAINS, SPILLWAYS AND THEIR OUTLETS WILL BE CONSTRUCTED TO BE STABLE IN AT LEAST THE 1:20 YEAR ARI, TIME OF CONCENTRATION STORM EVENT.
- WATERWAYS AND OTHER AREAS SUBJECT TO CONCENTRATED FLOWS AFTER CONSTRUCTION ARE TO HAVE A MAXIMUM GROUNDCOVER C-FACTOR OF 0.05 (70% GROUND COVER) WITHIN 10 WORKING DAYS FROM COMPLETION OFFORMATION. FLOW VELOCITIES ARE TO BE LIMITED TO THOSE SHOWN INTABLE 5-1 OF "MANAGING URBAN STORMWATER SOILS AND CONSTRUCTION DEPT OF HOUSING 1998 (BLUE BOOK). FOOT
- AND VEHICULAR TRAFFIC WILL BE PROHIBITED IN THÉSE AREAS.

 STOCKPILES AFTER CONSTRUCTION ARE TO HAVE A MAXIMUM GROUND COVER C-FATOR OF 0.1 (60% GROUND COVER) WITHIN 10 WORKING DAYS FROM COMPLETION OF FORMATION.
- ALL LANDS, INCLUDING WATERWAYS AND STOCKPILES, DURING CONSTRUCTION ARE TO HAVE A MAXIMUM GROUND COVER C—FACTOR OF 0.15 (50% GROUND COVER) WITHIN 20 WORKING DAYS FROM INACTIVITY EVEN THOUGH WORKS MAY CONTINUE LATER.
- FOR AREAS OF SHEET FLOW USE THE FOLLOWING GROUND COVER PLANT SPECIES FOR TEMPORARY COVER: JAPANESE MILLET 20KG/HA AND OATS.
- PERMANENT REHABILITATION OF LANDS AFTER CONSTRUCTION WILL ACHIEVE A GROUND COVER C-FACTOR OF LESS THAN 0.1 AND LESS THAN 0.05 WITHIN 60 DAYS. NEWLY PLANTED LANDS WILL BE WATERED REGULARLY UNTIL AN EFFECTIVE COVER IS ESTABLISHED AND PLANTS ARE GROWING VIGOROUSLY FOLLOW-UP SEED AND FERTILISER WILL BE APPLIED AS 20KG/HA
- REVEGATATION SHOULD BE AIMED AT RE-ESTABLISHING
 NATURAL SPECIES. NATURAL SURFACE SOILS SHOULD BE
 REPLACED AND NON-PERSISTANT ANNUAL COVER SROPS
 SHOULS BE USED.

DUST CONTROL INSTRUCTIONS

- ALL STOCKPILED MATERIAL OR SEDIMENT COLLECTION TO BE SPRAYED BY LIGHTLY WIDE ANGLED WATER
- THIS TEMPORARY MECHANICAL METHOD CONFINES AND SETTLES
 THE DUST FROM THE AIR BY DUST AND WATER PARTICLE
 ADHESION. WATER IS SPRAYED THROUGH NOZZELS OVER THE
 PROBLEM AREA.

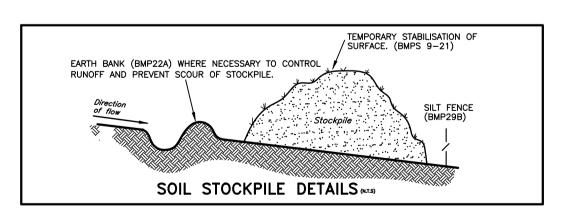

В	ISSUED FOR DA APPROVAL	16/12/2021			
Α	PRELIMINARY DESIGN	21/09/2021			
REVISION	AMENDMENT	ISSUE DATE	ISSUE	ISSUED TO	ISSUE DATE



SUITE 303 / 29-31 LEXINGTON DRIVE NORWEST BUSINESS PARK, BELLA VISTA N.S.W. 2153 ALL CORRESPONDENCE TO:

ALL CORRESPONDENCE TO: P.O. BOX 6080 BAULKHAM HILLS BC BAULKHAM HILLS NSW 2153

PH. 8814 6191 FAX 8814 5301 MOB. 0425 270 333 EMAIL andrew@camconsulting.com.au

PROJECT
PROPOSED DEVELOPMENT
LOT 3, 10 FERN CREEK ROAD,
WORRIEWOOD, NSW
CLIENT

KAE CHAN

SOIL MANAGEMENT PLAN

CLIENT
SKYCORP
SCALES
A1 - 1:100

ARCHITECT / PROJECT MANAGER

DESIGNED A.C. DRAFTED M.W.

WING NO. C21187 -SW02 A.C. B