VIEW FROM FISHERMANS BEACH UPDATED WITH NE PROPOSAL. DRAWING REGISTER UPDATED.



PHOTOMONTAGE - PROPOSED FRONT ELEVATION / STREETSCAPE



PHOTOMONTAGE - PROPOSED VIEW FROM STANLEY AND FLORENCE TWIGHT RESERVE

VIRGINIA KERRIDGE ARCHITECT

g 03 / 59 great buckingham street redfern nsw 2016 ph 02 9699 3487 ph 02 9699 8527 fax 02 9699 4626 in fo @ v k .c om .au w w w . v k .c om .au abn 12 083 17 159 THIS IS FOR THE PURPOSE OF DEVELOPMENT APPLICATION TO COUNCIL ONLY

REFER TO WRITTEN DIMENSIONS ONLY, DO NOT SCALE FROM DRAWINGS.
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REFER TO ALL CONSULTANTS DRAWINGS AND SPECIFICATIONS FOR ALL SPECIALIST INFORMATION AND DETAILS.
REFER TO SURVEY DRAWING FOR ALL EXISTING GROUND LEVELS.

amendments:

REV DESCRIPTION

A DA ISSUE

12/12/2019

03/07/2020

PHOTOMONTAGE - PROPOSED VIEW FROM FISHERMANS BEACH

C DA ISSUE - AMENDMENT C

41 & 43 BEACH ROAD COLLAROY 03/07/2020 LO1 1 DP300846 AND LOT 2 SEC 7 DP7391 SCALE: DRAWING NO. DRAWING TITLE N/A **DA 000** COVER + PHOTOMONTAGES


DEVELOPMENT APPLICATION SUBMISSION FOR: 41 & 43 BEACH ROAD, COLLAROY, 2097 LOT 1 DP300846 & LOT 2 SEC 7 DP7391


SCALE REVISION


DDAWING DEGISTED	

DWG NO. DRAWING

DWG NO.	DIAWING	SOALL	IKEVISIOI
DA 000	COVER + PHOTOMONTAGES	N/A	С
DA E 100	EXISTING SITE & ROOF PLAN	1:100	А
DA E 110	SITE ANALYSIS PLAN	1:100	А
DA E 120	LOT AMALGAMATION PLAN	1:250	А
DA E 130	DEMOLITION AND WASTE MANAGEMENT PLAN	1:100	А
DA E 140	EXCAVATION & FILL PLAN	1:100	С
DA E 200	EXISTING ELEVATIONS	1:200	А
DA 100	PROPOSED SITE & ROOF PLAN	1:100	А
DA 105	ANALYSIS AGAINST DCP-B1 "WALL HEIGHT CONTROL"	1:100	С
DA 106	ANALYSIS AGAINST DCP-B1 - SE AREA DETAIL	1:100	С
DA 107	ANALYSIS AGAINST DCP-B1 & DCP-B3 - SECTIONS	1:50	С
DA 108	ANALYSIS AGAINST DCP-B1 & DCP-B3 - SECTIONS	1:50	С
DA 110	PROPOSED BASEMENT PLAN	1:100	В
DA 120	PROPOSED GROUND FLOOR PLAN	1:100	В
DA 130	PROPOSED FIRST FLOOR PLAN	1:100	С
DA 150	PROPOSED GFA & FSR CALCULATIONS	1:200	С
DA 160	DESIGN AMENDMENTS - FIRST FLOOR PLAN	1:100	В
DA 200	PROPOSED NORTH & EAST ELEVATIONS	1:100	С
DA 210	PROPOSED SOUTH & WEST ELEVATIONS	1:100	С
DA 300	PROPOSED SECTIONS A-A' & B-B'	1:100	С
DA 310	PROPOSED SECTIONS C-C' & D-D'	1:100	С
DA 320	PROPOSED SECTION E-E' & F-F'	1:100	С
DA 330	PROPOSED SECTION H-H' & DESIGN AMENDMENTS	1:100	С
DA 400	PROPOSED MATERIALS & FINISHES SCHEDULE	1:200	С
DA 500	SHADOWS 9AM 21ST JUNE	1:200	В
DA 501	SHADOWS 12PM 21ST JUNE	1:200	В
DA 502	SHADOWS 3PM 21ST JUNE	1:50	В
DA 520	EX.ELEVATION SHADOWS 29 BEACH RD. NORTH FACADE	1:50	В
DA 521	PR.ELEVATION SHADOWS 29 BEACH RD. NORTH FACADE	1:50	В
DA 522	PR.ELEVATION SHADOWS 35 BEACH RD. EAST FACADE	1:50	А
DA 523	PRIVATE OPEN SPACE: 29 BEACH ROAD 01/02	1/200	А
DA 524	PRIVATE OPEN SPACE: 29 BEACH ROAD 02/02	1/200	А
DA 600	SWIMMING POOL PLANS	1/20	А
DA 800	EXISTING VIEW LOSS ANALYSIS	1/200	А
DA 810	PROPOSED VIEW LOSS ANALYSIS	1/200	А
DA 820	EX. & PR. VIEW LOSS ANALYSIS: 35 BEACH ROAD	1/200	А
DA 825	PR. VIEW LOSS ANALYSIS: 29 BEACH ROAD	N/A	С
NP 01	NOTIFICATION PLAN: SITE PLAN	1/200	А
NP 02	NOTIFICATION PLAN: ELEVATIONS	1/200	А

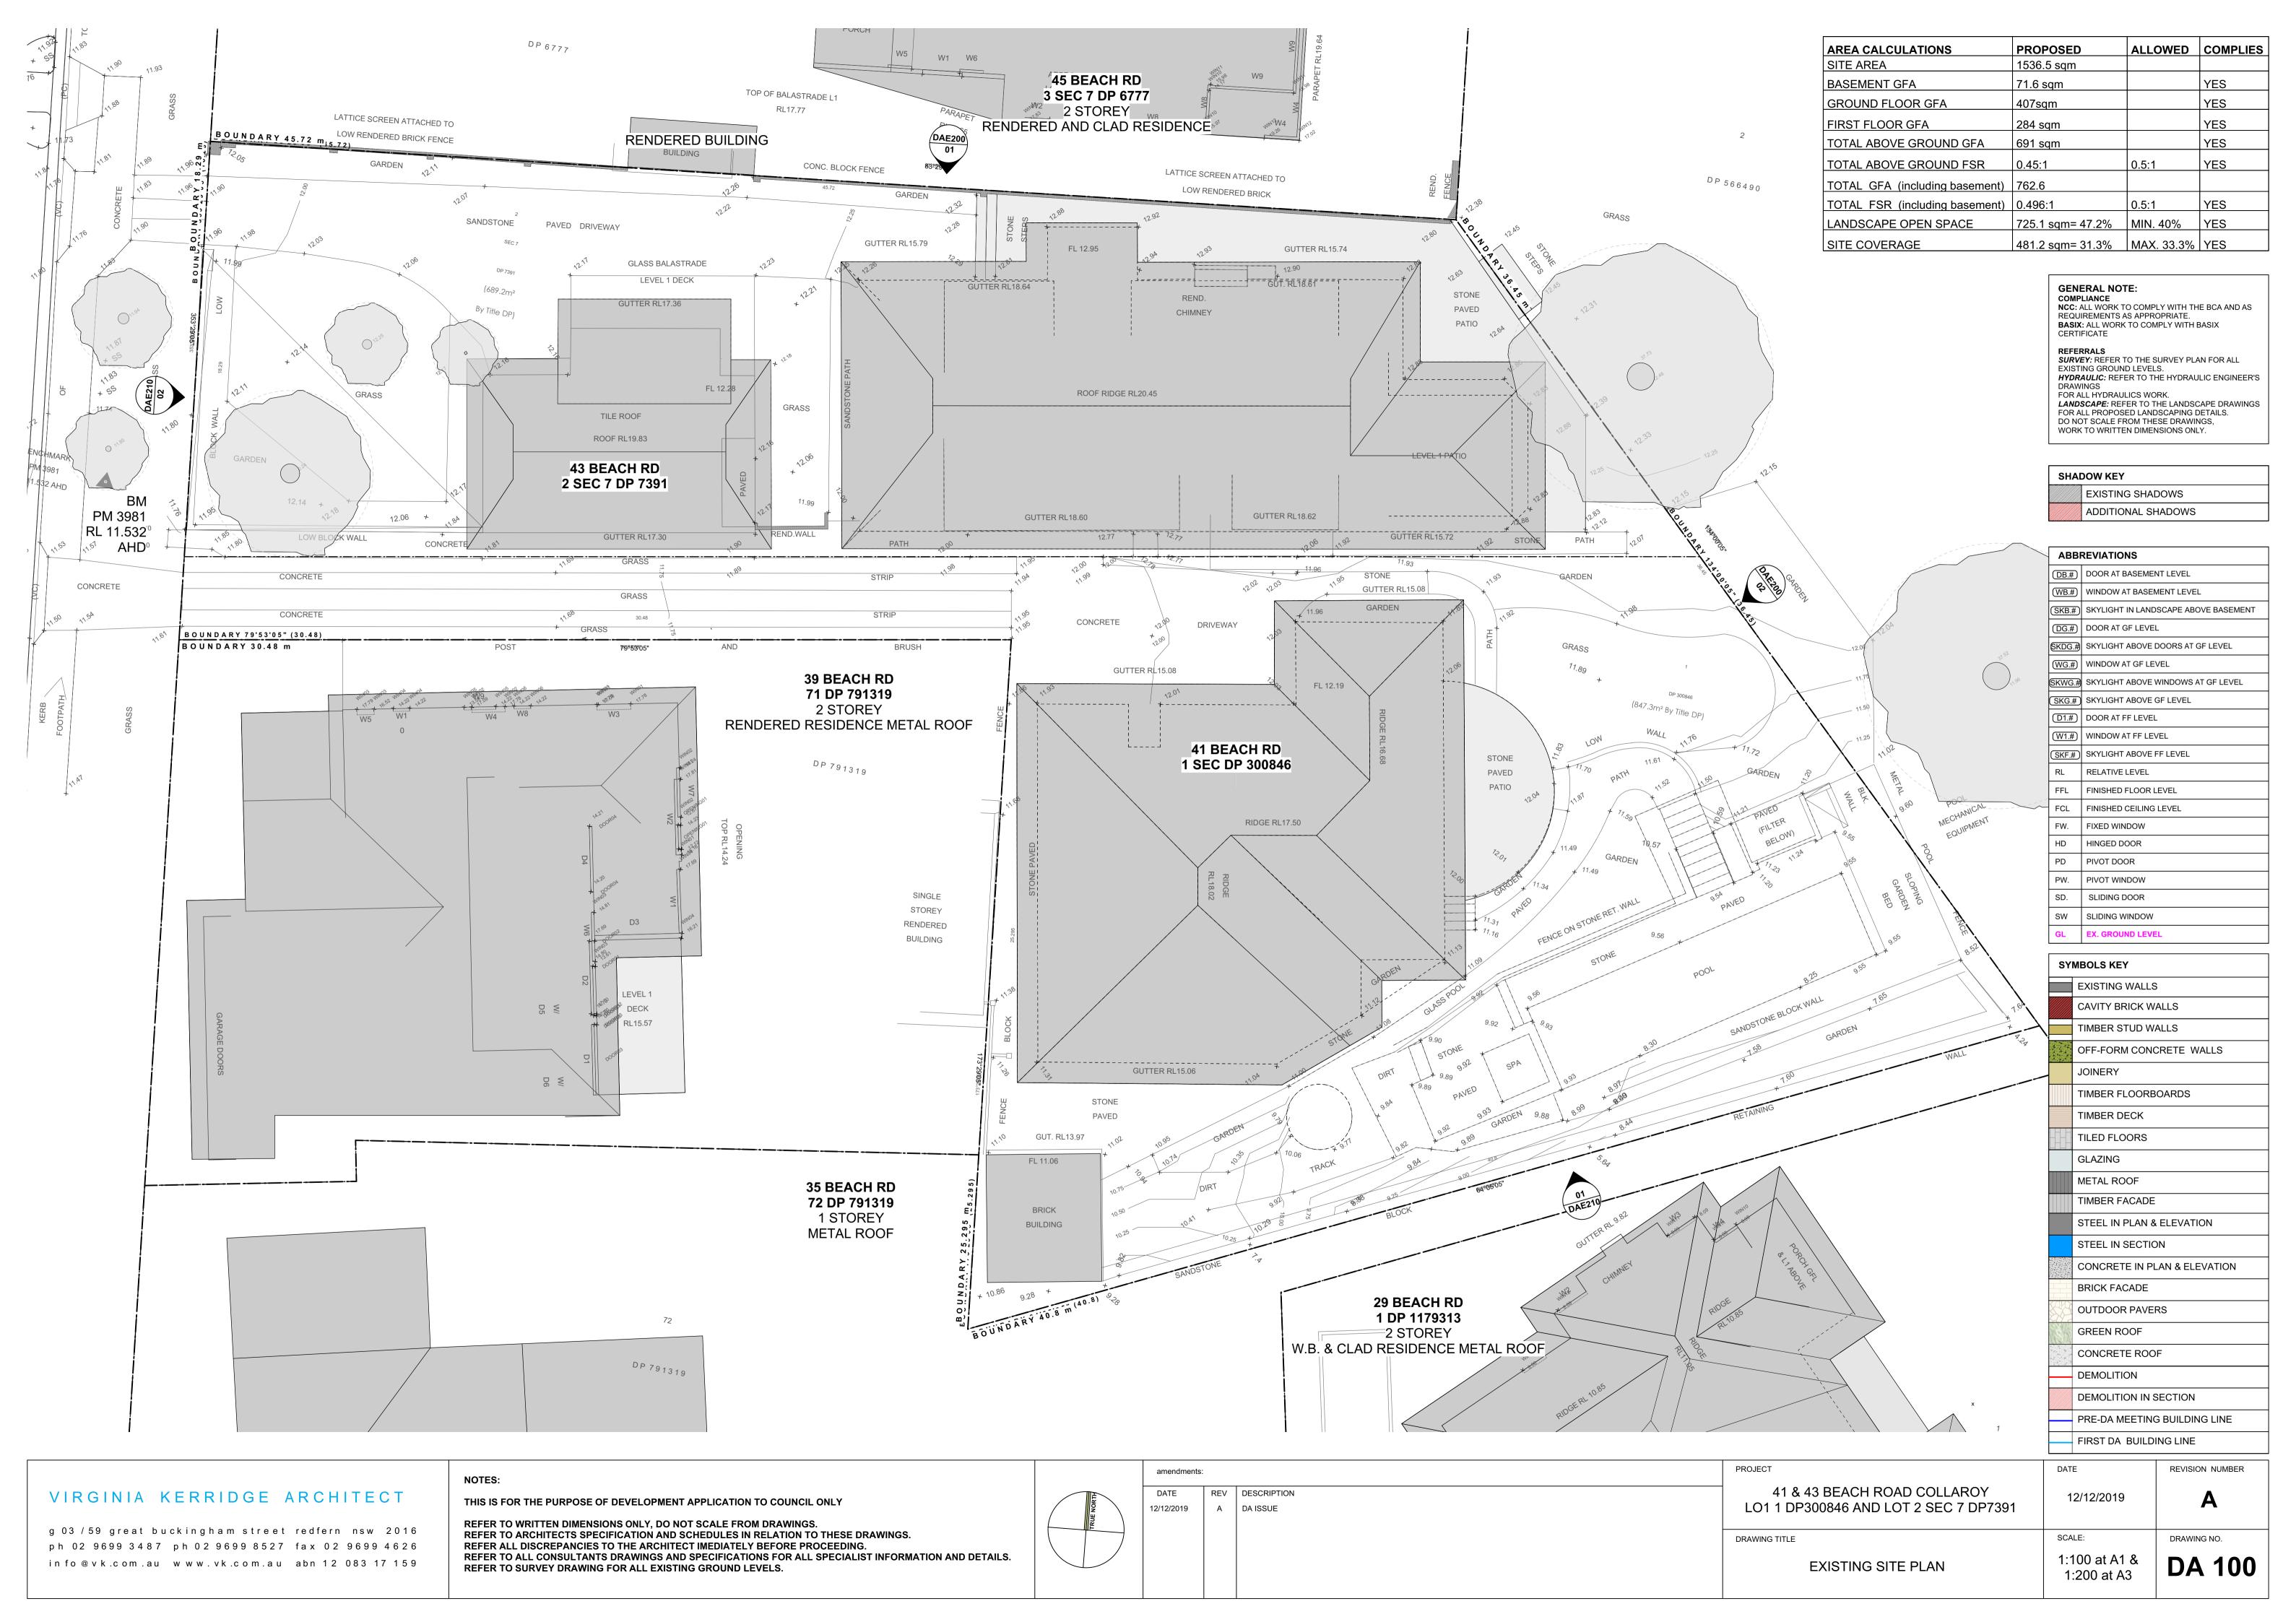

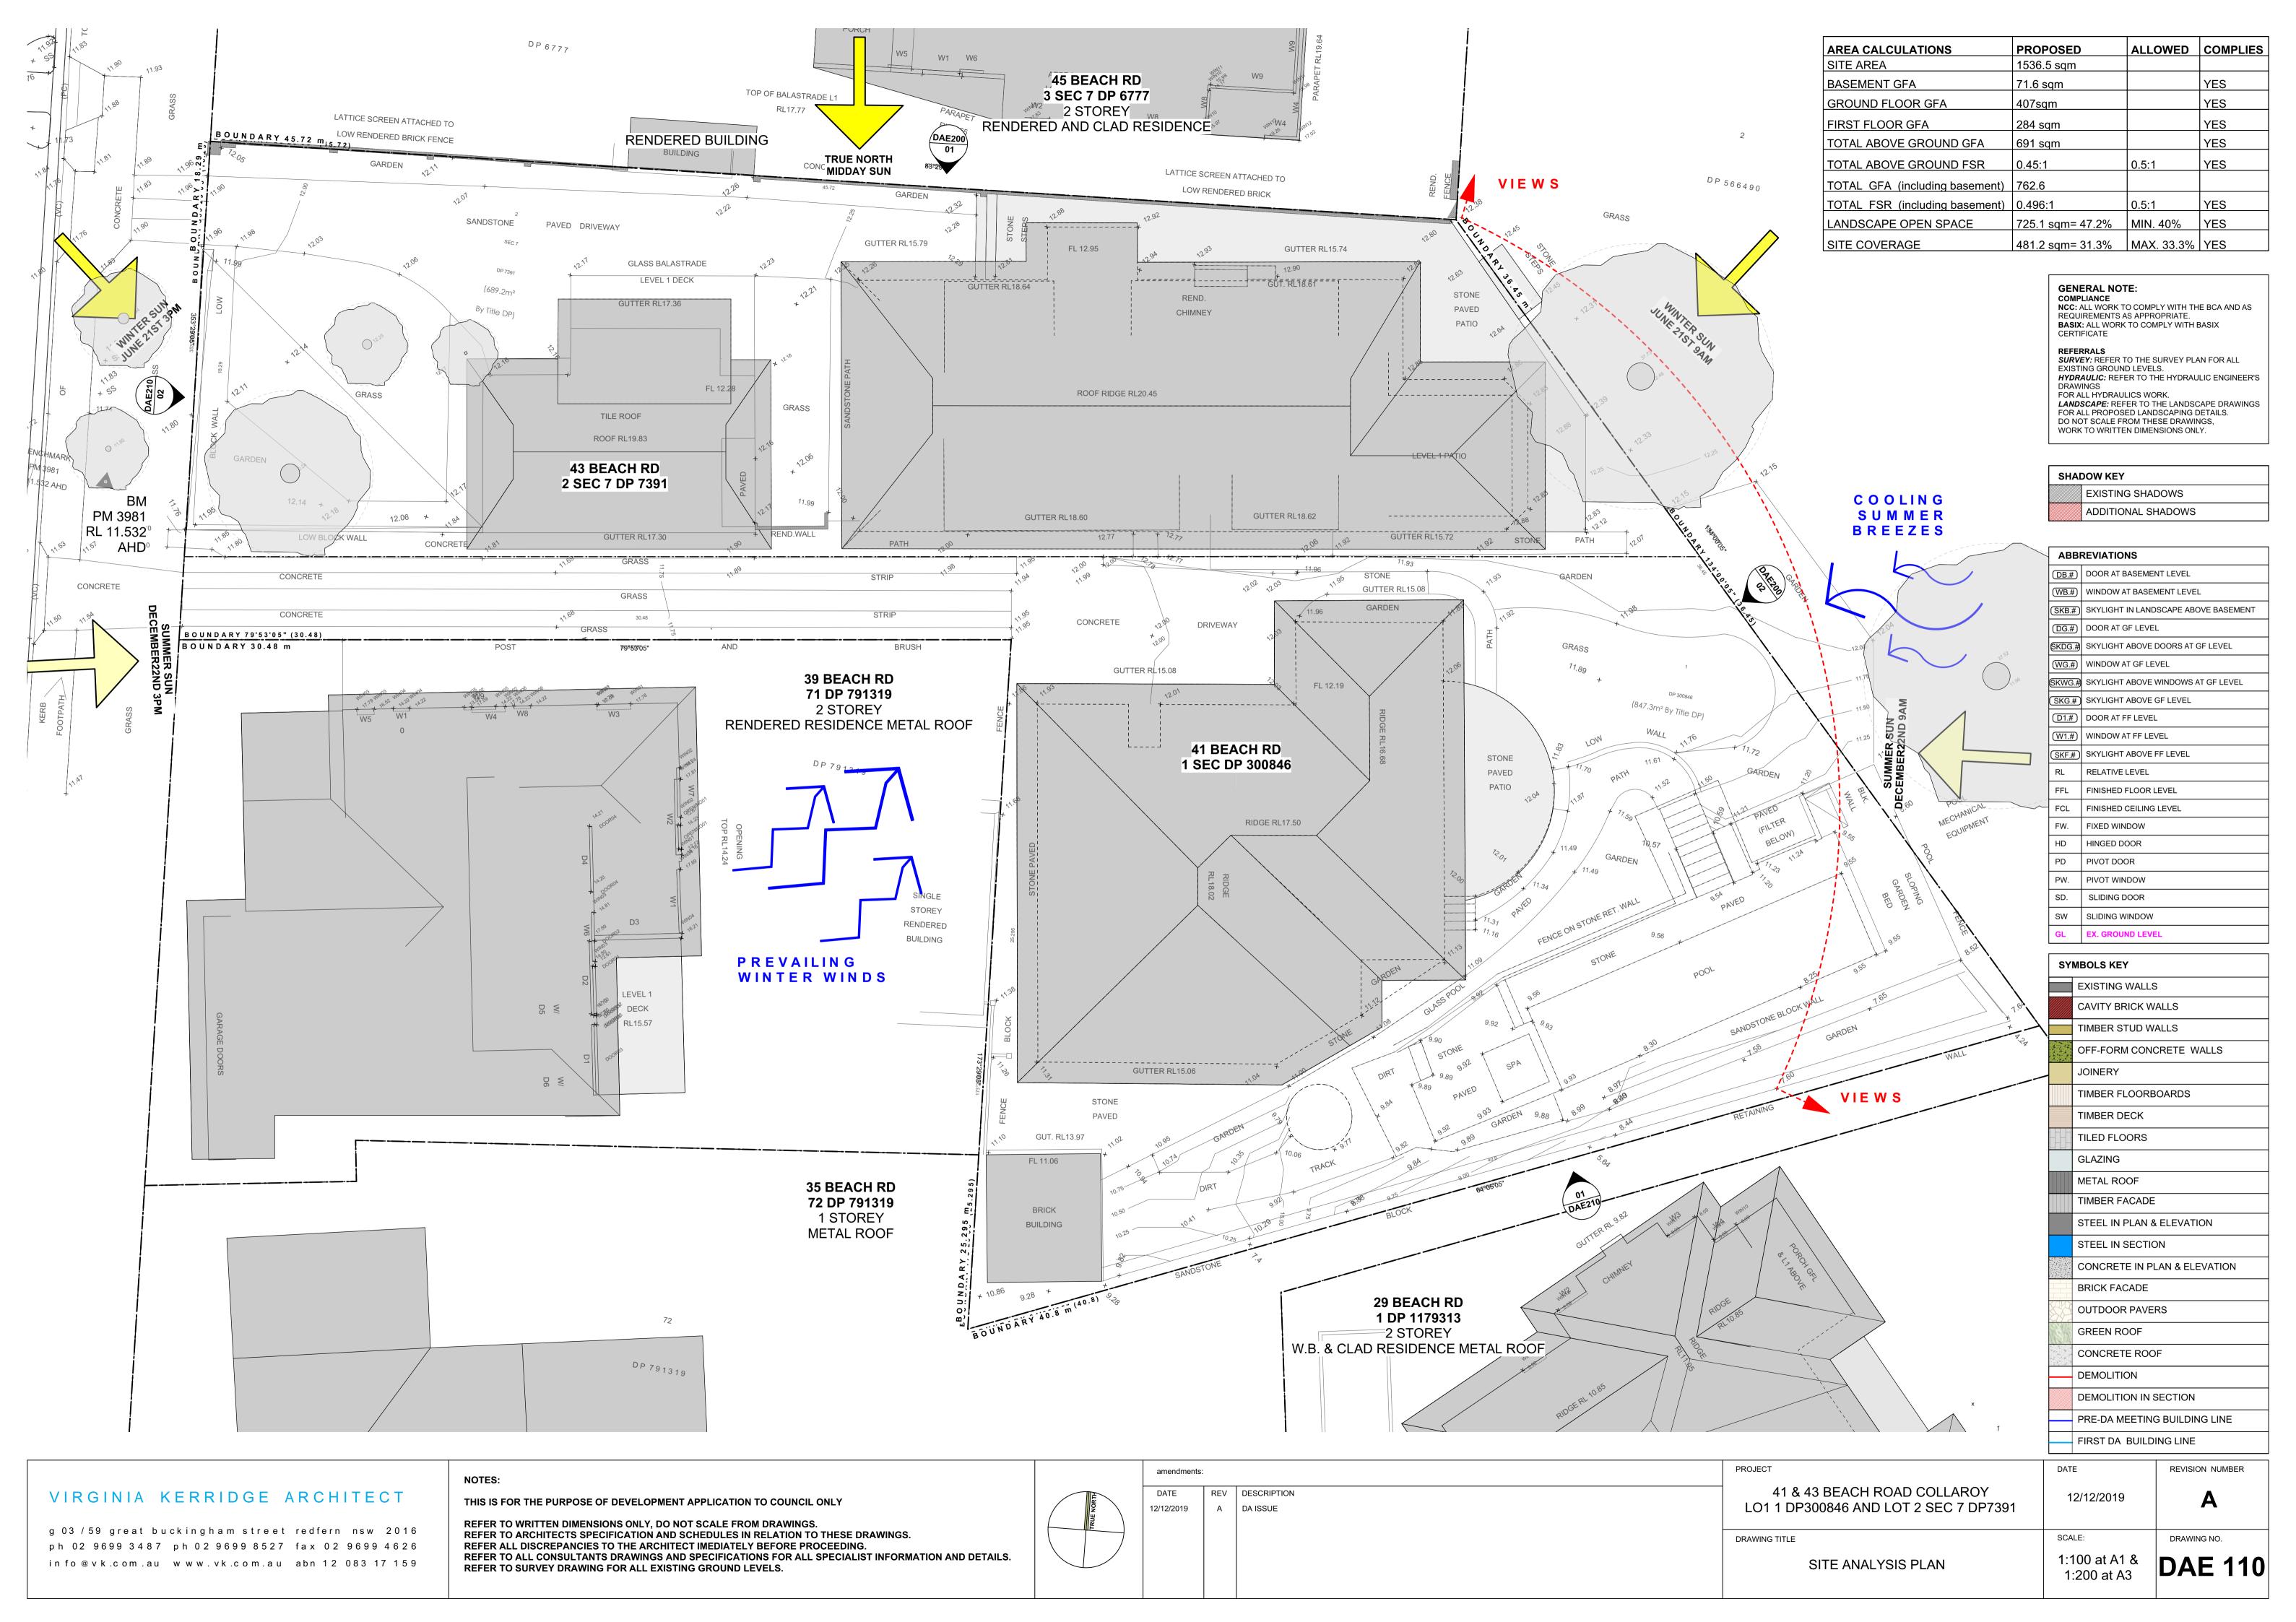

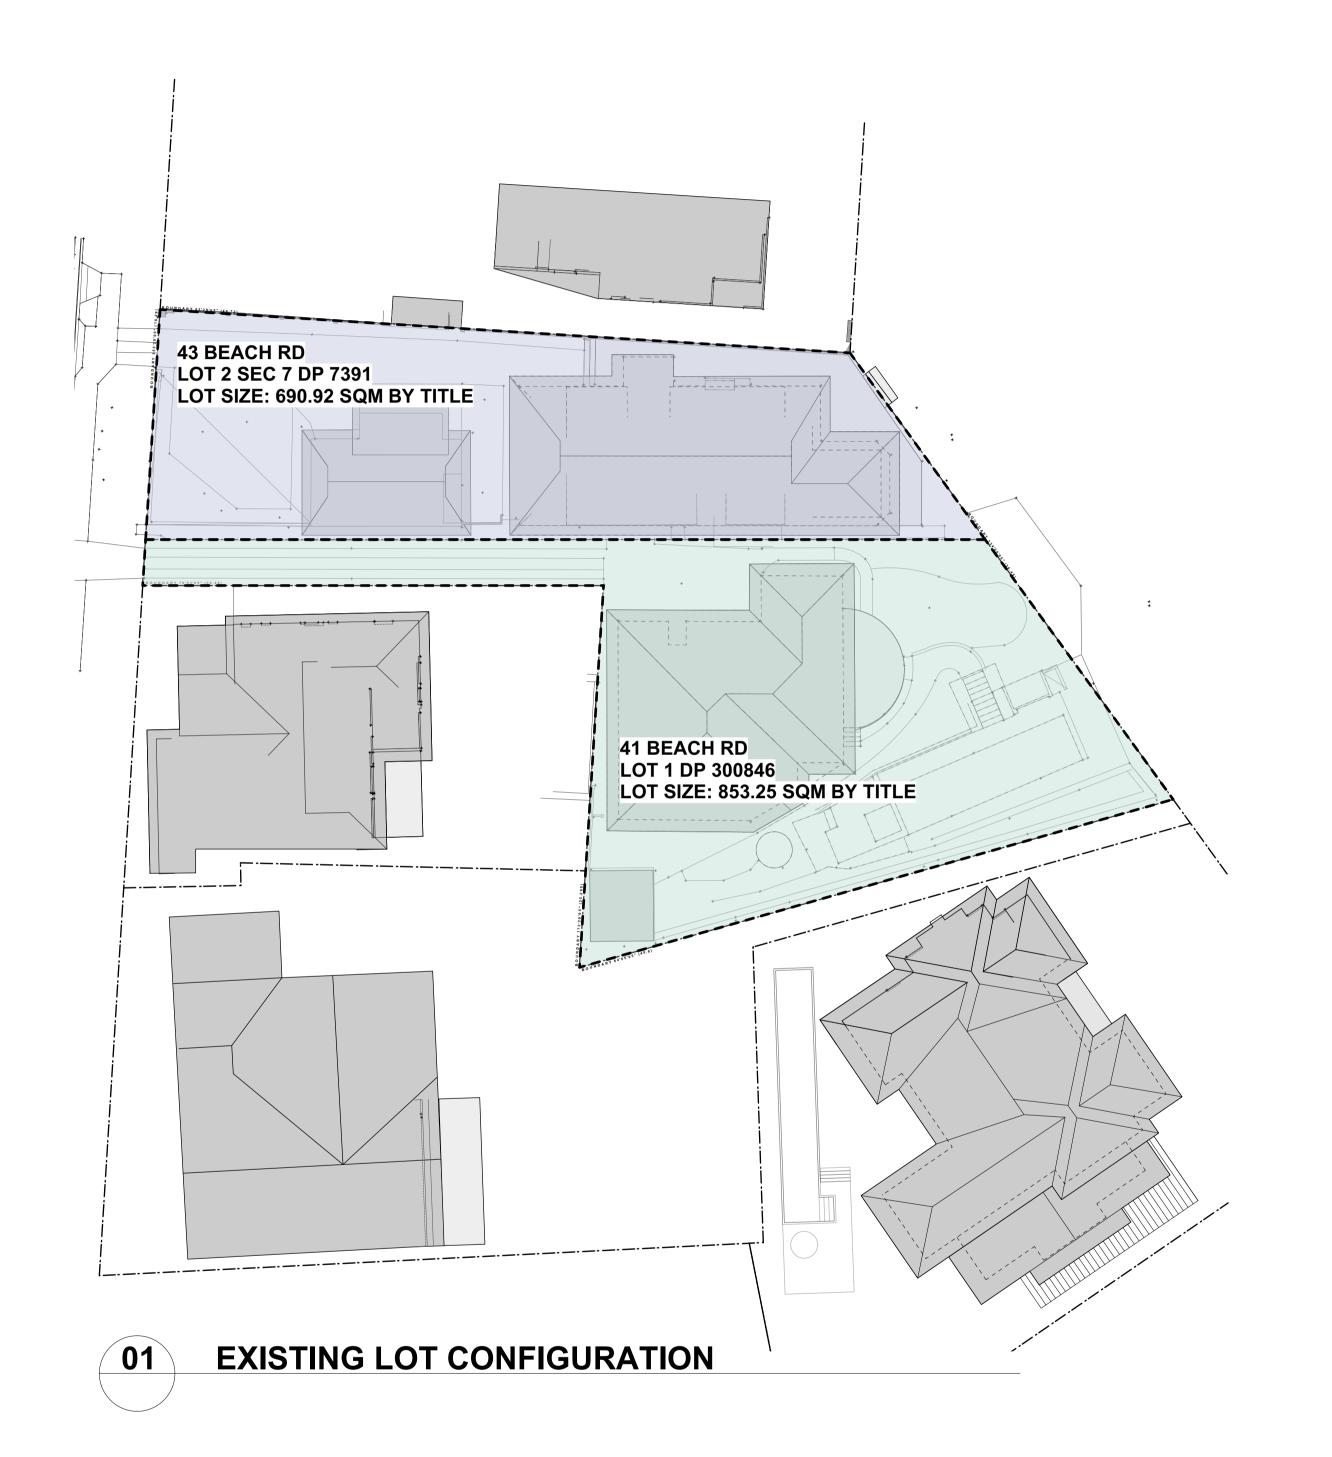



AREA CALCULATIONS	PROPOSED	ALLOWED	COMPLIES
SITE AREA	1536.5 sqm		
BASEMENT GFA	71.6 sqm		YES
GROUND FLOOR GFA	407sqm		YES
FIRST FLOOR GFA	284 sqm		YES
TOTAL ABOVE GROUND GFA	691 sqm		YES
TOTAL ABOVE GROUND FSR	0.45:1	0.5:1	YES
TOTAL GFA (including basement)	762.6		
TOTAL FSR (including basement)	0.496:1	0.5:1	YES
LANDSCAPE OPEN SPACE	725.1 sqm= 47.2%	MIN. 40%	YES
SITE COVERAGE	481.2 sqm= 31.3%	MAX. 33.3%	YES

GENERAL NOTE:

COMPLIANCE
NCC: ALL WORK TO COMPLY WITH THE BCA AND AS
REQUIREMENTS AS APPROPRIATE.
BASIX: ALL WORK TO COMPLY WITH BASIX

REFERRALS
SURVEY: REFER TO THE SURVEY PLAN FOR ALL
EXISTING GROUND LEVELS.
HYDRAULIC: REFER TO THE HYDRAULIC ENGINEER'S
DRAWINGS
FOR ALL HYDRAULICS WORK.
LANDSCAPE: REFER TO THE LANDSCAPE DRAWINGS
FOR ALL PROPOSED LANDSCAPING DETAILS.
DO NOT SCALE FROM THESE DRAWINGS,
WORK TO WRITTEN DIMENSIONS ONLY.

SHADOW KEY	
	EXISTING SHADOWS
	ADDITIONAL SHADOWS

ABBF	REVIATIONS
DB.#	DOOR AT BASEMENT LEVEL
(WB.#)	WINDOW AT BASEMENT LEVEL
(SKB.#)	SKYLIGHT IN LANDSCAPE ABOVE BASEMENT
DG.#	DOOR AT GF LEVEL
(SKDG.#)	SKYLIGHT ABOVE DOORS AT GF LEVEL
(WG.#)	WINDOW AT GF LEVEL
SKWG.#)	SKYLIGHT ABOVE WINDOWS AT GF LEVEL
SKG.#	SKYLIGHT ABOVE GF LEVEL
D1.#	DOOR AT FF LEVEL
(W1.#)	WINDOW AT FF LEVEL
SKF.#	SKYLIGHT ABOVE FF LEVEL
RL	RELATIVE LEVEL
FFL	FINISHED FLOOR LEVEL
FCL	FINISHED CEILING LEVEL
FW.	FIXED WINDOW
HD	HINGED DOOR
PD	PIVOT DOOR
PW.	PIVOT WINDOW
SD.	SLIDING DOOR
sw	SLIDING WINDOW
GL	EX. GROUND LEVEL

SY	MBOLS KEY
	EXISTING WALLS
	CAVITY BRICK WALLS
	TIMBER STUD WALLS
	OFF-FORM CONCRETE WALLS
	JOINERY
	TIMBER FLOORBOARDS
	TIMBER DECK
	TILED FLOORS
	GLAZING
	METAL ROOF
	TIMBER FACADE
	STEEL IN PLAN & ELEVATION
	STEEL IN SECTION
	CONCRETE IN PLAN & ELEVATION
	BRICK FACADE
	OUTDOOR PAVERS
160	GREEN ROOF


VIRGINIA KERRIDGE ARCHITECT

g 03 / 59 great buckingham street redfern nsw 2016 ph 02 9699 3487 ph 02 9699 8527 fax 02 9699 4626 in fo @ v k .c om .au w w w . v k .c om .au abn 12 083 17 159

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amenoments.		
DATE	REV	DESCRIPTION
12/12/2019	Α	DA ISSUE

41 & 43 BEACH ROAD COLLAROY LO1 1 DP300846 AND LOT 2 SEC 7 DP7391 SCALE: DRAWING TITLE PROPOSED LOT AMALGAMATION PLAN 1:250 at A1 & 1:500 at A3

FIRST DA BUILDING LINE REVISION NUMBER 12/12/2019

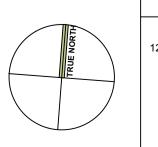
CONCRETE ROOF


DEMOLITION IN SECTION


PRE-DA MEETING BUILDING LINE

DEMOLITION

DAE 120

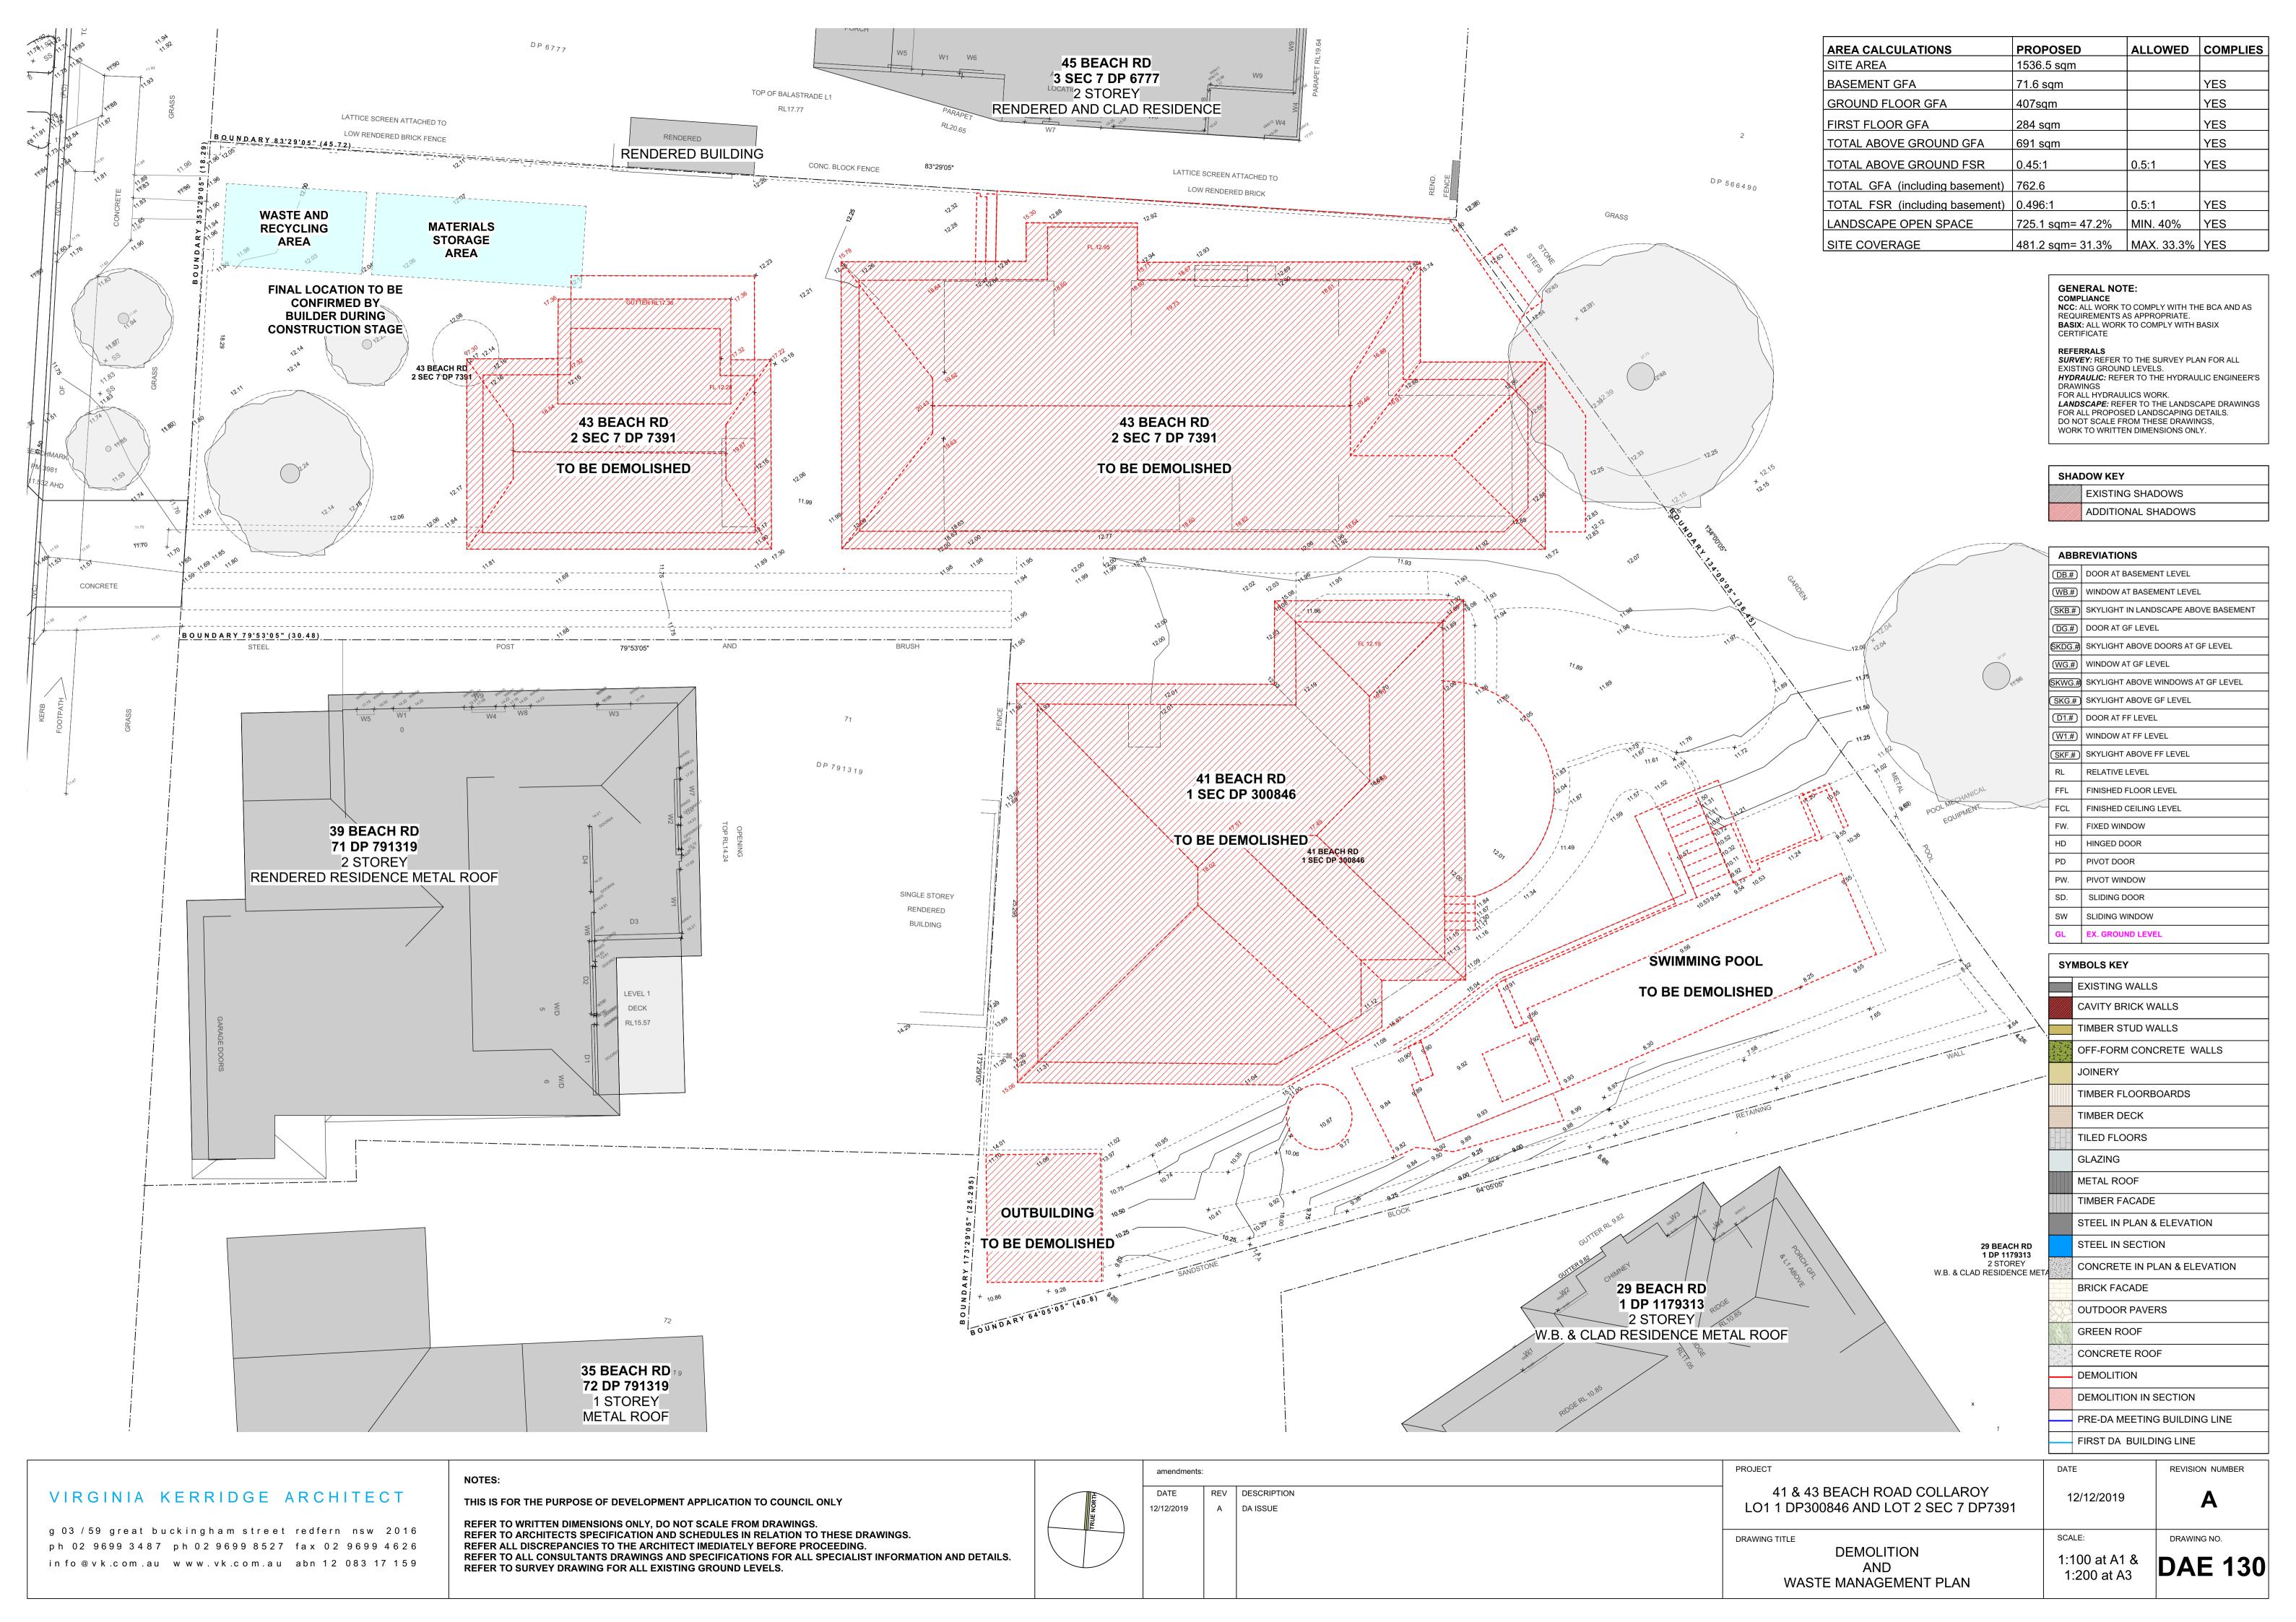

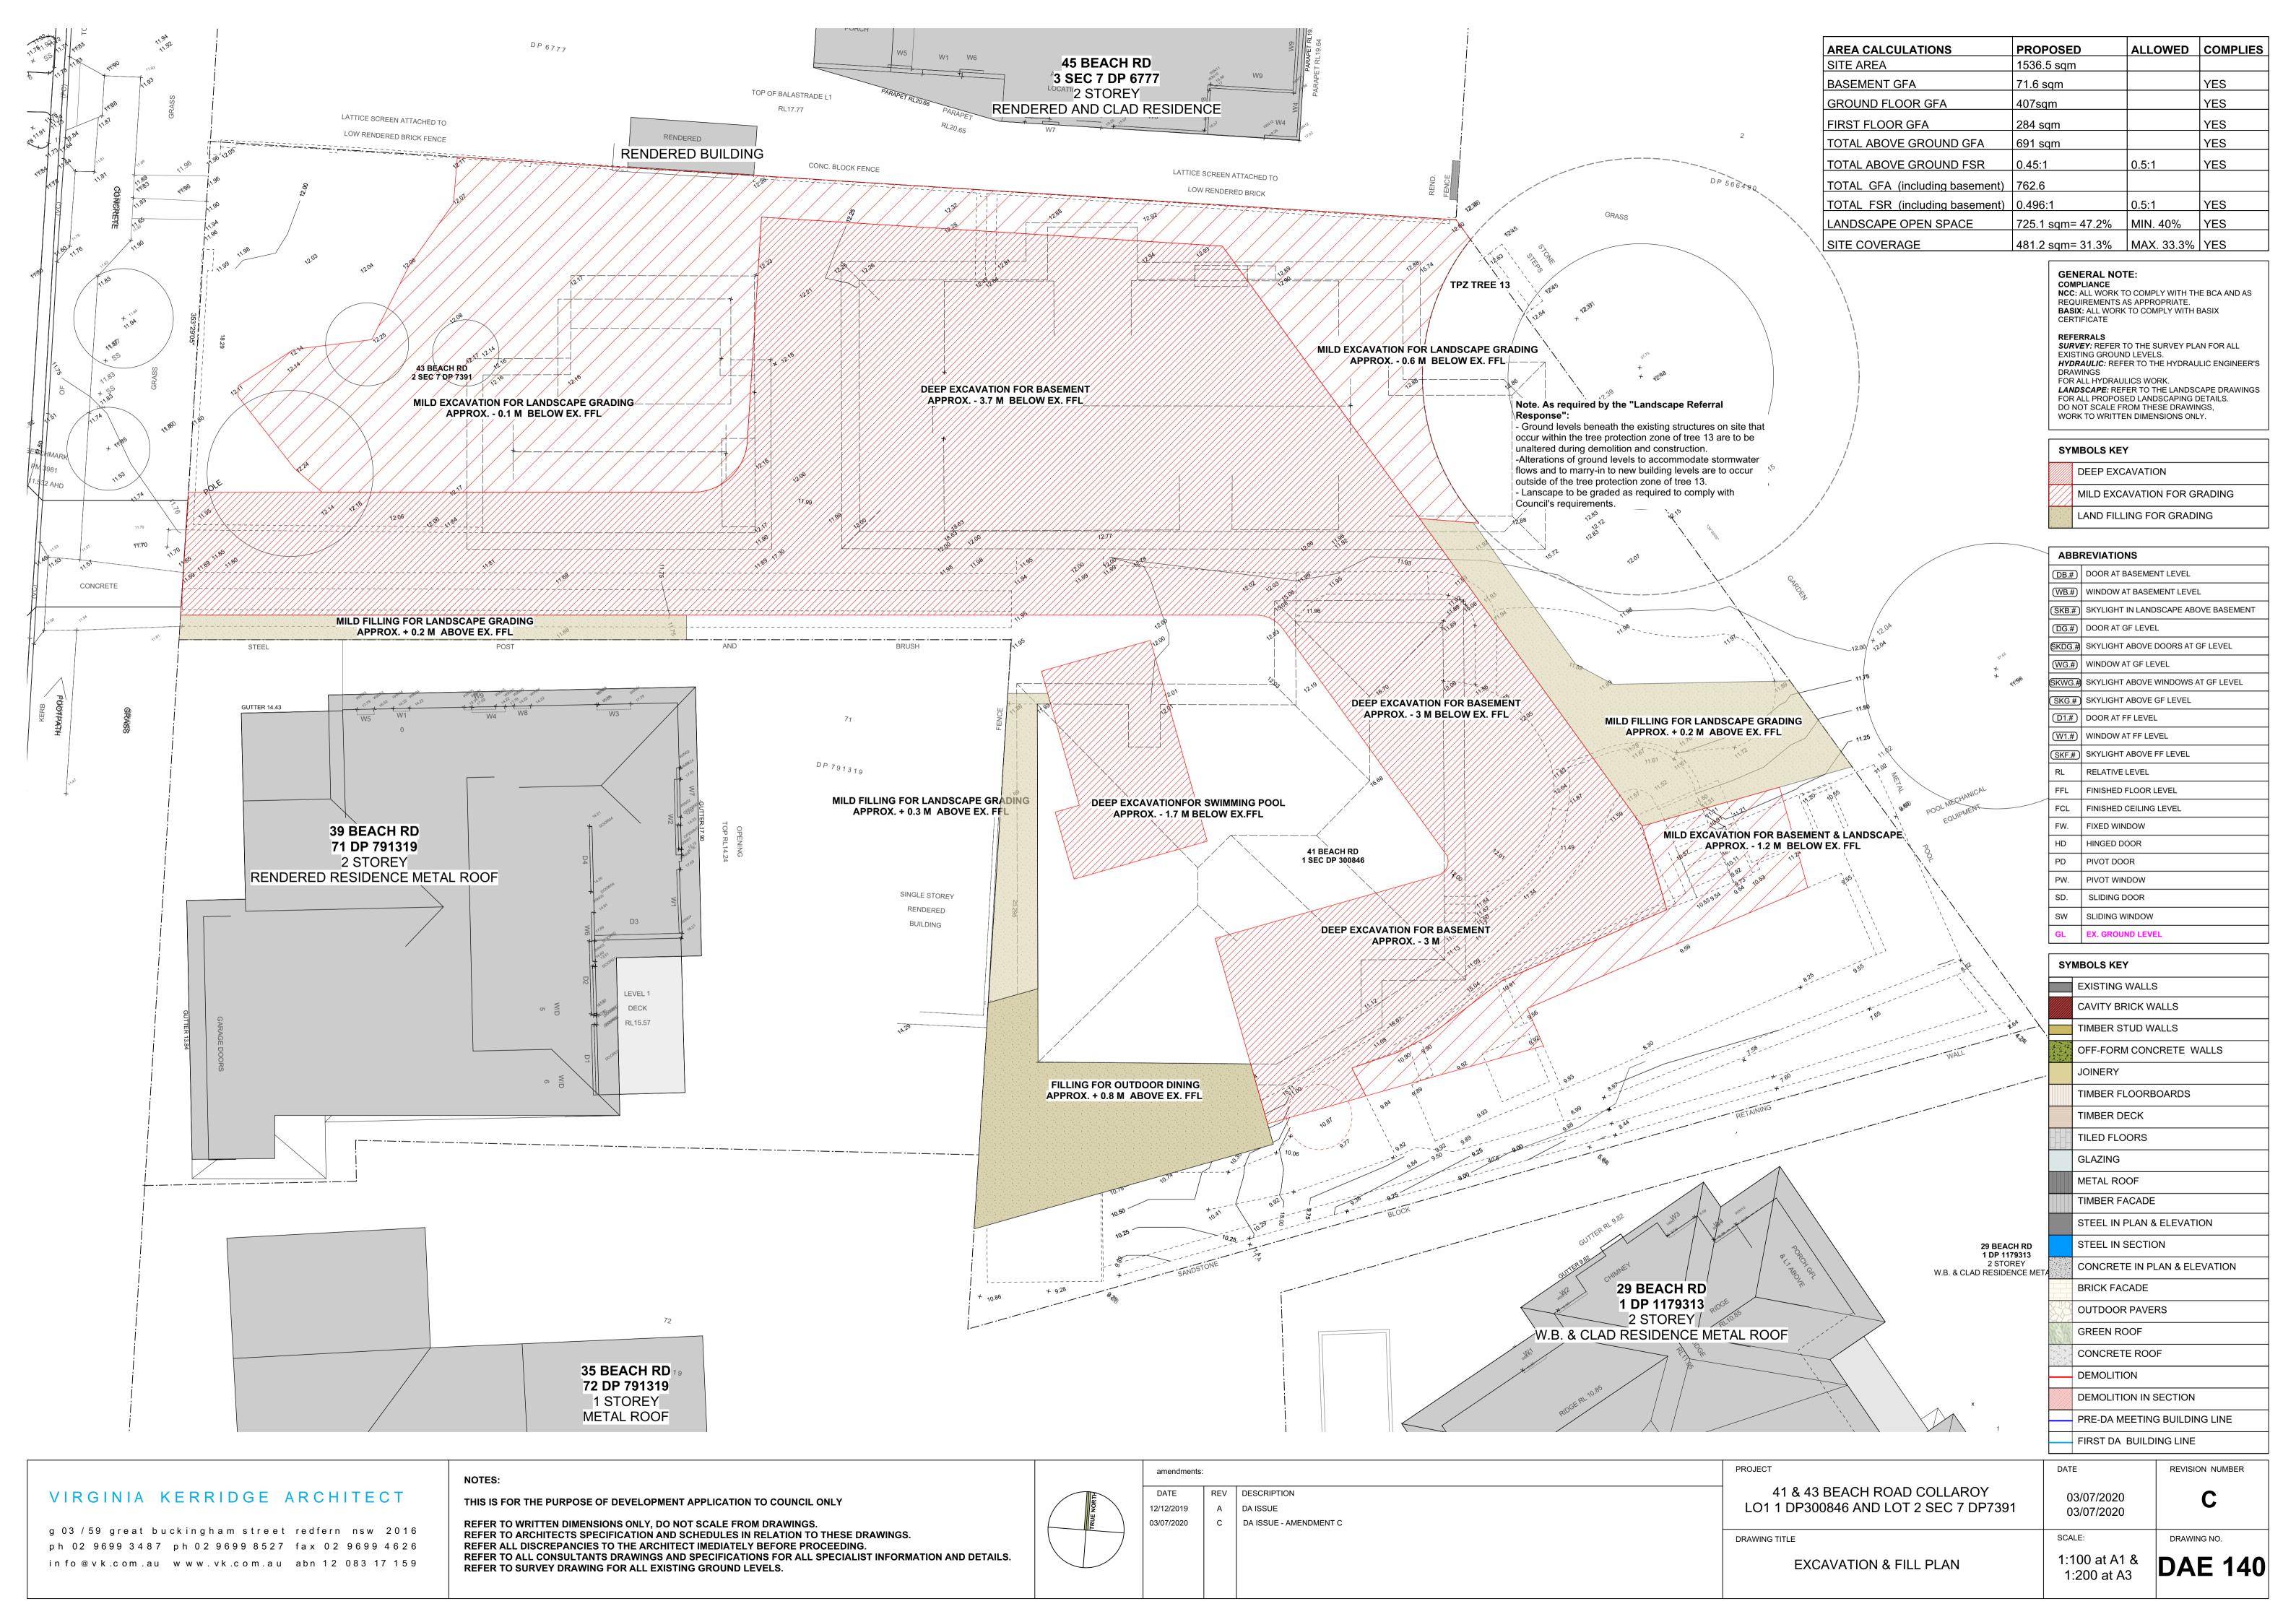

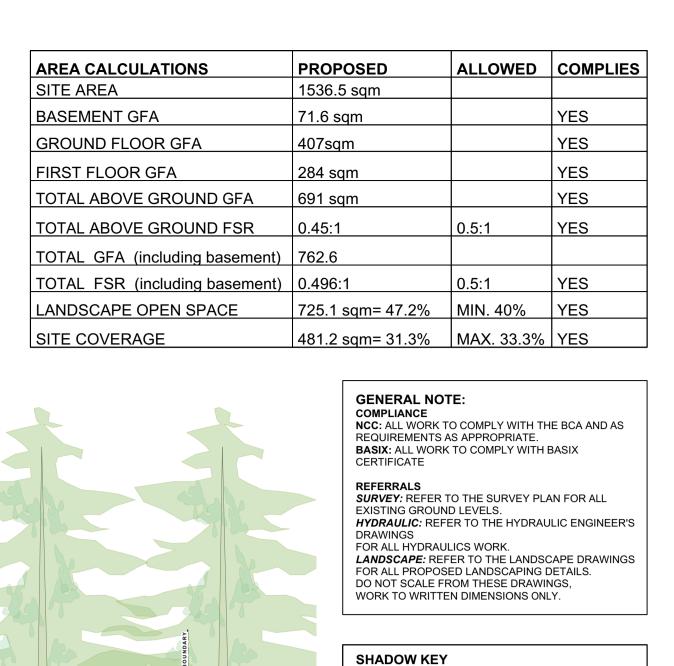

EXISTING SHADOWS

ABBREVIATIONS

(DG.#) DOOR AT GF LEVEL

(WG.#) WINDOW AT GF LEVEL

D1.# DOOR AT FF LEVEL W1.# WINDOW AT FF LEVEL

FW. FIXED WINDOW

PD PIVOT DOOR

PW. PIVOT WINDOW

SW SLIDING WINDOW

EXISTING WALLS

JOINERY

GLAZING

TIMBER DECK

TILED FLOORS

METAL ROOF

TIMBER FACADE

STEEL IN SECTION

BRICK FACADE

GREEN ROOF

DEMOLITION

OUTDOOR PAVERS

CONCRETE ROOF

DEMOLITION IN SECTION

FIRST DA BUILDING LINE

PRE-DA MEETING BUILDING LINE

STEEL IN PLAN & ELEVATION

CONCRETE IN PLAN & ELEVATION

SYMBOLS KEY

HINGED DOOR

SLIDING DOOR

EX. GROUND LEVEL

CAVITY BRICK WALLS

TIMBER FLOORBOARDS

OFF-FORM CONCRETE WALLS

TIMBER STUD WALLS

SKG.# SKYLIGHT ABOVE GF LEVEL

(SKF.#) SKYLIGHT ABOVE FF LEVEL RELATIVE LEVEL FFL FINISHED FLOOR LEVEL

FINISHED CEILING LEVEL

DB.# DOOR AT BASEMENT LEVEL


WB.# WINDOW AT BASEMENT LEVEL

SKB.#) SKYLIGHT IN LANDSCAPE ABOVE BASEMENT

SKDG.# SKYLIGHT ABOVE DOORS AT GF LEVEL

(SKWG.#) SKYLIGHT ABOVE WINDOWS AT GF LEVEL

ADDITIONAL SHADOWS

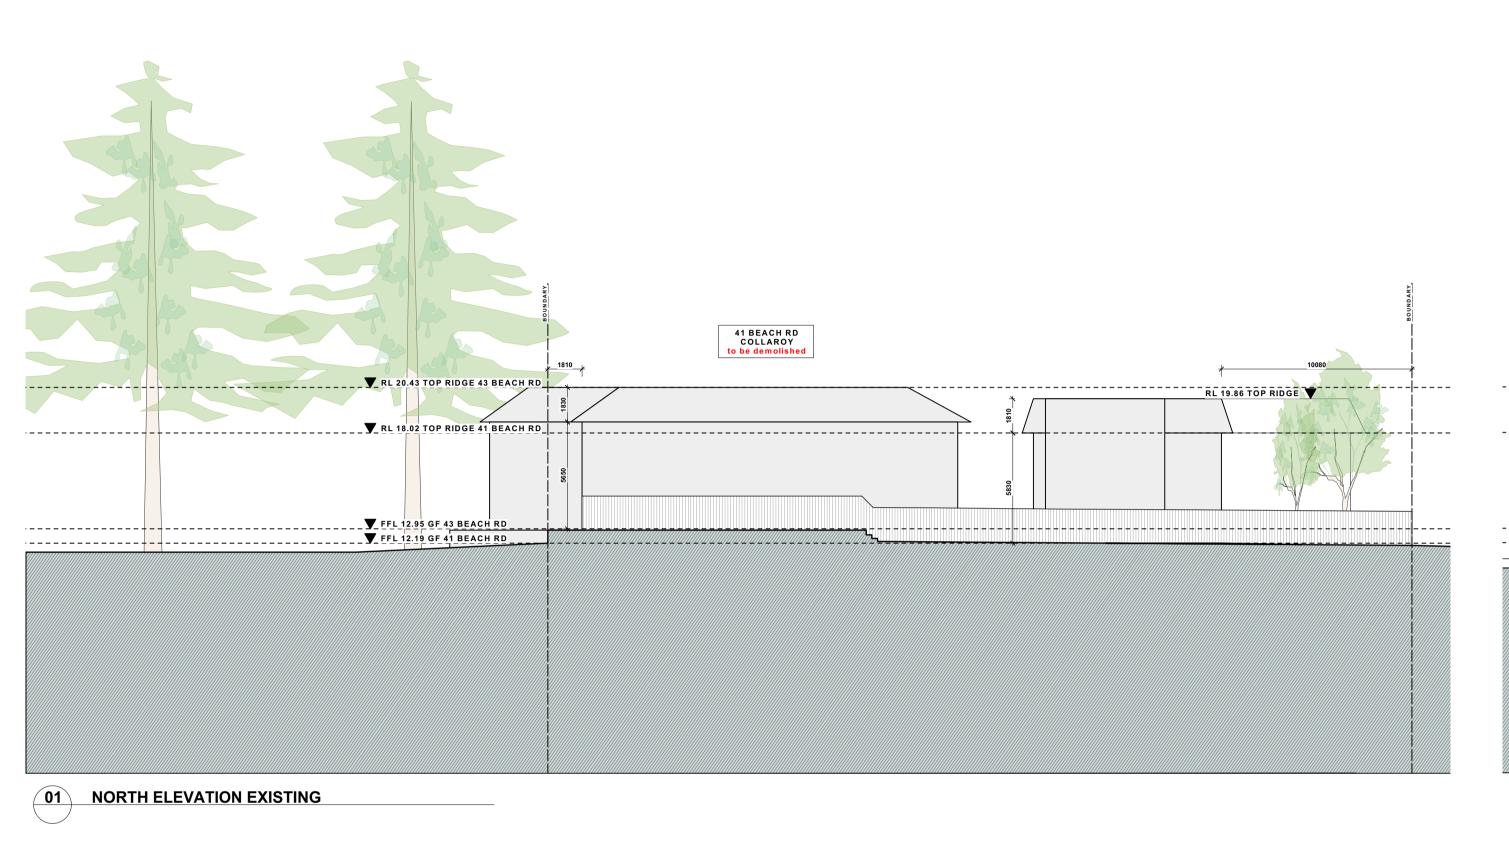

41 BEACH RD COLLAROY to be demolished RL 19.86 TOP RIDGE V TRL 18.02 TOP RIDGE 41 BEACH RD ▼ FFL 12.95 GF 43 BEACH RD
▼ FFL 12.19 GF 41 BEACH RD 03 SOUTH ELEVATION EXISTING

45 BEACH RD COLLAROY 35 BEACH RD COLLAROY RL 20.43 TOP RIDGE 43 BEACH RD ▼RL 19.64 TOP RIDGE RL 18.02 TOP RIDGE 41 BEACH RD ▼ FFL 12.95 GF 43 BEACH RD ------RL 10.85 TOP RIDGE 02 EAST ELEVATION EXISTING

RL 19.86 TOP RIDGE ▼ RL 19.64 TOP RIDGE T RL 18.02 TOP RIDGE 41 BEACH RD ▼ FFL 12.95 GF 43 BEACH RD
▼ FFL 12.19 GF 41 BEACH RD 43 BEACH RD COLLAROY 04 WEST- FRONT ELEVATION EXISTING

VIRGINIA KERRIDGE ARCHITECT

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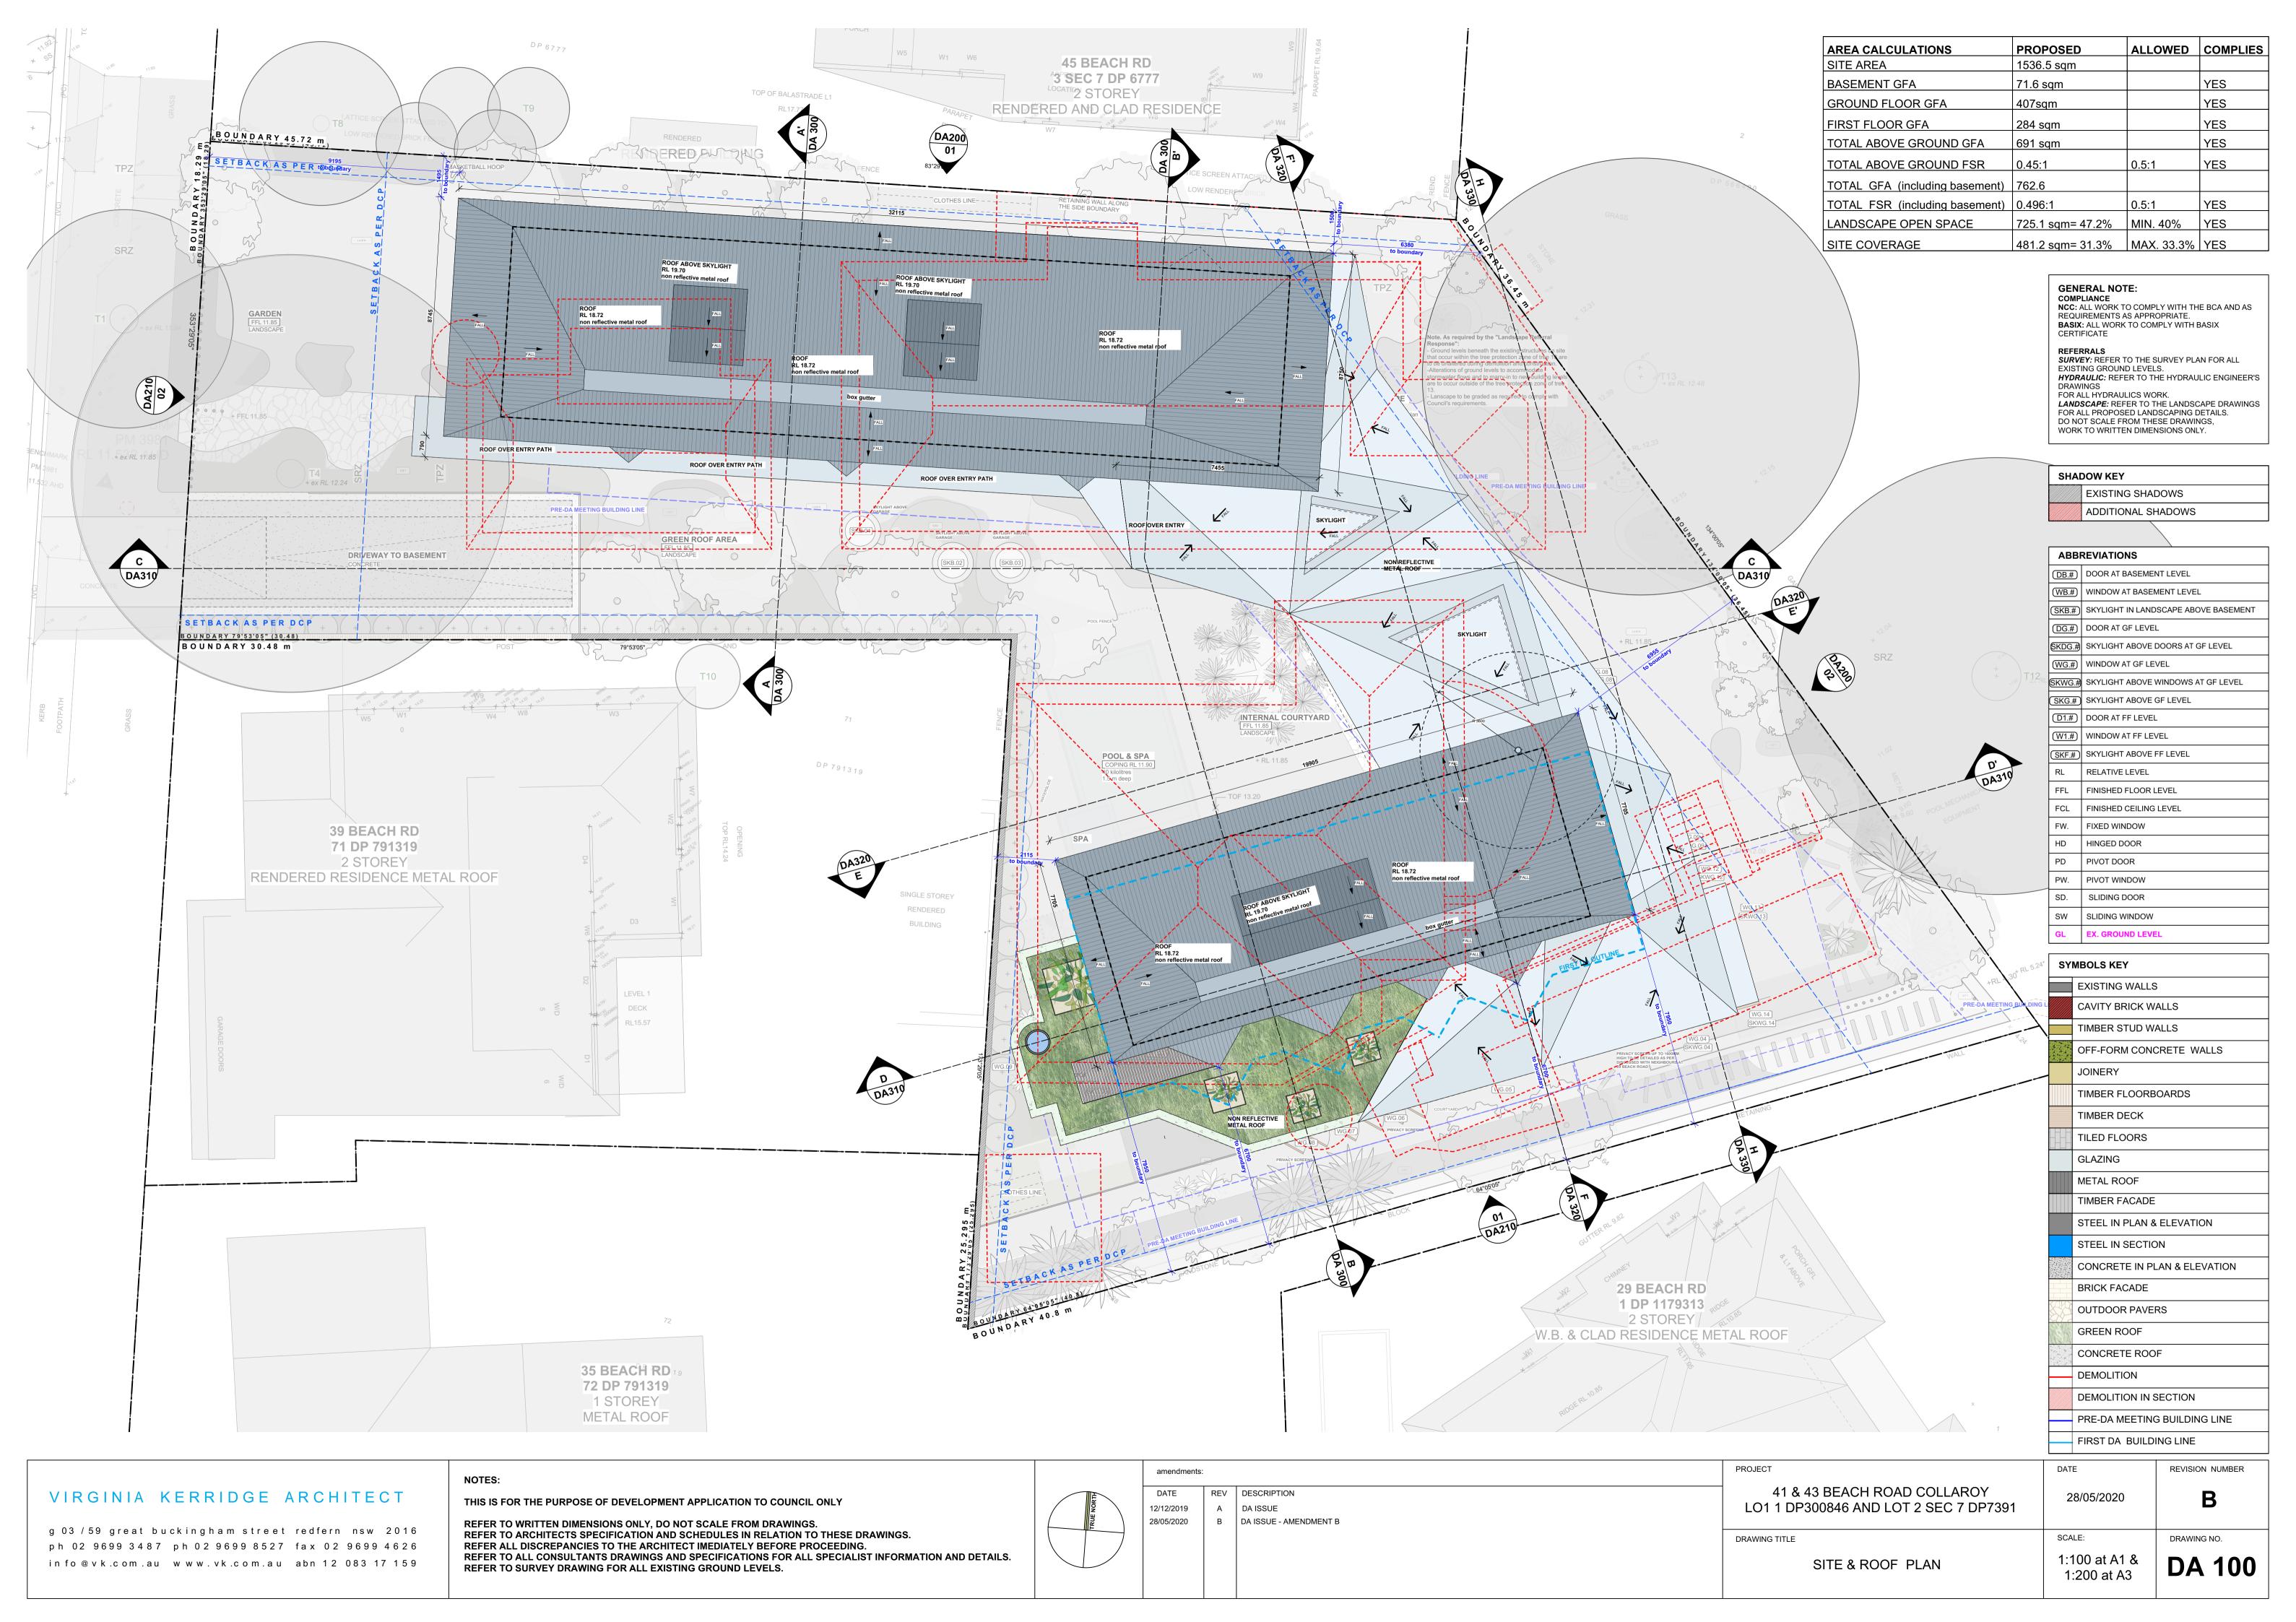
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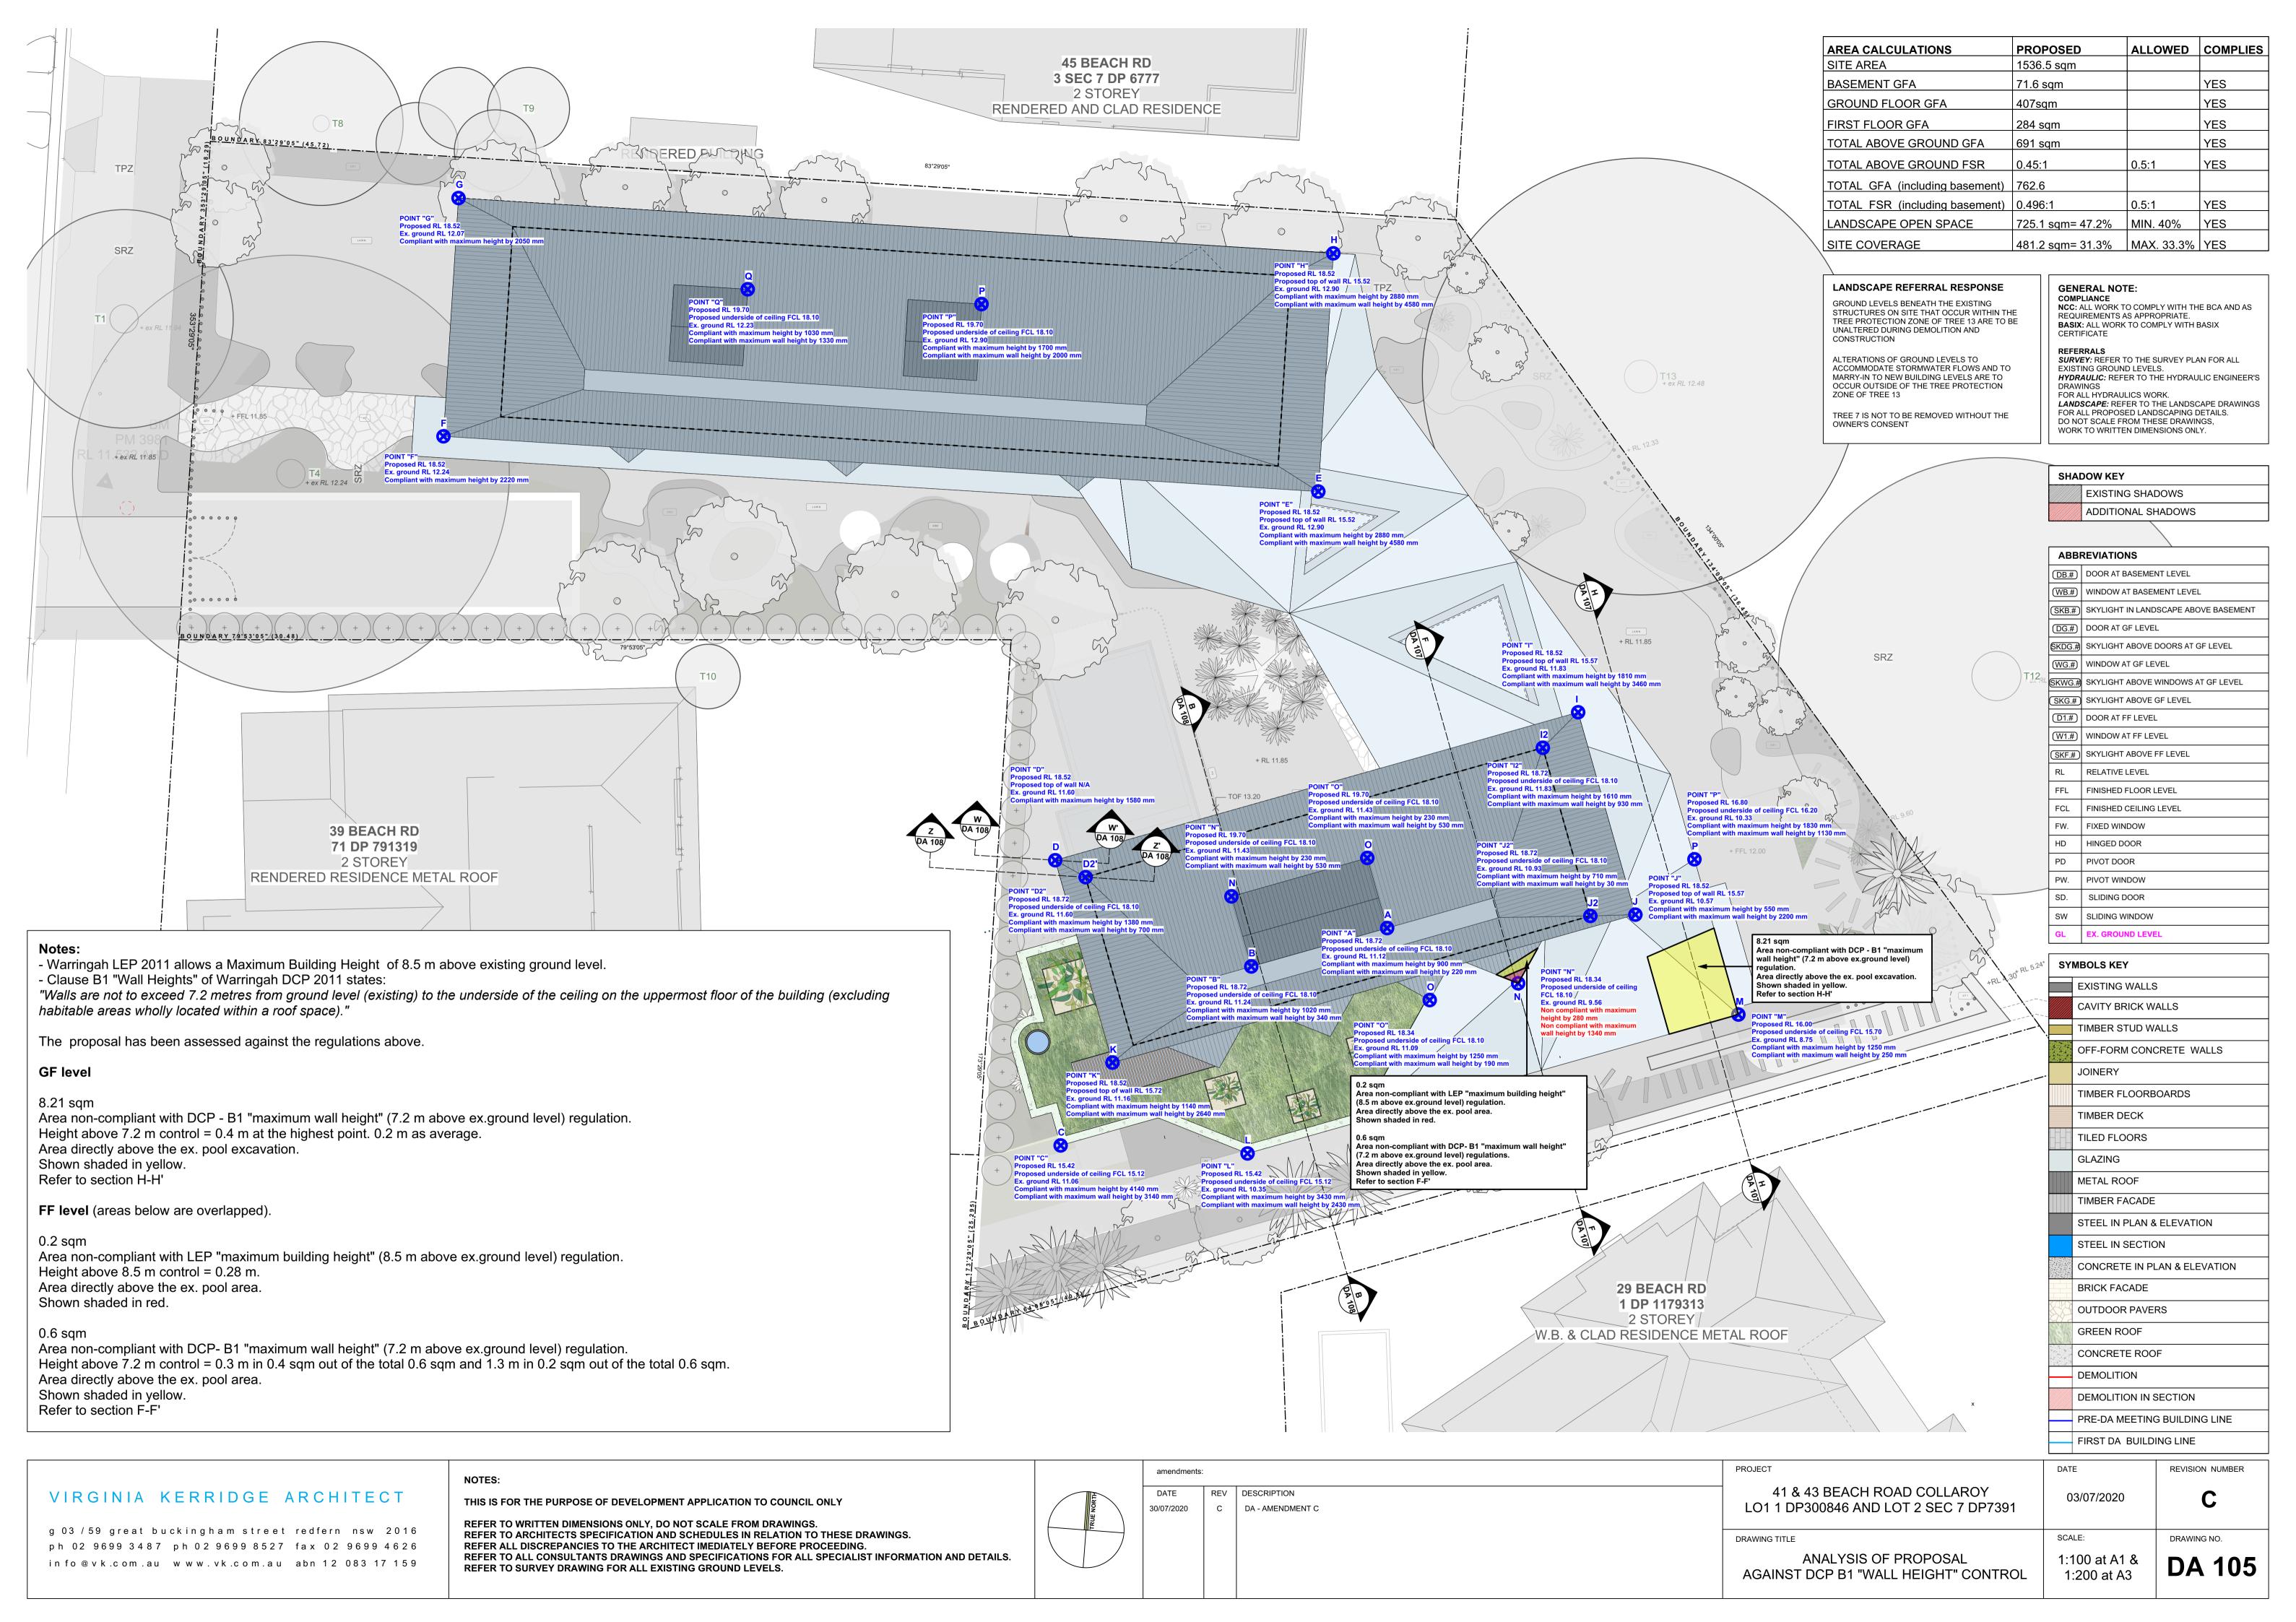
A DA ISSUE 12/12/2019

41 & 43 BEACH ROAD COLLAROY LO1 1 DP300846 AND LOT 2 SEC 7 DP7391 DRAWING TITLE

12/12/2019

1:200 at A1 & **EXISTING ELEVATIONS** 1:400 at A3






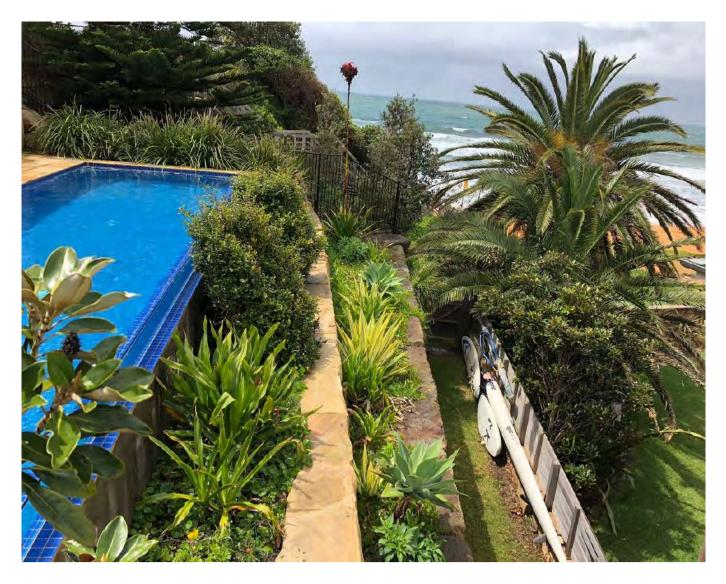


Photo of existing pool, stone retaining walls and garden terraces



Photo of existing pool and stone retaining wall.

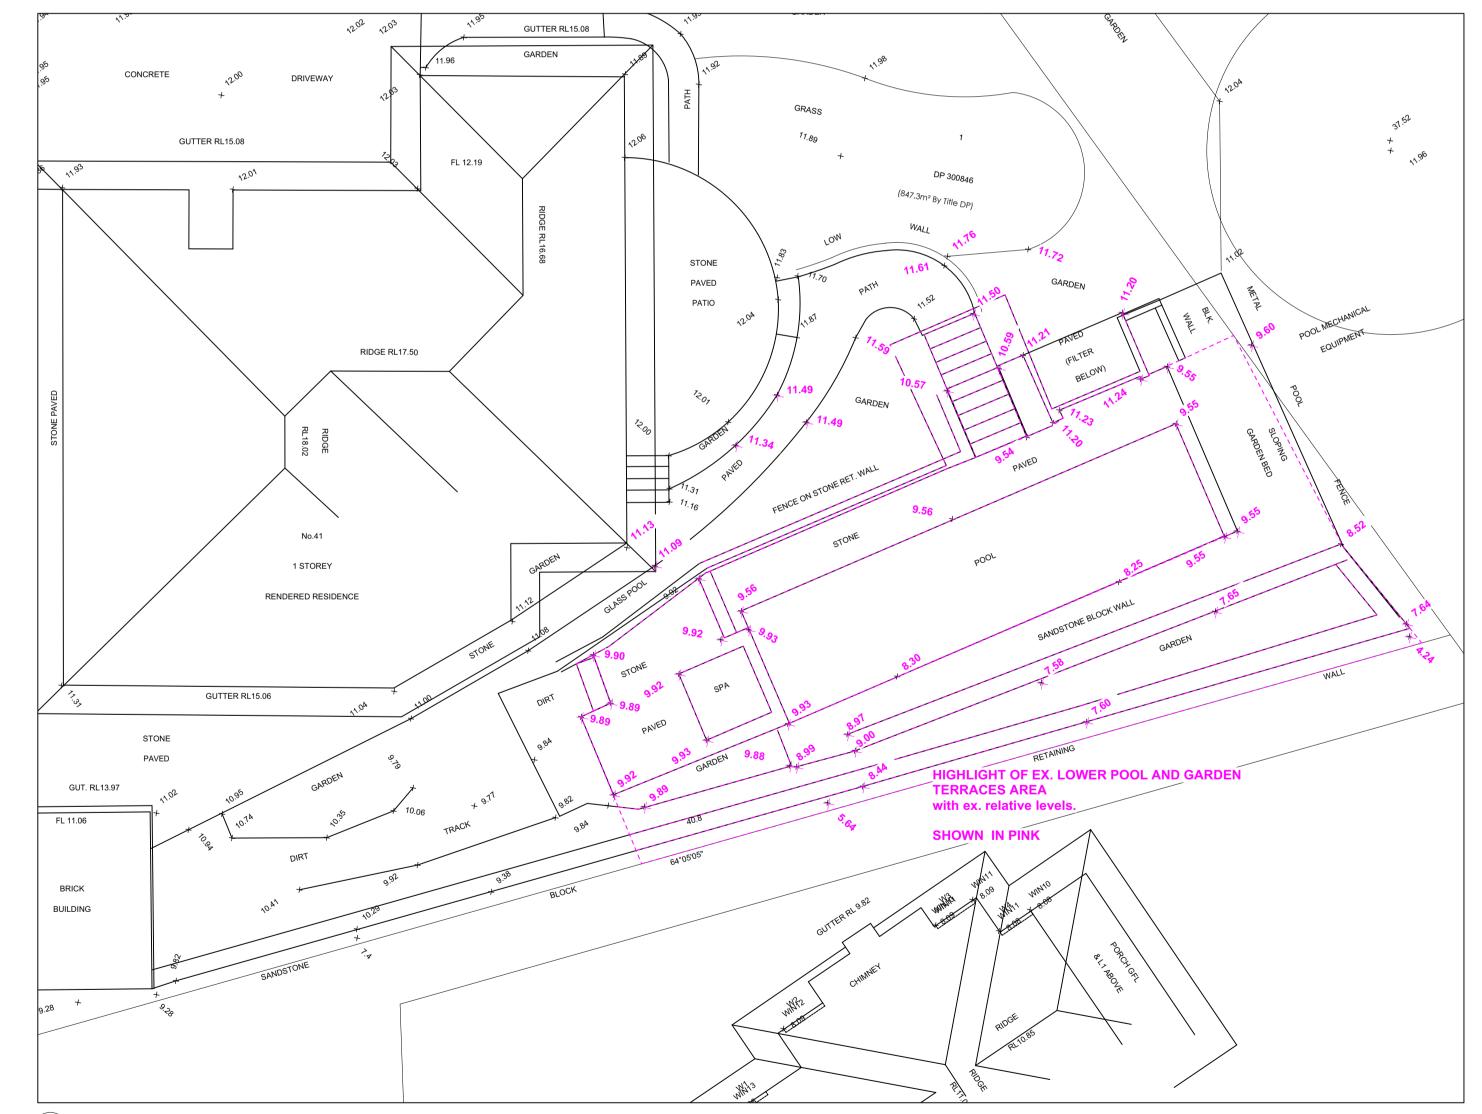

01 SURVEY. PARTIAL PLAN OF SOUTH EAST SECTION OF THE LOT.

- Warringah LEP 2011 allows a Maximum Building Height of 8.5 m above existing ground level.
- Clause B1 "Wall Heights" of Warringah DCP 2011 states:
- "Walls are not to exceed 7.2 metres from ground level (existing) to the underside of the ceiling on the uppermost floor of the building (excluding habitable areas wholly located within a

The proposal has been assessed against the regulations above.

GF level

8.21 sqm

Area non-compliant with DCP - B1 "maximum wall height" (7.2 m above ex.ground level) regulation. Height above 7.2 m control = 0.4 m at the highest point. 0.2 m as average.

Area directly above the ex. pool excavation.

Shown shaded in yellow.

Refer to section H-H'

FF level (areas below are overlapped).

0.2 sqm

Area non-compliant with LEP "maximum building height" (8.5 m above ex.ground level) regulation.

Height above 8.5 m control = 0.28 m.

Area directly above the ex. pool area.

Shown shaded in red.

0.6 sqm


Area non-compliant with DCP- B1 "maximum wall height" (7.2 m above ex.ground level) regulation.

Height above 7.2 m control = 0.3 m in 0.4 sqm out of the total 0.6 sqm and 1.3 m in 0.2 sqm out of the total 0.6 sqm.

Area directly above the ex. pool area.

Shown shaded in yellow.

Refer to section F-F'

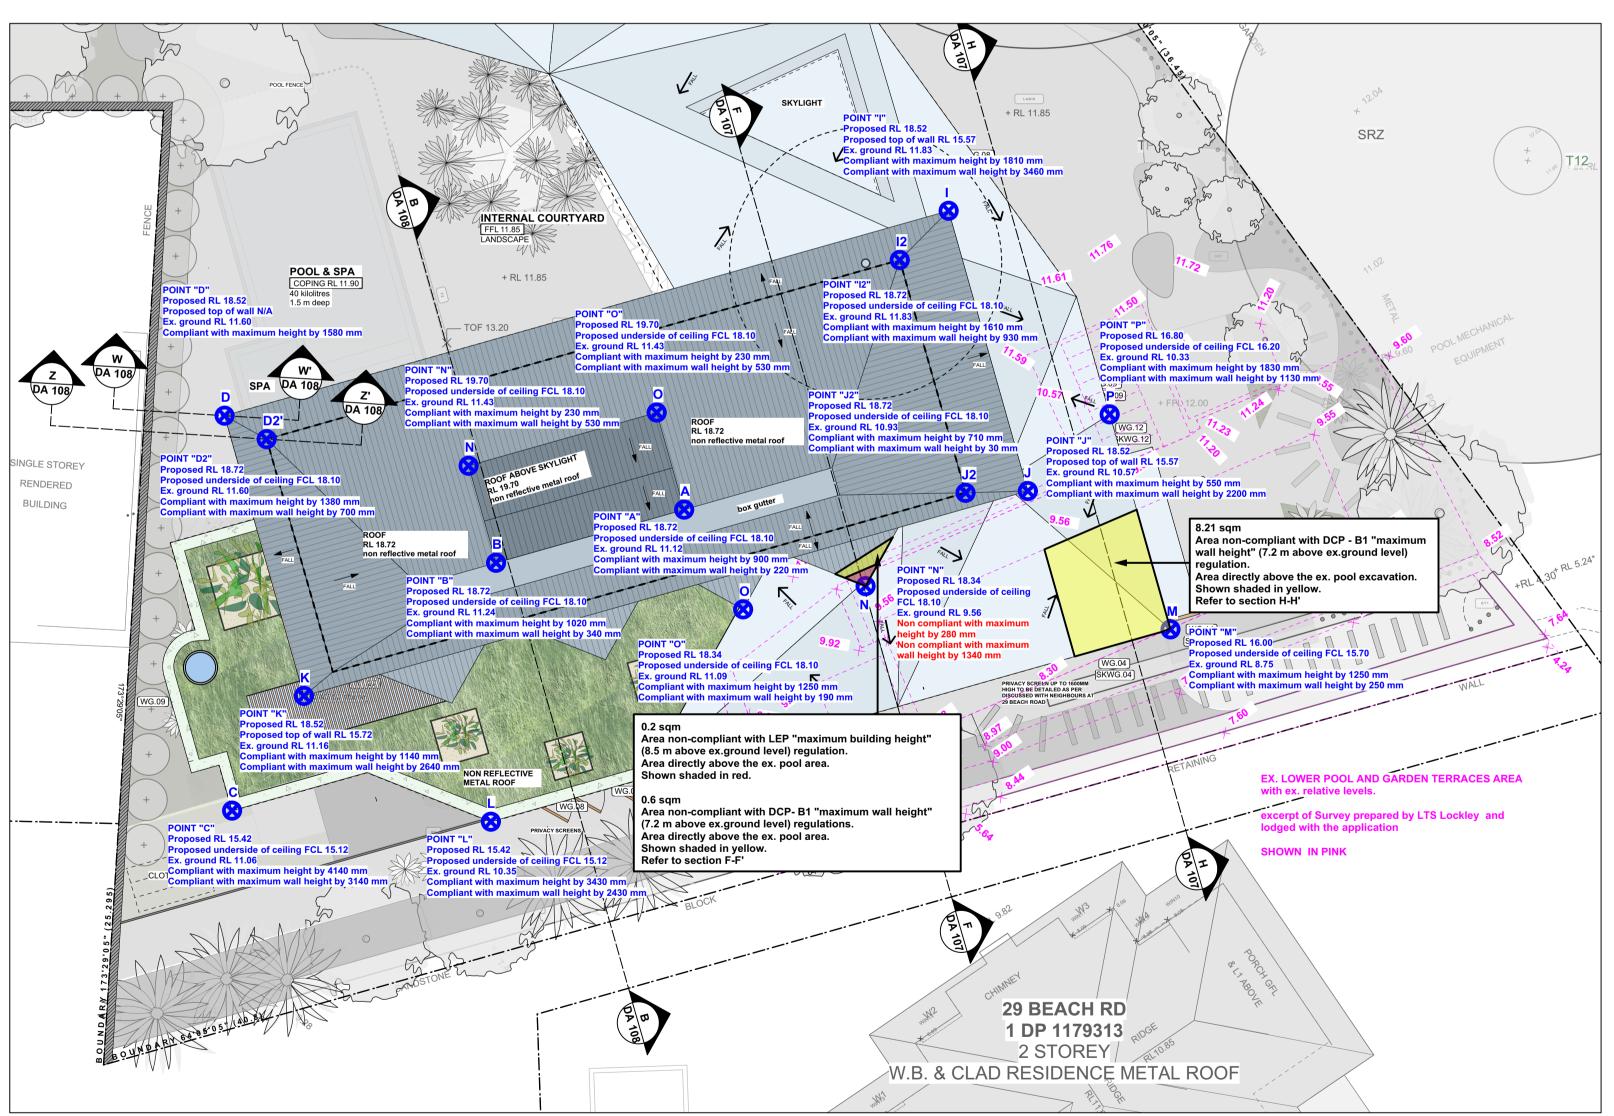

02 ROOF PLAN / RL ANALYSIS. PARTIAL PLAN OF SOUTH EAST SECTION OF THE LOT.

VIRGINIA KERRIDGE ARCHITECT

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DATE	REV	DESCRIF
30/07/2020	С	DA - AMI

amendments:


41 & 43 BEACH ROAD COLLAROY LO1 1 DP300846 AND LOT 2 SEC 7 DP7391 MENDMENT C DRAWING TITLE


SCALE: ANALYSIS OF PROPOSAL 1:100 at A1 & AGAINST DCP B1 "WALL HEIGHT" CONTROL 1:200 at A3 SOUTH EAST AREA DETAIL


DATE

03/07/2020

REVISION NUMBER

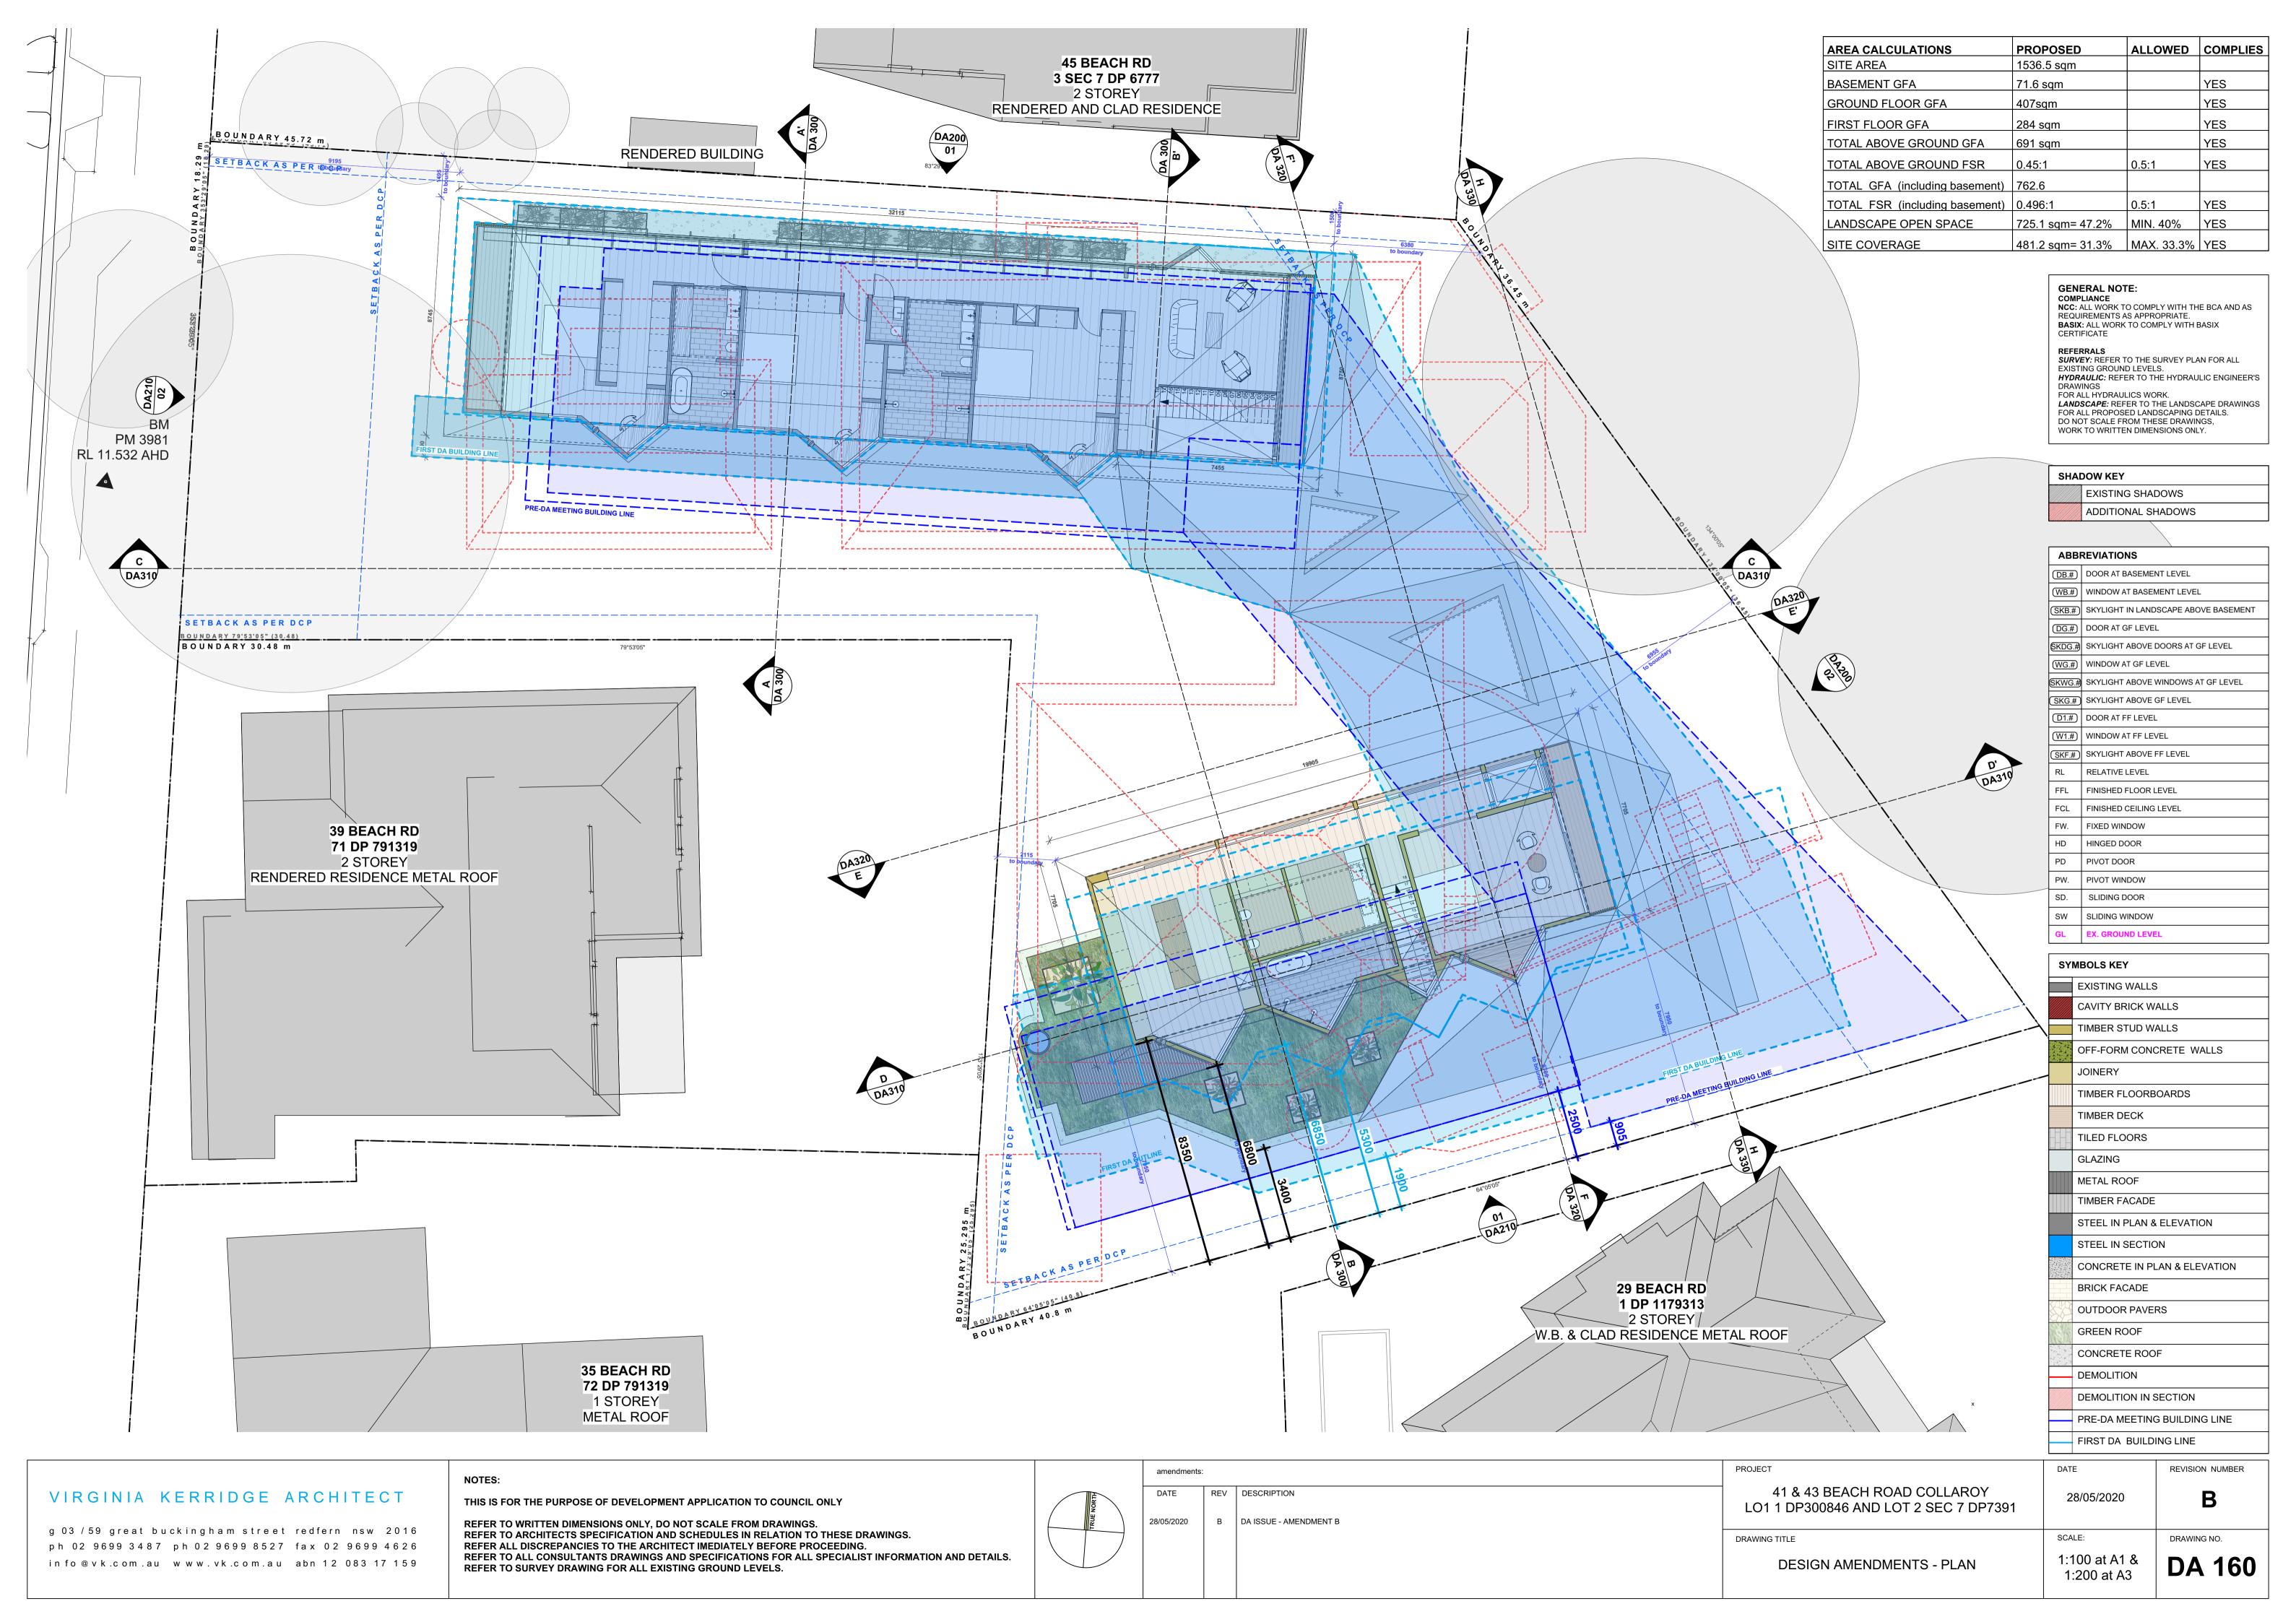


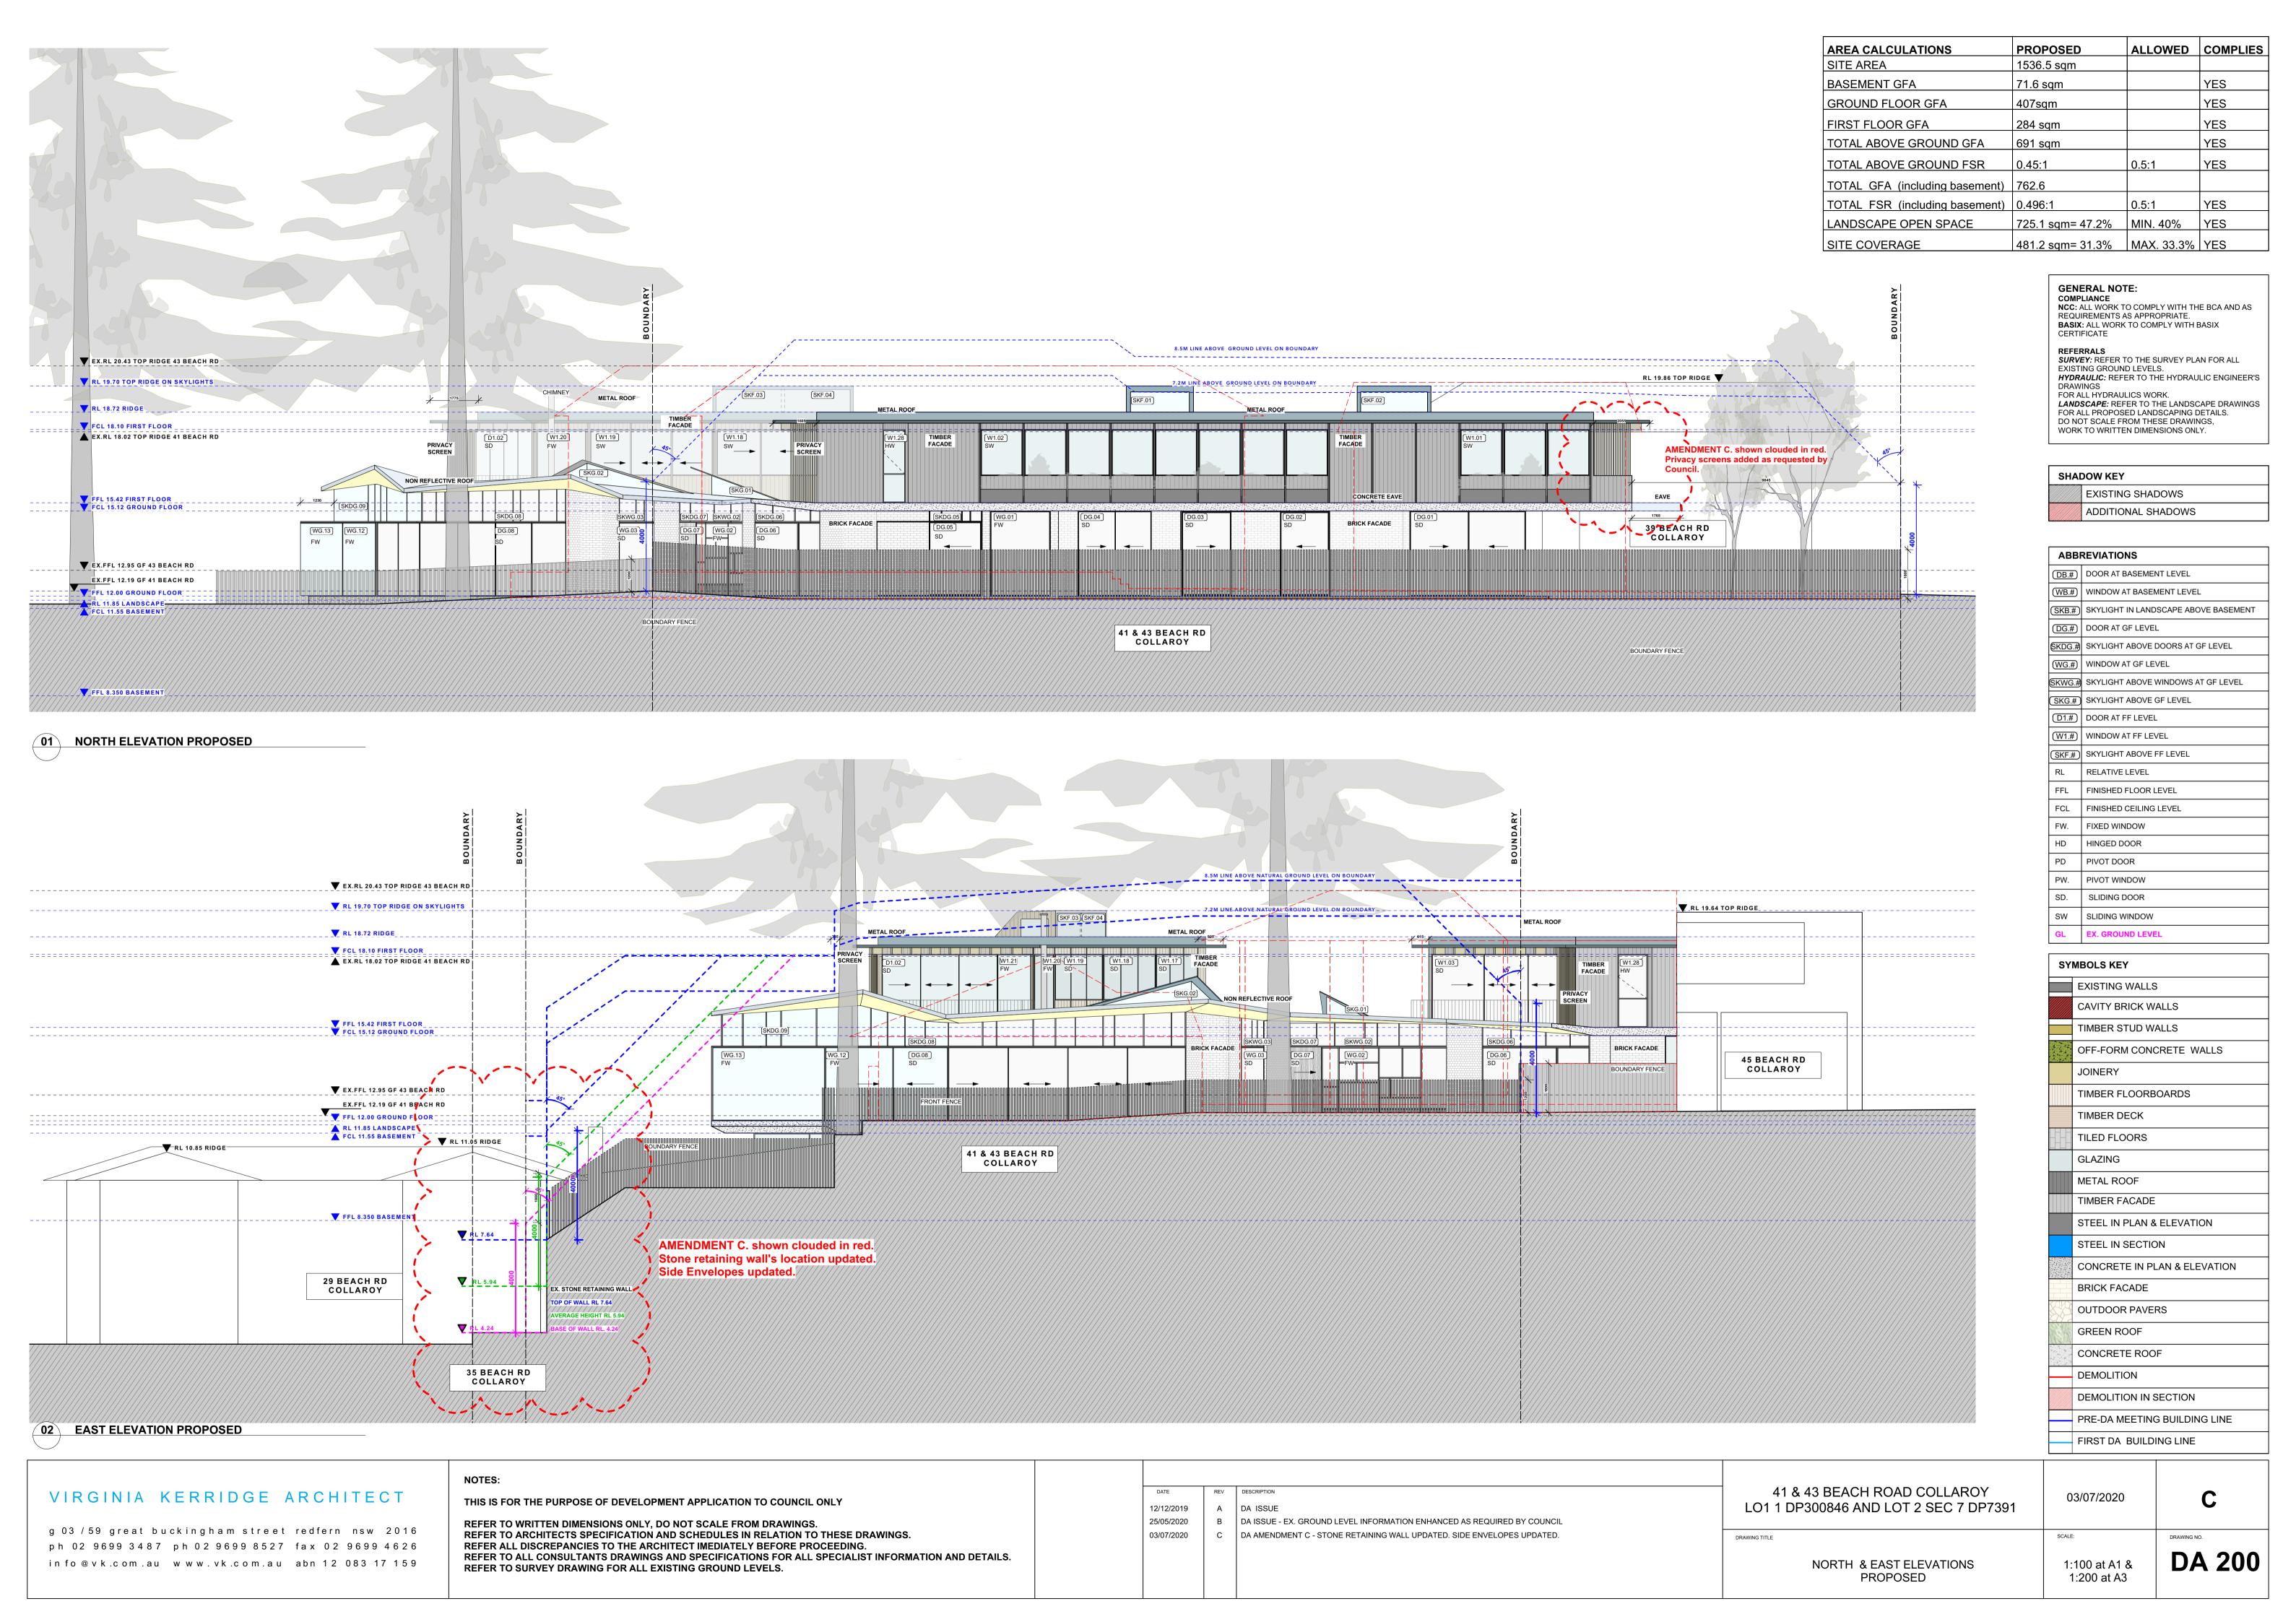

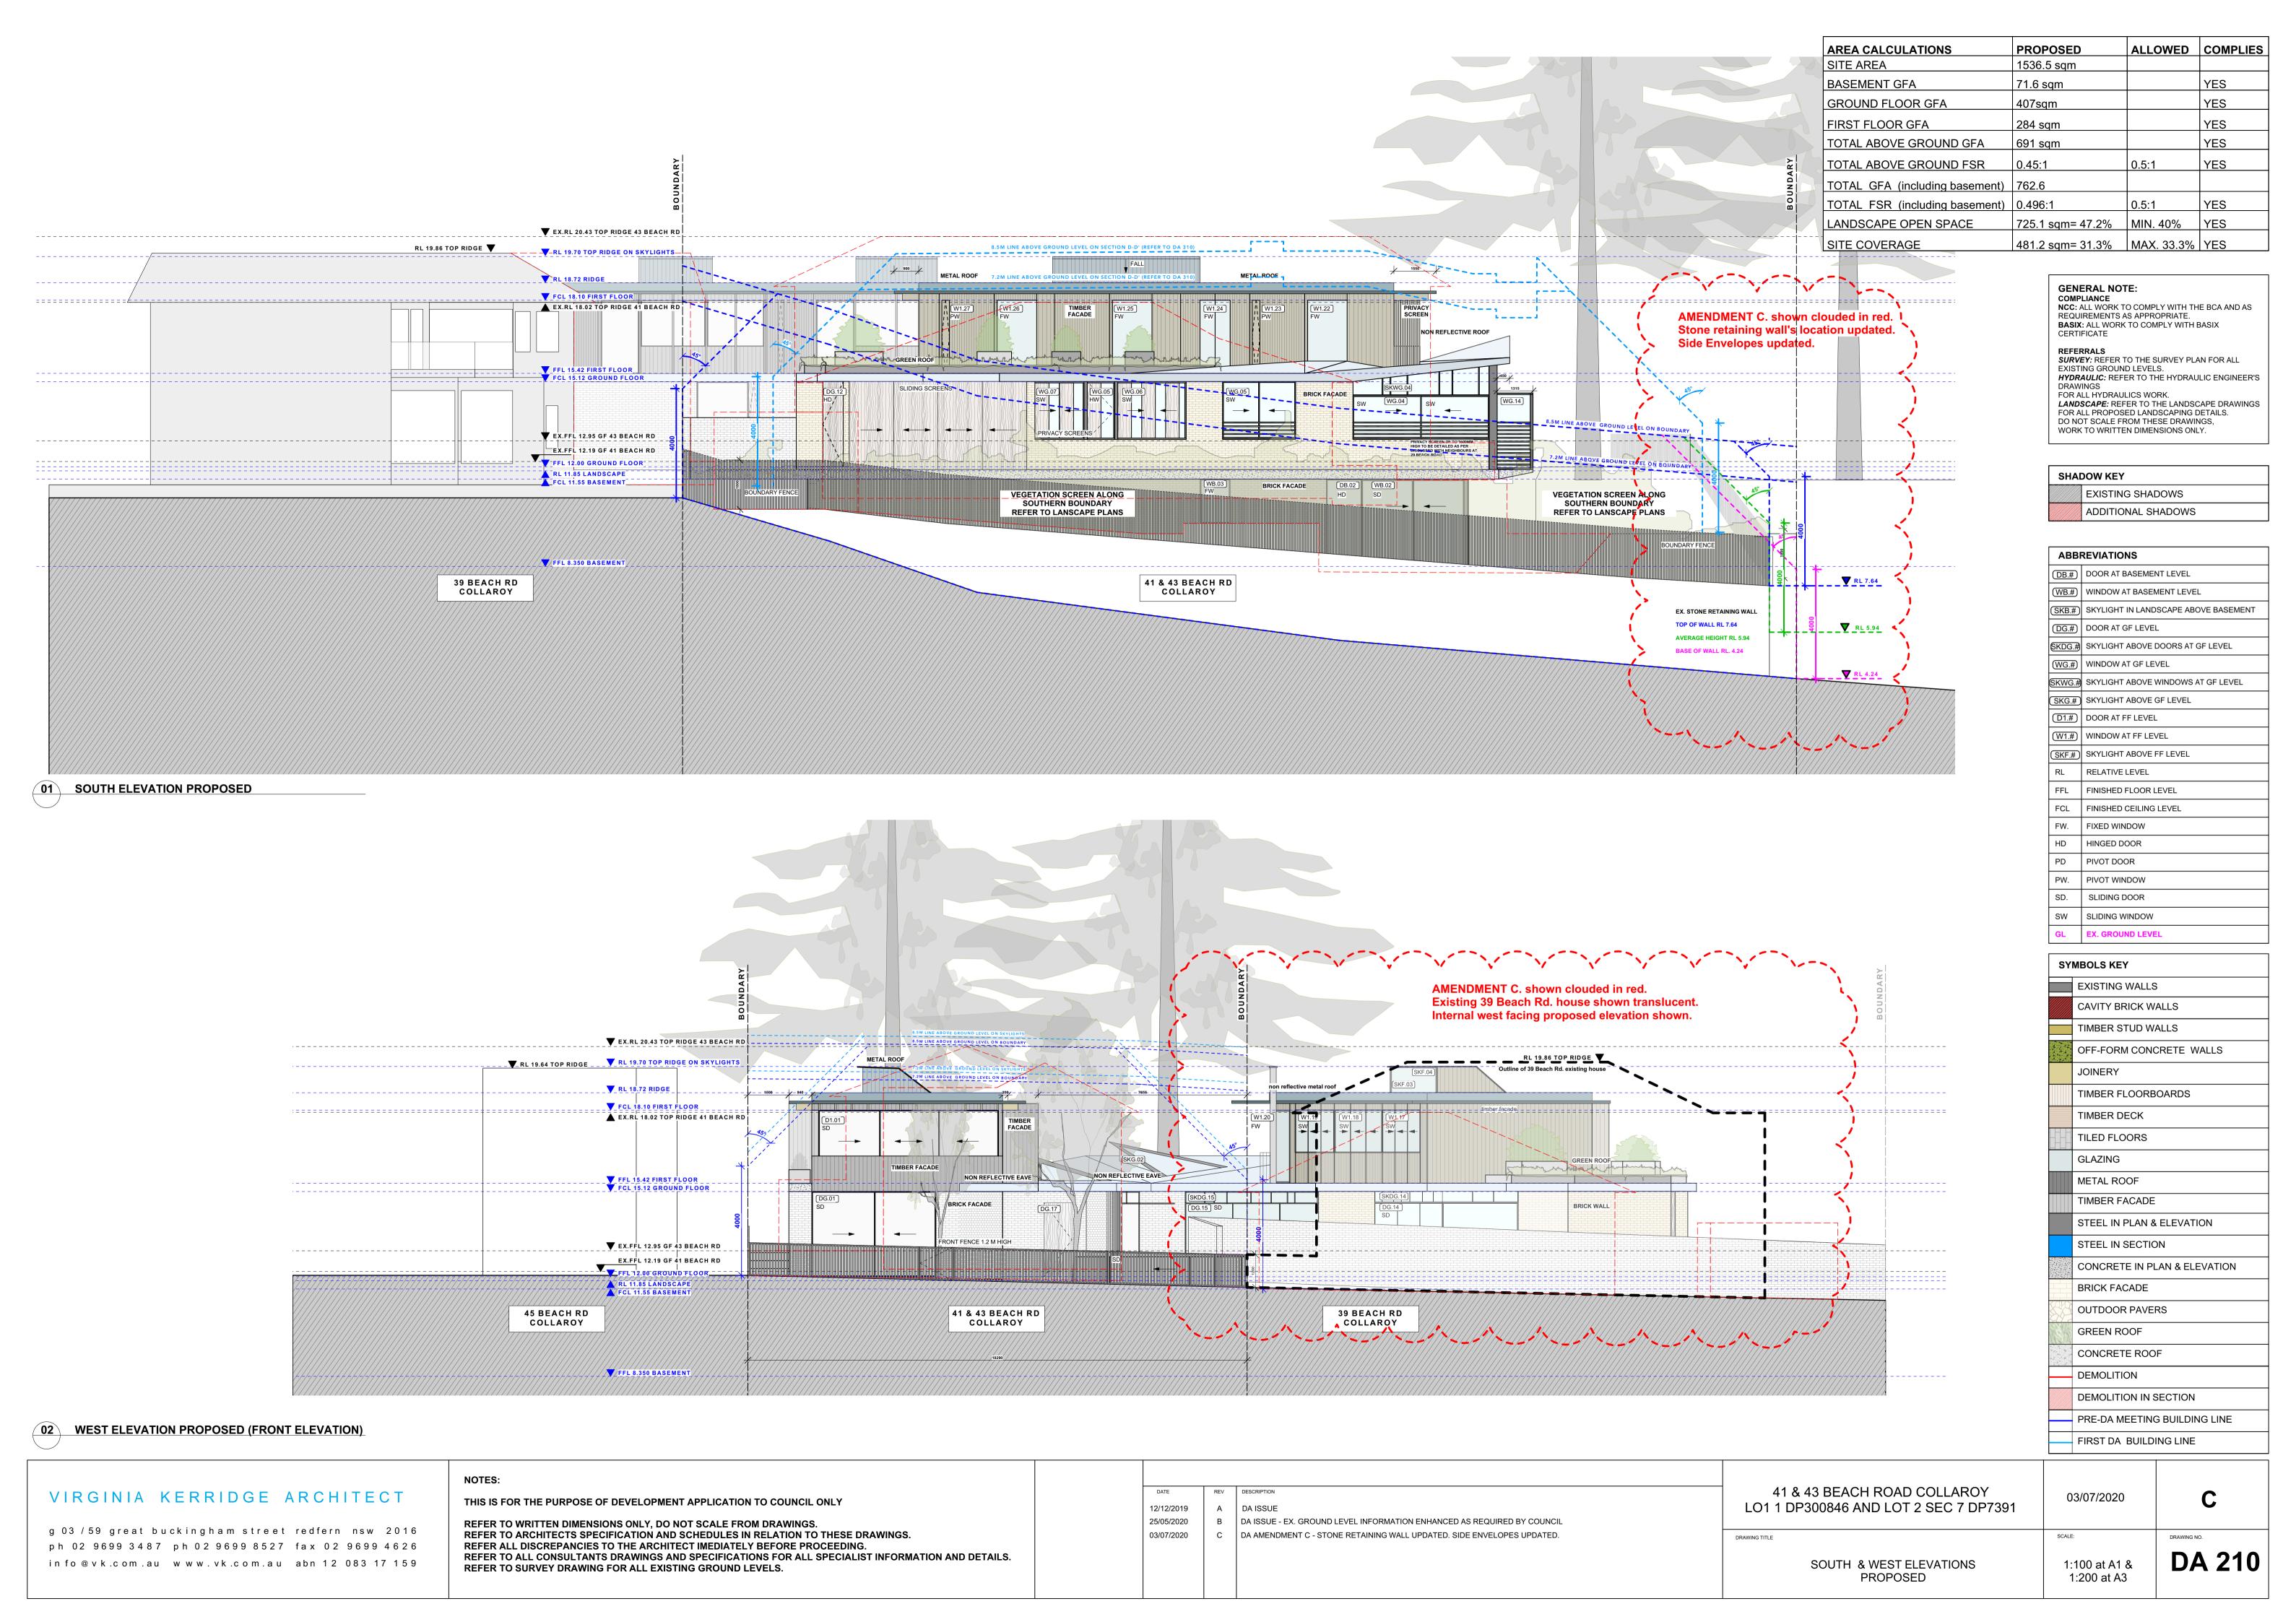



TIMBER PRIVACY SCREENS

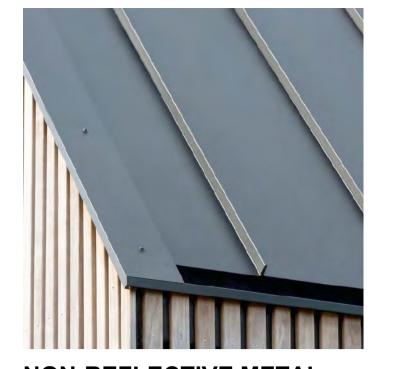


NON-REFLECTIVE METAL ROOF



WINDOWS / DOORS -ALUMINIUM FRAME



BRICK WALLS / STRUCTURE

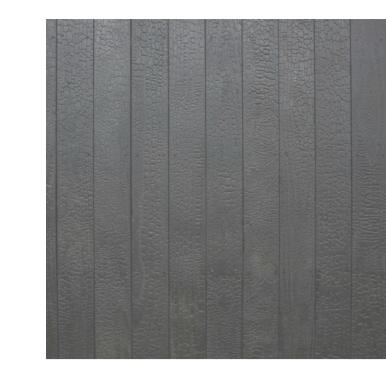

GROUND FLOOR GFA

TOTAL ABOVE GROUND GFA

TOTAL ABOVE GROUND FSR

LANDSCAPE OPEN SPACE

TOTAL GFA (including basement) 762.6 TOTAL FSR (including basement) 0.496:1

FIRST FLOOR GFA

SITE COVERAGE

SITE AREA

BASEMENT GFA

PROPOSED

1536.5 sqm

71.6 sqm

407sqm

284 sqm

0.45:1

725.1 sqm= 47.2%

ALLOWED COMPLIES


MIN. 40%

COMPLIANCE
NCC: ALL WORK TO COMPLY WITH THE BCA AND AS
REQUIREMENTS AS APPROPRIATE.
BASIX: ALL WORK TO COMPLY WITH BASIX
CERTIFICATE

481.2 sqm= 31.3% MAX. 33.3% YES

GENERAL NOTE:

TIMBER CLADDING

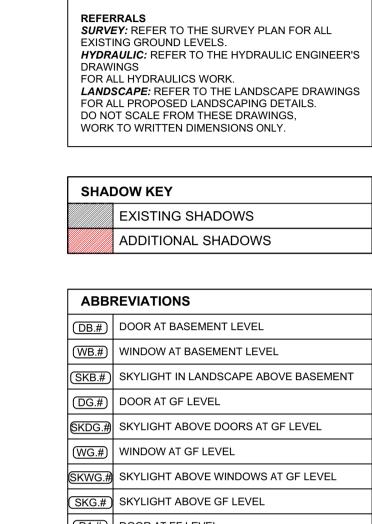

	EXISTING WALLS
SYM	BOLS KEY
GL	EX. GROUND LEVEL
sw	SLIDING WINDOW
SD.	SLIDING DOOR
PW.	PIVOT WINDOW
PD	PIVOT DOOR
HD	HINGED DOOR
FW.	FIXED WINDOW
FCL	FINISHED CEILING LEVEL
FFL	FINISHED FLOOR LEVEL
RL	RELATIVE LEVEL
(SKF.#)	SKYLIGHT ABOVE FF LEVEL
(W1.#)	WINDOW AT FF LEVEL
D1.#	DOOR AT FF LEVEL
SKG.#	SKYLIGHT ABOVE GF LEVEL
SKWG.#	SKYLIGHT ABOVE WINDOWS AT GF LEVEL
(WG.#)	WINDOW AT GF LEVEL
SKDG.#)	SKYLIGHT ABOVE DOORS AT GF LEVEL
(20:11)	


"	MIDOLO RET
	EXISTING WALLS
	CAVITY BRICK WALLS
	TIMBER STUD WALLS
	OFF-FORM CONCRETE WALLS
	JOINERY
	TIMBER FLOORBOARDS
	TIMBER DECK
	TILED FLOORS
	GLAZING
	METAL ROOF
	TIMBER FACADE
	STEEL IN PLAN & ELEVATION
	STEEL IN SECTION
	CONCRETE IN PLAN & ELEVATION
	BRICK FACADE
	OUTDOOR PAVERS



TIMBER DECK




CONCRETE

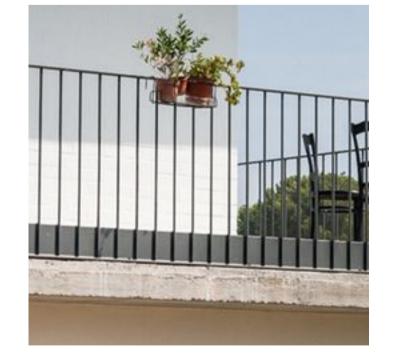

STEEL / TIMBER **BALUSTRADE**



TIMBER DOOR

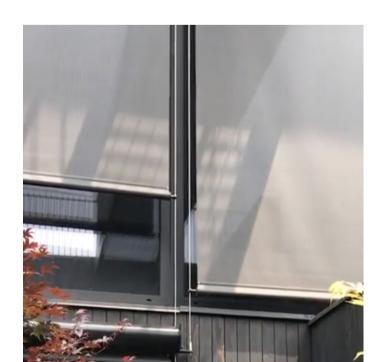

WINDOWS - EXTERNAL BLINDS

VIRGINIA KERRIDGE ARCHITECT

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REFER TO SURVEY DRAWING FOR ALL EXISTING GROUND LEVELS.

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REFER TO ALL CONSULTANTS DRAWINGS AND SPECIFICATIONS FOR ALL SPECIALIST INFORMATION AND DETAILS.

12/12/2019 03/07/2020

amendments:

A DA ISSUE C DA ISSUE - AMENDMENT C 41 & 43 BEACH ROAD COLLAROY

LO1 1 DP300846 AND LOT 2 SEC 7 DP7391

FIRST DA BUILDING LINE REVISION NUMBER: 03/07/2020

GREEN ROOF

DEMOLITION

CONCRETE ROOF

DEMOLITION IN SECTION

PRE-DA MEETING BUILDING LINE

DA 400 N/A MATERIALS AND FINISHES SCHEDULE



PROPOSED

ALLOWED COMPLIES



SITE AREA

PROPOSED

ALLOWED COMPLIES



SITE AREA


PROPOSED


1536.5 sqm

1:400 at A3

SHADOW DIAGRAMS AT 3PM -21ST JUNE

ALLOWED COMPLIES

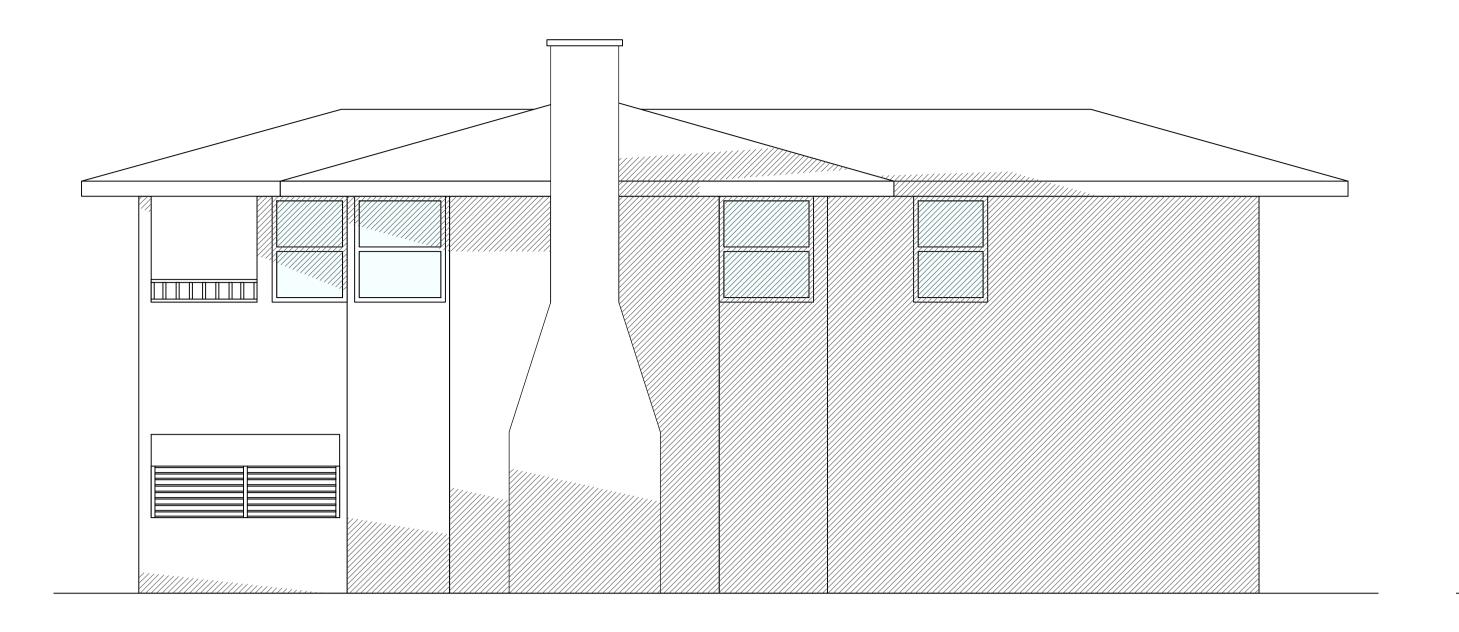


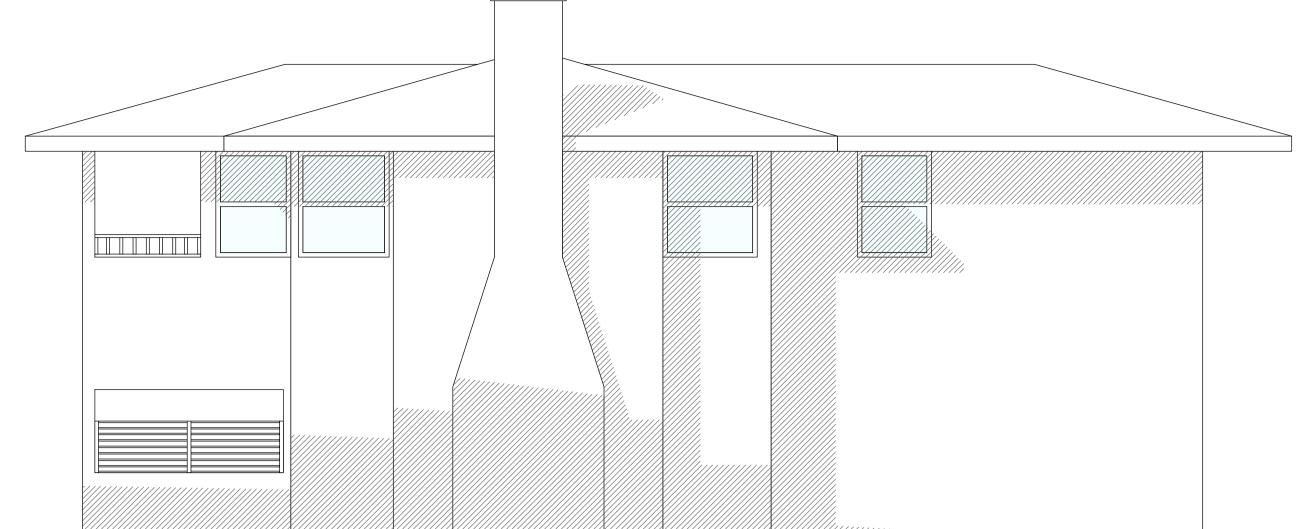

EXISTING ELEVATION SHADOWS - 29 BEACH RD. NORTHERN FACADE 9 AM - 21st June



EXISTING ELEVATION SHADOWS - 29 BEACH RD. NORTHERN FACADE 12 PM - 21st June

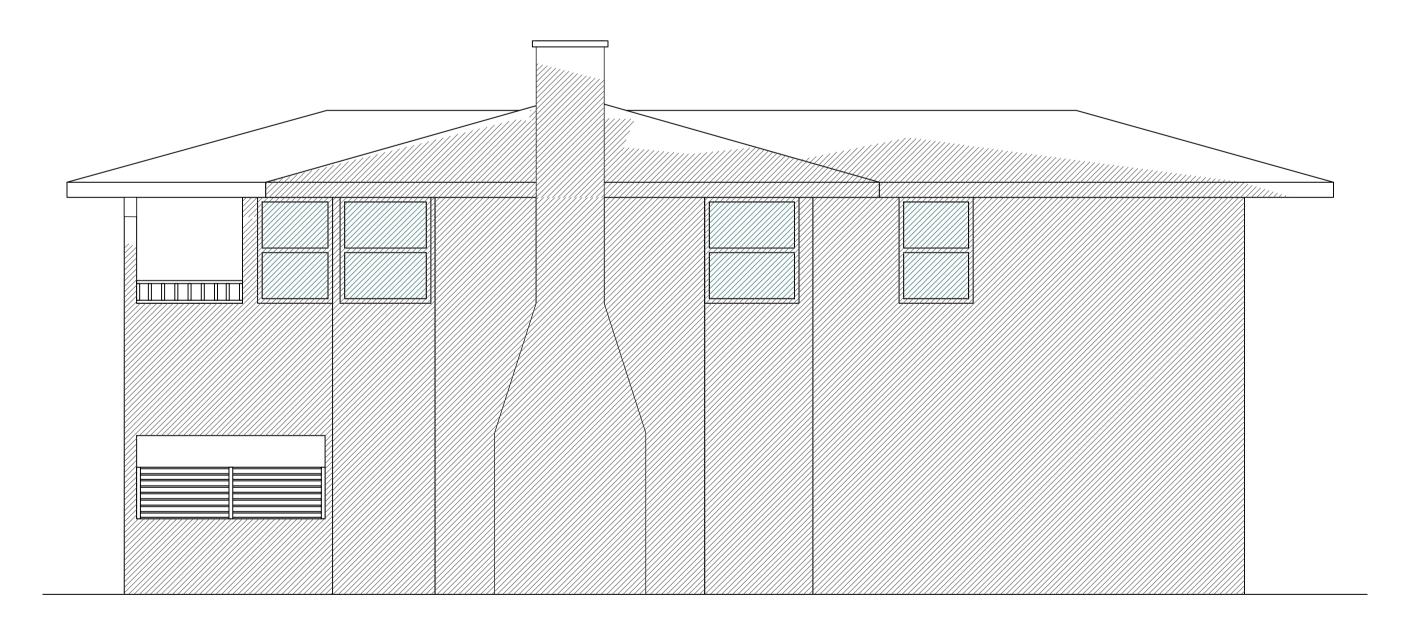

EXISTING ELEVATION SHADOWS - 29 BEACH RD. NORTHERN FACADE 3 PM - 21st June

VIRGINIA KERRIDGE ARCHITECT

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amendments: A DA ISSUE 28/05/2020 B DA ISSUE - AMENDMENT B REFERRALS
SURVEY: REFER TO THE SURVEY PLAN FOR ALL
EXISTING GROUND LEVELS.
HYDRAULIC: REFER TO THE HYDRAULIC ENGINEER'S

GENERAL NOTE:

DRAWINGS
FOR ALL HYDRAULICS WORK.

LANDSCAPE: REFER TO THE LANDSCAPE DRAWINGS
FOR ALL PROPOSED LANDSCAPING DETAILS.
DO NOT SCALE FROM THESE DRAWINGS,


COMPLIANCE
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BASIX: ALL WORK TO COMPLY WITH BASIX CERTIFICATE


SHADOW KEY EXISTING SHADOWS ADDITIONAL SHADOWS

ABBF	REVIATIONS
DB.#	DOOR AT BASEMENT LEVEL
(WB.#)	WINDOW AT BASEMENT LEVEL
SKB.#)	SKYLIGHT IN LANDSCAPE ABOVE BASEMENT
DG.#	DOOR AT GF LEVEL
SKDG.#)	SKYLIGHT ABOVE DOORS AT GF LEVEL
(WG.#)	WINDOW AT GF LEVEL
SKWG.#)	SKYLIGHT ABOVE WINDOWS AT GF LEVEL
SKG.#	SKYLIGHT ABOVE GF LEVEL
D1.#	DOOR AT FF LEVEL
(W1.#)	WINDOW AT FF LEVEL
SKF.#	SKYLIGHT ABOVE FF LEVEL
RL	RELATIVE LEVEL
FFL	FINISHED FLOOR LEVEL
FCL	FINISHED CEILING LEVEL
FW.	FIXED WINDOW
HD	HINGED DOOR
PD	PIVOT DOOR
PW.	PIVOT WINDOW
SD.	SLIDING DOOR
sw	SLIDING WINDOW
GL	EX. GROUND LEVEL

500	SLIDING WINDOW	
GL	EX. GROUND LEVEL	
SYMBOLS KEY		
E	EXISTING WALLS	
	CAVITY BRICK WALLS	
	TIMBER STUD WALLS	
(OFF-FORM CONCRETE WALLS	
,	JOINERY	
-	TIMBER FLOORBOARDS	
-	TIMBER DECK	
-	TILED FLOORS	
(GLAZING	
ľ	METAL ROOF	
-	TIMBER FACADE	
9	STEEL IN PLAN & ELEVATION	
9	STEEL IN SECTION	
(CONCRETE IN PLAN & ELEVATION	
E	BRICK FACADE	
	OUTDOOR PAVERS	
	GREEN ROOF	
P4 (CONCRETE ROOF	
	DEMOLITION	
]	DEMOLITION IN SECTION	
F	PRE-DA MEETING BUILDING LINE	

PROJECT	DATE	REVISION NUMBER:
41 & 43 BEACH ROAD COLLAROY LO1 1 DP300846 AND LOT 2 SEC 7 DP7391	28/05/2020	В
DRAWING TITLE	SCALE:	DRAWING NO.
EXISTING ELEVATION SHADOWS OVER 29 BEACH RD. NORTHERN FACADE SHADOW DIAGRAMS AT 9AM, 12PM & 3PM-21ST JUNE	1:50 at A1 & 1:100 at A3	DA 520

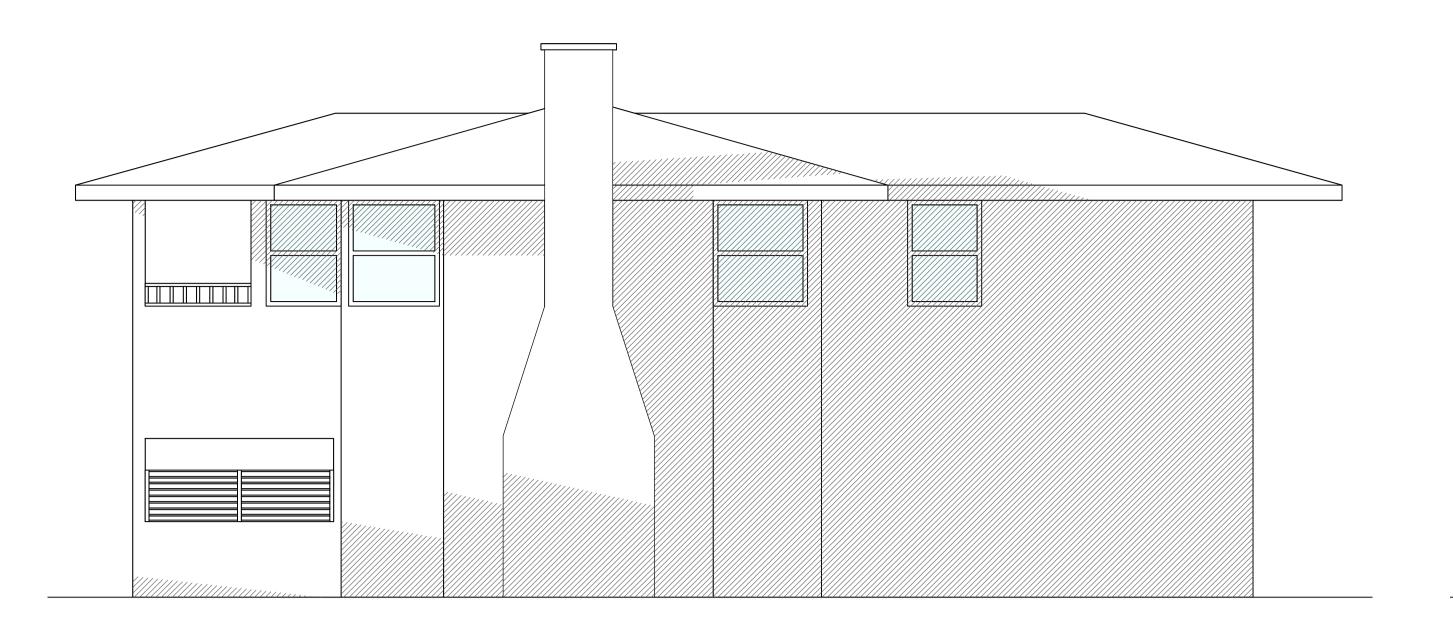


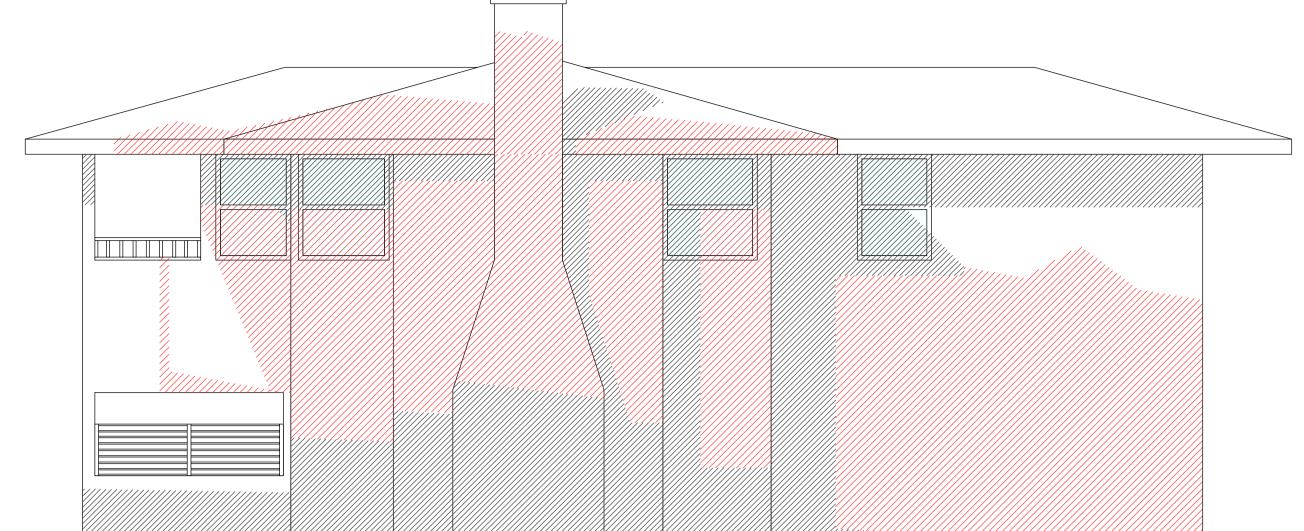

PROPOSED ELEVATION SHADOWS - 29 BEACH RD. NORTHERN FACADE **9 AM - 21st June**



PROPOSED ELEVATION SHADOWS - 29 BEACH RD. NORTHERN FACADE **12 PM - 21st June**

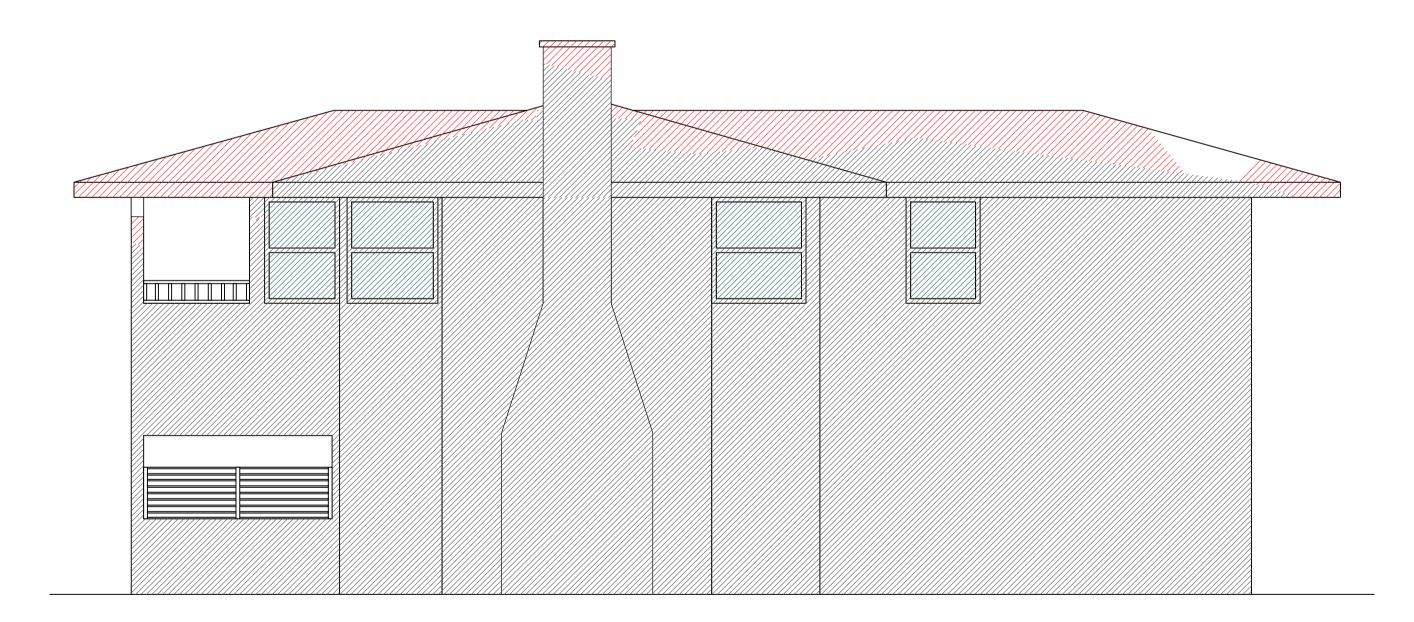

PROPOSED ELEVATION SHADOWS - 29 BEACH RD. NORTHERN FACADE 3 PM - 21st June

VIRGINIA KERRIDGE ARCHITECT

g 03 / 59 great buckingham street redfern nsw 2016 ph 02 9699 3487 ph 02 9699 8527 fax 02 9699 4626 in fo @ v k .c om .au w w w . v k .c om .au abn 12 083 17 159 NOTES: THIS IS FOR THE PURPOSE OF DEVELOPMENT APPLICATION TO COUNCIL ONLY REFER TO WRITTEN DIMENSIONS ONLY, DO NOT SCALE FROM DRAWINGS. REFER TO ARCHITECTS SPECIFICATION AND SCHEDULES IN RELATION TO THESE DRAWINGS. REFER ALL DISCREPANCIES TO THE ARCHITECT IMEDIATELY BEFORE PROCEEDING. REFER TO ALL CONSULTANTS DRAWINGS AND SPECIFICATIONS FOR ALL SPECIALIST INFORMATION AND DETAILS.

REFER TO SURVEY DRAWING FOR ALL EXISTING GROUND LEVELS.

amendments: A DA ISSUE 28/05/2020 B DA ISSUE - AMENDMENT B

FW. FIXED WINDOW PD PIVOT DOOR PW. PIVOT WINDOW SLIDING DOOR SW SLIDING WINDOW **EX. GROUND LEVEL**

SYMBOLS KEY EXISTING WALLS CAVITY BRICK WALLS TIMBER STUD WALLS OFF-FORM CONCRETE WALLS

JOINERY TIMBER FLOORBOARDS TIMBER DECK

GENERAL NOTE:

SHADOW KEY

ABBREVIATIONS

DG.# DOOR AT GF LEVEL

(WG.#) WINDOW AT GF LEVEL

D1.# DOOR AT FF LEVEL W1.# WINDOW AT FF LEVEL

SKG.# SKYLIGHT ABOVE GF LEVEL

(SKF.#) SKYLIGHT ABOVE FF LEVEL RELATIVE LEVEL FFL FINISHED FLOOR LEVEL FCL FINISHED CEILING LEVEL

DB.# DOOR AT BASEMENT LEVEL

WB.# WINDOW AT BASEMENT LEVEL

(SKB.#) SKYLIGHT IN LANDSCAPE ABOVE BASEMENT

SKDG.# SKYLIGHT ABOVE DOORS AT GF LEVEL

(SKWG.#) SKYLIGHT ABOVE WINDOWS AT GF LEVEL

REQUIREMENTS AS APPROPRIATE. **BASIX:** ALL WORK TO COMPLY WITH BASIX

COMPLIANCE
NCC: ALL WORK TO COMPLY WITH THE BCA AND AS

REFERRALS
SURVEY: REFER TO THE SURVEY PLAN FOR ALL
EXISTING GROUND LEVELS.
HYDRAULIC: REFER TO THE HYDRAULIC ENGINEER'S

DRAWINGS FOR ALL HYDRAULICS WORK. *LANDSCAPE:* REFER TO THE LANDSCAPE DRAWINGS

FOR ALL PROPOSED LANDSCAPING DETAILS. DO NOT SCALE FROM THESE DRAWINGS, WORK TO WRITTEN DIMENSIONS ONLY.

EXISTING SHADOWS

ADDITIONAL SHADOWS

GLAZING METAL ROOF TIMBER FACADE

TILED FLOORS

STEEL IN PLAN & ELEVATION STEEL IN SECTION

CONCRETE IN PLAN & ELEVATION BRICK FACADE OUTDOOR PAVERS

GREEN ROOF CONCRETE ROOF

DEMOLITION

DEMOLITION IN SECTION PRE-DA MEETING BUILDING LINE

1:50 at A1 &

1:100 at A3

41 & 43 BEACH ROAD COLLAROY


LO1 1 DP300846 AND LOT 2 SEC 7 DP7391

RD. NORTHERN FACADE

SHADOW DIAGRAMS AT 9AM, 12PM & 3PM-21ST JUNE

REVISION NUMBER:


B 28/05/2020 PROPOSED ELEVATION SHADOWS OVER 29 BEACH **DA 521**

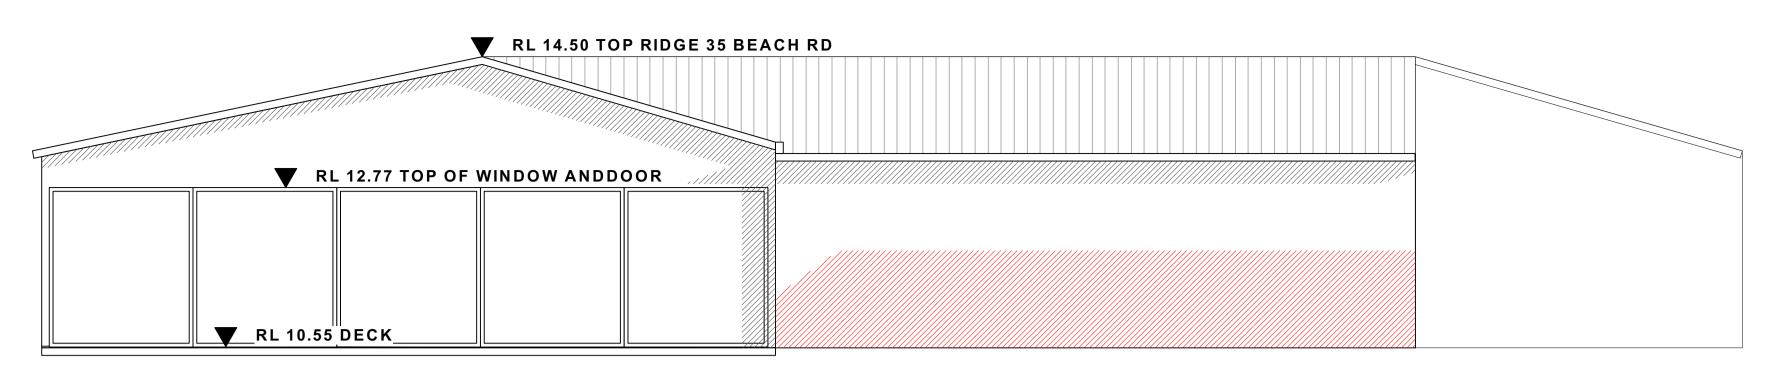

ELEVATION DRAWN WITH LIMITED SURVEY INFORMATION LEVELS SHOWN ARE TAKEN FROM THE SURVEY BY LTS LOCKLEYS
TO DO MORE SHADOW DIAGRAMS MORE DETAILED INFORMATION IS NEEDED


PROPOSED ELEVATION SHADOWS - 35 BEACH RD. EASTERN FACADE 9 AM - 21st June


SHADOW DIAGRAMS SHOW THAT THERE IS NO OVERSHADOWING ON 35 BEACH ROAD FROM THE PROPOSED DEVELOPMENT **EXCEPT FOR 9AM ON 21ST JUNE**

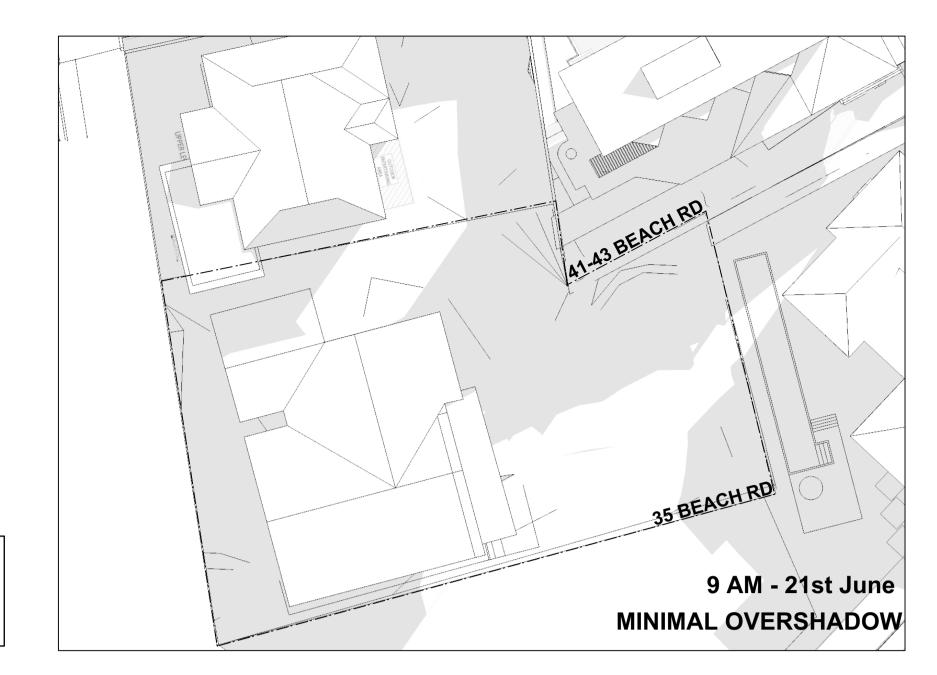





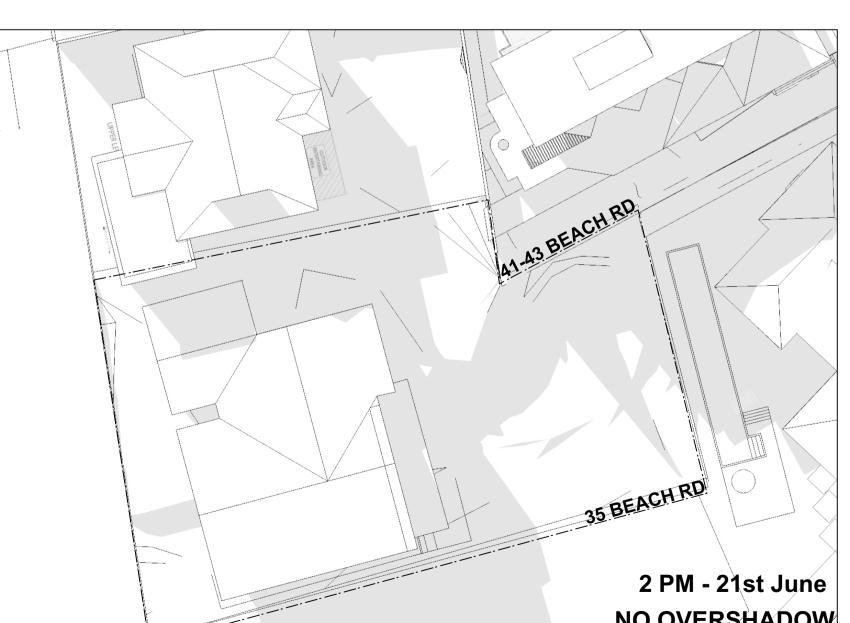

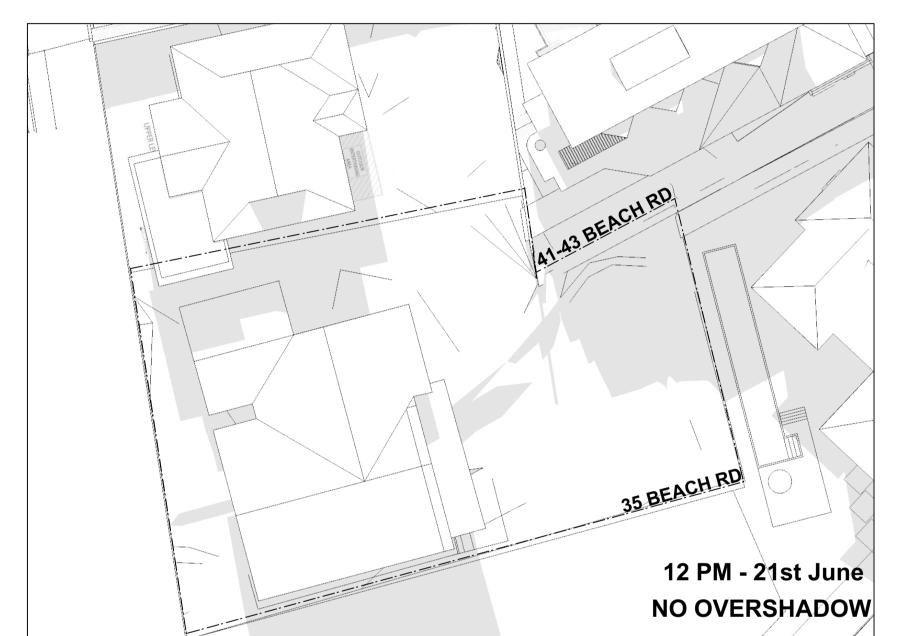





GENERAL NOTE: COMPLIANCE
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BASIX: ALL WORK TO COMPLY WITH BASIX
CERTIFICATE

REFERRALS
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LANDSCAPE: REFER TO THE LANDSCAPE DRAWINGS
FOR ALL PROPOSED LANDSCAPING DETAILS.
DO NOT SCALE FROM THESE DRAWINGS,
WORK TO WRITTEN DIMENSIONS ONLY.

SHAI	DOW KEY	
	EXISTING SHADOWS	
	ADDITIONAL SHADOWS	

ABB	REVIATIONS
DB.#	DOOR AT BASEMENT LEVEL
(WB.#)	WINDOW AT BASEMENT LEVEL
SKB.#	SKYLIGHT IN LANDSCAPE ABOVE BASEMEN
DG.#	DOOR AT GF LEVEL
SKDG.#)	SKYLIGHT ABOVE DOORS AT GF LEVEL
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FFL	FINISHED FLOOR LEVEL
FCL	FINISHED CEILING LEVEL
FW.	FIXED WINDOW
HD	HINGED DOOR
PD	PIVOT DOOR
PW.	PIVOT WINDOW
SD.	SLIDING DOOR
sw	SLIDING WINDOW
GL	EX. GROUND LEVEL

GL	EX. GROUND LEVEL
SYN	IBOLS KEY
	EXISTING WALLS
	CAVITY BRICK WALLS
	TIMBER STUD WALLS
	OFF-FORM CONCRETE WALLS
	JOINERY
	TIMBER FLOORBOARDS
	TIMBER DECK
	TILED FLOORS
	GLAZING
	METAL ROOF
	TIMBER FACADE
	STEEL IN PLAN & ELEVATION
	STEEL IN SECTION
	CONCRETE IN PLAN & ELEVATION
	BRICK FACADE
	OUTDOOR PAVERS
100	GREEN ROOF
D 4 10	CONCRETE ROOF

VIRGINIA KERRIDGE ARCHITECT

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1 PM - 21st June

NO OVERSHADOW

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REFER TO SURVEY DRAWING FOR ALL EXISTING GROUND LEVELS.

amendments: A DA ISSUE - AMENDMENT B 28/05/2020

41 & 43 BEACH ROAD COLLAROY LO1 1 DP300846 AND LOT 2 SEC 7 DP7391

SHADOW DIAGRAM AT 9AM -21ST JUNE

REVISION NUMBER: 28/05/2020 PROPOSED ELEVATION SHADOWS OVER 35 BEACH RD. EASTERN FACADE **DA 522**

1:50 at A1 & 1:100 at A3

DEMOLITION

DEMOLITION IN SECTION

PRE-DA MEETING BUILDING LINE









CALCULATIONS SHOW THAT AT LEAST 50% OF PRIVATE OPEN SPACE RECEIVE A MINIMUM OF 3 HOURS SUNLIGHT BETWEEN 9AM AND 3PM ON JUNE 21.

ALLOWED COMPLIES

PROPOSED

1536.5 sqm

71.6 sqm

407sqm

284 sqm

0.45:1

0.496:1

725.1 sqm= 47.2%

GENERAL NOTE:

CERTIFICATE

DRAWINGS

SHADOW KEY

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REQUIREMENTS AS APPROPRIATE.

SURVEY: REFER TO THE SURVEY PLAN FOR ALL EXISTING GROUND LEVELS.
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FOR ALL HYDRAULICS WORK.

LANDSCAPE: REFER TO THE LANDSCAPE DRAWINGS

FOR ALL PROPOSED LANDSCAPING DETAILS.
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> EXISTING SHADOWS ADDITIONAL SHADOWS

BASIX: ALL WORK TO COMPLY WITH BASIX

AREA CALCULATIONS

GROUND FLOOR GFA

TOTAL ABOVE GROUND GFA

TOTAL ABOVE GROUND FSR

LANDSCAPE OPEN SPACE

TOTAL FSR (including basement)

TOTAL GFA (including basement) 762.6

FIRST FLOOR GFA

SITE AREA

BASEMENT GFA


29 BEACH ROAD	
PRIVATE OPEN SPACE	% OF TOTAL
WITH SOLAR ACCESS	PRIVATE OPEN
(21 JUNE)	SPACE
9:00 am	55.9
10:00 am	54.9
11:00 am	54.8
12:00 pm	61.0
1:00 pm	61.6
2:00 pm	55.3
3:00 pm	28.0

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REFER TO SURVEY DRAWING FOR ALL EXISTING GROUND LEVELS.



amendments:

28/05/2020 A DA ISSUE - AMENDMENT B

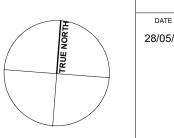41 & 43 BEACH ROAD COLLAROY LO1 1 DP300846 AND LOT 2 DP7391

29 BEACH ROAD

SHADOW DIAGRAMS


28/05/2020

PRIVATE OPEN SPACE SOLAR ACCESS

DA 523 1:200 at A1 & 1:400 at A3





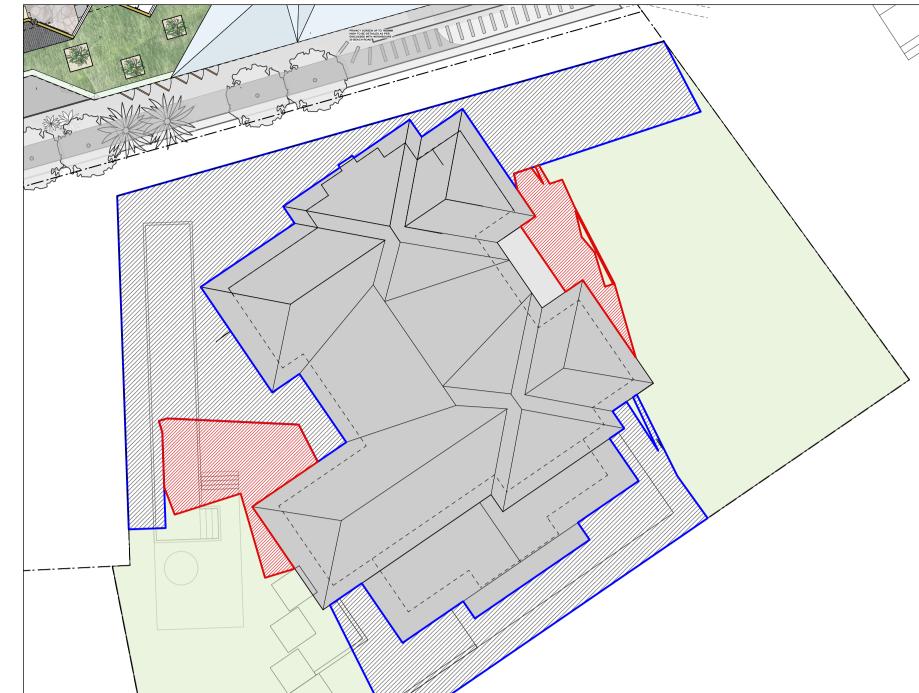

AREA CALCULATIONS	PROPOSED	ALLOWED	COMPLIES
SITE AREA	1536.5 sqm		
BASEMENT GFA	71.6 sqm		YES
GROUND FLOOR GFA	407sqm		YES
FIRST FLOOR GFA	284 sqm		YES
TOTAL ABOVE GROUND GFA	691 sqm		YES
TOTAL ABOVE GROUND FSR	0.45:1	0.5:1	YES
TOTAL GFA (including basement)	762.6		
TOTAL FSR (including basement)	0.496:1	0.5:1	YES
LANDSCAPE OPEN SPACE	725.1 sqm= 47.2%	MIN. 40%	YES
ı			

GENERAL NOTE: COMPLIANCE NCC: ALL WORK TO COMPLY WITH THE BCA AND AS REQUIREMENTS AS APPROPRIATE. BASIX: ALL WORK TO COMPLY WITH BASIX CERTIFICATE

SURVEY: REFER TO THE SURVEY PLAN FOR ALL EXISTING GROUND LEVELS.
HYDRAULIC: REFER TO THE HYDRAULIC ENGINEER'S **DRAWINGS**

FOR ALL HYDRAULICS WORK.

LANDSCAPE: REFER TO THE LANDSCAPE DRAWINGS FOR ALL PROPOSED LANDSCAPING DETAILS.
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SHADOW KEY

EXISTING SHADOWS

ADDITIONAL SHADOWS

3P 21st June Scale: 1:200


CALCULATIONS SHOW THAT AT LEAST 50% OF PRIVATE OPEN SPACE RECEIVE A MINIMUM OF 3 HOURS SUNLIGHT BETWEEN 9AM AND 3PM ON JUNE 21.

29 BEACH ROAD	
PRIVATE OPEN SPACE	% OF TOTAL
WITH SOLAR ACCESS	PRIVATE OPEN
(21 JUNE)	SPACE
9:00 am	55.9
10:00 am	54.9
11:00 am	54.8
12:00 pm	61.0
1:00 pm	61.6
2:00 pm	55.3
3:00 pm	28.0

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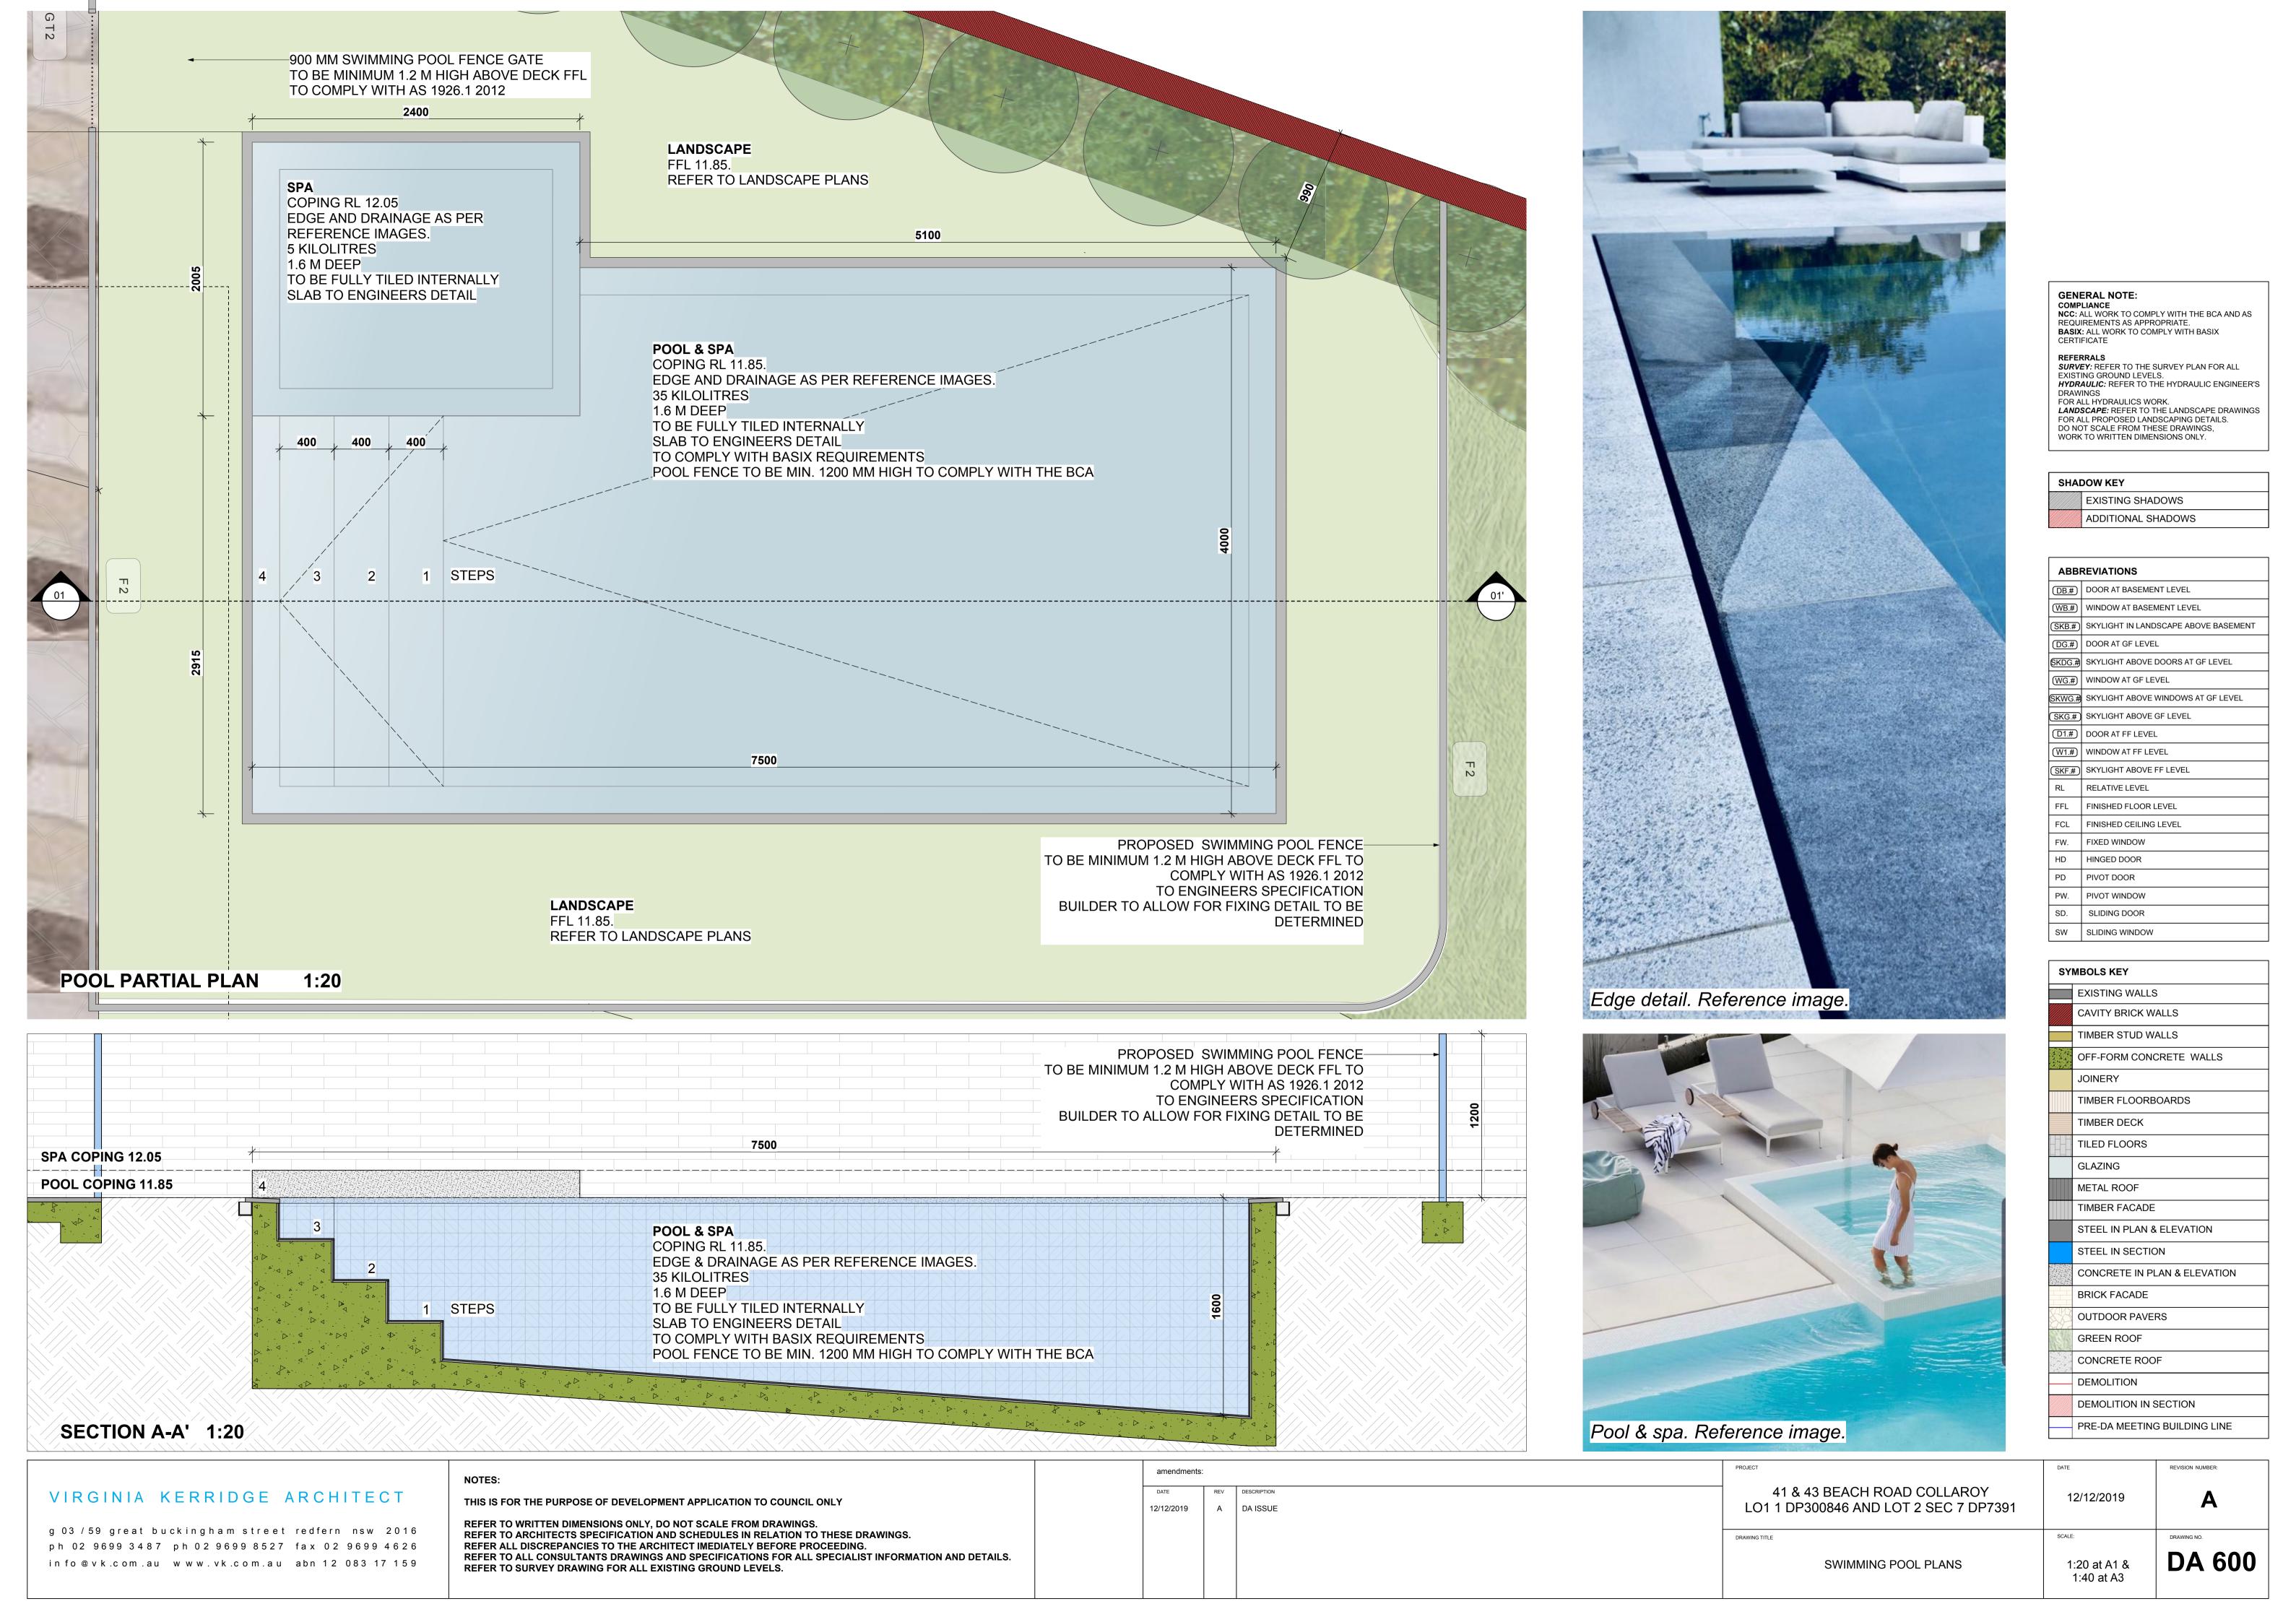
28/05/2020 A DA ISSUE - AMENDMENT B


41 & 43 BEACH ROAD COLLAROY LO1 1 DP300846 AND LOT 2 DP7391 28/05/2020


29 BEACH ROAD 1:200 at A1 & PRIVATE OPEN SPACE SOLAR ACCESS 1:400 at A3 SHADOW DIAGRAMS

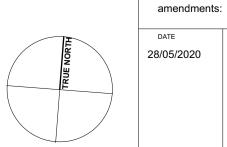
DA 524


REVISION NUMBER:




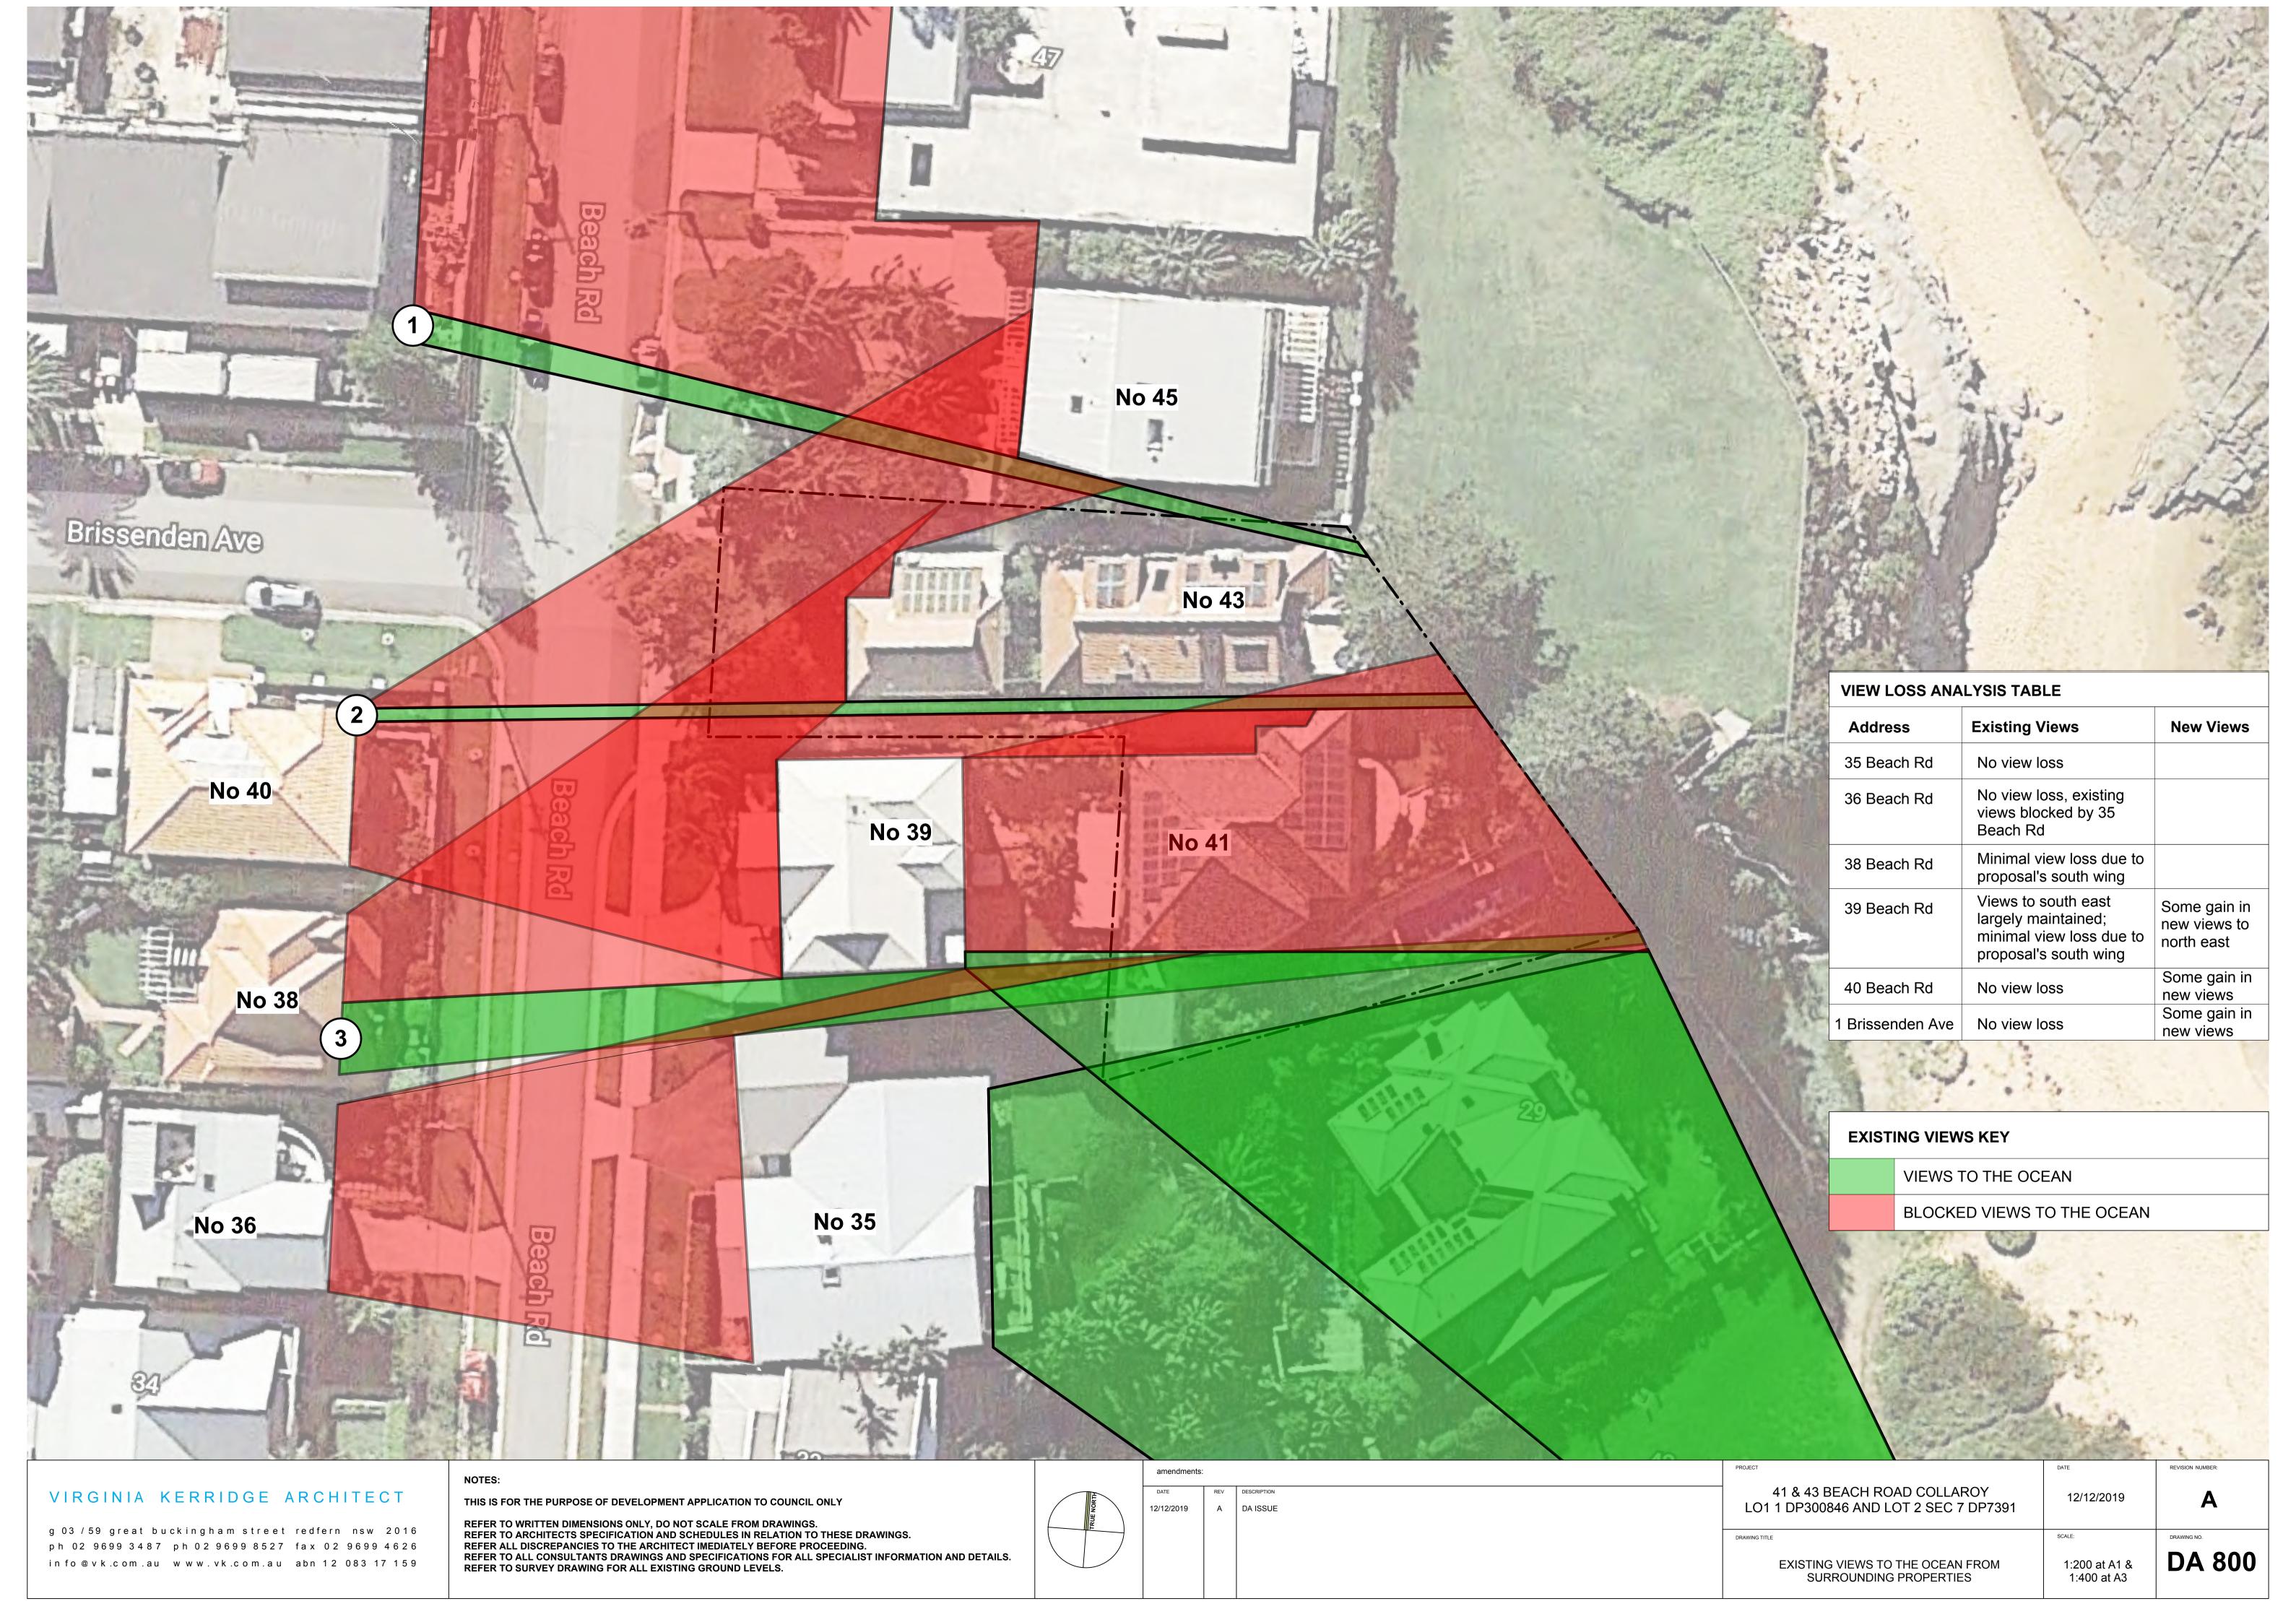

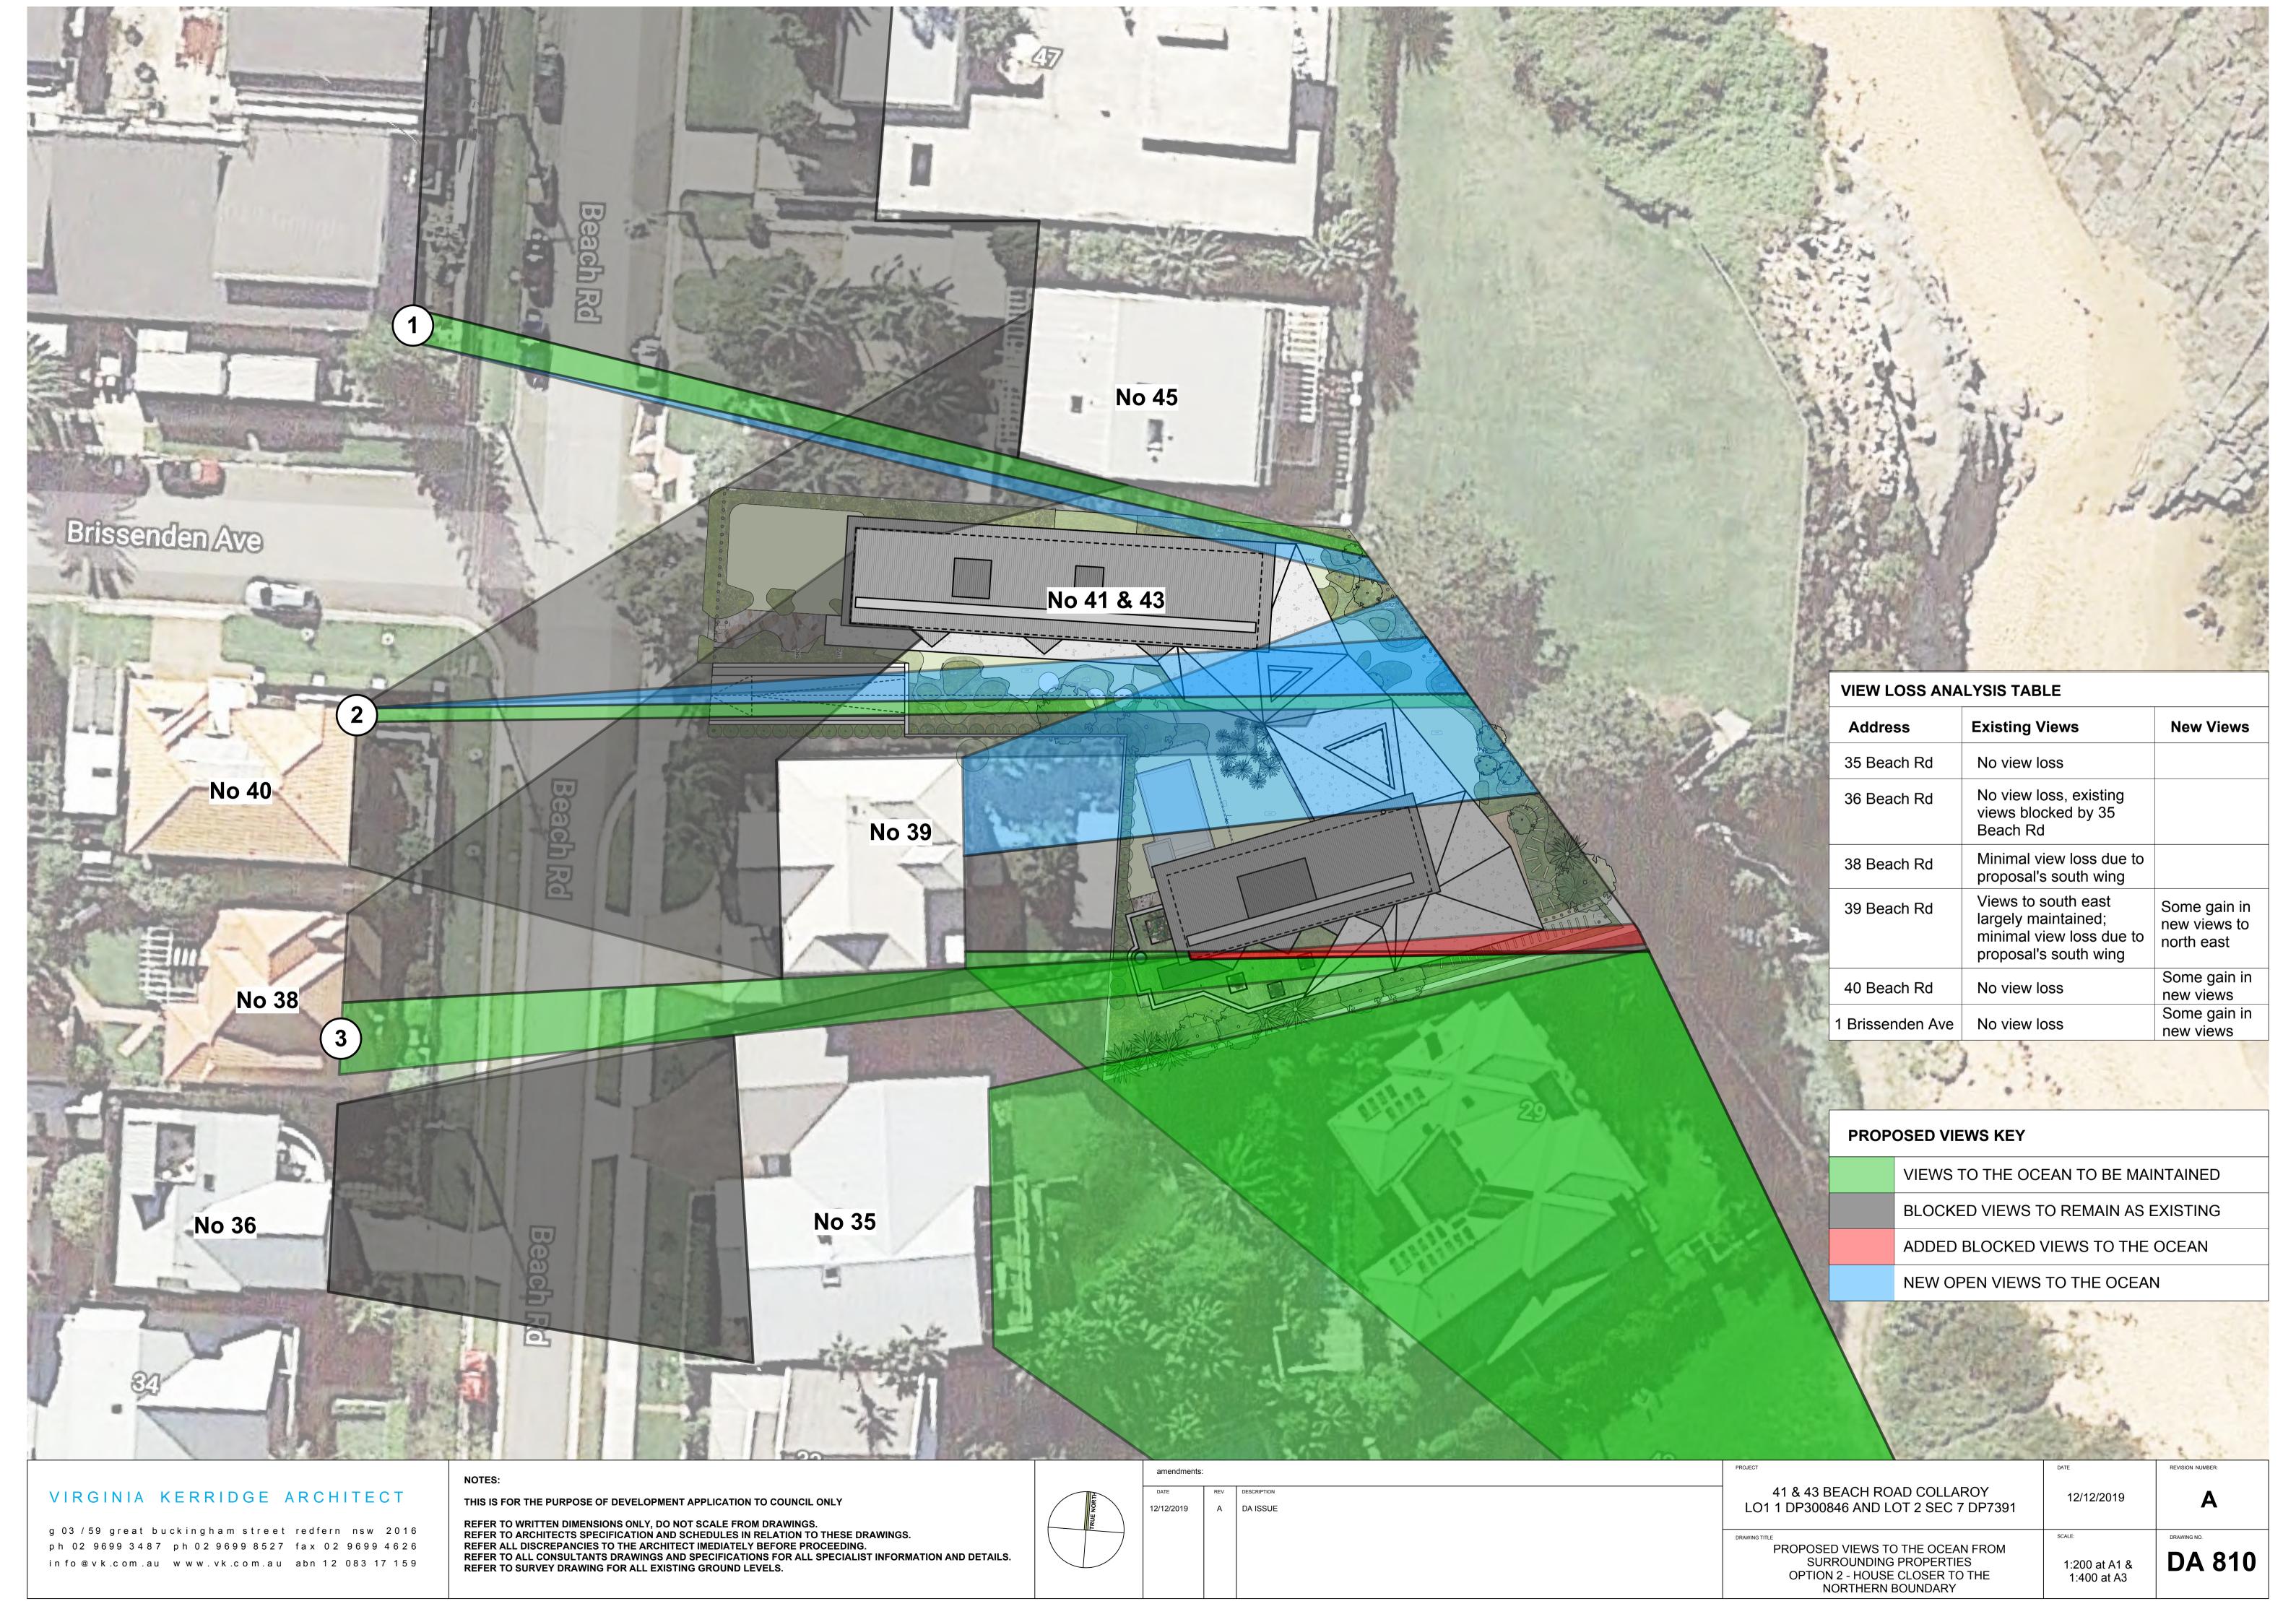

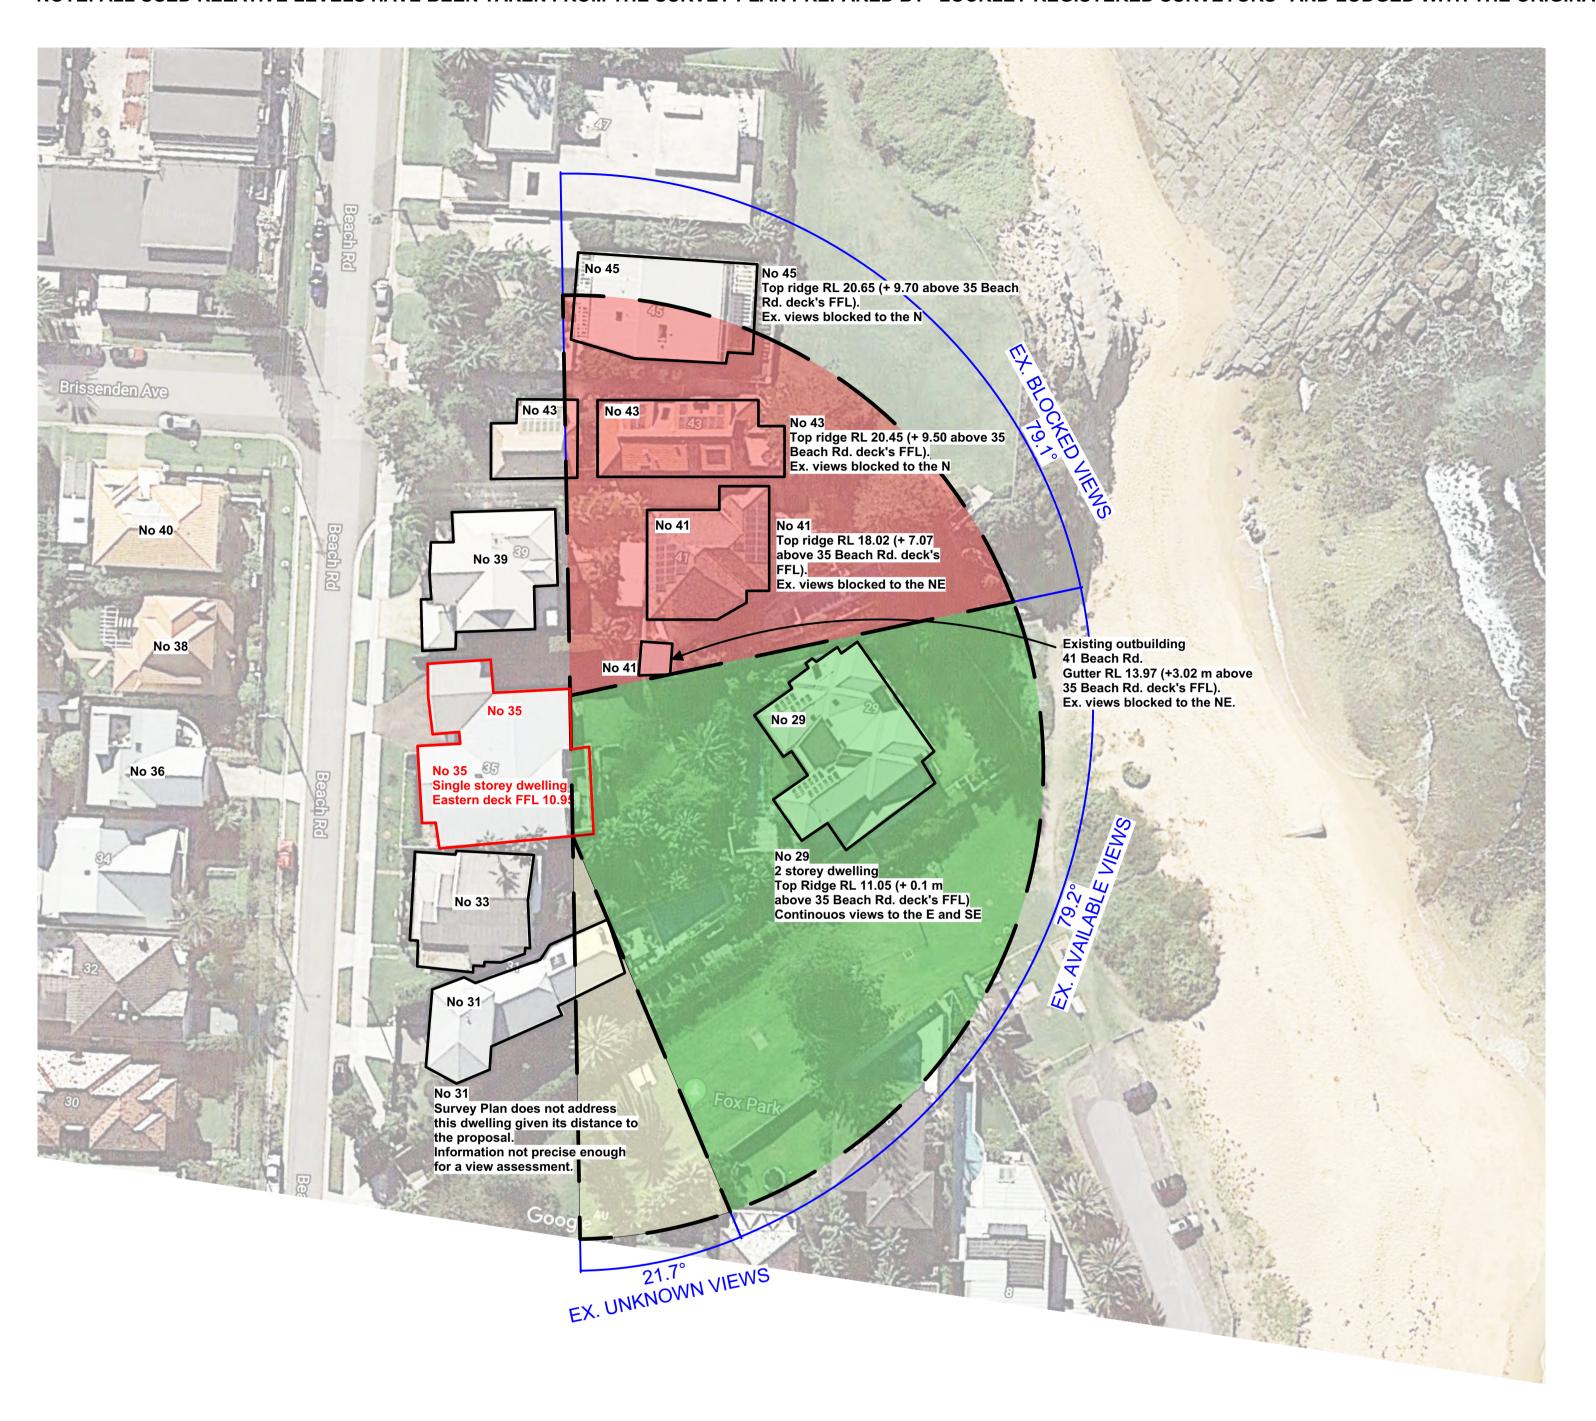

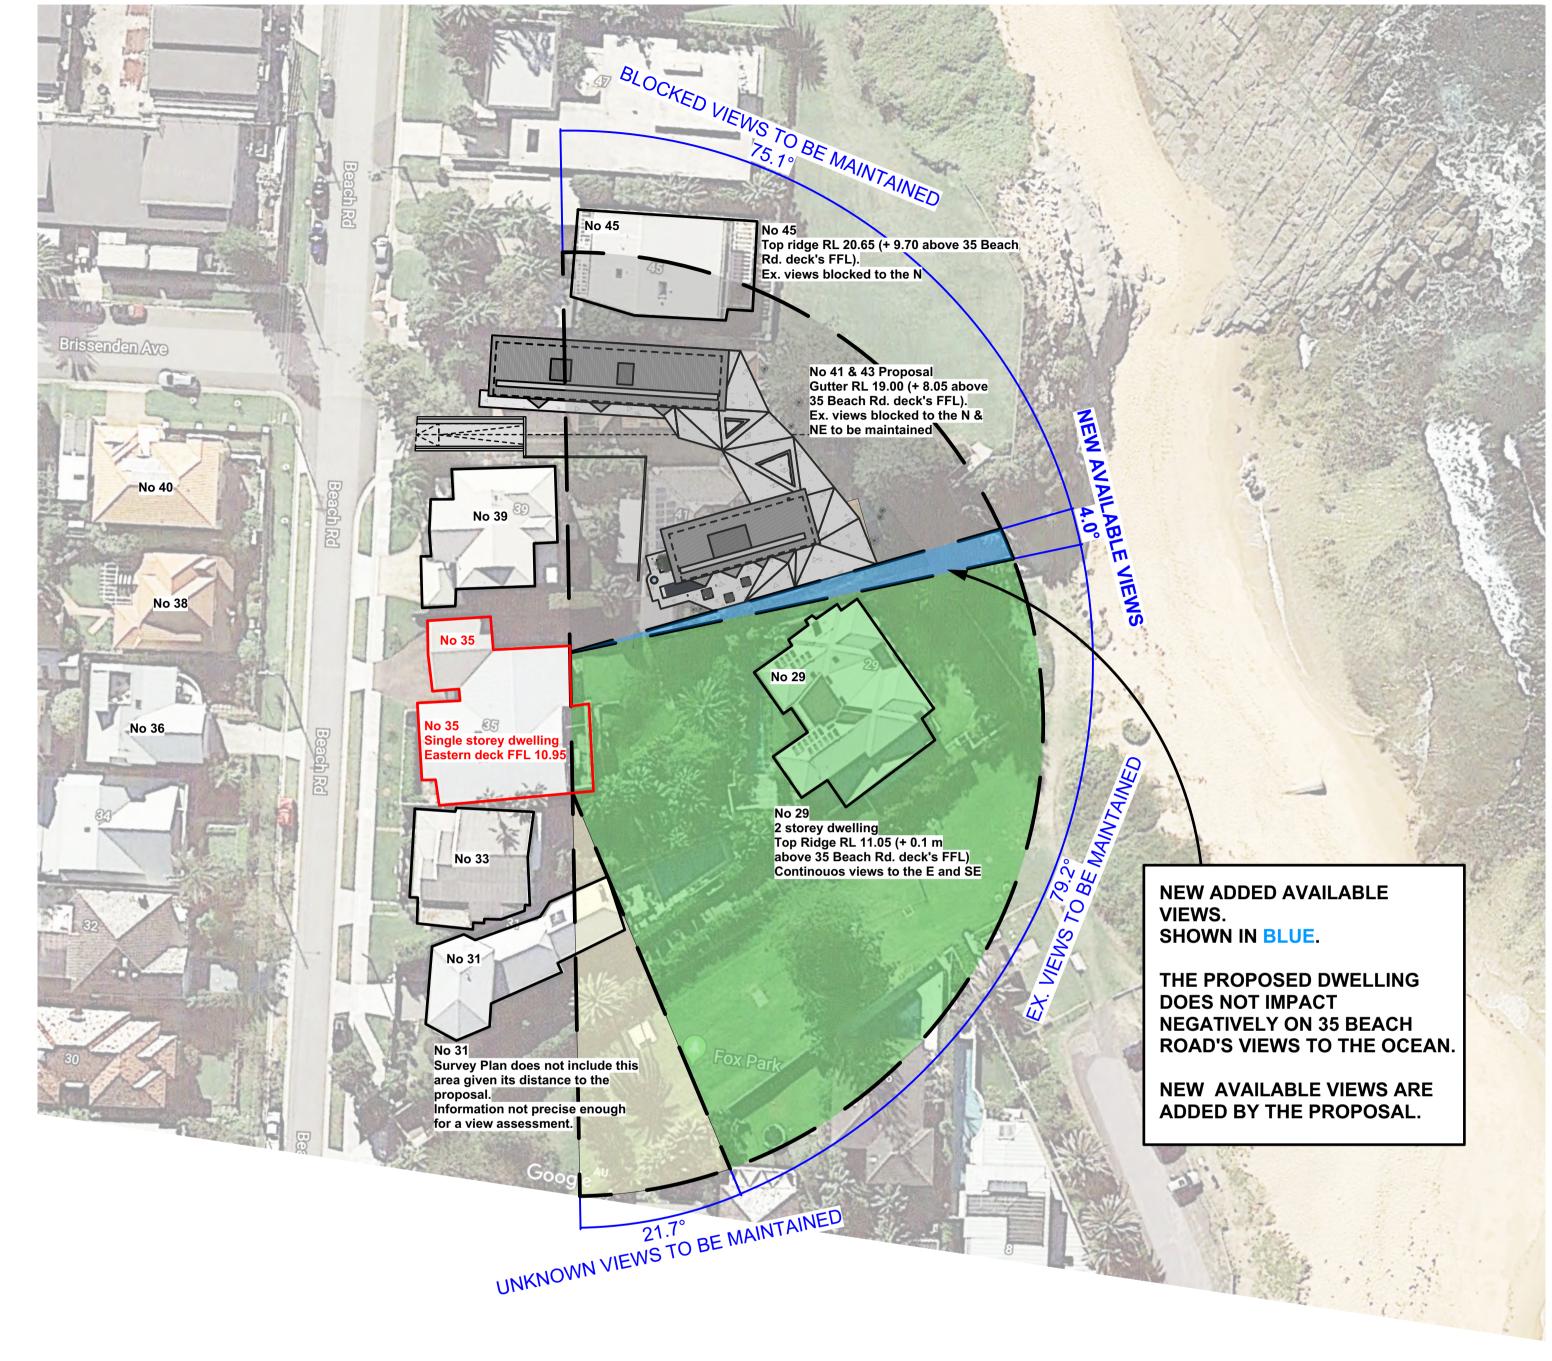

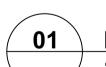

EX. VIEWS TO THE OCEAN ANALYSIS. 35 BEACH ROAD 1/500 AT A1

EXISTING VIEWS KEY			
	EX. VIEWS TO THE OCEAN		
	UNKNOWN VIEWS. LACK OF PRECISE INFORMATION.		
	EX. BLOCKED VIEWS TO THE OCEAN		

PROPOSED VIEWS TO THE OCEAN ANALYSIS. 35 BEACH ROAD 1/500 AT A1

PR	PROPOSED VIEWS KEY			
	EX. VIEWS TO THE OCEAN TO BE MAINTAINED			
	UNKNOWN VIEWS TO BE MAINTAINED. LACK OF PRECISE INFORMATION.			
	EX. BLOCKED VIEWS TO THE OCEAN TO BE MAINTAINED			
	NEW ADDED OPEN VIEWS TO THE OCEAN			

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	amendments:		
	DATE		
)	30/03/2020		

		PROJECT	DATE	REVISION NUMBER:
REV A	DA ISSUE: EXTRA INFORMATION REQUIRED BY COUNCIL	41 & 43 BEACH ROAD COLLAROY LO1 1 DP300846 AND LOT 2 SEC 7 DP7391	30/03/2020	A
		DRAWING TITLE	SCALE:	DRAWING NO.
		EXISTING & PROPOSED VIEWS TO THE OCEAN ANALYSIS 35 BEACH ROAD, COLLAROY	1:500 at A1	DA 820



ORIGINAL PHOTO TAKEN BY NICK JURADOWITCH. TOWNPLANNER. DIRECTOR OF INGHAM PLANNING PHOTO TAKEN ON 25 JUNE 2020

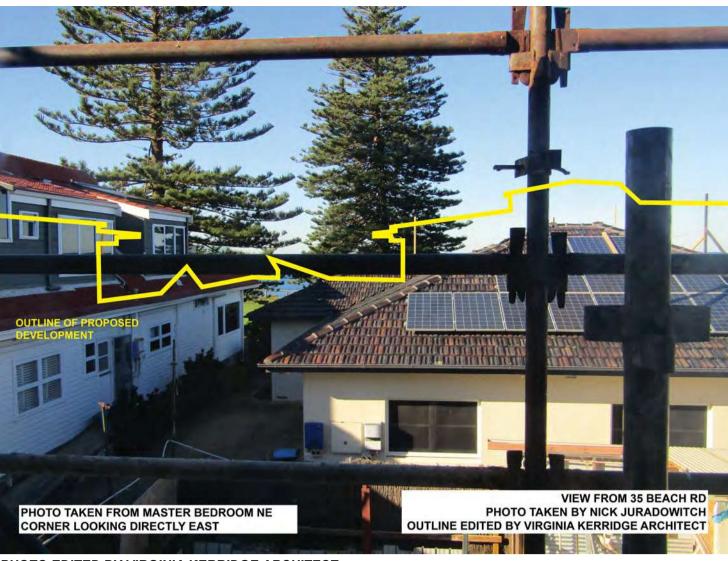
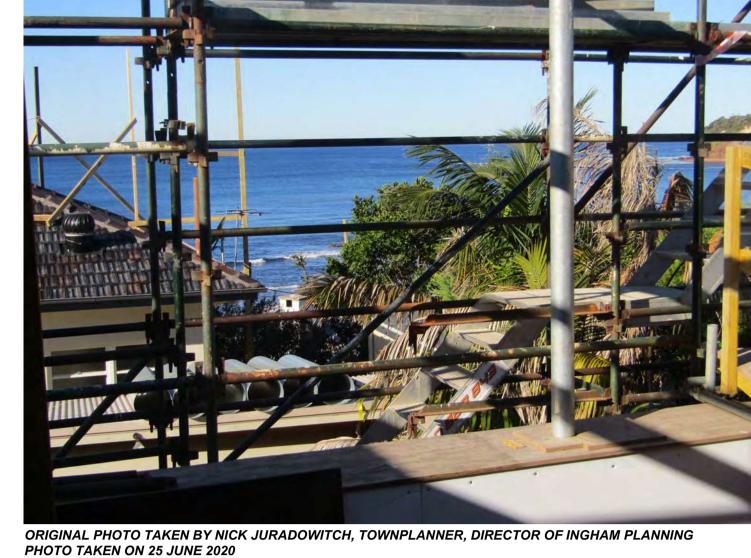


PHOTO EDITED BY VIRGINIA KERRIDGE ARCHITECT. OUTLINE OF PROPOSED DEVELOPMENT SHOWN AS A YELLOW LINE.



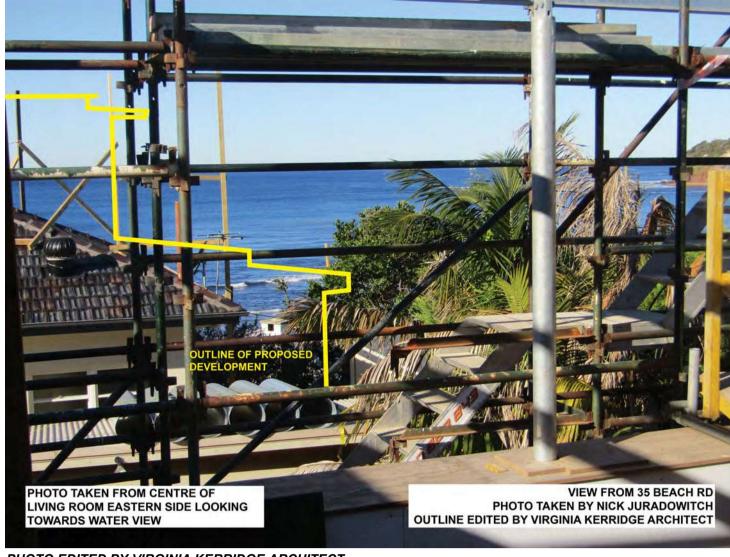



PHOTO EDITED BY VIRGINIA KERRIDGE ARCHITECT.
OUTLINE OF PROPOSED DEVELOPMENT SHOWN AS A YELLOW LINE.




ORIGINAL PHOTO TAKEN BY NICK JURADOWITCH. TOWNPLANNER. DIRECTOR OF INGHAM PLANNING PHOTO TAKEN ON 25 JUNE 2020



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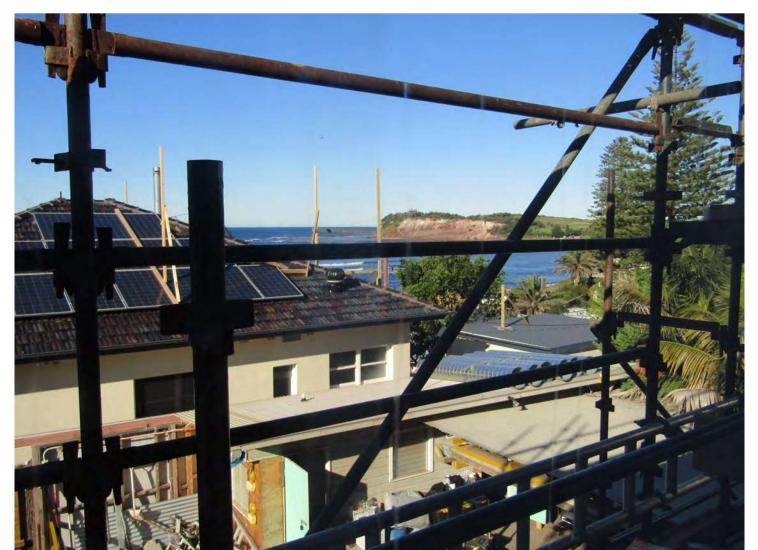
OUTLINE OF PROPOSED DEVELOPMENT SHOWN AS A YELLOW LINE.

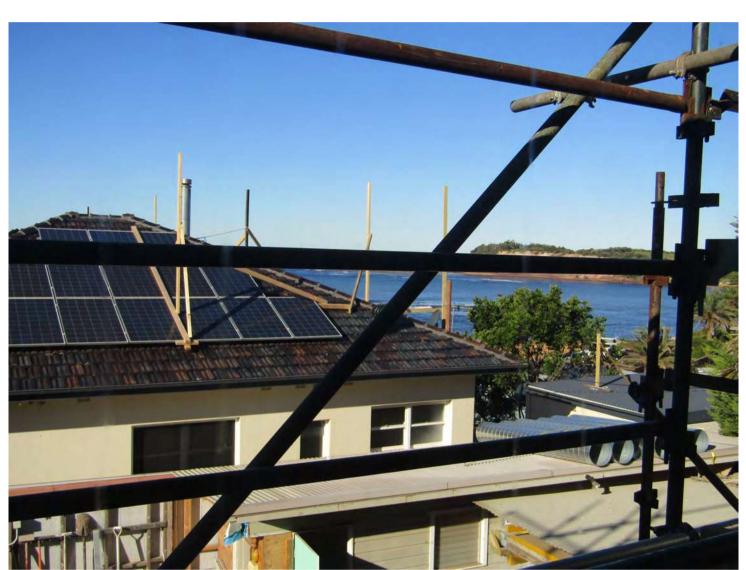

ORIGINAL PHOTO TAKEN BY NICK JURADOWITCH, TOWNPLANNER, DIRECTOR OF INGHAM PLANNING PHOTO TAKEN ON 25 JUNE 2020

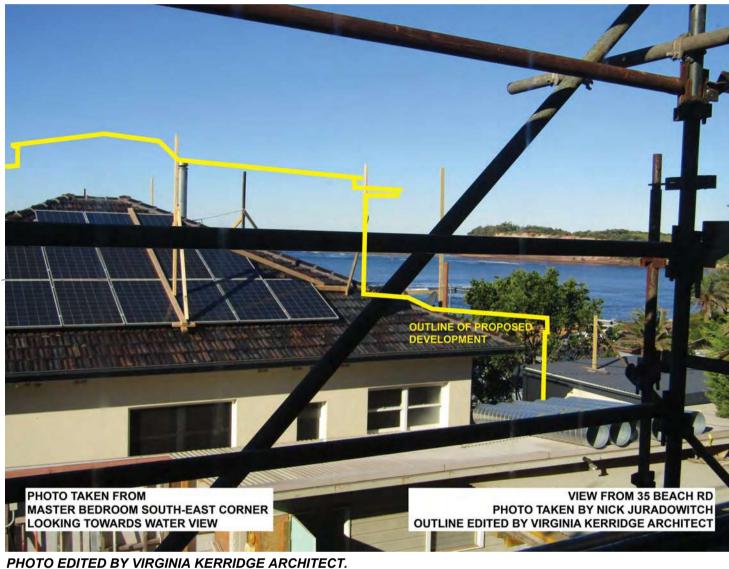

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VIRGINIA KERRIDGE ARCHITECT

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REFER TO SURVEY DRAWING FOR ALL EXISTING GROUND LEVELS.

amendments:

C DA ISSUE C - ADDITIONAL INFORMATION

41 & 43 BEACH ROAD COLLAROY LO1 1 DP300846 AND LOT 2 SEC 7 DP7391

03/07/2020

REVISION NUMBER:

VIEW LOSS ANALYSIS FROM **DA 825** N/A 39 BEACH ROAD, COLLAROY



41 & 43 BEACH ROAD COLLAROY

LANDSCAPE DOCUMENTATION

DEVELOPMENT APPLICATION

DRAWING REGISTER

Dwg No. Drawing Title		Scale	Size	
General				
LA-DA-00	Cover Page & Drawing Schedule	N/A	A1	
LA-DA-01	Landscape Schedules & Notes	N/A	A 1	
LA-DA-02	Landscape Statement & Precedents	N/A	A1	
Plans				
LA-DA-03	Tree Removal Plan	1:100	A1	
LA-DA-04	Landscape Plan - Ground Floor	1:100	A 1	
LA-DA-05	Landscape Plan - Basement	1:100	A 1	
LA-DA-06	Landscape Plan - Roof	1:100	A 1	
Sections				
LA-DA-07	Landscape Sections 1	1:50	A1	
LA-DA-08	Landscape Sections 2	1:50	A1	
Palettes				
LA-DA-09	Planting Palette	N/A	A1	

SITE RENDER



LOCATION PLAN





Rev	Amendment	Date	Ву
Α	Draft DA for Co-ordination	12.12.19	KR
В	DA	18.12.19	KR

IMPORTANT NOTES:	
Do not scale from drawings	
All discrepancies to be brought to the attention of the Project Landscape Architect	
Larger scale drawings and written dimensions take preference. All dimensions in mm unless otherwise stated.	
All tree dimensions and RLs in metres.	_
Use figured dimensions only.	
Ose righted dimensions on site before the commencement of any works.	
Contractors shall locate and protect all services prior to construction.	- 1
All work shall be carried out in accordance with ASA, BCA and Local Government Regulations.	
Structural Details shall be subject to Engineer's Specifications.	
Drainage & Water Feature Details shall be subject to Hydraulic Engineer's Specifications.	
All work shall be carried out in a professional manner by Qualified Tradesman according to Landscape Drawings and	
Engineer's Specifications.	
No responsibility will be taken by 360 Degrees Landscape Architects Pty Ltd for any variations in design, construction	- 1 - 3
method, materials specified, and general specifications without permission from the Project Engineer or Landscape	
Architect	
	- 1
This Drawing is copyright to 360 Degrees Landscape Architects Pty Ltd.	

	CLIENT Jennifer & Russell Staley	CHECKED GD
	ARCHITECT Virginia Kerridge Architect	DRAWN KR
nd pri	SCALE N/A @ A1	ISSUED FOR DA

DWG. TITLE
Cover Page & Drawing Schedule

PROJECT
41 & 43 BEACH ROAD COLLAROY





LANDSCAPE STATEMENT

The proposed DA Landscape Drawings for 41 - 43 Beach Road Collaroy have been designed and set out in accordance with;

- The Client's Brief
- The Northern Beaches Council (Warringah DCP Documents)
- Architectural plans by Virginia Kerridge Architects

As part of a collaborative design team, 360 Degrees Landscape Architects propose to support clients requirements, architectural function and character through considered and refined landscape design, while also responding to the Northern Beaches Council (Warringah) Development Control Guidelines and the residences context within the coastal headland and beachfront Reserve of Stanley Florence Twight Reserve.

The proposed landscape increases the sites existing landscape offerings while maintaining deep soil zones for all proposed tree and palms to provide useable and attractive garden spaces for the residents.

The ground level landscape consists of three primary garden zones;

- Entry garden & Kids freeplay area
- Protected central pool garden and outdoor dining space
- Coastal bushland garden with pocketed lawn spaces to address Stanley & Florence Twight Reserve.


Level 1 Roof Gardens will provide screening and privacy planting along the sites Northern boundary, while the green roof to the Southern wing will provide a green outlook for the Western neighbours will maintaining view lines.

The gardens will consist of primarily native plantings complemented with hardy exotic species suitable to the sites frontline coastal position.

Native Tree and Palm plantings will frame views lines and settle the building within the natural bushland reserve landscape.

LANDSCAPE PRECEDENTS


Landscape Character

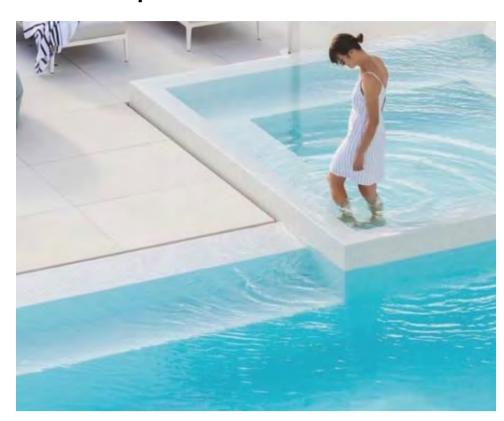

Protected Central Garden with Pool, Spa & Entertaining Area



Pocketed Lawn spaces ensconced in garden

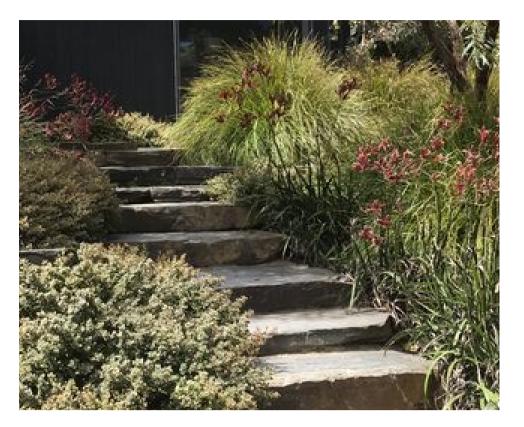

Connection to beach & surrounding coastal landscape character

Planting Character



Native Coastal planting palette which extends the surrounding reserve and coastal landscape




Intergration of hardy low water succulents suitable for coastal landscapes



Feature plants to compliment Architecture

Materiality

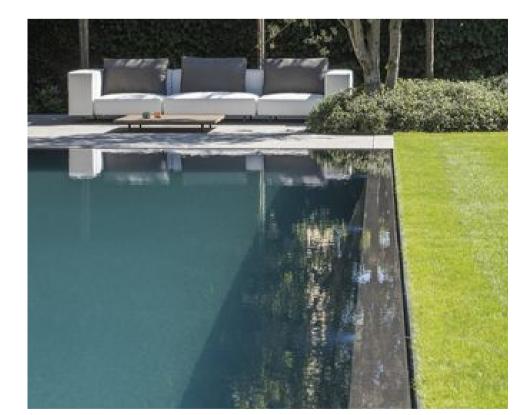

Granite pool tiling with flush wet edge coping



Entry pathway - Mixed stone crazy pave




Decking & Crushed granite informal pathways

IMPORTANT NOTES:	- 1
Do not scale from drawings All discrepancies to be brought to the attention of the Project Landscape Architect Larger scale drawings and written dimensions take preference. All dimensions in mm unless otherwise stated.	١,
All free dimensions and RLs in metres. Las figured dimensions of the provided in the service prior to construction. Contractors shall locate and protect all services prior to construction. Contractors shall locate and protect all services prior to construction. Structural Details shall be subject to Engineer's Specifications. Structural Details shall be subject to Engineer's Specifications. Dirainage & Watter Feature Details shall be subject to Hydration Engineer's Specifications.	,
All work shall be carried out in a professional manner by Qualified Tradesman according to Landscape Drawings and Engineer's Specifications. No responsibility will be taken by 360 Degrees Landscape Architects Pty Ltd for any variations in design, construction method, materials specified, and general specifications without permission from the Project Engineer or Landscape Architect. This Drawing is copyright to 360 Degrees Landscape Architects Pty Ltd.	:

Jennifer & Russell Staley	CHECKED GD
ARCHITECT Virginia Kerridge Architect	DRAWN KR
SCALE N/A @ A1	ISSUED FOR DA


DWG. TITLE Landscape Statement & Precedent Images	
PROJECT 41 & 43 BEACH ROAD COLLAROY	




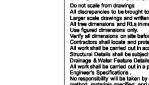

ARCHITECT
Virginia Kerridge Architect ISSUED FOR 1:50 @ A1

PROJECT
41 & 43 BEACH ROAD COLLAROY

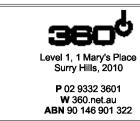

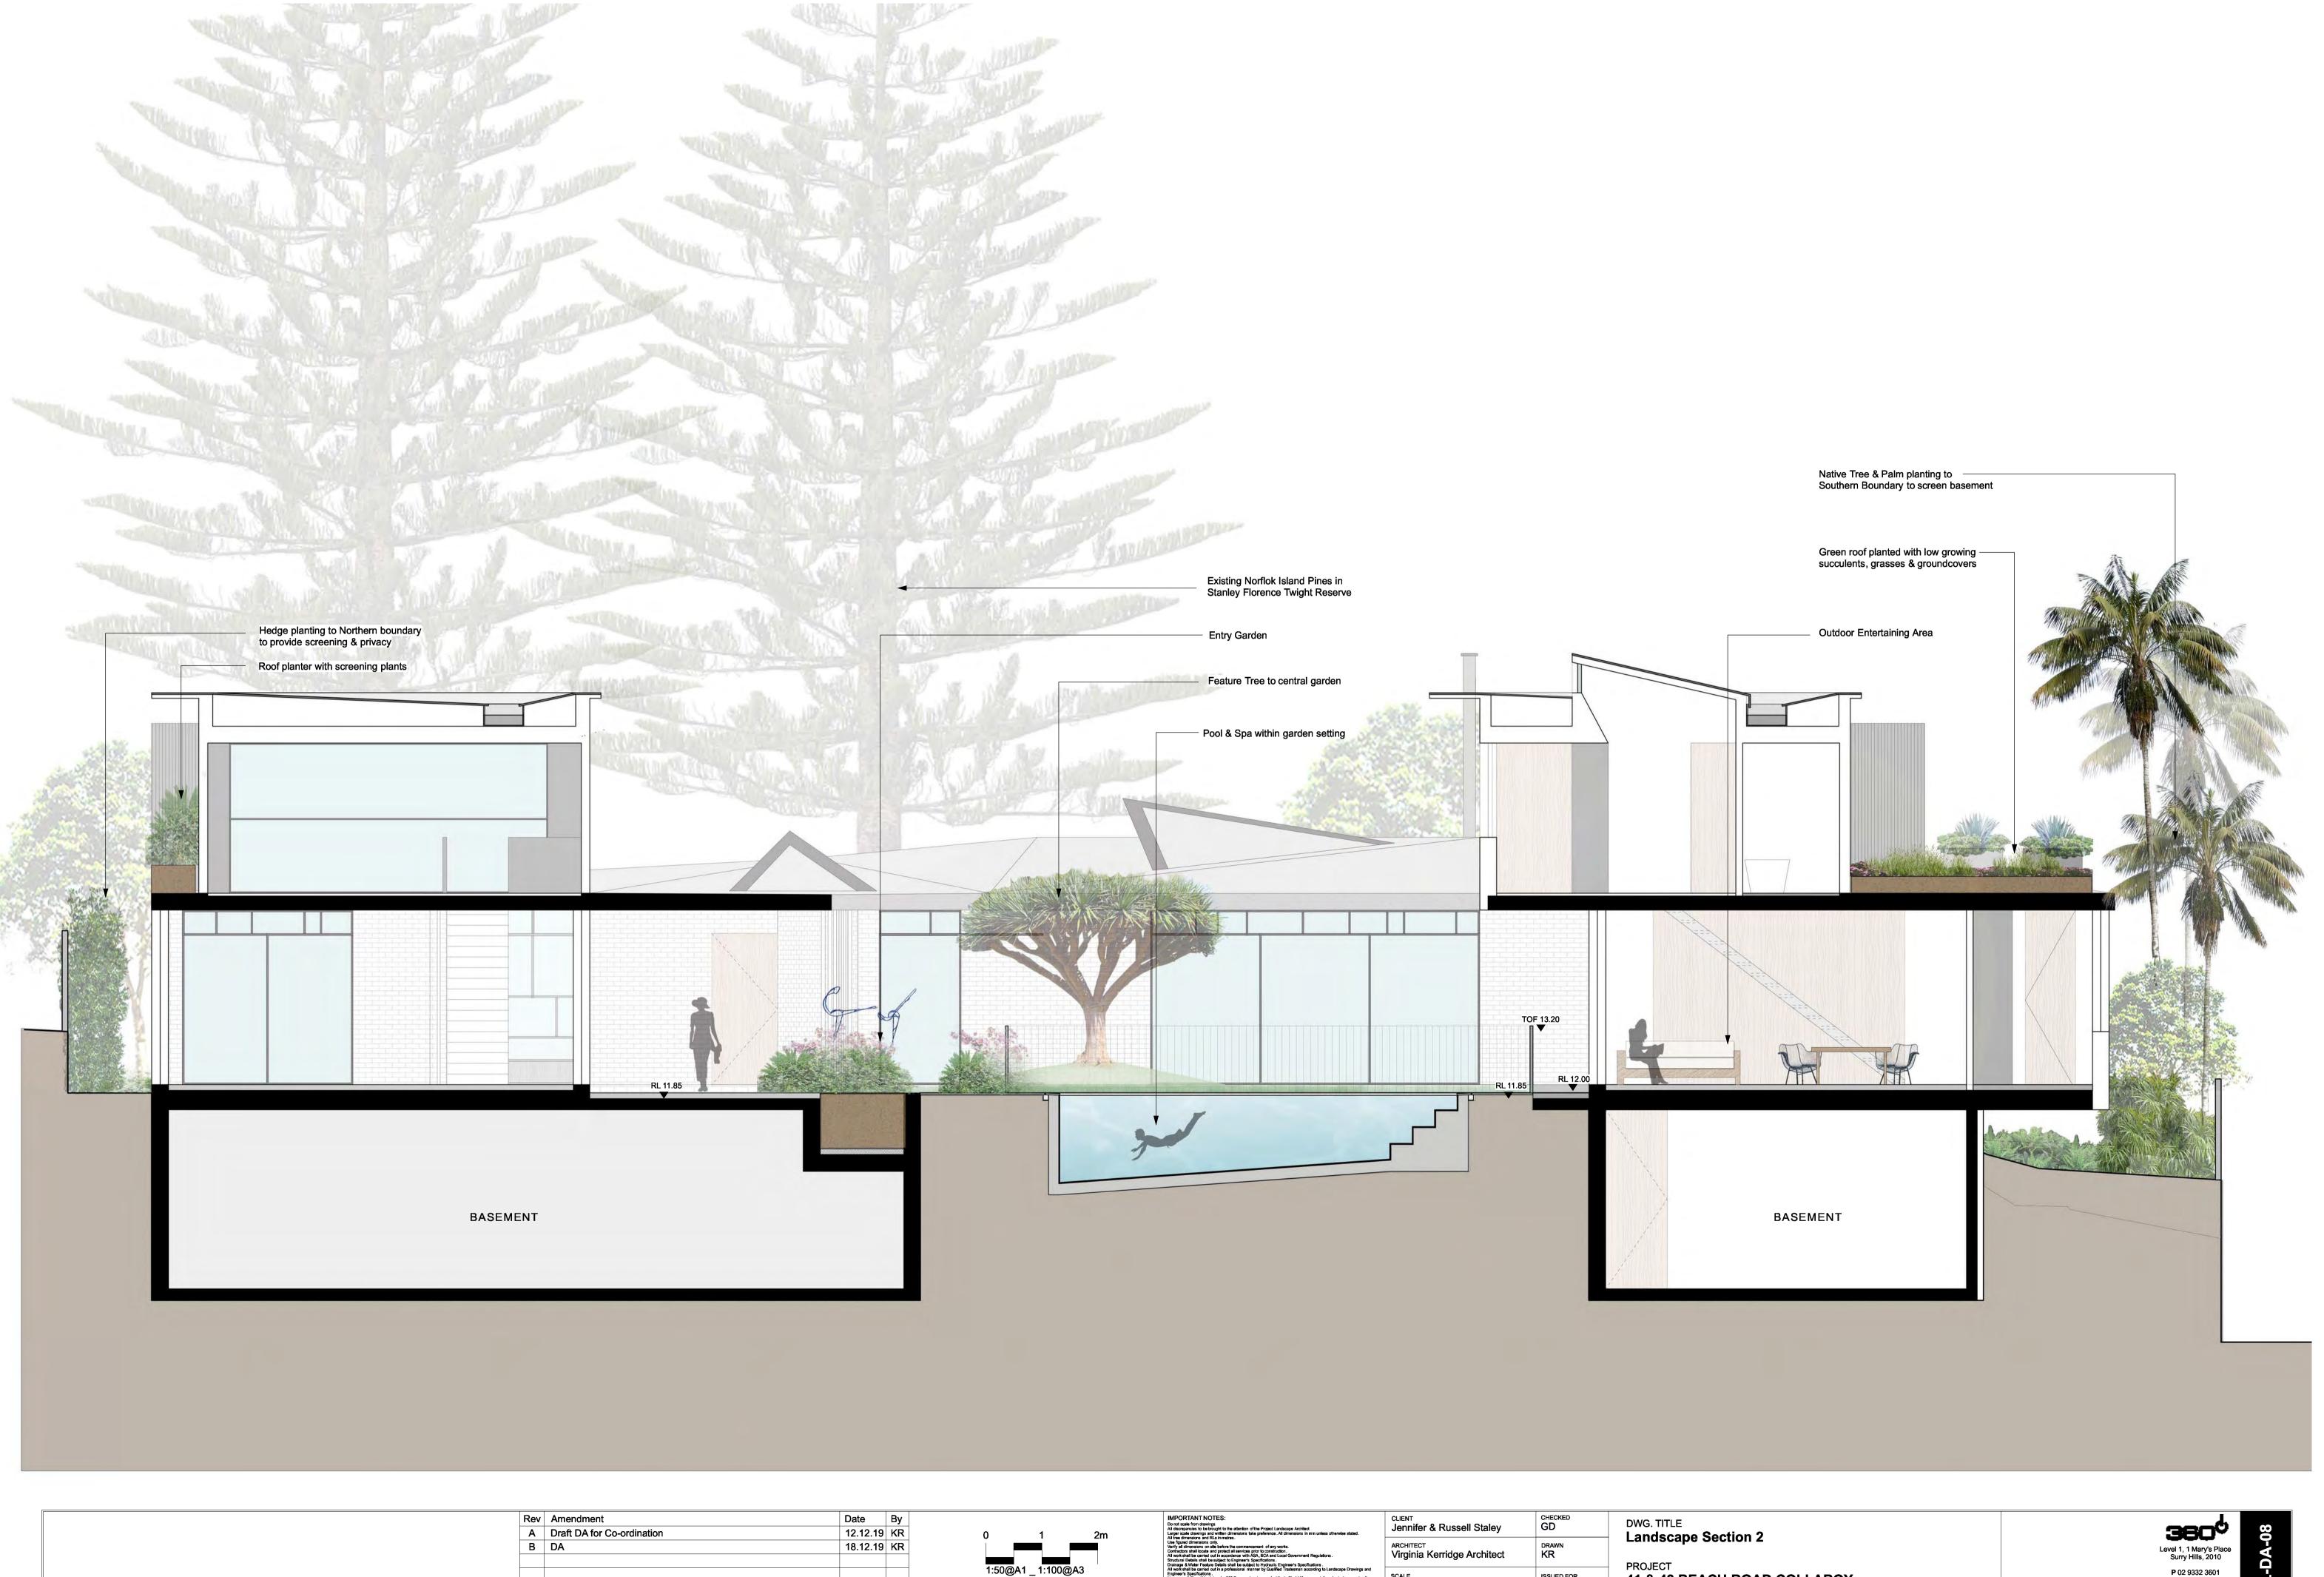

ISSUED FOR 1:50 @ A1

PROJECT
41 & 43 BEACH ROAD COLLAROY



GROUND FLOOR PLANTING PALETTE

TREES & PALMS



Howea forsteriana Kentia Palm



Robinia pseudoacacia 'Frisia' Golden Robinia



Tristaniopsis laurina 'Luscious' Luscious Water Gum



Waterhousea floribunda 'Sweeper' Sweeper Waterhousea



Elaeocarpus eumundii Quandong



SCREENING SHRUBS


Rhapiolepsis 'Snow Maiden' Snow Maiden Indian Hawthorn



Fatsia japonica

GRASSES, SUCCULENTS & GROUNDCOVERS

LEVEL 1 PLANTING PALETTE

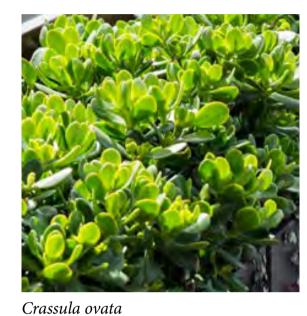



Crassula undulatum ' Max Cook' Wavy Jade



Lomandra 'Verday' Verday Mat Rush







Yucca filamentosa Adam's Needle



Casuarina 'Cousin It'

Poa labillardieri 'Eskdale'

Eskdale Tussock Grass

Trailing SheOak



Rosmarinus 'Irene' Trailing Rosemary

Dianella 'Little Jess'

Little Jess Flax Lily



Viola hederacea Native Violet

Dietes robinsoniana

Lord Howe Wedding Lily



Doodia aspera Rasp Fern



Lomandra 'Verday' Verday Mat Rush

Aeonium arboreum

Tree Houseleek



Rosmarinus 'Irene'
Trailing Rosemary



Liriope muscari 'Just Right'
Just Right Lily Turf **SHRUBS & PERENNIALS**

Carpobrotus glaucescens Angular Pig Face



Acmena smithii 'Sublime' Sublime Lilly Pilly

Gardenia augusta 'Florida' Fragrant Gardenia





Leptospermum laevigatum 'Foreshore' Fore Shore Dwarf Coastal Tea Tree



Alpinia nutans Dwarf Cardamon Ginger



Ligularia tussilaginea Leopard Plant



Banksia ericifolia Heathleafed Banksia



Rhaphiolepis indica 'Oriental Pearl' Oriental Pearl



Casuarina 'Green Wave'



Telopea 'Wirrimbia White' White Waratah



Correa alba



Westringia fruticosa 'Blue Gem' Coastal Rosemary Blue Gem



Fatsia japonica Aralia



Westringia fruticosa 'Mundi' Coastal Rosemary Mundi

Rev	Amendment	Date	Ву
Α	Draft DA for Co-ordination	12.12.19	KR
В	DA	18.12.19	KR

IMPORTANT NOTES: Do not scale from drawings All discrepancies to be brought to the attention of the Project Landscape Architect Larger scale drawings and written dimensions take preference. All dimensions in mm unless otherwise stated.	CLIENT Jenn
All free dimensions and RLs in metres. Use figured dimensions only. Verify all dimensions only. Verify all dimensions on site before the commencement of any works. Contractors shall locate and protect all services prior to construction. All work shall be carried out in accordance with ASA, BCA and Local Government Regulations. Structural Delais shall be subject to Engineer's Secrifications.	ARCHI [*] Virgi
Drainage & Water Feature Details shall be subject to Hydraulic Engineer's Specifications . All work shall be carried out in a professional manner by Qualified Tradesman according to Landscape Drawings and	
Engineer's Specifications. No responsibility will be taken by 360 Degrees Landscape Architects Pty Ltd for any variations in design, construction method, materials specified, and general specifications without permission from the Project Engineer or Landscape Architect. This Drawing is copyright to 360 Degrees Landscape Architects Pty Ltd.	SCALE N/A (


	CLIENT Jennifer & Russell Staley	CHECKED GD	_
	ARCHITECT Virginia Kerridge Architect	DRAWN KR	
and tion be	scale N/A @ A1	ISSUED FOR DA	

ARE SHOWN BELOW SLAB U.N.O




NEW RESIDENCE AT 41 & 43 BEACH ROAD COLLAROY

FOR RUSSELL STALEY JENNIFER STALEY

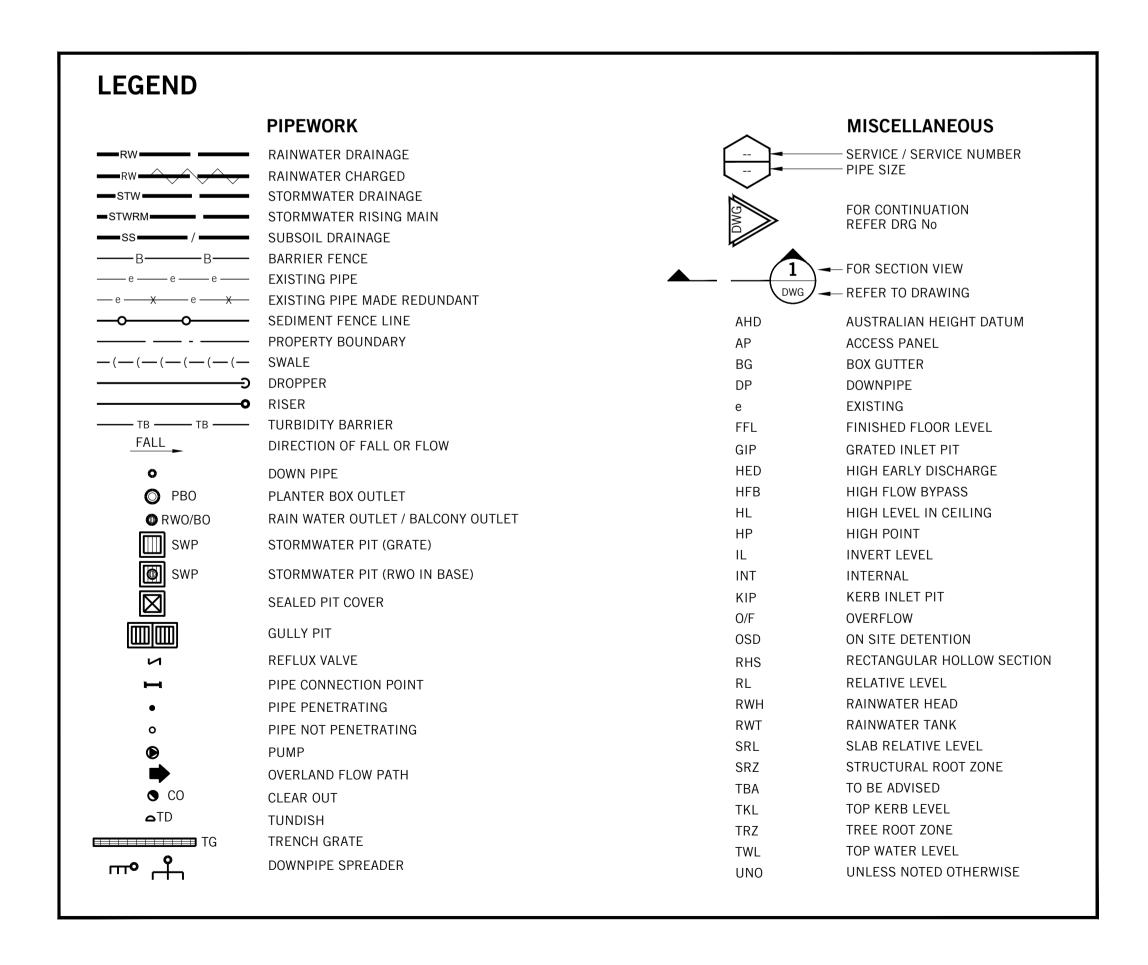

DRAWING LIST		
DRAWING No.	TITLE	
SWDA 1.1	COVERSHEET AND DRAWING LEGEND	
SWDA 1.2	GROUND FLOOR LAYOUT	
SWDA 1.3	BASEMENT FLOOR LAYOUT	
SWDA 1.4	DETAILS SHEET	
SWDA 1.5	EROSION & SEDIMENT CONTROL PLAN AND DETAILS	

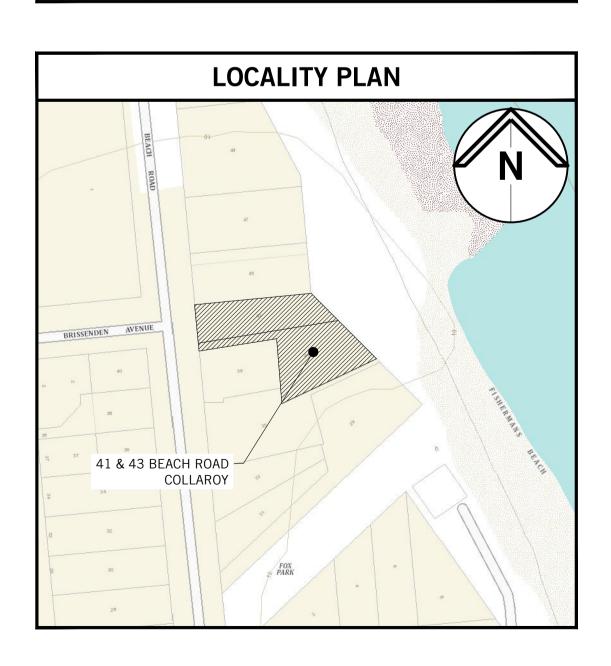

NOTES

- 1) ALL DRAINAGE WORKS ARE TO BE IN ACCORDANCE WITH AS/NZS 3500 -STORMWATER DRAINAGE. WARRINGAH COUNCIL DEVELOPMENT CONTROL PLAN FOR ON-SITE STORMWATER MANAGEMENT AND THE LATEST BASIX CERTIFICATE.
- 2) SITE AREA = $1536m^2$
- 3) DUE TO THE PRESENCE OF A SILTY CLAY LAYER INVESTIGATED BY TAYLOR GEOTECHNICAL ENGINEERING REPORT DATED ON 15/06/2019, IT IS CONCLUDED THAT A STORMWATER ABSORPTION TRENCH IS NOT SUITABLE FOR THE DEVELOPMENT. A STORMWATER DISPERSAL TRENCH AND LEVEL SPREADER IS PROPOSED DOWNSTREAM OF THE DEVELOPMENT IN LIEU OF A STORMWATER ABSORPTION TRENCH IN ACCORDANCE WITH COUNCIL PRE-DA MEETING MINUTES ADVICE NUMBER PLM2019/0024 - DATED ON 26/02/2019.
- 4) A SILT TRAP PIT IS TO BE INCORPORATED WITHIN THE DOWNSTREAM END OF THE EXISTING STORMWATER SYSTEM SERVING THE SITE IN ACCORDANCE WITH WARRINGAH COUNCIL REQUIREMENTS. THIS IS TO BE REGULARLY MAINTAINED AND CLEARED OF ALL DEBRIS.
- 5) IN ACCORDANCE WITH THE BASIX CERTIFICATE A RAINWATER TANK WITH A MIN CAPACITY OF 6000L IS PROPOSED. THIS IS TO COLLECT A MINIMUM ROOF AREA OF 370m².

P2 ISSUED FOR DA DH GB 17.12.19 P1 95% PRELIMINARY ISSUE DH GB 16.12.19 Rev. Issue / Amendment By App. Date



PARTRIDGE HYDRAULIC SERVICES ABN 11 608 027 578 Level 5, 1 Chandos Street, St Leonards NSW 2065 Australia t 612 9460 9000 f 612 9460 9090 email: partridge@partridge.com.au web: www.partridge.com.au

HYDRAULIC SERVICES

RUSSELL STALEY JENNIFER STALEY

VIRGINIA KERRIDGE ARCHITECT


03/59 GREAT BUCKINGHAM STREET, REDFERN TEL: 02 3699 8527 EMAIL: info@vk.com.au


NEW RESIDENCE 41 & 43 BEACH ROAD COLLAROY


STORMWATER DRAINAGE SERVICES COVERSHEET AND DRAWING LEGEND

2019H0087	SWD	A 1.1	P2
Job No.	Drawing No.		Revision
N/A	DECEMBE	ER 2019	S.P
Scale at A1	Date		Drawn
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PRELIMINARY - NOT FOR CONSTRUCTION



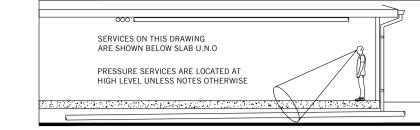

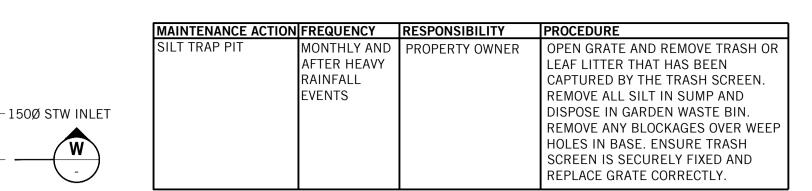

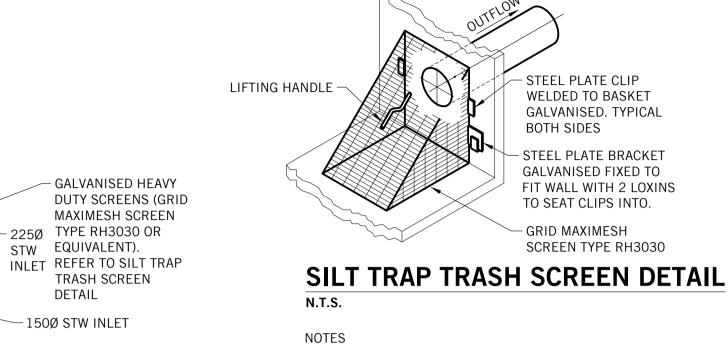NOTES

1) PIT DIMENSIONS: $600 \times 600 \text{ FOR} < D \le 0.9$ $600 \times 900 \text{ FOR} 0.9 < D \le 1.2$ $900 \times 900 \text{ FOR} 1.2 < D \text{ (AS SHOWN ON PLAN)}$

2) PITS TO BE CONSTRUCTED FROM - CAST IN-SITU CONCRETE, PRECAST CONCRETE OF DOUBLE BRICK.


3) A SIGN SHALL BE CONSTRUCTED ADJACENT TO THE PIT STATING: "THIS SEDIMENT / SILT ARRESTOR PIT SHALL BE REGULARLY INSPECTED AND CLEANED".

SILT TRAP PIT

150Ø INLET PIPES


- MIN 4 x 90Ø

WEEP HOLES

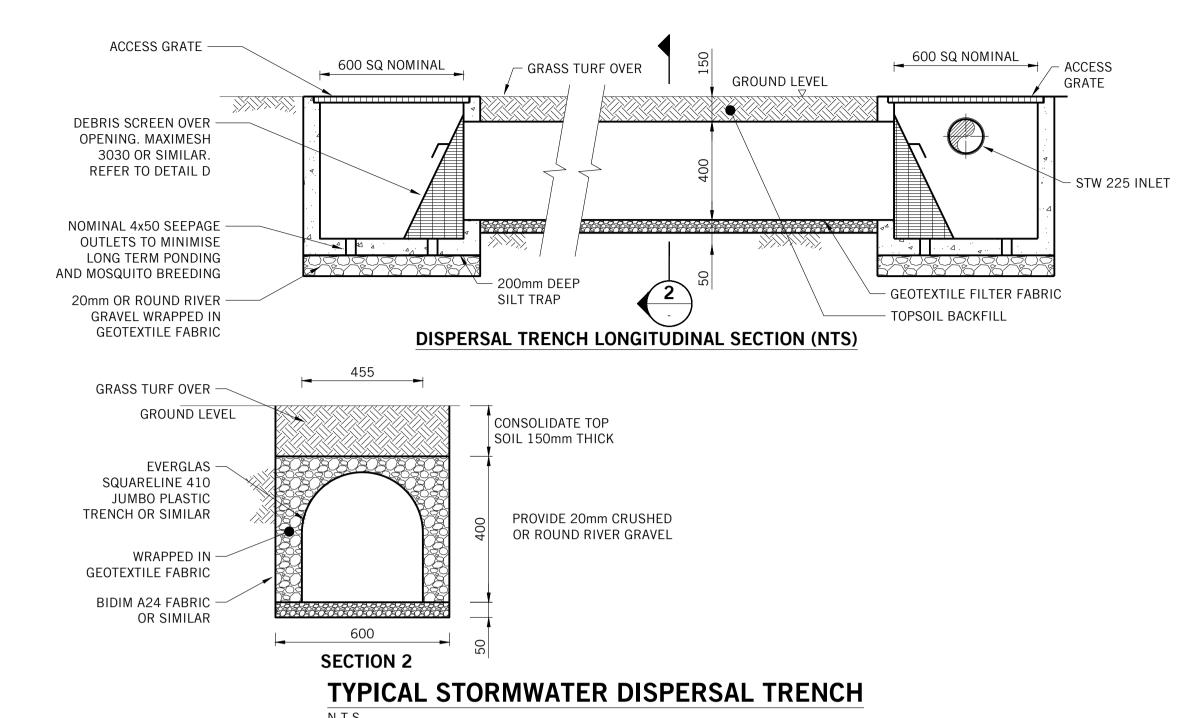

- MOSQUITO AND VERMIN RESISTANT BASKET SCREEN FIRST FLUSH DEVICE TO CAPTURE -— HIGH LEVEL OVERFLOW PIPE <u></u> 150mm INITIAL ROOF RUNOFF. REFER TO PLANS FOR SPECIFICATIONS & **VOLUME REQUIREMENTS** TO STORMWATER SYSTEM (REFER TO PLAN) RAINWATER HARVESTING FIRST FLUSH UNIT IS TO BE TANK. REFER TO PLANS FOR CLEANED OUT AFTER EACH SPECIFICATION & VOLUME MAJOR STORM & AS PER REQUIREMENTS. MAINTENANCE SCHEDULE TOP OF TANK OPEN TO ATMOSPHERE (SCREENED) BASE RL + 0.10m- 0.1m SLUDGE BASE RL (REFER TO PLAN) 5 RAINWATER TO BE USED IN ACCORDANCE WITH - GRATED INLET PIT THE BASIX CERTIFICATE CONCRETE PLINTH SLAB - OUTLET PIPE TO STRUCTURAL DETAIL

TYPICAL ABOVE GROUND RAINWATER STORAGE TANK

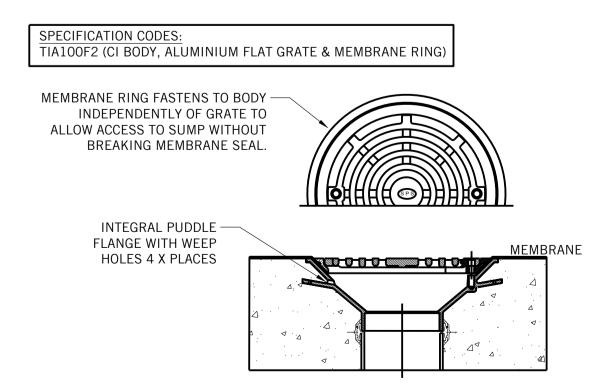

150Ø INLET PIPES

PLAN

SECTION W

- 225Ø STW INLET

225Ø OUTLET PIPE

CHILDPROOF & -

FASTENING SYSTEM

(EG. SPRING LOADED

J-BOLTS OR SIMILAR)

GEOTEXTILE FABRIC

(HIGH FILTRATION


CORROSION

RESISTANT

OUTLET PIPE


SPS TRUFLO 100mm RWO WITH FLAT GRATE & MEMBRANE CLAMP

N.T.S (SPS REF 1.03)

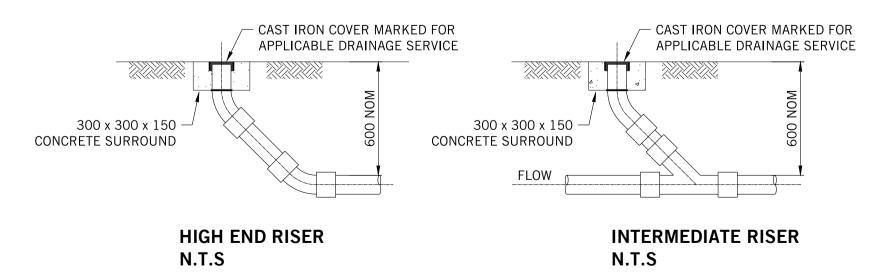

PROVIDE CLEAR OUTS INSTALLED IN ACCORDANCE WITH A.S. 3500 AT LOCATIONS WHERE NOTED C.O. ON PLAN

TYPICAL DRAINAGE CLEAR OUT (INSPECTION OPENING)

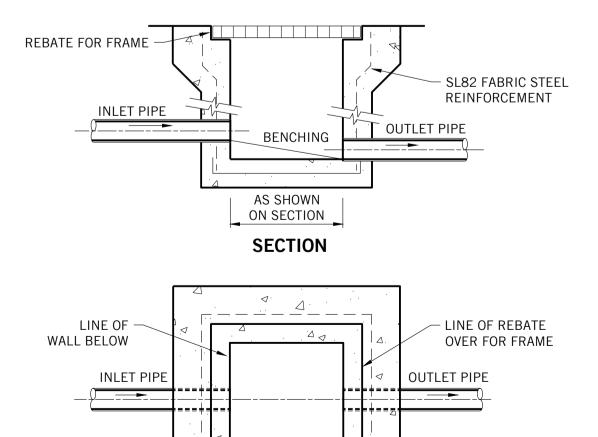

PLAN WITHOUT GRATE

TYPICAL GRATED INLET PIT

N.T.S

P2	ISSUED FOR DA	DH	GB	17.12.19
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Architect

VIRGINIA KERRIDGE ARCHITECT

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Project

NEW RESIDENCE

41 & 43 BEACH ROAD COLLAROY

STORMWATER DRAINAGE SERVICES DETAILS SHEET

2019H0087	7 SWD/	۹ 1.4	P2
Job No.	Drawing No.		Revision
AS SHOWN	DECEMBE	R 2019	S.P
Scale at A1	Date		Drawn
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