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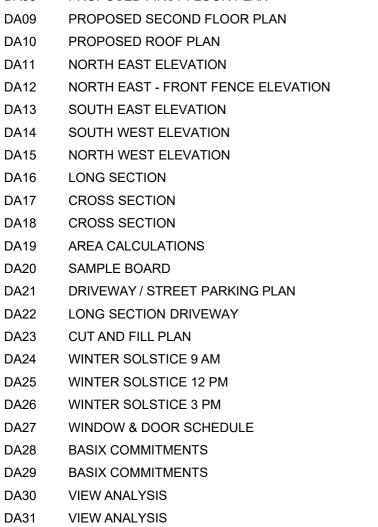
e: operations@actionplans.com.au w: www.actionplans.com.au

PLANS PUBLISHED 23 May 2025

DEVELOPMENT APPLICATION

These plans are for Council Approval only.

| NO. | DRAWING NAME |
|------|--------------------------------------------|
| DA00 | COVER |
| DA01 | NOTATION |
| DA02 | SAFTEY NOTES |
| DA03 | SUB-DIVISION PLAN |
| DA04 | SITE ANALYSIS |
| DA05 | SITE / SEDIMENT EROSION / WASTE MANAGEMENT |
| DA06 | PROPOSED BASEMENT FLOOR PLAN |
| DA07 | PROPOSED GROUND FLOOR PLAN |
| DA08 | PROPOSED FIRST FLOOR PLAN |
| DA09 | PROPOSED SECOND FLOOR PLAN |
| DA10 | PROPOSED ROOF PLAN |
| DA11 | NORTH EAST ELEVATION |
| DA12 | NORTH EAST - FRONT FENCE ELEVATION |
| DA13 | SOUTH EAST ELEVATION |
| DA14 | SOUTH WEST ELEVATION |





Star rating

7.1

HOUSE





35 Moore road, Freshwater, NSW 2096



| SITE INFORMATION | |
|------------------|------------------------------------|
| ADDRESS | 35 Moore Road, Freshwater NSW 2096 |
| LOT | 15/1/DP7022 |
| AREA | 385.2m ² |

| WARRINGAH LOCAL ENVIRO | ONMENTAL PLAN 2011 CONTROLS | |
|------------------------|----------------------------------|------------------------------------------------|
| | CONTROL | COMPLIANCE |
| ZONING | R2: LOW DENSITY RESIDENTIAL | YES* |
| | | State Environmental Planning Policy (Housing) |
| | | 2021 overrules this LEP, allowing dual |
| | | occupancies to be constructed on land zoned R2 |
| BUILDING HEIGHT | 8.5m | |
| MINIMUM LOT SIZE | 450m | NO: Torrens title subdivision |
| | | YES: Strata subdivision |
| LANDSLIDE RISK LAND | AREA A – SLOPES <5 | Geotechnical report not required. |
| | AREA B - FLANKING SLOPES 5 TO 25 | |

| | CONTROL | COMPLIANCE | |
|-------------------------|------------------------------------------------------------------------|------------|--|
| FRONT SETBACK | 6.5m | NO | |
| SIDE SETBACK | 0.9m | YES | |
| REAR SETBACK | 6.5m | YES | |
| SIDE BOUNDARY ENVELOPE | 5m | YES | |
| MAXIMUM WALL HEIGHT | 7.2m | YES | |
| MINIMUM LANDSCAPED AREA | 40% OF SITE AREA = 154.08m ² or 77.04m ² per lot | YES | |
| MINIMUM PARKING SPACES | 2 per lot | YES | |

IMPORTANT NOTATION FOR BUILDERS

- All dimensions are to be confirmed on-site by the builder/subcontractor, any incongruencies must be reported to the Designer in writing before the commencement of any work.
- No Survey has been made on the boundaries. All bearings, distances, and areas have been taken from the contour survey plan. A Survey must be carried out to confirm the exact boundary locations.
- No construction work shall commence until a site survey confirming the site boundaries has been completed. The contractor is to ensure that the approved boundary setbacks are confirmed and used, the boundary setbacks take precedence over all other dimensions. The Survey work must be performed by a registered Surveyor. - In the event of encountering any discrepancies on these drawings, specification, or subsequent instructions issued,
- the Builder/Subcontractor shall contact the designer in writing before proceeding further with any work. The builder/subcontractor is responsible to ensure that all materials installed on-site are fit for purpose and comply with
- the NCC and relevant Australian Standards. The builder is to obtain written confirmation of material selection by the Client prior to ordering.
- All construction, control joints, and expansion joints in the walls, floors, and other locations shall be in strict accordance with the structural engineering details. No joints or breaks other than specified are allowed without written permission from the Engineer
- Measurements for the fabrication of secondary components such as windows, doors, internal frames, structural steel components, and the like, are not to be taken from these documents. Measurements must be taken on-site to suit the work as constructed
- All structural components shall be in strict accordance with details and specifications as prepared by a suitably qualified structural engineer.
- All existing structures need to be examined for structural adequacy, and it is the Contractor's responsibility to ensure that a certificate of structural adequacy is available prior to the start of any work.

SPECIFICATION

- "Approval" obtained by either an 'Accredited Certifying Authority' or 'Local Council'
- The Owner will directly pay all fees associated with the following:
- Building approval from council or accredited certifier, any footpath and kerb deposits with the local council, insurance fees to Building Services Corporation, Long Service Leave levy fees and approval fees by water and sewerage authority. All other fees are to be paid by the builder. The amount of any local authority deposits which are forfeited due to damage or other causes, will be deducted from payments due to the builder.
- -The Builder is to provide at his/her own expense adequate Public Risk Insurance and arrange indemnification under the Workers Compensation Act. Works insurance to be as stated in the contract conditions
- All tenderers are to visit the site to satisfy themselves as to the nature and extent of the Works, facilities available and difficulties entailed in the works as Variations will not be allowed due to work arising owing to neglect of this clause.
- These drawings shall be read in conjunction with all structural and other consultant's drawings and specifications and with any such written instructions as may be issued during the course of the contract.
- Set out dimensions shown on this drawing shall be verified by the builder on site before commencement of any work.
- Dimensions shall not be obtained by scaling the drawings, use figured dimensions. All dimensions are in millimetres. - The Builder is to ensure all construction, levels and other items comply with the conditions of the Building Approval.
- Any detailing additional to that which is supplied shall be resolved between the Owner and the Builder, to the Owner's approval. Except for any structural details or design, which is to be supplied by the Engineer.
- All work to be carried out in a tradesman like manner and in accordance with the standards, codes and regulations of Standards Australia, the National Construction Code and any statutory authority having jurisdiction over the works. - All structural work is to be in accordance with the structural details prepared by a suitably qualified structural engineer, including but not limited to all piers, footings, concrete slabs, retaining walls, steelworks, formwork, underpinning additional structural loads, timber framing, wind bracing and associated connections. Builder to obtain prior to finalising the tender, unless previously obtained by owners.
- All brickwork is to be selected by the Owner, and is to comply with AS 1640.
- All masonry is to comply with AS 3700.

is more than 4m

- Provide all metalwork and flashings necessary to satisfactorily complete the works.
- All timber construction to be in accordance with AS 1684 Residential timber-framed construction. Level and grade where necessary under timber floors to provide a minimum clearance of 300mm under bearers or 400mm under joists. Adequate precautions shall be taken to ensure that the surface and/or seepage water does not collect or remain under
- Sustainable timbers, and not rainforest or old growth timber will be used. Recycled timber or second hand timbers are to be sourced and used in preference to plantation timbers, if available and suitable
- All glazing installation is to comply with AS 1288, AS 2047 and in accordance with manufacturers recommendations. - All wall and ceiling linings in wet areas to be plasterboard and villaboard, or equal. A breathable wall wrap is to be provided to all external walls. Timber cladding is to be battened out from timber frame to provide an 'air' gap to prevent condensation. Workmanship is to comply with the relevant Australian Standards or installed in accordance with manufacturer's specifications. All bathrooms and wet areas to be waterproofed with a flexible membrane to manufacturer's specifications and to AS 3740, Part H4D2 and Section 10; Part 10.2 of the 2022 NCC.
- All Architraves and skirtings to the profile as selected by owner, and painted or stain finish as selected
- All plumbing and drainage work to be installed and completed by a licensed tradesman and in accordance with the statutory body having authority over the works. Connect all waste to Sydney Water sewer line
- Connect all stormwater to existing system or street drainage system in accordance with AS 3500, Part H2D2 and Section 3: Part 3.3 of the 2022 NCC.
- Smoke detector alarms are to be installed in accordance with AS 3786, Part H3D6 and Section 9; Part 9.5 of the 2022
- If a member which provides structural support to the works is subject to termite attack, management measures are to comply with AS 3660 and Section 3; Part 3.4 of the 2022 NCC. Termite management system to be installed to manufacturer's specifications.
- Stairs and Balustrades to comply with Part H5D2, H5D3 and Section 11; Part 11.2 and 11.3 of the 2022 NCC. Provide a handrail along the full length of the flight and a slip resistant finish to the edge of the nosings to comply with 3.9.1 and 3.9.2 of the NCC. No horizontal elements to facilitate climbing between 150mm and 760mm where floor to level below
- Electrical works to be in accordance with SAA wiring rules and be done by a licenced tradesperson. Obtain electrical layout prior to proceeding. All electrical power (GPO's) and light outlets to be determined by the Owner
- Painting: All paints or other coatings shall be of the best quality materials & of approved manufacture. All priming materials shall be of an approved brand acceptable to the manufacturer of the finishing coats to be used. External iginery intended to be painted shall be primed on all faces at the place of assembly. Where new work or alteration work adjoins existing painted surfaces allow for repainting existing surfaces to provide uniform appearance.
- ZERO-VOC or LOW-VOC paints and primers only are to be used.
- Any work indicated on the plans but not specified and any item not shown on the plans which is obviously necessary as part of proper construction and/or finish, is to be considered as shown and specified and is to be undertaken as part of the contract. Variations will not be permitted without prior written approval by the owners
- The Builder shall provide sediment and siltration control measures as required by Council, and maintain them throughout the duration of the works
- A legible copy of the plans bearing approval stamps, must be maintained on the job site at all times. Hours of construction shall be restricted to the times as required by the building approval.
- The Builder is to arrange for all inspections required by the relevant authorities and/or lending institutions, to their

- The Builder is to obtain approval for interruptions to existing services and minimise the duration and number of interruptions. Any interruptions to existing services and equipment is to be undertaken by appropriately qualified tradespersons
- The Builder shall restore, reinstate or replace any damage to existing structures or landscaping caused by the
- Provide protection to existing trees to remain, or as required by the Approval Conditions.

GENERAL NOTATION

- Approved means by the 'relevant local authority' or council?
- All work and materials to comply with the current Australian standards at the time of commencement, where
- The builder is to comply with all ordinances, local authority regulations and the requirements of all services supply authorities having jurisdiction over the works.
- All new downpipes are to be connected to the existing stormwater system.
- All timber sizes and concrete details to be confirmed by the builder prior to commencement of any work
- All gutters, downpipes to be colorbond.
- All wall and ceiling linings to be plasterboard or cement render as selected, and villa board in wet areas. To comply with relevant Australian standards, and installed in accordance with manufacturers specification

NCC 2022 & AS COMPLIANCES SPECIFICATIONS

- Structure Part H1 & Section 2 of NCC
- Structural Provisions PART H1D2 & PART 2.2 of NCC
- Site Preparation Part H1D3 & Section 3 of NCC
- Earthworks Part 3.2 of NCC Drainage - Part 3.3 of NCC
- Termite Risk Management Part 3.4 of NCC
- Footings & Slabs Part H1D4 & Section 4 of NCC
- Footings, Slabs & Associated Elements Part 4.2 of NCC
- Masonry Part H1D5 & Section 5 of NCC
- Masonry Veneer Part 5.2 of NCC
- Cavity Masonry Part 5.3 of NCC
- Unreinforced Single Leaf Masonry Part 5 4 of NCC
- Isolated Piers Part 5.5 of NCC
- Masonry Components & Accessories Part 5.6 of NCC
- Waetherproofing of Masonry Part 5.7 of NCC
- Framing Part H1D6 & Section 6 of NCC
- Sub Floor Ventilation Part 6.2 of NCC
- Structural Steel Members Part 6.3 of NCC
- Roof & Wall Cladding Part H1D7 & Section 7 of NCC
- Sheet Roofing Part 7.2 of NCC
- Roof Tiles & Shingles Part 7.3 of NCC
- Gutters & Downpipes Part 7.4 of NCC
- Timber & Composite Wall Cladding Part 7.5 of NCC
- Glazing Part H1D8 & Section 8 of NCC
- Windows & External Glazed Doors Part 8.2 of NCC
- Glass Part 8.3 of NCC
- Glazing Human Impact Part 8.4 of NCC
- Damp & Weatherproofing Part H2 of NCC
- Fire Safety Part H3 & Section 9 of NCC
- Fire Separation of External Walls Part 9.2 of NCC
- Fire Protection of Separating Walls & Floors Part 9.3 of NCC - Fire Protection of Garage Top Dwellings - Part 9.4 of NCC
- Smoke Alarms & Evacuation Lighting Part 9.5 of NCC
- Health & Amenity Part H4 & Section 10 of NCC
- Wet Area Waterproofing Part 10.2 of NCC
- Room Heights Part 10.3 of NCC
- Facilities Part 10.4 of NCC
- Light Part 10.5 of NCC
- Ventilation Part 10.6 of NCC Sound Insulation - Part 10.7 of NCC
- Condensation Management Part 10.8 of NCC
- Safe Movement & Access Part H5 & Section 11 of NCC - Stairway & Ramp Construction - Part 11.2 of NCC
- Barriers & Handrails Part 11.3 of NCC
- Ancillary Provisions Part H7 & Section 12 of NCC
- Construction in Alpine Areas Part 12.2 of NCC
- Attachment of Framed Decks & Balconies to External Walls of Buildings Using a Waling Plate Part 12.3 of NCC
- Heating Appliances, Fireplaces, Chimneys & Flues Part 12.4 of NCC
- Swimming Pools Part H7P1 & NSW H7D2 of NCC
- Construction in Bushfire Prone Areas Part NSW H7D4 of NCC - Energy Efficiency - Part H6 & Section 13 of NCC
- Building Fabric Part 13.2 of NCC
- External Glazing Part 13.3 of NCC
- Building Sealing Part 13.4 of NCC - Ceiling Fans - Part 13.5 of NCC
- Whole of Home Energy Usage Part 13.6 of NCC
- Services Part 13.7 of NCC

- Pool Fencing & other provisions Regulations & AS 1926
- Demolition Works to comply with AS 2601-2001 The Demolition of Structures.
- Waterproofing of Wet Areas to comply with AS 3740:2021
- All plumbing & drainage work to comply with AS 3500:2021
- All plasterboard work to comply with AS 2588:2018
- All structural steel work to comply with AS 4100:2020 & AS 1554.1:2014
- All concrete work to comply with AS 3600:2018
- All roof sheeting work to comply with AS 1562.1:2018
- All skylights to comply with AS 4285:2019 - All ceramic tiling to comply with AS 3958.1-2007 & 3958.2-1992
- All glazing assemblies to comply with AS 2047-2014 & AS 1288:2021
- All timber retaining walls to comply with AS 1720, AS 1170
- All retaining walls to comply with AS 3700:2018 & AS 3600:2018 - All construction in bushfire-prone areas to comply with AS 3959:2018



THIS SET OF DRAWING SHOULD BE READ & KEPT IN ITS ENTIRETY. NO INDIVIDUAL PAGE SHOULD BE SEPARATED FROM THE REST OF THE SET. EACH NOTATION LISTED ON THIS PAGE APPLY TO ALL PAGES OF THIS SET.

SAFTEY NOTES

THESE NOTES MUST BE READ AND UNDERSTOOD BY ALL INVOLVED IN THE PROJECT. THIS INCLUDES (but is not excluded to): OWNER, BUILDER, SUB-CONTRACTORS, CONSULTANTS, RENOVATORS, OPERATORS, MAINTENORS, DEMOLISHERS.

1. FALLS, SLIPS, TRIPS

a) WORKING AT HEIGHTS

DURING CONSTRUCTION

Wherever possible, components for this building should be prefabricated off-site or at ground level to minimise the risk of workers falling more than two metres. However, construction of this building will require workers to be working at heights where a fall in excess of two metres is possible and injury is likely to result from such a fall. The builder should provide a suitable barrier wherever a person is required to work in a situation where falling more than two metres is a possibility.

DURING OPERATION OR MAINTENANCE

For houses or other low-rise buildings where scaffolding is appropriate: Cleaning and maintenance of windows, walls, roof or other components of this building will require persons to be situated where a fall from a height in excess of two metres is possible. Where this type of activity is required, scaffolding, ladders or trestles should be used in accordance with relevant codes of practice, regulations or legislation. For buildings where scaffold, ladders, trestles are not appropriate: Cleaning and maintenance of windows, walls, roof or other components of this building will require persons to be situated where a fall from a height in excess of two metres is possible. Where this type of activity is required, scaffolding, fall barriers or Personal Protective Equipment (PPE) should be used in accordance with relevant codes of practice, regulations or legislation.

b) SLIPPERY OR UNEVEN SURFACES

FLOOR FINISHES Specified

If finishes have been specified by designer, these have been selected to minimise the risk of floors and paved areas becoming slippery when wet or when walked on with wet shoes/ feet. Any changes to the specified finish should be made in consultation with the designer or, if this is not practical, surfaces with an equivalent or better slip resistance should be chosen.

FLOOR FINISHES By Owner

If designer has not been involved in the selection of surface finishes. the owner is responsible for the selection of surface finishes in the pedestrian trafficable areas of this building. Surfaces should be selected in accordance with AS HB 197:1999 and AS/ NZ 4586:2004.

STEPS, LOOSE OBJECTS AND UNEVEN SURFACES

Due to design restrictions for this building, steps and/ or ramps are included in the building which may be a hazard to workers carrying objects or otherwise occupied. Steps should be clearly marked with both visual and tactile warning during construction, maintenance, demolition and at all times when the building operates as a workplace. Building owners and occupiers should monitor the pedestrian access ways and in particular access to areas where maintenance is routinely carried out to ensure that surfaces have not moved or cracked so that they become uneven and present a trip hazard. Spills, loose material, stray objects or any other matter that may cause a slip or trip hazard should be cleaned or removed from access ways. Contractors should be required to maintain a tidy work site during construction, maintenance or demolition to reduce the risk of trips and falls in the workplace. Materials for construction or maintenance should be stored in designated areas away from access ways and work areas.

2. FALLING OBJECTS

LOOSE MATERIALS OR SMALL OBJECTS

Construction, maintenance or demolition work on or around this building is likely to involve persons working above ground level or above floor levels. Where this occurs one or more of the following measures should be token to ovoid objects falling from the area where the work is being carried out onto persons below.

- 1. Prevent or restrict access to areas below where the work is
- being carried out.
- 2. Provide toeboards to scaffolding or work platforms.
- 3. Provide protective structure below the work area
- 4. Ensure that all persons below the work area have Personal

Protective Equipment (PPE).

BUILDING COMPONENTS

During construction, renovation or demolition of this building, parts of the structure including fabricated steelwork, heavy panels and many other components will remain standing prior to or after supporting parts are in place. Contractors should ensure that temporary bracing or other required support is in place at all times when collapse which may injure persons in the area is a possibility. Mechanical lifting of materials and components during construction, maintenance or demolition presents a risk of falling objects. Contractors should ensure that appropriate lifting devices are used, that loads are properly secured and that access to areas below the load is prevented or restricted.

3. TRAFFIC MANAGEMENT

For building on a major road, narrow road or steeply sloping road: Parking of vehicles or loading/ unloading of vehicles on this roadway may cause a traffic hazard. During construction, maintenance or demolition of this building designated parking for workers and loading areas should be provided. Trained traffic management personnel should be responsible for the supervision of these areas. For building where on-site loading/ unloading is restricted: Construction of this building will require loading and unloading of materials on the roadway. Deliveries should be well planned to ovoid congestion of loading areas and trained traffic management personnel should be used to supervise loading/ unloading areas. For all buildings: Busy construction and demolition sites present a risk of collision where deliveries and other traffic are moving within the site. A traffic management plan supervised by trained traffic management personnel should be adopted for the work site.

4. SERVICES

GENERAL

Rupture of services during excavation or other activity creates a variety of risks including release of hazardous material. Existing services are located on or around this site. Where known, these ore identified on the plans but the excel location and extent of services may vary from that indicated. Services should be located using on appropriate service (such as Dial Before You Dig), appropriate excavation practice should be used and, where necessary, specialist contractors should be used. Locations with underground power: Underground power lines MAY be located in or around this site. All underground power lines must be disconnected or carefully located and adequate warning signs used prior to any construction, maintenance or demolition commencing. Locations with overhead power lines: Overhead power lines MAY be near or on this site. These pose a risk of electrocution if struck or approached by lifting devices or other plant and persons working above ground level. Where there is a danger of this occurring, power lines should be, where practical, disconnected or relocated. Where this is not practical adequate warning in the form of bright coloured tape or signage should be used or a protective barrier provided.

5. MANUAL TASKS

Components within this design with a moss in excess of 25kg should be lifted by two or more workers or by mechanical lifting device. Where this is not practical, suppliers or fabricators should be required to limit the component mass. All material packaging, building and maintenance components should clearly show the total moss of packages and where practical all items should be stored on site in a way which minimises bending before lifting. Advice should be provided on safe lifting methods in all areas where lifting may occur. Construction, maintenance and demolition of this building will require the use of portable tools and equipment. These should be fully maintained in accordance with manufacturer's specifications and not used where faulty or (in the case of electrical equipment) not carrying a current electrical safety tag. All safety guards or devices should be regularly checked and Personal Protective Equipment should be used in accordance with manufacturer's specification.

6. HAZARDOUS SUBSTANCES

ASBESTOS

For alterations to a building constructed prior to 1990: If this existing building was constructed prior to:

1990 - it therefore may contain asbestos

1986 - it therefore is likely to contain asbestos

either in cladding material or in fire retardant insulation material. In either case, the builder should check and, if necessary, take appropriate action before demolishing, culling, sanding, drilling or otherwise disturbing the existing structure

POWDERED MATERIALS

Many materials used in the construction of this building con cause harm if inhaled in powdered form. Persons working on or in the building during construction, operational maintenance or demolition should ensure good ventilation and wear Personal Protective Equipment including protection against inhalation while using powdered material or when sanding, drilling, cutting or otherwise disturbing or creating powdered material.

TREATED TIMBER

The design of this building may include provision for the inclusion of treated limber within the structure. Dust or furnes from this material can be harmful. Persons working on or in the building during construction, operational maintenance or demolition should ensure good ventilation and wear Personal Protective Equipment including protection against inhalation of harmful material when sanding, drilling, cutting or using treated timber in any way that may cause harmful material to be released. Do not burn treated timber.

VOLATILE ORGANIC COMPOUNDS

Many types of glue, solvents, spray packs, paints, varnishes and some cleaning materials and disinfectants have dangerous emissions. Areas where these are used should be kept well ventilated while the material is being used and for a period after installation. Personal Protective Equipment may also be required. The manufacturer's recommendations for use must be carefully considered at all times.

SYNTHETIC MINERAL FIBRE

Fibreglass, rockwool, ceramic and other material used for thermal or sound insulation may contain synthetic mineral fibre which may be harmful if inhaled or if it comes in contact with the skin, eyes or other sensitive parts or the body. Personal Protective Equipment including protection against inhalation of harmful material should be used when installing, removing or working near bulk insulation material.

TIMBER FLOORS

This building may contain timber floors which have an applied finish. Areas where finishes are applied should be kept well ventilated during sanding and application and for a period after installation. Personal Protective Equipment may also be required. The manufacturer's recommendations for use must be carefully considered at all times.

7. CONFINED SPACES

EXCAVATION

Construction of this building and some maintenance on the building will require excavation and installation of items within excavations. Where practical, installation should be carried out using methods which do not require workers to enter the excavation. Where this is not practical, adequate support for the excavated area should be provided to prevent collapse. Warning signs and barriers to prevent accidental or unauthorised access to all excavations should be provided.

ENCLOSED SPACES

For buildings with enclosed spaces where maintenance or other access may be required: Enclosed spaces within this building may present a risk to persons

entering for construction, maintenance or any other purpose. The design documentation calls for warning signs and barriers to unauthorised access. These should be maintained throughout the life of the building. Where workers are required to enter enclosed spaces, air testing equipment and Personal Protective Equipment should be provided.

SMALL SPACES

For buildings with small spaces where maintenance or other access may be required: Some small spaces within this building will require access by construction or maintenance workers. The design documentation calls for warning signs and barriers to unauthorised access. These should be maintained throughout the life of the building. Where workers are required to enter small spaces they should be scheduled so that access is for short periods. Manual lifting and other manual activity should be restricted in small spaces.

8. PUBLIC ACCESS

Public access to construction and demolition sites and lo areas under maintenance causes risk to workers and public. Warning signs and secure barriers to unauthorised access should be provided. Where electrical installations, excavations, plant or loose materials are present they should be secured when not fully supervised.

9. OPERATIONAL USE OF BUILDING RESIDENTIAL BUILDINGS

This building has been designed as a residential building. If it, at a later date, it is used or intended to be used as a workplace, the provisions of the Work Health and Safely Act 2011 or subsequent replacement Act should be applied to the new use.


NON-RESIDENTIAL BUILDINGS


For non-residential buildings where the end-use has not been identified: This building has been designed to requirements of the classification identified on the drawings. The specific, use of the building is not known at the time of the design and a further assessment of the workplace health and safety issues should be undertaken at the time of fit-out for the end-user. For non-residential buildings where the end-use is known: This building has been designed for the specific use as identified on the drawings. Where a change of use occurs at a later dale a further assessment of the workplace health and safety issues should be undertaken.

10. OTHER HIGH RISK ACTIVITY

All electrical work should be carried out in accordance with Code of Practice: Managing Electrical Risks at the Workplace, AS/ NZ 3012 and all licensing requirements. All work using Plant should be carried out in accordance with Code of Practice: Managing Risks of Plant at the Workplace. All work should be carried out in accordance with Code of Practice: Managing Noise and Preventing Hearing Loss at Work. Due to the history of serious incidents it is recommended that particular care be exercised when undertaking work involving steel construction and concrete placement. All the above applies.



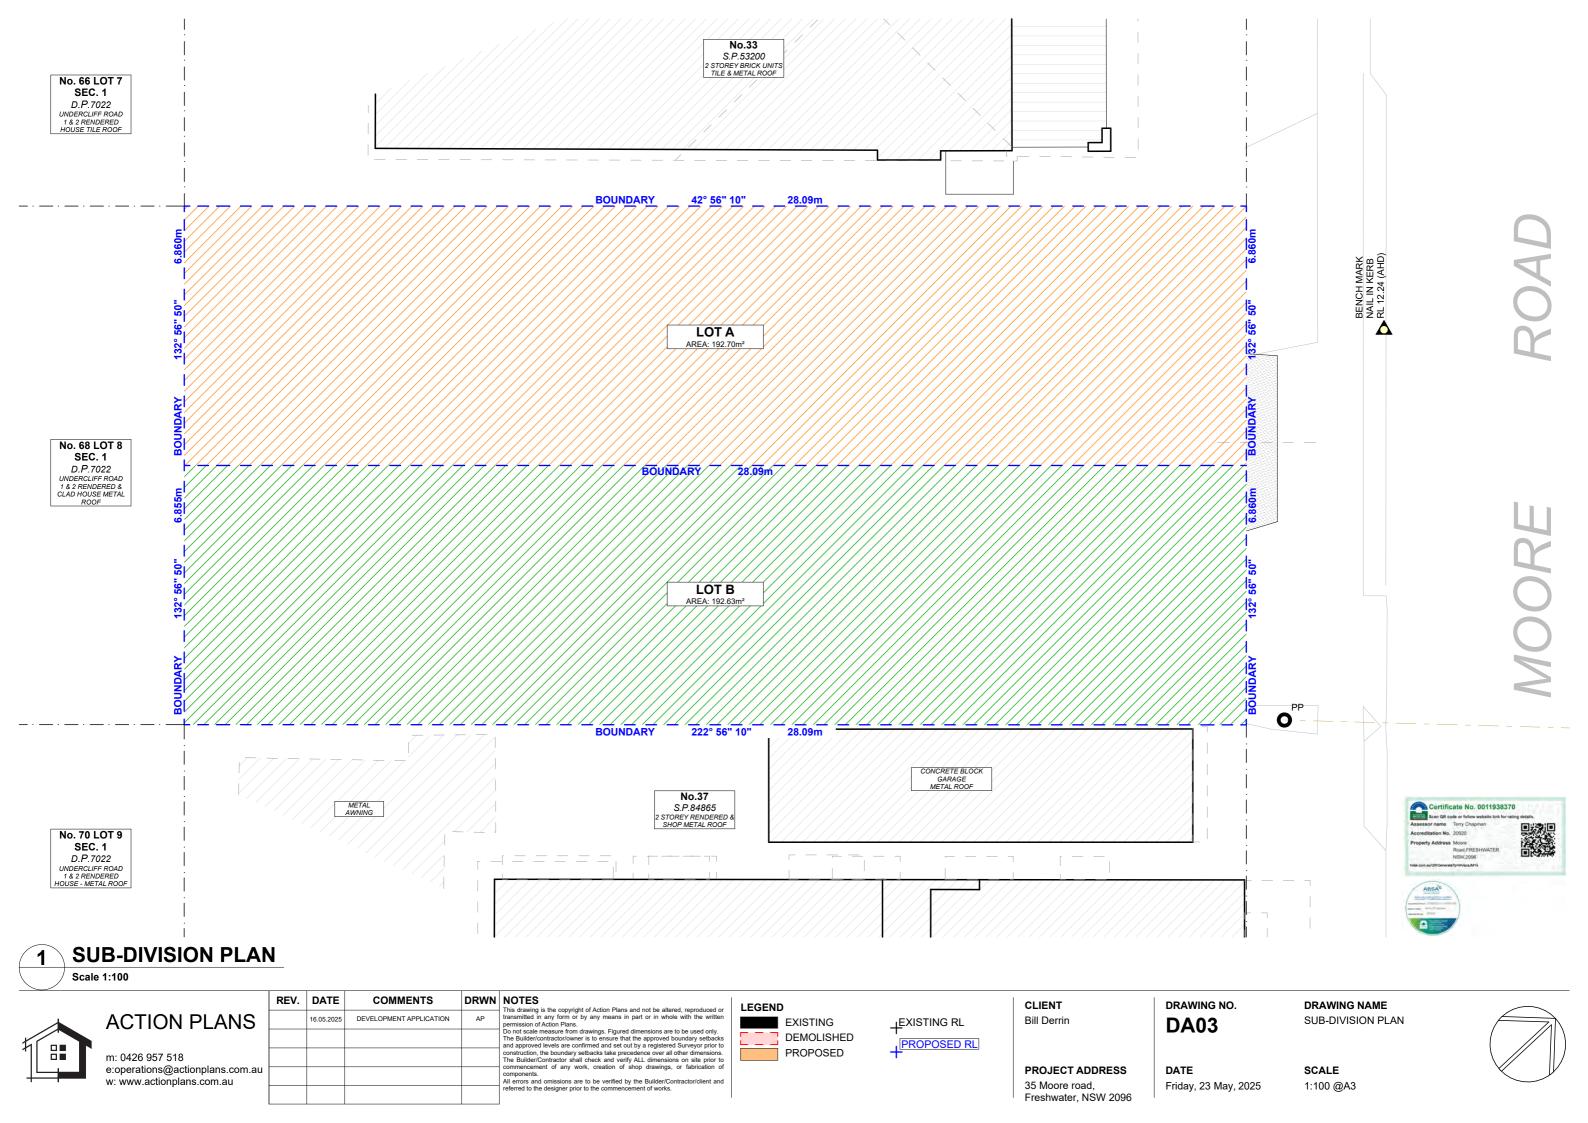

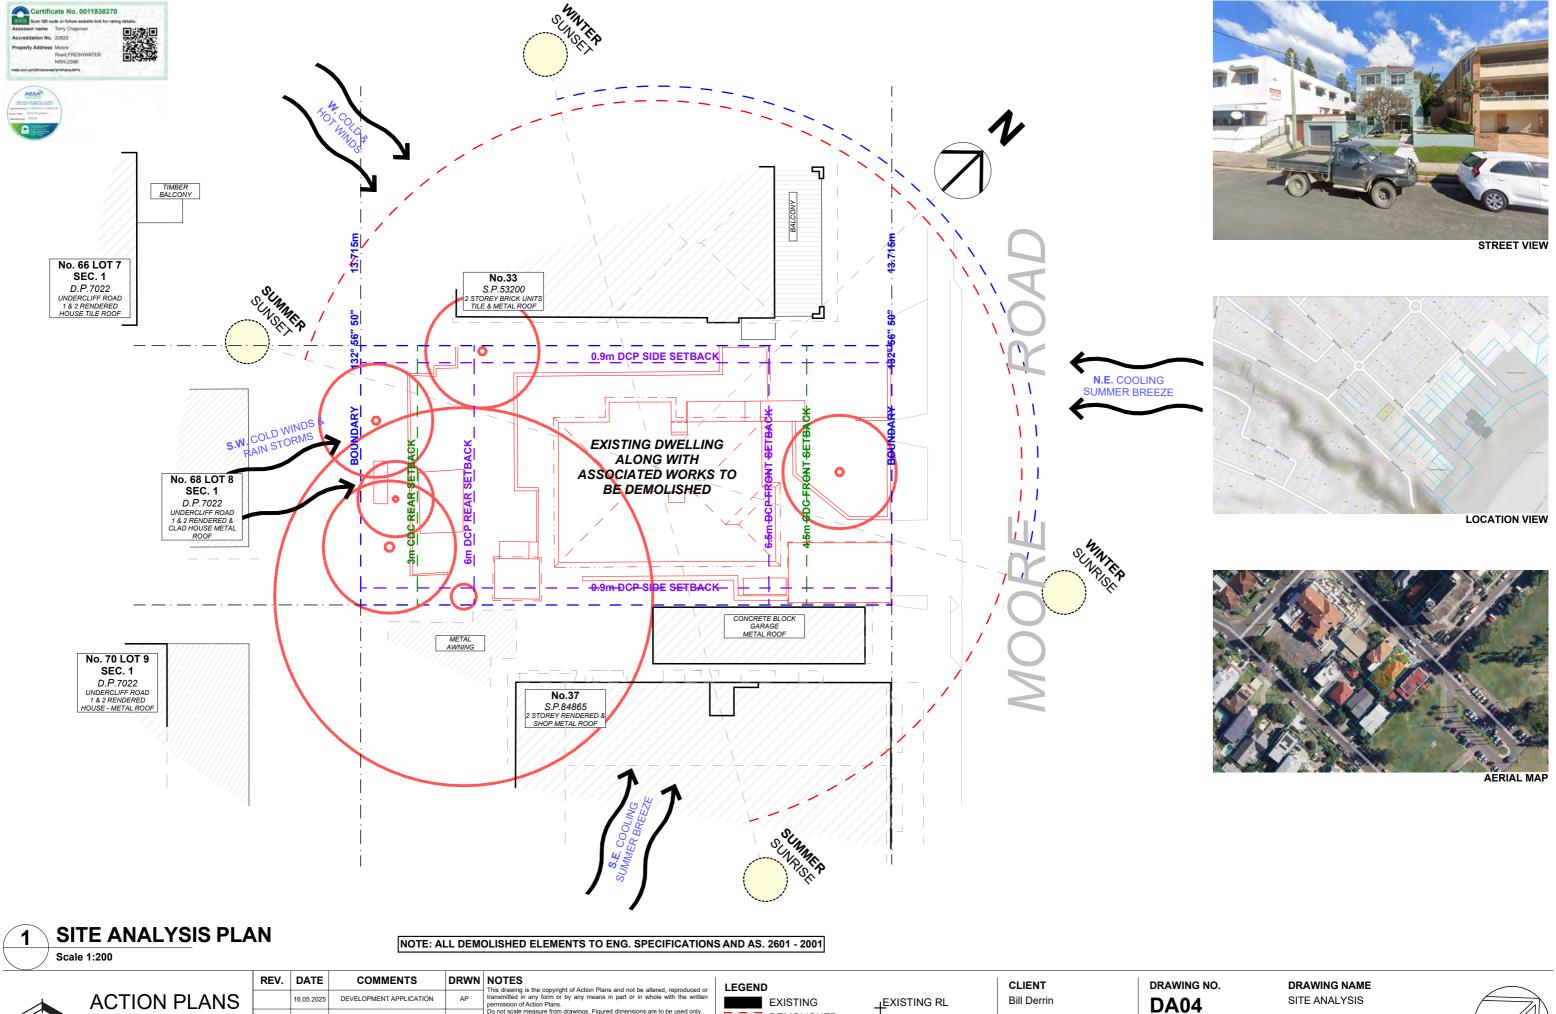

DEMOLISHED

PROPOSED

Do not scare inequire from forming single dimensions are to be asset only. The Builderic microtractoriowners is to ensure that the approved boundary setbacks and onstruction levels are confirmed and set out by a registered Surveyor prior to construction, the boundary setbacks take precedence over all other dimensions. The BuilderiContract of shall check and verify ALL dimensions on site prior to commencement of any work, creation of shop drawings, or fabrication of

components.

All errors and omissions are to be verified by the Builder/Contract referred to the designer prior to the commencement of works.

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PROPOSED RL

PROJECT ADDRESS

Freshwater, NSW 2096

35 Moore road,


DATE

Friday, 23 May, 2025

SCALE

1:200 @A3

NOTE: SITE BOUNDARY IS TO BE IDENTIFIED BY A
REGISTERED SURVEYOR AND CLEARLY MARKED ON SITE
PRIOR TO COMMENCEMENT OF ANY CONSTRUCTION WORKS.

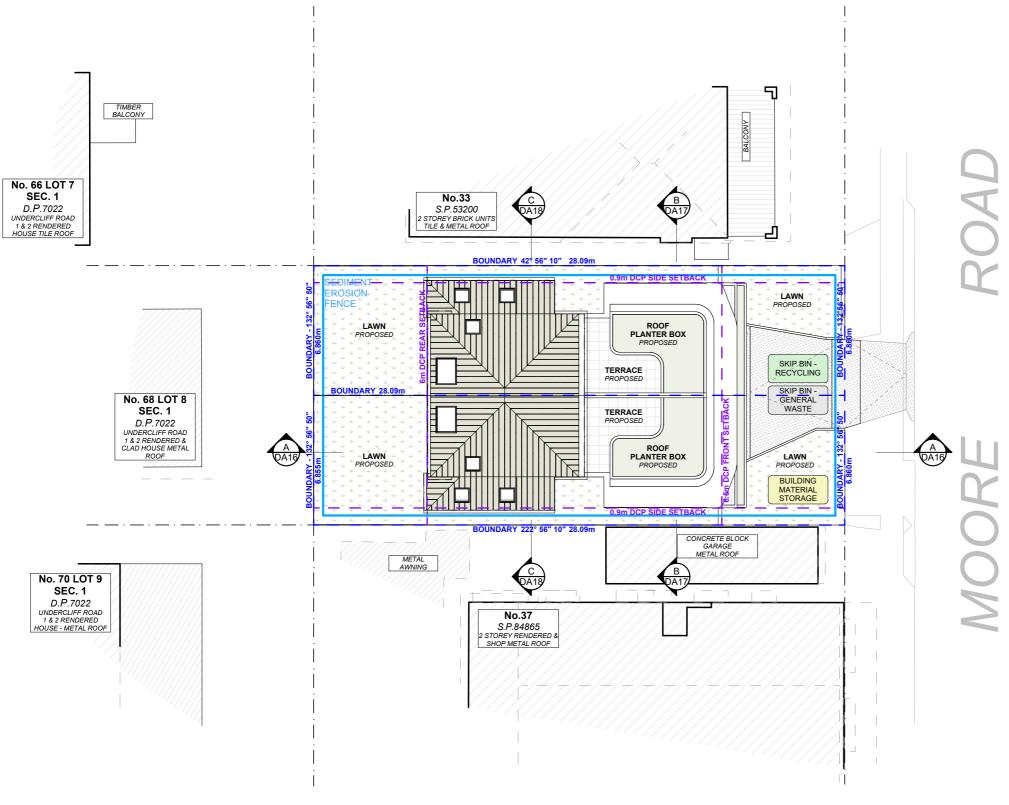

Certificate No. 0011938370

Size Officed or fation websits link for rating details.

Assessor name. Torry Chapman
Accreditation No. 2020

Property Address Moore
Road FRESHMATER.
NSW 2096



NOTES REGARDING BOUNDARY

THE INFORMATION SHOWN ON THIS PLAN IS FOR DESIGN PURPOSES ONLY. THE POSITION OF BOUNDARY LINES HAVE BEEN ESTABLISHED BY A SURVEY TO MEET THE IDENTIFICATION REQUIREMENTS FOR COUNCIL AND NOT FOR REGISTRATION WITH THE LAND REGISTRATION SERVICES NSW NOR MAY THIS PLAN BE USED FOR ANY OTHER PURPOSE. SUBSEQUENT REGISTERED OR OTHER SURVEYS MAY AFFECT THE DEFINED BOUNDARY POSITIONS IN THIS AREA. ANY DIFFERENCES OF THIS NATURE ARE BEYOND THE PURPOSES OF THIS PLAN. THIS PLAN IS FOR THE ABOVE STATED PURPOSES ONLY. RESTRICTIONS ON THE TITLE HAVE NOT BEEN INVESTIGATED. IF FURTHER DEVELOPMENT IS CONTEMPLATED OR CONSTRUCTION INTENDED THEN IT IS IMPORTANT THAT A SURVEY SET OUT IS CARRIED OUT.

DUST CONTROL:

TO REDUCE DUST GENERATED BY WIND ACTION, THE REMOVAL OF THE TOP SOIL IS TO BE MINIMISED. TO PREVENT DUST GENERATION, WATERING DOWN OF THE SITE, ESPECIALLY DURING THE MOVEMENT OF MACHINERY IS REQUIRED. WHERE EXCAVATINGINTO ROCK, KEEP THE SURFACE MOIST TO MINIMISE DUST. CONSTRUCT A GRAVEL ENTRY/EXIT POINT USING BLUE METAL AND RESTRICT ALL VEHICLE MOVEMENTS WITHIN THE SITE TO A MINIMUM. ENSURE WIND BREAKS, SUCH AS EXISTING FENCES ARE MAINTAINED DURING THE CONSTRUCTION PHASE UNTIL NEW LANDSCAPING IS PROVIDED OR REINSTATED. PREVENT DUST BY COVERING STOCKPILES

SEDIMENT NOTE:

- 1. ALL EROSION AND SEDIMENT CONTROL MEASURES TO BE INSPECTED AND MAINTAINED DAILY BY THE SITE MANAGER.
- 2. MINIMISE DISTURBED AREAS, REMOVE EXCESS SOIL FROM EXCAVATEDAREA AS SOON AS POSSIBLE.
 3. ALL MATERIAL STOCKPILE TO BE CLEAR FROM DRAINS, GUTTERS AND FOOTPATHS, OR WITHIN SEDIMENT FENCE
- 4. DRAINAGE TO BE CONNECTED TO STORMWATERAS SOON AS POSSIBLE. IF STORED ON SITE, IT MUST BE FILTERED BEFORE RELEASING INTO STORMWATER SYSTEM OR WATERWAYS.
- 5. ROADS AND FOOTPATHS TO BE SWEPT DAILY.


STOCKPILES:

ALL STOCKPILES ARE TO BE KEPT ON-SITE WHERE POSSIBLE. ANY MATERIALS PLACED ON THE FOOTPATHS OR NATURE STRIPS REQUIRE COUNCIL'S PERMISSION. ALL STOCKPILES ARE TO BE PLACED AWAY FROM THE DRAINAGE LINES AND STREET GUTTERS. IT IS BEST TO LOCATE THESE ON THE HIGHEST PART OF THE SITE IF POSSIBLE. PLACE WATERPROOF COVERING OVER STOCKPILES. IF REQUIRED PROVIDE DIVERSION DRAIN & BANK AROUND STOCKPILES.

GUTTER PROTECTION:

PROVIDE PROTECTION TO DOWNHILL GRATE IN GUTTER BY MEANS OF SAND BAGS OR BLUE METAL WRAPPED IN GEOTEXTILE FABRIC. WHEN SOIL OR SAND BUILDS UP AROUND THIS SEDIMENT BARRIER, THE MATERIAL SHOULD BE RELOCATED BACK TO THE SITE FOR DISPOSAL.

NOTE: ALL PROPOSED STORMWATER
TO CONNECT WITH EXISTING

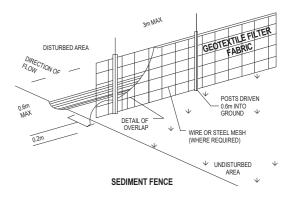


SITE / ROOF / SEDIMENT EROSION / WASTE MANAGEMENT / STORMWATER CONCEPT PLAN


Scale 1:200




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CLIENT Bill Derrin

35 Moore road,

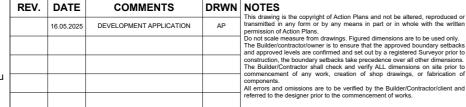Freshwater, NSW 2096

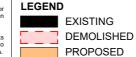PROJECT ADDRESS

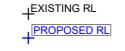RESS DATE Friday, 23 May, 2025

TREE PROTECTION


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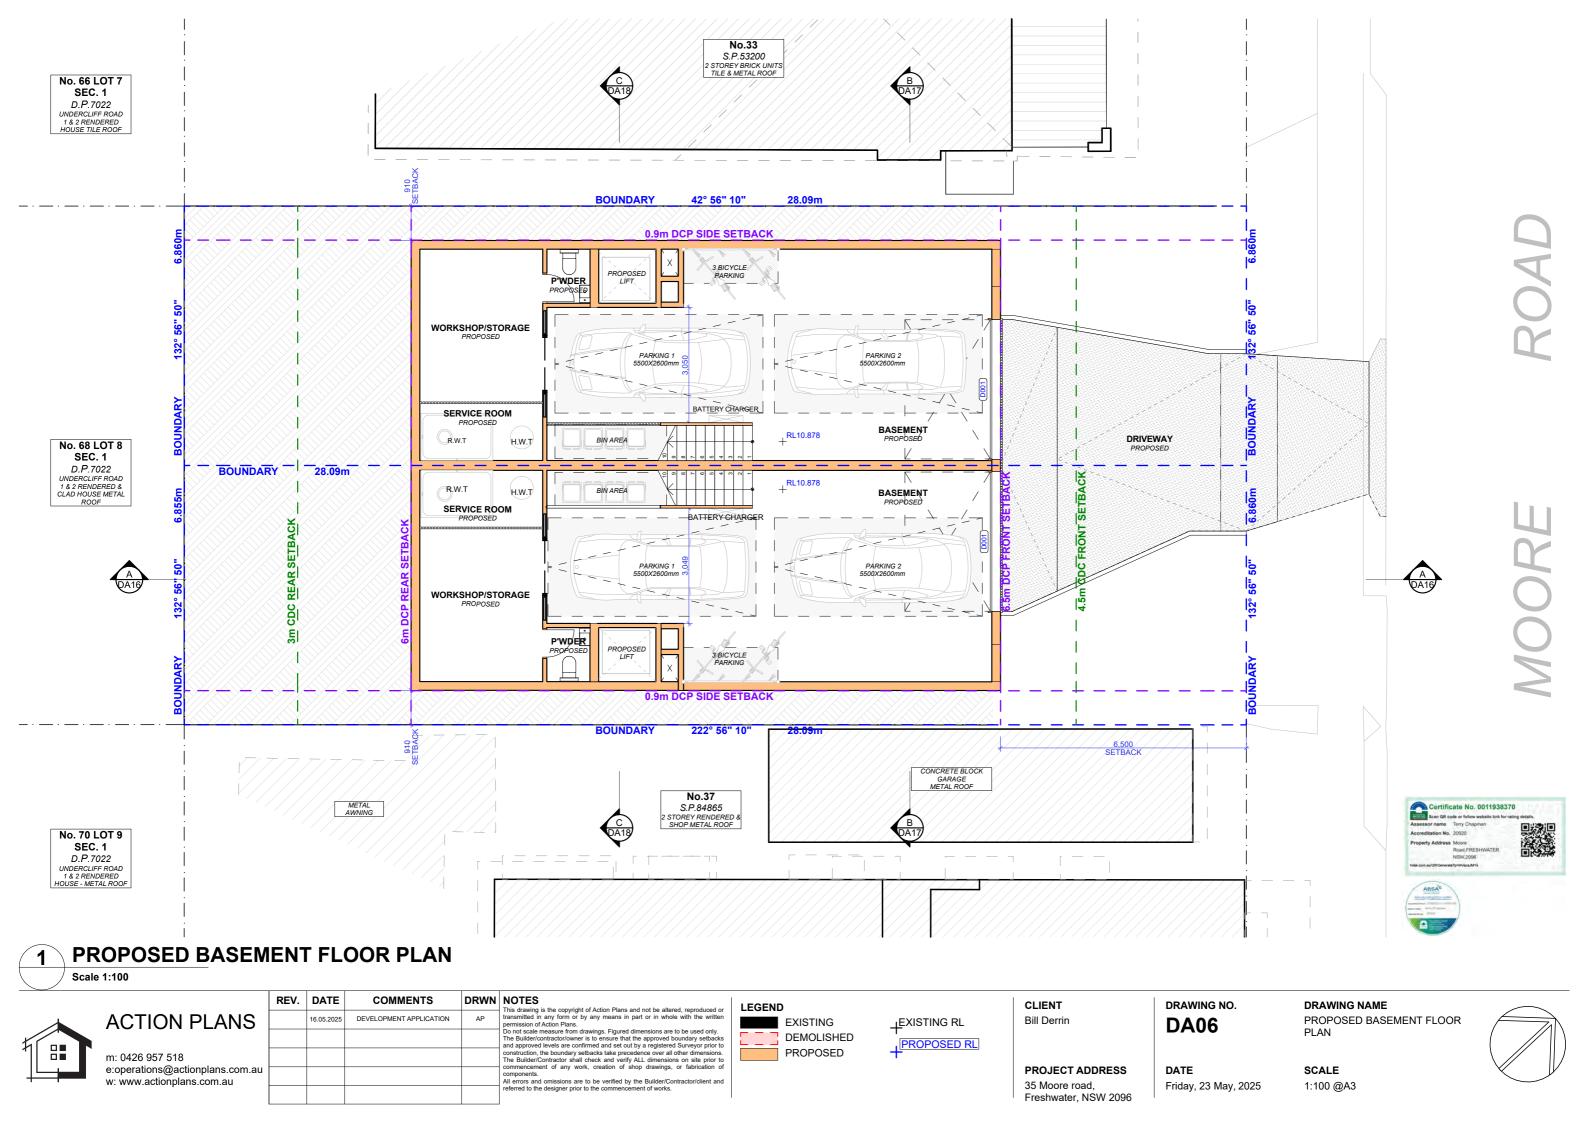
DA05


DRAWING NAME

SITE / SEDIMENT EROSION / WASTE MANAGEMENT





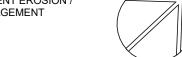

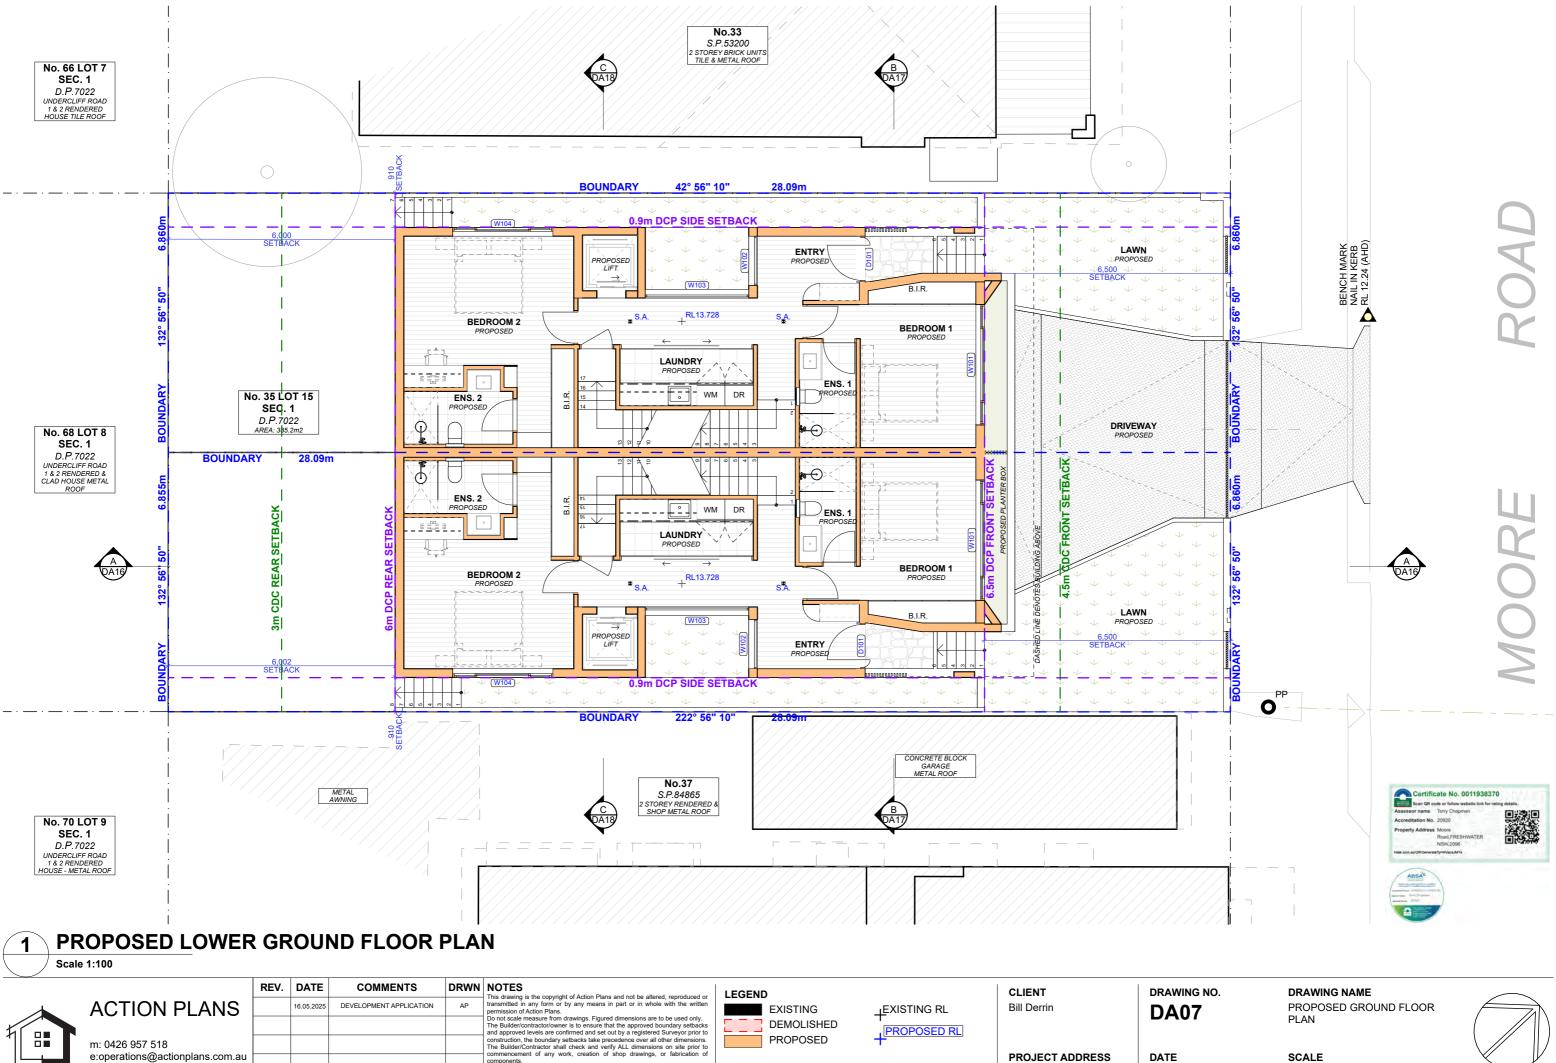

PROPOSED

components.

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PROJECT ADDRESS

Freshwater, NSW 2096

35 Moore road,

DATE

Friday, 23 May, 2025


SCALE

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components.

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35 Moore road,

DATE


Friday, 23 May, 2025

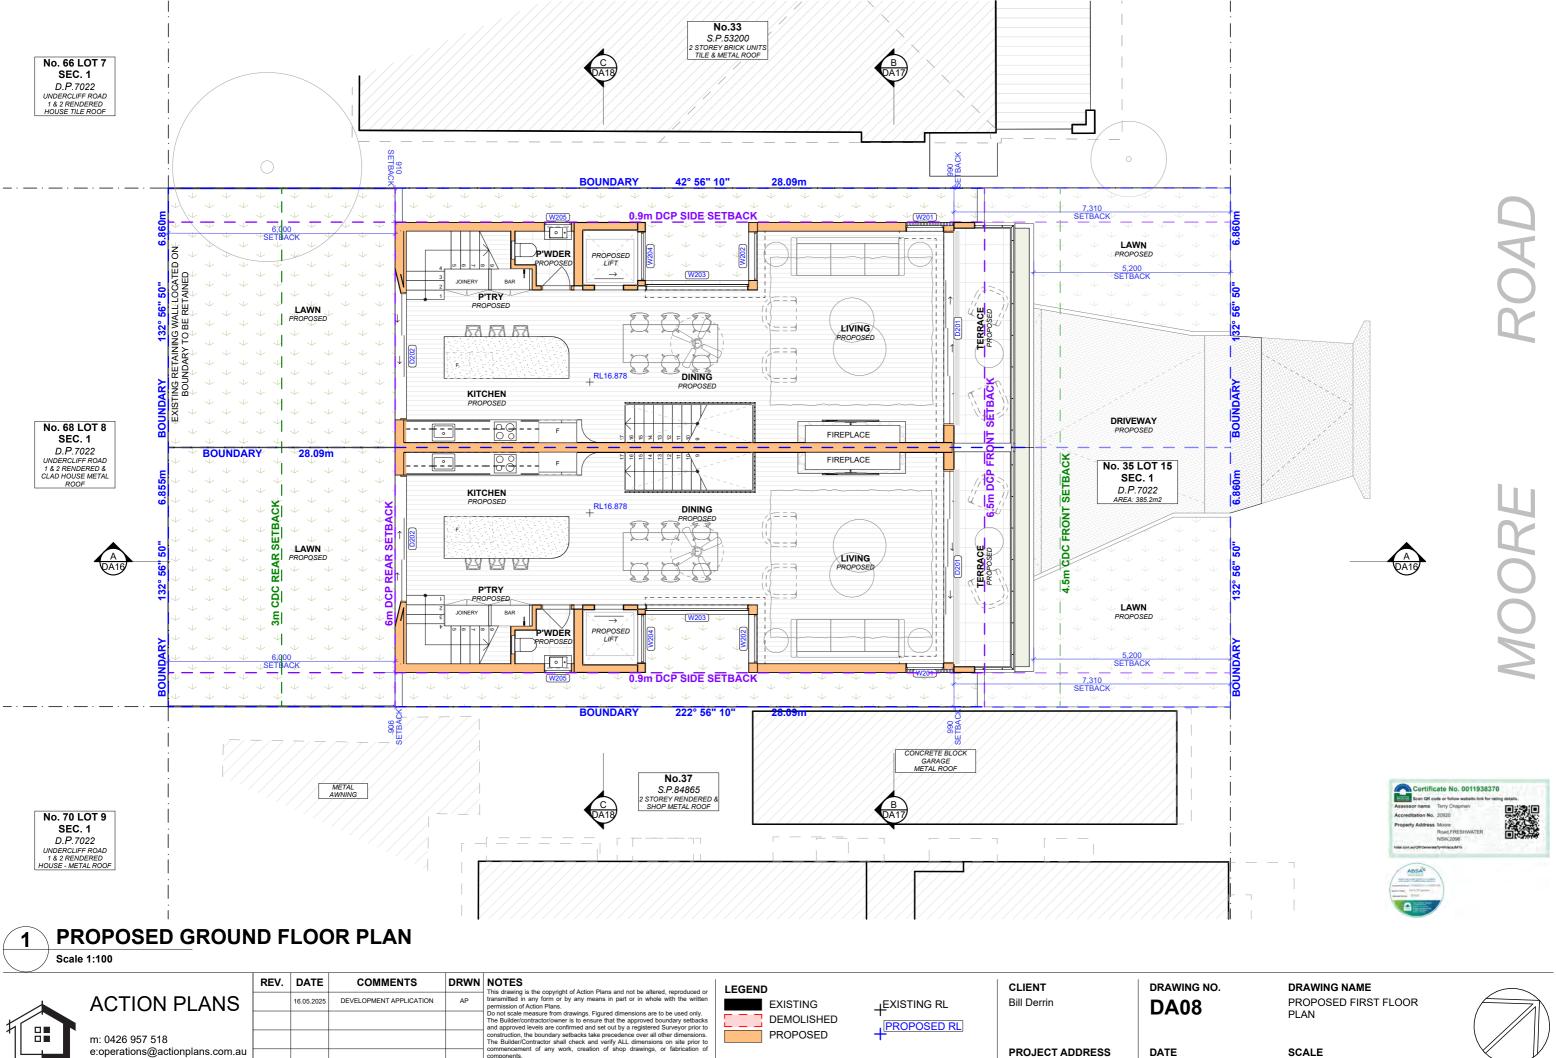
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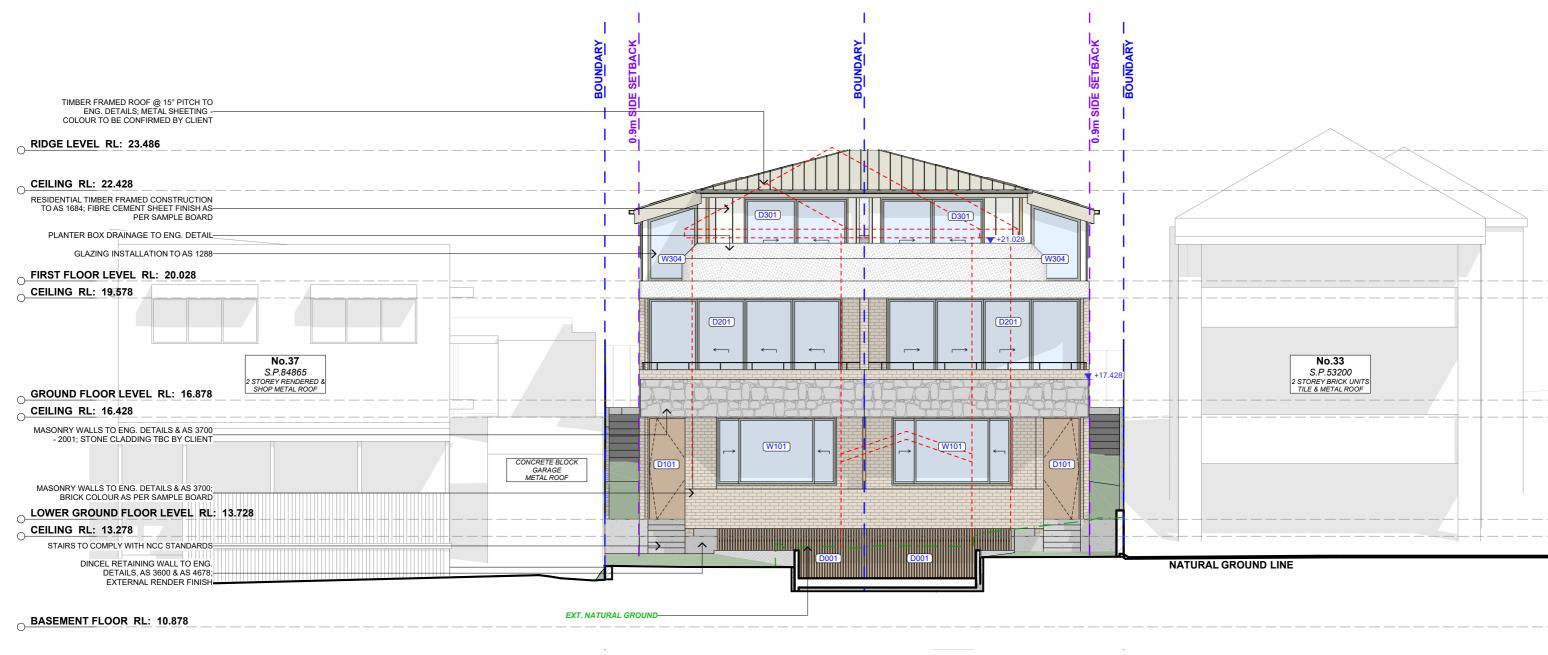
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NORTH EAST ELEVATION Scale 1:100

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| CLIENT | DRAWING NO. | DRAWING NAME |
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| Bill Derrin | DA11 | NORTH EAST ELEVATION |
| | | |
| PROJECT ADDRESS | DATE | SCALE |


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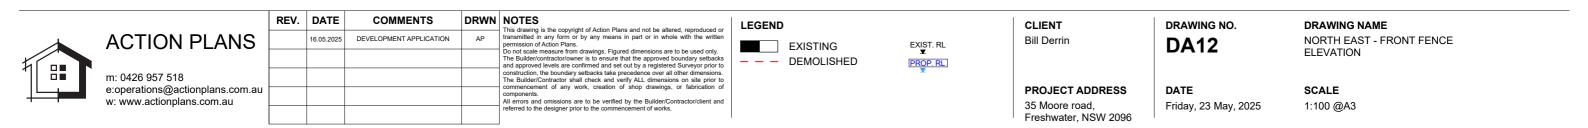
Friday, 23 May, 2025

35 Moore road,

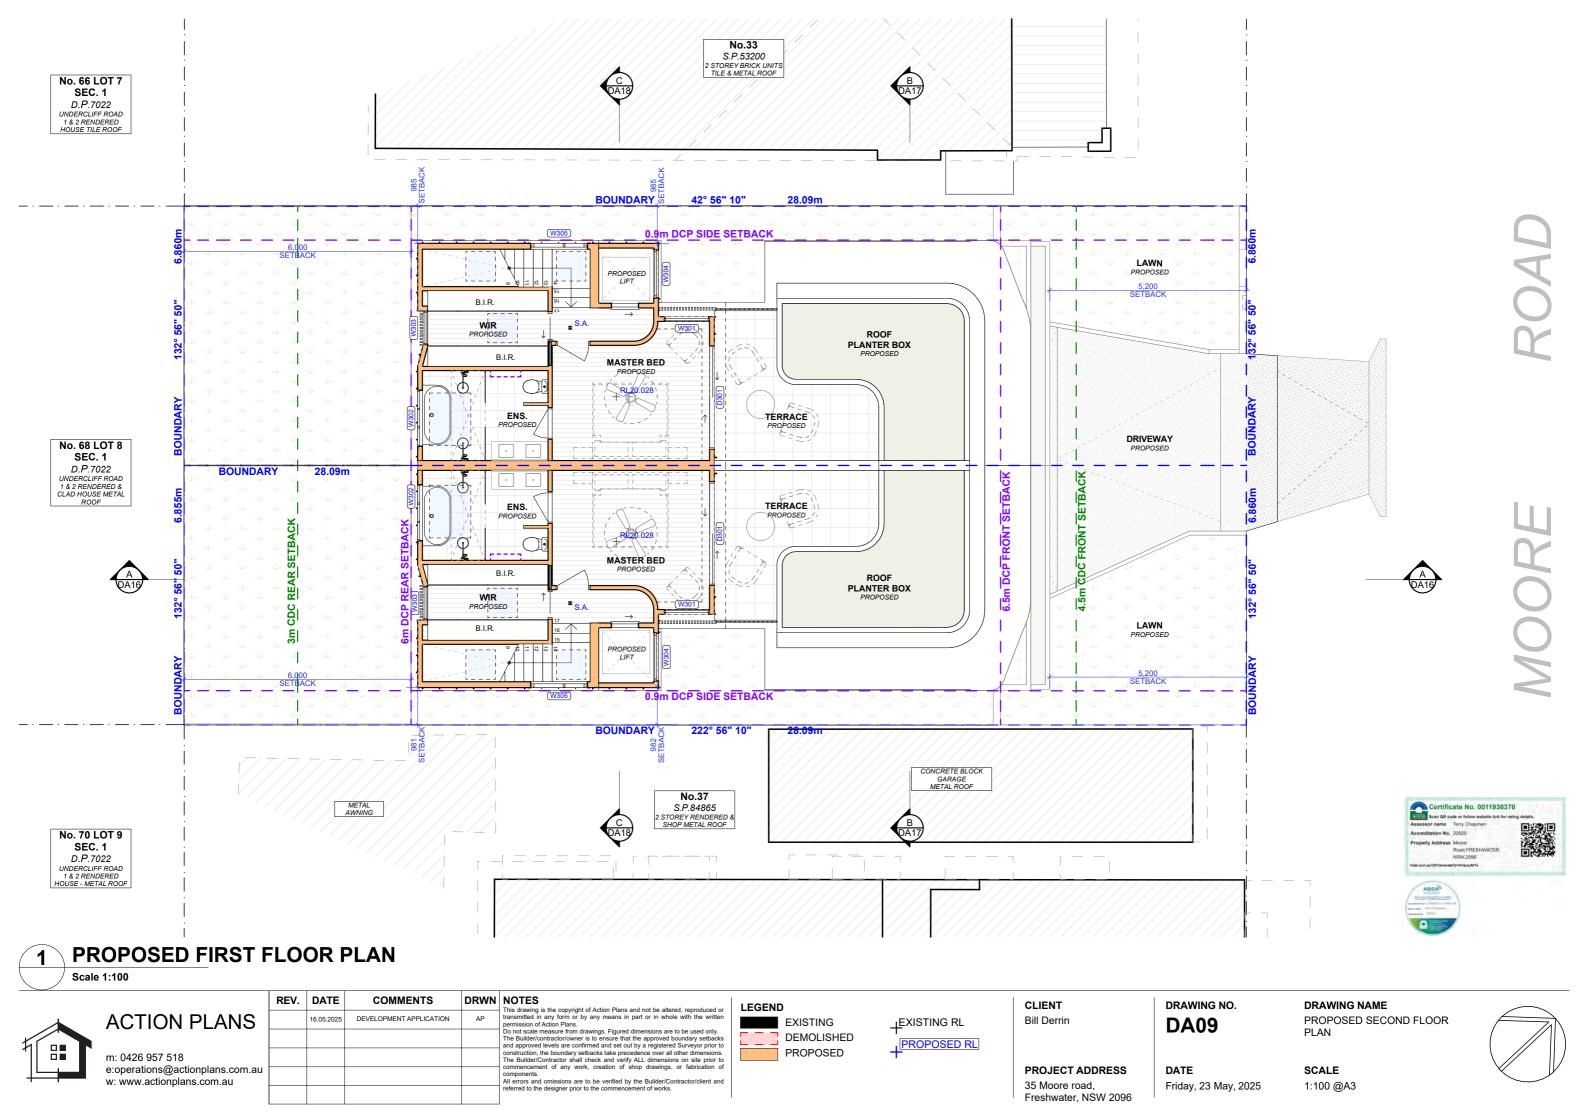
Freshwater, NSW 2096

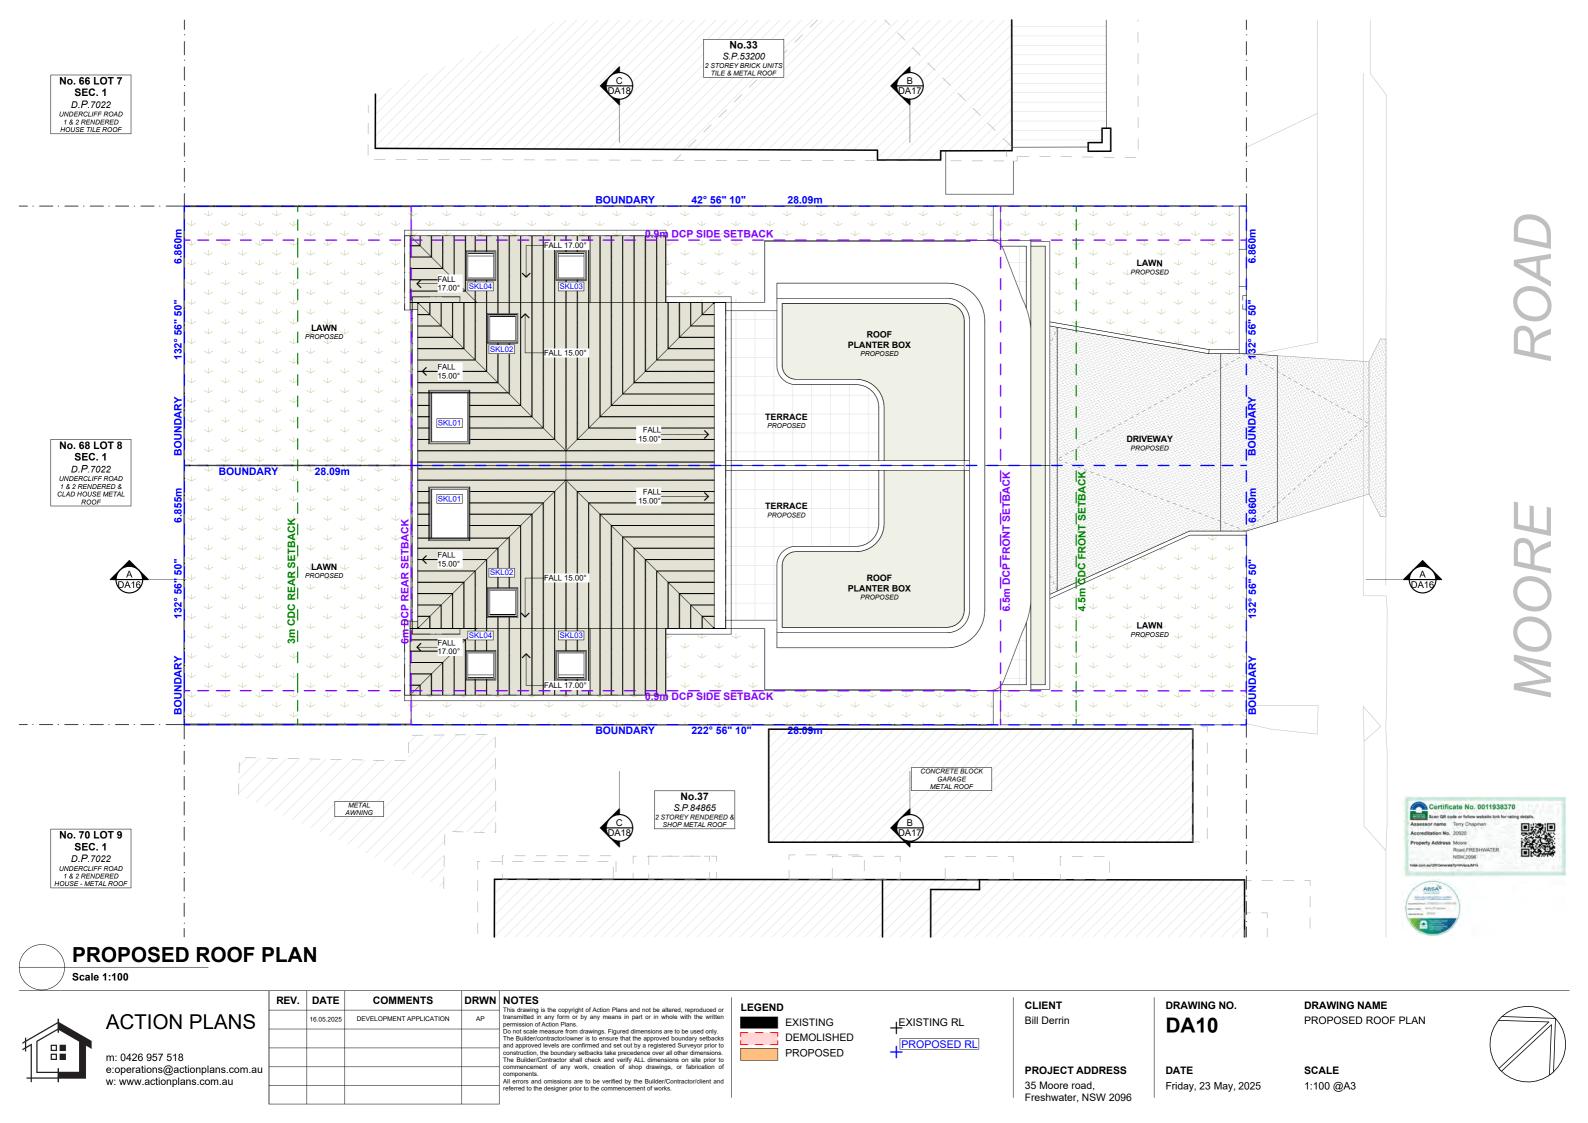



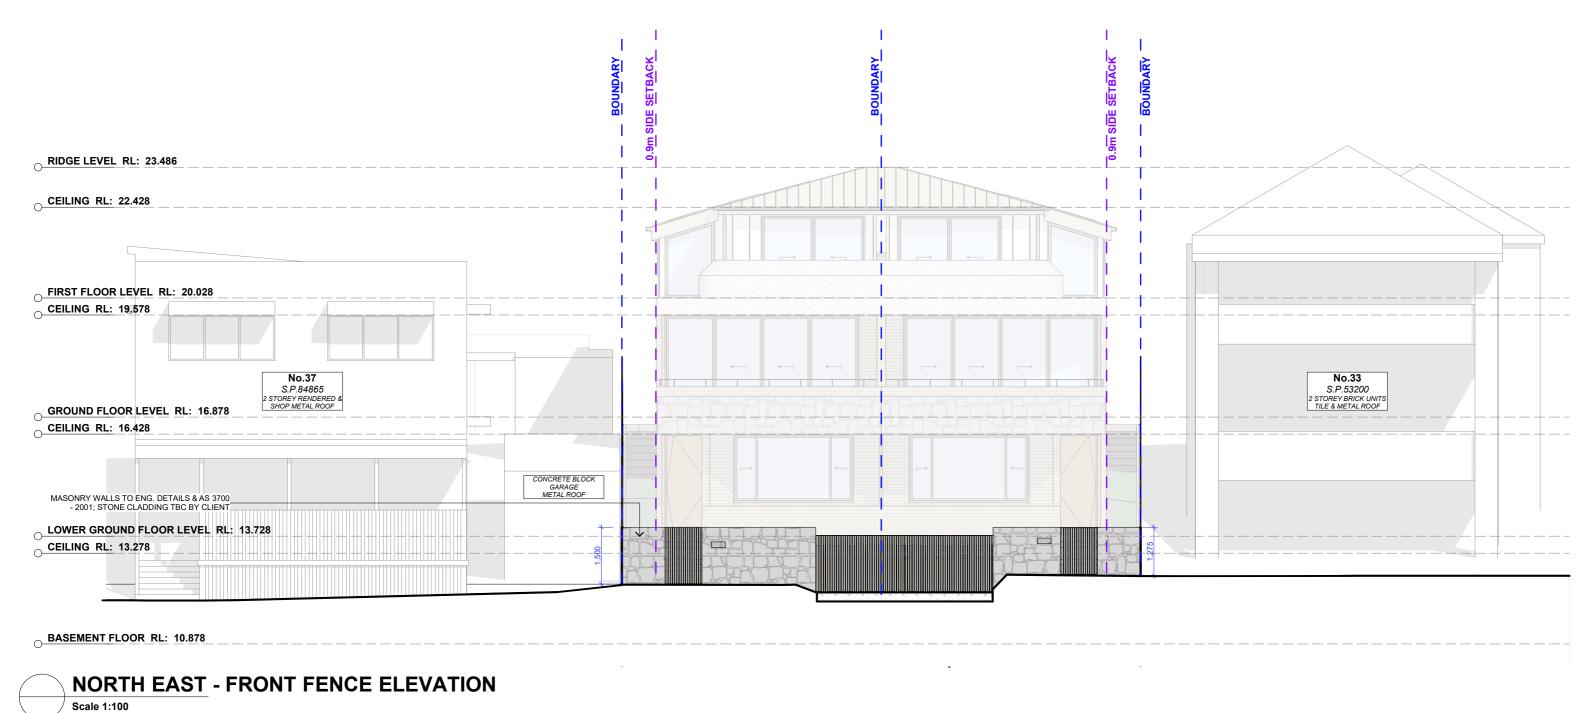



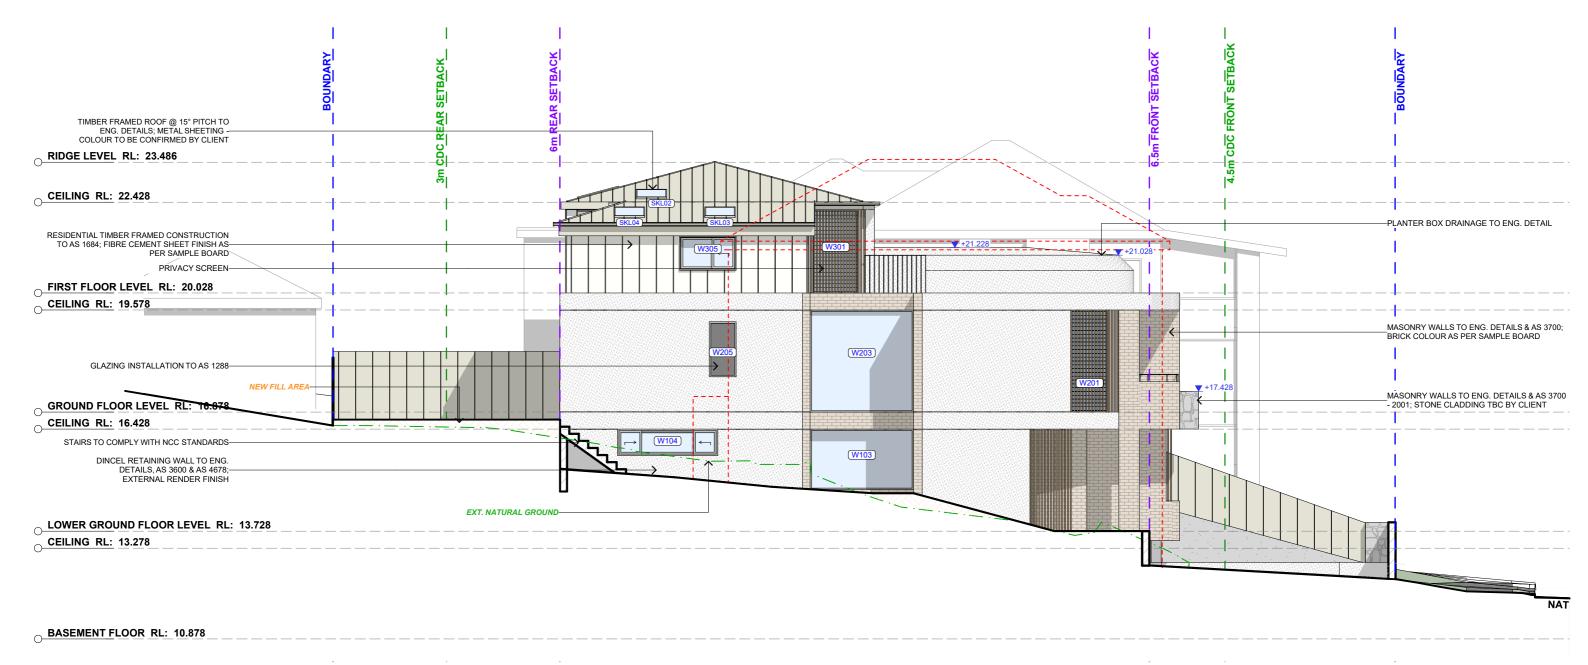





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| CLIENT Bill Derrin | DA13 | DRAWING NAME SOUTH EAST ELEVATION |
|--------------------------------|------------------------------|-----------------------------------|
| PROJECT ADDRESS 35 Moore road, | DATE Friday, 23 May, 2025 | SCALE 1:100 @A3 |

Freshwater, NSW 2096





O LOWER GROUND FLOOR LEVEL RL: 13.728
O CEILING RL: 13.278

BASEMENT FLOOR RL: 10.878

SOUTH WEST ELEVATION

Scale 1:100

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CLIENT DRAWING NO.

Bill Derrin

DA14


wing no. **DRAWING NAME**SOUTH WEST ELEVATION


PROJECT ADDRESS 35 Moore road, Freshwater, NSW 2096

DATEFriday, 23 May, 2025


SCALE 2025 1:100 @A3



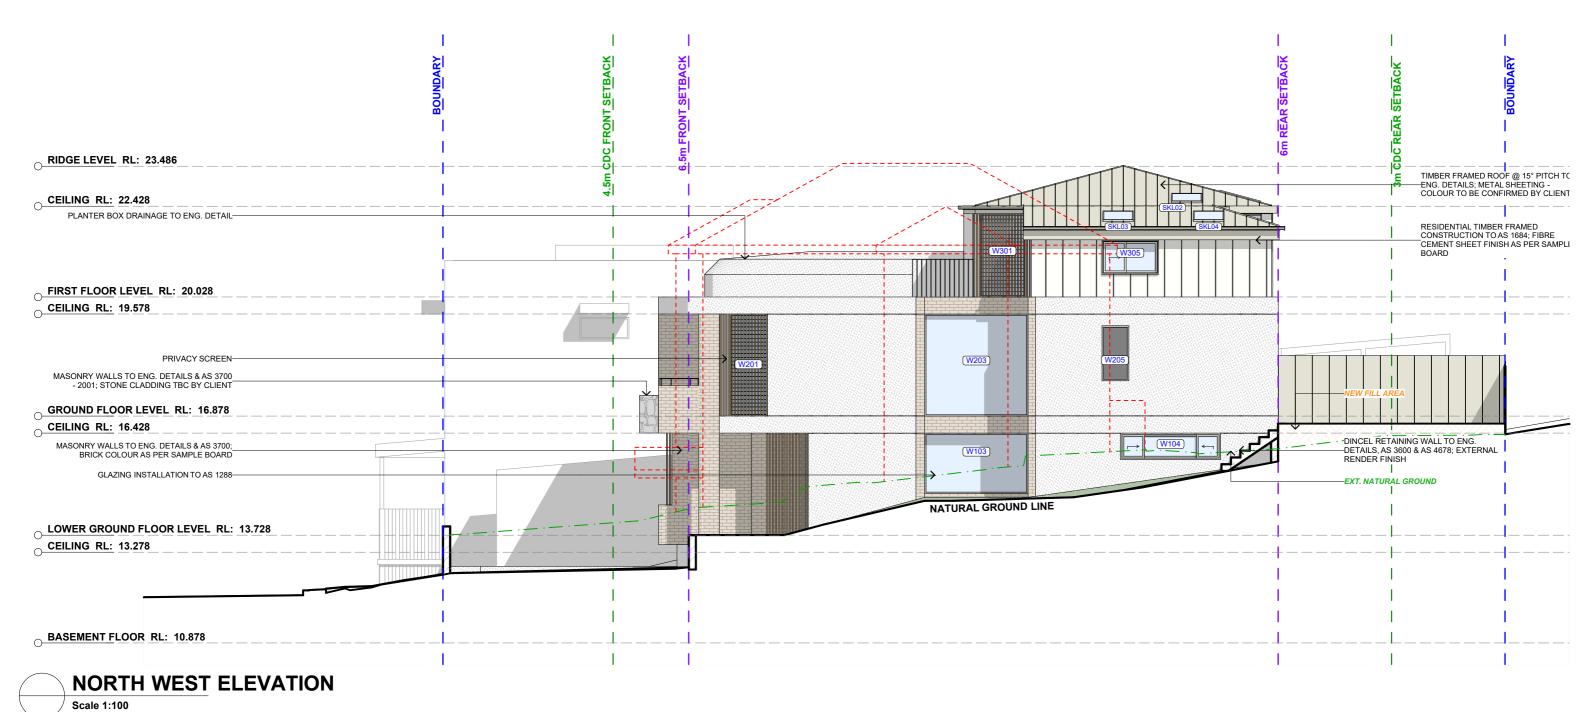

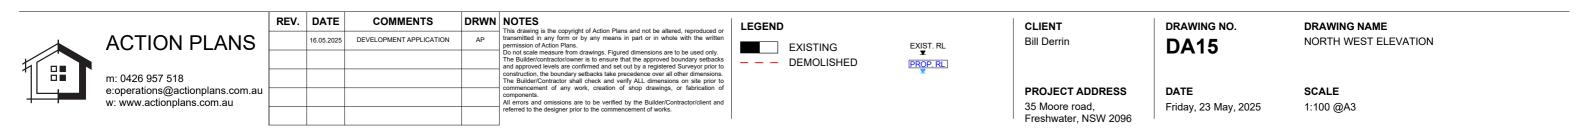




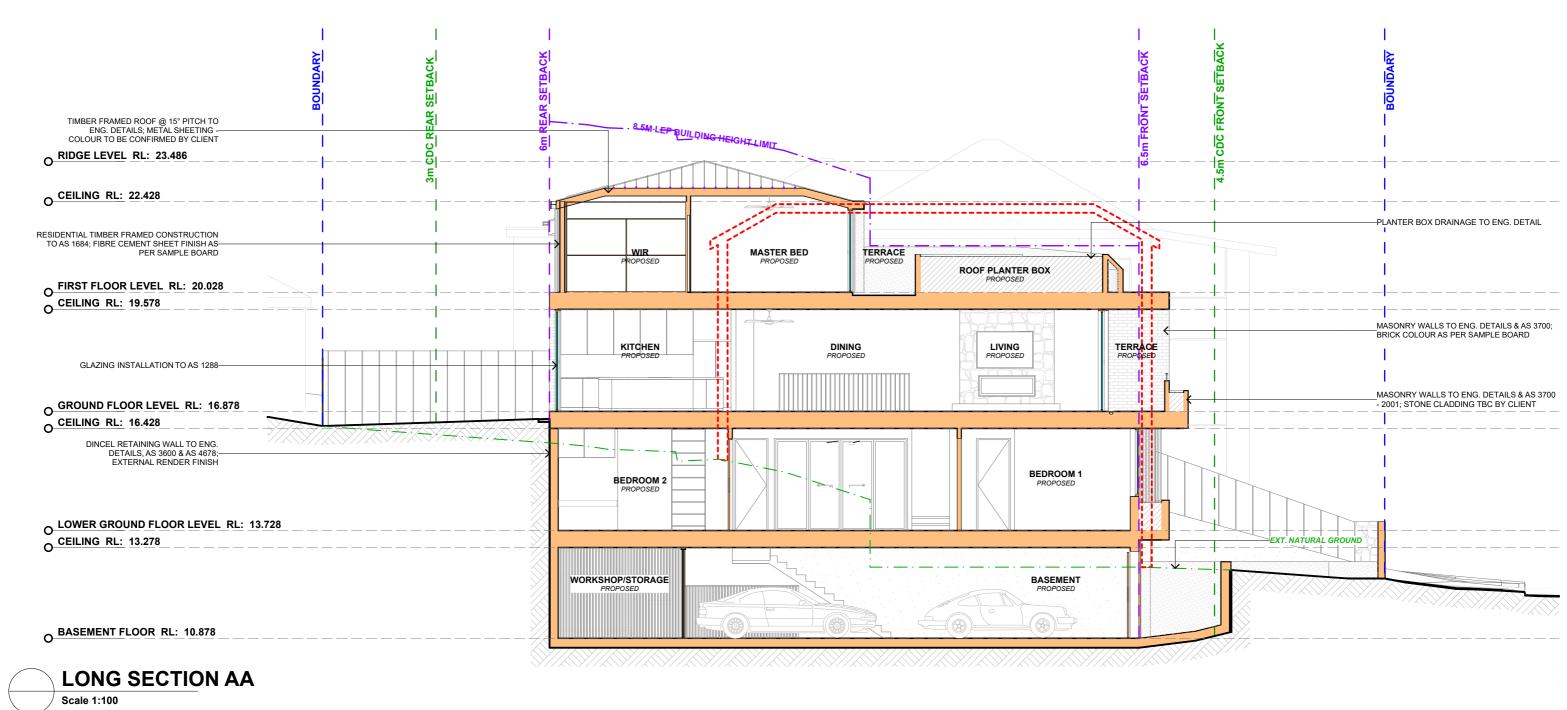



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EXIST. RL ▼ PROP. RL CLIENT DRAWING NO. Bill Derrin

PROJECT ADDRESS

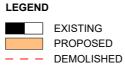Freshwater, NSW 2096

35 Moore road,


DA16

DRAWING NAME LONG SECTION


Friday, 23 May, 2025

SCALE 1:100 @A3



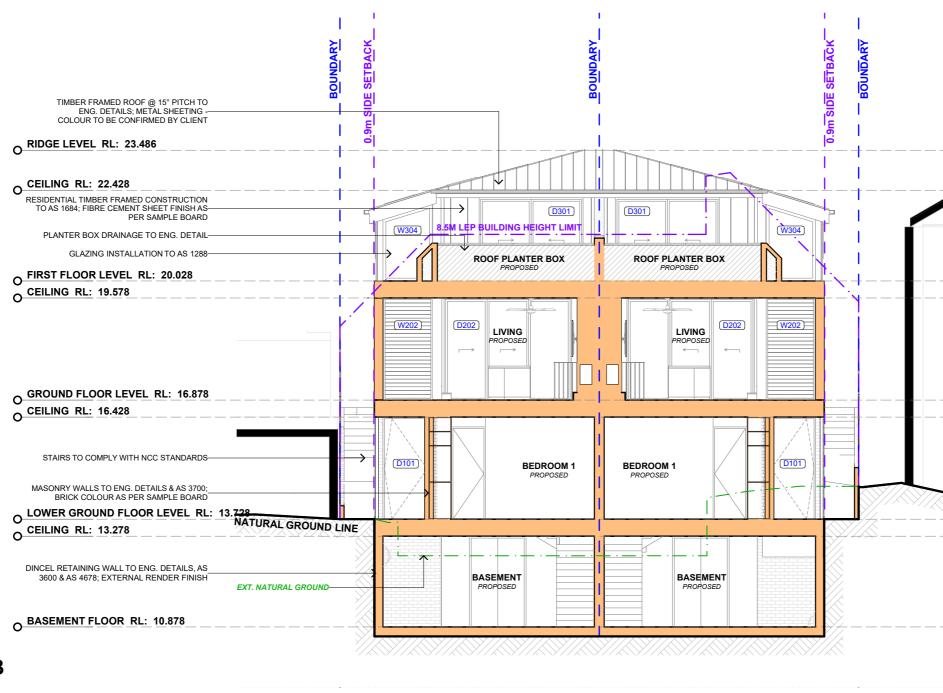


CROSS SECTION B-B
Scale 1:100

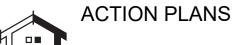

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EXIST. RL

PROP. RL

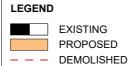CLIENT DRAWING NO.

Bill Derrin

DA17

35 Moore road,

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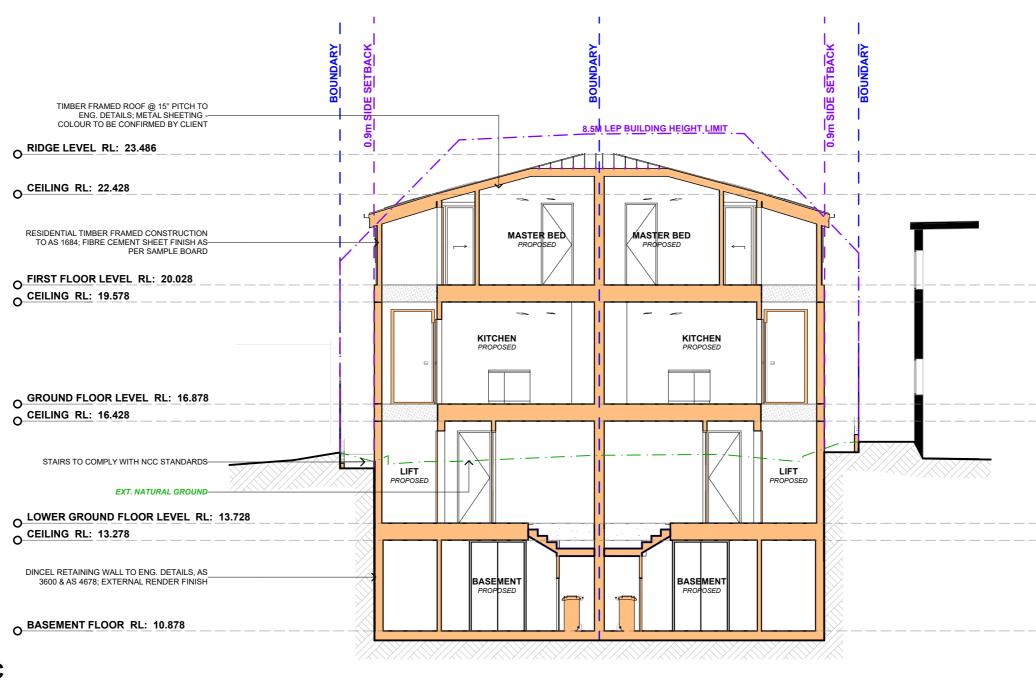
PROJECT ADDRESS DATE

DRAWING NAME CROSS SECTION

DATE Friday, 23 May, 2025

SCALE 2025 1:100 @A3










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CLIENT Bill Derrin

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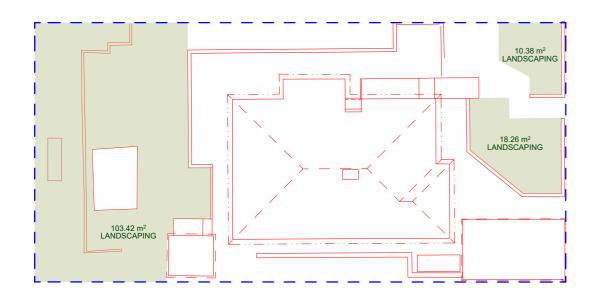
Freshwater, NSW 2096

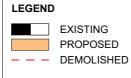35 Moore road,

DRAWING NO. DRAWING NAME CROSS SECTION **DA18**

Friday, 23 May, 2025


SCALE 1:100 @A3





EXISTING AREA CALCULATIONS

Scale 1:200

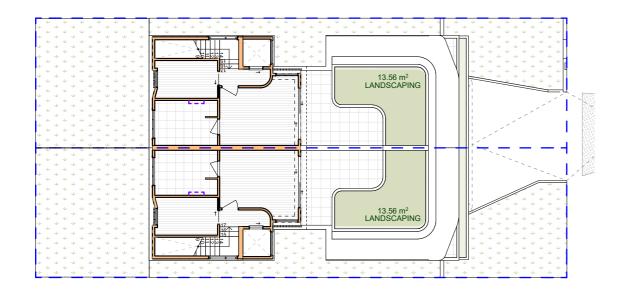



PROPOSED AREA CALCULATIONS - SECOND FLOOR LEVEL

Scale 1:200

SITE AREA: 385.2m²
LANDSCAPE AREA CONTROL: 40% OF SITE AREA (154.08m²)




938370
Init for rating details.

ABSA


ABS

EXISTING LANDSCAPED AREA = 132.06m² (34.28%)

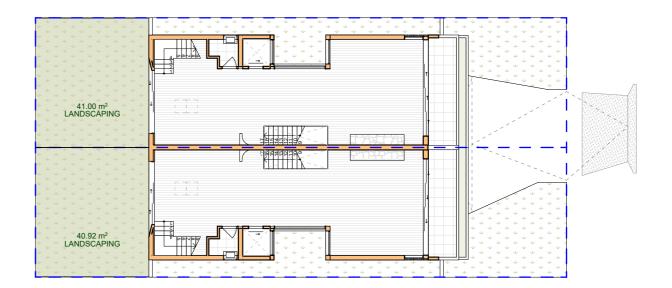

PROPOSED AREA CALCULATIONS - FIRST FLOOR PLAN

Scale 1:200

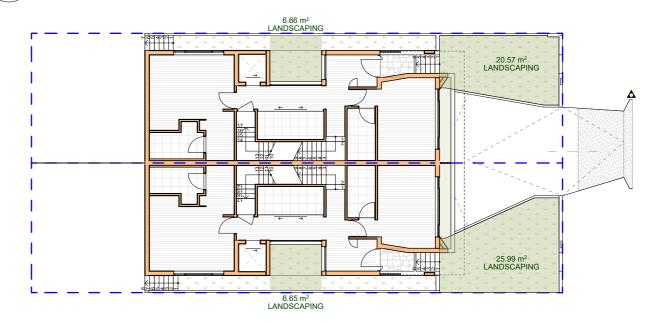

PROPOSED AREA CALCULATIONS - GROUND FLOOR PLAN Scale 1:200

PROPOSED LANDSCAPED AREA = 168.91m² (43.84%)

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LEGEND

LANDSCAPED AREA

CLIENT Bill Derrin

DA19

DRAWING NO. DRAWING NAME
AREA CALCULATIONS

SCALE

1:200 @A3

PROJECT ADDRESS 35 Moore road, Freshwater, NSW 2096

Friday, 23 May, 2025









METAL FRAMED WINDOWS AND **DOORS**



LIGHT COLOURED BRICKWORK



LIGHT COLOURED EXTERNAL RENDER



TIMBER CLAD GARAGE DOORS





LIGHT PAINTED BOARD & BATTEN FIBRE CEMENT SHEETING



REV. DATE

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DRWN NOTES

LEGEND

CLIENT Bill Derrin

DA20

DRAWING NO.


DRAWING NAME SAMPLE BOARD


PROJECT ADDRESS 35 Moore road,

Freshwater, NSW 2096

DATE Friday, 23 May, 2025 SCALE @A3



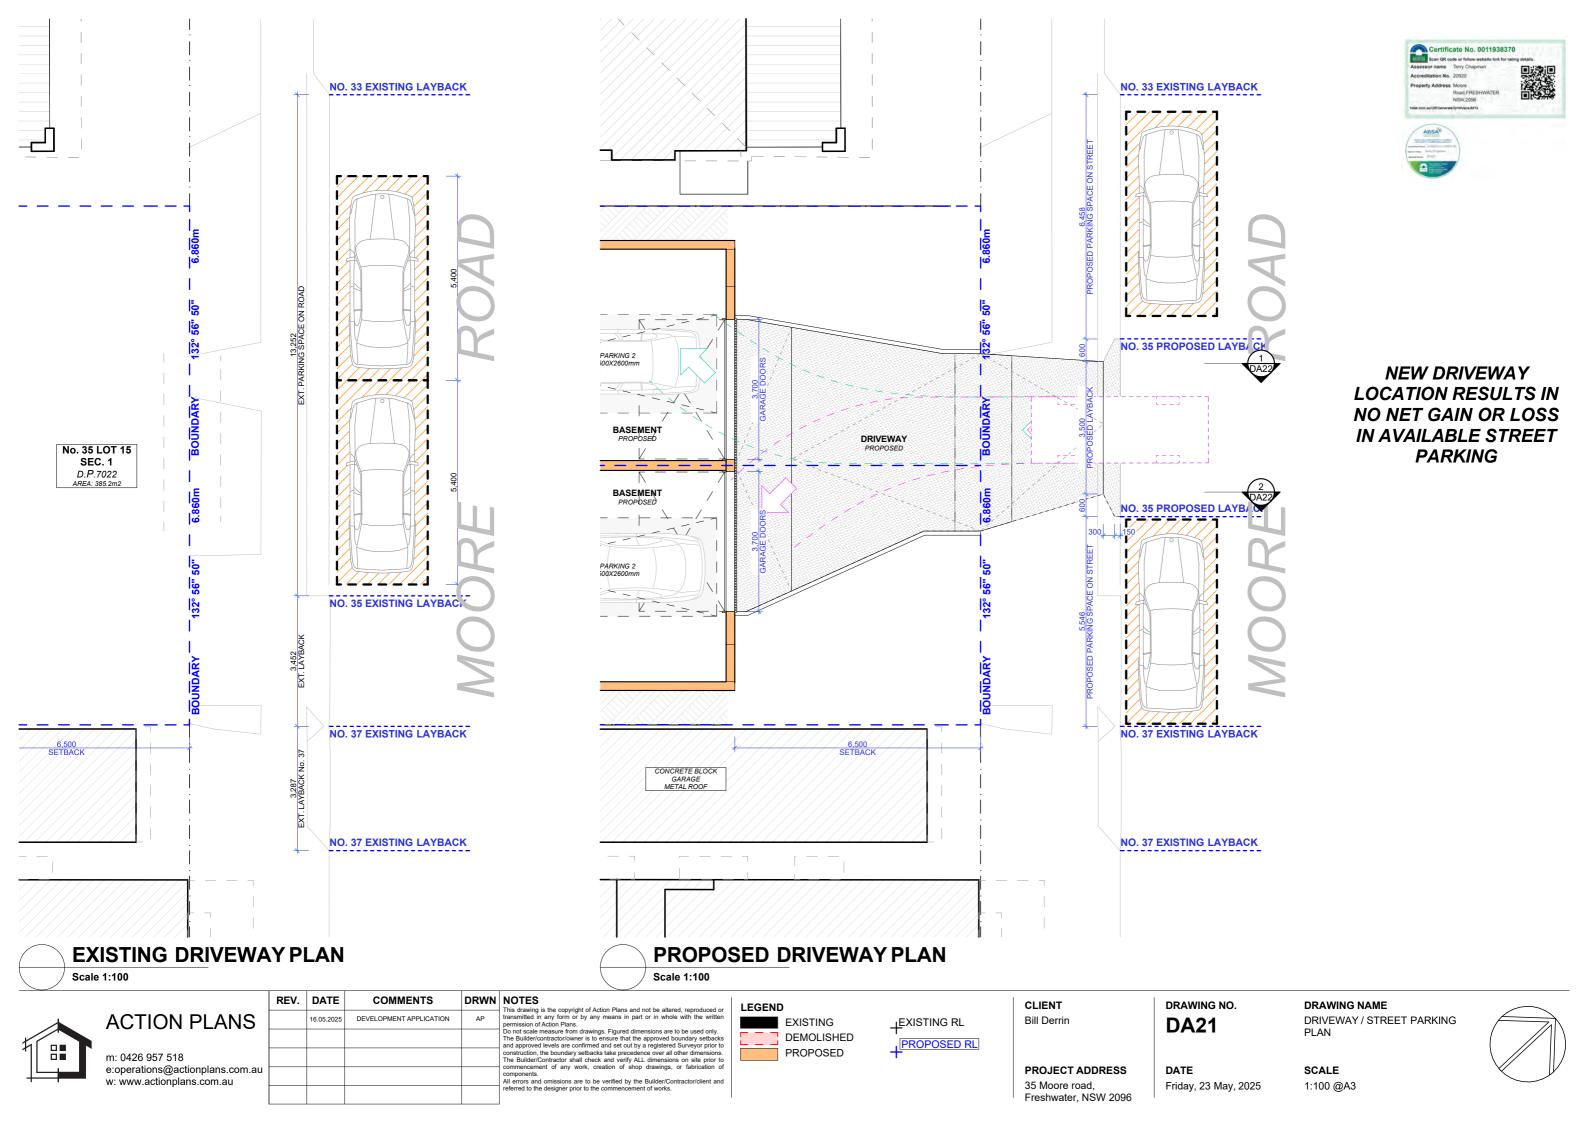


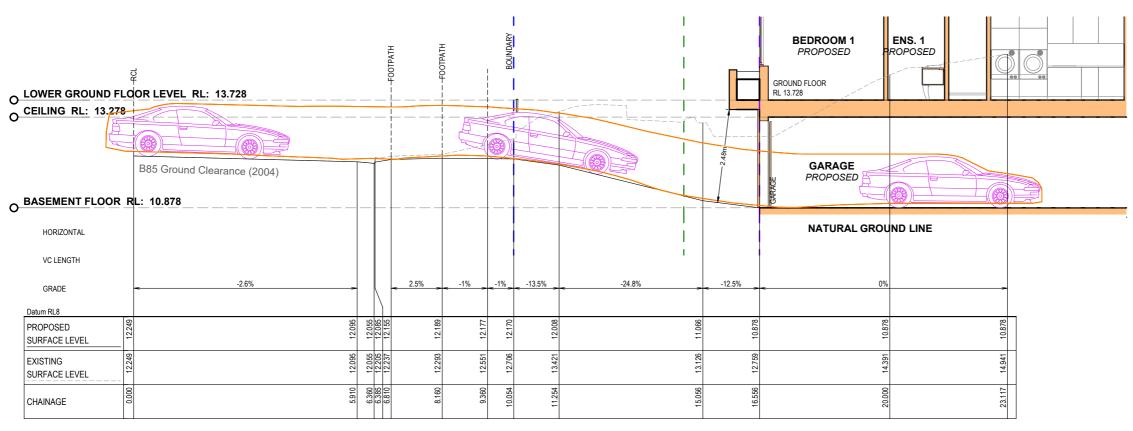



DRIVEWAY LONG SECTION 1

Scale 1:100

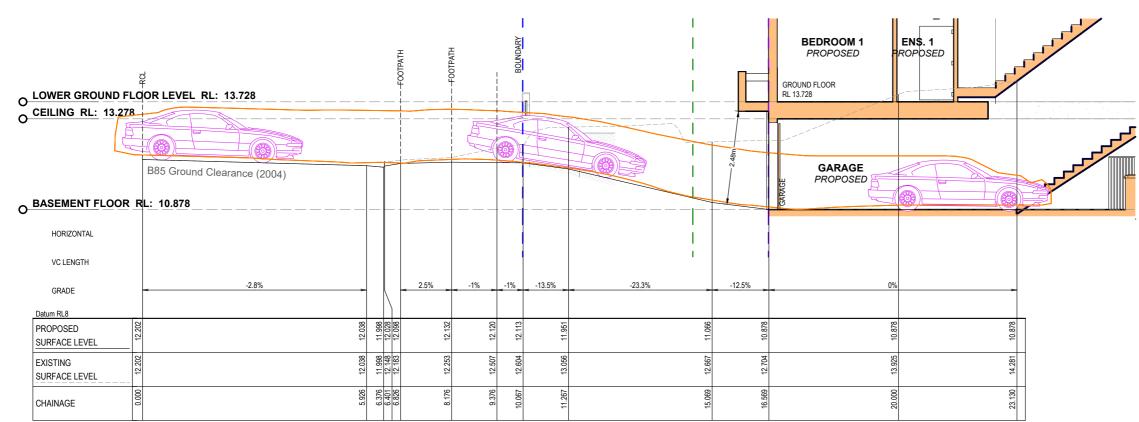

DRIVEWAY LONG SECTION 2

Scale 1:100

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LEGEND

CLIENT Bill Derrin

35 Moore road,

PROJECT ADDRESS

Freshwater, NSW 2096

DA22


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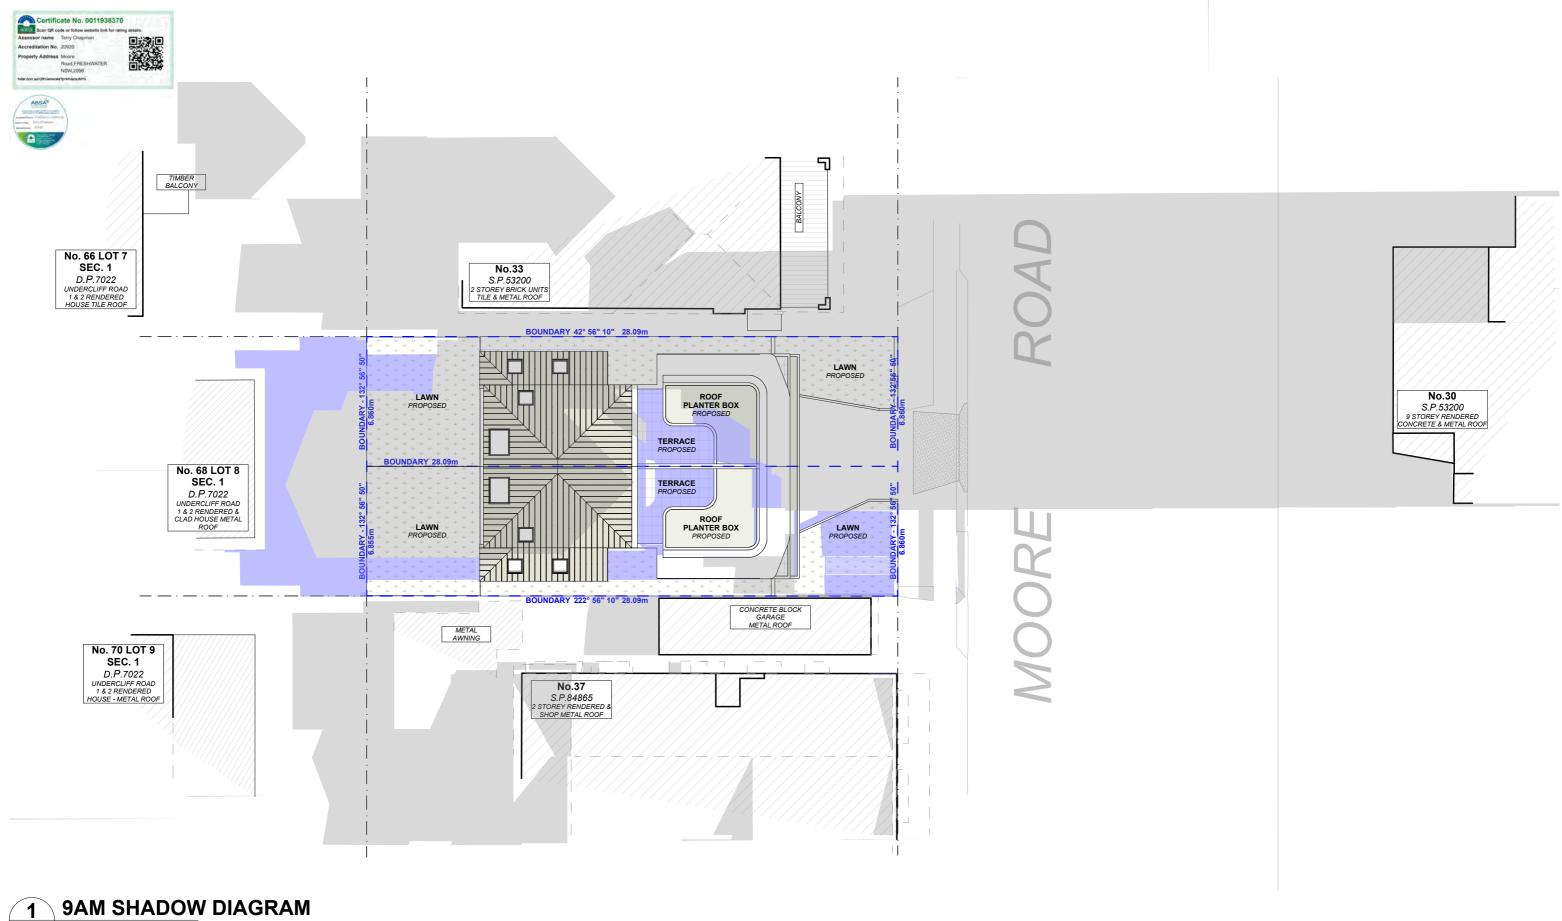
Friday, 23 May, 2025

DRAWING NO.

DRAWING NAME LONG SECTION DRIVEWAY

SCALE 1:100 @A3



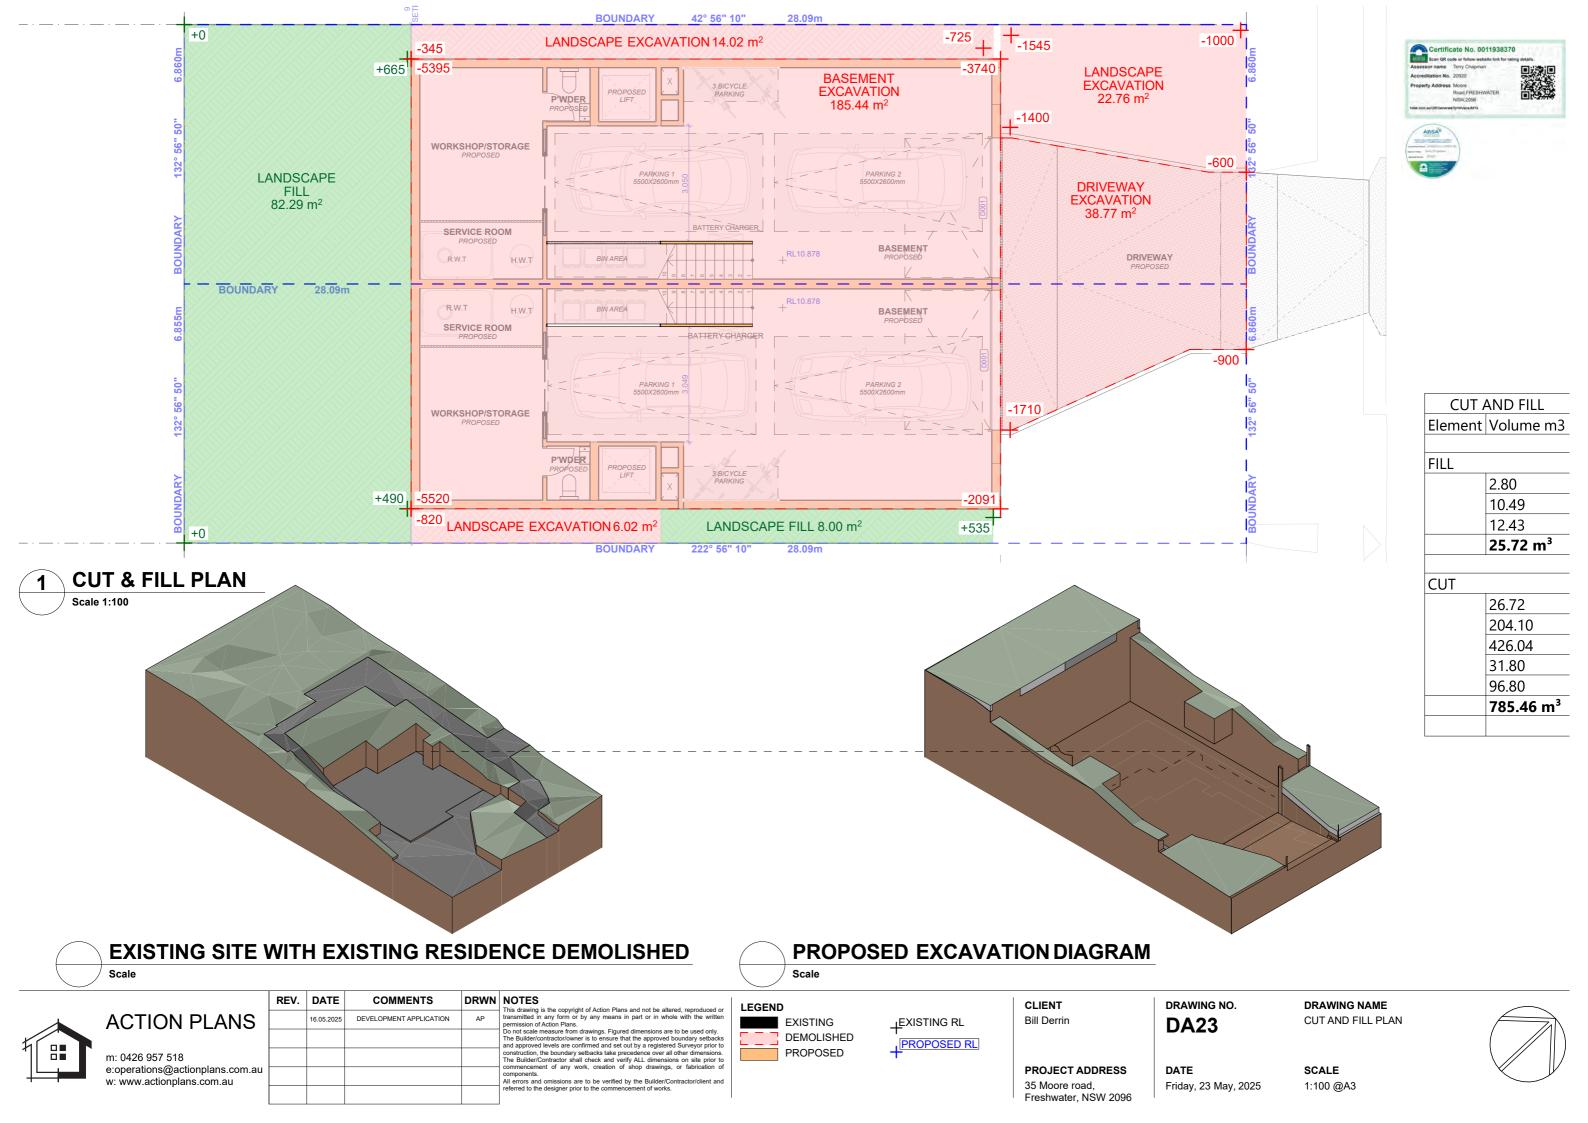

Scale 1:200

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EXISTING SHADOWS

PROPOSED SHADOWS

CLIENT Bill Derrin

Bill Derrin

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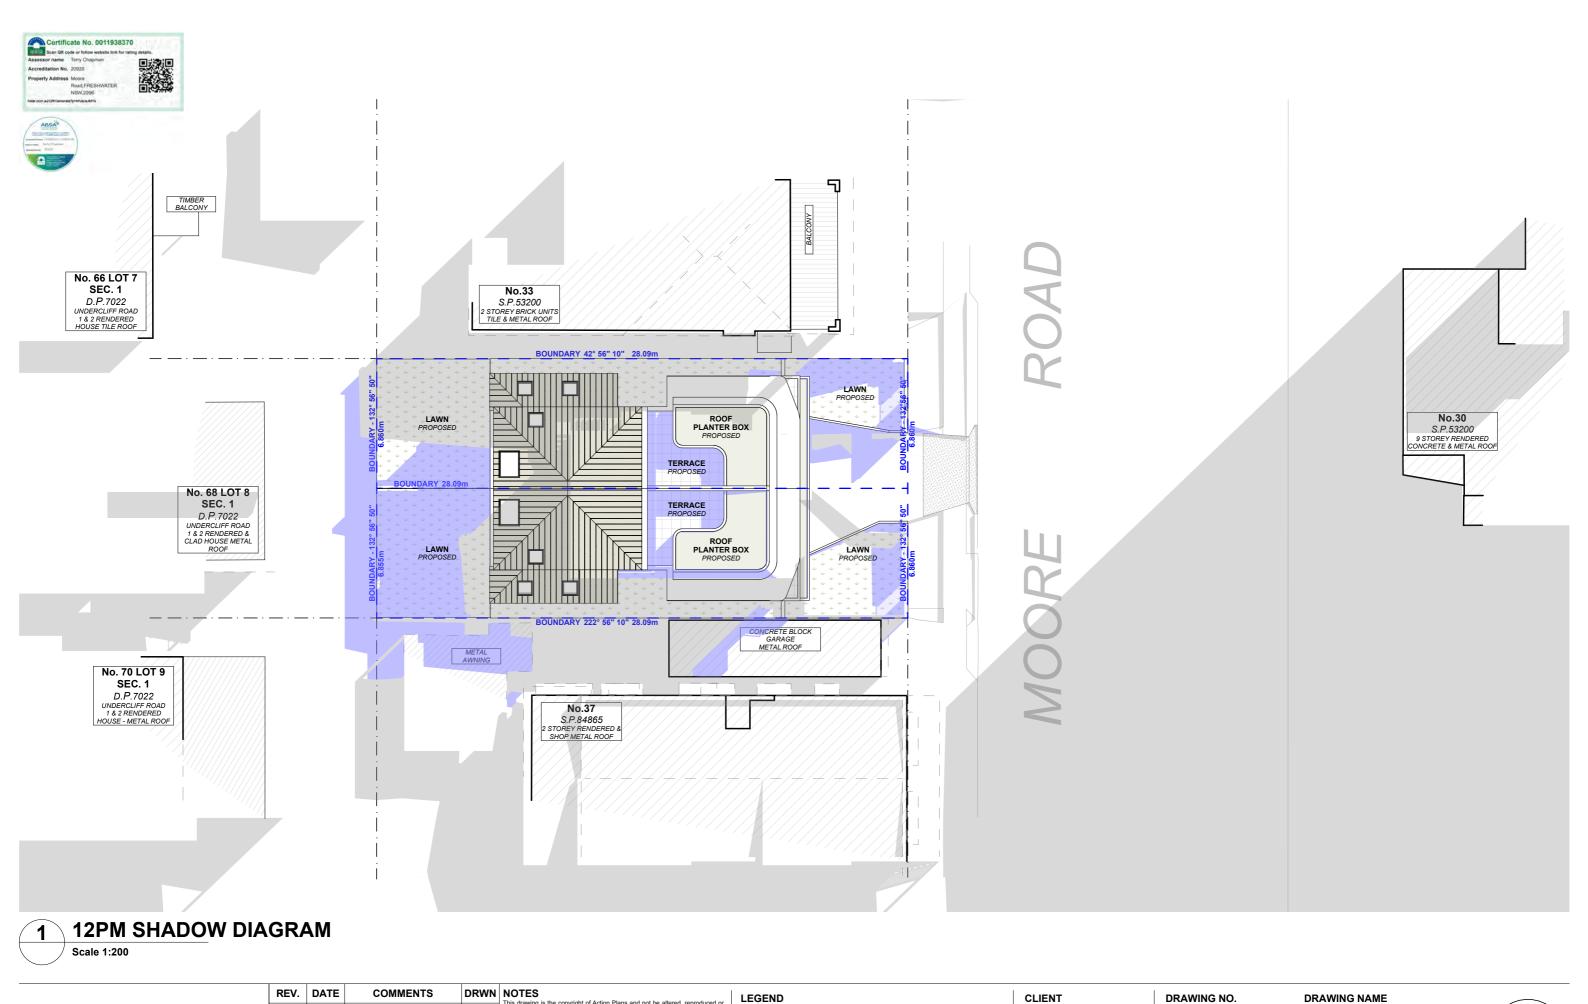
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DATE Friday, 23 May, 2025

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DEVELOPMENT APPLICATION 16.05.2025

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components.

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LEGEND

EXISTING SHADOWS PROPOSED SHADOWS

CLIENT Bill Derrin

> PROJECT ADDRESS 35 Moore road,

Freshwater, NSW 2096


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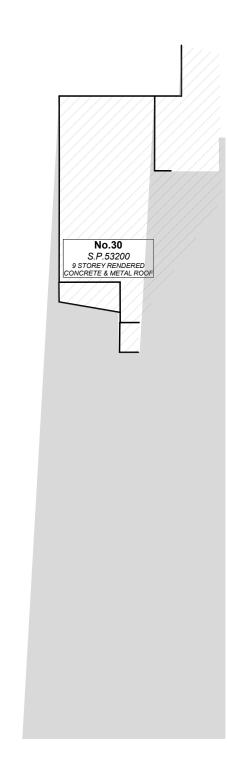
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DRAWING NAME WINTER SOLSTICE 12 PM







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| EXISTING SHADOWS |
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| PROPOSED SHADOWS |

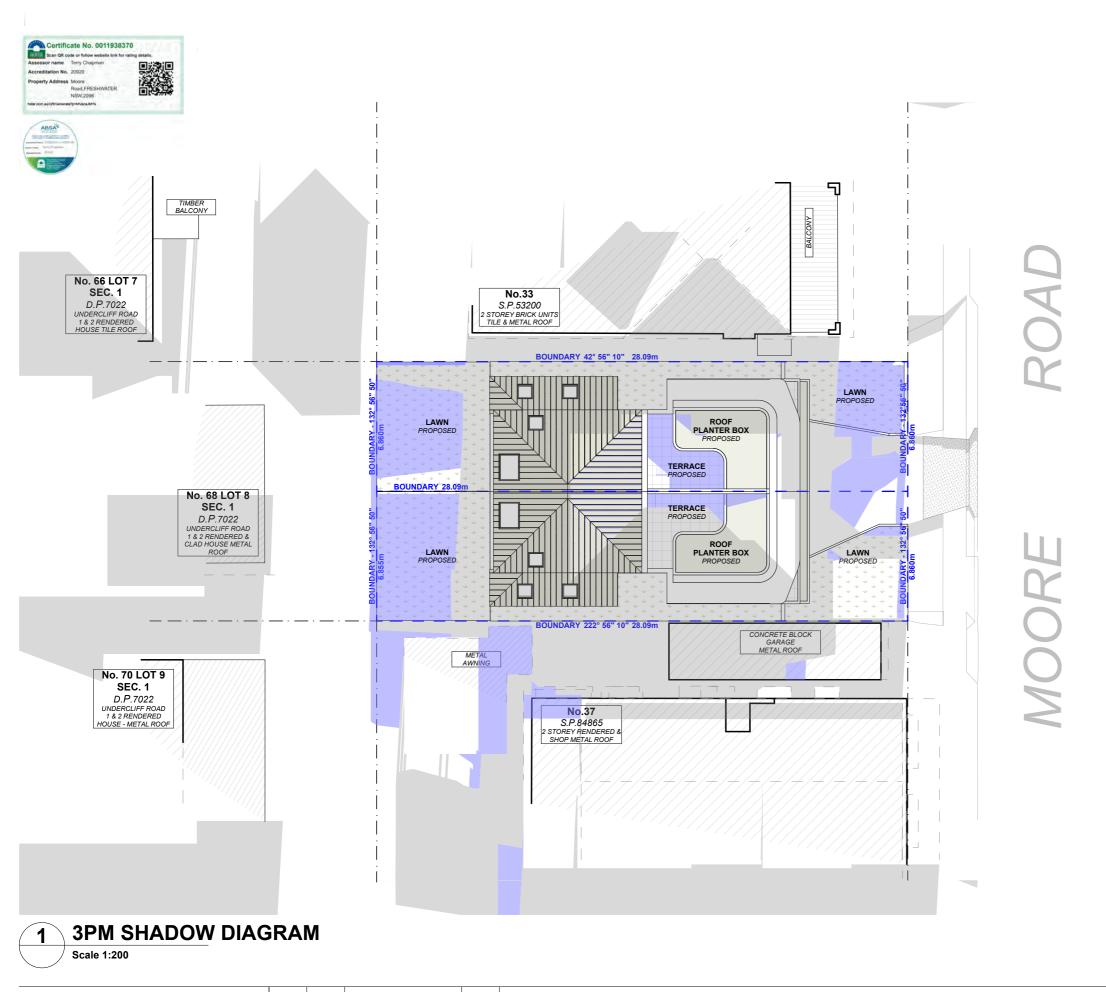LEGEND

CLIENT Bill Derrin

Bill Derrin

PROJECT ADDRESS 35 Moore road, Freshwater, NSW 2096 DRAWING NO.

Friday, 23 May, 2025

DATE


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WINTER SOLSTICE 3 PM







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LEGEND

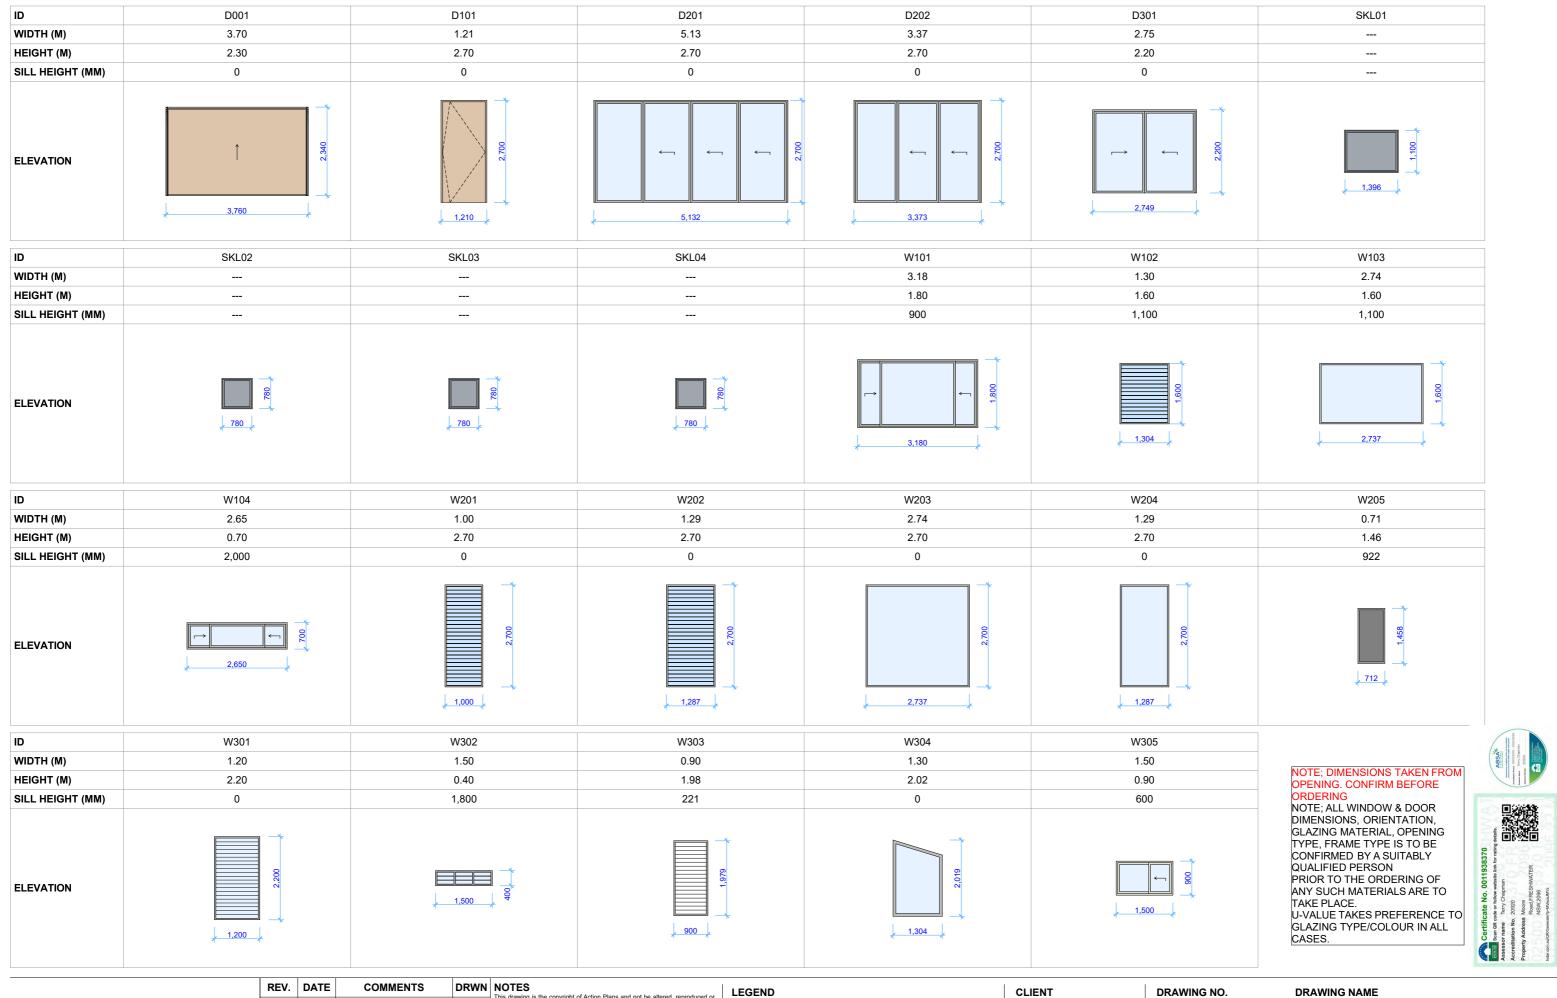CLIENT Bill Derrin

DATE

DA27

Friday, 23 May, 2025

DRAWING NAME WINDOW & DOOR SCHEDULE

SCALE @A3

PROJECT ADDRESS

35 Moore road, Freshwater, NSW 2096





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| Dual Occupancy | | | Prepared by Chapman Enviro | | | 3 | | |
| 35 Moore Road | | | www.basixcertificates.com.a | | I VICCS | | | |
| Freshwater | NSW | 2096 | 1300 004 914 | | | | CHA | PMAN |
| Water Target | | 40 | Water Score | | 43 | | | |
| Energy Target | | 72 | Energy Score | | 72 | | | |
| - 87 - 8 | | | | | | | | |
| | Total area of | f garden & lav | | mmitments | | gonous/low water use | nlants (m²) | 0 |
| Landscaping | Total alea of | i garueri & iav | vii (iii) 76.3 ea | | Alea oi illui | genous/low water use | piants (iii) | O |
| Fixtures | Shower hea | ads | 4 star (> 6 but <= 7.5 L/min) | | Toilets | 4 star | All tans | 4 star |
| | | | , , , | | | | | |
| | Minimum F | Rainwater tai | nk size (L) 2000 ea | Co | llect run off fr | om roof area of at lea | st (m²) | 43.6 ea |
| Alternative Water | Toilet co | onnection | Laundry connection | Landscane | connection | Pool ton un | 1 | Spa top up |
| | | 'es | Yes | | | n/a | | n/a |
| | Hat water o | u ct o m | Gas instantaneous | | | Dating Estar | | |
| | Hot water s | | Individual fan, ducted to facade | e or roof | | | switch on/off | : |
| | Kitchen ver | | Individual fan, ducted to facade | | | | | |
| | Laundry vei | | Individual fan, ducted to facad | e or roof | | | | |
| Energy | Cooling - liv | | 1-phase airconditioning | | | | | 4 |
| | Cooling - be | | 1-phase airconditioning 1-phase airconditioning | | | | | Zoned |
| | Heating - be | | 1-phase airconditioning | | | | | |
| | Alternate E | | Photovoltaic system able to ge | | | | | |
| | Gas cookto | p & electric o | oven Outd | oor clothes | line required | N | o indoor cloth | esline required |
| | | The | rmal Performance Assessment | Based on th | ne Following F | Requirements | | |
| Floor Types | Concrete sl | ab on ground | | | | | | |
| rioui Types | Suspended | concrete sla | b | with | R2.3 unders | lab insulation | | |
| -1 4 . | Tiles | Wet Areas | | | Timber | Living Areas/ Bedroo | oms | |
| Floor Coverings | Carpet | n/a | | | Concrete | Garage | | |
| | Dincel (200 | mm) - Basen | nent Level | with | No insulatio | n required | Colour | Light |
| F 1 1347. II. | | | Framed - Ground & 1st Floor | with | | | | |
| External Walls | Cavity brick | (| | with | R1.1 cavity | board | | |
| | Timber fran | ned Fibro cla | ad on battens | with | Sarking and | R2.5 bulk insulation | Colour | Light |
| Internal Walls | Plasterboar | rd | | with | No insulatio | n required | | |
| Party Walls | Dincel (200 | mm) with pla | asterhoard | | | | | |
| | | | | | | | | |
| Ceiling (floor over) | Concrete at | bove plasterl | poard | with | | | | nternai ceilings |
| Ceilings (roof over) | | bove plasterl | | with | | | e garage only | |
| ge (reer eren) | Timber abo | ve plasterbo | pard. | with | R6.0 bulk in | sulation | | |
| Roof | Metal | | | with | | | Colour | Medium |
| NOOI | Concrete | | | with | Waterproof | membrane only | Colour | Medium |
| | AF single gl | azed Comfor | rt Plus | Fixed Glass | | BRD-041-001-001 U-V | alue 6.15 or les | s SHGC 0.74 +/- 5% |
| | | | | Louvres | | BRZ-006-009-001 U-V | alue 4.90 or less | s SHGC 0.46 +/- 5% |
| | | | | | | : | | - |
| | to all window | s and glazed do | oors unless noted otherwise | Sliding Doors | 5 | BKD-033-010-001 U-V | alue 4.30 or les | S SHGC 0.59 +/- 5% |
| Windows and Doors - | | | | Toilets 4 star All taps Collect run off from roof area of at least (m²) Landscape connection Yes Not many the star All taps Corroof With Manual switch on/off With Manual switch on/off Not roof With Manual switch on/off Rating EER 3.0 - 3.5 Rating EER 3.0 - 3.5 | | | | |
| Unit A | | glazed clear | | | s | | | |
| | _ | D201 & D202 o | only | Fixed Glass | | BRD-153-040-001 U-V | alue 2.70 or les | s SHGC 0.53 +/- 5% |
| | Fixed Window | v - vv 103 only | | | | | | |
| | AF = Aluminiu | ım Framed | TB = Thermally Broken Aluminium Fr | amed | | TF = Timber Framed | | |
| | AF single gl | azed Comfor | rt Plus | Fixed Glass | | BRD-041-001-001 U-V | alue 6.15 or les | s SHGC 0.74 +/- 5% |
| | | | | Louvres | | | | |
| | | | | | | · · · · · · · · · · · · · · · · · · · | | |
| Windows and Doors | to all window | s and glazed do | oors unless noted otherwise | Sliding Doors | S | BRD-033-010-001 U-V | alue 4.30 or les | s SHGC 0.59 +/- 5% |
| Windows and Doors - | | | | | | | | |
| Unit B | AF double g | glazed clear | | Sliding Doors | S | BRD-035-029-001 U-V | alue 2.70 or les | s SHGC 0.51 +/- 5% |
| | _ | D201 & D202 o | - | Fixed Glass | | BRD-153-040-001 U-V | alue 2.70 or les | s SHGC 0.53 +/- 5% |
| | Fixed Window | v - W103 & W2 | 03 only | | | | | |
| | AF = Aluminiu | ım Framed | ITB = Thermally Broken Aluminium Fr | l amed | | TF = Timber Framed | | |
| | | | | | | | <u>.</u> | |
| | - | - | to be fitted with self-closing dampers | | | | | |
| | | | be installed in accordance with Part 3 | | | | | |
| | If there is a di | screpancy betv | veen this document and the Nathers C | ertificate, the | n the Nathers C | ertificate shall take preced | ence | |
| Notes | Ceiling Fans (| 1400mm) requi | red in the Dining Living Area x 2 & Ma | ster Bed | | | | |
| | | , | | | | | | |

This document to be read in conjunction with the Basix Certificate and Nathers Universal Certificate

LEGEND



| REV. | DATE | COMMENTS | DRWN | NOTES |
|------|------------|-------------------------|------|-------------------------------------------------------------------------------------------------------------------------------------------------------------------------------------------------------------------------------------------------|
| | 16.05.2025 | DEVELOPMENT APPLICATION | AP | This drawing is the copyright of Action Plans and not be altered, reproduced or transmitted in any form or by any means in part or in whole with the written permission of Action Plans. |
| | | | | Do not scale measure from drawings. Figured dimensions are to be used only. The Builder/contractor/owner is to ensure that the approved boundary setbacks and approved levels are confirmed and set out by a registered Surveyor prior to |
| | | | | construction, the boundary setbacks take precedence over all other dimensions. The Builder/Contractor shall check and verify ALL dimensions on site prior to commencement of any work, creation of shop drawings, or fabrication of |
| | | | | components. All errors and omissions are to be verified by the Builder/Contractor/client and |
| | | | | referred to the designer prior to the commencement of works. |

CLIENT
Bill Derrin

T rrin

DA28 DRAWING NO. DR

DRAWING NAMEBASIX COMMITMENTS

PROJECT ADDRESS 35 Moore road, Freshwater, NSW 2096 DATE Friday, 23 May, 2025

SCALE

@A3

BASIX™Certificate

Multi Dwelling



| Project name | 35 Moore Road | |
|-------------------------------------------------|----------------------|-----------|
| Street address | 35 MOORE ROAD FRESHW | ATER 2096 |
| Local Government Area | NORTHERN BEACHES | |
| Plan type and plan number | Deposited Plan 7022 | |
| Lot No. | 15 | |
| Section no. | 1 | |
| No. of residential flat buildings | 0 | |
| Residential flat buildings: no. of dwellings | 0 | |
| Multi-dwelling housing: no. of dwellings | 2 | |
| No. of single dwelling houses | 0 | |
| Project score | | |
| Water | ✓ 43 | Target 4 |
| Thermal Performance | ✓ Pass | Target P |
| Energy | ✓ 72 | Target 7 |
| Materials | ✓ -42 | Target n |


| ertificate Prepared by |
|-----------------------------------------------------------|
| me / Company Name: CHAPMAN ENVIRONMENTAL SERVICES PTY LTD |
| N (if applicable): |

Description of project

| Project name | 35 Moore Road |
|-------------------------------------------------|-------------------------------|
| Street address | 35 MOORE ROAD FRESHWATER 2096 |
| Local Government Area | NORTHERN BEACHES |
| Plan type and plan number | Deposited Plan 7022 |
| Lot No. | 15 |
| Section no. | 1 |
| Project type | |
| No. of residential flat buildings | 0 |
| Residential flat buildings: no. of dwellings | 0 |
| Multi-dwelling housing: no. of dwellings | 2 |
| No. of single dwelling houses | 0 |
| Site details | |
| Site area (m²) | 385.3 |
| Roof area (m²) | 145 |
| Non-residential floor area (m²) | 0 |
| Residential car spaces | 4 |
| Non-residential car spaces | 0 |

| Common area lawn (m²) Common area garden (m²) | 0 | |
|-----------------------------------------------------|-------------|------------|
| Area of indigenous or low water use species (m²) | 0 | |
| Assessor details and therm | nal loads | |
| Assessor number | 20920 | |
| Certificate number | 0011938370 | |
| Climate zone | 56 | |
| Project score | | |
| Vater | ✓ 43 | Target 40 |
| Thermal Performance | ✓ Pass | Target Pas |
| Energy | ✓ 72 | Target 72 |
| Materials | √ -42 | Target n/a |

| ASIX | Department of Planning, Housing and Infrastructure | www.basix.nsw.gov.au | Version: 4.03 / EUCALYPTUS_03_01_0 | Certificate No.: 1796655M | Thursday, 22 May 2025 | P |
|------|-------------------------------------------------------|----------------------|------------------------------------|---------------------------|-----------------------|---|
| | | | | | | |

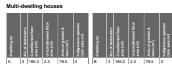

No common areas specified.

Schedule of BASIX commitments

| (i) Water | Show on DA plans | Show on CC/CDC plans & specs | Certifie check |
|---------------------------------------------------------------------------------------------------------------------------------------------------------------------------------------------------------------------------------------------------------------------------------------------------------------------------------------------------------------------------------------------------------------|---------------------|------------------------------|-------------------|
| (a) The applicant must comply with the commitments listed below in carrying out the development of a dwelling listed in a table below. | | | |
| (b) The applicant must plant indigenous or low water use species of vegetation throughout the area of land specified for the dwelling in the "Indigenous species" column of the table below, as private landscaping for that dwelling. (This area of indigenous vegetation is to be contained within the "Area of garden and lawn" for the dwelling specified in the "Description of Project" table). | ~ | ~ | |
| c) If a rating is specified in the table below for a fixture or appliance to be installed in the dwelling, the applicant must ensure that each such fixture and appliance meets the rating specified for it. | | ~ | - |
| d) The applicant must install an on demand hot water recirculation system which regulates all hot water use throughout the dwelling, where indicated for a dwelling in the "HW recirculation or diversion" column of the table below. | | ~ | - |
| e) The applicant must install: | | | |
| (aa) a hot water diversion system to all showers, kitchen sinks and all basins in the dwelling, where indicated for a dwelling in the "HW recirculation or diversion" column of the table below; and | | _ | - |
| (bb) a separate diversion tank (or tanks) connected to the hot water diversion systems of at least 100 litres. The applicant must connect the hot water diversion tank to all toilets in the dwelling. | | - | - |
| e) The applicant must not install a private swimming pool or spa for the dwelling, with a volume exceeding that specified for it in the table below. | v | ~ | |
| f) If specified in the table, that pool or spa (or both) must have a pool cover or shading (or both). | | ~ | |
| (g) The pool or spa must be located as specified in the table. | - | - | |
| h) The applicant must install, for the dwelling, each alternative water supply system, with the specified size, listed for that dwelling in the table below. Each system must be configured to collect run-off from the areas specified (excluding any area which supplies any other alternative water supply system), and to divert overflow as specified. Each system must be connected as specified. | ~ | ~ | ~ |

Schedule of BASIX commitments

| DX. | Department of Planning, Housing and | www.basix.nsw.gov.au | Version: 4.03 / EUCALYPTUS_03_01_0 | Certificate No.: 1796655M | Thursday, 22 May 2025 | page 6/16 |
|-----|-------------------------------------|----------------------|------------------------------------|---------------------------|-----------------------|-----------|

| | Fixtures | | | | Appliances | | | Individual pool | | | Individual spa | | | |
|-----------------|-------------------------------------|--------------------------------------|------------------------|-------------------------|-------------------------------|---------------------------|----------------------|---------------------------|---------------|------------------|----------------|---------------------------|--------------|---------------|
| Dwelling no. | All shower- heads | All toilet flushing systems | All kitchen taps | All bathroom taps | HW recirculation or diversion | All clothes washers | All dish- washers | Volume (max volume) | Pool cover | Pool location | Pool shaded | Volume (max volume) | Spa cover | Spa shaded |
| dwellings | 4 star (> 6 but <= 7.5 L/min) | 4 star | 4 star | 4 star | - | - | - | - | - | - | | - | - | - |
| | | | | | | | | ve water sou | | | | | | |

| | 1) | (min) 2000 liters | 43.6 square metres of roof area; 0 square metres of impervious area; 0 square metres of garden and lawn area; and 0 square metres of planter box area. | | | | |
|--------------------------------------------|-----------------------------------------------------------------|-----------------------------------------------------------------|-------------------------------------------------------------------------------------------------------------------------------------------------------------------------------------------------------------------------------------|-----------------------------------------------|---------------------|------------------------------|-----------|
| (ii) Energy | | | | | Show on DA plans | Show on CC/CDC plans & specs | Certifier |
| (a) The applic | ant must comply with the cor | mmitments listed | below in carrying out the development of a dwelling | listed in a table be | low. | | |
| supplied b | y that system. If the table spi | ecifies a central | ied for the dwelling in the table below, so that the di not water system for the dwelling, then the applican t water is supplied by that central system. | | | ~ | ~ |
| | | | d laundry of the dwelling, the ventilation system spr e the operation control specified for it in the table. | ecified for that room | in | V | ~ |
| headings of cooling or such areas | of the "Cooling" and "Heating heating system is specified in | of columns in the n the table for "L | m/s specified for the dwelling under the "Living area table below, inflor at least 1 living/bedroom area of iving areas" or "Bedroom areas", then no systems r ir conditioning system, then the system must provid | the dwelling. If no nay be installed in a | ny | • | ~ |
| the table b lighting" fo specified f | elow (but only to the extent s r each such room in the dwe | specified for that dling is fluoresce then the light fitt | welling which is referred to in a heading to the "Artifi room or area). The applicant must ensure that the ' nt lighting or light emitting diode (LED) lighting. If th ngs in that room or area must only be capable of be | primary type of artifi term "dedicated" is | icial s | • | ~ |

| (ii) Energy | 1 | | | | | Show on DA plans | Show on CC/CDC plans & specs | Certifie check |
|----------------------------|---------------------------------------------------------------|------------------------------------------------------------|------------------------------------------------------------|-----------------------------|---------------------|---------------------|------------------------------|-------------------|
| the tab | | extent specified for that | relling which is referred to room or area). The applica | | | ~ | ~ | ~ |
| (g) This co | ommitment applies if the | applicant installs a wate | r heating system for the dw | elling's pool or spa. The | applicant must: | | | |
| (aa | i) install the system spec any system for the po | | | | | | | |
| (bb |) install the system spec any system for the sp | | - | | | | | |
| (h) The ap | plicant must install in the | dwelling: | | | | | | |
| (aa | the kitchen cook-top are table below; | nd oven specified for tha | t dwelling in the "Appliance | s & other efficiency meas | ures" column of the | | - | |
| (bb | | ch a rating is specified for that the appliance has the | or that dwelling in the "Appl nat minimum rating; and | iances & other efficiency r | neasures" column of | | - | v |
| (cc |) any clothes drying line | specified for the dwelling | g in the "Appliances & othe | r efficiency measures* col | umn of the table. | | | |
| (i) If specifi ventilar | | icant must carry out the | development so that each | refrigerator space in the d | welling is "well | | ~ | |
| | | | fied for the dwelling under nect the system to that dw | | heading of the | ~ | - | - |
| | Hot water | Bathroom v | entilation system | Kitchen ven | tilation system | | aundry ventilation sy | tem |
| | | | | | | | | |

| | Coc | ling | Hea | Natural lighting | | |
|--------------|-----------------------------------------------------|-----------------------------------------------------|-----------------------------------------------------|-----------------------------------------------------|-----------------------------|--------------|
| Owelling no. | living areas | bedroom areas | living areas | | No. of bathrooms or toilets | Main kitchen |
| Il dwellings | 1-phase airconditioning - ducted / EER 3.0 - 3.5 | 1-phase airconditioning - ducted / EER 3.0 - 3.5 | 1-phase airconditioning - ducted / EER 3.0 - 3.5 | 1-phase airconditioning - ducted / EER 3.0 - 3.5 | 2 | yes |

| BASIX | Department of Planning, Housing and | www.basix.nsw.gov.au | Version: 4.03 / EUCALYPTUS_03_01_0 | Certificate No.: 1796655M | Thursday, 22 May 2025 | page 8/1 |
|-------|-------------------------------------|----------------------|------------------------------------|---------------------------|-----------------------|----------|

| | ا ا | Individual pool | | Individua | l spa | 1 | Appliances of | ther efficien | icy measures | |
|--------------------------|-------------------------------------------------------|---------------------------------------------------------------------------------------------------------|----------------------------------|----------------------------------------------|---------------------------------|---------------------------------------------|---------------------------------|---------------------|--------------------------------------------------|----------------------------------------------------------------|
| Dwelling no. | Pool heating system | Pool Pump | Timer | Spa heating system | Timer | Kitchen cooktop/oven | Dishwasher | Clothes dryer | Indoor or sheltered clothes drying line | Private outdoor or unsheltered clothes drying line |
| VI twellings | - | - | - | - | - | gas cooktop & electric oven | - | - | - | yes |
| | | | | | | Alternative energ | ay. | | | |
| Dwelling n | 10. | Photovoltaic sy output in peak | | ated electrical | Photovolta | ic collector installs | ation | Orientation | inputs | |
| III dwellings | s | - | | | - | | | - | | |
| iii) Therma | al Performance and | Materials | | | | | | Show on DA plans | Show on CC/CDC plans & specs | Certifier check |
| *Assess the app | sor Certificate*) to the plicant is applying for a | e certificate referred to e development applicat a complying developm or Certificate to the ap | tion and cons ent certificate | truction certificate a for the proposed d | pplication for evelopment, t | the proposed develors that application). To | opment (or, if The applicant | | | |
| (b) The Ass | sessor Certificate mu | st have been issued b | y an Accredit | ed Assessor in acco | ordance with t | he Thermal Comfort | Protocol. | | | |
| (c) The det Certifica | tails of the proposed of ate, including the deta | development on the As ails shown in the "Ther | sessor Certif mal Loads' t | ficate must be consi able below. | stent with the | details shown in this | s BASIX | | | |
| the The | ermal Comfort Protoco | the plans accompany of requires to be show ify that this is the case | n on those pla | | | | | • | | |
| certifica | ate, if applicable), all t | the plans accompany thermal performance s ed to calculate those s | pecifications | set out in the Asses | | | | | ~ | |
| Certifica | ate, and in accordance | the development in ac ce with those aspects of to calculate those spec | of the develop | | | | | | ~ | ~ |
| | there is an in-slab he | ating or cooling system | n, the applica | nt must: | | | | | | T |
| (g) Where t | | | | | | | | • | • | _ |

| ii) Thermal Performan | ce and Materials | | Show on DA plans | Show on CC/CDC plans & specs | Certifier check | | |
|-----------------------------------------------------------------------|-------------------------------------------------------------------------------------------------------------------------------|--------------------------------------------------------|---------------------|------------------------------|--------------------|--|--|
| | ded floor, install insulation with an R-value of not less than 1 perimeter of the slab. | 1.0 underneath the slab and around the vertical | | | | | |
| n) The applicant must co | onstruct the floors and walls of the development in accordan | nce with the specifications listed in the table below. | ~ | ~ | - | | |
| | ow on The plans accompanying The development application. The Assessor Certificate. | ~ | | | | | |
| The applicant must she certificate, if applicable | ow on the plans accompanying the application for a constru le), the locations of ceiling fans set out in the Assessor Cert | ction certificate (or complying development ificate. | | ~ | | | |
| | | Thermal loads | | | | | |
| welling no. | Area adjusted heating load (in MJ/m²/yr) | Area adjusted cooling load (in MJ/m ² /yr) | Area adju | sted total load (in MJ/ | m²/yr) | | |
| | 40.5 | 16.5 12.7 | | | | | |

| | 17.3 | | | 1 | 1.6 | | | 28.900 | | |
|----------------|--------------------------------------------------------------------------------------------------------------------------------------------------------------------------------------------------------------------------------------------------------------------------------------------------------------------------------------------------------------------------------------------------------------------------------------------------------------------------------------------------------------------------------------------------------------------------------------------------------------------------------------------------------------------------------------------------------------------------------------------------------------------------------------------------------------------------------------------------------------------------------------------------------------------------------------------------------------------------------------------------------------------------------------------------------------------------------------------------------------------------------------------------------------------------------------------------------------------------------------------------------------------------------------------------------------------------------------------------------------------------------------------------------------------------------------------------------------------------------------------------------------------------------------------------------------------------------------------------------------------------------------------------------------------------------------------------------------------------------------------------------------------------------------------------------------------------------------------------------------------------------------------------------------------------------------------------------------------------------------------------------------------------------------------------------------------------------------------------------------------------------|-----------------------------------------------------------------------------------------------------------------------------------------------------|--------------------------------------------------------------------------------------------------------------------------------------------------------------------------------------------------------------------------------------------------------------------------------------------------------------------------------------------------------------------------------------------------------------------------------------------------------------------------------------------------------------------------------------------------------------------------------------------------------------------------------------------------------------------------------------------------------------------------------------------------------------------------------------------------------------------------------------------------------------------------------------------------------------------------------------------------------------------------------------------------------------------------------------------------------------------------------------------------------------------------------------------------------------------------------------------------------------------------------------------------------------------------------------------------------------------------------------------------------------------------------------------------------------------------------------------------------------------------------------------------------------------------------------------------------------------------------------------------------------------------------------------------------------------------------------------------------------------------------------------------------------------------------------------------------------------------------------------------------------------------------------------------------------------------------------------------------------------------------------------------------------------------------------------------------------------------------------------------------------------------------|----------------------------------------------------------------------------------------------------|---------------------------------------------------------------------------------------------------------------------------------------------------------------------------------------------------------------------------------------------------------------------------------------------------------------------------------------------------------------------------------------------------------------------------------------------------------------------------------------------------------------------------------------------------------------------------------------------------------------------------------------------------------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------------------------------------------------------------------------------------------------------------------------------------------------------------------------------------------------------------------------------------------------------------------------------------------------------------------------------------------------------------------------------------------------------------------------------------------------------------------------------------------------------------------------------------------------------------------------------------------------------------------------------------------------------------------------------------------------------------------------------------------------------------------------|
| | | | | | | | | | | |
| | | | | | Construction of | of floors and wall | 5 | | | |
| Concre (m²) | ete slab on g | | | with open | | | Suspended (garage (m²) | floor above | | rammed earth or walls |
| 87.6 | | 3 | | | - | | 57.1 | | no | |
| loor types | | | | | | | | | | |
| | Concre | te slab on gri | ound | | Suspended flo | or above enclos | ed subfloor | Suspende | d floor above | open subfloor |
| krea (m²) | Insulation | Low emission option | | | | Area (m²) I | nsulation | Construction type | Area (m² |) Insulation |
| 7.6 | - | - | convention | al slab - | | - 1- | | concrete - suspended | 3 | polystyrene |
| nstruction | Area (m²) | Insulation | Construction type | Area (m²) | Insulation | Construction type | Area (m²) | Insulation | Low emissions | Dematerialisation |
| | 117.8 | - | concrete - suspended | 57.1 | polystyrene | concrete slab on ground | 87.6 | - | option - | conventional slab |
| External v | valle | | | | | | | • | | • |
| | | Externa | l wall type 1 | | | | E | xternal wall ty | ne 2 | |
| Wall type | Ar | ea (m²) | Insulation | | | Wall type | Area (m²) | Insu | ation | Low emissions option |
| | | 2 | - | none | | concrete panel/ plasterboard, frame : timber | 62 | fibreg | lass batts or | none |
| | (m²) S7.6 Floor types Area (m²) 7.6 or types First floor types First floor types First floor types Frest floor types Fre | (m) 87.6 Roor types Concret Area (m) Insulation 7.6 - por types First floor above hab rooms or mezzani rooms or mezzani corete- pendes Wall type An | (mr) s 37.6 3 Theor types Concrete side on gr frea (mr) Insulation Une emission oppose First (mr) Insulation oppose First (mr) Insulation oppose First (mr) Insulation oppose Insulation of Insulation oppose I | (en) subfloor (en) [87.6] ST.6] Concrete slab on ground free (en) Low control convention T.6 | Enternal walls Source So | Extract walls Subjected Floor above garage Suspended Flo | (eff) subfloor (eff) enclosed subfloor (eff) enclosed subfloor (eff) 87.6 3 - | (eff) subfloor (eff) enclosed subfloor (eff) garage (eff) (87.6 3 - | (eff) subfider (eff) exclosed subfider (eff) garage (eff) 87.5 3 - | (eff) subfloor (eff) enclosed subfloor (eff) garage (eff) modelands Supported floor above enclosed subfloor (eff) for 1 for 2 for 1 for 1 for 1 for 2 for 1 for 1 for 2 for 1 for 2 for 1 for 2 for 2 for 1 for 2 |

| | | Evt | ernal wall type 1 | | | | | External wa | all type 2 | |
|---------------|----------------------------------------------------------------------|--------------------|---------------------------------------------------------------------|------------------------------------------------------------|---------------------|---------------------------------------------------------------------|------|----------------------------------------|---------------------------|-------------------------|
| Dwelling no. | Wall type | Area (m²) | Insulation | Low emis | ssions Wa | I type | Area | | Insulation | Low emissions option |
| | | | | | | treated rood | | | | |
| | External walls | | | | | | | | | |
| | | Exte | ernal wall type 3 | | | | | External wa | all type 4 | |
| Dwelling no. | Wall type | Area (m²) | Insulation | Low emis | ssions Wa | I type | Area | (m²) | Insulation | Low emissions option |
| All dwellings | cavity brick | 30.3 | polystyrene | none | cem boar timb | ed (fibre ent sheet or ds), frame : er - H2 ed softwood | 62 | | ibreglass batts or oll | none |
| | Internal walls | | | | | | | | | |
| | Interna | l walls shared w | ith garage | | Internal wall t | ype 1 | | | Internal wall ty | pe 2 |
| Dwelling no. | Wall type | Area (m²) | Insulation | Wall type | Area (m²) | Insulation | | Wall type | Area (m²) | Insulation |
| All dwellings | - | - | - | plasterboard, frame: timber - H2 treated softwood | 117.8 | - | | - | - | - |
| | Ceiling and roo | f | | | | | | | | |
| | Fla | t ceiling / pitche | d roof | Raked ce | iling / pitched | or skillion roof | | | Flat ceiling / flat | roof |
| Dwelling no. | Construction type | Area (m²) | Insulation | Construction type | Area (m²) | Insulation | 1 | Construction type | Area (m²) | Insulation |
| All dwellings | framed - metal roof, frame: timber - H2 treated softwood | 43.6 | Ceiling-fibreglass batts or roll,Roof: foil backed blanket | - | - | Ceiling:,Ro | oof: | concrete - plasterboard internal | 28.9 | Ceiling:polystyren none |

| | Glazing type | | | | | Frame types | | | | |
|---|---------------|---------------------|------------------------|---------------------|----|-----------------------|---------------------|----------------------|--------------------------|--|
| ı | Dwelling no. | Single glazing (m²) | Double glazing (m²) | Triple glazing (m²) | | Timber frames (m²) | uPVC frames (m²) | Steel frames (m²) | Composite frames (m²) | |
| j | All dwellings | 46 | 23 | - | 69 | - | - | - | - | |



| Central energy systems | Туре | Specification |
|------------------------|------|---------------|
| Other | - | |
| | | |
| | | |







ACTION PLANS m: 0426 957 518 e:operations@actionplans.com.au

w: www.actionplans.com.au

| REV. | DATE | COMMENTS | DRWN |
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| | 16.05.2025 | DEVELOPMENT APPLICATION | AP |
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The Builder/contractor/owner is to ensure that the approved boundary setbacks and approved levels are confirmed and set out by a registered Surveyor prior to construction, the boundary setbacks take precedence over all other dimensions.

The Builder/Contractor shall check and verify ALL dimensions on site prior to commencement of any work, creation of shop drawings, or fabrication of components. All errors and omissions are to be verified by the Builder/Contractor/client and referred to the designer prior to the commencement of works. All window & door dimensions, orientation, glazing materials, opening types, frame types are to be confirmed by a suitable untilified processor arise to the ordering for purpose presents. suitably qualified person prior to the ordering of any such materials are to take place. U value takes precedence over glazing type/colour in all cases, all new glazing must meet the BASIX specified frame and glass type, <u>QR</u> meet the ecified U value and SHGC value.

CLIENT

Bill Derrin

PROJECT ADDRESS

35 Moore road, Freshwater, NSW 2096

DRAWING NO. **DA29**

DRAWING NAME BASIX COMMITMENTS

DATE

Friday, 23 May, 2025



EXISTING VIEW FROM THE MOST SOUTH EASTERN NEIGHBOURING WINDOW AT NO.33



PROPOSED VIEW FROM THE MOST SOUTH EASTERN **NEIGHBOURING WINDOW AT NO.33**



VIEW IMPACT CAUSED BY A POTENTIAL COMPLYING DEVELOPMENT PROJECT FROM THE MOST SOUTH EASTERN **NEIGHBOURING WINDOW AT NO.33**



m: 0426 957 518

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REV. DATE COMMENTS **ACTION PLANS** 16.05.2025

DRWN DEVELOPMENT APPLICATION

NOTES

NOTES

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The Builder/contractor/owner is to ensure that the approved boundary setbacks and approved levels are confirmed and set out by a registered Surveyor prior to construction, the boundary setbacks take precedence over all other dimensions.

The Builder/Contractor shall check and verify ALL dimensions on site prior to commencement of any work, creation of shop drawings, or fabrication of components. All errors and omissions are to be verified by the Builder/Contractor/client and referred to the designer prior to the commencement of works. All window & door dimensions, orientation, glazing materials, opening types, frame types are to be confirmed by a suitable qualified person prior to the profession of any such practicals are to take nature. It value takes precedence over relation types of the profession of any such practicals are to take nature. suitably qualified person prior to the ordering of any such materials are to take place. U value takes precedence over glazing type/colour in all cases. all new glazing must meet the BASIX specified frame and glass type, <u>OR</u> meet the ecified U value and SHGC value.

CLIENT

Bill Derrin

PROJECT ADDRESS 35 Moore road, Freshwater, NSW 2096

DRAWING NO. **DA30**

DRAWING NAME VIEW ANALYSIS

Friday, 23 May, 2025





VIEW IMPACT CAUSED BY A POTENTIAL COMPLYING DEVELOPMENT PROJECT FROM THE HIGHEST FRONT BALCONY AT NEIGHBOURING NO.33



PROPOSED VIEW FROM THE HIGHEST FRONT BALCONY AT NEIGHBOURING NO.33



| _/ | ACTION PLANS |
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Bill Derrin

35 Moore road,

Freshwater, NSW 2096

PROJECT ADDRESS

DRAWING NAME VIEW ANALYSIS

Friday, 23 May, 2025

DRAWING NO.

DA31