


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EXISTING COUNCIL'S STORMWATER ASSET

NOT TO SCALE

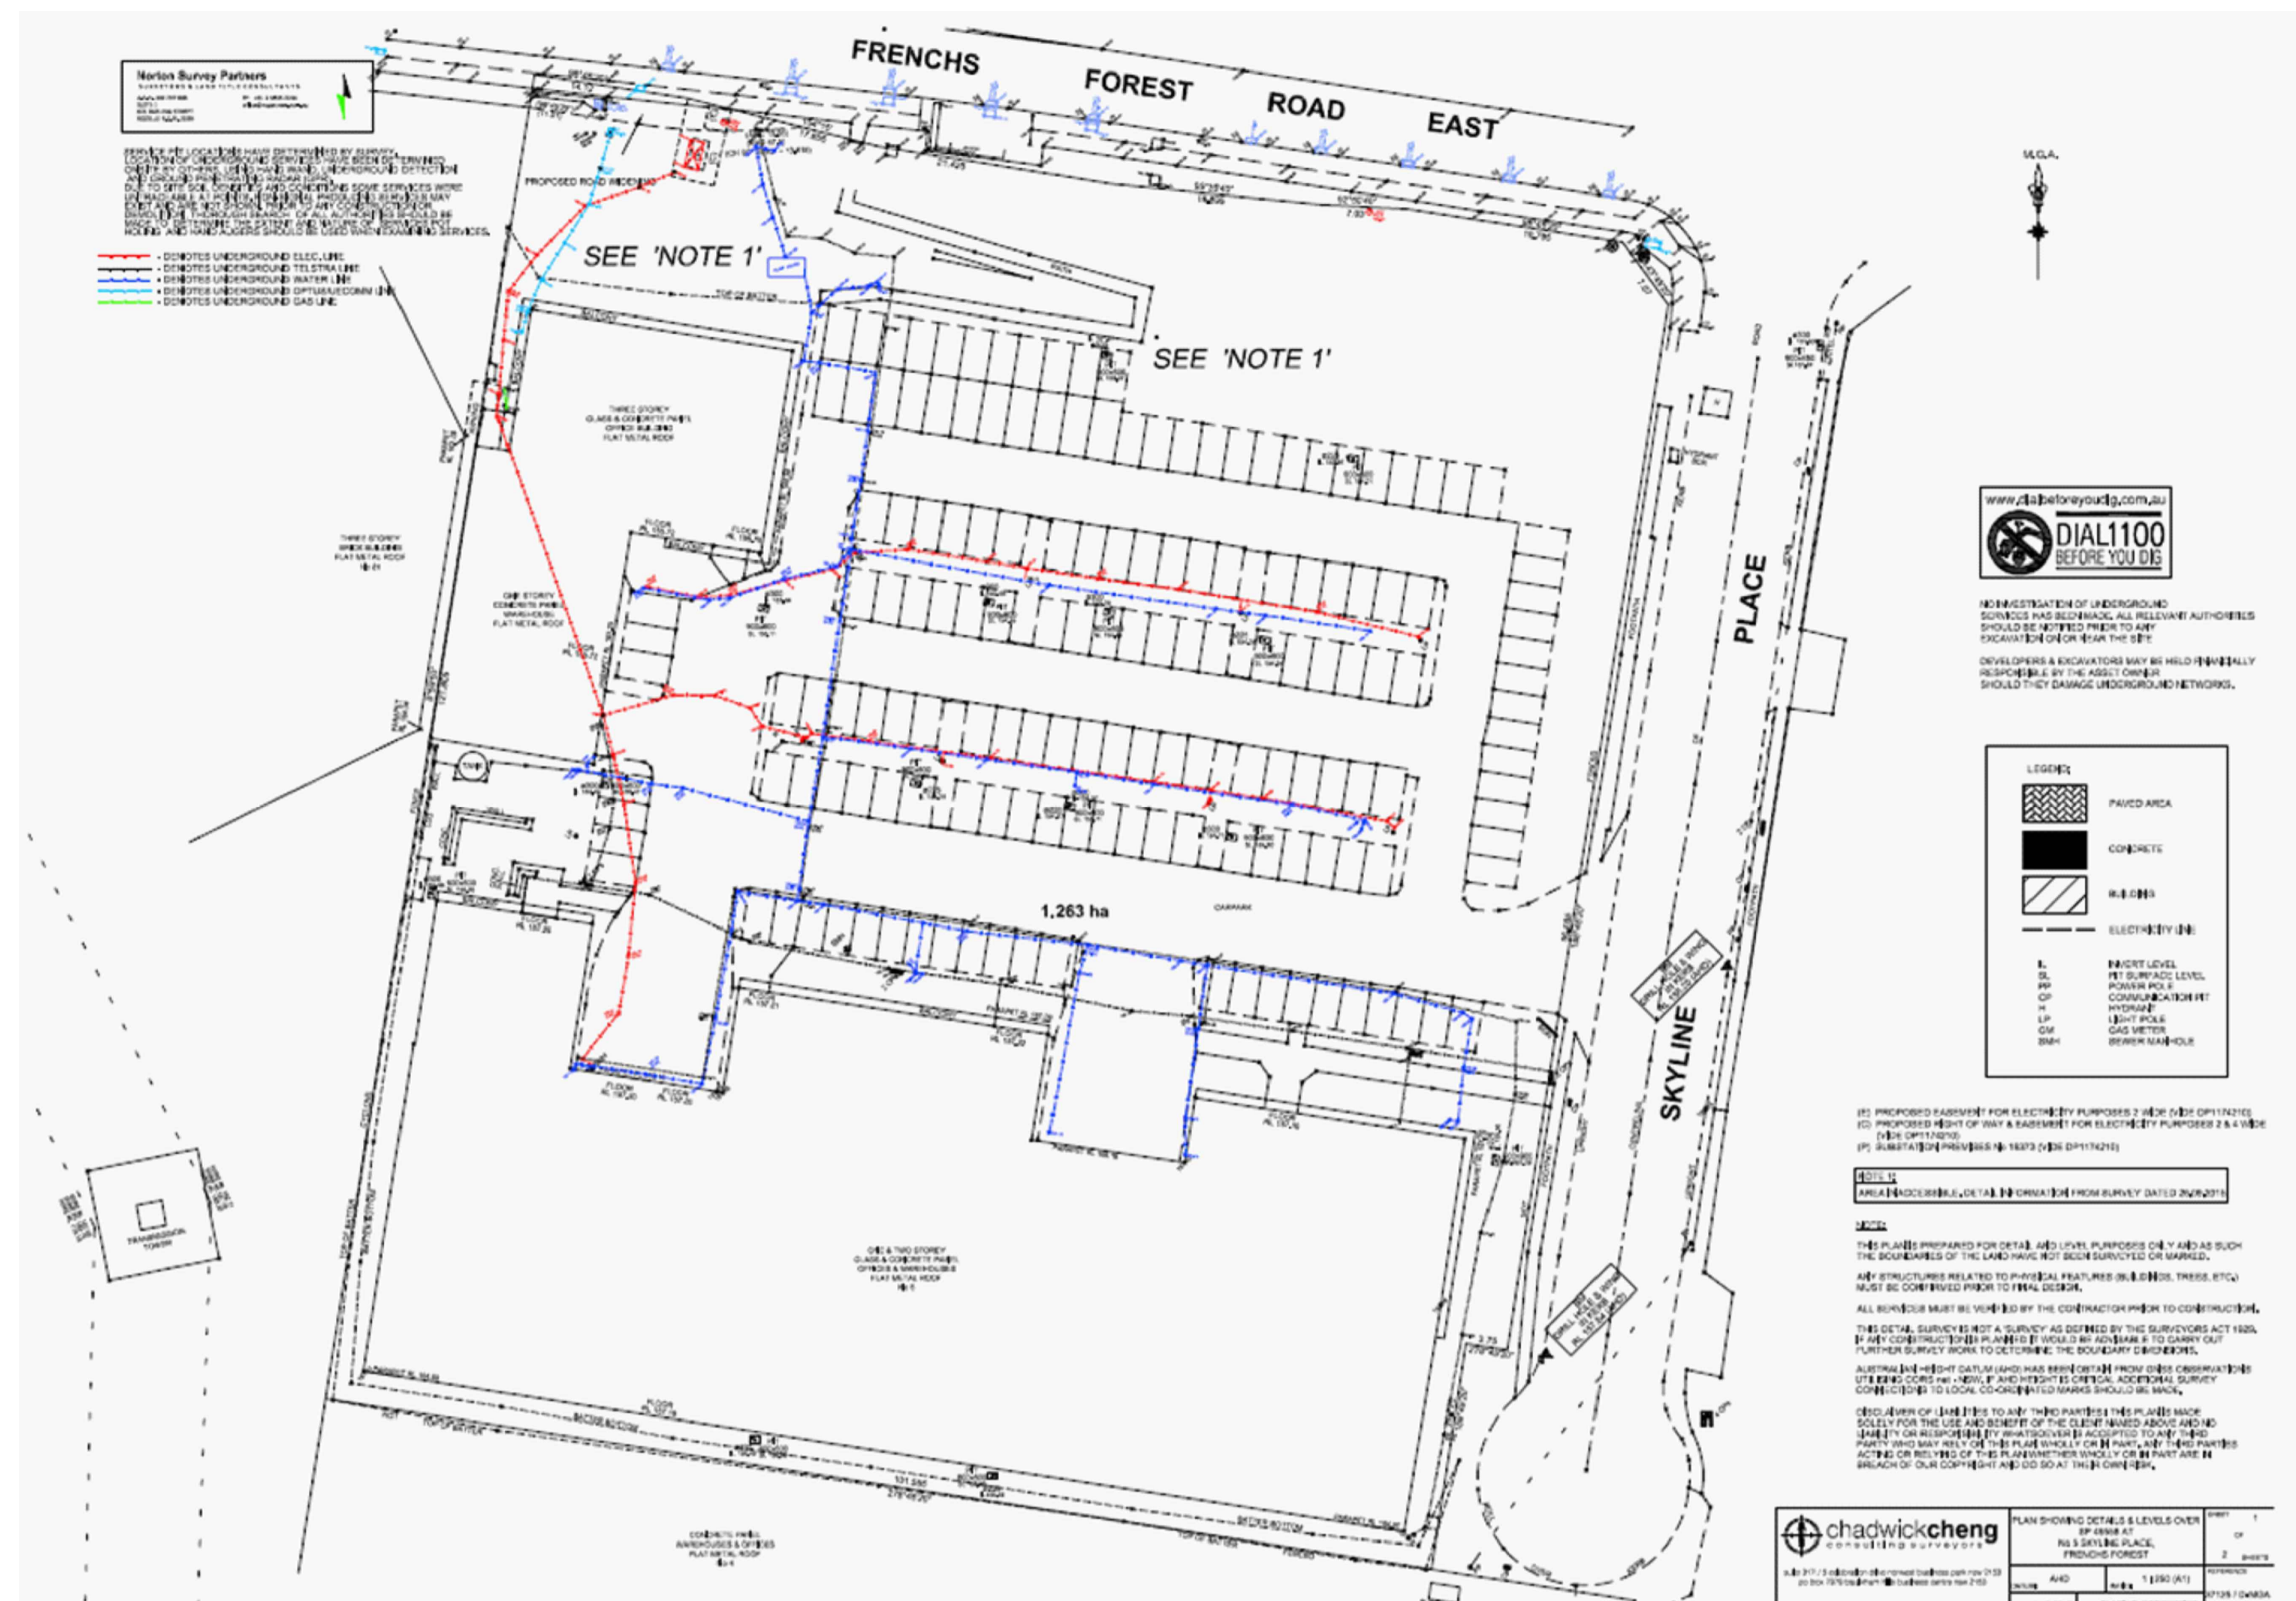

SURVEY OF EXISTING SERVICES WITHIN DEVELOPMENT SITE

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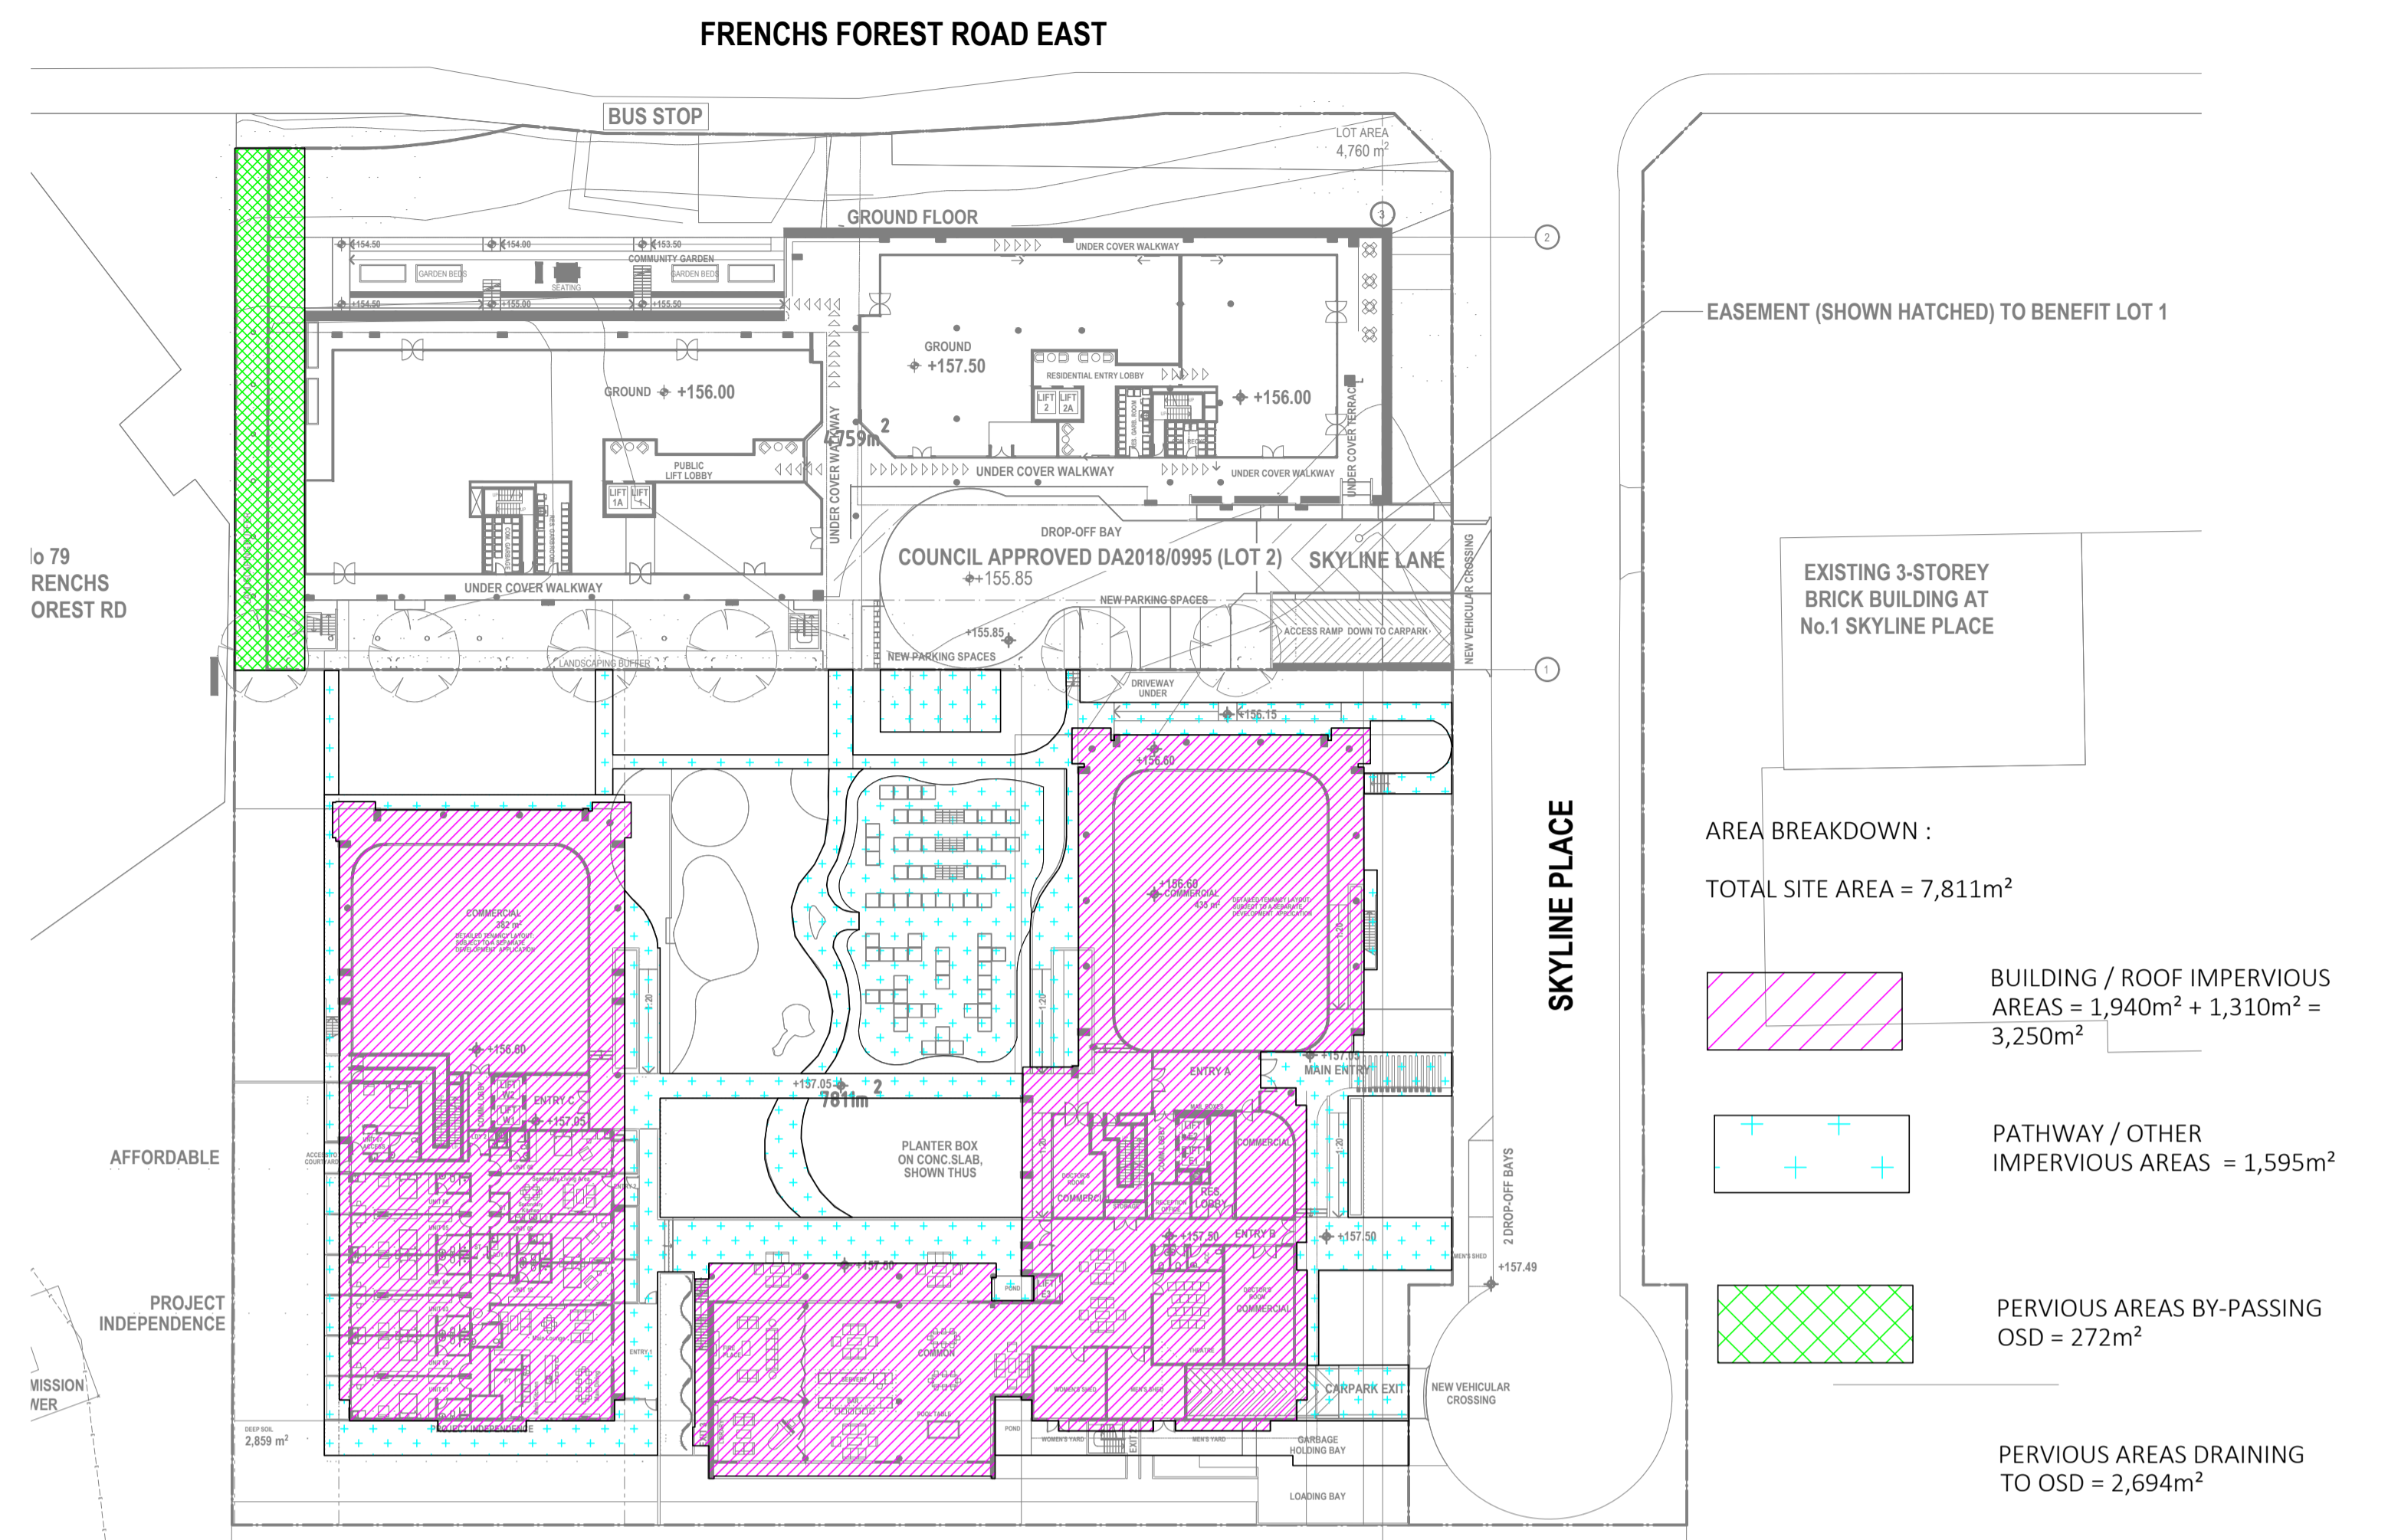
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		Drawn & Designed By : R. Koh		Designed By ING CONSULTING ENGINEERS PTY LTD P. O BOX 1543 BAULKHAM HILLS NSW 1755 F : (02) 8807 5656 M: 0433 778 109 E : ken@ingengineers.com.au	Project Proposed Seniors Living (Stage 2)	Drawing Title Existing Services and Survey Plan	
		Checked By : N. Evans		At 5 Skyline Place Frenchs Forest NSW 2086	Date January 2021	Scale As Shown @ A1	
A Development Application		Approved By : Kenneth T. NG MIEAust CPEng NER APEC Engineer IntPE(Aus) (Reg. No. 2206352) RPEQ Registered Certifier (Hydraulic (stormwater), Road & Drainage and Stormwater) NSW Fair Trading (Reg. No. BDC0827)		Client	Project No. 284012021DA	Drawing & Sheet No./Issue 28401-00/21 / A	
Issue	Description	Date of Drawing					

PIT / NODE DETAILS		Version 8						Constraint
Name	Max HGL	Max Pond HGL	Max Surface Flow Arriving (cu.m/s)	Max Pond Volume (cu.m)	Min Freeboard (m)	Overflow (cu.m/s)	None	
Overflow Pit -1	150.42		0		5.48			
Overflow Pit-2	149.12		0		0.88		None	
KIP	147.16		0					
SUB-CATCHMENT DETAILS								Due to Storm
Name	Max Flow Q (cu.m/s)	Paved Max Q (cu.m/s)	Grassed Max Q (cu.m/s)	Paved Tc (min)	Grassed Tc (min)	Supp. Tc (min)		
Lot1-Pre	0.479	0	0.479	5	5	0	AR&R 100 year, 15 minutes storm, average 176.2 mm/h, Zone 1	
Lot1-Post (ex bypass)	0.5	0.335	0.165	5	5	0	AR&R 100 year, 15 minutes storm, average 176.2 mm/h, Zone 1	
Bypass Area	0.017	0	0.017	5	5	0	AR&R 100 year, 15 minutes storm, average 176.2 mm/h, Zone 1	
Outflow Volumes for Total Catchment (0.48 impervious + 1.08 pervious = 1.56 total ha)								
Storm	Total Rainfall cu.m 359.54	Total Runoff cu.m (Runoff %)	Impervious Runoff cu.m (Runoff %)	Pervious Runoff cu.m (Runoff %)				
AR&R 100 year, 5 minutes storm, average 276.1 mm/h, Zone 1		261.08 (72.6%)	106.72 (95.7%)	154.36 (62.2%)				
AR&R 100 year, 10 minutes storm, average 211.2 mm/h, Zone 1	549.89	428.30 (77.9%)	165.79 (97.2%)	262.51 (69.2%)				
AR&R 100 year, 15 minutes storm, average 176.2 mm/h, Zone 1	688.15	546.64 (79.4%)	208.69 (97.7%)	337.96 (71.2%)				
AR&R 100 year, 20 minutes storm, average 153.4 mm/h, Zone 1	798.8	639.86 (80.1%)	243.03 (98.0%)	396.83 (72.0%)				
AR&R 100 year, 25 minutes storm, average 136.9 mm/h, Zone 1	891.09	715.11 (80.3%)	271.66 (98.2%)	443.44 (72.2%)				
AR&R 100 year, 30 minutes storm, average 124.4 mm/h, Zone 1	971.69	780.99 (80.4%)	296.67 (98.4%)	484.32 (72.3%)				
AR&R 100 year, 45 minutes storm, average 99.58 mm/h, Zone 1	1166.72	939.91 (80.6%)	357.19 (98.7%)	582.72 (72.4%)				
AR&R 100 year, 1 hour storm, average 84.46 mm/h, Zone 1	1319.43	1064.34 (80.7%)	404.58 (98.8%)	659.76 (72.5%)				
AR&R 100 year, 2 hours storm, average 56.68 mm/h, Zone 1	1770.9	1434.30 (81.0%)	544.67 (99.1%)	889.63 (72.8%)				
AR&R 100 year, 4.5 hours storm, average 35 mm/h, Zone 1	2460.47	1971.32 (80.1%)	758.64 (99.4%)	1212.68 (71.5%)				
AR&R 100 year, 6 hours storm, average 29.63 mm/h, Zone 1	2777.28	2196.08 (79.1%)	856.95 (99.4%)	1339.12 (69.9%)				
AR&R 100 year, 9 hours storm, average 23 mm/h, Zone 1	3233.83	2471.68 (76.4%)	998.63 (99.5%)	1473.05 (66.0%)				
PIPE DETAILS		Max Q (cu.m/s)	Max V (m/s)	Max U/S HGL (m)	Max D/S HGL (m)	Due to Storm		
Pipe 3	0.369	3.15	149.685	149.121	utes storm, average 136.9 mm/h, Zone 1			
Pipe 2	0.369	8.24	148.157	147.157	utes storm, average 136.9 mm/h, Zone 1			
Pipe 1	0.369	8.24	148.157	147.157	utes storm, average 136.9 mm/h, Zone 1			
CHANNEL DETAILS		Max Q (cu.m/s)	Max V (m/s)	Chainage (m)	Max D HGL (m)	Due to Storm		
OF	0	0	1.939	0	Max DxV 0			
DETENTION BASIN DETAILS	Max WL	MaxVol	Max Q	Max Q	Max Width 0			
OSD	155.49	80.5	Total 0.369	Low Level 0.369	High Level 0			
CONTINUITY CHECK FOR AR&R 100 year, 15 minutes storm, average 176.2 mm/h, Zone 1								
Node	Inflow (cu.m)	Outflow (cu.m)	Storage Change (cu.m)	Difference %				
KO	245	245	0	0				
OSD	293.11	293.03	0.08	0				
Overflow Pit -1	293.03	293.03	0	0				
Overflow Pit-2	293.03	293.03	0	0				
KIP	293.03	293.03	0	0				
K O	8.53	8.53	0	0				

DRAINS MODELLING RESULTS




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CATCHMENT PLAN FOR OSD CALCULATIONS

SCALE 1 : 500

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HYDRAULIC GRADE LINE (FROM OSD TO KIP)

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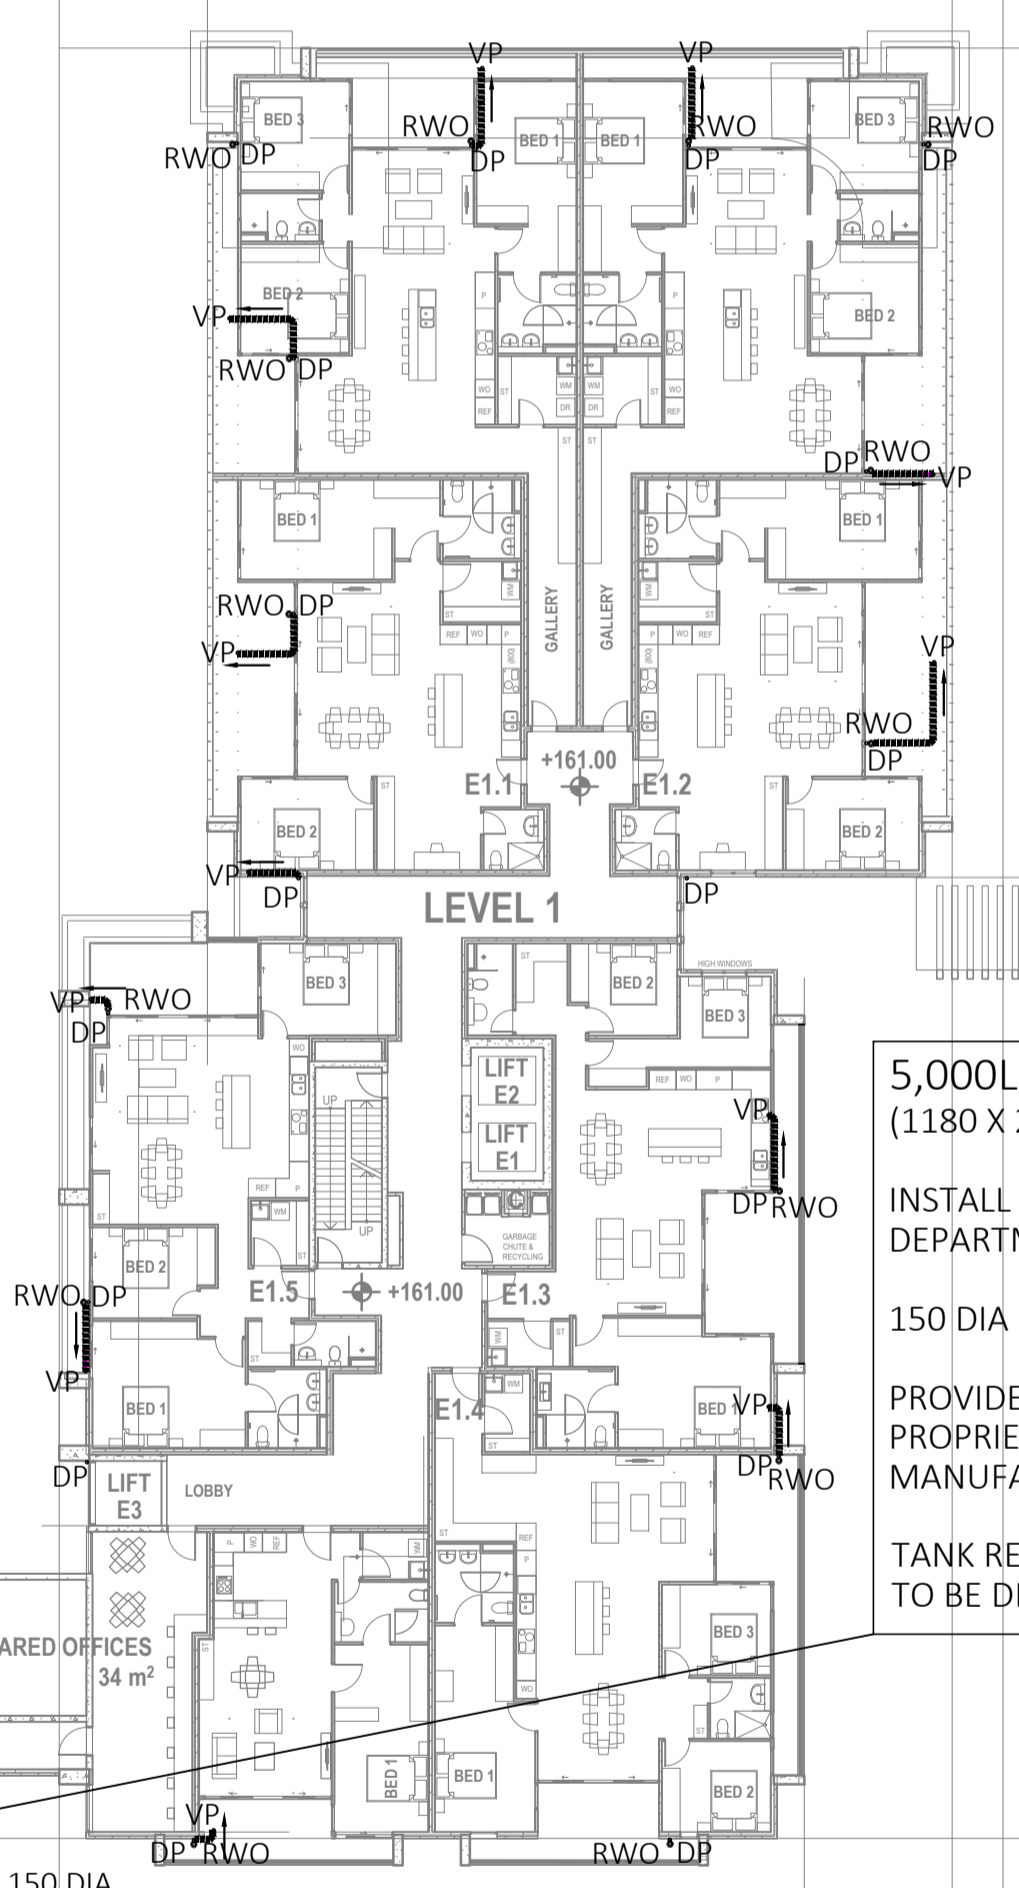
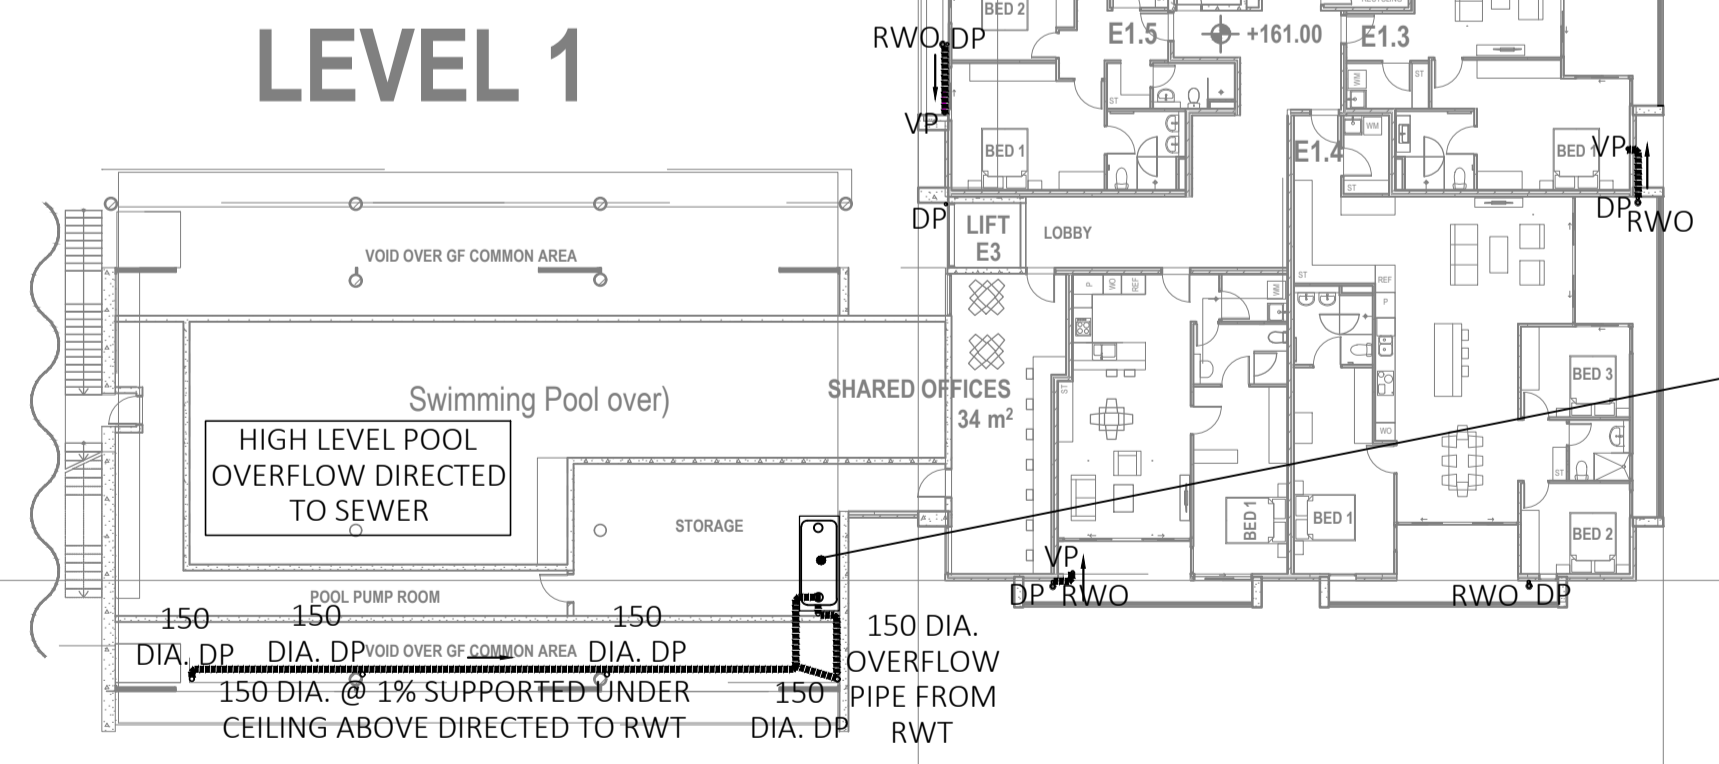
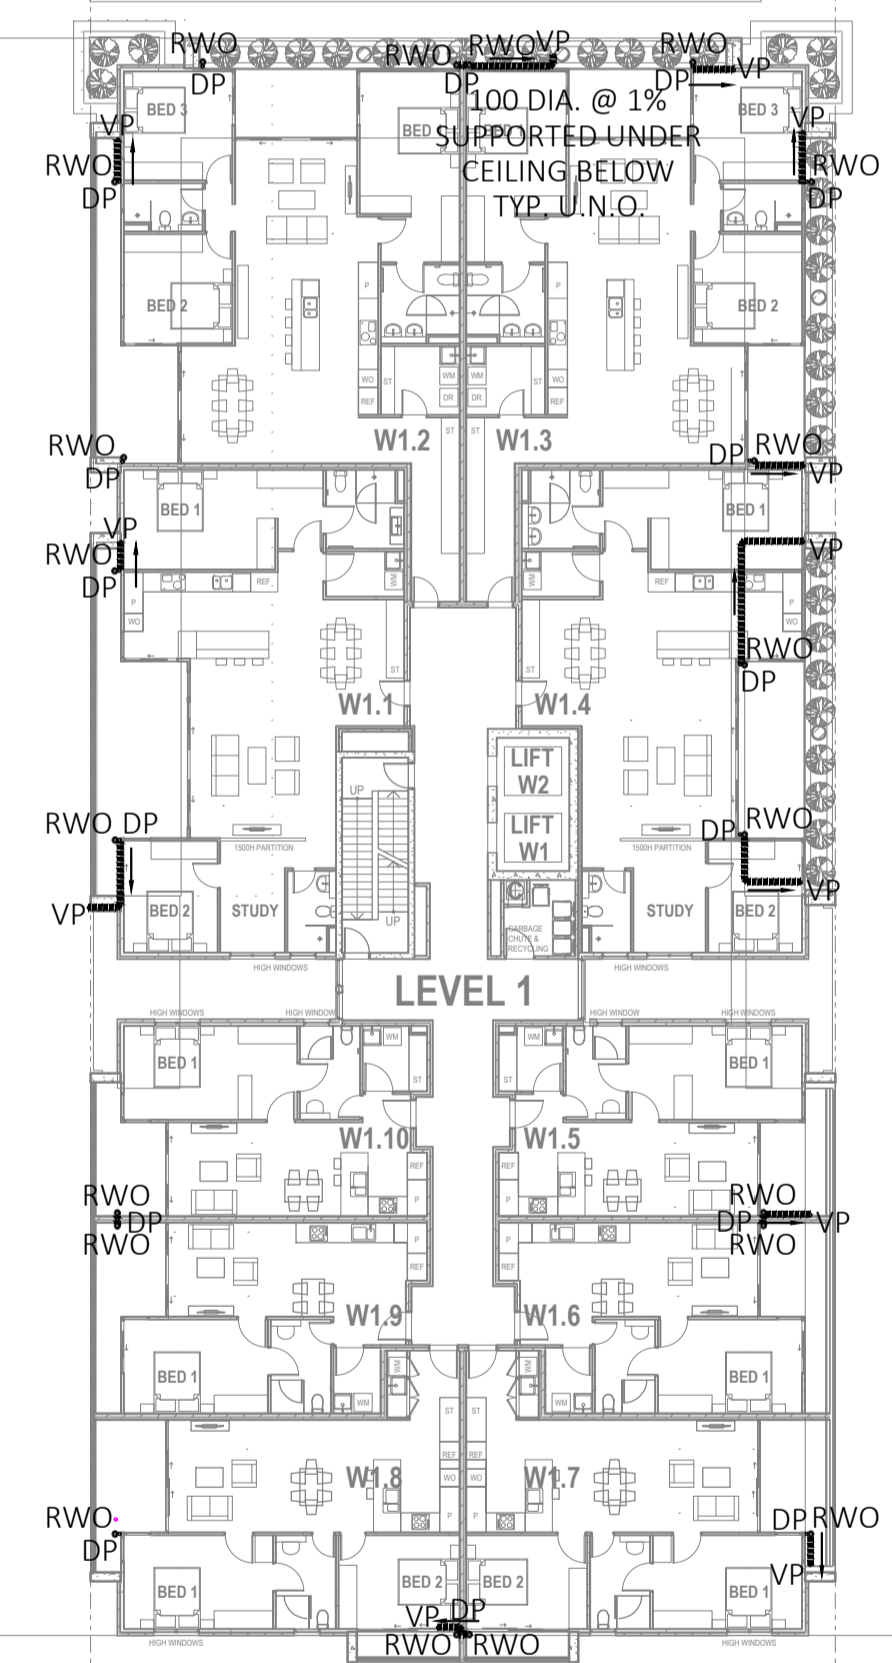
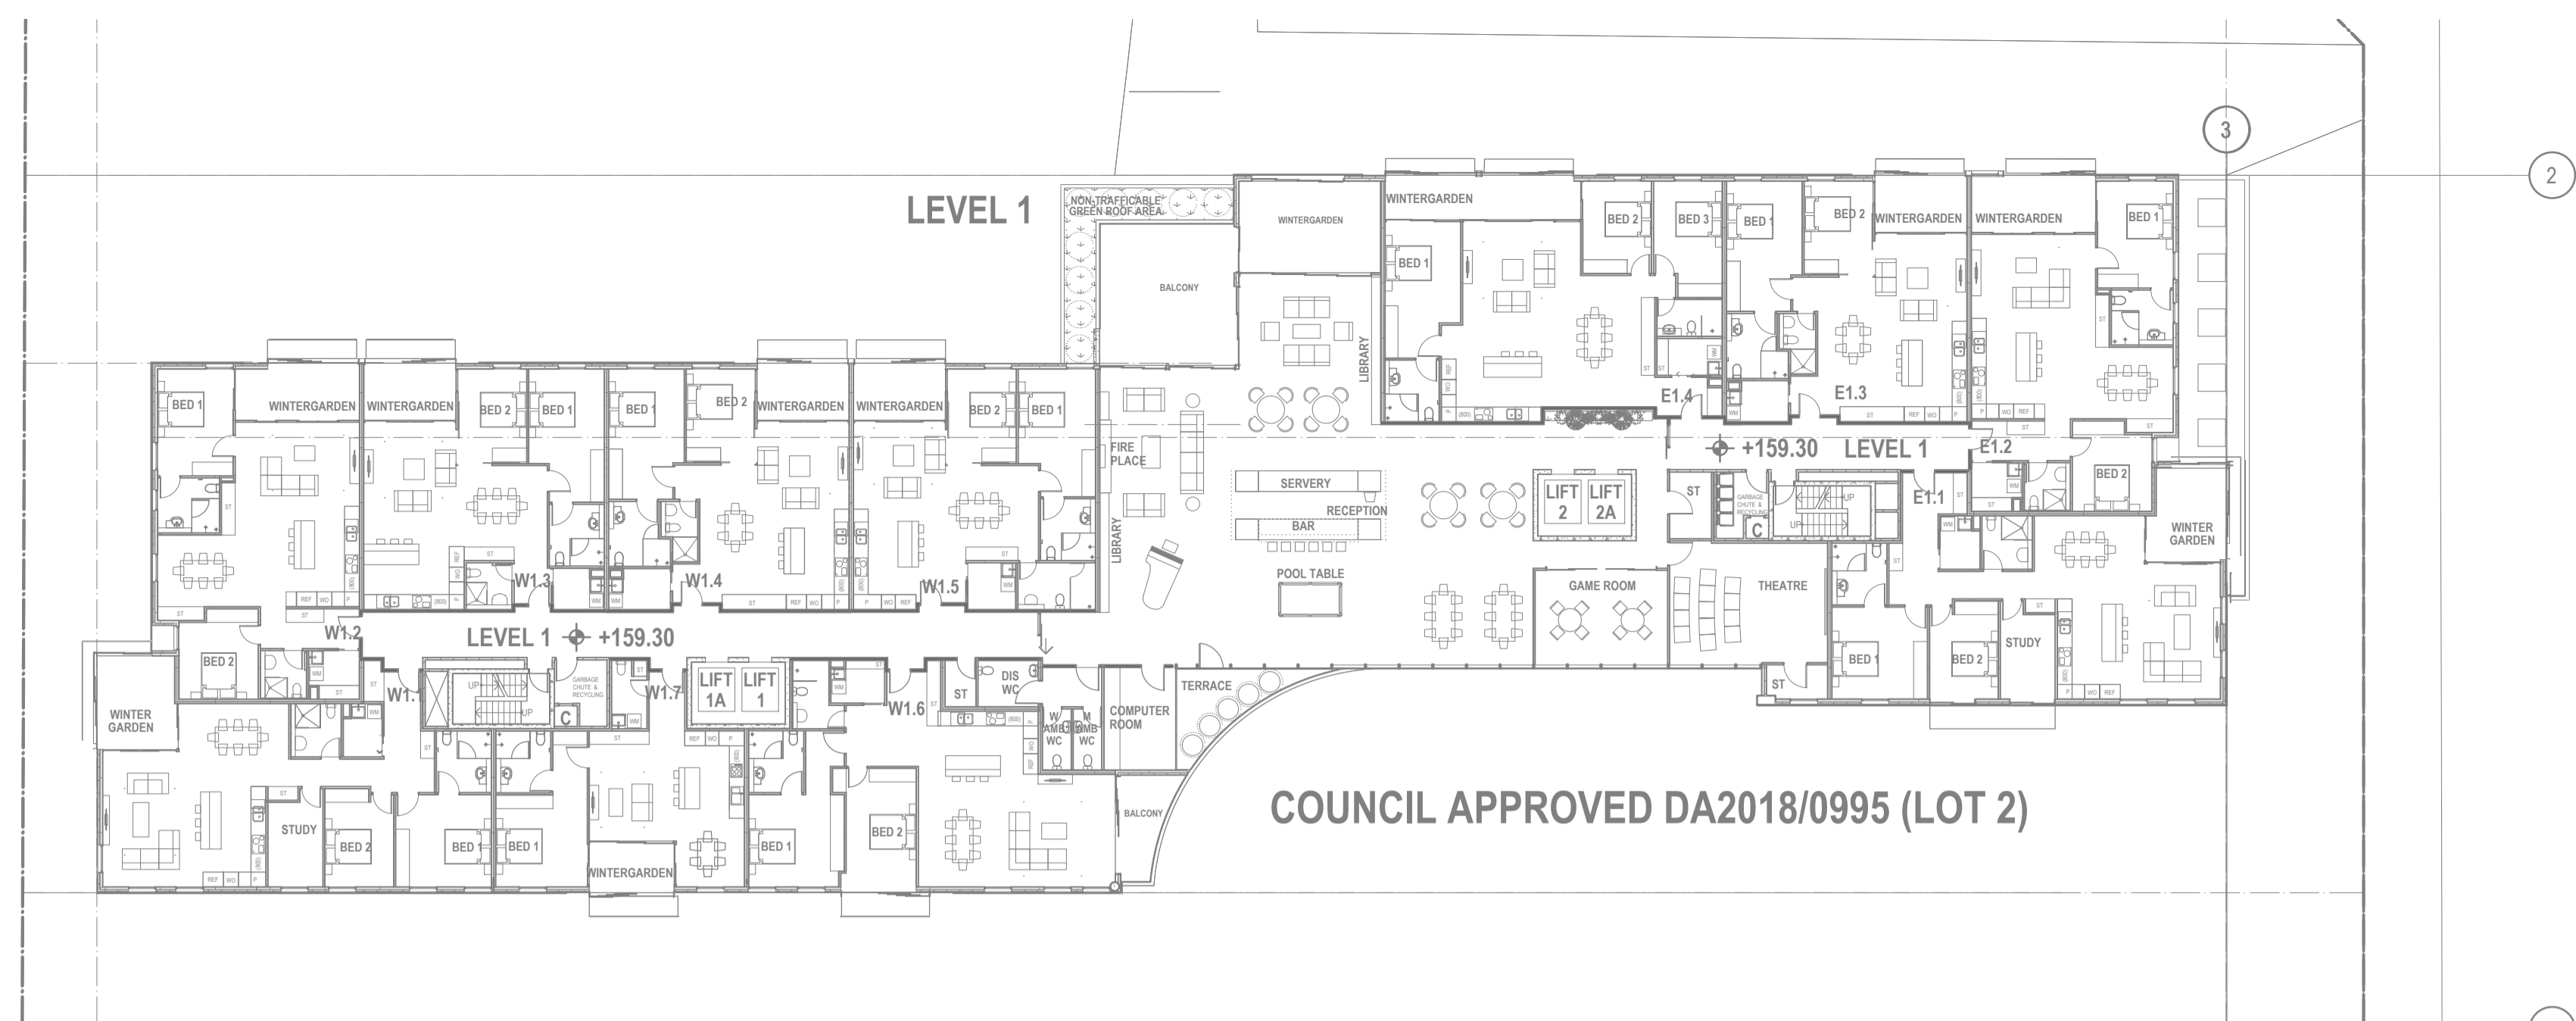
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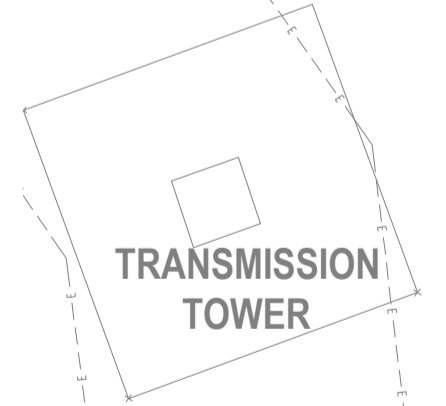
Drawn & Designed By : R. Koh			Designed By ING CONSULTING ENGINEERS PTY LTD P. O BOX 1543 BAULKHAM HILLS NSW 1755 F : (02) 8807 5656 M: 0433 778 109 E : ken@ingengineers.com.au		Project Proposed Seniors Living (Stage 2)		Drawing Title Catchment Plan & OSD Calculations	
Checked By : N. Evans			At 5 Skyline Place Frenchs Forest NSW 2086		Date January 2021	Scale As Shown @ A1		
Approved By : Kenneth T. NG MIE Aust CP Eng NER APEC Engineer IntPE (Aus) (Reg. No. 2206352) RPEQ Registered Certifier (Hydraulic (stormwater), Road & Drainage and Stormwater) NSW Fair Trading (Reg. No. BDC0827)			Client		Project No. 284012021DA	Drawing & Sheet No./Issue 28401-04/21 / A		
A	Development Application	28 Jan. 2021						
Issue	Description	Date of Drawing						

No 79
FRENCHS
FOREST RD
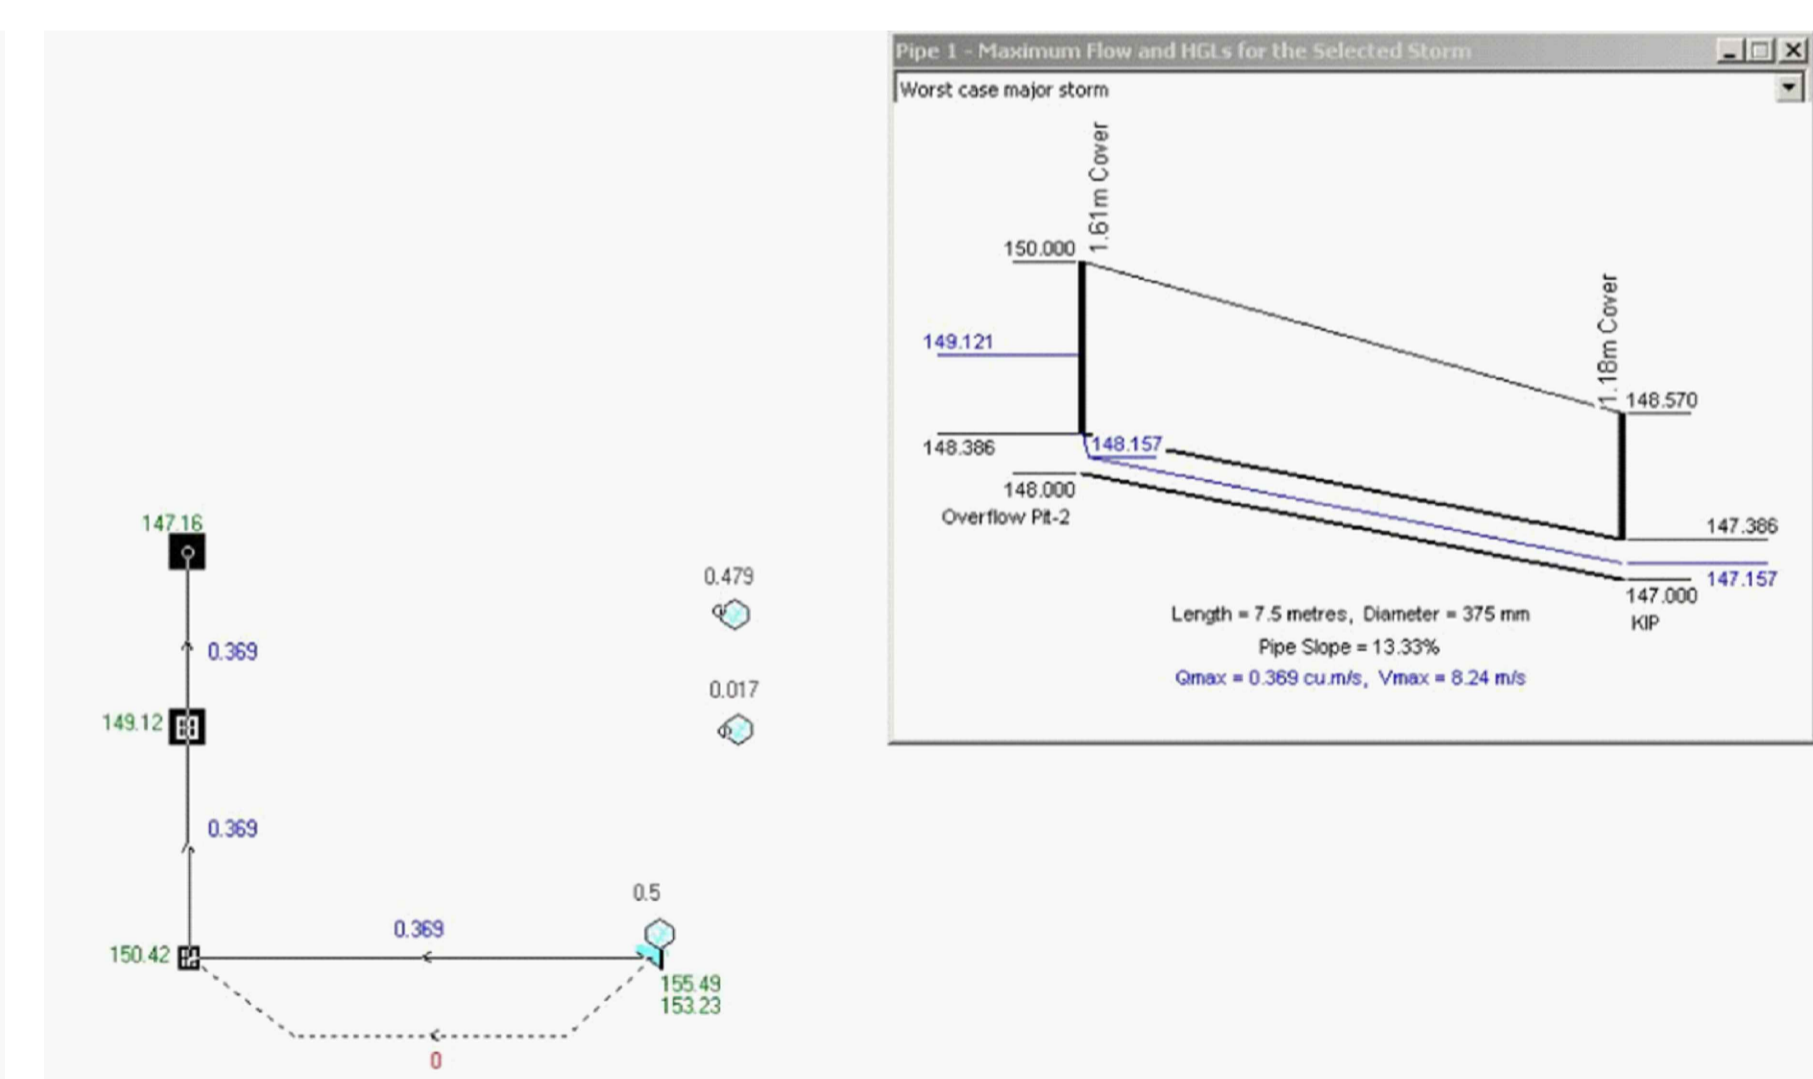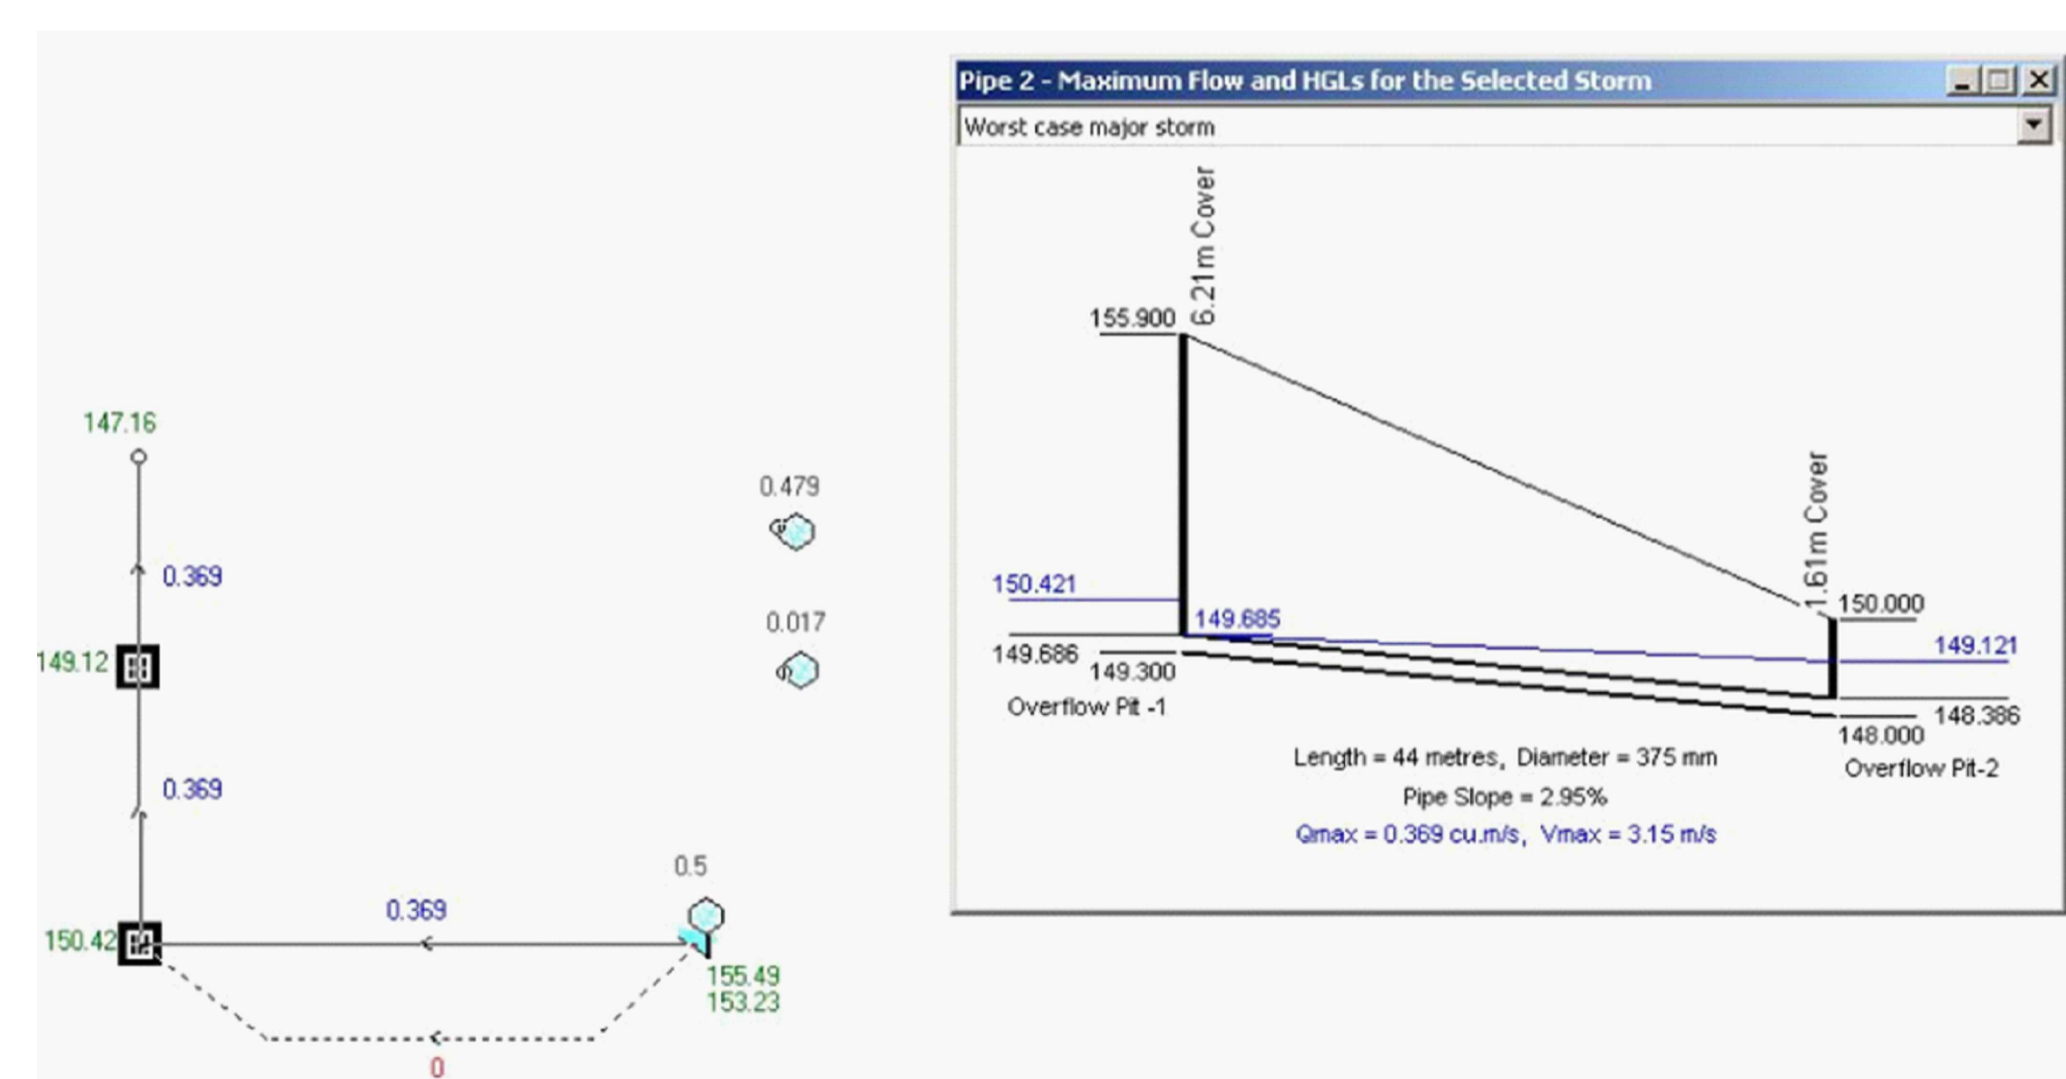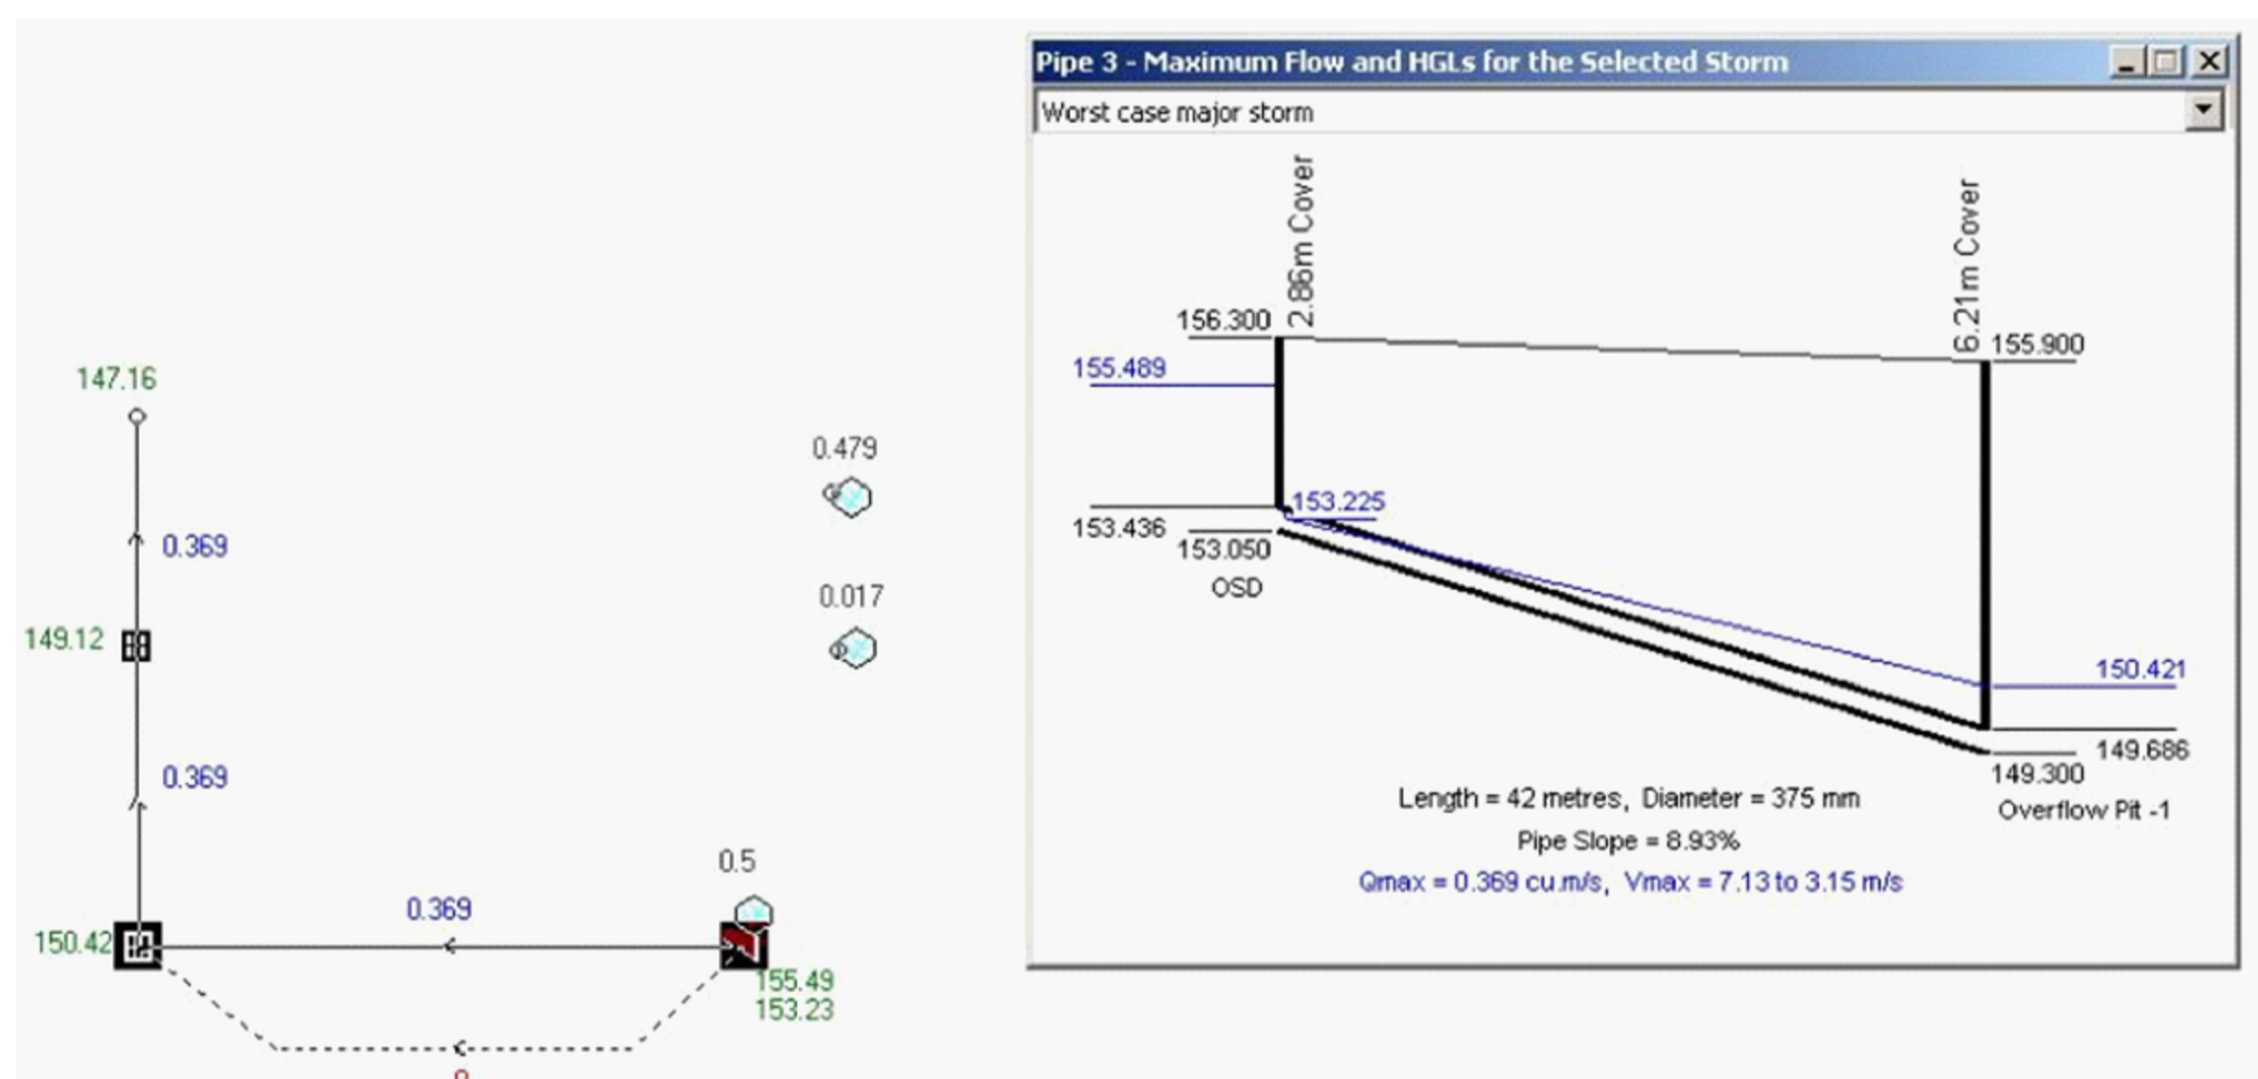
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5,000L SLIMLINE RAINWATER TANK (FOR IRRIGATION ONLY)
(1180 X 2800 X 1850 (H)) SEE DETAIL.
INSTALL IN ACCORDANCE WITH MANUFACTURER'S SPECIFICATION, AS3500,
DEPARTMENT OF HEALTH AND COUNCIL'S GUIDELINES.
150 DIA INLETS , 150 DIA OVERFLOW OUTLET
PROVIDE FIRST FLUSH RAINWATER HEAD TO EACH DOWNPIPE OR EQUIVALENT
PROPRIETARY DEVICE AND INLINE REFLUX VALVE TO 100 DIA. OUTLET PIPE TO
MANUFACTURER'S SPECIFICATION.
TANK RE-USE PUMP CONTROL UNIT METER BOX MOUNTED TO ALL. LOCATION
TO BE DETERMINED.



LEGEND

PIPEWORK

- 100 DIA. PVC UPSTAND TO PIPE
- 100 DIA. PVC DOWNSTAND TO PIPE
- 100 DIA. PVC TO DOWNSTAND
- 100 DIA. PVC TO UPSTAND
- 100 DIA. PVC TO DOWNSTAND (FOR RAINWATER)
- 100 DIA. PVC TO UPSTAND (FOR RAINWATER)
- 100 DIA. PVC TO DOWNSTAND (FOR RAINWATER)
- 100 DIA. PVC TO UPSTAND (FOR RAINWATER)



SERVICE ACCESSORIES

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		Checked By : N. Evans				At 5 Skyline Place Frenchs Forest NSW 2086	Date January 2021	Scale 1 : 250 @ A1
		Approved By : Kenneth T. NG MIE Aust CP Eng NER APEC Engineer IntPE (Aus) (Reg. No. 2206352) RPEQ Registered Certifier (Hydraulic (stormwater), Road & Drainage and Stormwater) NSW Fair Trading (Reg. No. BDC0827)				Client	Project No. 284012021DA	Drawing & Sheet No./Issue 28401-06/20 / A
A	Development Application	28 Jan. 2021						
Issue	Description	Date of Drawing						




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- LEGEND**
- PIPEWORK
 - CONCRETE
 - GLASS
 - ALUMINIUM
 - STEEL
 - WOOD
 - PAINT
 - FINISH
 - MECHANICAL
 - ELECTRICAL
 - PLUMBING
 - LANDSCAPE
 - EXTERNAL LIGHTING
 - EXTERNAL FLOOR FINISH
 - CLEANING
- ABBREVIATIONS:**
- AWNING
 - CLERESTORY
 - COMMUNITY GARDEN
 - COMMON
 - CORRIDOR
 - DOOR
 - DOOR SWELL
 - DOOR STOP
 - DOOR SWELL STOP
 - DOOR SWELL STOP (1/2)
 - DOOR SWELL STOP (3/4)
 - DOOR SWELL STOP (1)
 - DOOR SWELL STOP (1 1/2)
 - DOOR SWELL STOP (2)
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		Drawn & Designed By : R. Koh		Designed By ING CONSULTING ENGINEERS PTY LTD P. O BOX 1543 BAULKHAM HILLS NSW 1755 F : (02) 8807 5656 M: 0433 778 109 E : ken@ingengineers.com.au		Project Proposed Seniors Living (Stage 2)		Drawing Title Level 6 Floor Plan		
		Checked By : N. Evans		At 5 Skyline Place Frenchs Forest NSW 2086		Date January 2021	Scale 1 : 250 @ A1			
		Approved By : Kenneth T. NG MIEAust CPEng NER APEC Engineer IntPE(Aus) (Reg. No. 2206352) RPEQ Registered Certifier (Hydraulic (stormwater), Road & Drainage and Stormwater) NSW Fair Trading (Reg. No. BDC0827)		Client		Project No. 284012021DA	Drawing & Sheet No./Issue 28401-11/20 / A			
A	Development Application	28 Jan. 2021								
Issue	Description	Date of Drawing								

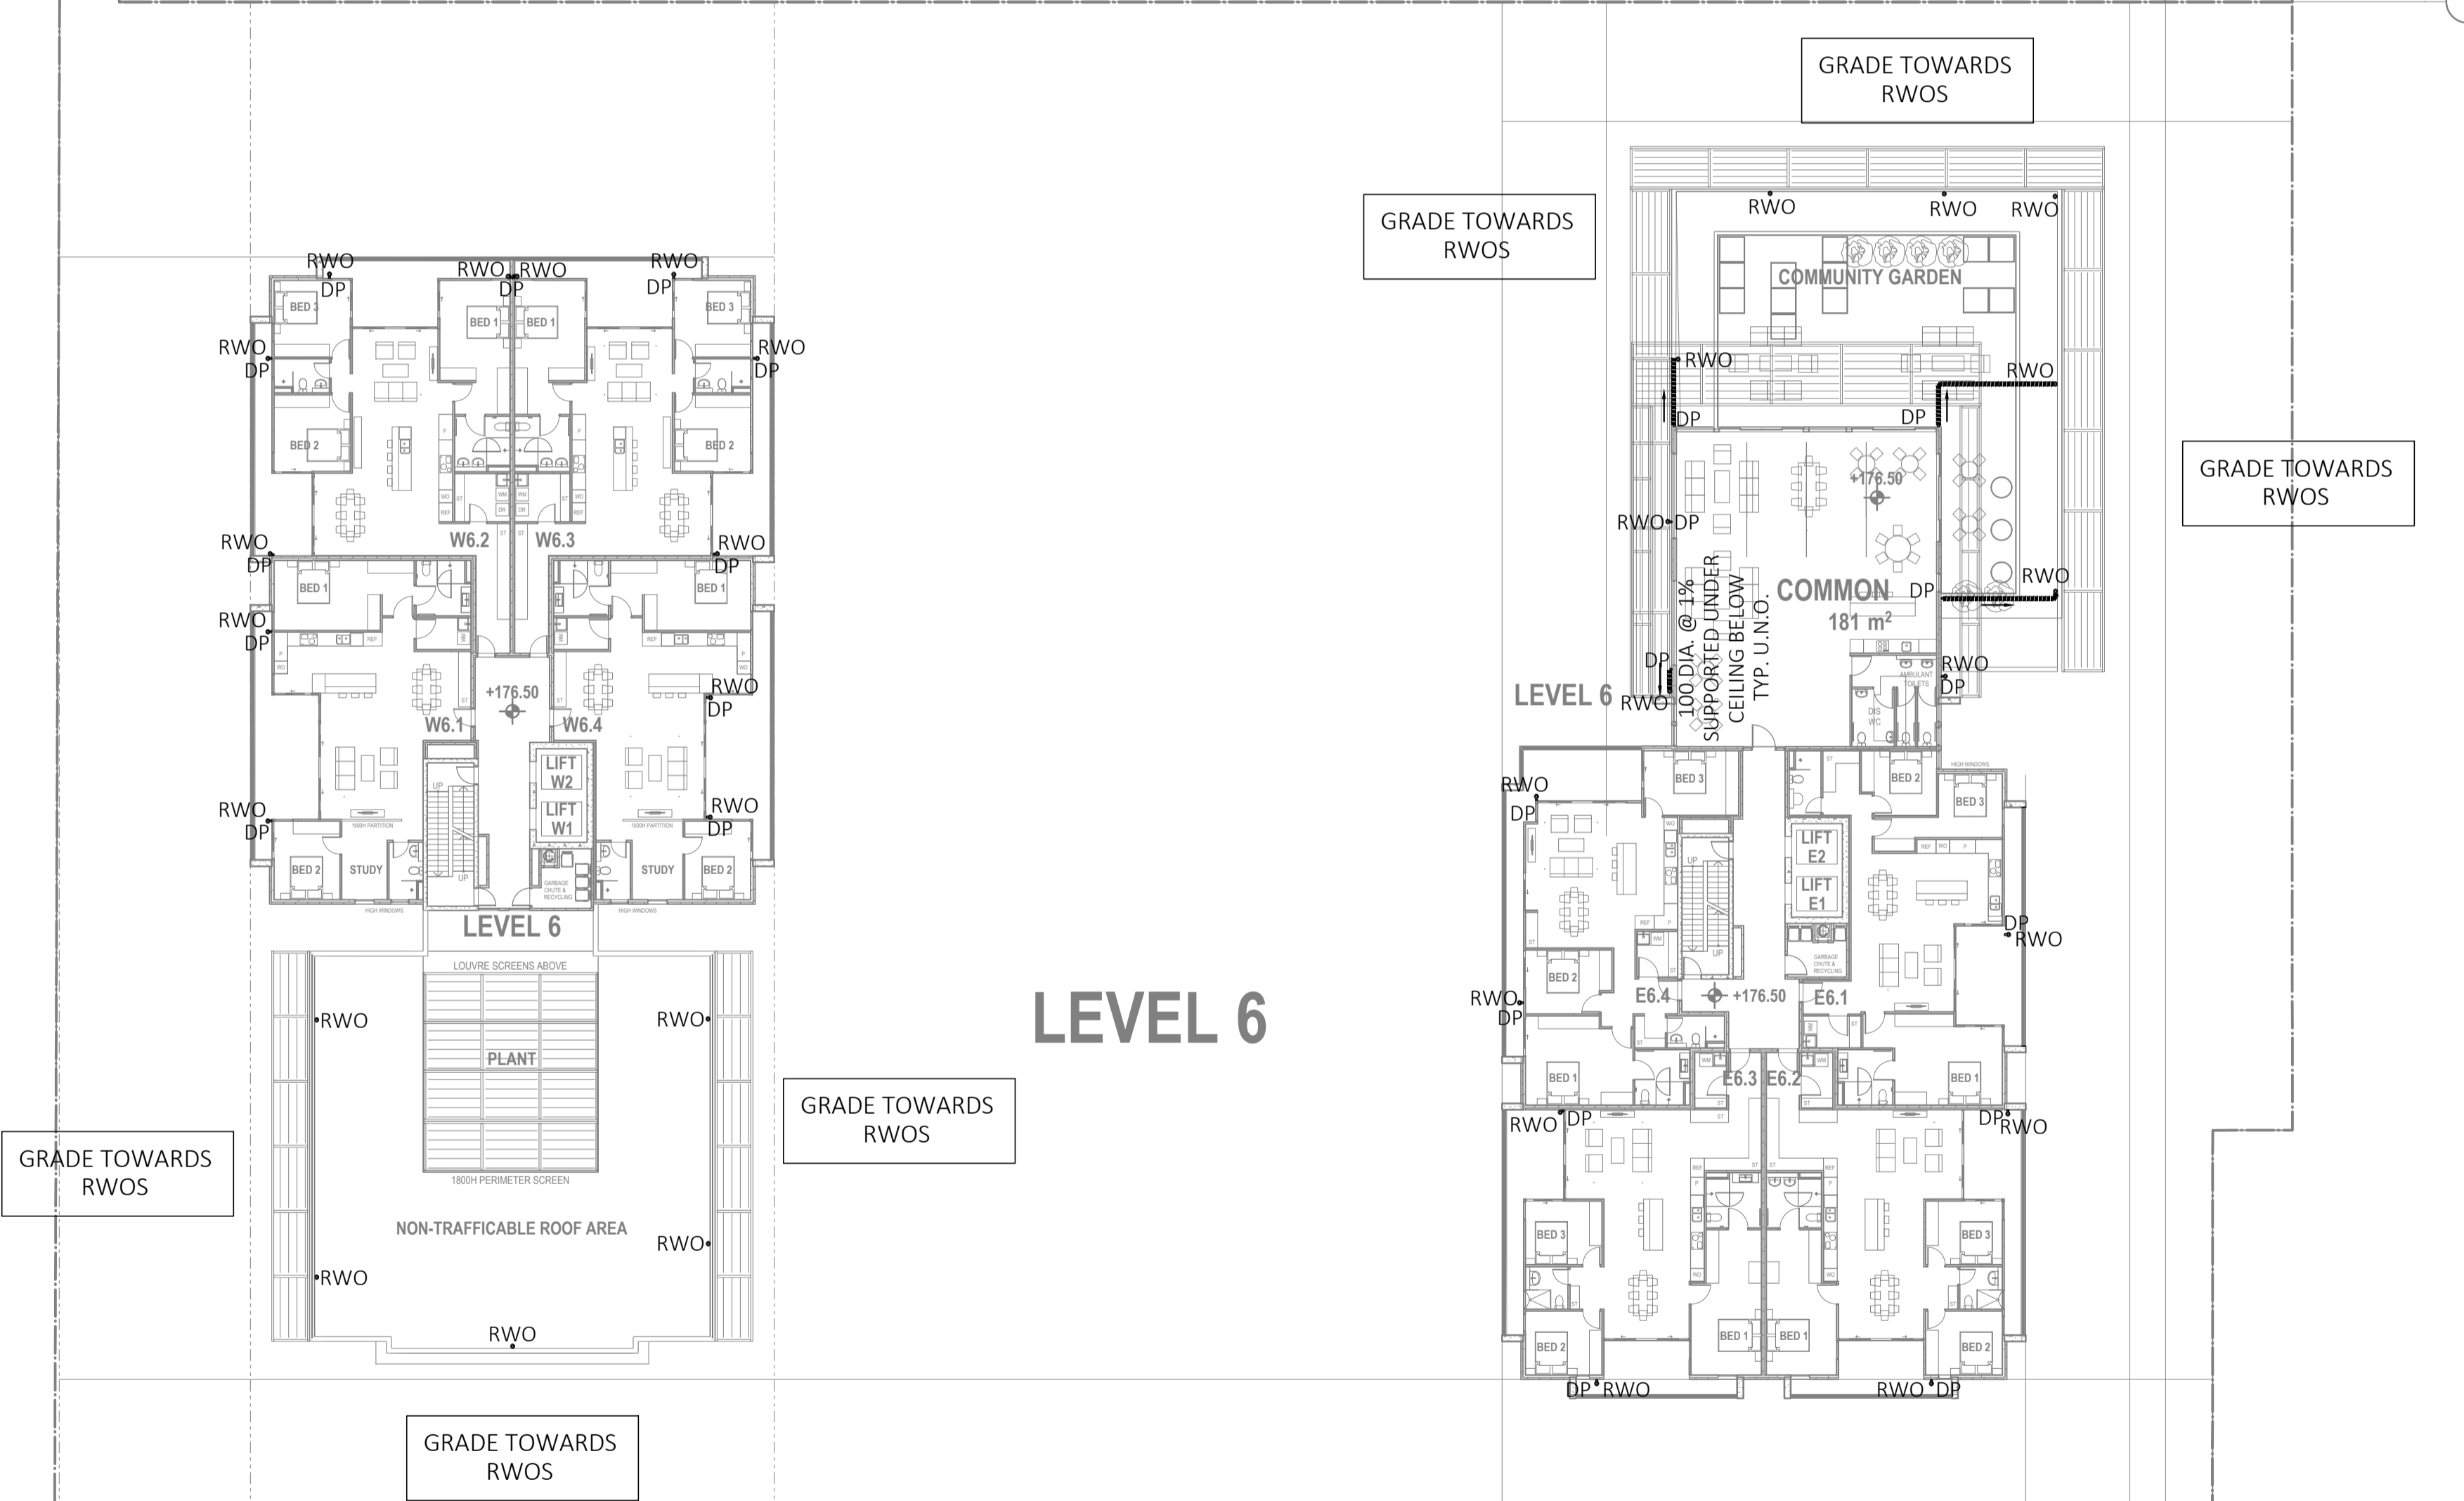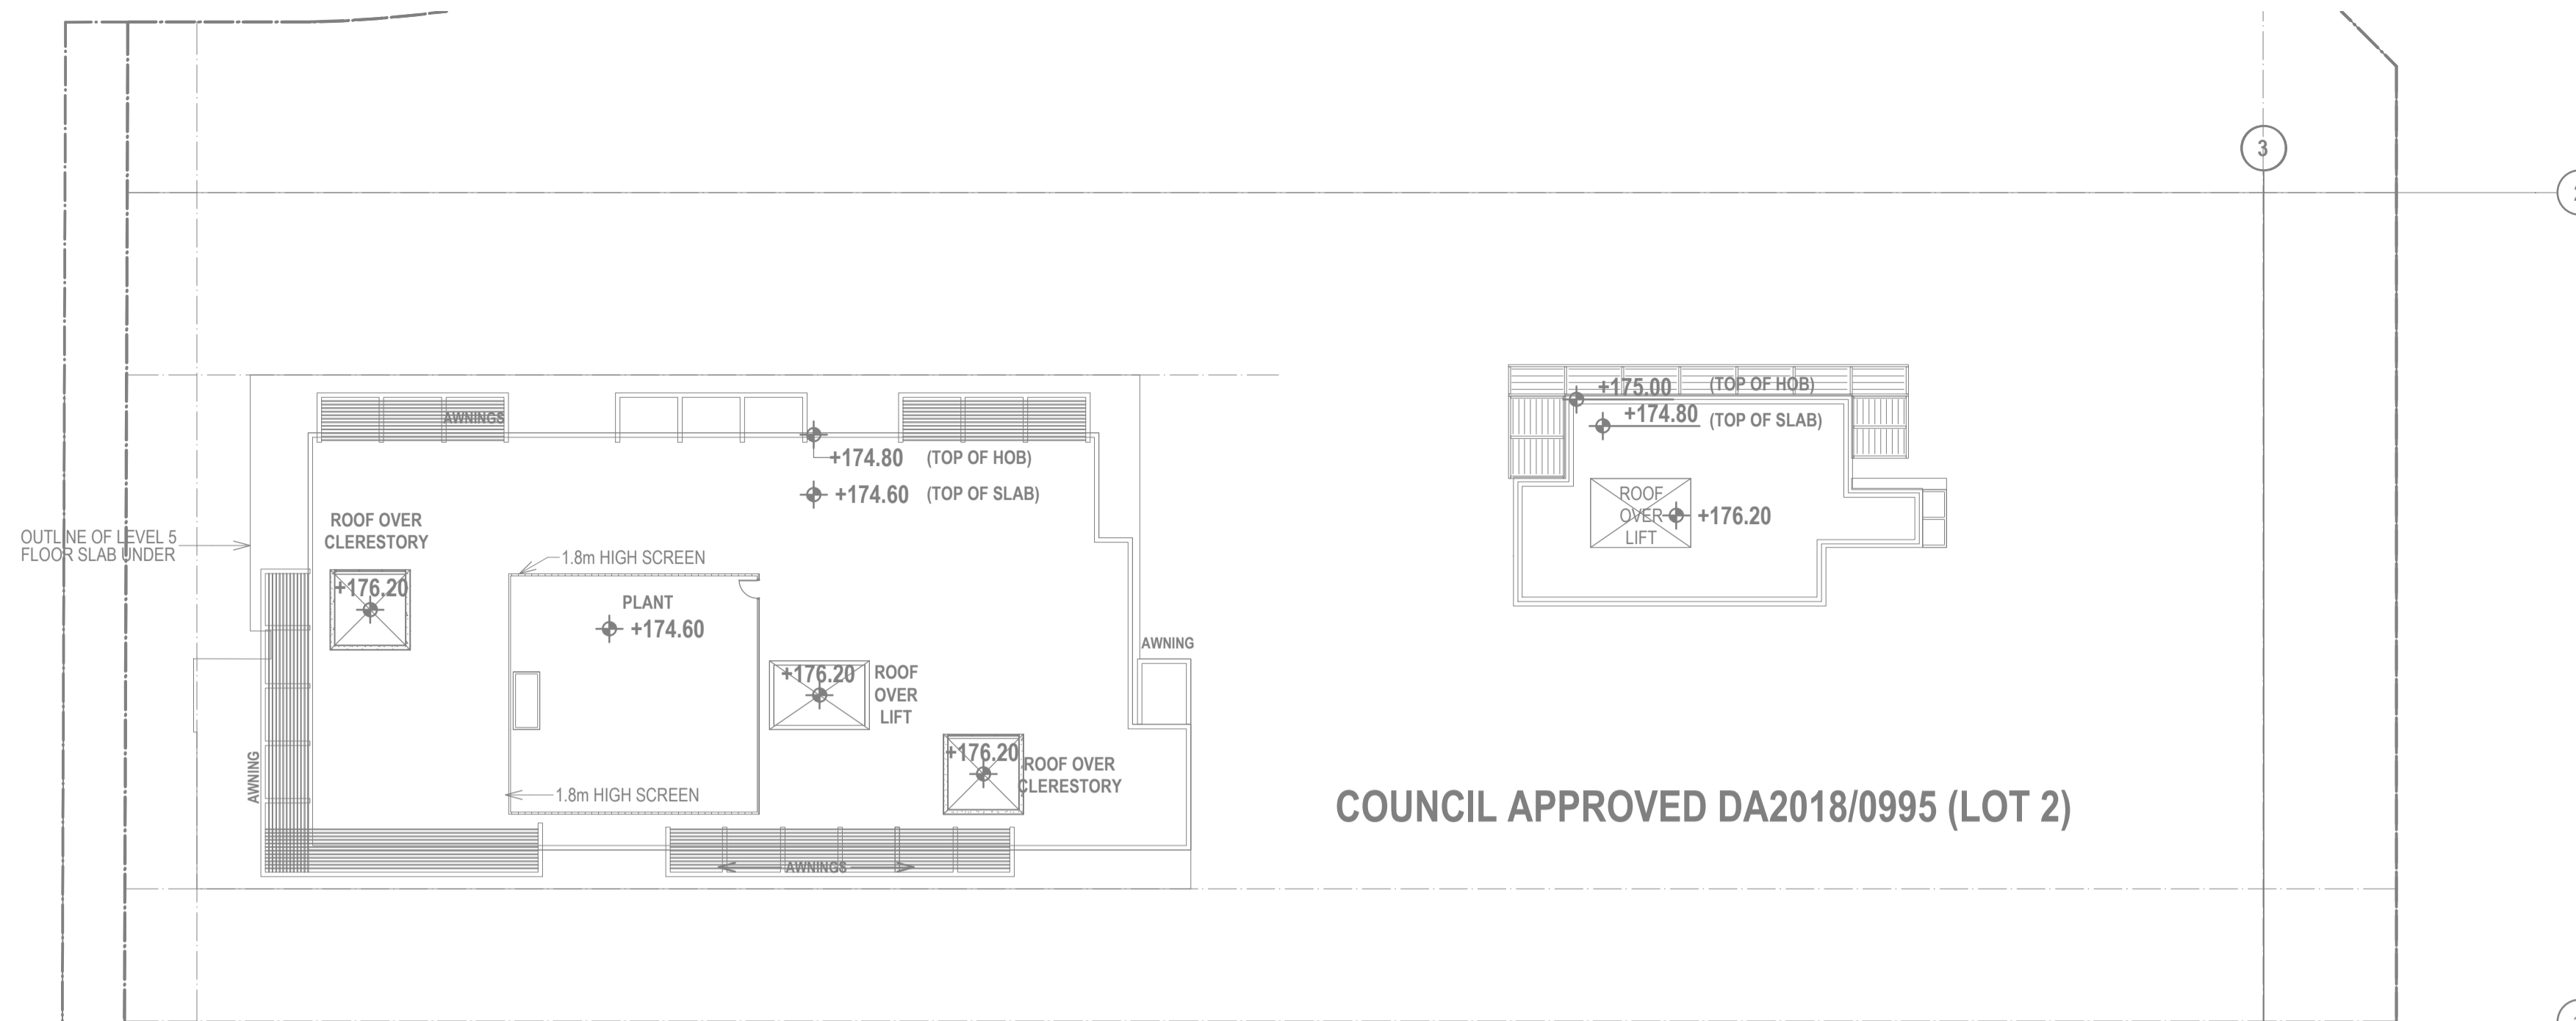


LEVEL 9

NOT FOR CONSTRUCTION

LEGEND

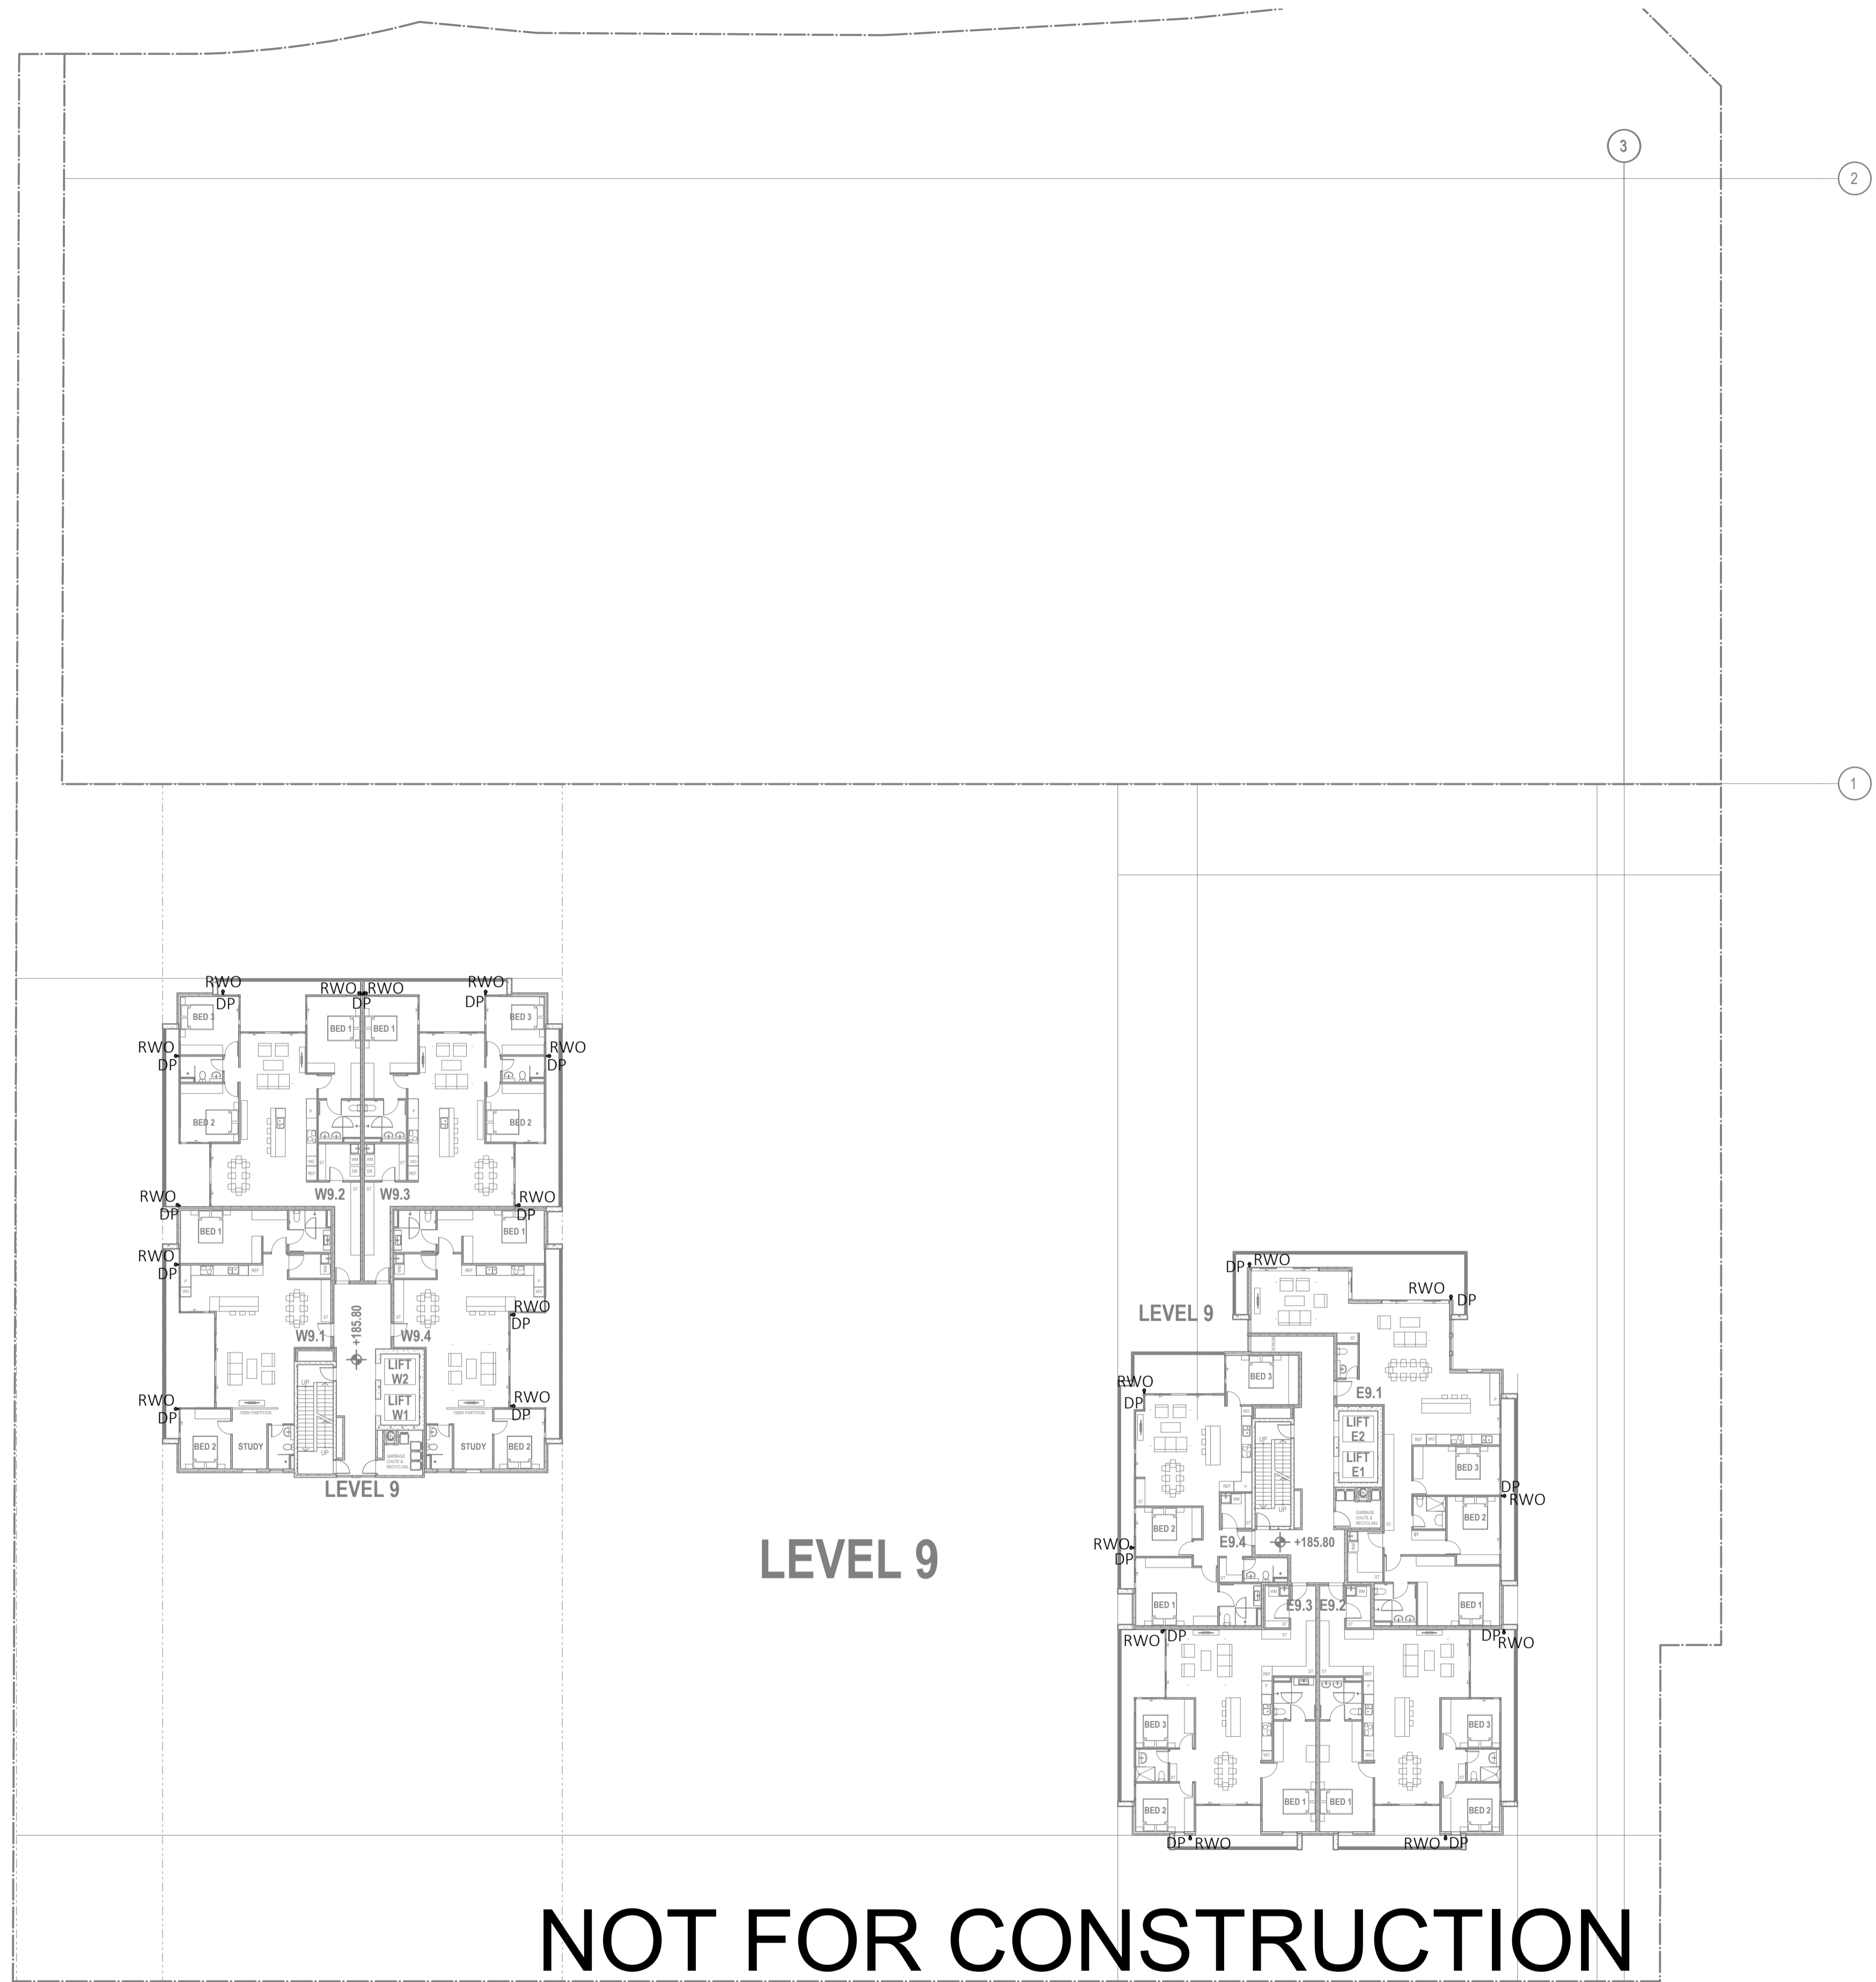- PIPEWORK**
- SW/300
 - SW/150
 - SW/75
 - SW/40
 - SW/20
 - SW/10
 - SW/5
 - SW/2.5
 - SW/1.25
 - SW/0.625
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NOT FOR CONSTRUCTION

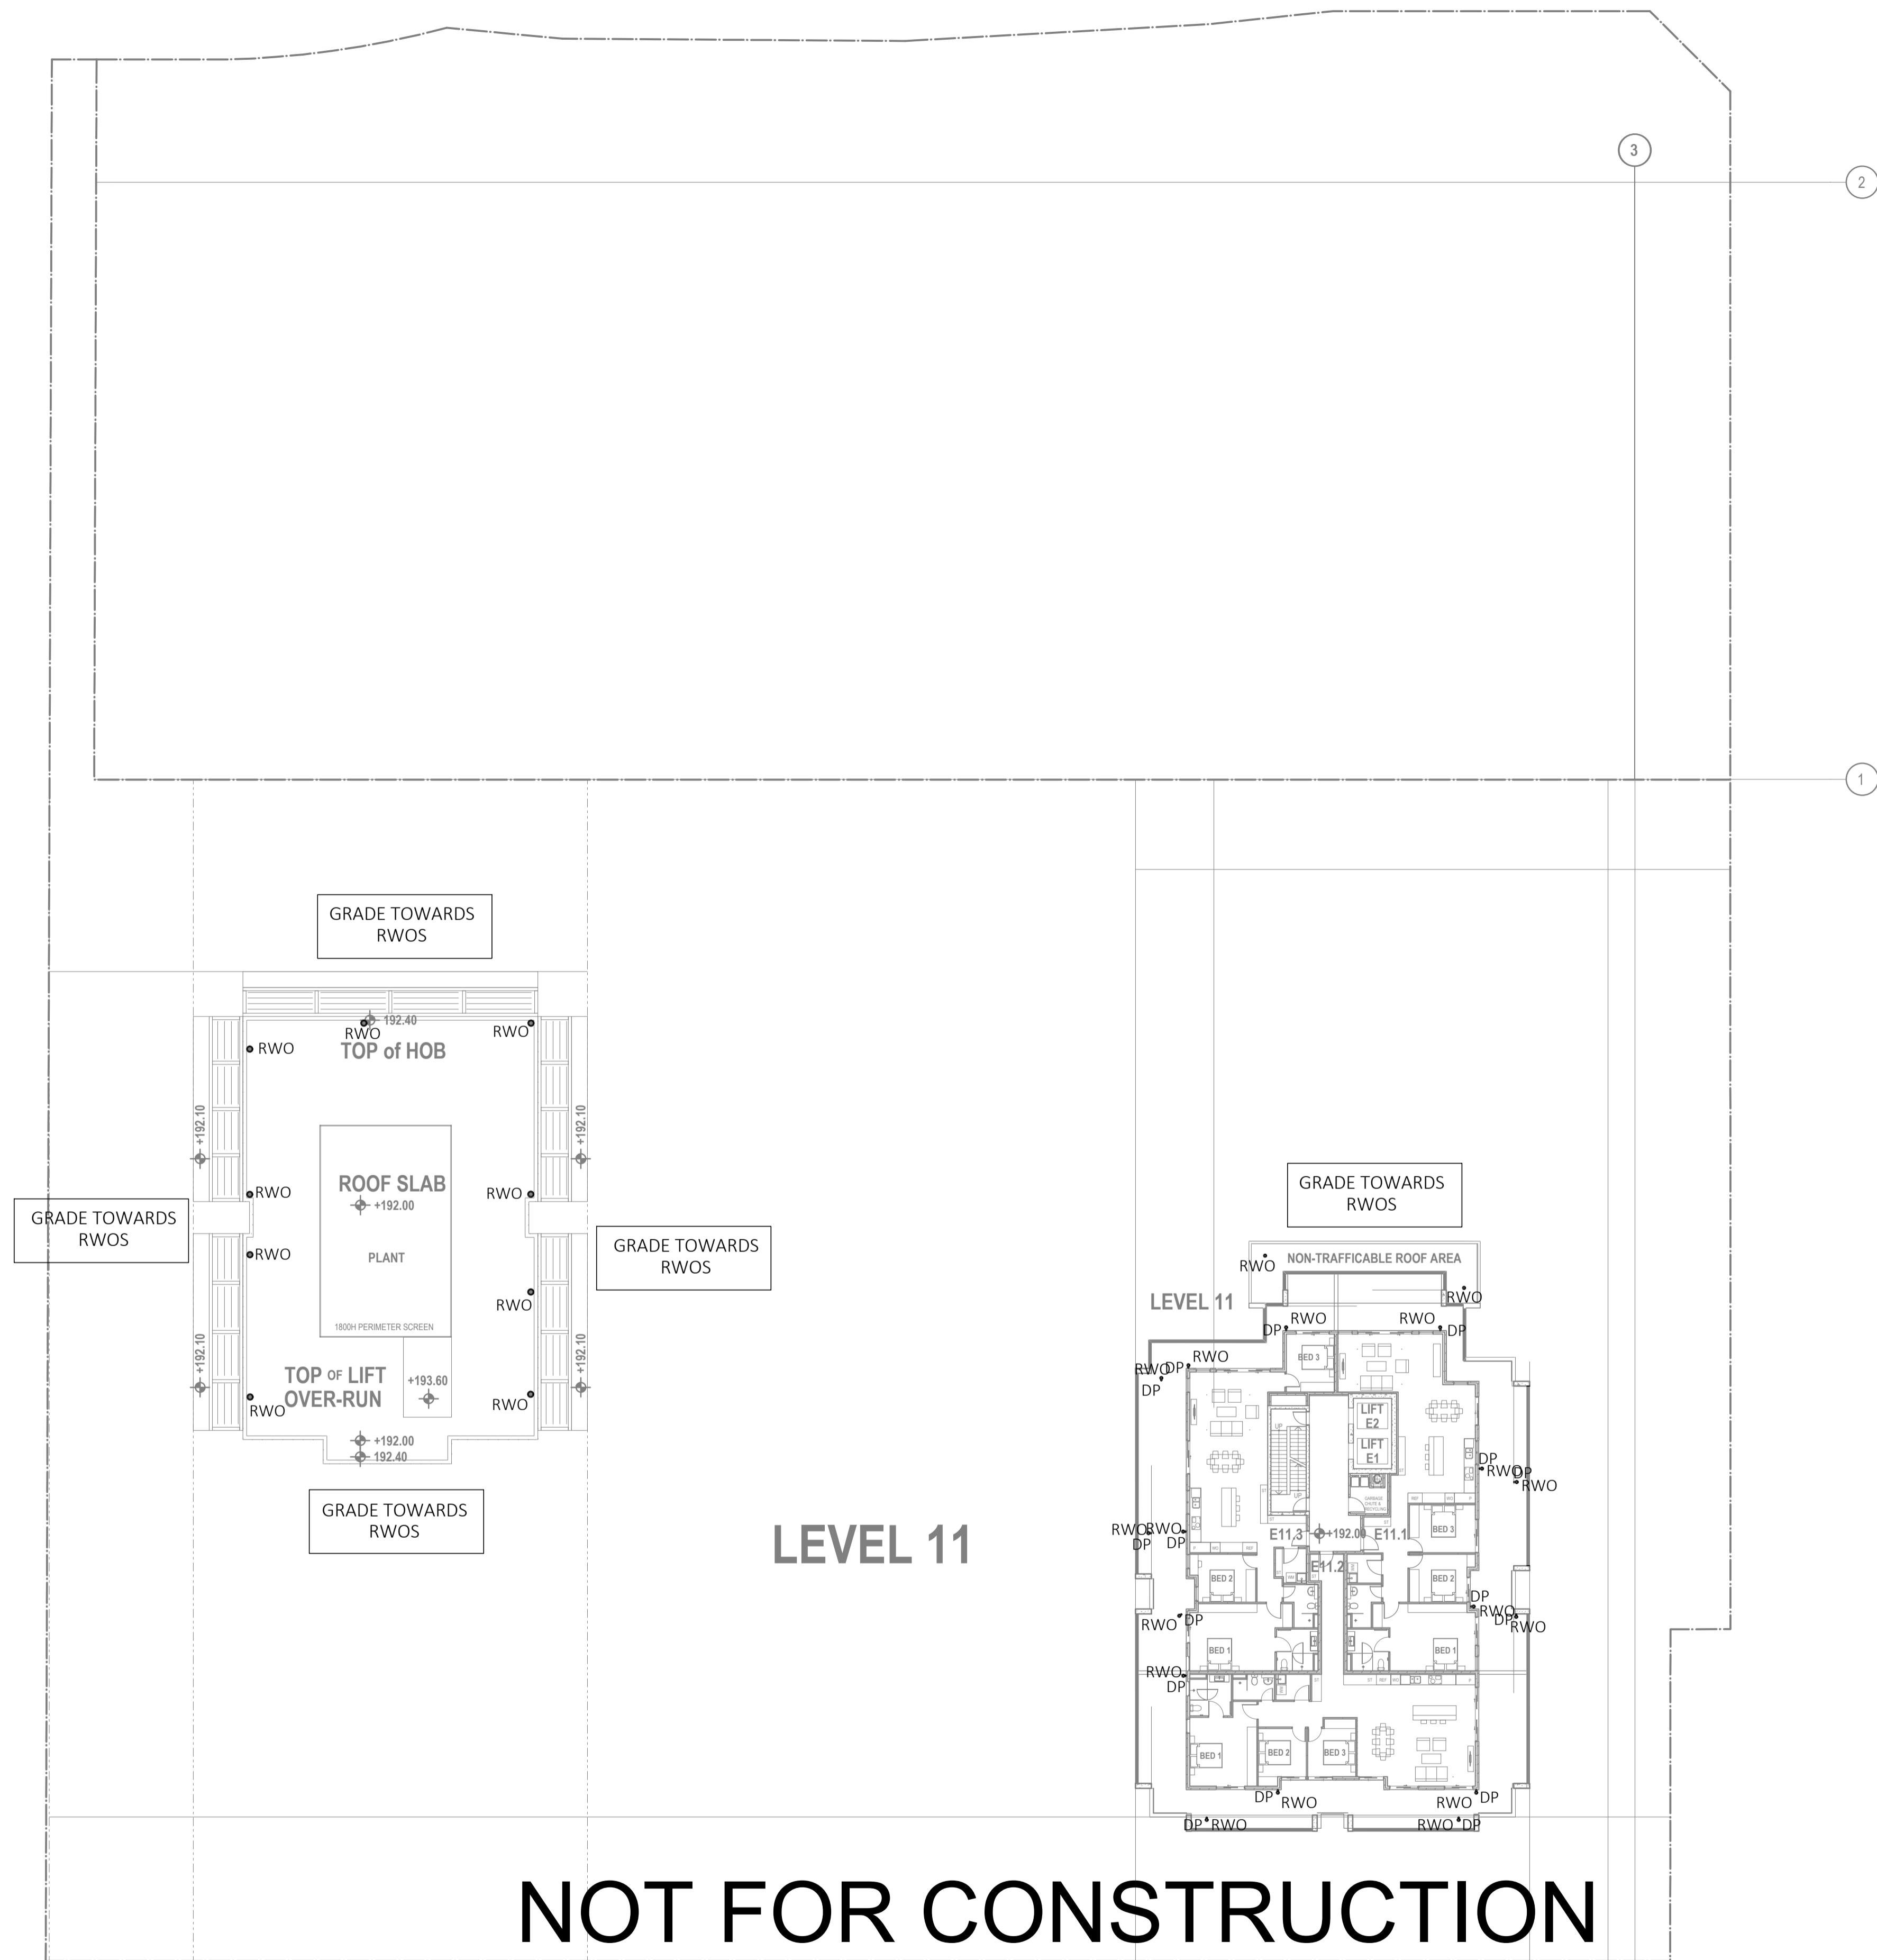LEGEND

- PIPEWORK**
- 100mm PVC UPSTAND/100mm PVC
 - 150mm PVC UPSTAND/150mm PVC
 - 200mm PVC UPSTAND/200mm PVC
 - 250mm PVC UPSTAND/250mm PVC
 - 300mm PVC UPSTAND/300mm PVC
 - 400mm PVC UPSTAND/400mm PVC
 - 500mm PVC UPSTAND/500mm PVC
 - 600mm PVC UPSTAND/600mm PVC
 - 750mm PVC UPSTAND/750mm PVC
 - 1000mm PVC UPSTAND/1000mm PVC
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 - 2000mm PVC UPSTAND/2000mm PVC
 - 3000mm PVC UPSTAND/3000mm PVC
 - 4000mm PVC UPSTAND/4000mm PVC
 - 5000mm PVC UPSTAND/5000mm PVC
 - 6000mm PVC UPSTAND/6000mm PVC
 - 7500mm PVC UPSTAND/7500mm PVC
 - 10000mm PVC UPSTAND/10000mm PVC
- SERVICE ACCESSORIES**
- 100mm PVC UPSTAND/100mm PVC
 - 150mm PVC UPSTAND/150mm PVC
 - 200mm PVC UPSTAND/200mm PVC
 - 250mm PVC UPSTAND/250mm PVC
 - 300mm PVC UPSTAND/300mm PVC
 - 400mm PVC UPSTAND/400mm PVC
 - 500mm PVC UPSTAND/500mm PVC
 - 600mm PVC UPSTAND/600mm PVC
 - 750mm PVC UPSTAND/750mm PVC
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 - 2000mm PVC UPSTAND/2000mm PVC
 - 3000mm PVC UPSTAND/3000mm PVC
 - 4000mm PVC UPSTAND/4000mm PVC
 - 5000mm PVC UPSTAND/5000mm PVC
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 - 7500mm PVC UPSTAND/7500mm PVC
 - 10000mm PVC UPSTAND/10000mm PVC

ABBREVIATIONS:


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- 10000mm PVC UPSTAND/10000mm PVC

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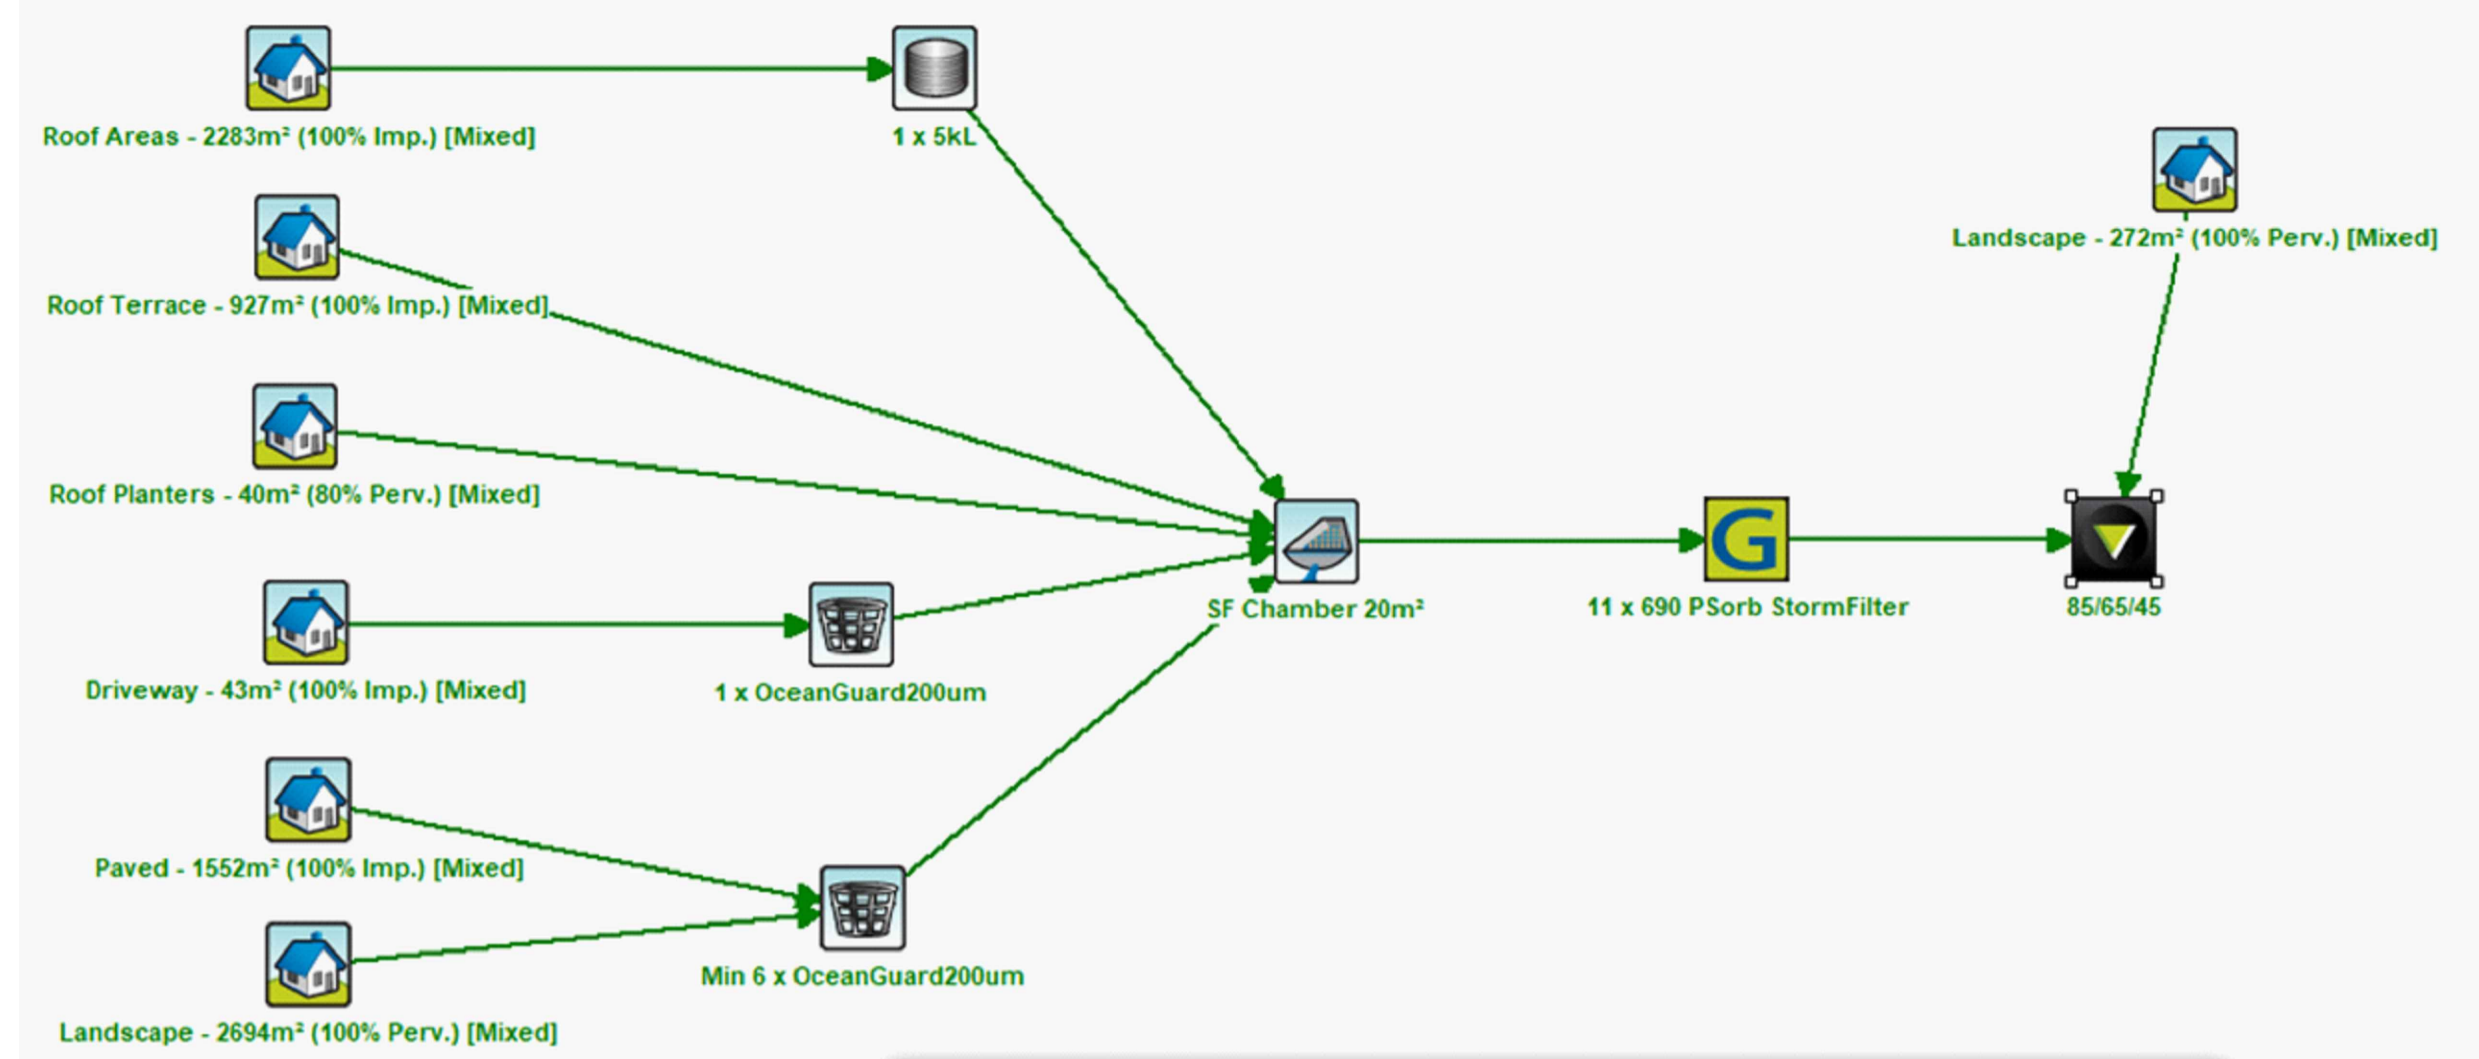
		Drawn & Designed By : R. Koh		Designed By ING CONSULTING ENGINEERS PTY LTD P. O BOX 1543 BAULKHAM HILLS NSW 1755 F : (02) 8807 5656 M: 0433 778 109 E : ken@ingengineers.com.au	Project Proposed Seniors Living (Stage 2)	Drawing Title Level 11 Floor Plan	
		Checked By : N. Evans		At 5 Skyline Place Frenchs Forest NSW 2086	Date January 2021	Scale 1 : 250 @ A1	
		Approved By : Kenneth T. NG MIE(Aust CP Eng NER APEC Engineer IntPE(Aus) (Reg. No. 2206352) RPEQ Registered Certifier (Hydraulic (stormwater), Road & Drainage and Stormwater) NSW Fair Trading (Reg. No. BDC0827)		Client	Project No. 284012021DA	Drawing & Sheet No./Issue 28401-16/20 / A	
A	Development Application	28 Jan. 2021					
Issue	Description	Date of Drawing					




	Roof : 2283m ²		Landscape: 2694m ²	Landscape Bypass
	Roof Planter: 40m ²		Driveway: 43m ²	Landscape: 272m ²
	Roof Impervious: 927m ²		Paved: 1552m ²	Total area: 7811m ²

15789 - 5 Skyline Place, Frenchs Forest (Rev1 - Site Area Breakup)

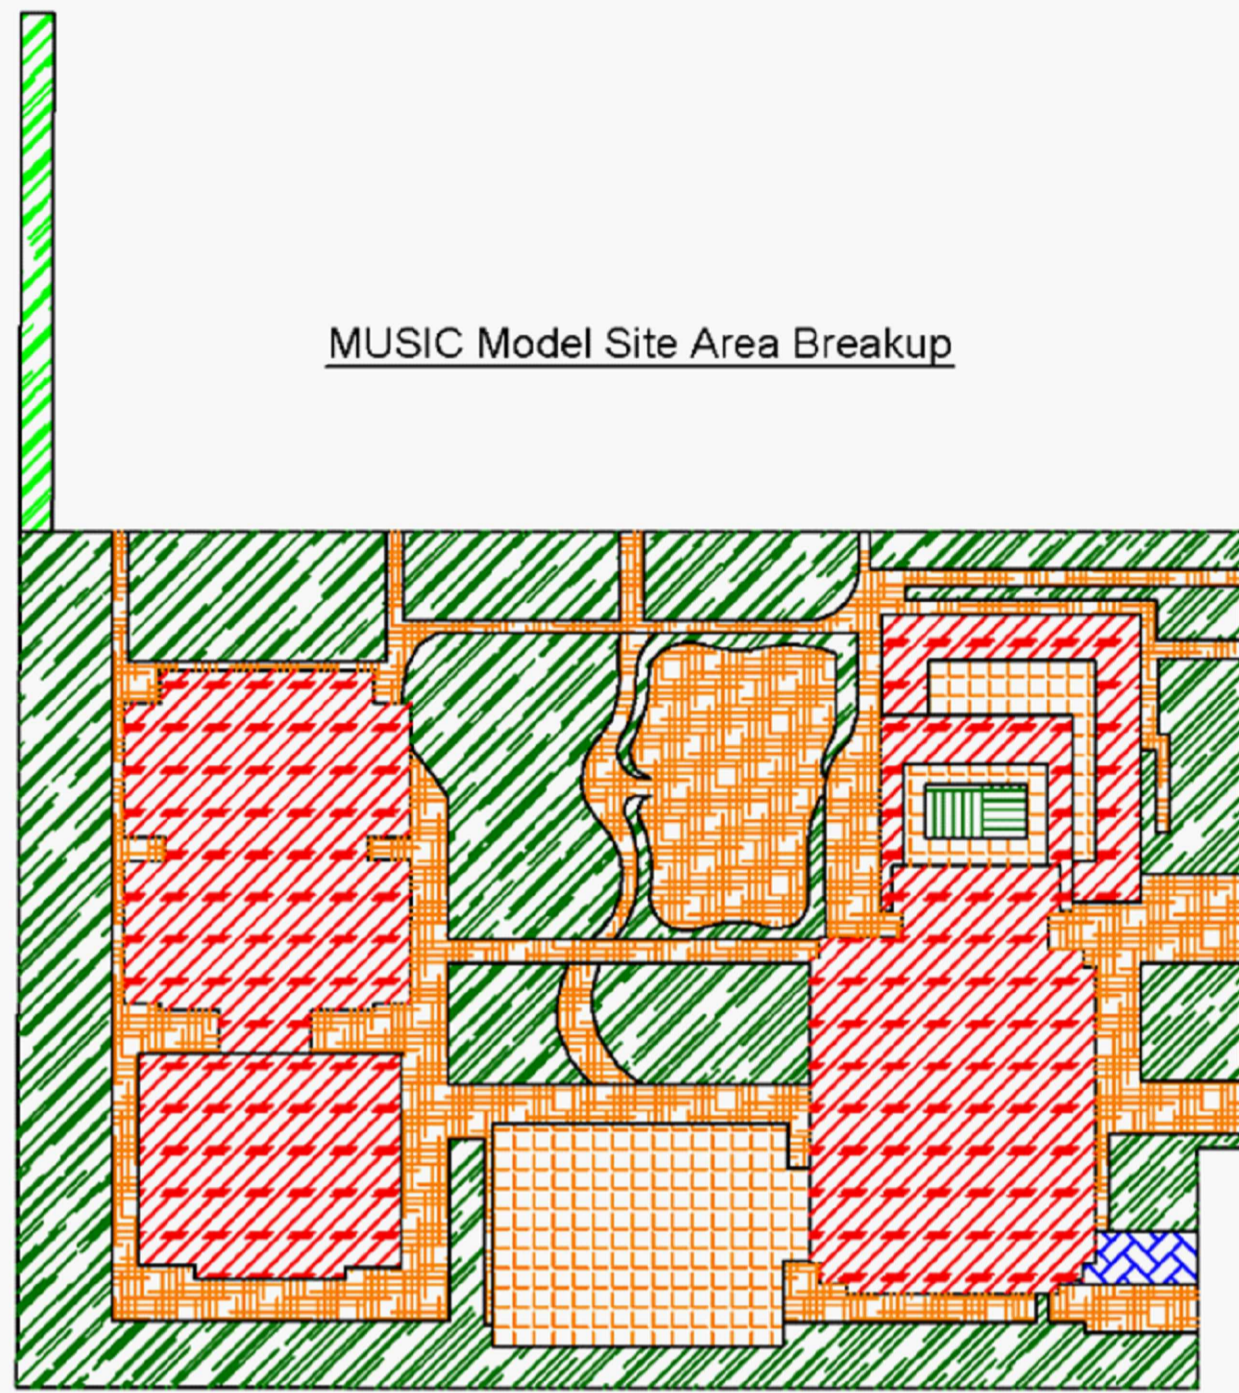NOT FOR CONSTRUCTION



	Sources	Residual Load	% Reduction
Flow (ML/yr)	6.71	6.46	3.8
Total Suspended Solids (kg/yr)	681	102	85.1
Total Phosphorus (kg/yr)	1.48	0.404	72.7
Total Nitrogen (kg/yr)	14	6.8	51.3
Gross Pollutants (kg/yr)	139	0	100

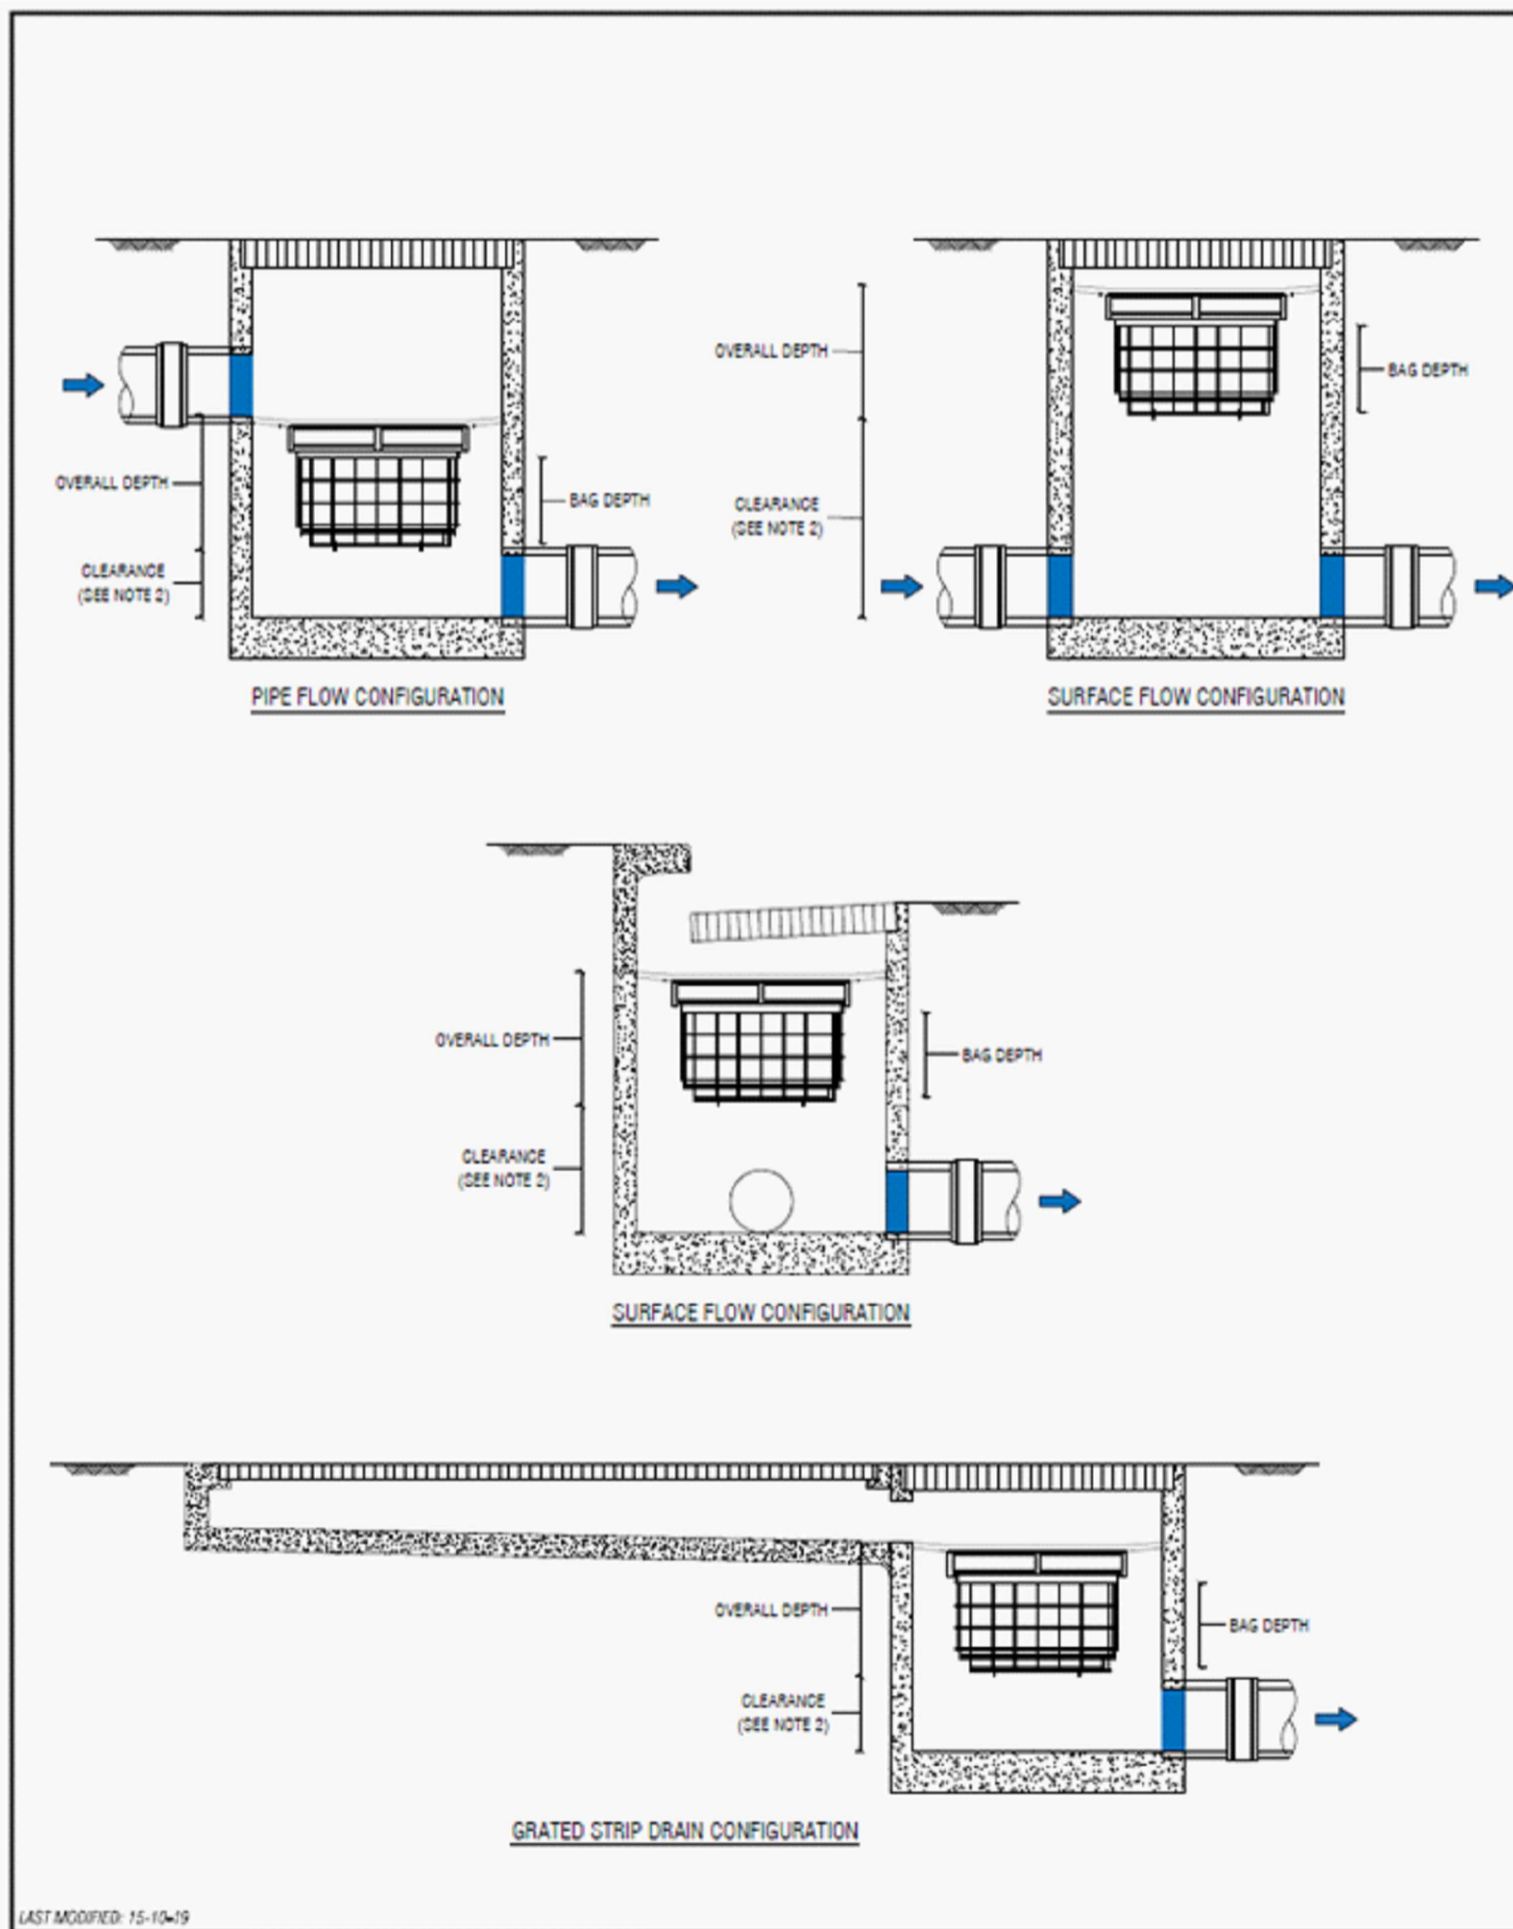

PLAN ID	MAXIMUM PIT PLAN DIMENSIONS
S	450mm x 450mm
M	600mm x 600mm
L	900mm x 900mm
XL	1200mm x 1200mm


DEPTH ID	BAG DEPTH	OVERALL DEPTH
1	170	270
2	300	450
3	600	700

PLAN ID	DEPTH ID		
	1	2	3
S	•	•	•
M	•	•	•
L	•	•	•
XL	•	•	•

GENERAL NOTES

- THE MINIMUM CLEARANCE DEPENDS ON THE CONFIGURATION (SEE NOTE 2) AND THE LOCAL COUNCIL REQUIREMENTS.
- CLEARANCE FOR ANY PIT WITHOUT AN INLET PIPE (ONLY USED FOR SURFACE FLOW) CAN BE AS LOW AS 50mm. FOR OTHER PITS, THE RECOMMENDED CLEARANCE SHOULD BE GREATER OR EQUAL TO THE PIPE OBVERT SO AS NOT TO INHIBIT HYDRAULIC CAPACITY.
- OCEAN PROTECT PROVIDES TWO FILTRATION BAG TYPES - 200 MICRON BAGS FOR HIGHER WATER QUALITY FILTERING AND A COARSE BAG FOR TARGETING GROSS POLLUTANTS.
- DRAWINGS NOT TO SCALE.

OCEAN PROTECT
OCEANGUARD
TYPICAL ARRANGEMENTS
SPECIFICATION DRAWING

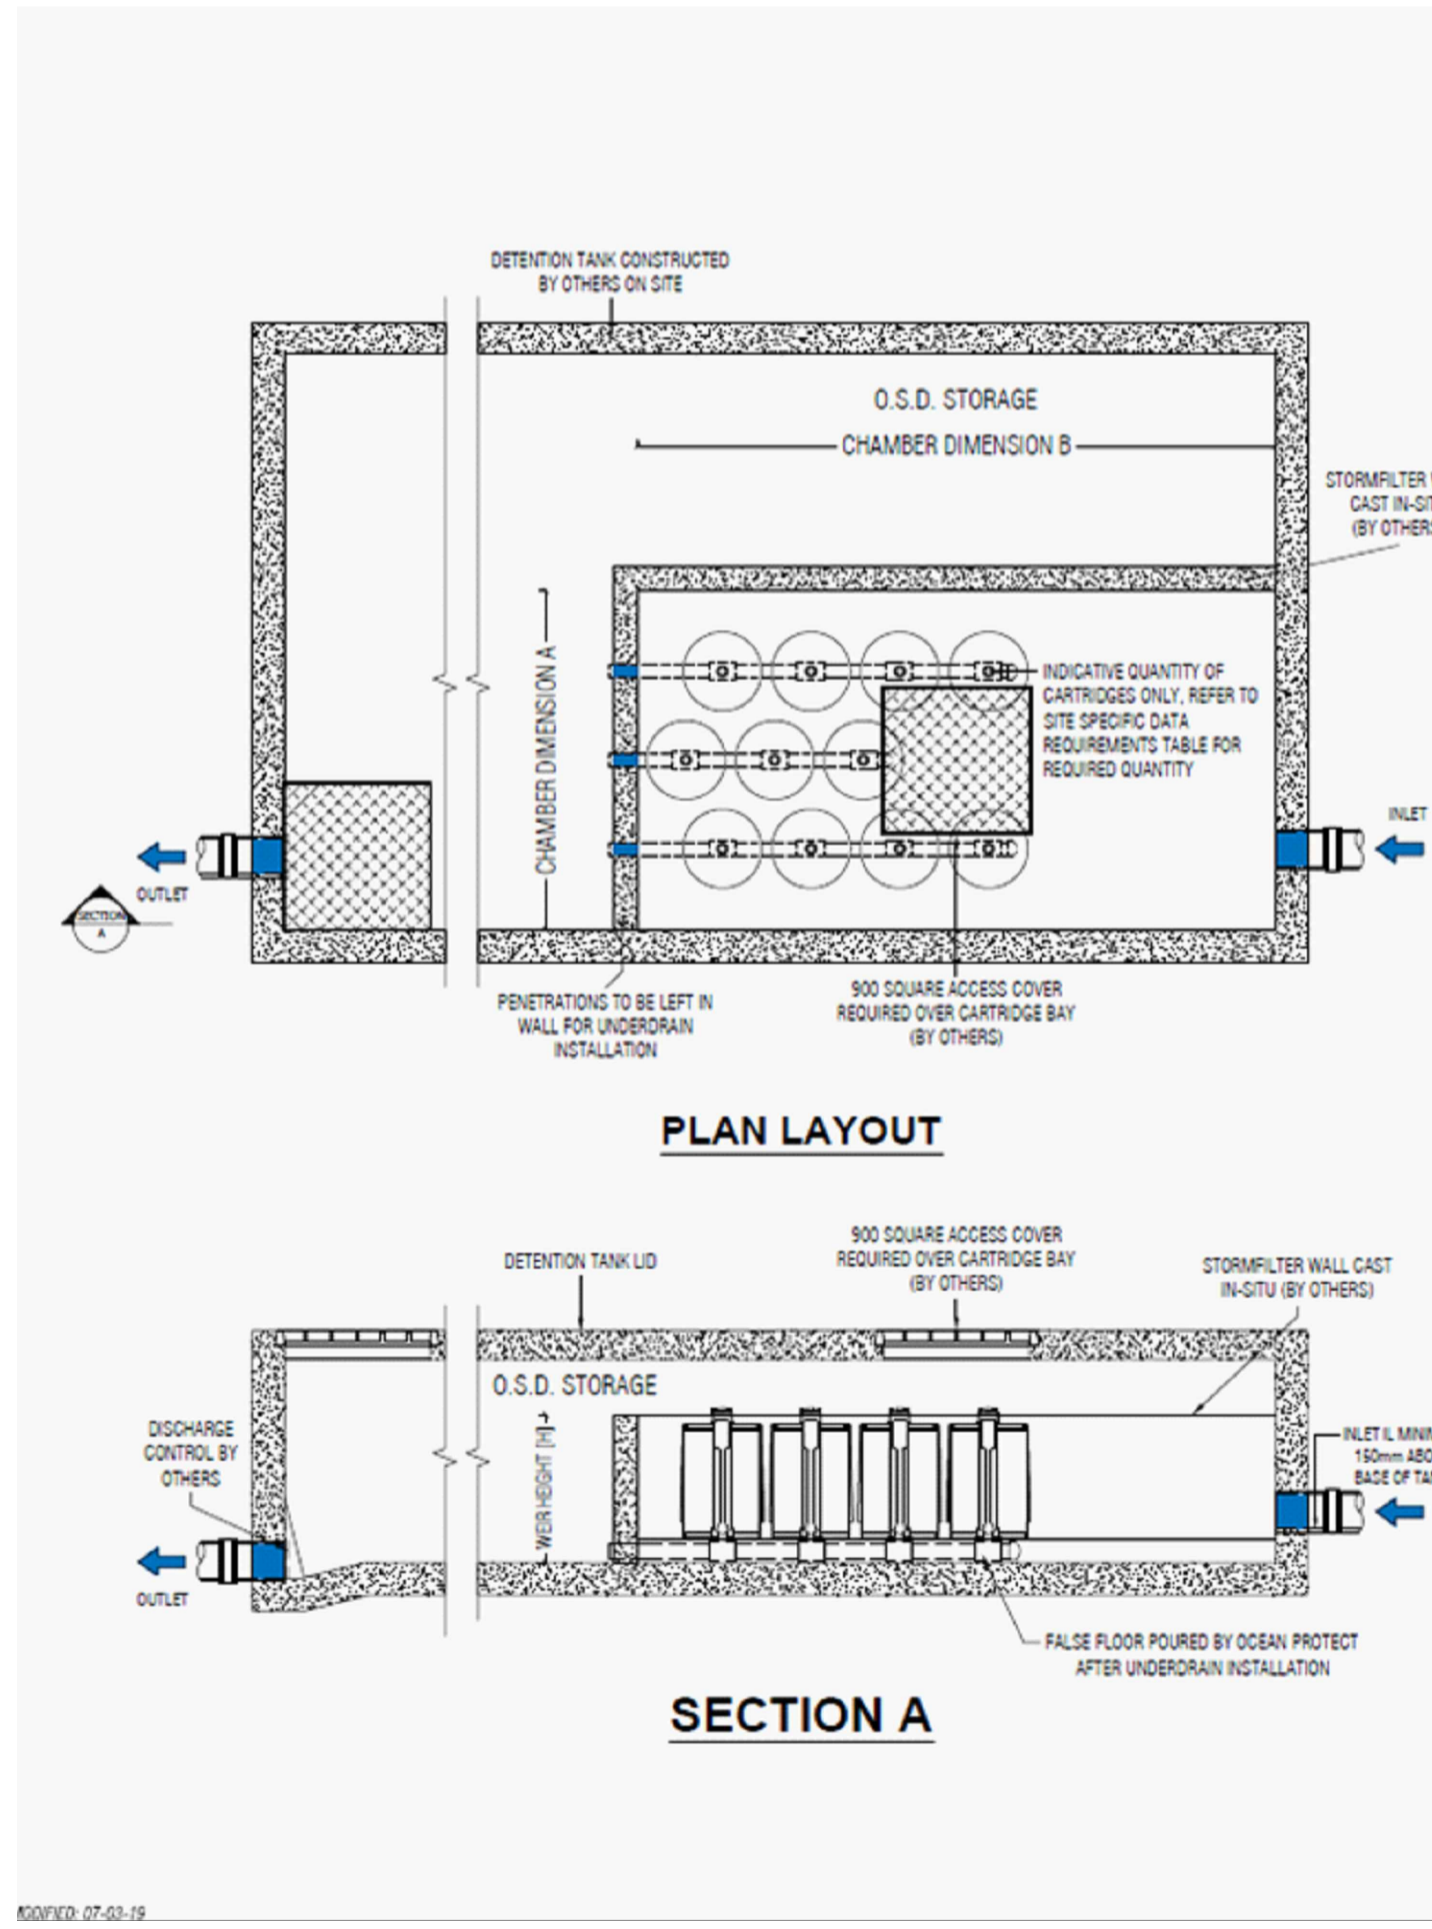

CARTRIDGE NAME / SIPHON HEIGHT (mm)	690	460	310
CARTRIDGE PHYSICAL HEIGHT (mm)	840	600	600
TYPICAL WEIR HEIGHT [H] (mm)	920	690	540
CARTRIDGE FLOW RATE FOR ZPG MEDIA (L/s)	1.6	1.1	0.7
CARTRIDGE FLOW RATE FOR PSORB MEDIA (L/s)	0.9	0.46	0.39

STRUCTURE ID	
NUMBER OF CARTRIDGES REQ'D	
SIPHON HEIGHT (310 / 460 / 690)	
MEDIA TYPE (ZPG / PSORB)	
WATER QUALITY FLOW RATE (L/S)	
DIMENSION A	
DIMENSION B	

GENERAL NOTES

- INLET AND OUTLET PIPES TO BE IN ACCORDANCE WITH APPROVED PLANS.
- A HIGH FLOW BYPASS ARRANGEMENT OR DISSIPATION STRUCTURE MAY BE REQUIRED TO MINIMISE RE-SUSPENSION OF SOLIDS OR ANY SIGNIFICANT INERTIAL FORCES ON THE CARTRIDGES.
- ALL WATER QUALITY TREATMENT DEVICES REQUIRE PERIODIC MAINTENANCE. REFER TO OPERATION AND MAINTENANCE MANUAL FOR GUIDELINES AND ACCESS REQUIREMENTS.
- SITE SPECIFIC PRODUCTION DRAWING WILL BE PROVIDED ON PLACEMENT OF ORDER.
- THE INVERT LEVEL OF THE INLET PIPE MUST BE GREATER THAN THE RL OF THE FALSE FLOOR WITHIN THE CARTRIDGE CHAMBER.
- CONCRETE STRUCTURE AND ACCESS COVERS DESIGNED AND PROVIDED BY OTHERS. ACCESS COVERS TO BE A MINIMUM 900 X 900 ABOVE CARTRIDGES. OHS REGARDING ACCESS COVERS AND TANK ACCESS TO BE ASSESSED BY OTHERS ON SITE.
- THE STRUCTURE THICKNESSES SHOWN ARE FOR REPRESENTATIONAL PURPOSES.
- DRAWINGS NOT TO SCALE.


INSTALLATION NOTES

- UNDERDRAIN AND FALSE FLOOR INSTALLED BY OCEAN PROTECT.

OCEAN PROTECT
OCEANGUARD
STORMFILTER SYSTEM
DETENTION TANK ARRANGEMENT
SPECIFICATION DRAWING

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A	Development Application	28 Jan. 2021
Issue	Description	Date of Drawing

Drawn & Designed By : R. Koh
Checked By : N. Evans
Approved By : Kenneth T. NG
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Registered Certifier
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Project
Proposed Seniors Living (Stage 2)
At
5 Skyline Place
Frenchs Forest NSW 2086
Client

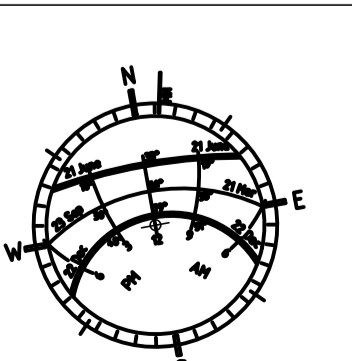Drawing Title
Water Sensitive Urban Design
Date
January 2021
Scale
As Shown @ A1
Project No.
284012021DA
Drawing & Sheet No./Issue
28401-18/21 / A


VERIFY ALL DISCREPANCIES WITH PROJECT ARCHITECT/ MANAGER PRIOR TO PROCEEDING WITH ANY WORKS. **Do not scale off drawings.**

- GENERAL NOTES**
1. THE CONTRACTOR MUST VERIFY ALL DIMENSIONS AND EXISTING LEVELS ON SITE PRIOR TO COMMENCEMENT OF WORKS.
 2. ALL WORKS ARE TO BE CARRIED OUT TO THE DETAILS SHOWN ON THE DRAWINGS.
 3. THESE PLANS ARE READ IN CONJUNCTION WITH APPROVED ARCHITECTURAL, STRUCTURAL, HYDRAULIC AND MECHANICAL DRAWINGS AND SPECIFICATIONS.
 4. CARE IS TO BE TAKEN WHEN EXCAVATING NEAR SERVICES. NO MECHANICAL EXCAVATION ARE TO BE UNDERTAKEN OVER TELECOMMUNICATION OR ELECTRICAL SERVICES. HAND EXCAVATE IN THESE AREAS ONLY.
 5. DIAL 1100 BEFORE YOU DIG FOR LOCATION OF UNDERGROUND SERVICES PRIOR TO ANY CONSTRUCTION WORKS.
 6. SERVICES HAVE NOT BEEN SHOWN ON THIS PLAN. FIELD INVESTIGATIONS ARE TO BE CARRIED OUT SEPARATELY TO DETERMINE EXACT POSITIONS OF SERVICES OR INFORMATION IS TO BE PROVIDED BY THE PROPERTY PROPRIETOR. NOT WITHSTANDING THIS, ALL INFORMATION PROVIDED SHALL BE VERIFIED BY THE CONTRACTOR PRIOR TO COMMENCEMENT OF CONSTRUCTION WORKS.
 7. THESE DRAWINGS ARE ONLY APPROVED WHEN THEY ARE SIGNED WITH AN ORIGINAL SIGNATURE BY THE ENGINEER.


- STORMWATER DRAINAGE**
8. ALL WORKS TO BE CARRIED OUT IN ACCORDANCE WITH AS 3500 AND THE REQUIREMENTS OF THE LOCAL COUNCIL'S POLICIES AND CODES.
 9. ALL GUTTERS TO BE 100 x 75 MIN. AND DOWNPIPES TO BE 100 x 75 (76 DIA.) UNLESS OTHERWISE NOTED.
 10. ALL PIPES TO BE 100mm uPVC SEWER GRADE UNLESS NOTED OTHERWISE.
 11. ALL GRADIENTS FOR STORMWATER PIPES TO BE NOT LESS THAN 1.0% UNLESS NOTED OTHERWISE.
 12. THE INVERTS OF ALL OUTLET PIPES ARE TO BE INSTALLED FLUSH WITH THE BASE OF ALL STORMWATER/RAINWATER PIT.
 13. ALL FENCES SHALL BE KEPT AT LEAST 100mm ABOVE THE GROUND LEVEL TO FACILITATE THE FREE PASSAGE FOR STORMWATER OVERLAND FLOW.
 14. MANUFACTURER'S CERTIFICATE SHALL BE OBTAINED BY THE BUILDER FOR PIPES, PRE-CAST PITS AND GRATES FOR THE STRUCTURAL ADEQUACY RELATING TO ITS LOCATION.
 15. AREAS SPREAD WITH BARK SHALL BE BARRICADED TO PREVENT BARK GETTING INTO THE PITS AND STORMWATER SYSTEMS.
 16. MINIMUM SLOPE FOR PAVED AREAS SHALL BE 0.5%, FOR LANDSCAPED AREAS MINIMUM SLOPE SHALL BE 1% AND GRADED TOWARDS THE GRATED PITS.
 17. ALL EXCAVATIONS WITHIN THE INFLUENCE OF BUILDINGS AND SERVICES SHALL BE UNDERTAKEN WITH THE KNOWLEDGE OF THE HYDRAULIC AND STRUCTURAL ENGINEER.
 18. THE DETENTION AND DRAINAGE SYSTEM SHALL BE MAINTAINED AT REGULAR INTERVALS AND THE CONTRACTOR SHALL MAKE NECESSARY ARRANGEMENTS.
 19. CONNECTION OF DISCHARGE PIPE TO EXISTING COUNCIL KERB AND GUTTER, PIPE OR KERB INLET PIT SHALL BE CARRIED OUT IN ACCORDANCE WITH COUNCIL'S REQUIREMENTS.
 20. PROVIDE STEP-IRONS 'MASCOT S1.104' OR SIMILAR STAGGERED TO GIVE SPACING 300 VERTICAL AND 220 HORIZONTAL TO ALL PIT DEEPER THAN 1m .
 21. SUITABLE AG-LINES SHALL BE PROVIDED AND CONNECTED TO STORMWATER SYSTEM OR AS INSTRUCTED BY THE ENGINEER ON SITE PRIOR TO BACKFILLING.

- RAINWATER TANK**
22. DRAWING IS TO BE READ IN CONJUNCTION WITH SYDNEY WATER'S "PLUMBING REQUIREMENTS - GUIDELINES FOR RAINWATER TANKS ON RESIDENTIAL PROPERTIES".
 23. ALL PLUMBING WORK UNDERTAKEN ON OR FOR THE TANK THAT AFFECTS THE WATER SERVICE PIPE OR WATER MAIN MUST BE UNDERTAKEN WITH THE CONSENT OF SYDNEY WATER IN ACCORDANCE WITH THE REQUIREMENTS OF SYDNEY WATER, AND THE MANUFACTURER'S SPECIFICATIONS.
 24. ALL PLUMBING WORKS UNDERTAKEN SHALL BE UNDERTAKEN BY A LICENSED PLUMBER IN ACCORDANCE WITH THE NEW SOUTH WALES CODE OF PRACTICE - PLUMBING AND DRAINAGE PRODUCED BY THE COMMITTEE ON UNIFORMITY OF PLUMBING AND DRAINAGE REGULATIONS IN NEW SOUTH WALES.
 25. ALL PLUMBING MUST BE COMPLETED BY A LICENSED PLUMBER IN COMPLIANCE WITH AS/NZS3500.5, AND ANY OTHER RELEVANT NATIONAL STANDARDS.
 26. INLET TO THE RAINWATER TANKS MUST BE SCREENED OR FILTERED TO PREVENT ENTRY OF FOREIGN MATTER AND CREATURES.
 27. THE RAINWATER TANKS MUST BE MAINTAINED AT ALL TIMES SO AS NOT TO CAUSE A NUISANCE WITH RESPECT TO MOSQUITO BREEDING OR OVERLAND FLOW OF WATER.
 28. A SIGN MUST BE AFFIXED TO THE RAINWATER TANKS CLEARLY STATING THAT THE WATER IN THE TANKS IS RAINWATER.
 29. BOTH THE RE-USE AND ANY FITTINGS CONNECTED TO THE RAINWATER TANKS MUST BE LABELED "RAINWATER , NOT SUITABLE FOR DRINKING".
 30. ALL ROOF GUTTERS ARE TO BE FITTED WITH LEAF GUARDS AND INSPECTED REGULARLY AND CLEANED TO ENSURE LEAF LITTER CANNOT ENTER THE DOWNPIPES.
 31. PRESSURE PUMP ELECTRICAL CONNECTION TO BE CARRIED OUT BY A LICENSED ELECTRICIAN.

Specification code:
 R100B/C90 (brass grate, ABS lower body)
 R100N/C90 (nickel bronze grate, ABS lower body)
 R100S4/C90 (polished 304 stainless steel, ABS lower body)
 R100S/C90 (satin 316 stainless steel grate, ABS lower body)

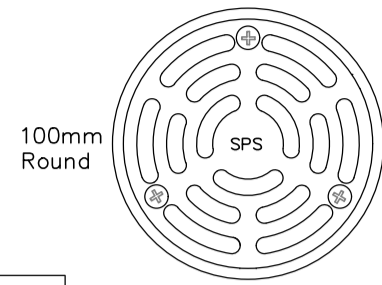


- Round grate available in nickel bronze, 304 & 316 stainless Steel. Bronze non-stock option.
- ABS 90° Body and Reversible Membrane Clamp Collar with female 65mm BSP thread.

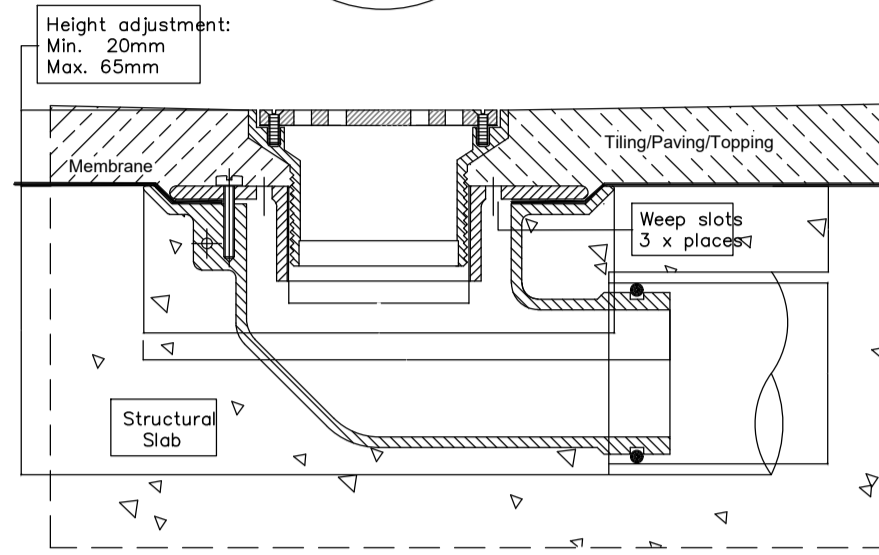

N.B.	A	B	C	D
50	100	40	180	200
65	105	37	180	200

RAINWATER OUTLET (RWO) (TERRACE AND COURTYARDS)
 NOT TO SCALE

SPS TRUFLO & SUPERFLO DOME GRATE RWO (2-PIECE DOME GRATE, MEMBRANE CLAMP)

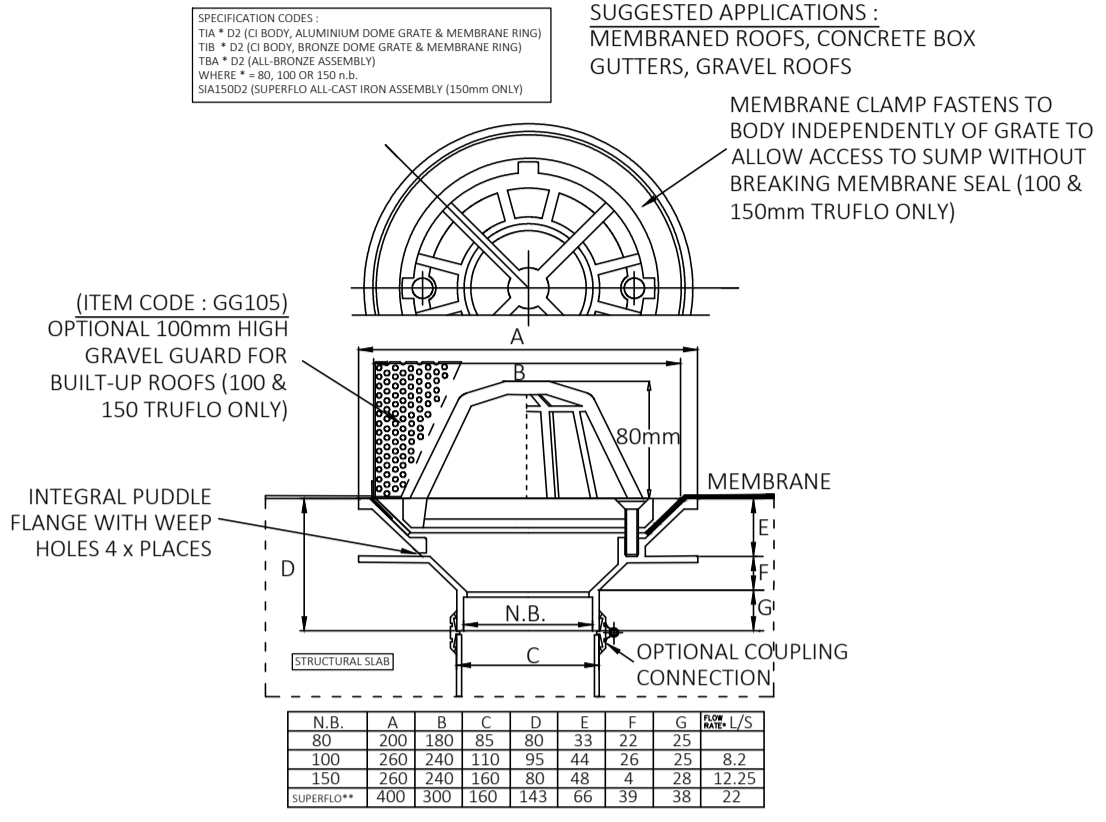


N.B.	A	B	C	D	E	F	G	H	I	J
50	100	150	25	80	33	72	25	25	25	25
100	200	240	110	95	44	76	25	25	25	25
150	300	260	100	80	48	4	28	12	25	25
200	300	100	143	66	49	38	22			

SPECIALITY PLUMBING SUPPLIES PTY LTD
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ROOF RAINWATER WATER OUTLET (RWO) 100 TRUFLOW
 NOT TO SCALE


SPS TRUFLO & SUPERFLO FLAT GRATE RWO (1-PIECE GRATE, NO MEMBRANE CLAMP)

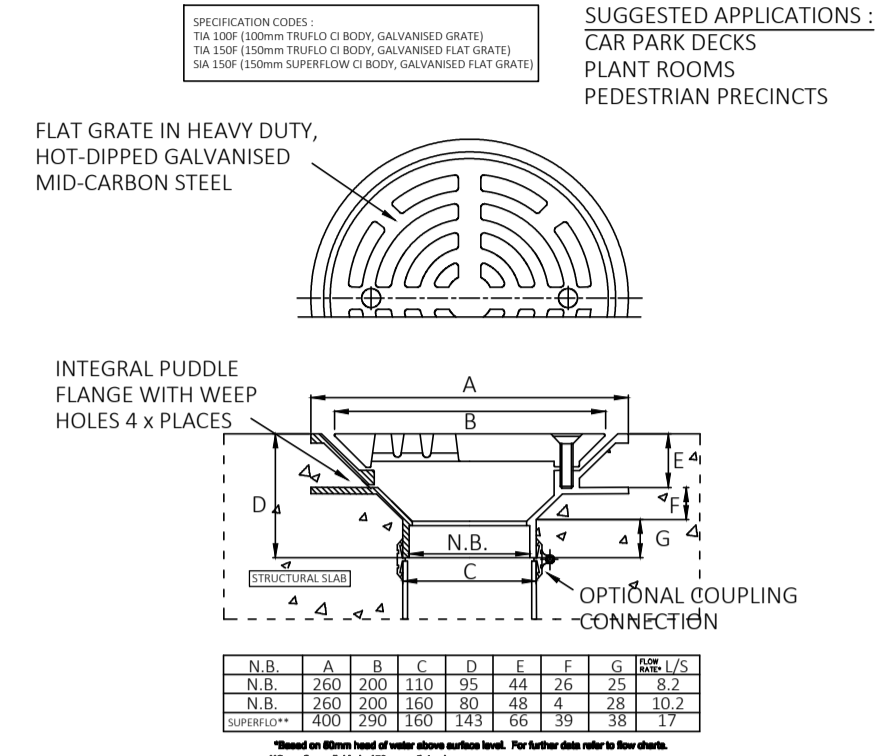


N.B.	A	B	C	D	E	F	G	H	I	J
50	100	100	95	44	26	25	25	25	25	25
100	200	100	80	48	4	28	12	25	25	25
150	200	250	100	243	66	49	38	22		

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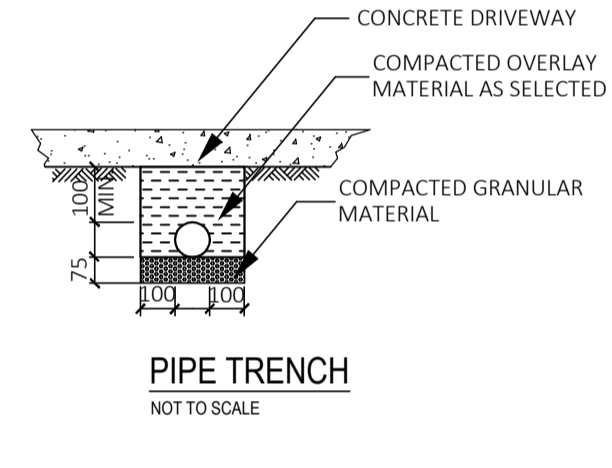
CARPARK TRUFLOW (RWO)
 NOT TO SCALE

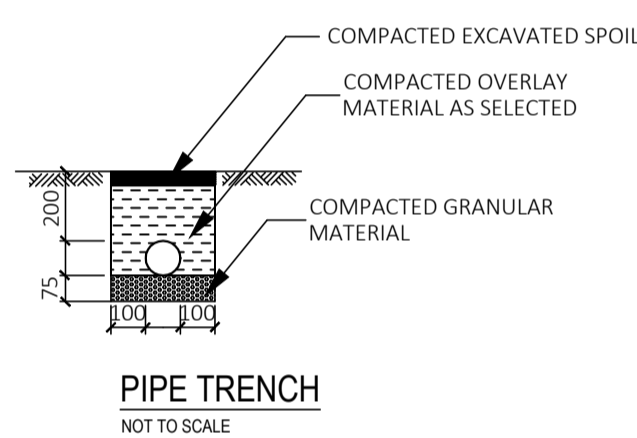


PIPE TRENCH
 NOT TO SCALE

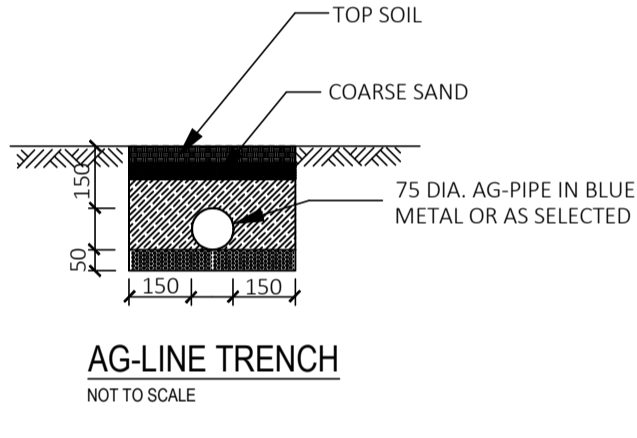

AG-LINE TRENCH
 NOT TO SCALE



PIPE TRENCH
 NOT TO SCALE

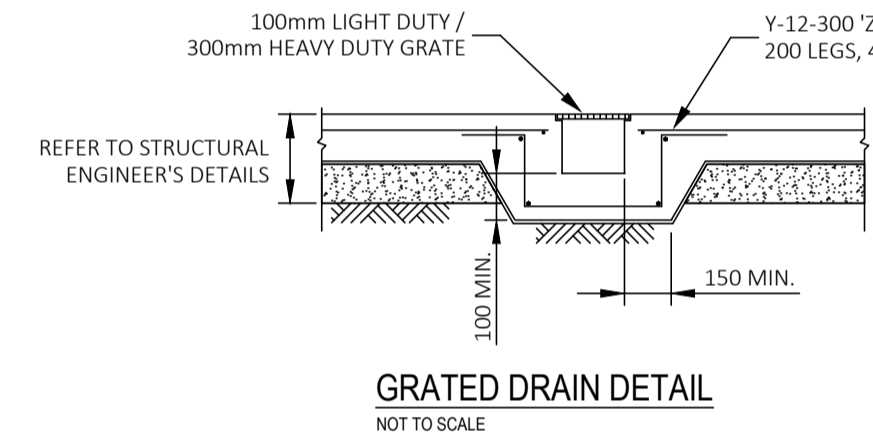


GRADED DRAIN DETAIL
 NOT TO SCALE

NOT FOR CONSTRUCTION


PIT SCHEDULE

1. PROVIDE LIGHT DUTY GRATES FOR NON VEHICULAR TRAFFICKED AREAS.
2. PROVIDE HEAVY DUTY GRATES FOR VEHICULAR TRAFFICKED AREAS.
3. PROVIDE 450 x 450 CLEAR OPENING FOR PIT DEPTHS UP TO 600mm U.N.O.
4. PROVIDE 600 x 600 CLEAR OPENING FOR PIT DEPTHS UP TO 900mm U.N.O.
5. PROVIDE 900 x 900 CLEAR OPENING FOR PIT DEPTHS GREATER THAN 900mm U.N.O.
6. ALL REINFORCED CONCRETE PIPES SHALL BE OF RUBBER RING JOINTS
7. ALL DISCHARGE CONTROL PITS SHALL HAVE A MINIMUM OF 900 x 900 CLEAR OPENING U.N.O.
8. ALL GRATED TRENCH SHALL BE A MINIMUM OF 150(W) x 200(H) U.N.O.

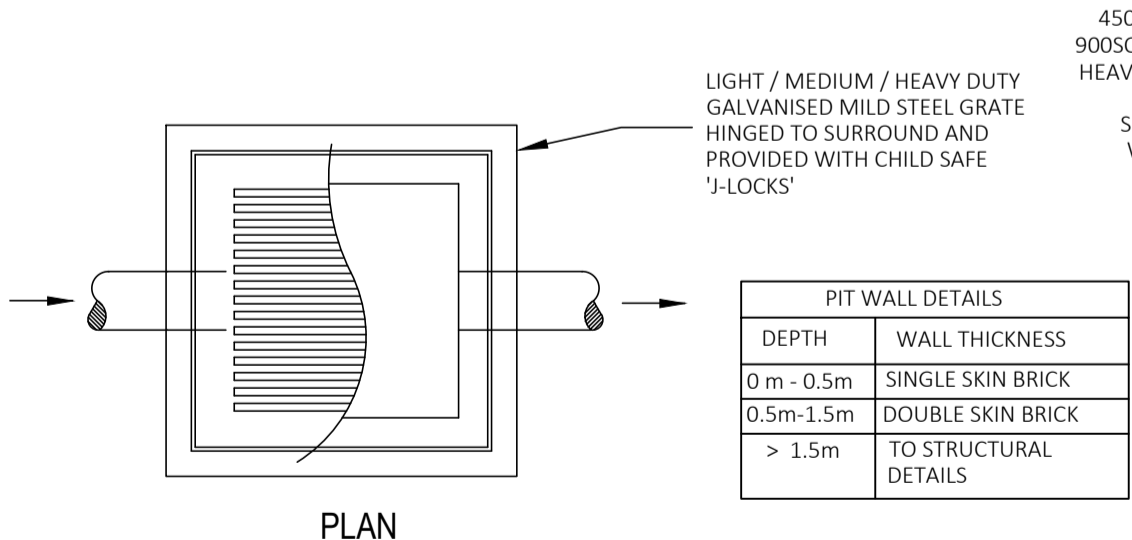


PIT WALL DETAILS	
DEPTH	WALL THICKNESS
0 m - 0.5m	SINGLE SKIN BRICK
0.5m - 1.5m	DOUBLE SKIN BRICK
> 1.5m	TO STRUCTURAL DETAILS


TYPICAL INLET PIT DETAIL
 NOT TO SCALE

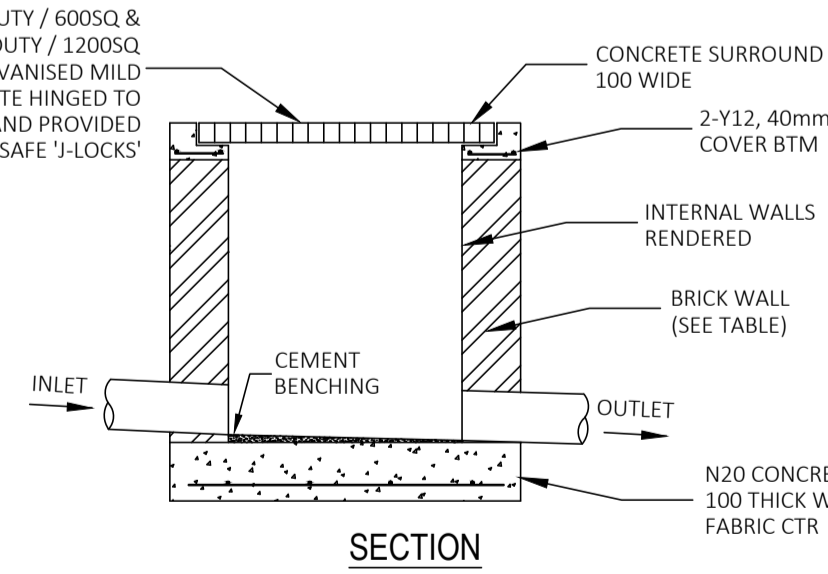

SECTION

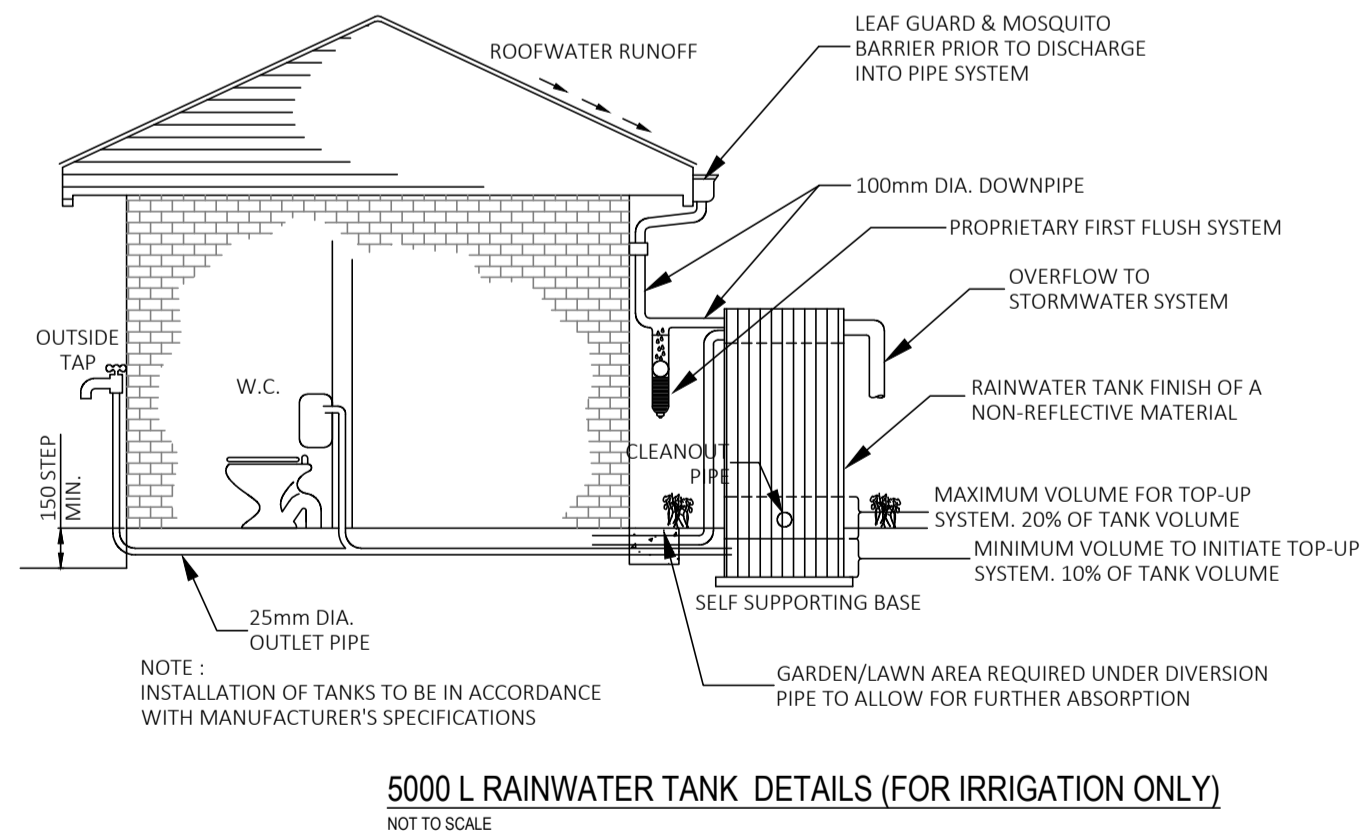

5000 L RAINWATER TANK DETAILS (FOR IRRIGATION ONLY)
 NOT TO SCALE

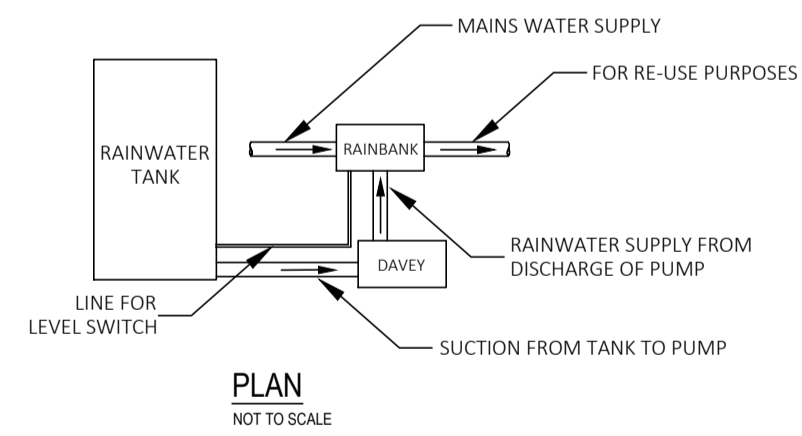

PLAN
 NOT TO SCALE

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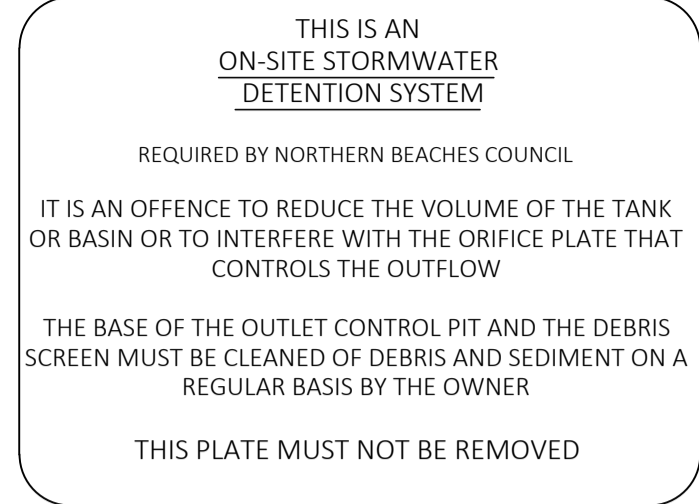
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Checked By : N. Evans			At 5 Skyline Place Frenchs Forest NSW 2086		Date January 2021	Scale As Shown @ A1
Approved By : Kenneth T. NG MIEAust CPEng NER APEC Engineer IntPE(Aus) (Reg. No. 2206352) RPEQ Registered Certifier (Hydraulic (stormwater), Road & Drainage and Stormwater) NSW Fair Trading (Reg. No. BDC0827)			Client		Project No. 284012021DA	Drawing & Sheet No./Issue 28401-19/21 / A
A	Development Application	28 Jan. 2021				
Issue	Description	Date of Drawing				




CONFINED SPACE SIGNAGE
NOT TO SCALE


110mm X 80mm SIGN TO BE PLACED AT VISIBLE LOCATION AT OSD TANK, TO READ:



OSD SIGNAGE
NOT TO SCALE

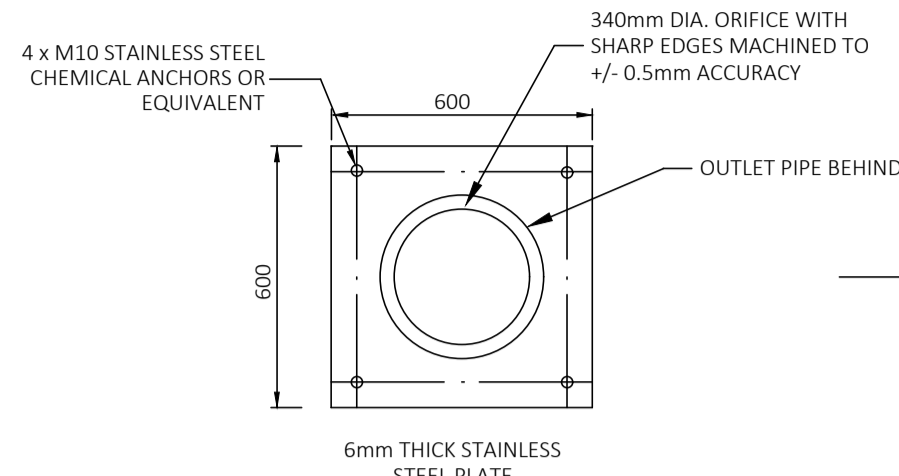


ORIFICE PLATE DETAIL
NOT TO SCALE

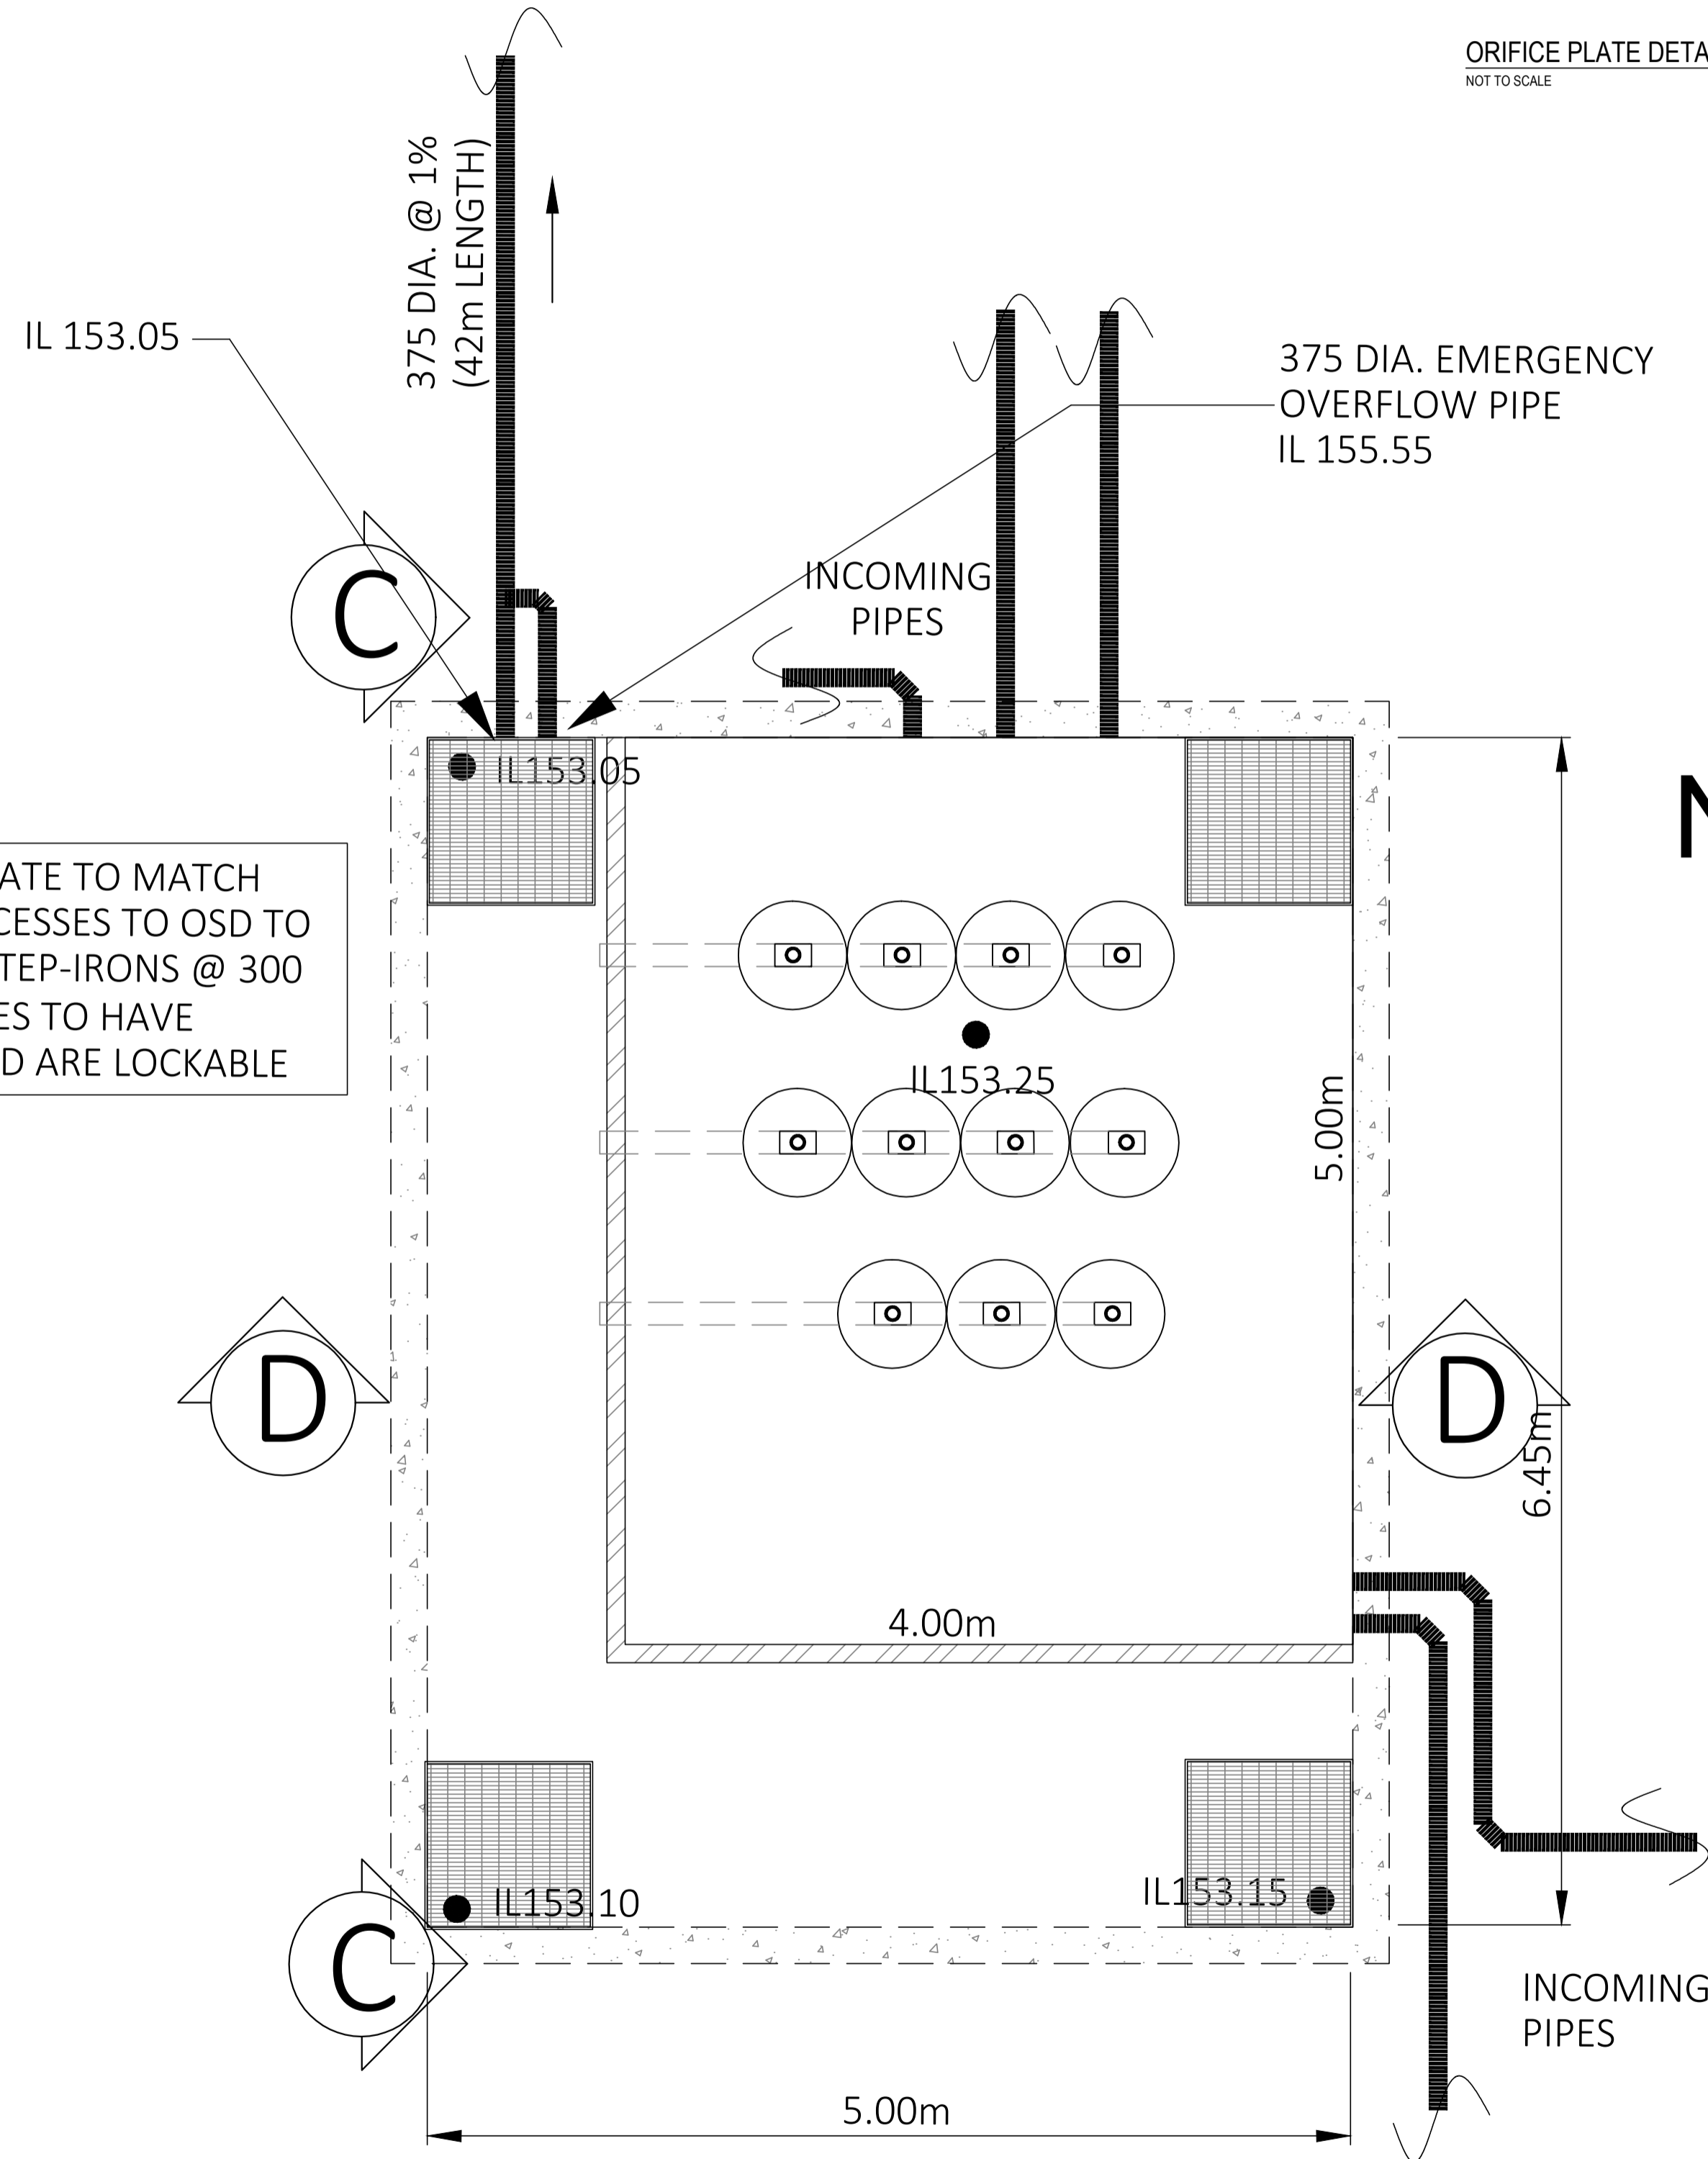


900SQ. ACCESS GRATE TO MATCH FINISHED RLS. ALL ACCESSES TO OSD TO BE PROVIDED WITH STEP-IRONS @ 300 C/C AND GRATES TO HAVE ACO-HEELGARDS AND ARE LOCKABLE


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SECTION C - C THROUGH ON-SITE DETENTION TANK WITH DISCHARGE CONTROL PIT DETAIL
NOT TO SCALE

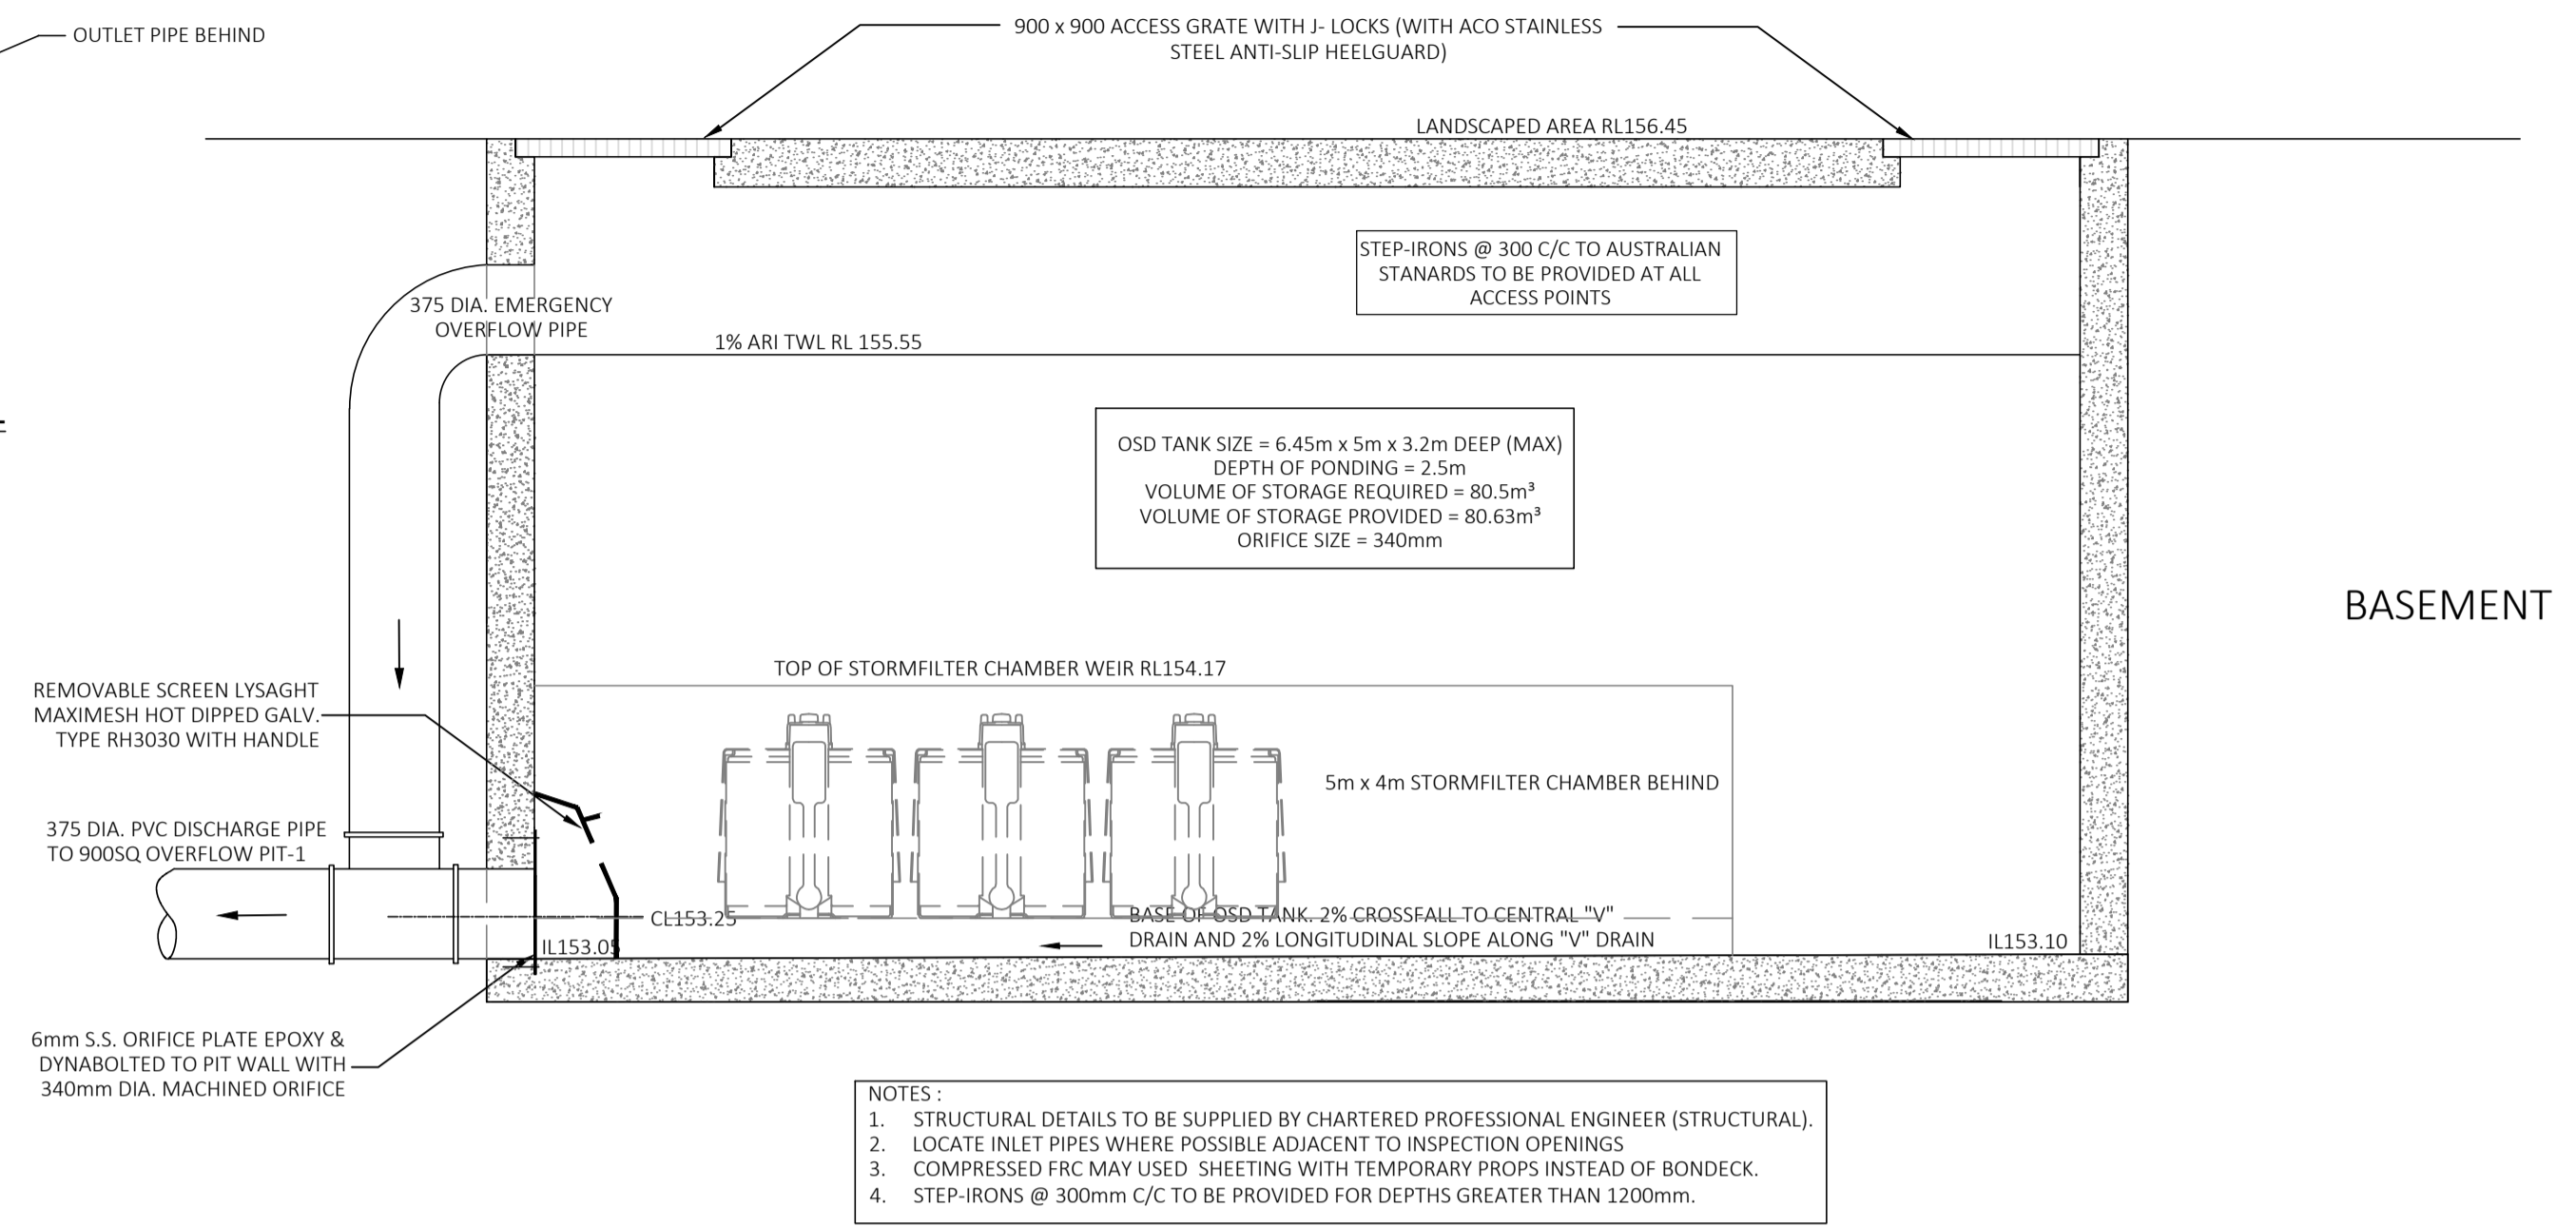

SECTION D - D THROUGH ON-SITE DETENTION TANK AND STORMFILTER CHAMBER
NOT TO SCALE

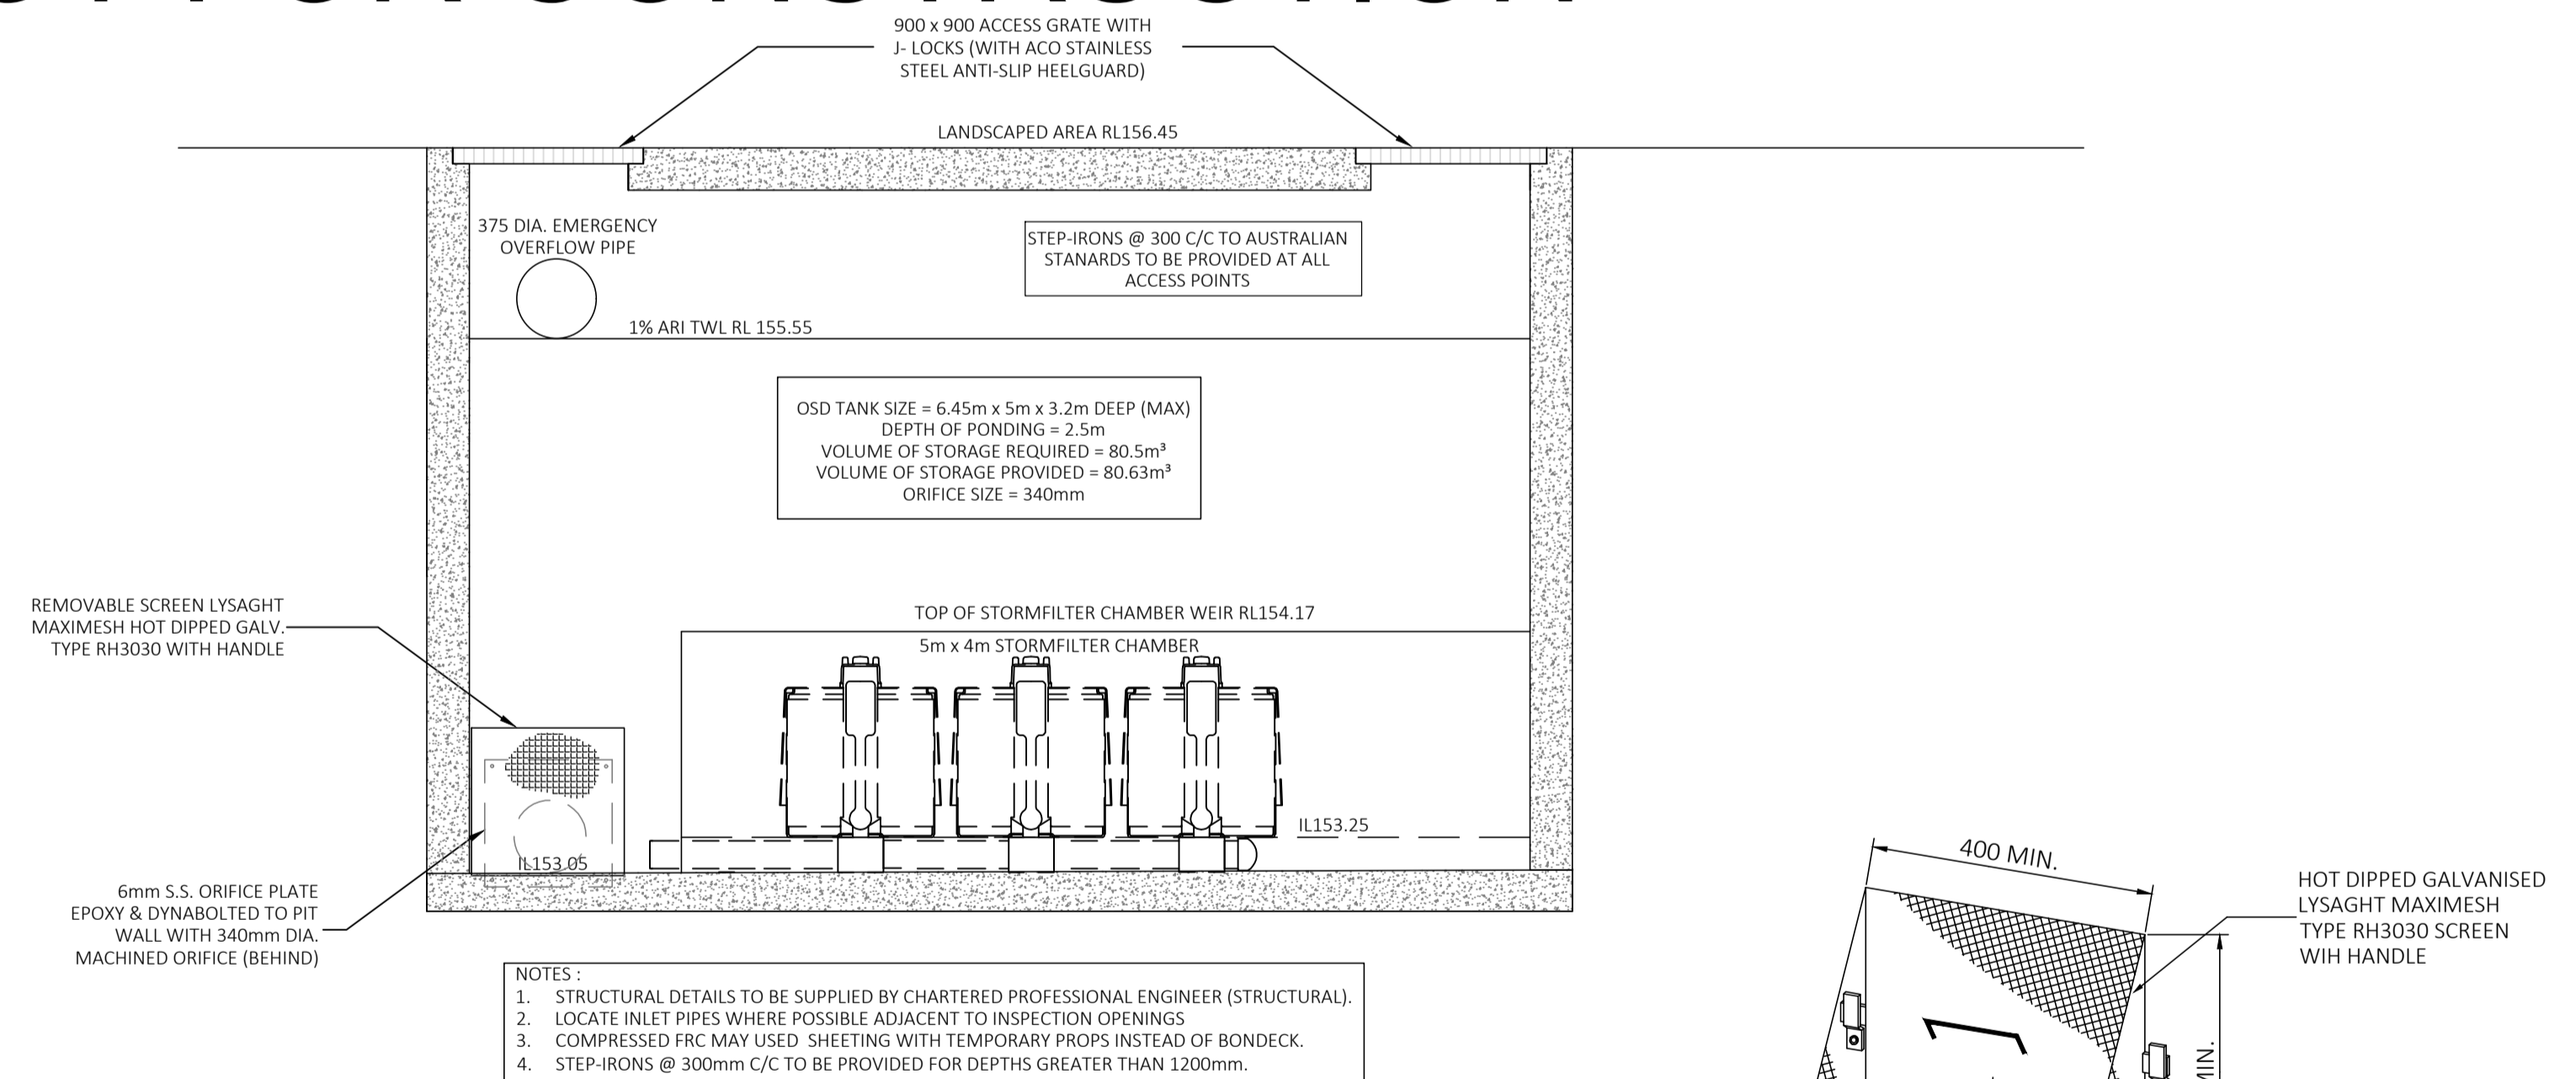


TRASH SCREEN DETAIL
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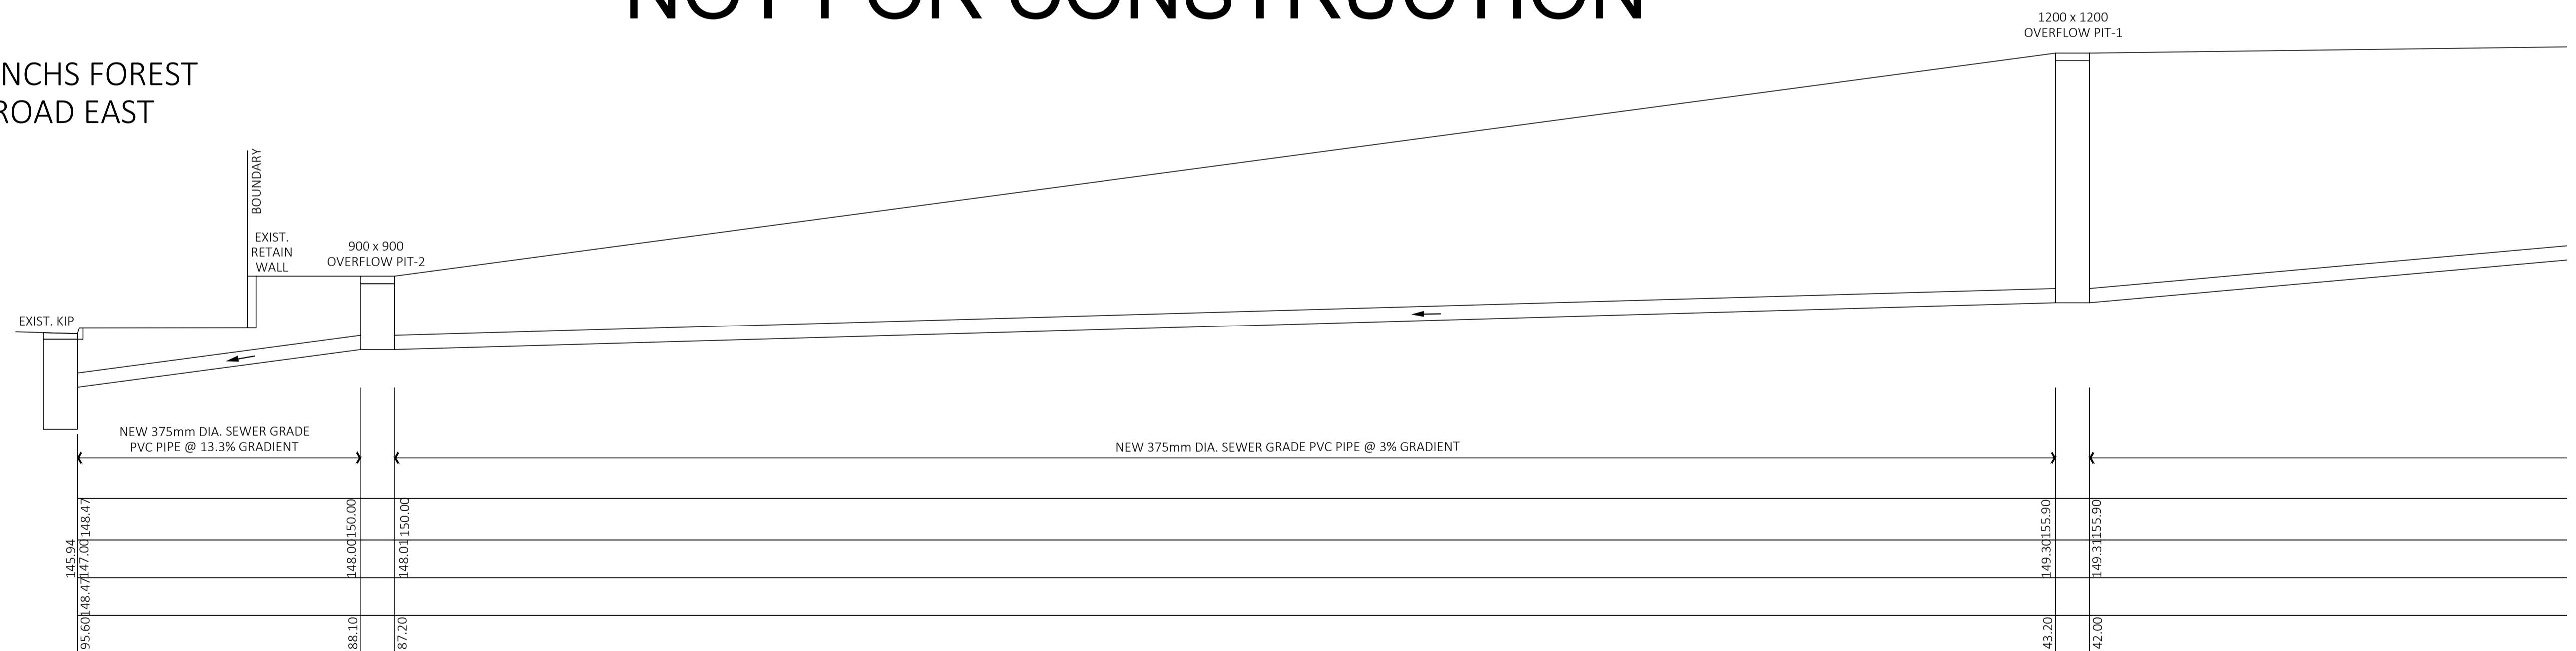


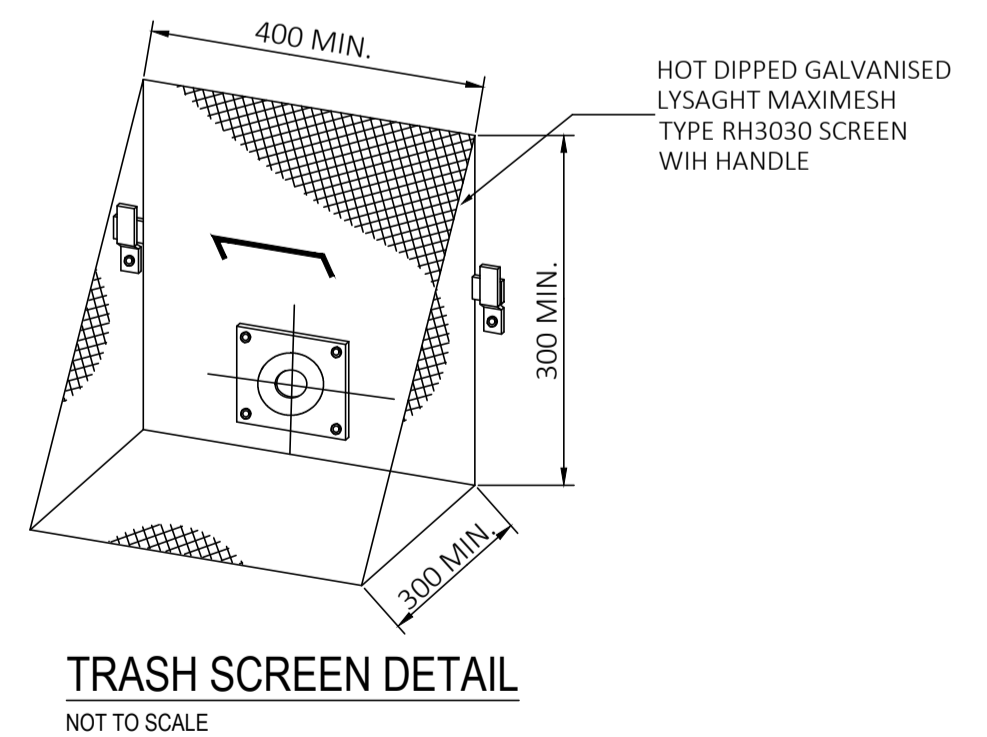OSD / PIPE LONGITUDINAL SECTION

SCALE 1 : 100

NOT FOR CONSTRUCTION

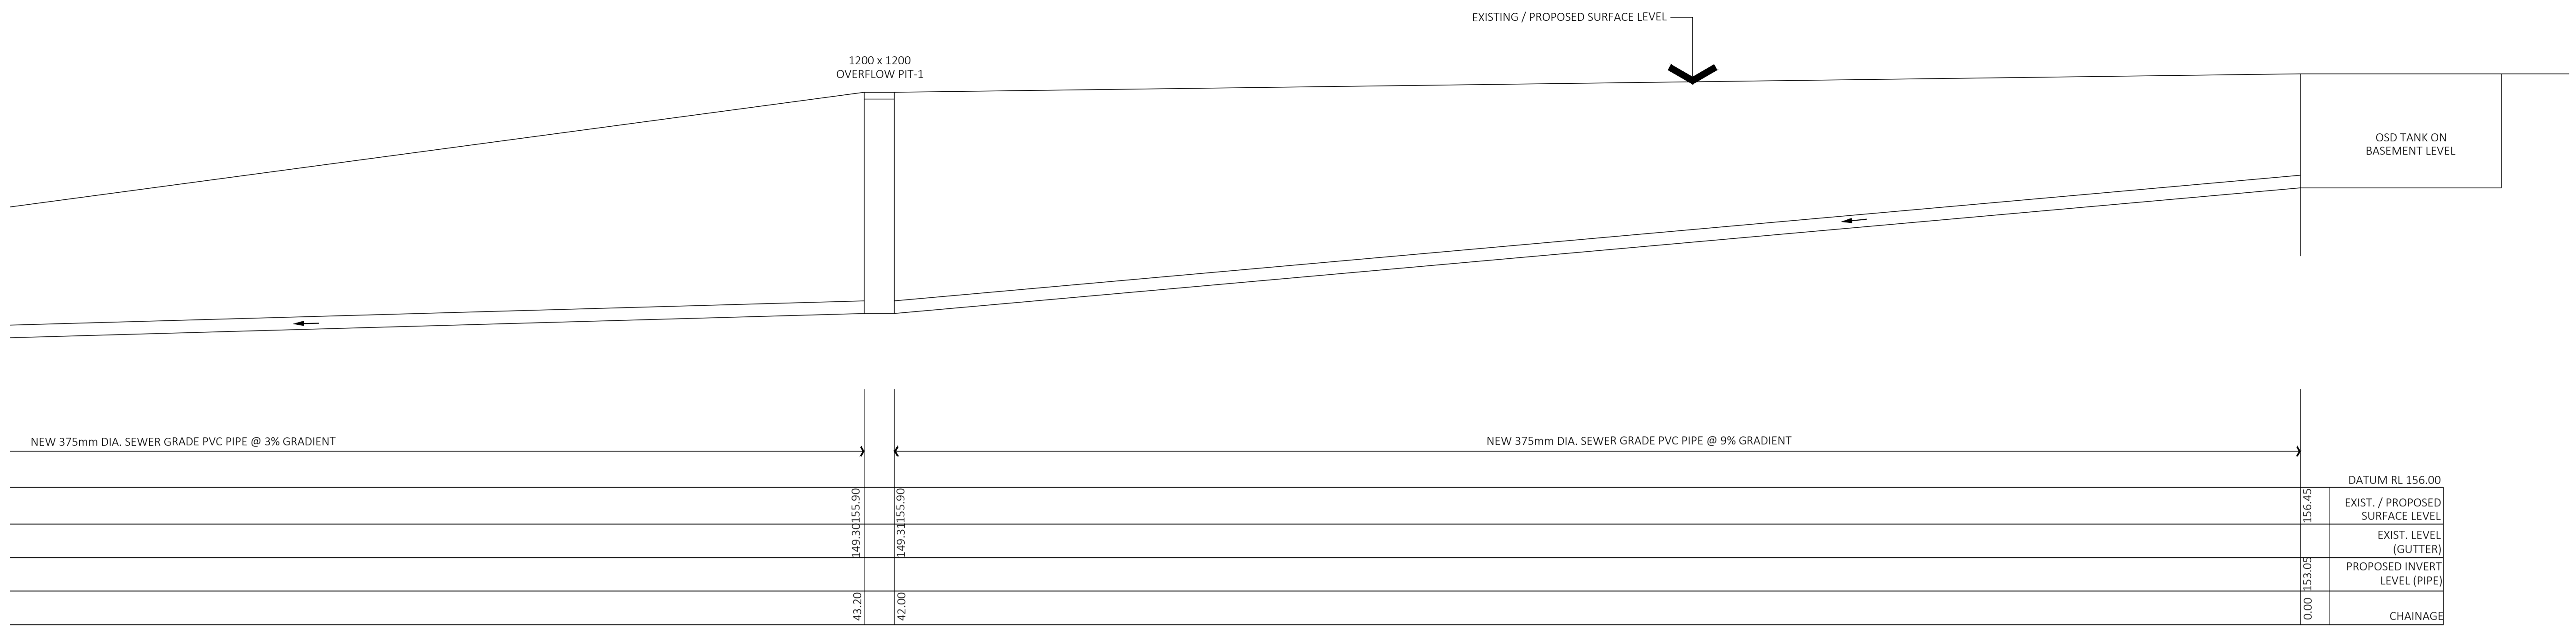FRENCHS FOREST ROAD EAST



OSD / PIPE LONGITUDINAL SECTION (CONTINUE)

SCALE 1 : 100

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		Checked By : N. Evans			Date January 2021	Scale 1 : 100 @ A1
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