MECHANICAL SERVICES - Kitchen Ventilation

SHOP 2, 11 ADA AVE, BROOKVALE, NSW, 2100

Drawing List					
Drawing Number	Drawing Title	Current Revision Description	Current Revision	Current Revision Date	
M-000	COVER SHEET & DRAWING LIST	ISSUE FOR CONSTRUCTION	3	2024/10/21	
M-001	LEGEND, NOTES, DETAILS & FAN SCHEDULE	ISSUE FOR CONSTRUCTION	2	2024/10/21	
M-110	FITOUT KITCHEN VENTILATION PLAN	ISSUE FOR CONSTRUCTION	3	2024/10/21	
M-120	SECTION - KITCHEN VENTILATION	ISSUE FOR CONSTRUCTION	3	2024/10/21	
M-130	ELEVATION - SHOPFRONT	ISSUE FOR CONSTRUCTION	3	2024/10/21	

Date	Issue
2024/09/05	1
2024/10/11	2
2024/10/21	3

Description PRELIMINARY ISSUE DRAWING UPDATED FOR NEW ARCH LAYOUT ISSUE FOR CONSTRUCTION



Architect:



Mechanical Designer:

Design by:	SJ	Project:
Drawn by:	QD	Shon
Checked by:	SJ	Shop
Project number:	800072	Drawing Title:
Date:	2024-10-21	
Scale @ A3	NTS	
Project Status:		Drawing Number:

ISSUE FOR CONSTRUCTION

Shop 2, 11 Ada Ave, Brookvale, NSW, 2100

COVER SHEET & DRAWING LIST

Revision: M-000

GENERAL NOTES


THE CONTRACTOR SHALL REVIEW INTERROGATE AND SATISFY THEMSELVES THAT THE DESIGN IS ADEQUATE FOR THE PROJECT AND MEETS THE REQUIREMENTS OF:

- 1) AUSTRALIAN STANDARDS & BCA
- 2) CONSENT CONDITIONS
- 3) ARCHITECTURAL INTENT
- 4) ANY OTHER CODE OR STANDARD THAT IS APPLICABLE TO THE PROJECT
- 1. ALL DIMENSIONS ARE IN MILLIMETERS UNLESS OTHERWISE NOTED.
- 2. INFORMATION SHOWN IS FOR TENDER PURPOSES ONLY. THE CONTRACTOR SHALL CO-ORDINATE WITH ALL SERVICES ON SITE PRIOR TO MANUFACTURE AND SITE-
- 3. ALL DUCTWORK SHALL COMPLY WITH AS 4254 AND AS 1668 PART 1 & 2.
- ALL DUCTWORK DIMENSIONS ARE **SHEETMETAL** SIZES. SIZES SHOWN IN () ARE APPROXIMATE ONLY AND SHOULD BE CHECKED ON SITE WITH CONTRACTOR.
- PROVIDE ALL SECONDARY GALVANISED STEEL SUPPORT FOR ALL SERVICES, UNLESS NOTED OTHERWISE. ALL SECONDARY SUPPORTS SHALL BE FROM LOAD BEARING ROOF, COLUMNS, BEAMS, WALLS, COLUMNS AND FLOORS ONLY.
- SUPPORTING OF ALL DUCTING IN ACCORDANCE WITH CURRENT EARTHQUAKE CODES AND STANDARDS, WITH ALL BRACING AS REQUIRED.
- ALL EXPOSED DUCTWORK CROSS BROKEN TO PREVENT POOLING OF WATER.
- ALL DUCTWORK OTHER THAN EXHAUST DUCTWORK NOT IN THE CONDITIONED SPACE EXTERNALLY INSULATED UNLESS INDICATED OTHERWISE.
- ACCESS PANELS WITHIN PLASTERBOARD CEILINGS SHALL BE POSITIONED TO SUIT THE LOCATION OF MECHANICAL SERVICES EQUIPMENT AND SHALL BE SUPPLIED AND INSTALLED BY THE BUILDING TRADE.
- PROVIDE ACCESS PANELS IN PLASTERBOARD CEILINGS TO ENABLE ACCESS TO ALL DAMPERS, VALVES, AIR CONDITIONING UNITS, FANS ETC.
- ADEQUATE CLEARANCE PROVIDED TO ALLOW FOR FUTURE, ONGOING MAINTENANCE AND SERVICE OF ALL INSTALLED PLANT AND EQUIPMENT.
- PROVIDE FLANGED JOINTS ON ALL DUCTWORK EXPOSED TO VIEW. EMER PAINTS OR EQUIVALENT SHALL NOT BE USED.
- 22. ALL DUCTWORK SUPPORTS SHALL BE GALVANISED STEEL, INSTALLED NEAT MANNER WITH TIDY CUT ENDS.
- 23. PROVIDE ANODISED ALUMINUM FINISH TO AIR TERMINALS TO BE MOUNTED ON DUCTWORK
- 24. ALLOW FOR ACCESS PANELS ON ALL KITCHEN EXHAUST DUCTWORK, AT CHANGE OF DIRECTIONS, AND AT EVERY 3m MAXIMUM STRAIGHT RUNS. PROVIDE TIGHT SEALS AS REQUIRED. ALLOW ALSO FOR ACCESS PANELS UPSTREAM ANDDOWNSTREAM OF CARBON AND HEPA FILTERS FOR TESTING/MAINTENANCE.
- 25. ALL PLANT AND EQUIPMENT INSTALLED/SUPPORTED ON APPROVED MACHINERY MOUNTS.
- 26. IN THE EVENT OF A FIRE SIGNAL AT THE FIP, TENANCY FAN COIL UNIT IS TO AUTOMATICALLY SHUTDOWN. ALL SYSTEMS SHALL AUTOMATICALLY RESET TO NORMAL MODE OPERATION AND CONTROL ONCE THE FIRE SIGNALS ARE CLEARED.


Description

PRELIMINARY ISSUE

LEGEND:

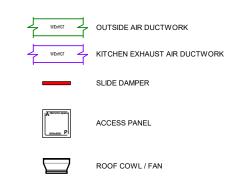

TYPICAL DETAILS:

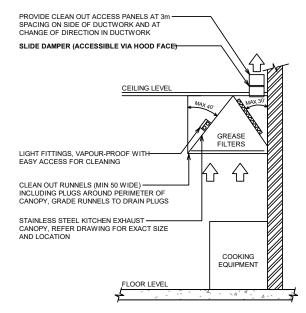

- 1. CEILING/ROOF PENETRATION BY BUILDER.
- 2. ALL SIDES OF CANOPY NOT AGAINST A WALL SHALL OVERHANG COOKING EQUIPMENT
- 3. KITCHEN EXHAUST CANOPY SUPPORT STRUCTURE BY BUILDER

1 KITCHEN EXHAUST HOOD CONNECT DETAILS SCALE: NTS

FAN SCHEDULE:

Equipment Reference	KEF-01
Make or Equivalent	FANTECH
Model	GUE454V
Туре	Gamma Ultra - Vertical
Performance Details	
Air Flow (I/s)	1200
Static Pressure (Pa)	300
Fan Details	
Diameter (mm)	450
Impeller Type	Mixed Flow
Fan Speed @ 50Hz (r/min)	1380
Input Power (kW)	1.04
Fan Weight (kg)	38.0
Motor Details	
Electrical Supply	240V 1ph 50Hz
Motor Frame	137
Motor Power (kW)	1.10
FLC / Start (A)	5.20/17.16
Motor Speed	4 pole
Sound Levels (dBA)	
63Hz	79
125Hz	83
250Hz	86
500hz	77
1k Hz	76
2k Hz	72
4k Hz	68
8k Hz	60
Inlet dBA @ 3m	61
Control	VSD

Client:

Architect:



Mechanical Designer:



Design by:	SJ	Project:
Drawn by:	QD	S
Checked by:	SJ	٦
Project number:	800072	Drawing
Date:	2024-10-21	
Scale @ A3	NTS	
Project Status:		Drawing

Shop 2, 11 Ada Ave, Brookvale, NSW, 2100

rawing Title:

LEGEND, NOTES, DETAILS & FAN SCHEDULE

2

Revision: Drawing Number: ISSUE FOR CONSTRUCTION M-001

Date


2024/09/05


2024/10/21

Issue


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ISSUE FOR CONSTRUCTION



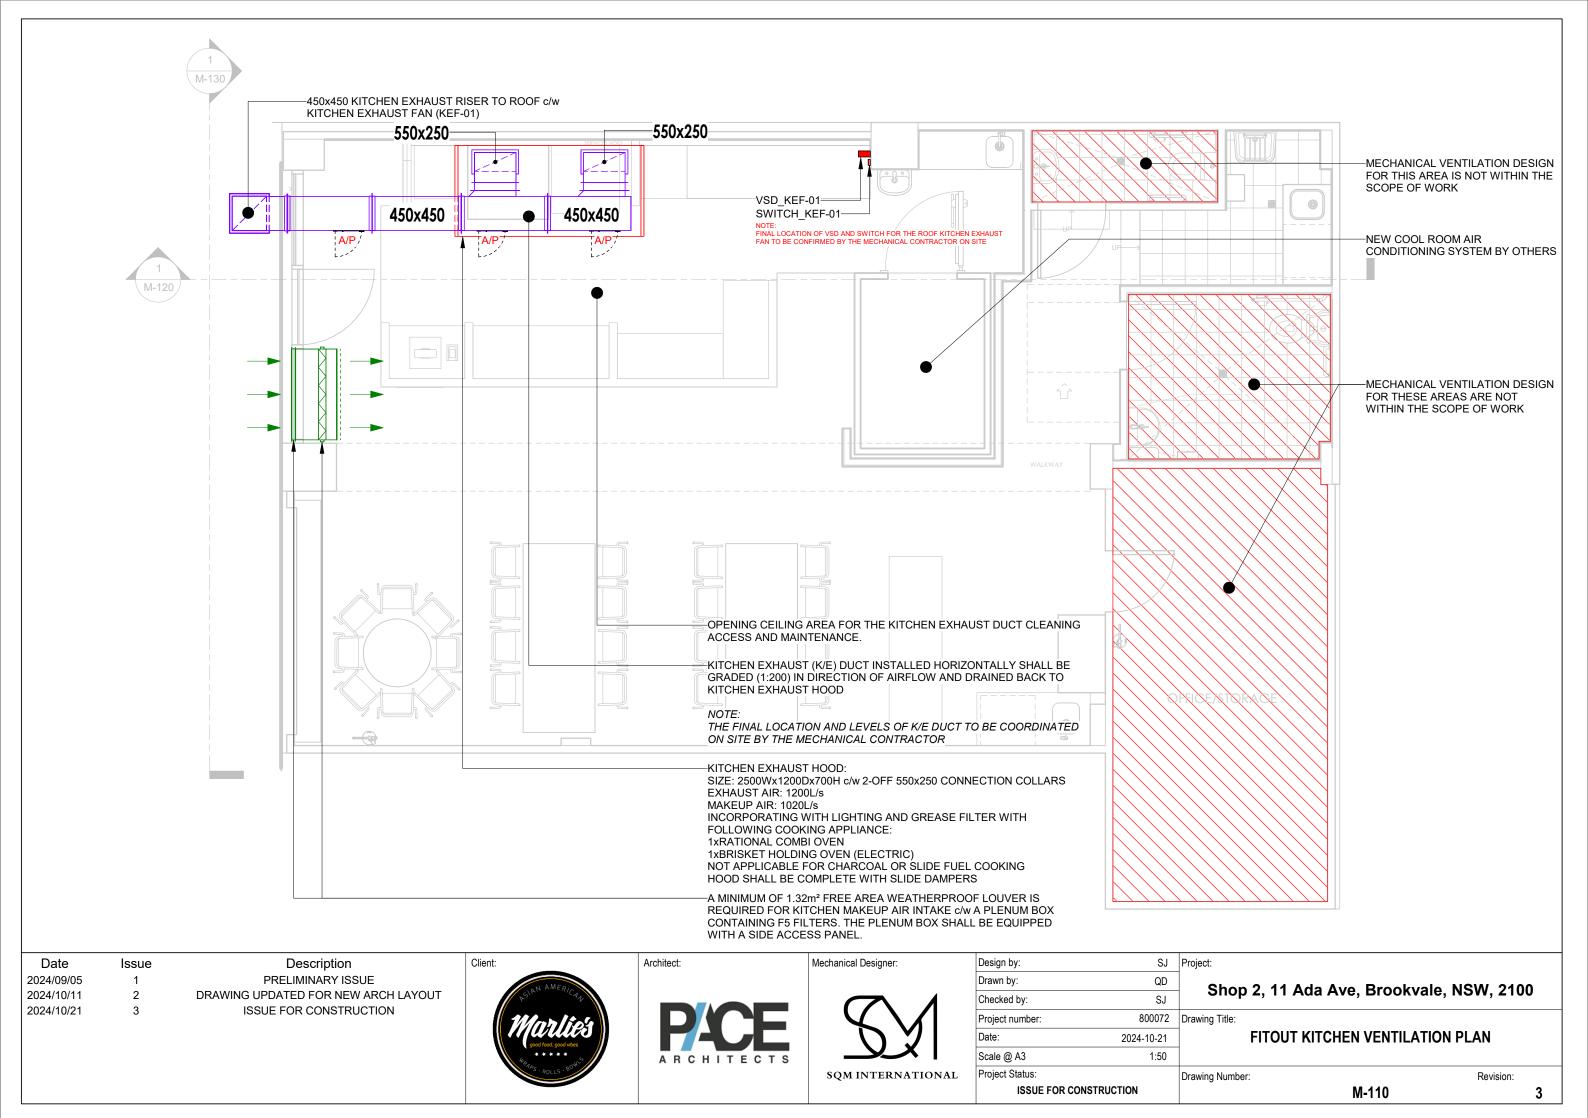

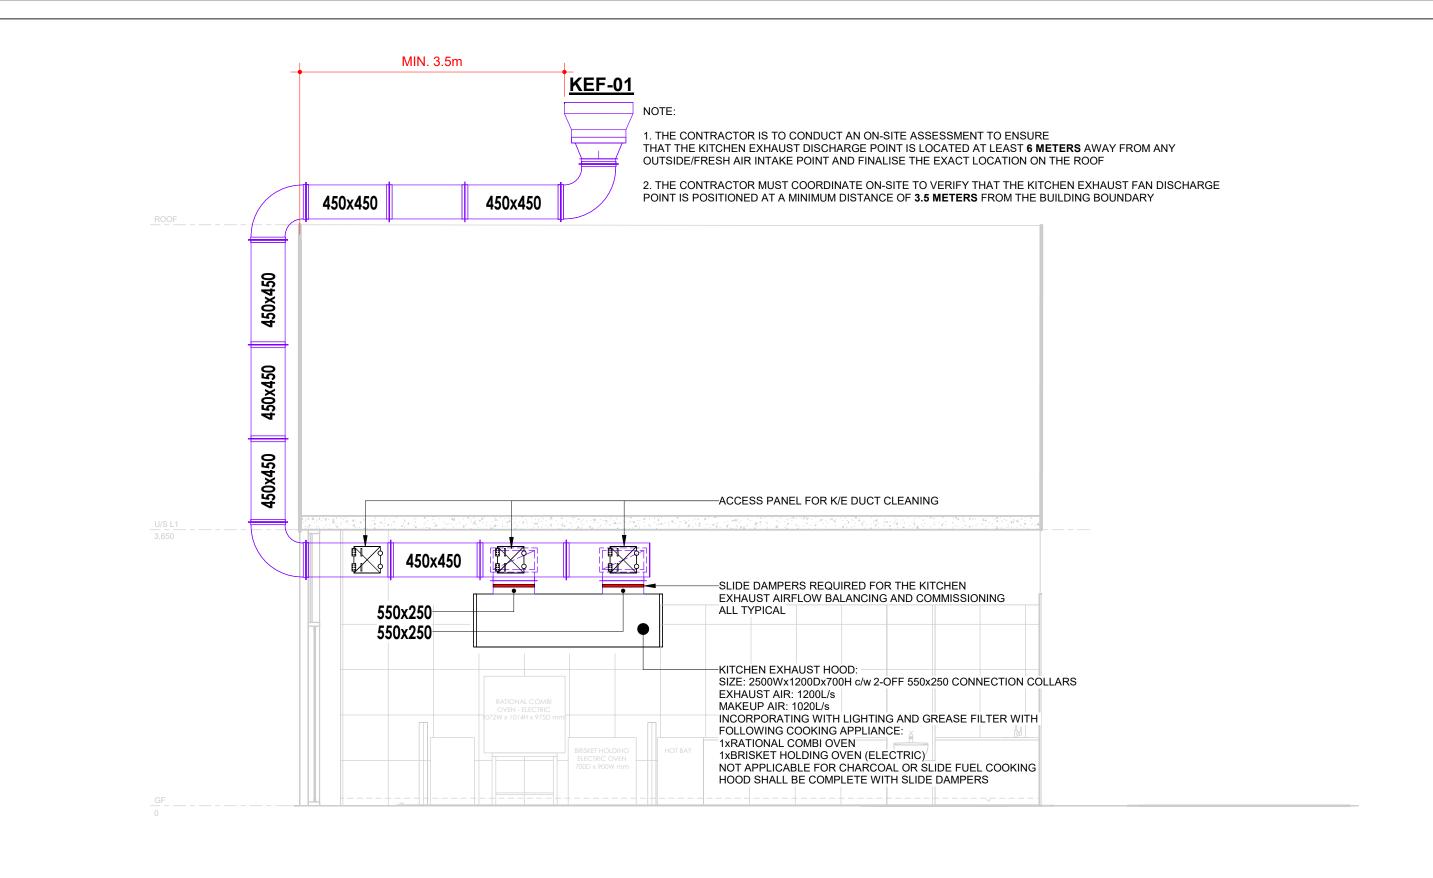Date	Issue	Description	Client:	Architect:	Mechanical Designer:	Design by: SJ	Project:
2024/09/05	1	PRELIMINARY ISSUE	N AMEG			Drawn by: QD	Char 2 44 Ada Ava Braskurala NCM 2400
2024/10/11	2	DRAWING UPDATED FOR NEW ARCH LAYOUT	ESIAM MICHICAN			Checked by: SJ	Shop 2, 11 Ada Ave, Brookvale, NSW, 2100
2024/10/21	3	ISSUE FOR CONSTRUCTION	100-10-6			Project number: 800072	Drawing Title:
			Marines			Date: 2024-10-21	d
			good food, good vibes				SECTION - KITCHEN VENTILATION
			to RADS : DOUS : BOWLE	ARCHITECTS		Scale @ A3 1:50	
			MOLLS		SQM INTERNATIONAL	Project Status:	Drawing Number: Revision:
						ISSUE FOR CONSTRUCTION	M-120 3

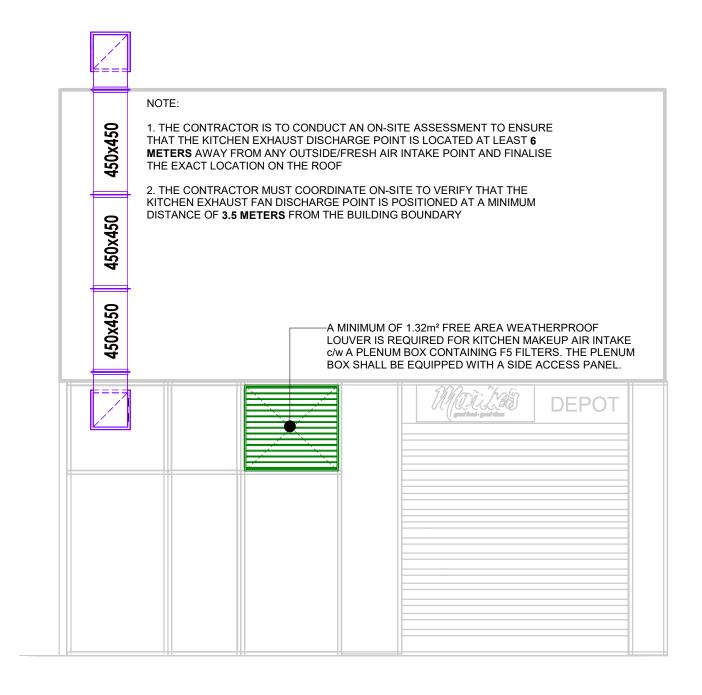

Date	Issue
2024/09/05	1
2024/10/11	2
2024/10/21	3

Description
PRELIMINARY ISSUE
DRAWING UPDATED FOR NEW ARCH LAYOUT
ISSUE FOR CONSTRUCTION

Marlies

good food, good values

Popings ROLLS - SCHOOL

Architect:



Mechanical Designer:



Design by:	Author	Proje
Drawn by:	Checker	
Checked by:	Designer	
Project number:	800072	Drawi
Date:	2024-10-21	
Scale @ A3	NTS	

Shop 2, 11 Ada Ave, Brookvale, NSW, 2100

2 Drawing Title:

ELEVATION - SHOPFRONT

NTS

Revision: M-130

tatus: Drawing Number:

ISSUE FOR CONSTRUCTION M-13