# LOT 83 PARKES ROAD, COLLAROY PLATEAU

# design & construction

Office: 46 Buller St, North Parramatta, NSW 2151 Tel:02 96 307 307 Fax: 02 8076 1576 M:0423 211 914 www.arcinovationz.com.au



# TORRENS TITLE SUBDIVISION OF 1 LOT INTO 2 AND BUILD DOUBLE STOREY DWELLING ON EACH LOT



### **BASIX REQUIREMENTS (LOT 101)**

- 1.Shower Heads, Toilet and Taps must be Min 4 star rated
- 2.Minimum 1500 Litre Rain Water Tank with min roof runoff from 95 sqm.
- 3.RWT must be connected to all baths, cold water tap in all toilets and one outdoor tap.

- 1.External Wall insulation:R Value 1.86 or (2.40 including Construction)
- 2.Ceiling to have min R value 3.5 and must have Foil/Sarking
- 3. Insulation specified above must be installed in accordance with the Part 3.12.1.1 of BCA 4.All windows are Aluminum and Single Clear.

- 1.Hot Water gas Instantanous -5 star rating 2.Heating and cooling system of 1- Phase aircondition with a zoning in day and night areas.EER -2.5 Star (old label)
- 3.Individual Fan -ducted to facade or roof must be installed to Kitchen, One bath and
- 4. Dedicated LED lighting to 6 bedrooms; 2 livings, kitchen, bath, laundry, hallways

Install a outdoor clothes line Electric oven & Gas cooktop

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## **BASIX REQUIREMENTS (LOT 102)**

- 1. Shower Heads, Toilet and Taps must be Min 4 star rated
- 2. Minimum 1500 Litre Rain Water Tank with min roof runoff from 90
- 3.RWT must be connected to all baths, cold water tap in all toilets and one outdoor tap.

- 1.External Wall insulation: R Value 2.86 or (3.40 including Construction) 2.Ceiling to have min R value 3.5 and must have Foil/Sarking
- 3. Insulation specified above must be installed in accordance with the Part 3.12.1.1 of BCA
- 4.All windows are Aluminum and Single Clear.

Other:

- 1.Hot Water gas Instantanous -5 star rating
- 2. Heating and cooling system of 1- Phase aircondition with a zoning in
- day and night areas. EER -2.5 Star (old label)
- 3.Individual Fan -ducted to facade or roof must be installed to Kitchen, One bath and Laundry.
- 4. Dedicated LED lighting to 5 bedrooms; 3 livings, kitchen, bath, laundry, hallways

Install a outdoor clothes line Electric oven & Gas cooktop



# AMENDMENTS AS PER SECTION 4.55 (LOT 101)

1.MEDIA ROOM ADDED ABOVE GARAGE LEVEL 2.TWO MORE WINDOWS ARE ADDED AT MEDIA ROOM'S FRONT WALL

3.DRIVEWAY UPDATED

### SITE LOCATION



Office: 46 Buller St, North Parramatta, NSW 2151 Tel:02 96 307 307 M·0423 211 914 Fax: 02 8076 1576 www.arcinovationz.com.au info@arcinovationz.com.au

#### 1. FALLS, SLIPS, TRIPS

#### C)a) WORKING AT HEIGHTS

#### DURING CONSTRUCTION

Wherever possible, components for this building should be prefabricated off-site or at ground level to minimise the risk of workers falling more than

two metres. However, construction of this building will require workers to be working at heights where a fall in excess of two metres is possible and injury is likely to result from such a fall. The builder should provide a suitable barrier wherever a person is required to

falling more than two metres is a possibility

#### DURING OPERATION OR MAINTENANCE

For houses or other low-rise buildings where scaffolding is appropriate:

Cleaning and maintenance of windows, walls, roof or other components of this building will require persons to be situated where a fall from a height in excess of two metres is possible. Where this type of activity is required, scaffolding, ladders or trestles should be used in accordance with relevant codes of practice, regulations or legislation.

#### b) SLIPPERY OR UNEVEN SURFACES

Designer has not not been involved in the selection of surface finishes, the owner is responsible for the selection of surface finishes in the pedestrian trafficable areas of this building. Surfaces should be selected in accordance with AS HB 197:1999 and AS/NZ

#### c) STEPS, LOOSE OBJECTS AND UNEVEN SURFACES

Due to design restrictions for this building, steps and/or ramps are included in the building which may be a hazard to workers carrying objects or otherwise occupied. Steps should be clearly marked with both visual and tactile warning during construction ince,demolition and at all times when the building operates as a workplace.

Building owners and occupiers should monitor the pedestrian access ways and in particular access to areas where maintenance is routinely carried out to ensure that surfaces have not moved or cracked so that they become uneven and present a trip nazard.Spills, loose material, stray objects or any other matter that may cause a slip or trip hazard should be cleaned or removed from access ways.

Contractors should be required to maintain a tidy work site during construction, maintenance or demolition to reduce the risk of trips and falls in the workplace. Materials for construction or maintenance should be stored in designated areas away from access 2. FALLING OBJECTS

#### LOOSE MATERIALS OR SMALL OBJECTS

Construction, maintenance or demolition work on or around this building is likely to involve persons working above ground level or above floor levels. Where this occurs one or more of the following measures should be taken to avoid objects falling from the area where the work is being carried out onto persons below:

Prevent or restrict access to areas below where the work is being carried

Provide toeboards to scaffolding or work platforms.

Provide protective structure below the work area Ensure that all persons below the work area have Personal Protective

During construction, renovation or demolition of this building, parts of the structure including fabricated steelwork, heavy panels and many other components will remain standing prior to or after supporting parts are in place. Contractors should ensure that temporary bracing or other required support is in place at all times when collapse which may injure persons in the area is a possibility.

BUILDING COMPONENTSMechanical lifting of materials and components during construction, maintenance or demolition presents a risk of falling objects. Contractors should ensure that appropriate lifting devices are used, that loads are properly secured and that access to areas below the load is prevented or restricted.
For building on a major road, narrow road or steeply sloping road:

hazard. During construction, maintenance or demolition of this building designated parking for workers and loading areas should be provided. Trained traffic management personnel should be responsible for the supervision of these areas.

#### For building where on-site loading/unloading is restricted:

Construction of this building will require loading and unloading of materials on the roadway. Deliveries should be well planned to avoid congestion of loading areas and trained traffic management personnel should be used to supervise loading/unloading

Busy construction and demolition sites present a risk of collision where deliveries and other traffic are moving within the site. A traffic management plan supervised by trained traffic management personnel should be adopted for the work site.

Rupture of services during excavation or other activity creates a variety of risks including release of hazardous material. Existing services are located on or around this site. Where known these are identified on the plans but the exact location and extent of services may vary from that indicated. Services should be located using an appropriate service (such as Dial Before You Dig), appropriate excavation practice should be used

necessary, specialist contractors should be used.

Locations with underground power: Underground power lines MAY be located in or around this site. All underground power lines must be disconnected or carefully located and adequate warning signs used prior to any construction, maintenance or demolitior

Overhead power lines MAY be near or on this site. These pose a risk of electrocution if struck or approached by lifting devices or other plant and persons working above ground level. Where there is a danger of this occurring, power lines should be, where practical, disconnected or relocated. Where this is not practical adequate warning in the form of bright coloured tape or signage should be used or a protective barrier provided

#### 5 MANUAI TASKS

Components within this design with a mass in excess of 25kg should be lifted by two or more should be required to limit the component mass.

All material packaging, building and maintenance components should clearly show the total mass of packages and where practical all items should be stored on site in a way which minimises bending before lifting. Advice should be provided on safe lifting methods in all areas

Construction, maintenance and demolition of this building will require the use of portable tools and equipment. These should be fully maintained in accordance withmanufacturer's specifications and not used where faulty or (in the case of electrical equipment) not carrying a current electrical safety tag.

All safety guards or devices should be regularly checked and Personal Protective Equipment should be used in accordance with manufacturer's specification.

Construction of this building and some maintenance on the building will require excavation and installation of items within excavations. Where practical, installation should be carried out using methods which do not require workers to enter the excavation. Where this is not practical, adequate support for the excavated area should be provided to prevent collapse. Warning signs and barriers to prevent accidental or unauthorised access to all excavations should be provided.

For buildings with enclosed spaces where maintenance or other access may be required: Enclosed spaces within this building may present a risk to persons entering for construction maintenance or any other purpose. The design documentation calls for warning signs and barriers to unauthorised access. These should be maintained throughout the life of the building. Where workers are required to enter enclosed spaces, air testing equipment and Personal Protective Equipment should be provided.

For buildings with small spaces where maintenance or other access may be required: Some small spaces within this building will require access by construction or maintenance workers. The design documentation calls for warning signs and barriers to unauthorised access. These should be maintained throughout the life of the building. Where workers are required to enter small spaces they should be scheduled so that access is for short periods. Manual lifting and other manual activity should be restricted in small spaces. 6. HAZARDOUS SUBSTANCES

For alterations to a building constructed prior to 1990:If this existing building was constructed

1990 - it therefore may contain asbestos 1986 - it therefore is likely to contain asbestos either in cladding material or in fire retardant insulation material. In either case, the builder should check and, if necessary, take appropriate action before demolishing, cutting, sanding, drilling or otherwise disturbing the existing structure.

### POWDERED MATERIALS

Many materials used in the construction of this building can cause harm if inhaled in powdered form. Persons working on or in the building during construction, operational maintenance or demolition should ensure good ventilation and wear Personal Protective Equipment including protection against inhalation while using powdered material or when sanding, drilling, cutting or otherwise disturbing or creating powdered material.

The design of this building may include provision for the inclusion of treated timber within the structure. Dust or fumes from this material can be harmful. Persons working on or in the building during construction, operational maintenance or demolition should ensure good ventilation and wear Personal Protective Equipment including protection against inhalation of harmful material when sanding, drilling, cutting or using treated timber in any way that may cause harmful material to be released. Do not burn treated timber

### VOLATILE ORGANIC COMPOLINDS

Many types of glue, solvents, spray packs, paints, varnishes and some cleaning materials and disinfectants have dangerous emissions. Areas where these are used should be kept well ventilated while the material is being used and for a period after installation. Personal Protective Equipment may also be required. The manufacturer's recommendations for use must be

#### SYNTHETIC MINERAL FIBRE

Fibreglass, rockwool, ceramic and other material used for thermal or sound insulation may contain synthetic mineral fibre which may be harmful if inhaled or if it comes in contact with the skin, eyes or other sensitive parts or the body. Personal Protective Equipment including protection against inhalation of harmful material should be used when installing, removing or

### TIMBER FLOORS

This building may contain timber floors which have an applied finish. Areas where finishes are applied should be kept well ventilated during sanding and application and for a period after installation. Personal Protective Equipment may also be required. The manufacturer's 8. PUBLIC ACCESS use must be carefully considered at all times.

risk to workers and public. Warning signs and secure barriers to unauthorised access should be provided. Where electrical installations, excavations, plant or loose materials are present they should be secured when not fully supervised.

### 9. OPERATIONAL USE OF BUILDING

#### RESIDENTIAL BUILDINGS

This building has been designed as a residential building. If it, at a later date, it is used or intended to be used as a workplace, the provisions of the Work Health and Safety Act 2011 or subsequent replacement Act should be applied to the new use.

10.OTHER HIGH RISK ACTIVITY

Electrical Risks at the Workplace, AS/NZ 3012 and all licensing requirements

All work using Plant should be carried out in accordance with Code of Practice: Managing Risks of Plant at the Workplace.

All work should be carried out in accordance with code of Practice: Managing Noise and Preventing Hearing Loss at Work. Due to the history of serious incidents it is recommende that particular care be exercised when undertaking work involving steel construction and concrete placement. All the above applies.

### NATIONAL CONSTRUCTION CODE (NCC)

#### Section A General Provisions

#### Vol. 2 Part 1.3. Clause 1.3.2 Classifications:

CLASS 1: One or more buildings which in association constitute -

- (a) Class 1A A single dwelling, being -
- (i) a detached house, or
- (ii) one or more attached dwellings, each being a building, separated by a fire-resisting wall, including a
- row house, terrace house, town house or villa unit;

CLASS 10: A non-habitable building being a private garage, carport, shed, or the

### Section C Fire Separation

### Part 3.7.1 Fire Separation

Application

Compliance with this Part satisfies Performance Requirement P2.3.1 for fire separation.

General Concession - Non-combustible materials

The following materials, though combustible or containing combustible fibtres, may be used wherever a non-

combustible is required in the Housing Provisions: (a) plasterboard, and

- perforated gypsum lath with a normal paper finish, and
- fibrous-plaster sheet, and
- fibre-reinforced cement sheeting, and
- pre-finished metal sheeting having a combustible surface finish not exceeding 1mm thick and

where the Spread-of-Flame Index of the product is not more than 0; and above bonded laminated materials, where -

- each laminate is non-combustible; and
- each adhesive layer is not more than 1mm thick; and the total thickness of adhesive layers is not more than 2mm; and
- the Spred-of-Flame Index and the Smoke-Development Index of the
- as a whole does not exceed 0 and 3 respectively.

### External Walls of Class 1 buildings

An external wall of a Class 1 building and any openings in that wall must comply with 3.7.1.5, if the wall is

(a) 900mm from the allotment boundary other than the boundary adjoining a road alignment or other

public space; or

1.8m from another building on the same allotment other than appurtenant Class 10 building or a

detached part of the same Class 1 building.

#### Measurement of distances

- (a) The distance from any point on an external wall of a building to an allotment
- building is the distance to that point measured along a line at right angles from the allotment
- boundary or external wall of the other building which intersects that point without obstruction by a wall complying with 3.7.1.5.
- (b) Where a wall within a specified distance is required to be constructed in a certain manner, only that part of the wall, (including any openings) within the specified
- distance, must be constructed in that manner.
- 3.7.1.5 Construction of External Walls
- (a) External walls (including gables) required to be fire-resisting [Referred to in
- 3.7.1.3 or 3.7.1.6] must
- extend to the underside of a non-combustible roof covering or non-combustible eaves lining, and must
  - than 90mm thick: or
  - be of masonry construction not less than 90mm thick.
  - Openings in external walls required to be fire-resisting [referred to in 3.7.1.3 or

have an FRL of not less than 60/60/60 when tested from the outside; or

be of masonry-veneer construction in which the external masonry veneer is

3.7.1.6] must be protected by-

non-operable fire-windows or other construction with an FRL of not less

(ii) self-closing solid-core doors not less than 35mm thick. (c) Sub-floor vents, roof vents, weep holes and penetrations for pipes,

comply with (b) above. (d) Concessions for non-habitable room windows, conduits and the like-Despite the requirements in (b), in a non-habitable room a

window that faces the boundary of an adjoining allotment may be not less than 600mm from that

boundary, or, where the building faces another building on the same allotment, not less than 1.2m from

that building; providing thatin a bathroom, laundry or toilet, the opening has an area of not more

than 1.2sam; or (ii) in a room other than referred to in (i), opening has an area of not

more than 0.54sqm; and-

(A) the window is steel-framed, there are no opening sashes and it is glazed in

#### wire glass; or (B) the opening is enclosed with hollow glass blocks.

#### Separating walls

A wall that separates Class 1 dwellings, or separates a Class 1 building from a Class 10a building

which is not apurtenant to that Class 1 building, must have an FRL of not less than 60/60/60, and-

commence at the footings or ground slab; and

(A) if the building has a non-comustible roof covering, to the underside of

the roof (B) if the building has a combustible roof covering, to not less than 450mm

#### the roof covering.

### SPECIFICATION C1.10 Fire Hazard Properties

Materials used in the building having flamability, smoke developed and spread-of-flame indices as set-out in Spec. C1.10.

### SECTION F Health and Amenity

#### Part F1: Damp and Weatherproofing

-Stormwater drainage must comply with AS/NZS 3500.3.2

-Roof covering to comply with F1.5

-Sarking must comply with AS/NZS 4200, Parts 1 and 2 Water proofing of wet areas in buildings to comply with F1.7

-Damp-proofing of floors on ground to comply with F1.11

### Part F3.7: Fire safety

3.8.6.2

-Automatic fire detection system to be provided in accordance with Part 3.7.2 General concession:

Part 3.7.2: Smoke alarms - requirements for smoke alarms:

(a) Smoke alarms must be installed in: any storey containing bedrooms.

Part 3.8: Health and amenity -Wet areas within the building must comply with the requirements of Part

Part 3.8.6: Sound insulation requirements

Application - Compliance with this Part satisfies performance requirement P2.4.6 for sound insulation.

(a) to provide insulation from air-born and impact sound, a separating wall between two or more Class

1 buildings, mustachieve the weighted sound reduction with spectrum adaption term

#### [Rw+Ctr] and discontinuous construction

Sound insulation requirements

requirements, as required by Table 3.8.6.1; and be installed in accordance with the appropriate requirements of


(b) For the purpose of this Part, the Rw+Ctr must be determined in accordance with As/NZS 1276.2 or ISO 717.1, using results from laboratory measurements.

### Safe movement and access

-The treads and risers of the proposed stairs are to comply with Part 3.9.1.2 General requirements.



THESE NOTES MUST BE READ AND UNDERSTOOD BY ALL INVOLVED IN THE PROJECT. THIS INCLUDES (But is not excluded to): OWNER.BUILDER.SUB-CONTACTORS.CONSULTANTS, RENOVATORS, OPERATORS, MAINTAINORS, DEMOLISHERS.

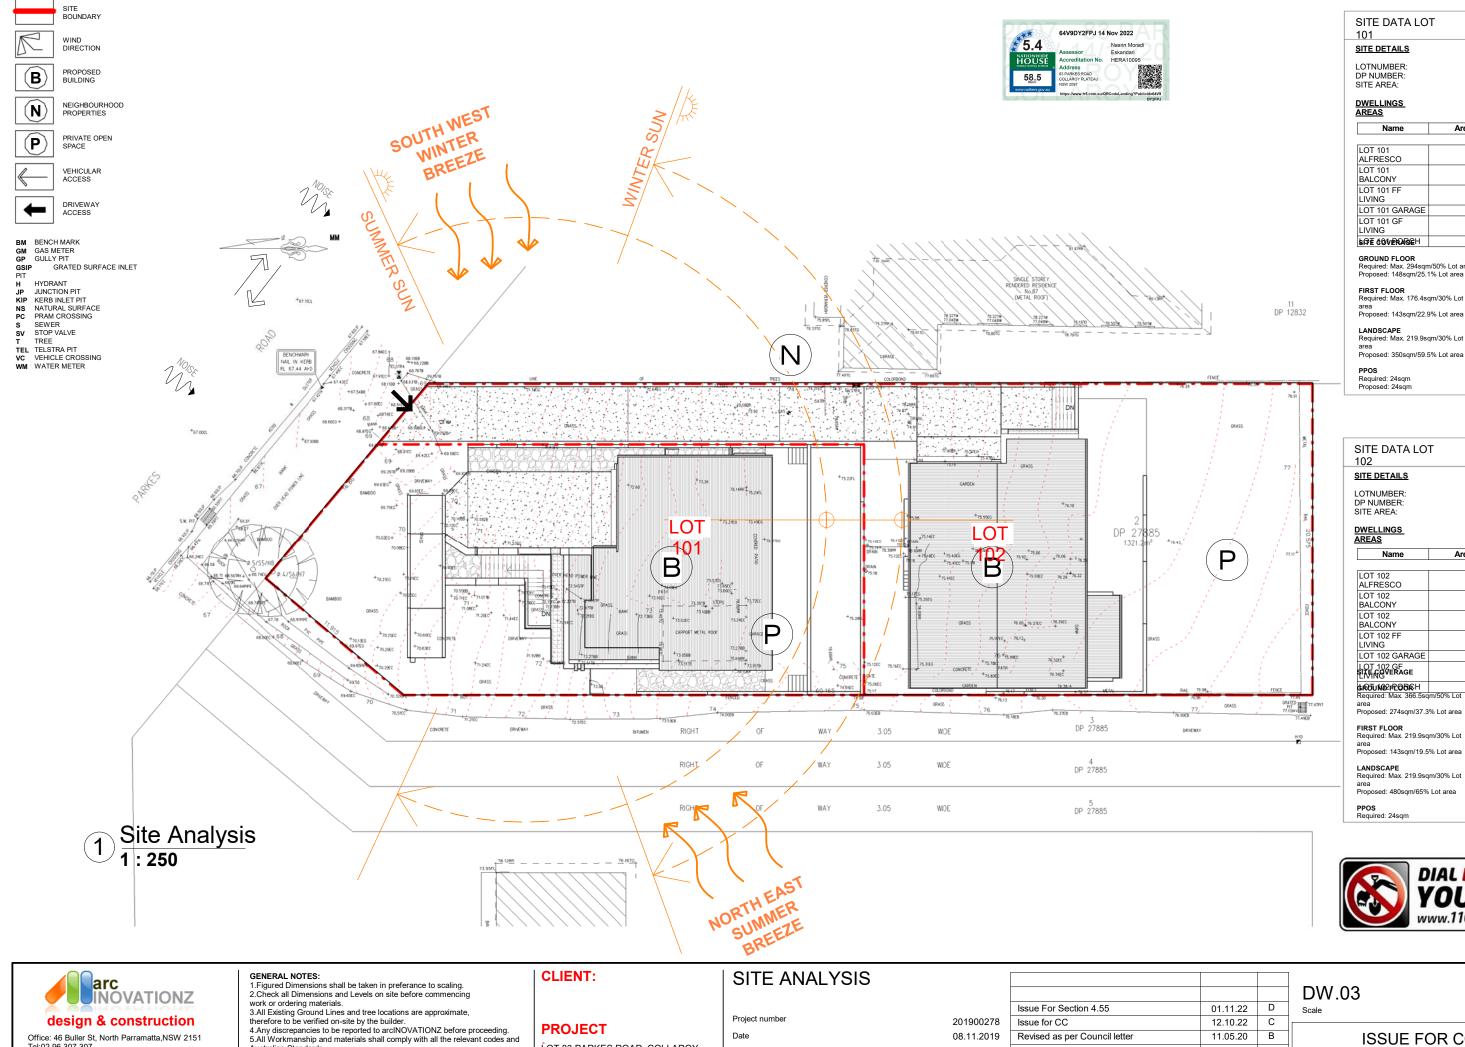

SITE DETAILS

Name	Area	Square
LOT 101	7 m²	0.8
ALFRESCO		
LOT 101	19 m²	2.0
BALCONY		
LOT 101 FF	135 m²	14.6
LIVING		
LOT 101 GARAGE	33 m²	3.6
LOT 101 GF	115 m²	12.4
LIVING		
SOFE COVERDAGEH	9 m²	1.0
	318 m²	34.4

GROUND FLOOR Required: Max. 294sqm/50% Lot area Proposed: 148sqm/25.1% Lot area

area Proposed: 143sqm/22.9% Lot area

area Proposed: 350sqm/59.5% Lot area

SITE DATA LOT

Name	Area	Square
LOT 102 ALFRESCO	21 m²	2.3
LOT 102 BALCONY	6 m²	0.7
LOT 102 BALCONY	11 m²	1.2
LOT 102 FF LIVING	143 m²	15.4
LOT 102 GARAGE	34 m²	3.7
LOT 102 GF SITE COVERAGE	120 m²	13.0
GROTUNDERPOREH	5 m²	0.6
Required: Max. 366.5sc	m/50% Lot 341 m <sup>2</sup>	36.9

Proposed: 274sam/37.3% Lot area

FIRST FLOOR Required: Max. 219.9sqm/30% Lot area Proposed: 143sqm/19.5% Lot area

LANDSCAPE Required: Max. 219.9sqm/30% Lot area
Proposed: 480sqm/65% Lot area

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Australian Standards.

6.All Plans are copyright work of arcINOVATIONZ.

LOT 83 PARKES ROAD, COLLAROY

Drawn by

Checked by

08.11.2019 DM JS

Revised as per Council letter 11.05.20 Issue for DA Approval 02.12.19 DESCRIPTION DATE ISSUE



### BUILDING SPECIFICATION NOTES:

 $0.2 \mathrm{MM}$  HIGH IMPACT VAPOUR MEMBRANE IS REQUIRED FOR ROOMS OR HABITABLE NATURE.

DWELLING TIMBER FRAMING CONSTRUCTION AS PER AS 1684

INTERNAL STAIRS/ANTI-SKID NOSINGS THROUGHOUT THE

ARE IN ACCORDANCE WITH THE REQUIREMENTS OF PART 3.9 VOLUME 2 OF THE NCCS (BCA)

INTERNAL STAIR HANDRAIL TO MEET REQUIREMENTS OF CLAUSE 3.9.2.4 OF VOLUME 2 OF THE NCCS (BCA)

BALUSTRADES SERVICING THE DWELLING ARE IN ACCORDANCE WITH REQUIREMENTS OF PART 3.9 OF VOLUME 2 OF THE NCCS

ALL GLASS BALUSTRADES REQUIRE A LOAD BEARING HANDRAIL

TO BE COMPLIED WITH THE REQUIREMENTS OF AS 1288.

SMOKE ALARMS ARE TO BE PROVIDED IN ACCORDANCE WITH THE REQUIREMENTS OF PART 3.7.2 OF VOLUME 2 OF NCCS (BCA)

EXTERIOR DOORS STEP DOWN AS PER THE REQUIREMENTS OF PART 3.9 OF VOLUME 2 OF THE NCCS (BCA).

DOOR SWING OR LIFT OFF HINGES ARE TO BE PROVIDED TO ENCLOSED WC AREA IN ACCORDANCE WITH REQUIEMENTS OF CLAUSE 3.8.3.3 OFVOLUME 2 OF

THE SLAB ON GROUND IS BE PROVIDED WITH A 0.2 MICRON HIGH IMPACT VAPOUR MEMBRANE.

INTERNAL FLOOR TO CEILING HEIGHT IN ACCORDANCE WITH THE REQUIREMENTS OF PART 3.8.2 OF VOLUME 2 OF THE NCCS – BCA.

CONSTRUCTION PLANS/DETAILS/SPECIFICATIONS FOR THE PROPOSAL WILL BE PROVIDED PRIOR TO THE COMMENCEMENT OF ANY WORKS.

- AS & BCA NOTES:
- Glazing, AS 1288 and AS 2047
   Timber Framing in accordance with AS 1684
   Footings in accordance with AS 2870
- Stormwater in Accordance with AS 3500
  Termite Management in accordance with AS 3660.
- Masonry Construction in accordance with AS 3700 & AS 4773.2
- Waterproofing in accordance with AS 3740 Smoke Alarms in accordance with AS 3786
- Smoke Alarms in accordance with AS 3780
  Concrete Construction in accordance with AS 3600
  Metal roof sheeting in accordance with AS1562.1&Clause3.5.1 of the BCA.
  Roof Tiling in accordance with Part 3.5.1 of the BCA Vol.2 and AS 2049
  Sound Insulation in accordance with AS/TS2 1276
  Ballustrade to comply with Part 3.9.2 of the BA Vol. 2

- Stair Construction in accordance with Part 3.9.1 of the BCA Vol. 2
  Stair floor finishes are required to comply with Part 3.9.1.3 of the BCA slip resistance (when tested in accordance with AS 4586). Steel Structures including Steel lintels compliance with AS 4100

### SITE NOTES:

ONE OUTDOOR CLOTHES LINE ROTARY OR FIXED ON WALLMUST BE INSTALLED AS SELECTED BY CLIENT

RETAINING WALL AS PER ENG'S DETAILS (IF REQUIRED)

THE CUT & FILL CALCULATIONS ARE BASED ON WAFFLE POD SLAB CONSTRUCTION

- NOTE:

   All building works must be carried out in accordance with the requirements of the Building Code of Australia (BCA).
- BASIX affected development must comply with the schedule of BASIX commitments specified within the submitted BASIX Certificate.

### NOTE:

- In order to protect and enhance onsite vegetation and trees the following applies to the
- development site: Layout of the approved development
- Location of trees identified for retention (Three trees located in the south western corner (front) of the site described on the Survey Plan as Ø.5/S5/H8, Ø.4/S6/H7 and Ø.7/S6/H12
- and Four trees located at the western end (rear) of the site described on the Survey Plan as Ø.7/S6/H10, Ø.5/S4/H8, M/S5/H3 and Ø.15/S2/H4) Extent of canopy spread
- Location of tree protection fencing / barriers (fencing in accordance with AS2470 2009) General tree protection measures
- Inspection hold points.

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ISSUE

- The Tree Protection Plan is to be submitted to the Principal Certifying Authority for approval prior to issue of a Construction Certificate.
- Tree protection measures identified on the plan are to be in place prior to

commencement of works.



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#### GENERAL NOTES:

- Figured Dimensions shall be taken in preferance to scaling. 2.Check all Dimensions and Levels on site before commencing
- work or ordering materials.
- 3.All Existing Ground Lines and tree locations are approximate therefore to be verified on-site by the builder. 4.Any discrepancies to be reported to arcINOVATIONZ before proceeding.

  5.All Workmanship and materials shall comply with all the relevant codes and
- Australian Standards. 6.All Plans are copyright work of arcINOVATIONZ.

# **CLIENT:**

# **PROJECT**

LOT 83 PARKES ROAD, COLLAROY

# SITE PLAN

Project number

Drawn by Checked by 201900278 08.11.2019

CLOTHES

PRINCIPLE

CL

01.11.22 D Issue For Section 4.55 12.10.22 Issue for CC 11.05.20 Revised as per Council letter R**Ississed foor DoA CAppin od val**etter 02)at 2.219 DM DATE DESCRIPTION JS

BENCH MARK

GAS METER

HYDRANT

SEWER

STOP VALVE TREE
TELSTRA PIT
VEHICLE CROSSING

WM WATER METER

JUNCTION PIT

KERB INLET PIT NATURAL SURFACE PRAM CROSSING

DW.04









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# LOT 101 DRIVEWAY CROSS SECTION

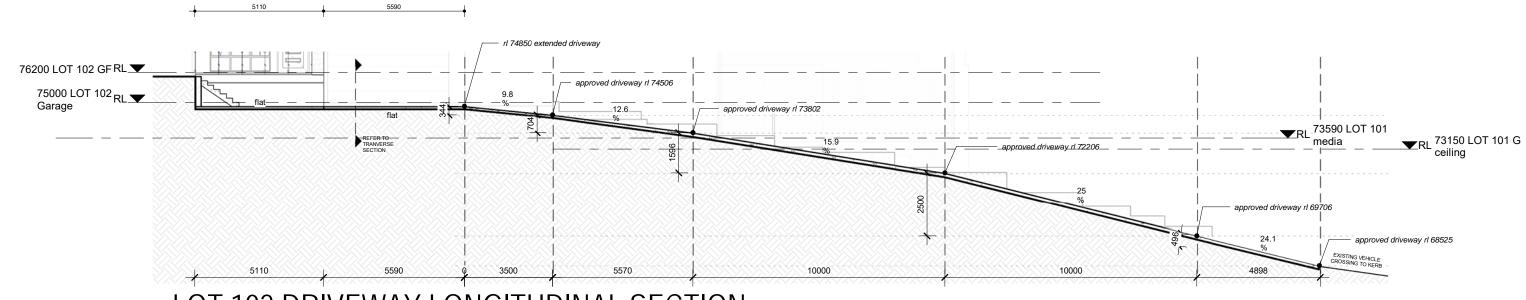

# LOT 102 DRIVEWAY LONGITUDINAL SECTION

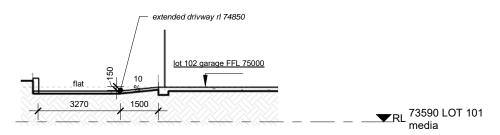

# LOT 102 DRIVEWAY TRANSVERSE SECTION





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### CLIENT:

NT: | DRIVEWAY CROSS SECTION

 PROJECT
 Project number
 201900278

 Date
 08.11.2019

 Drawn by
 Author


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Issue For Section 4.55	01.11.22	D	
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Revised as per Council letter	11.05.20	В	
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DW.04.0 Scale 1:150

ISSUE FOR CC

Shared drives\2022\201900278\_83 Parkes Rd\CAD\83 Par



Demolition Plan 1 : 200

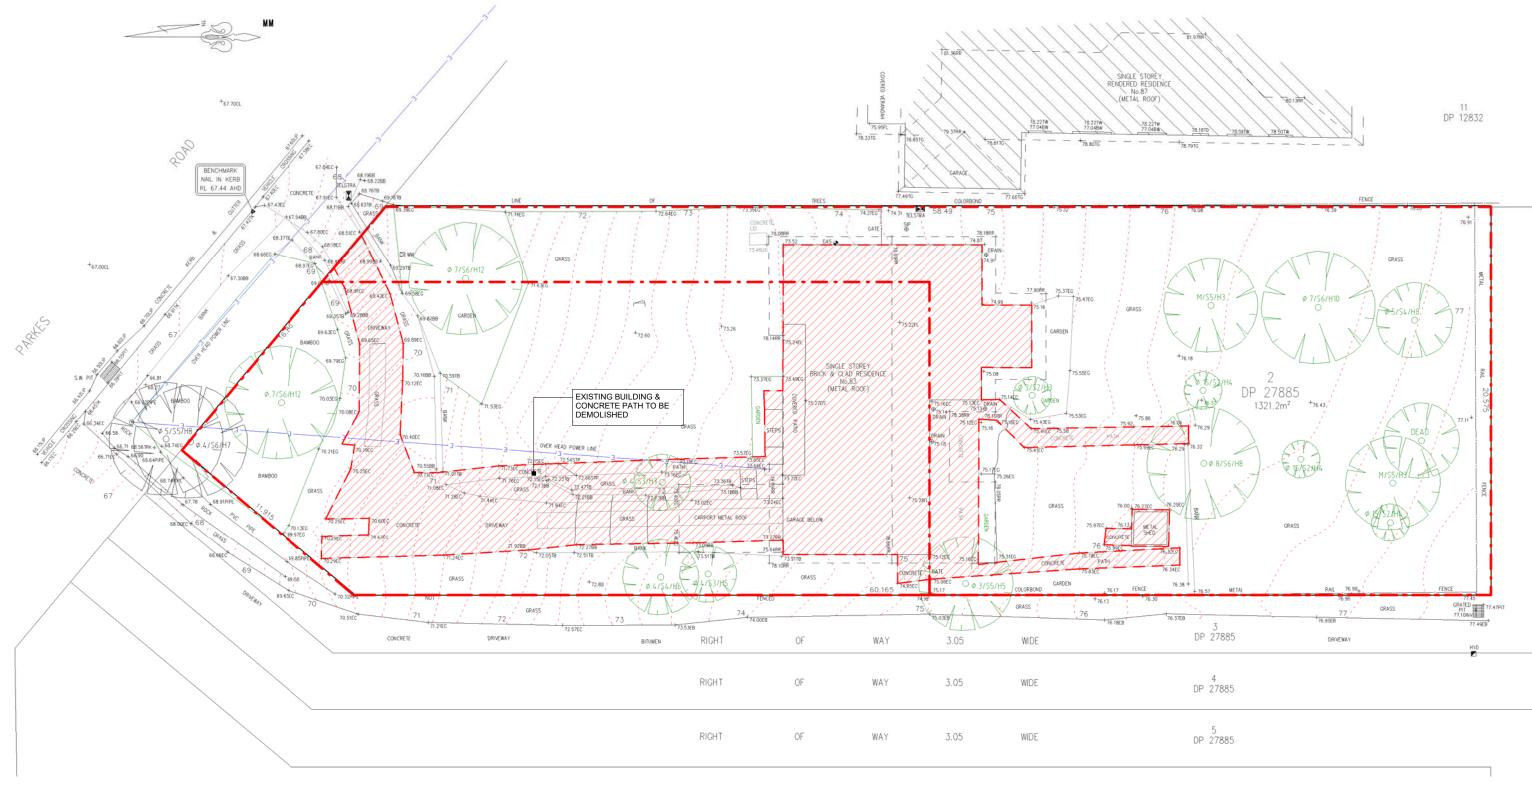



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### GENERAL NOTES:

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# **CLIENT:**

**PROJECT** LOT 83 PARKES ROAD, COLLAROY PLATEAU

# **DEMOLITION PLAN**

Project number

Drawn by

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ssue For Section 4.55	01.11.22	D
ssue for CC	12.10.22	С
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**PROJECT** LOT 83 PARKES ROAD, COLLAROY PLATEAU

# SUBDIVISION PLAN

Project number Date Drawn by


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# **PROJECT**

**CLIENT:** 

LOT 83 PARKES ROAD, COLLAROY PLATEAU

# TREE REMOVAL PLAN

Project number
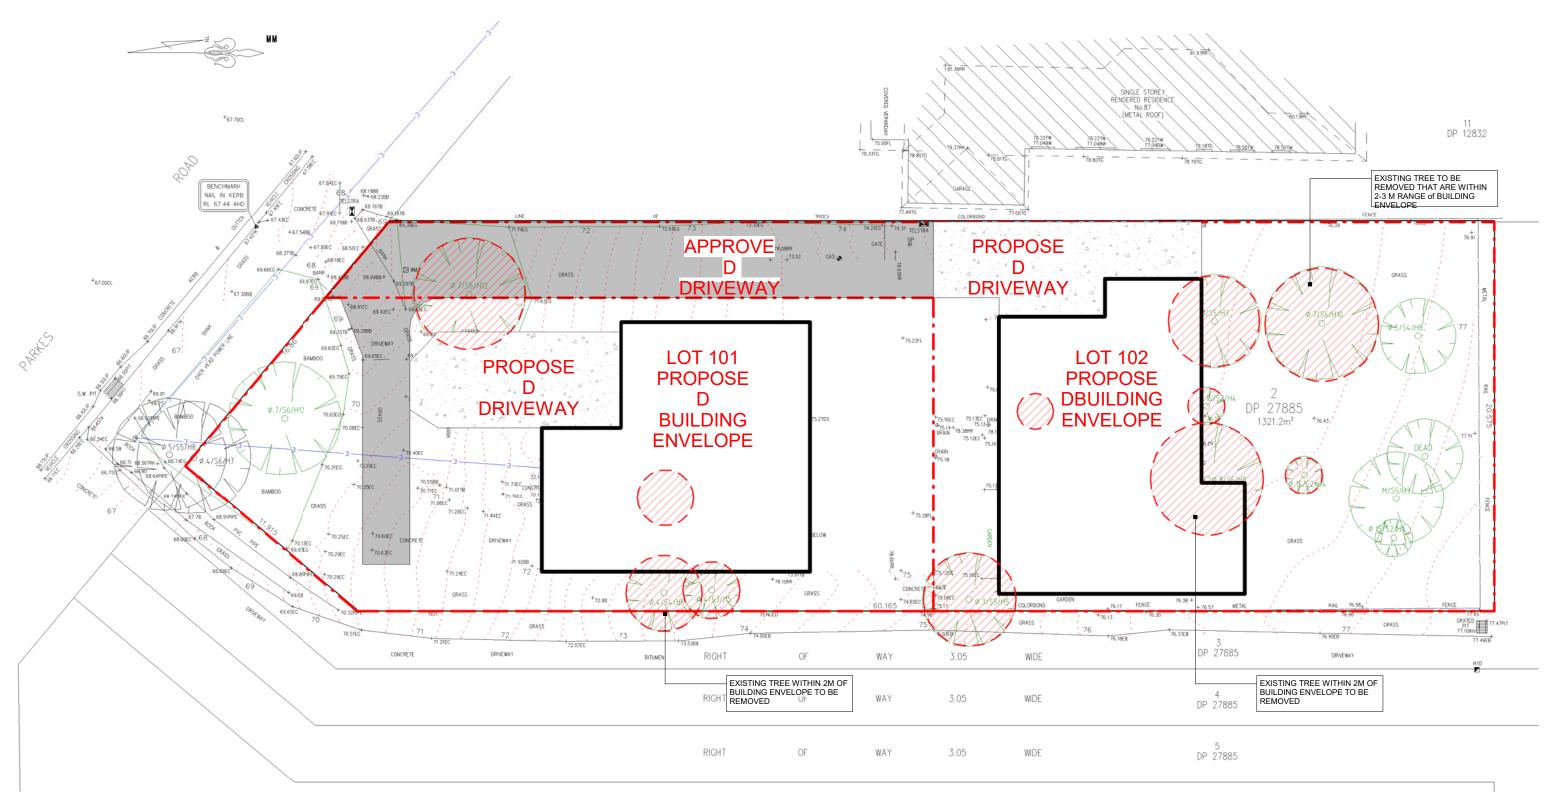
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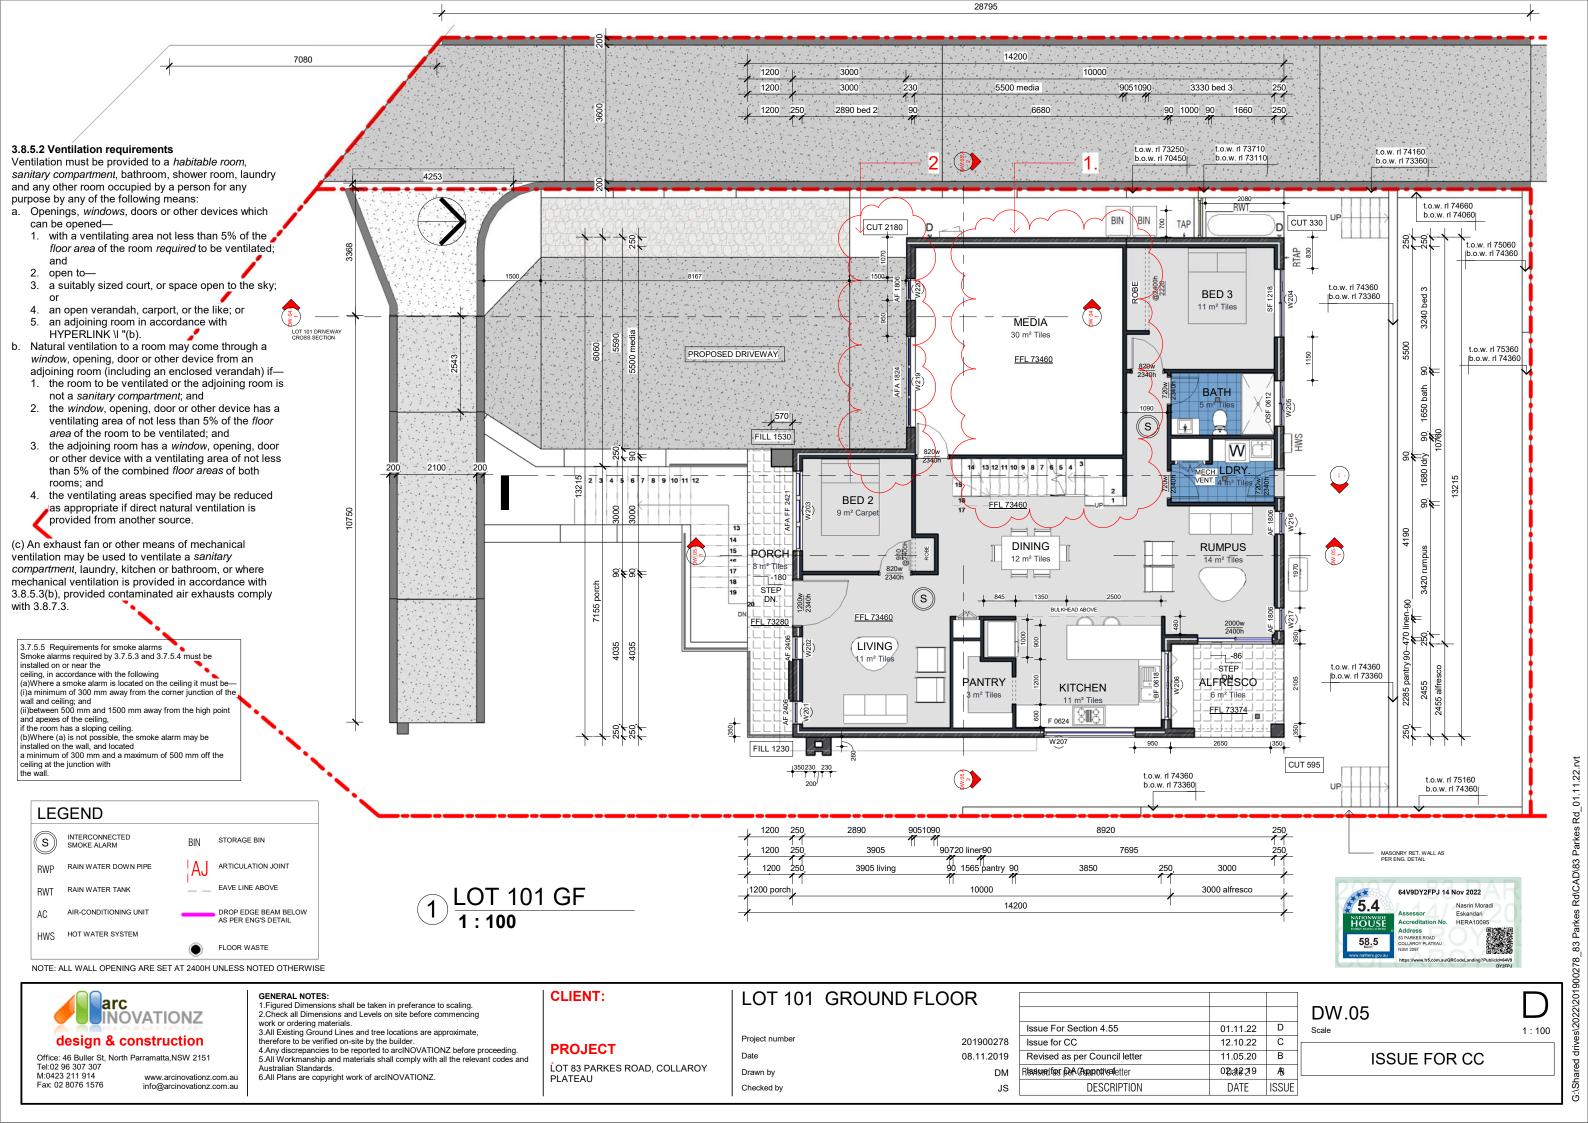
Issue For Section 4.55	01.11.22	D
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DESCRIPTION	DATE	ISSUE

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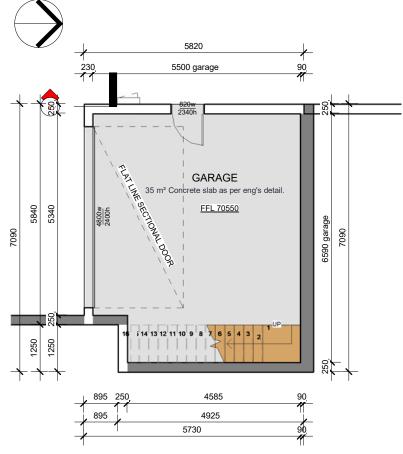
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2 LOT 101 Garage 1:100



Window Schedule unit 2				
Mark	Туре	Height	Width	Location
W201	AF 2406	2400	600	PORCH
W202	AF 2406	2400	600	PORCH
W203	AFA FF 2421	2400	2100	PORCH
W204	SF 1218	1200	1810	BED 3
W205	OSF 0612	600	1200	BATH
W206	BF 0618	600	1800	ALFRESCO
W207	F 0624	600	2400	KITCHEN
W208	AFA FF 2421	2400	2100	UPPER LIVING
W209	AFA 1824	1800	2400	M.BED
W210	AF 1806	1800	600	WIR
W211	OSF 0612	600	1200	ENS
W212	SF 0624	600	2400	BED 5
W213	SF 1224	1200	2400	BED 4
W214	OSF 1015	1000	1510	BATH
W216	AF 1806	1800	600	RUMPUS
W217	AF 1806	1800	600	RUMPUS
W218	SF 1224	1200	2400	BED 6
W219	AFA 1824	1800	2400	MEDIA
W220	AF 1806	1800	600	MEDIA

Door Schedule Copy 1					
Type	Height	Width	Location	Note	
ED 2424	2400	2400	UPPER LIVING	External Glaze	
ED 2424	2400	2400	UPPER LIVING	External Glaze	
ED 2420	2400	2000	RUMPUS	External Glaze	
Grand total: 3					

-TO BE CHEKED AND CONFIRMED BY BUILDER ON SITE BEFORE PLACING ORDER
-FALL PREVENTION FROM WINDOWS
-WINDOWS TO BE MANUFACTURED IN ACCORDANCE WITH REQUIREMENTS OF BCA CLAUSE 3.9.2.5

NOTE:


1-If Opening within 1700 mm above the floor;and climbable elements between 150 and 750 mm above the floor,Opening must be permanently restricted to 125 mm; or fitted with a non-removable robust screen. 2-If opening between 865 and 1700 mm above the floor;and no climbable

between 150 and 760 mm ablove the floor, Opening must be restricted to 125 mm; or fitted with a removable robust screen

3-If opening between 865 of the floor; and climbable elements between 150 and 760 mm ablove the floor, Opening must be permanently restricted to 125 mm; or fitted with a

non-removable robust screen
4-If no opening within 1700 mm of the floor.No restrictions apply

AWNING-FIXED AWNING-FIXED-AWNING FIXED FIXED CORNER FIXED-FIXED SLIDING-FIXED
SLIDING-FIXED
SLIDING-FIXED-BOTTOM
FIXED
SKYLIGHT
LOURVE NOTE: O:OBSECURE GLAZING WINDOW

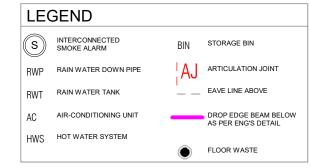

NOTE: ALL WALL OPENING ARE SET AT 2400H UNLESS NOTED OTHERWISE



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1 LOT 101 FF 1:100

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**PROJECT** LOT 83 PARKES ROAD, COLLAROY

Project number

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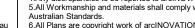
**LOT 101 FIRST FLOOR** 

201900278 08.11.2019 DM JS


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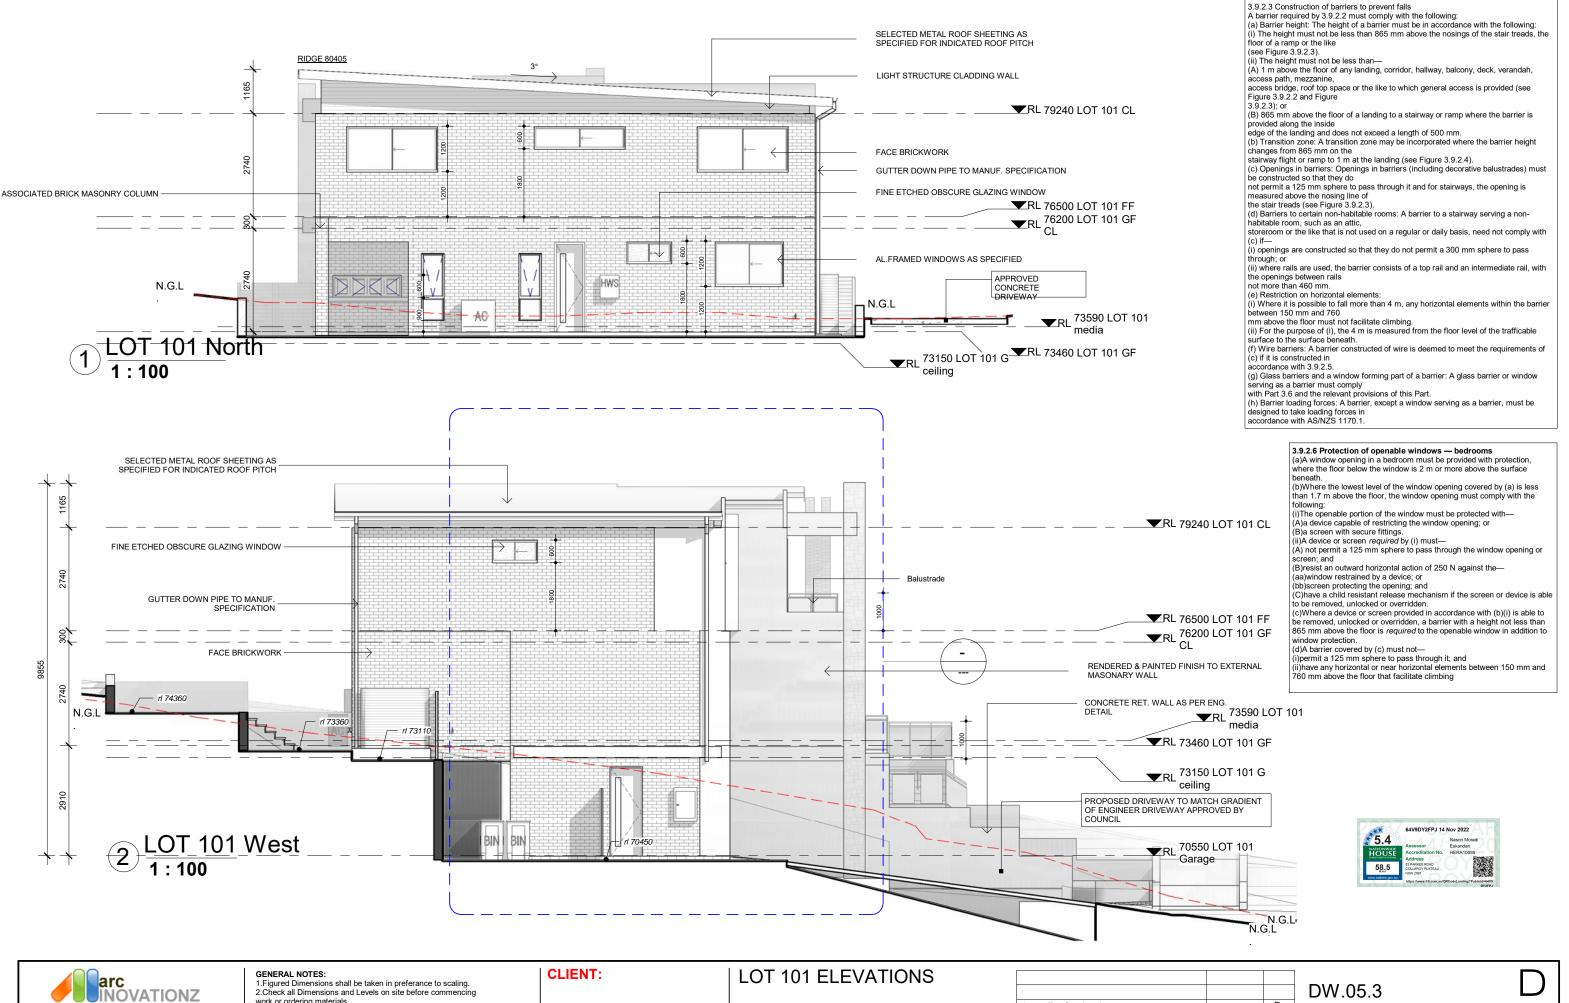
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LOT 83 PARKES ROAD, COLLAROY

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Issue for DA Approval

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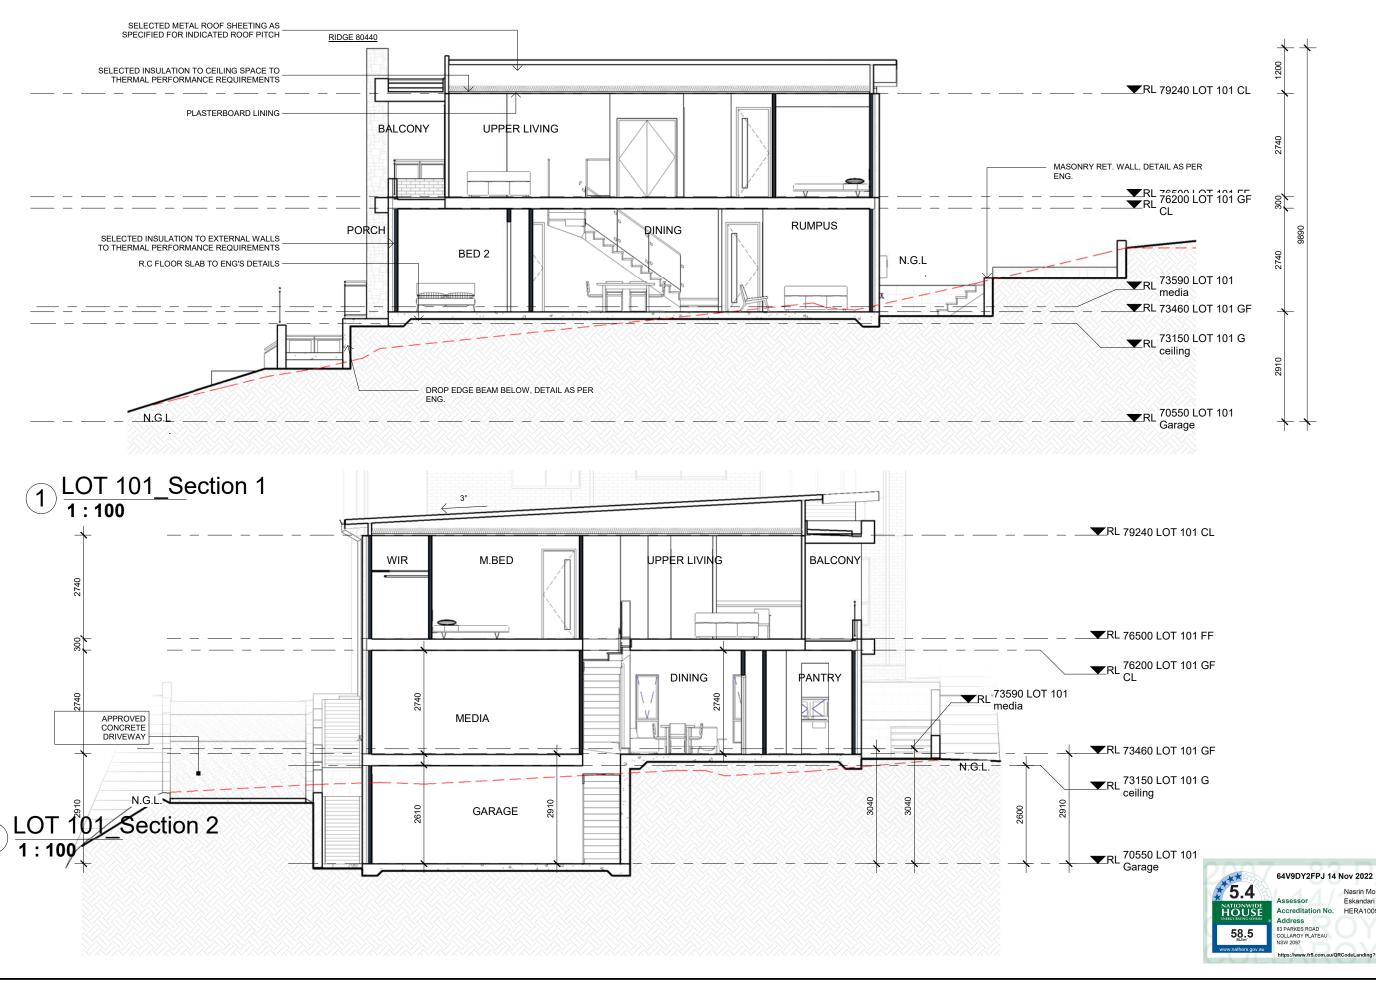
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#### **LOT 101 SECTIONS CLIENT:**

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LOT 83 PARKES ROAD, COLLAROY PLATEAU

Project number
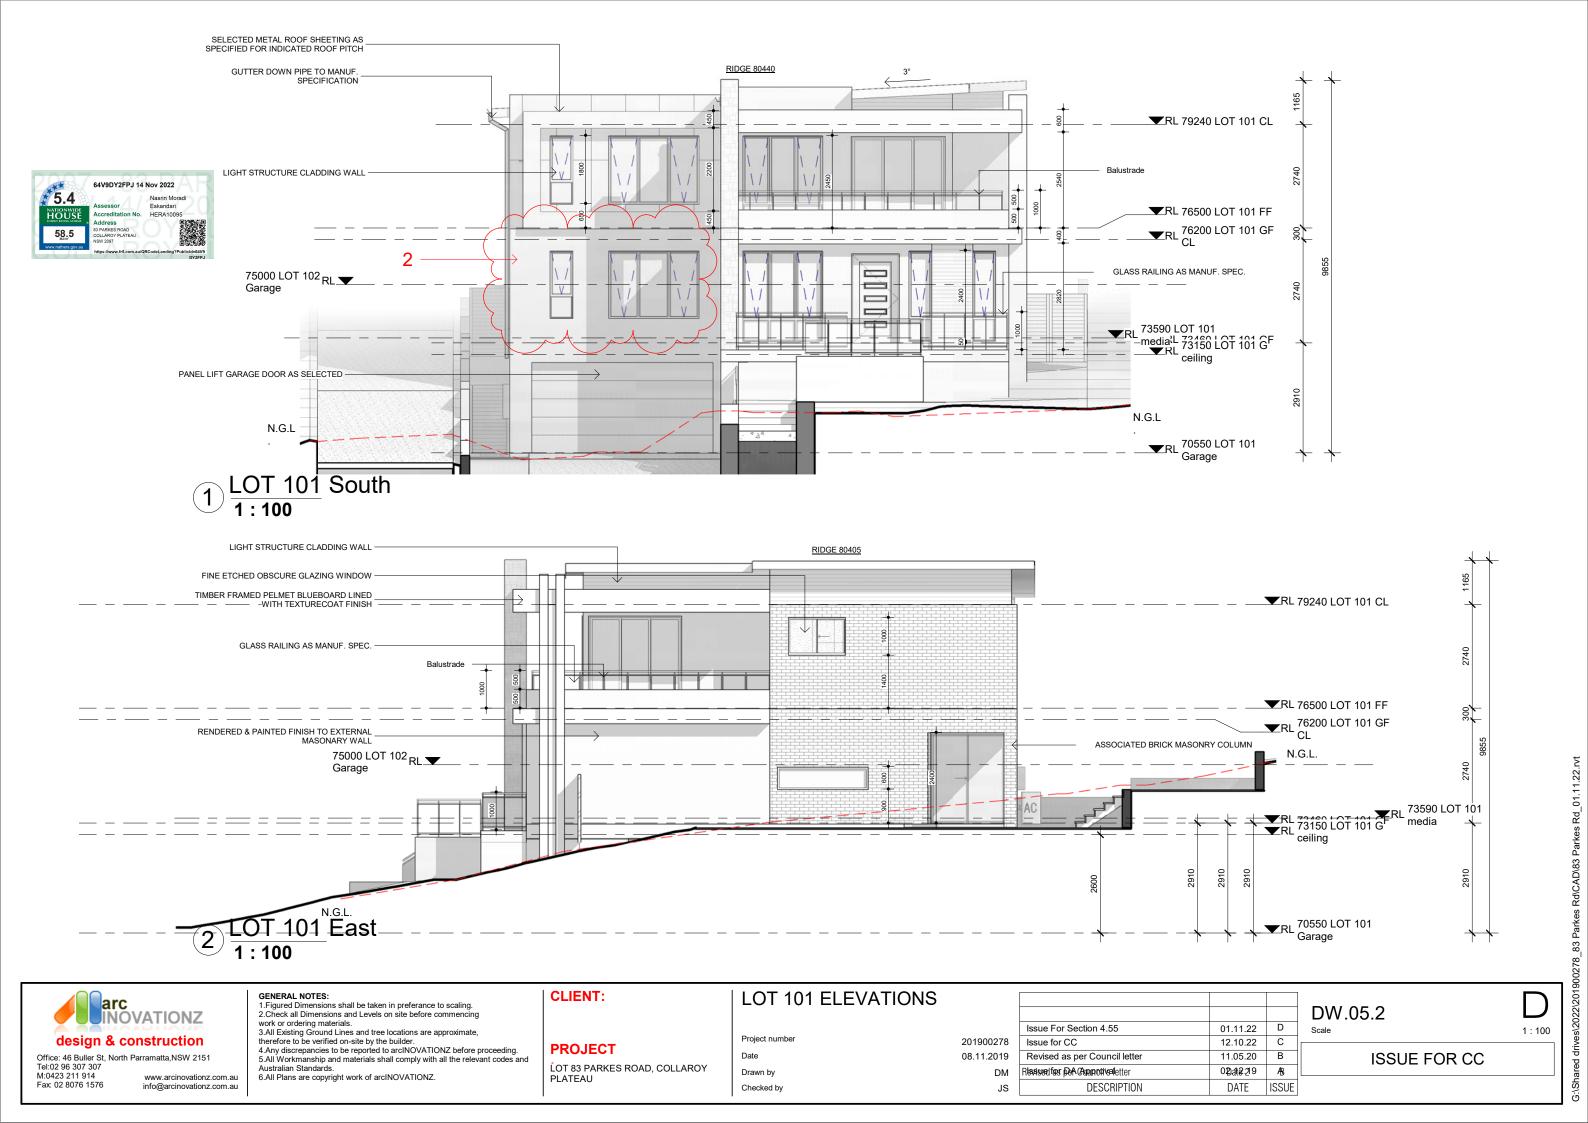
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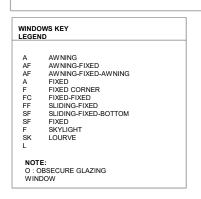
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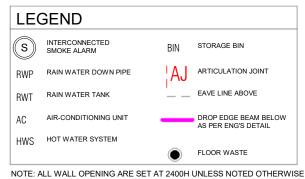
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201900278 08.11.2019 DM JS

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DW.06



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the floor area of the room required to be

room is not a sanitary compartment, and

has a ventilating area of not less than 5%

ventilating area of not less than 5% of the

combined *floor areas* of both rooms; and


reduced as appropriate if direct natural ventilation is provided from another

of the floor area of the room to be

opening, door or other device with a

the sky; or

ventilated: and

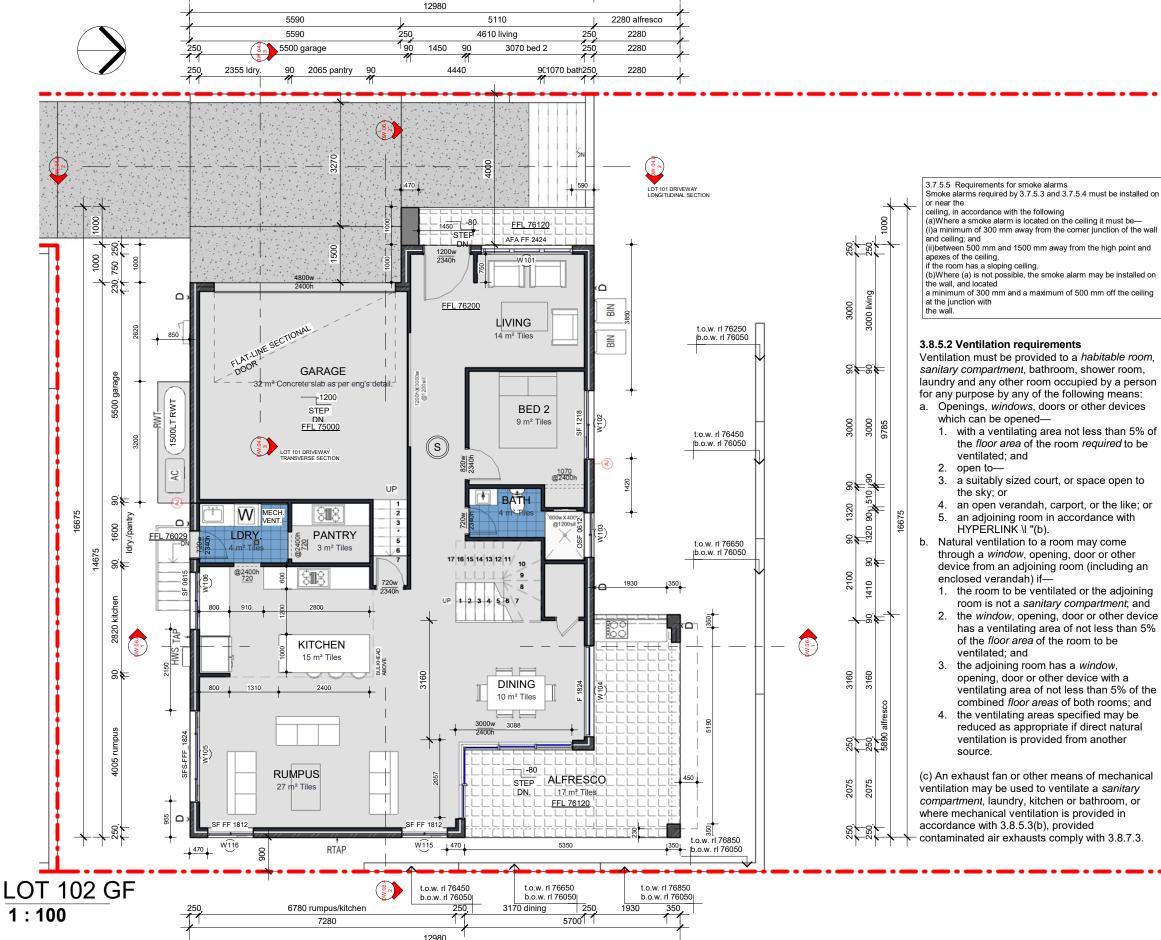

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As indicated

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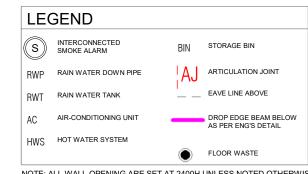
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GENERAL NOTES:



1 LOT 102 FF 1:100

NOTE: THE PRIVACY SCREEN SHALL BE OF FIXED PANELS OR LOUVER STYLE CONSTRUCTION (WITH A MAXIMUM SPACING OF 20MM)



NOTE: ALL WALL OPENING ARE SET AT 2400H UNLESS NOTED OTHERWISE



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#### LOT 102 FIRST FLOOR PLAN **CLIENT:**

Project number 201900278 **PROJECT** 08.11.2019 LOT 83 PARKES ROAD, COLLAROY Drawn by Checked by

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0278	Issue for CC	12.10.22	С
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(ii) The height must not be less than—
(A) 1 m above the floor of any landing, corridor, hallway, balcony, deck, verandah, access path, mezzanine.

access bridge, roof top space or the like to which general access is provided (see Figure 3.9.2.2 and Figure

3.9.2.3); or (B) 865 mm above the floor of a landing to a stairway or ramp where the barrier is provided along the inside edge of the landing and does not exceed a length of 500 mm.

(b) Transition zone: A transition zone may be incorporated where the barrier height

changes from 865 mm on the stairway flight or ramp to 1 m at the landing (see Figure 3.9.2.4). (c) Openings in barriers: Openings in barriers (including decorative balustrades) must be constructed so that they do

not permit a 125 mm sphere to pass through it and for stairways, the opening is measured above the nosing line of the stair treads (see Figure 3.9.2.3)

(d) Barriers to certain non-habitable rooms: A barrier to a stairway serving a non-

habitable room, such as an attic, storeroom or the like that is not used on a regular or daily basis, need not comply with

(i) openings are constructed so that they do not permit a 300 mm sphere to pass

through; or
(ii) where rails are used, the barrier consists of a top rail and an intermediate rail, with the openings between rails

not more than 460 mm. (e) Restriction on horizontal elements

(i) Where it is possible to fall more than 4 m, any horizontal elements within the barrier between 150 mm and 760 mm above the floor must not facilitate climbing

(ii) For the purpose of (i), the 4 m is measured from the floor level of the trafficable surface to the surface beneath.

(f) Wire barriers: A barrier constructed of wire is deemed to meet the requiren (c) if it is constructed in accordance with 3 9 2 5

(g) Glass barriers and a window forming part of a barrier: A glass barrier or window serving as a barrier must comply

with Part 3.6 and the relevant provisions of this Part.
(h) Barrier loading forces: A barrier, except a window serving as a barrier, must be designed to take loading forces in

accordance with AS/NZS 1170.1

3.9.2.6 Protection of openable windows — bedrooms

(a)A window opening in a bedroom must be provided with protection, where the floor below the window is 2 m or more above the surface beneath. (b)Where the lowest level of the window opening covered by (a) is less than 1.7 m above

the floor, the window opening must comply with the following:
(i)The openable portion of the window must be protected with—

(Á)a device capable of restricting the window opening; or

(B)a screen with secure fittings.

(ii)A device or screen required by (i) must-

(A) not permit a 125 mm sphere to pass through the window opening or screen; and (B)resist an outward horizontal action of 250 N against the—

(aa)window restrained by a device; or (bb)screen protecting the opening; and

(C)have a child resistant release mechanism if the screen or device is able to be removed


(c)Where a device or screen provided in accordance with (b)(i) is able to be removed,

unlocked or overridden, a barrier with a height not less than 865 mm above the floor is required to the openable window in addition to window protection.

(d)A barrier covered by (c) must not— (i)permit a 125 mm sphere to pass through it; and

(ii)have any horizontal or near horizontal elements between 150 mm and 760 mm above the floor that facilitate climbing

THE PRIVACY SCREEN SHALL BE OF FIXED PANELS OR LOUVER STYLE CONSTRUCTION (WITH A MAXIMUM SPACING OF 20MM)

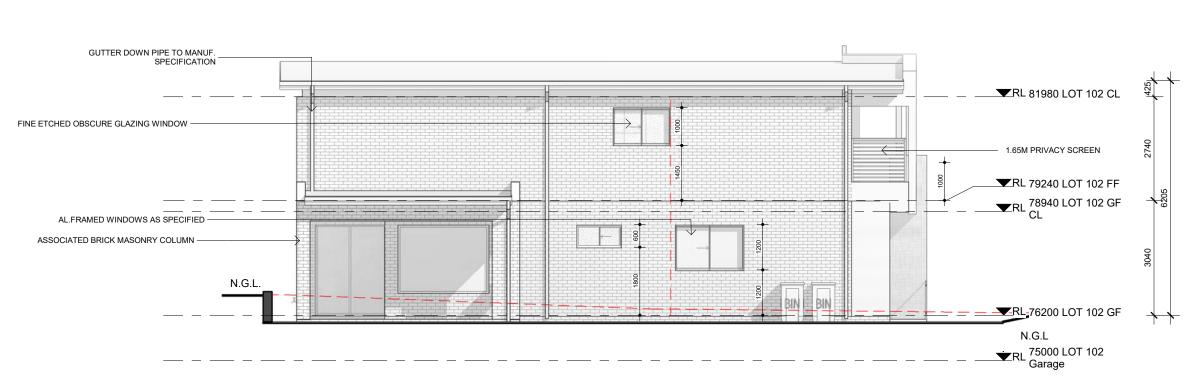

2  $\frac{\text{LOT 102 North}}{1:100}$ 

LOT 102 West 1 : 100

# arc INOVATIONZ design & construction

TIMBER FRAMED PELMET BLUEBOARD LINED

WITH TEXTURECOAT FINISH

GUTTER DOWN PIPE TO MANUF SPECIFICATION

1.65M PRIVACY SCREEN

AL. FRAMED STACKABLE SL/DOOR AS SPECIFIED

GLASS RAILING AS MANUF. SPEC.

N.G.L

ASSOCIATED BRICK MASONRY COLUMN

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### **CLIENT:**

**PROJECT** LOT 83 PARKES ROAD, COLLAROY

## **LOT 102 ELEVATIONS**

Project number 201900278 08.11.2019 Drawn by DM Checked by JS

SELECTED METAL ROOF SHEETING AS

SPECIFIED FOR INDICATED ROOF PITCH

RENDERED & PAINTED FINISH TO EXTERNAL

PANEL LIFT GARAGE DOOR AS SELECTED

MASONARY WALL

N.G.L

▼RL 81980 LOT 102 CL

▼RL 79240 LOT 102 FF

▼RL 76200 LOT 102 GF

75000 LOT 102 Garage

78940 LOT 102 GF


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### **CLIENT:**

# **PROJECT**

LOT 83 PARKES ROAD, COLLAROY

# **LOT 102 ELEVATIONS**

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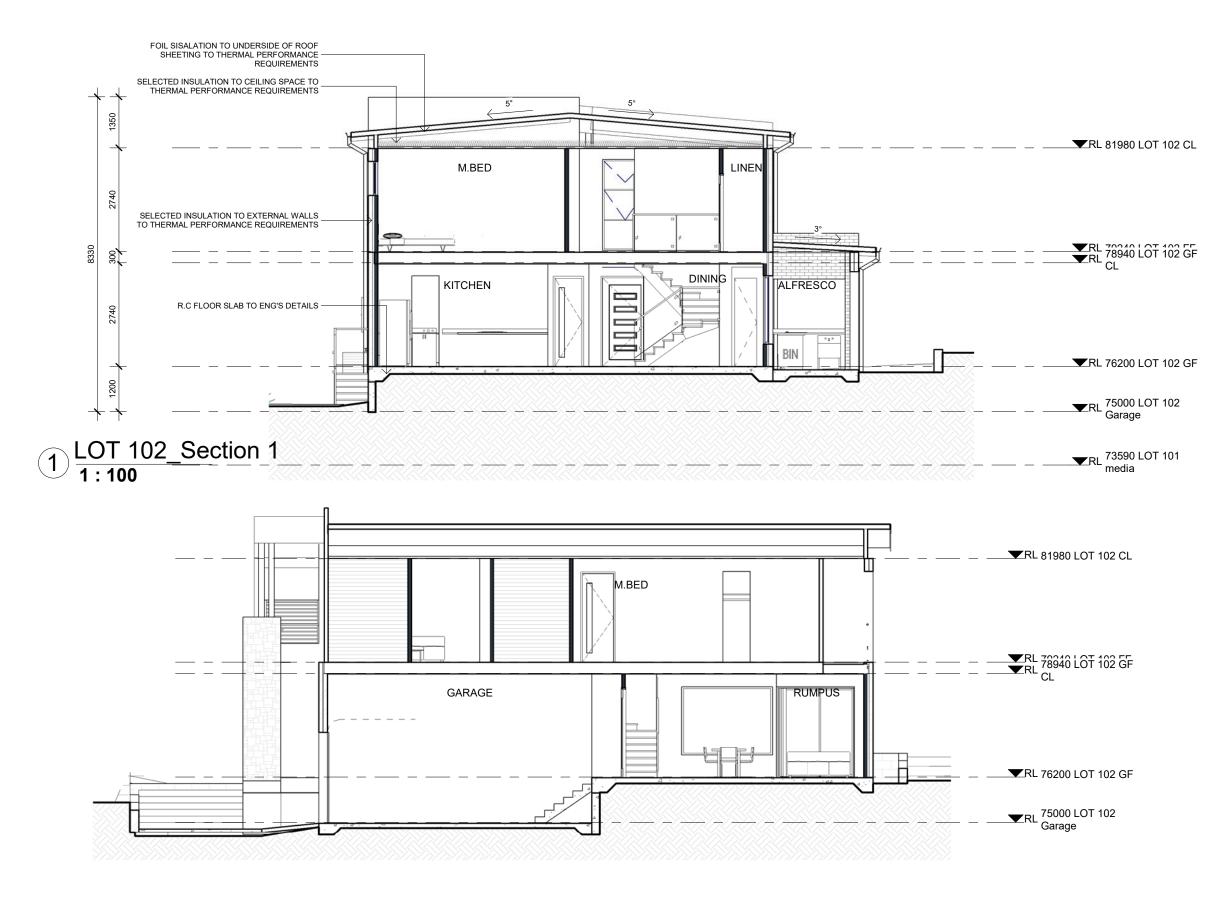
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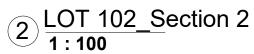
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**CLIENT:** 
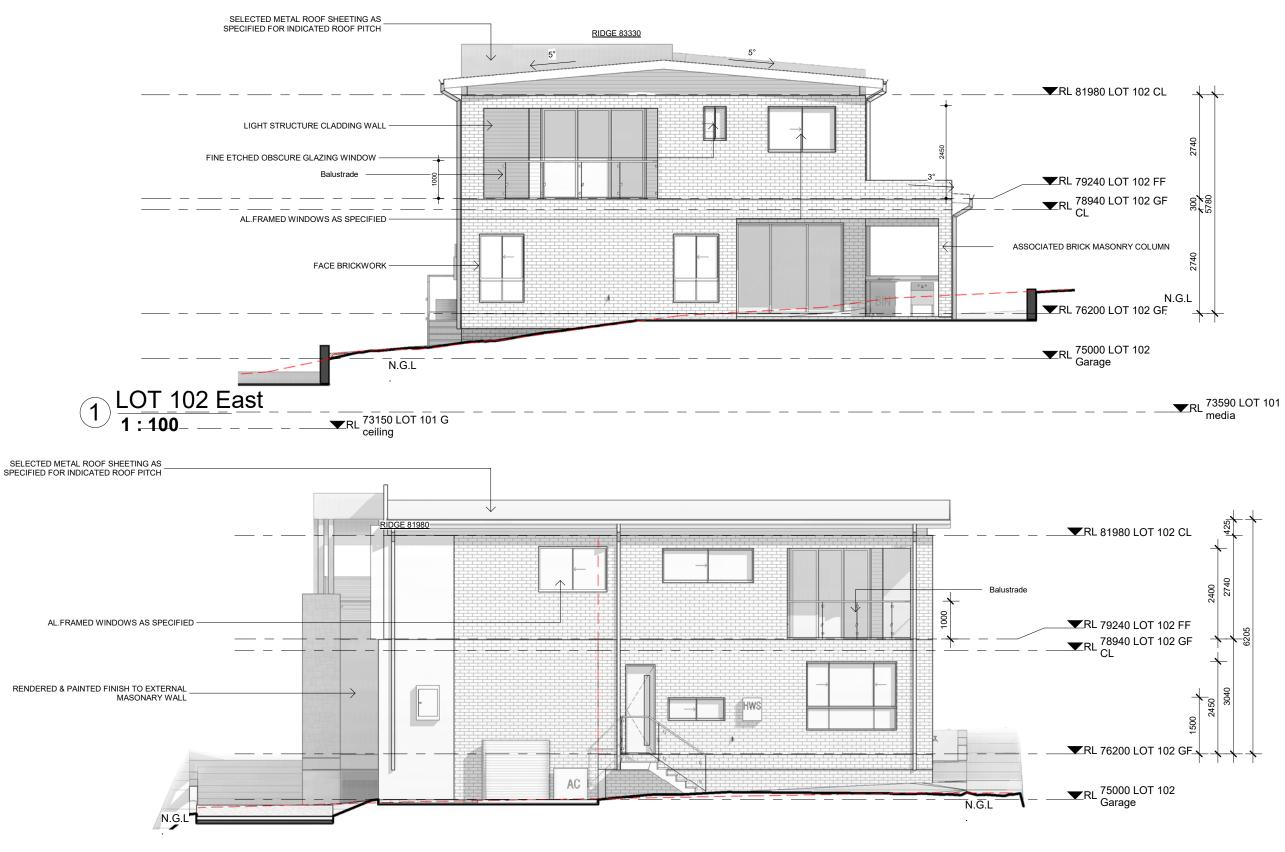
# **LOT 102 SECTIONS**

Project number

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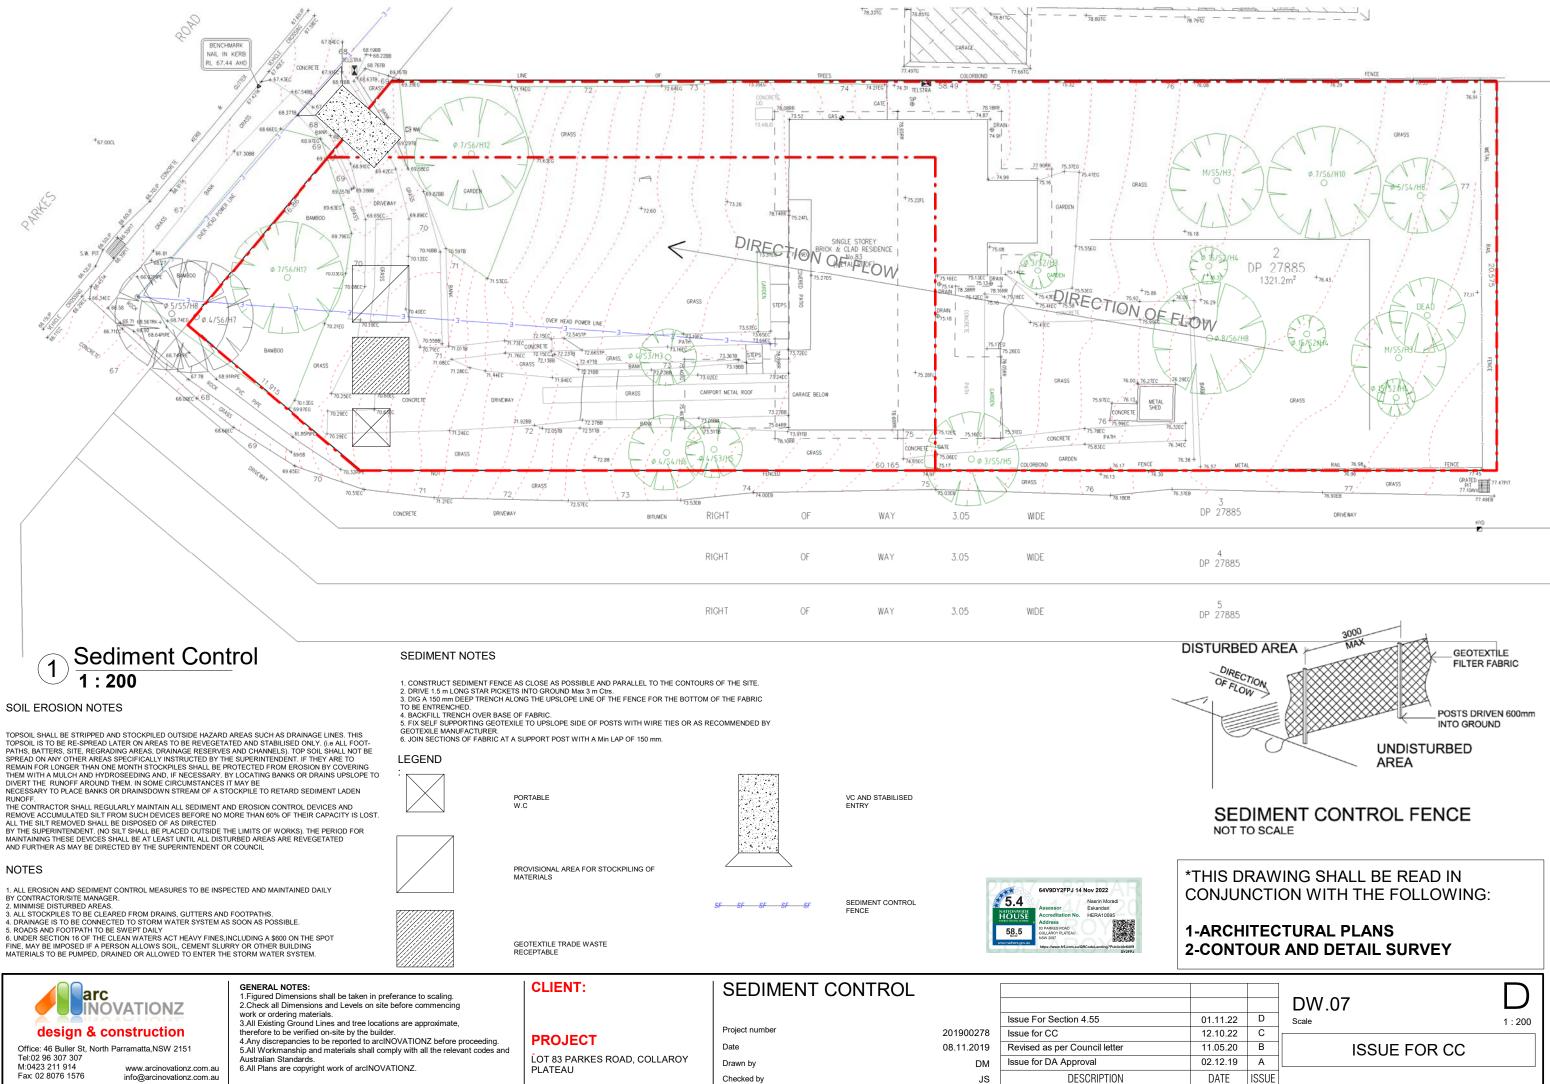
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## **CLIENT:**

**PROJECT** LOT 83 PARKES ROAD, COLLAROY PLATEAU

# SHADOW DIAGRAM

Project number Date

Drawn by

Checked by

201900278 08.11.2019


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LOT 83 PARKES ROAD, COLLAROY PLATEAU

**CLIENT:** 

**PROJECT** 

# SHADOW DIAGRAM

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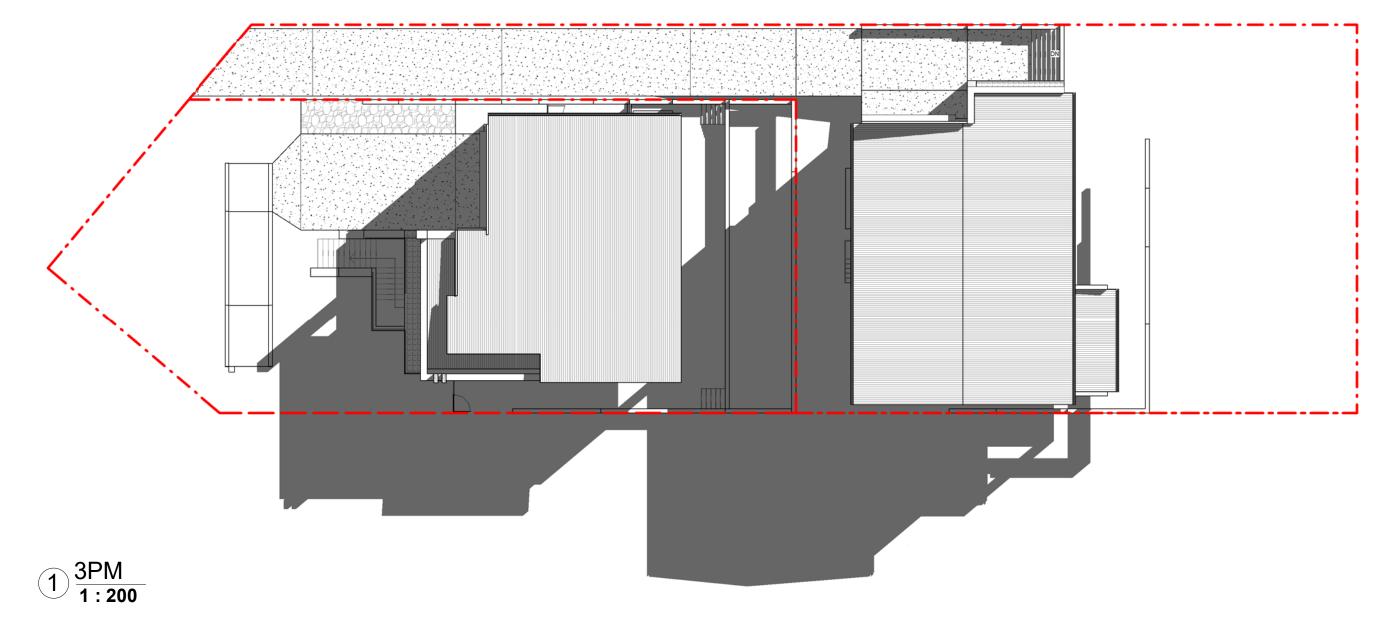
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**CLIENT:** 

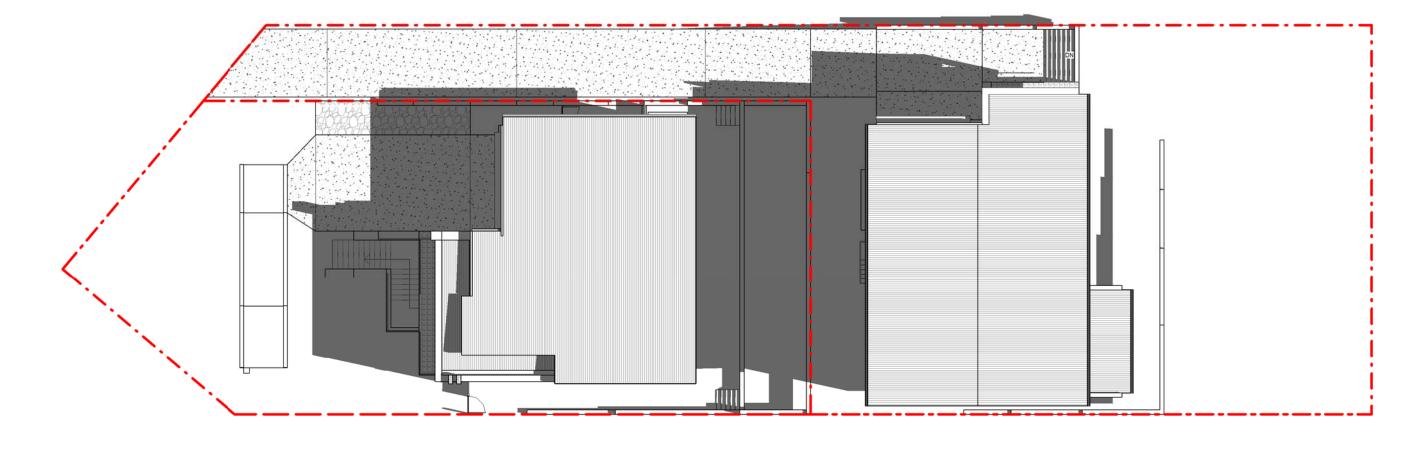**PROJECT** 

# SHADOW DIAGRAM

Project number

Drawn by Checked by 201900278 08.11.2019 Author Checker

Issue For Section 4.55	01.11.22	D
Issue for CC	12.10.22	С
Revised as per Council letter	11.05.20	В
Issue for DA Approval	02.12.19	Α
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DW.08.2


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ISSUE FOR CC

LOT 83 PARKES ROAD, COLLAROY PLATEAU



# **Planting Schedule** POT SIZE CODE **BOTANICAL NAME** | M.Ht QTY **IMAGE** Crepe Myrtle - 4m Lilly Pily- 1.4m

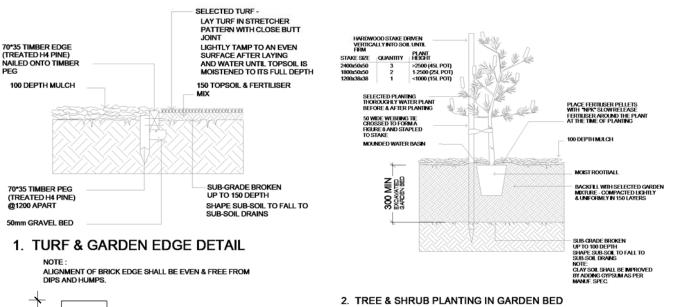

EXCAVATE/ GRADE AREAS TO BE TURFED TO 120MM BELOW THE REQUIRED FINISHED LEVELS. DO NOT EXCAVATE WITH 1500MM

ANY EXISTING TREE TO BE RETAINED. ENSURE THAT ALL OF THE SURFACE WATER RUNOFF IS TO BE DIRECTED TOWARDS THE INLET PITS, KERBS ETC. AD AWAY FROM BUILDINGS. ENSURE THAT NO POOLING OR PONDING WILL OCCUR. RIP SUBGRADE TO 150MM DEEP. INSTALL 100MM DEPTH OF IMPORTED TOPSOIL.
JUST PRIOR TO SPREADING TURF. SPREAD 'SHIRLEYS NO. 17 LAWN FERTILISER' OVER THE TOPSOIL AT THE RECOMMENED RATE. LAY SIR WALTER BUFFALO TURF ROLLS CLOSELY BUTTED. FILL ANY SMALL GAPS WITH TOPSOIL. WATER THOROUGHLY.

STABILISED CRUSHED SANDSTONE PATH TO BE CRUSHED SANDSTONE OVER WEEDMAT TO DEPTH OF 50MM. STABILSED WITH 5% CEMENT.

TIMBER EDGING TREATED HARDWOOD EDGING. THE EDGES ARE TO BE LAID IN EVEN CURVES AND STRAIGHT LINES AS INDICATED ON

THE PLAN. WHERE TIGHT CURVES ARE SHOWN SCORE TIMBER TO ACHIEVE MORE EVEN CURVES. THE TOP OF THE EDGE IS TO FINISH FLUSH WIH THE ADJACENT TURF AND

PLANTING AREAS ENSURE THAT THE MASS PLANTING AREAS HAVE BEEN EXCAVATED TO 300MM BELOW FINISHED LEVELS. RIP TO A FURTHER DEPTH OF 150MM. SUPPLY AND INSTALL 300MM SOIL MIX IF REQUIRED OR IMPROVE EXISTING SOIL WITH COMPOST BLEND. SOIL MIX TO COMPRISE OF ONE PART APPROVED COMPOST TO THREE PARTS TOP SOIL. TOPSOIL SHALL BE EITHER IMPORTED TOPSOIL OR STOCKPILED SITE TOPSOIL (IF SUITABLE IE. NO CLAY). INSTALL 75MM OF SELECTED MULCH. MULCH TO BE ANL 'FOREST BLEND'.



# arc INOVATIONZ design & construction

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www.arcinovationz.com.au Fax: 02 8076 1576 info@arcinovationz.com.au

#### GENERAL NOTES:

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- work of ordering interestals.

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### **CLIENT:**

# **PROJECT**

LOT 83 PARKES ROAD, COLLAROY

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Letter Box Detail

## LANDSCAPE PLAN

Project number

Date Drawn by Checked by 201900278 08.11.2019 DM JS

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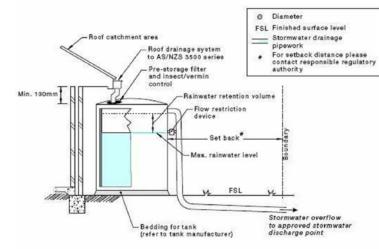
RAIN WATER PIPE

RAIN WATER TANK

ROOF PITCH TO DIRECTION

ALL OTHER SURFACE WATERS TO BE STRICTLY CONNECTED TO A SEPARATE SYSTEM IN ACCORDANCE WITH AS 3500:.3:2003 AND BCA PART 3.1.2.3.

RAINWATER TANKS WITH PUMPS TO SUPPLY GARDEN TAPS AND INTERNAL RE-USE AS PER BASIX ASSESSMENT





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**PROJECT** LOT 83 PARKES ROAD, COLLAROY

# STORMWATER CONCEPT

Checked by

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В	Issue for CC	12.10.22	С
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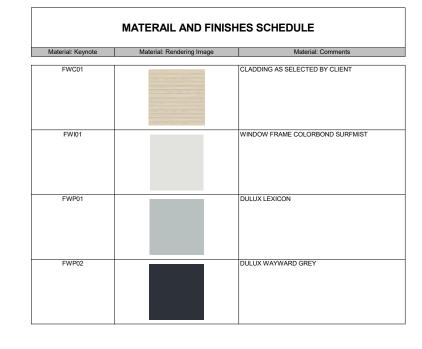
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1:200 **ISSUE FOR CC** 

Project number 201900278 08.11.2019 DM Drawn by JS



Material: Keynote	Material: Rendering Image	Material: Comments
FR01		COLORBOND ROOF CUSTOM ORB PROFILE
FR06		DOWNPIPE COLORBOND SURFMIST
FSD01		COLORTHROUGH CONCRETE DRIVEWAY
FWB01		AUSTRAL BRICK WILDERNESS DESIGN BLACKBU





F\_LOT 101 East 1:200











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Australian Standards.
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**CLIENT:** 

**PROJECT** 

LOT 83 PARKES ROAD, COLLAROY

# **LOT 101 FINISHES SCHEDULE**

Project number

Date Drawn by

Checked by

201900278 08.11.2019 Author Checker

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MATERAIL AND FINISHES SCHEDULE







1  $\frac{F\_LOT\ 102\ East}{1:200}$ 



F\_LOT 102 West 1 : 200

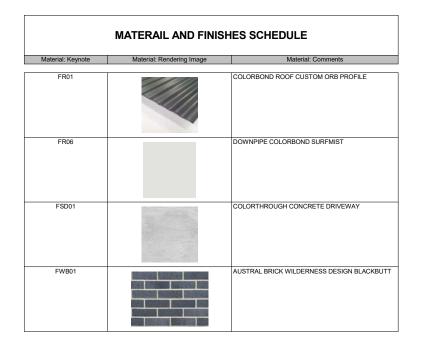

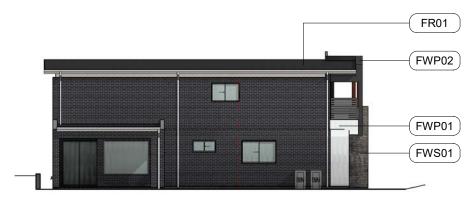

2 F\_LOT 102 North



F\_LOT 102 South 1:200





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**PROJECT** 

LOT 83 PARKES ROAD, COLLAROY

**LOT 102 FINISHES SCHEDULE** 

Project number

Date Drawn by

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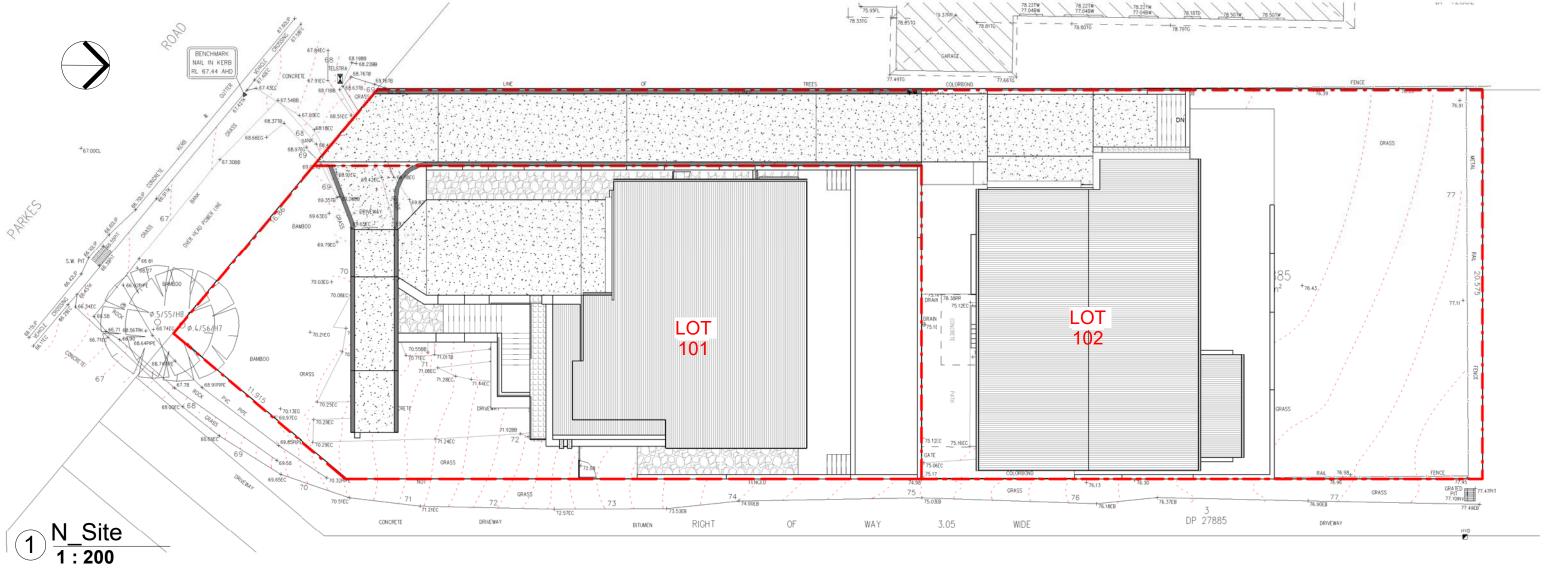
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## **CLIENT:**

**PROJECT** LOT 83 PARKES ROAD, COLLAROY PLATEAU

# **NOTIFICATION SITE PLAN**

Project number 201900278 Date 08.11.2019 Drawn by DM Checked by JS

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