

22nd April 2005

Pittwater Council PO Box 882 Mona Vale NSW 1660

Dear Sir/Madam,

Re: Development Application No.N0972/03

Our Construction Certificate No 105/2005-Premises: No 3a Dygal Street, Mona Vale

Please find attached a copy of the following:-

• Construction Certificate, stamped approved plans and relevant documentation.

• Notice to Commence Building Work.

• Appointment of a Principal Certifying Authority.

In accordance with the regulations we have enclosed a cheque for the sum of \$30.00 for the submission of the Part 4A certificate.

Should you have any further enquiries please do not hesitate to contact us and we will be pleased to assist you.

NB:(Please forward receipt for the above \$30.00 fee to The Certification Group P/L. PO Box 870 Narrabeen NSW 2101)

Yours faithfully,

Wayne Treble- Director

The Certification Group P/L

R 165959

Pittwater Council

OFFICIAL RECEIPT

22/04/2005 Receipt No 165959

To THE CERTIFICATION GROUP

PO BOX 870 NARRABEEN

Applic Reference

GL Re	PRVC-Priv 1 X DAN0972/03	\$30.00
То	tal:	\$30.00
	Amounts Tendered Cash	\$0.00

Amount

Amounts	Tendered	
Cash		\$0.00
Cheque		\$30.00
Card		\$0.00
Money Order		\$0,00
Agency Rec		\$0.00
Total		\$30.00
Rounding		\$0.00
Change		\$0.(X)
Nett		\$30,00

Printed 22/04/2005 4:47:09 Cashier GHill



CONSTRUCTION CERTIFICATE DETERMINATION

Issued under the Environmental Planning and Assessment Act 1979 Section 109C (1) (b), 81A (2) and 81A (4)

CONSTRUCTION CERTIFICATE NO:

105/2005

DETERMINATION

Decision:

Approved

Date of Decision:

22/04/2005

SUBJECT LAND

Address:

No 3a Dygal Street, Mona Vale

Lot No, DP:

Lot 3, DP 217045

DESCRIPTION OF DEVELOPMENT

Demolition of the existing dwelling and construction of two detached dwellings.

detached

APPLICANT

Name:

Tom Mclean

Address:

No 3a Dygal Street, Mona Vale

Contact Number: (tel)

tel 9913 7407

OWNER

Name:

Mrs A McLean & Mrs L Porter

Address:

No 3a Dygal Street, Mona Vale

Contact Number: (tel)

tel 9913 7407

PLANS AND SPECIFICATIONS

The development is to be carried out in compliance with the following plans and documentation listed below and endorsed with "The Certification Group" stamp.

DRAWING NUMBER

DATE

Architectural plans No CC-01 Issue B dated March 2005, CC-02 Issue A dated January 2005, CC-03 Issue A dated January 2005, prepared by Sean Gartner Architects.

Structural plans No S01 dated Nov 2004, S02 Rev B dated February 2005, S03, S04, S05, S06, S07, S08, S09, S10 dated November 2004, prepared by Northern Beaches Consulting

Engineers. P/L

Date as indicated with drawing number.

28 Cook Terrace Mona Vale NSW 2103 . PO Box 870 Narrabeen NSW 2101 tel 9944 8222 . fax 9944 6330 . email: info@thecgroup.com.au . www.thecgroup.com.au . acn 111 092 632

Stormwater plans No D01 Revision A dated February 2005, D02 dated November 2004,	Date as indicated with
prepared by Northern Beaches Consulting Engineers. P/L	drawing number.

ATTACHMENTS

Landscape plan No L01A, prepared by Landscapes Landscape Architecture.	19 January 2005
Landscape Architects certificate, certifying Landscape plan	15 February 2005
Footpath plans No CC-04 Issue D, CC-05 Issue A, prepared by Sean Gartner Architects.	January 2005
Pittwater Council letter advising Development consent is operative.	4 January 2005
Sydney Water Notice of Requirements. (Case Number 74928)	22 February 2005
Equibuilt Consultant Access certificate, certifying access requirements.	14 December 2004
Pittwater Council Deed of Agreement - Coloured Concrete Driveways.	1 February 2005
Pittwater Council approved access driveway profile.	20 January 2005
Sydney Water Quick Check Stamp	23 December 2005
Sean Gartner Architects certificate certifying internal driveway.	28 February 2005
Northern Beaches Engineers P/L certificate certifying compliance with condition B19 & B29	4 March 2005
Northern Beaches Engineers P/L certificate certifying stormwater plans.	January 2005
Construction Certificate Application Form	15 December 2004_
Section 94 Contributions receipt	4 April 2005
Long Service Levy Receipt	4 April 2005

CERTIFICATE

I certify that the work if completed in acco 581A (5) of the Environmental Planning and	rdance with these plans and specifications will comply with the requirements of Assessment Act 1979.		
SIGNATURE	A A A DD 300F		
DATE OF ENDORSEMENT	2 2 APR 2005		
CERTIFICATE NO	105/2005		
CERTIFYING AUTHORITY			
Name of Certifying Authority	THE CERTIFICATION GROUP P/L		
Name of Accredited Certifier	Wayne Treble		
Registration No	P0100 - Dept of Infrastructure, Planning & Natural Resources		
Contact No	PH (02) 9944 8222, FAX (02) 9944 6330		
Address	PO BOX 870 NARRABEEN NSW 2101		

DEVELOPMENT CONSENT

Pittwater Council **Development Consent No** N0972/03 Date of Determination No 4 January 2005

BUILDING CODE OF AUSTRALIA CLASSIFICATION

1a

Pittwater Council

OFFICIAL RECEIPT

04/04/2005 | Receipt No 164969

TO T N & A MCLEAN

Applic	Reference	Amount
GL. Re	QLSL-Buil	\$1,187.10
GL Re	NO972/03 SCSF- S94	\$877.00
GL Re	N0972/03 SLEL-594	\$875.00
Spr Barrier 1 1 1 2 2	N0972/03 SOPS-S94	\$4,906.00
GL Re	N0972/03	

Total:	\$7,845.10
Amounts	Tendered
Cash	\$0.00
Cheque	\$7,845.10
Card	\$0.00
Money Order	\$0.00
Agency Rec	\$0.00
Total	\$7,845.10 \$0.00
Rounding	\$0.00
Change	\$7,845.10
Nett	#/, B#3.10

Printed 04/04/2005 9:23:18 Cashier GHill P1/04 2005 15:25 PAX 1800 303 737

VERO INSURANCE LIMITED

Ø 006



Residential Construction Warranty

Certificate of Insurance

Addo Constructions Pty Ltd
PO Box 995
CROWS NEST NEW SOUTH WALES 2085

COUNCIL COPY

Form 1 Section 92 Home Building Act 1989

CERTIFICATE IN RESPECT OF INSURANCE

Local Authority's Copy

Curtificate No: RCW71779043

issue Date:

20/04/2005

Contract Of Incurance Compiles With: Section 92

Of The: Home Building Act 1/389

leaued By: Vero Insurance Limited

ABN 48 006 297 1107

Building Contract Details

Contract Data: April 08, 2005

Declared Building Contract Value: \$596,627.00

(Refer policy for indemnity simil)

Carried Out By: Addo Constructions Pty Ltd

ABN: 46001044391 .

Licence No: 9884

For: Thomas Notman McLean

In Respect Of: Single Dwelling

At: House No. 3A/1

Dygal Street

MONA VALENEW SOUTH WALES 2103

Permit Authority: Pittwater Council

Subject to the Act, the Home Building Requision 1897 and the conditions of the insurance continut, cover will be provided to a beneficiary described in the contract and excourages in the title to the beneficiary. Please note when the insurer has been distinct this cartificate, the insurance is not entitied to refuse to pay a claim, or to cancil the insurance contract on the grounds that the previous was not paid. This cartificate is to be read it conjunction with the policy wording.

N XXJT768UAWY

Printed 21/04/2006

Signed for and on behalf of the insurer:

Insurer: Vero Insurence Limited ABN 48 005 297 807

Vivo Consequention and Engladering is a division of Verb Instrumes Limited. Vadda 1711 11/03 \$1/04 2005 15:25 FAX 1800 303 737

VERO INSURANCE LIMITED

20005



Residential Construction Warranty

Certificate of Insurance

Adco Constructions Pty Ltd PO Box 996 CROWS NEST NEW BOUTH WALES 2065 **COUNCIL COPY**

Form 1 Bection 92 Home Building Act 1989

Local Authority's Copy

issue Date:

20/04/2005

Certificate No: RCW71779027

CERTIFICATE IN RESPECT OF INSURANCE

Contract Of Insurance Campiles With: Section 92

Of This: Home Building Act 1989

leased By: Vero Insurance Limited

ABN 48 005 297 807

Building Contract Details

Contract Date: April 08, 2005

Declared Building Contract Value: \$598,627.00

(Refer policy for Indemnity limit)

Carried Out By: Adop Constructions Pty Ltd

ABN: 46001044391

Licence No: 9864

For: Thomas Notman MoLean

in Respect Of: Single Dwelling

At: House No. 3A/2

Dypai Street

MONA VALE NEW SOUTH WALES 2103

Permit Authority: Pithwater Council

Subject to the Apt, the Home Building Regulation 1887 and the conditions of the insurance contra-provided to a beneficiary described in the confecol and numbers in the life to the beneficiary. P flucture has benefic the conditions, the insurer is not criticals to refuse to pay a Hairs, or is calculated on the grounds that the premium was not poid. This certificate is to be read in confunction with if

N ROBSFP2146VC


Printed 21/04/2006

Signed for and on behalf of the insurer:



Insurer: Verb Insurance Limited, ABN 48-005-297-907

Very Constitution and Engineering is a division of Very Insurance Limited. VASCA RTS: 11/03

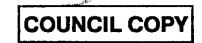

Units 9, 11 & 12/ 5 Vuko Place WARRIEWOOD NSW 2102 Avalon Customer Service Centre 59A Old Barrenjoey Road, AVALON 2107 Postal Address P.O. Box 882 MONA VALE NSW 1660 DX 9018MONA VALE Telephone (02)9970 1111
Facsimile (02) 9970 7150
Internet www.pittwaterlga.com.au
Email: pittwater_council@pittwater.nsw.gov.au

Amy Webb, Development Officer 8am to 6pm Mon - Thurs, 8am to 5pm Fri Phone 9970 1154

4 January 2004

Alan Blackmore Sean Gartner Architects PO Box 1122 MONA VALE NSW 1660

Dear Mr Blackmore

Re: Deferred Commencement Conditions – Development Application No. N00972/03 3A Dygal Street, Mona Vale

Please be advised that pursuant to Regulation 95(5) of the Environmental Planning and Assessment Regulation 2000, Council considers the details provided in accordance with deferred commencement Conditions 1.1, 1.2, 1.3, 1.4, 1.5 contained in Part 1 of the conditions of Development Consent are satisfactory. The following documentation therefore forms part of the consent documentation:

 Plan Numbers DA05 Issue C and DA06 both dated December 2004 prepared by Sean Gartner Architects.

In this regard, the Consent becomes operative from the date of this letter, subject to the conditions listed in Part 2 of the Consent.

Yours faithfully

Amy Webb

DEVELOPMENT OFFICER

THE CERTIFICATION GROUP PTY LTD
APPROVED CONSTRUCTION CERTIFICATE
DOCUMENTATION.



15 February, 2005

To whom it may concern,

Re: JA DYGAL STREET, MONA VALE

DA NO972/03

I, Lia Skountzos, am a qualified landscape architect and certify that the Landscape Plan (Dwg. No.L01) by Zenscapes Landscape Architects for the above Development Application has been prepared in accordance with Pittwater Council's DCP 23 – Landscape & Vegetation Management and complies with Clause 845 of the Conditions of Development Consent.

If you should have any queries, please contact myself on 0414 851 357.

Yours sincerely.

Lia Skountzos AAILA





Michael Frost & Associates c/- Greg Houston Plumbing P/L Case Number: 74928

Dear Applicant

NOTICE OF REQUIREMENTS

SECTION 73 SUBDIVIDER/DEVELOPER COMPLIANCE CERTIFICATE (Sydney Water Act 1994, Part 6, Division 9)

Developer:

Michael Frost & Associates

Your reference:

D0029

Development:

3A Dygal Street Mona Valc (lot 3 DP 217045)

Consent No:

N0972/03 by Pittwater Council of 22 November 2004.

Your application:

22 February 2005

Your attention is drawn to the requirements in this Notice that must be met before a Section 73 Subdivider/ Developer Compliance Certificate (the Certificate) can be issued. This Notice is given by Sydney Water on 1 March 2005, and the requirements are to apply for a year from that date after which the requirements will be updated on reapplication.

You must engage your current or another authorised Water Servicing Coordinator (the Coordinator) to manage and facilitate the construction of the sewer works that you must provide, at your cost, to service your development.

For a list of authorised Coordinators, see www.sydneywater.com.au and refer to Developing Your Land under Building Developing and Plumbing, or call 13 20 92. Coordinators may provide you with a quote or advice regarding costs for their and other supplier's services/ works as well as other

The Coordinator will generally be the single point of contact between you and Sydney Water and can answer any questions in the first instance you may have on Sydney Water's developer process and

SUMMARY OF REQUIREMENTS TO OBTAIN A CERTIFICATE:

You must:

- I. Note water service requirements for your development.
- 2. Engage a Coordinator prior to signing the enclosed Agreement.
- 3. Sign both copies of the enclosed Minor Works Agreement and lodge with a Water Servicing
- 4. Consequent to signing the Agreement, build sewer works required at your cost and pay

THE CERTIFICATION GROUP PTY LTD APPROVED CONSTRUCTION CERTIFICATE DOCUMENTATION.

- 5. Pay a total of \$7,733 for the charges identified in Section 5 of this notice. Please note:
 - The Developer Charges total will need to be paid before you will be given permission to construct the sewer works and councet into Sydney Water's water system; and
 - Credit card payments (to a maximum of \$1,000) may be made on Bankcard,
 MasterCard or Visa only at any Sydney Water Customer Service Centre.
- 6. Have Sydney Water stamp and approve your building/engineering plans (as there may be Building Over/Adjacent to Assets requirements).
- 7. Complete any special requirements detailed in Section 7.
- 8. Note alternatives to your proposal.

DETAILED REQUIREMENTS

1. Water service requirements

Please note that your development can only be served by a single point of connection to a watermain with either one 20mm water meter or two 20mm water meters off a tee.

There is an existing 100mm water main available in Dyal Street to serve your development.

2. Water Servicing Coordinator

You must engage an authorised Coordinator to manage and facilitate the construction of sewer works that you must provide, at your cost, to service your development.

3. Minor Works Agreement

After you engage a Coordinator, you will need to sign and lodge both copies of the enclosed Minor Works Agreement with your nominated Coordinator.

Notes:

- (i) If construction must take place on neighbouring properties, written consent on the Sydney Water Permission to Enter form must be obtained from the relevant property owners by you, or your Water Servicing Coordinator. Your Coordinator has copies of the form (also available on the Internet at the address as above) and can negotiate on your behalf. This consent must be lodged with the Agreement.
- (ii) The authorisation of the Coordinator must be current at all times throughout the project.

4. Sewer works.

The Coordinator will facilitate the engagement of a Sydney Water accredited Constructor of Minor Works (Sewer)/ Sewer Constructor (the Constructor) to build the works.

The Coordinator, in conjunction with the Constructor, will determine the location of the works consisting of a junction and a property connection sewer not in excess of six (6) metres in length or 2.5 metres in depth that will adequately drain the property.

The Constructor must give Sydney Water at least two (2) working days notice of the intended connection date. The Council for the area must be consulted before any work is carried out in, on or over a public road.

Upon completion of the required works, your Coordinator must submit to Sydney Water a "Work as Executed" package indicating what was actually constructed.

Sydney Water's specific requirements for your project are:

A sewerage point of connection within the property boundaries to adequately drain the lot.

In providing these works to Sydney Water you will need to pay construction costs directly to your suppliers. You should consult with your Coordinator in regard to Sydney Water's application and inspection fee (currently \$100.50) and the Coordinator's Minor Works

In addition, if the watermain/ sewer main/ stormwater located in the footway is found, after the issue of this notice, to require adjustment or deviation this work must be completed to Sydney Water's satisfaction prior to the issue of the Certificate (see also section on building plan stamping). You must use a Sydney Water authorised Coordinator to make an additional application for approval to undertake the works. For a list of authorised Coordinators please refer to the instructions detailed on page 1 of this Notice.

You must then sign a Major Works Agreement to construct the necessary works at no cost to Sydney Water. After the adjustment/ deviation design has been completed and its nature and complexity considered, Sydney Water may require your lodgement of an appropriate security that will be refunded upon completion.

5. Developer charges.

Development Servicing Plan (DSP)	Busis of Calculation	Charge (\$) for Applicable period (01/03/05 - 30/06/05)	Charge (S) for Applicable Period (01/07/05-28/03/06 (*CPI adjusted)
Warringah Water DSP Area	Residential Development Density 0-20 dwellings per ha band 2 dwellings @ \$851 = \$1,702 Less Credit of \$851 for previous payment/ use plus Upsizing Development Density 0-20 dwellings per ha band 2 dwellings @ \$188 = \$376 Less Credit of \$188 for previous payment/ use	\$851	STBA
Warriewood Sewer DSP Area	Residential Development Density 0-20 dwellings per ha hand 2 dwellings @ \$6,607 = \$13,214 Less Credit of \$6,607 for previous payment/ use plus Upsizing Development Density 0-20 dwellings per ha hand 2 dwellings @ \$87=\$174	\$6,607	STBA
Reticulation	Less Credit of \$87 for previous payment/ use	\$87	STBA
tecovery		\$NIL	\$NIL
OFFICE USE- In	CHARGES TOTAL: wice Charges total- Developer \$7,458 and Upsizing \$275] 12 months to 31/03/05)	\$7,733	STBA

Notes:

- If you do not pay the charges identified in column 3 of the above table by 30 June, the total will be adjusted for inflation (based on the weighted average of the capital cities CPI for the 12 months to the end of the previous March) from 1 July for the balance of the 12 month period. The charge from 1 July is shown in column 4 when the inflation figure is known.
- DSP charges are a contribution towards the cost of systems (cg treatment plants), which serve your development. They have been calculated using base developer charges that cannot be changed or waived by Sydney Water having been established in Plan(s), available on request, and registered with the Independent Pricing and Regulatory Tribunal (IPART) under its relevant Determination. For further details, and a copy of the IPART Act 1992 including section 31 that refers to arbitration rights, see the IPART web site www.IPART.nsw.gov.au. Costs of arbitration, if appropriate, are borne equally by you and Sydney Water irrespective of outcome.
- These charges are directly payable to Sydney Water. Credit card payments (to a maximum of \$1,000) may be made on Bankcard, MasterCard or Visa card only at any Sydney Water Customer Service Centre.
- You must pay your Developer Charges total before you will be given permission to construct the sewer works and/or connect your development to Sydney Water's water system.
- Reticulation Recovery Charges recover part of the cost of works that have been provided by Sydney Water or other developers that benefit your development. This charge has been calculated before your detailed designs are completed. If later design investigation shows your development will be connected to other main/s, the Reticulation Recovery charge may be varied and/or you may need to construct other works.

6. Stamping and approval of your engineering and building plans.

While NOT a requirement for the Certificate, you are reminded that your building plans must be stamped and approved at:

- a Quick Check agency (for an agency list see www.sydneywater.com.au, refer to Quick Check under Building Developing and Plumbing or call 13 20 92); or
- a Sydney Water Customer Service Centre.

Approval is required as construction/building works (eg earthworks, roadworks, drainage, landscaping, excavation, foundation works) may impact on existing Sydney Water assets (eg water and sewer mains). Approval of the plans may take up to 21 days and the results may affect these activities.

Note: If any work on our assets is carried out without that approval, then Sydney Water will take action to have work on the site cease and apply the provisions of Section 44 of the Sydney Water Act 1994.

7. Special requirements

Soffit Requirements

Please be aware that floor levels must be able to meet Sydney Water's soffit requirements for property connection and drainage.

8. Alternatives to your proposal.

Please note that, should you intend to submit an application for a Certificate for a Torrens, Strata, Stratum or Community Title subdivision in the future, you should consider the advice detailed below before you commence building.

(a) Advice before you build

If you subdivide your Dual Occupancy development by a Torrens, Strata, Stratum or Community Title subdivision, you must meet our subdivision requirements which are summarised below. Meeting these requirements at the time of construction of the building(s) rather than waiting for subdivision may be beneficial, in order to:

Minimise construction costs and disruptions. It is usually less expensive to install both sets of pipes at the same time and will avoid future building works disruptions.

Pay the current rate for Developer (DSP) charges.

Obtain a Certificate for the subdivision. When Council approval for the subdivision is granted you must make a fresh application for a Certificate with an authorised Coordinator paying the appropriate fees. Then, if there is no alteration to your original proposal your application for a Certificate should be quickly processed. However, if there is a variation to your proposal, further investigation fees and servicing requirements will apply.

(b) Summary of requirements

- (i) If you subdivide using Torrens Title you will need to:
 - Ensure each dwelling/ lot has a separate point of connection to a watermain with an independent private service line and 20mm water meter, and
 - Ensure each dwelling/ lot has a point of connection to a sewer main; and
 - Construct works, if necessary, to provide separate points of connection; and
 - Pay Developer charges; and
 - Meet other requirements; or
- (ii)If you subdivide using Strata, Stratum or Community Title you will need to:
 - Ensure each dwelling/ lot has a separate point of connection to a watermain with an independent private service line and 20mm meter; and
 - Ensure either that each dwelling/ lot has an independent private service line to a separate point of connection to a sewer main or that both dwellings/ lots have a joint private service line to a single point of connection to a sewer main; and
 - Construct works, if necessary, to provide separate points of connection; and
 - Pay Developer charges; and
 - Meet other requirements.

Your Coordinator can provide further advice.

POSSIBLE OTHER COSTS

Requirements in this Notice relate to your Certificate application and may not cover all aspects of Sydney Water's involvement with your development. During design and construction of your development other Sydney Water fees/requirements may be necessary, including:

- construction/building plan stamping fees including fees to ensure the protection of Sydney Water
- plumbing and drainage inspection costs for private service lines (including property service connection and inspection fees)
- install backflow prevention devices for certain commercial/industrial connections
- trade waste requirements when constructing a building
- council fire fighting requirements (if not catered for by your current Sydney Water main). You should investigate fire fighting facility requirements for your development as soon as possible. including a standard pressure inquiry to Sydney Water if needed.

END OF NOTICE -

COUNCIL COPY

equibuilt

Mr Sean Gartner Sean Gartner Architects Suite 15, 9 Bungan Street Mona Vale NSW 2103

14th December 2004

Dear Sean.

Re: 3A Digal Street Mong Vale Notice of Deferred Commencement Conditions

We refer to the above mentioned correspondence from Pillwaler Council and confirm that we are satisfied Conditions 1 – 4 inclusive have been resolved on the Drawings listed below.

With regard to Condition 5 we are satisfied Clause 5.7 and 5.8 of AS1428.1 have been resolved however there is no mention of a Clause 5.9 in the current version of AS1428.1.

Drawing No:	(ssue:	Title:	Date:
DA - 05	С	Footpath - Dygal Street	Aug 2004
DA - 06	-	Footpath - Waratah / Keenan Streets	Dec 2004

Please do not hesitate to call me on (02) 9314 2759 should you require further information

Sincerely.

Richard Klinger

Accredited Access Consultant

CHIRITIAN CHIRICAN CONTROL CON

Tulujduniu (19) 4414 2744 Fuerkinilis (82) 4414 2784 Michille fi484 478 478 Fattul unjulinjili Giplimer erior un

THE CERTIFICATION GROUP PTY LTD APPROVED CONSTRUCTION CERTIFICATE DOCUMENTATION.

SEAN GARTNER ARCHITECTS

ABN :69 226 937 246

28th February 2005

The Certification Group PO Box 870 NARRABEEN, NSW, 2101

DRIVEWAY CERTIFICATION

DA N0972/03 3 A DYGAL STREET, MONA VALE

To Whom it May Concern:

We forward this letter to council to provide confirmation of the driveway in accordance with the condition of consent B28.

We hereby certify that the internal driveway complies with council's policy DCP E3 "Driveways and Internal Roadways", and the Council street levels.

This certification references only the drawing supplied by Sean Gartner Architects on drawing CC-01 issue B.

Yours Faithfully, SEAN GARTNER ARCHITECTS

Sean Gartner B.Arch



PITTWATER COUNCIL

Unit 9/5 Vuko Place, Warriewood NSW 2102 Telephone 9970 1111

Date:

20-Jan-05

Receipt No: 160304

Amount:

\$165.00

Name:

Thomas Mclean for Mrs A Mclean & Mrs J Porter

Postal Address:

78 Narrabeen Park Parade

Warriewood 2102

APPROVED ACCESS DRIVEWAY PROFILE AT:

3A Dygal Street, Mona Vale 2103

The future vehicular access profile will be as per the enclosed plan EH.

WORK REQUIRED:

Construct:

Vehicular access slab 5.2m long x 3.5m wide at gutter crossing to 3.5m

wide at the boundary.

Type of Construction: Domestic

VEHICULAR ACCESS


- (a) All work within the road reserve (including excavation) in connection with the above, is to be carried out by authorised contractors only.
- (b) Quotations for the work specified above should be obtained from any of the contractors on the list and should be for the whole of the work stated.
- Construction of vehicular access will be strictly in accordance with the (c) profile supplied and where the drive within the property is to be constructed first, it shall be the responsibility of the owner to have the work carried out in such a manner as to provide a smooth join and continuity of grading.

Please Note: Council will only permit an absolute maximum gradient of 25% (1 in 4) measured at any point on the driveway and that an ease may be required for access into the car stand area, carport or garage. Refer to relevant attached profile.

Sigi Melderis

ASSETS / RESTORATIONS OFFICER


THE CERTIFICATION GROUP PTY LTD APPROVED CONSTRUCTION CERTIFICATE DOCUMENTATION.

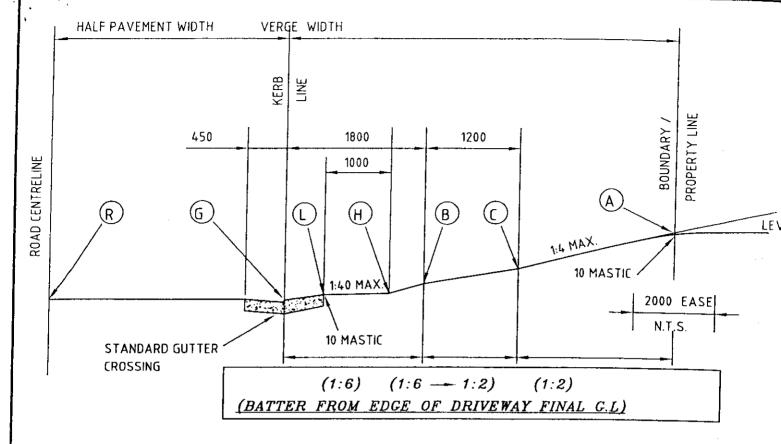

POINT	REMARKS	LEVELS
R	ROAD CENTRELINE	
G	INVERT OF GUTTER	
L	BACK OF LAYBACK	100 ABOVE "G"
Н	1000 FROM BACK OF LAYBACK	125 ABOVE "G"
В	1800 FROM KERB LINE	MAX 200 ABOVE "G"
ζ	3000 FROM KERB LINE	MAX 410 ABOVE "G"
Α	BOUNDARY	EASE REQUIRED AT GRADE CHANGE

NOTES:

- 1. ALL CONSTRUCTION WITHIN THE ROAD RESERVE TO BE IN PLAIN UNCOLOURED 20Mpa CONCRETE UNLESS OTHERWISE APPROVED BY COUNCIL.
- 2. SINGLE DWELLINGS 20Mpa CONCRETE 130mm THICK. DUAL OCCUPANCIES WHERE THE CROSSING SERVICES BOTH DWELLINGS - 20Mpa CONCRETE BASE 150mm THICK WITH F72 REINFORCEMENT.
- 3. THE VEHICULAR CROSSING AND THE DRIVEWAY TO 1800mm BEHIND THE KERBLINE IS TO BE GRADED PARALLEL WITH THE ROAD CENTRE LINE GRADING.
- 4. WHERE THE DRIVE WITHIN THE PROPERTY DRAINS TOWARDS THE ROAD, A GRATED DRAIN SHALL BE CONSTRUCTED ACROSS THE ENTRANCE WITHIN THE PROPERTY AND PIPED TO THE STREET GUTTER. THE WIDTH OF DRAIN AND SIZE OF PIPE WILL BE DETERMINED BY COUNCIL.
- DRIVEWAY PAVERS TO BE LAID ON A 100mm CONCRETE BASE.

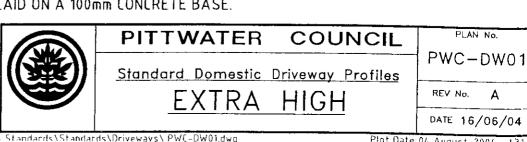

FOR USE ONLY FOR DEVELOPMENTS OF 2 OR LESS DWELLING UNITS



Pittwater Council List of Council Approved Contractors Vehicle Footpath Crossings & Associated Works

- The following contractors are authorised to carry out the above construction within the road reserve in the Pittwater Council area. No other persons are permitted to carry out excavation or any other part of this work.
- Please note that the contractors are specifically recommended as vehicle footpath crossing contractors only and in some instances the contractors may not hold a Builder's Licence or a Restricted Builder's Licence.

Action Concreting & Const. Pty Ltd			
	P.O. Box 521 Collaroy 2097	9982 2135	0414 355 772
Adaptive Construction Pty Ltd	2 Wollstonecraft Ave, Avalon 2107	9918 5211	0411 520 663
A Grade Concrete Pty Ltd	1A Selby Avenue, Dee Why 2099	9982 2616	0410 565 777
A.K. Concrete Solutions Pty Ltd	164 Madagascar Drive, Kings Park 2148	9837 8322	0412 392 355
Allan's Concreting	11A Second Avenue, Gymea Bay 2227	9542 7479	0417 481 022
Andcrete Pty Ltd	PO Box 546, Kingswood 2747	9756 0833	0418 404 575
Anton Constructions Pty Ltd	17 Cannons Parade Forestville 2086	9451 1300	0418 236 651
Antonio Tomaino	97 Wyadra Avenue, North Manly 2099	9938 3841	0422 994 938
Aranac (Contracting) Pty Ltd	63 Spencer Road, Killara 2071	9498 7050	0408 224 883
Arch Concreting Services (NSW) Pty Ltd	67 Fullers Road, Chatswood 2067	9904 6949	0419 424 930
Barry Bree Concreting	29 Seaview Ave, Newport 2106	9997 8840	0415 183 146
Better Lifestyle Landscaping Pty Ltd	Lot 20 Tomko Grove, Parklea 2768		0439 409 351
Brook Concrete P/L (Bomanite)	26 Adderton Rd, Telopea 2117	9638 2926	0418 218 671
B & D Concreting (Buddy Habkouk)	38 Thornleigh Street, Thornleigh 2120	9484 6644	0419 250 312
Capano Concrete Pty Ltd	40 Rowley Street, Smithfield 2164	9604 8715	0409 838 238
Cherrybrook Landscaping Pty Ltd	3 Alleyne Avenue, Nth Narrabeen 2101		0419 423 366
CKJ Building Services Pty Ltd	7 Warrimoo Avenue, St Ives		0414 410 082
Coastline Concrete Pty Ltd	47 Blighs Rd, Cromer 2099	9982 4805	0412 278 507
Cobblecrete Australia	PO Bxo 121 Hoxton Park 2171	9608 6059	0414 784 550
C-Side Concreting & Pump Hire P/L	43 Wesley Street, Elanora Heights 2101	9913 1653	0404 872 111
Concrete Australia	181 Queens Road, Connells Point 2221	9594 0745	0404 049 999
Cubic Concrete	12A Linden Street, Mount Druitt 2770		0407 016 064
D Spencer & Associates	7/1 Marina Close, Mount Kuring-gai 2080	9457 0332	0425 212 570
Danscapes Pty Ltd	PO Box 764 Caringbah 1495	9523 3335	0416 107 283
Domestic Concreting Services	20 Trentham Avenue, Douglas Park 2569	3020 0000	0416 150 360
Fairmont Homes NSW Pty Ltd	PO Box 752, Campelltown 2560	024628 1777	0410 130 360
Florimo, John	17 Iluka Ave, Elanora Heights 2099	9913 7440	
Frank's Concrete Pty Ltd	P.O. Box 983, Mona Vale 2103	9997 3999	0415 296 978
G & D Concrete Pty Ltd	18 Hawkesbury Ave, Dee Why 2099	9982 4780	0418 225 871
Hardrock Concrete	285 Carrington Road, Londonderry 2753		0418 644 887
Hardman Paving & Concrete	110 College Street, Cambridge Park 2747	4572 5582	0414 608 580
Harvey, N & P	13 Koorangi Ave, Elanora 2099	024735 7276	0418 285 703
H J Bellamy & Sons Pty Ltd	P.O. Box 541 Collaroy 2097	9913 9523	0404 475 731
Humphrey, Peter	251 Alfred Street, Cromer	9981 4137	0418 280 904
ngleside Landscaping Pty Ltd	<u></u>	9982 2784	0416 229 600
Joe's Concreting Pty Ltd	145 Wirreanda Road, Ingleside 2101	9450 2404	0408 296 359
Kakoda Concrete Pty Ltd	14 Whitefriars Way, Winston Hills 2153		0411 197 144
Karisma Building Services	32 Aldinga Drive Wamberal 2260	4384 2460	0421 342 177
Kelpie Concrete Pty Ltd	PO Box 78 Yagoona 2199	9608 2103	0419 616 262
	20 Spring Road Curl Curl	9905 8398	0418 164 604
KMD Landscapes & Stone	183 Rainbow Street, Randwick 2031	9664 6600	0418 688 324

L & G Concrete Pty Ltd	6 Bronzewing Terrace, Bella Vista 2153	8824 8196	0418 971 356
Lloyd Building & Civil Constructions P/L	17 Ilya Avenue, Bayview 2104		0418 232 523
Luch's Concrete Pty Ltd	15 Milpera Place Cromer 2099	9982 8739	0411 879 257
Maiolo, Raffele	1 Batho Road, Harbord 2096	9939 1982	
Masterform Pty Ltd	150 Alfred Street Narraweena 2099	9971 6309	0409 244 056
N.B.E Concrete Pty Ltd	1 Whitney Street Mona Vale 2103	9979 7035	0418 244 793
Newborn Concrete Pty Ltd	8 Hilmer St, Frenchs Forest 2086	9451 6048	0408 678 528
Newport Concreting Pty Ltd	P.O. Box 108 Newport 2106	9997 5686	0407 068 716
Noreast Constructions Pty Ltd	P.O. Box 62, Camperdown 1450	9519 9470	0414 696 731
Northcrete Concreting Pty Ltd	8 David Rd, Collaroy Plateau 2097	9971 7868	0418 239 958
Northshore Formwork & Concreting P/L	30 Nimbey Avenue, Narraweena 2099	9981 4390	0418 169 365
Northside Concreting Services Pty Ltd	P.O. Box 168 Mona Vale 2103	9913 2600	0411 529 004
Ocean Concrete Pty Ltd	7 Nursery PI, Belrose	9452 1473	0412 449 297
Paton Concrete Works Pty Ltd (formerly Naivy Pty Ltd)	PO Box 1237, Mona Vale 1660	9999 4220	0414 994 220
Pavecrete Pty Ltd	PO Box 710, Avalon 2107	9913 8500	0418 772 799
Pearl Design & Construction	20 Moxon Road, Punchbowl 2196	9708 2741	0414 692 348
Peter Yorke Landscapes Pty Ltd	205 Garden Street, Warriewood 2101	9979 6558	0414 997 644
PRC Constructions Pty Ltd	14 Buena Vista Avenue, Mona Vale 2103	9940 1019	0410 303 806
Prime Constructions Pty Ltd	394 Pacific Highway, Lane Cove 2066	9418 7707	0418 163 506
Rocco Crea Concrete Pty Ltd	177 Fisher Road North, Dee Why 2099	9982 8585	0412 237 559
Rocco Mileto & Co Pty Ltd	24 Cubitt Drive Denham Court 2565	9829 4061	0418 072 012
Rylehall Pty Ltd	Level 3,1C Homebush Bay Dr Rhodes 2138	9767 2000	
San Marcos Civil & Concreting Pty Ltd	196 Fairfield Road, Yennora NSW 2161	9721 3771	0413 428 435
S & E Cavalieri Pty Ltd	29 Quinlan Pde, Manly Vale 2093	9948 5442	0412 285 301
Spaghetti Concretors Pty Ltd	4/28 Goodwin Street, Narrabeen 2101	9971 6663	
SJ Hensby & Sons Concrete Maintenance Pty Ltd	7 Chippenham Street, Chipping Norton 2170	9755 5544	0400 110 453
T.B.R.H. Concreting and Landscaping P/L	P.O. Box 2078 Normanhurst 2076	9489 2620	0413 072 702
T & L Fowler	161 Ebenezer Wharf Road, Ebenezer 2756	4579 9332	0438 402
326	72 Kevin Avenue, Avalon 2107	9979 5670	0418 208 278
The Gardenmakers Pty Ltd	55 Laurel Rd, Ingleside 2101	9979 5500	
Timber Time Pty Ltd	57 Therry Street Avalon	9918 3313	0414 975 354
Warringah Formwork Pty Ltd	22 Waine St, Harbord 2096	9905 0602	0412 520 094
Wellington, Walter	34 Alexander St, Collaroy 2097	9982 6335	0414 614 119
Builders who wish to carry out their own	work only. (No quotes)		·
DAF Constructions Pty Ltd	3/6 Wilmette PI, Mona Vale 2103	9997 6723	0408 976 723
Gubler & Associates Pty Ltd	49 Careel Head Rd, Nth Avalon 2107	9918 2896	<u> </u>
Lamrock, BJ & LF	P.O. Box 76 Avalon 2107	9918 7037	0418 406 221
	P1-0400	0044 0960	0402 952 024

18A Pine Avenue, Brookvale 2100

0402 853 921

9944 0860

Shorecent Pty Ltd



Pittwater Council Deed of Agreement - Coloured Concrete Driveways

(For coloured surfaces only)

This refers to the section of your driveway between your property boundary and the roadway/kerb and gutter.

Council will allow a coloured driveway provided:


- a A Legal Agreement is signed by owner/s indemnifying Council.
- b The crossing is constructed by a Council approved contractor to Council's specifications.
- c) This type of agreement applies to coloured concrete only.

TWO (2) Deed of Agreement Forms attached are to be SIGNED BY ALL OWNERS and BOTH COPIES returned to Council with the prescribed fee of \$66.00. One copy endorsed by Council will be returned to the owner AFTER THE DRIVEWAY HAS BEEN CONSTRUCTED.

THE CERTIFICATION GROUP PTY LTD APPROVED CONSTRUCTION CERTIFICATE DOCUMENTATION.

DEED OF AGREEMENT FOR COLOURED DRIV	VEWAY INDEMINIFYING AGAINST LIABILITY
	day of FEBRUAR 20 05.
OWNERS name: ADELIA MELEAN &	: LAURA PORTER
Post: Address: 78 NARRABEEN P	SEK POR PORTER Postcode: NSW 210 Z
Hereinafter called "the owner" of the one part and THE C	COUNCIL OF PITTWATER (hereinafter called "the
1. The owner/s acknowledge that:-	
No: 34 Lot No.3 IN DP 217045	Postcode: NSW 2103
Subject: MOND VOLE	Postcode: NSW 2103
coloured concrete, which is structurally in cor	otpath/vehicular crossing to be constructed in nformity with Council's standards, the owner agrees:
a) The accept full responsibility for all restoration and maintena to the satisfaction of Council at all times.	nce of the crossing and to keep it in a sound and safe condition
b) The should the crossing be damaged at any time during the author sed person or body, the restoration of the surface appe	SSLSUCE Alli De Tile CALLEL 2 Lesbousing.
cold aread portland dement concrete to render it safe for vehicle	
of any intending purchaser of the property.	is pertaining to it will be noted in Council's records for the advice
IN WITNESS WHEREOF the parties hereto have here and year first hereinbefore written.	unto set their hands and seals on the day
SIGNED SEALED AND DELIVERED	
By the said owner in the presence of:	all: hi Some
Signature of Witness	Signature, of Owner ()
	Laura Fort
Name of Witness	Signature of Owner
23 Cook Ferrace morable Address of Witness	
Signer on behalf of THE COUNCIL OF PITTWATER URBAN INFRASTRUCTURE MANAGER	Inspecting Officer
Date:	Date:
Office Use Only: CODE, EROP	Form No: COL0603
FEE: \$86.00 incl. GST as at 1.7.04 ISSUED BY:	Translavante DATE: 1. Jeb CS

Any enquiries please contact Customer Service Ph: (02) 9970 1111 Fax: (02) 9970 7150

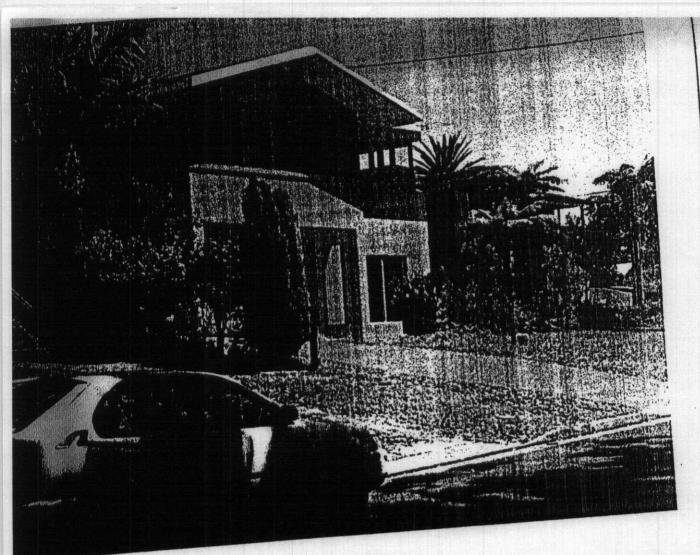

NTAGE VIEW FROM THE SOUTH

STONEY WATER APPROVED

Position of structure in relation to Sydney Water's assets is satisfactory.

Connections to Sydney Water sewer/water services may only be made following the issue of a permit to a licensed plumber/drainer.

It is the owner's responsibility to ensure that all proposed fittings will drain to Sydney

Any Plumbing and/or Drainage Work to be carried out in accordance with the Sydney Water Act 1994, AS 3500 and the NSW Code

Gullies, Inspection Shafts and Boundary Traps shall not be placed under any Roof, Balcony, Verandah. Floor or other cover unless otherwise approved by Sydney Water.

Property No. 3414163

Reece, Mona Vale Quick Check Agent on behalf of SYDNEY WATER

REECE 2312,05

COUNCIL COPY

THE CERTIFICATION GROUP PTY LTD APPROVED CONSTRUCTION CERTIFICATE DOCUMENTATION.





Design Certificate

Date: Client: 4th March 2005 Tom McClean

Job No. 041124

Engineer: LM

Engineer, Elv

Site: 3A Dygal Street, Mona Vale

We hereby certify that the plans prepared by NB Consulting Engineers P/L (Job No: 041124 drawings D01A to D02) are in accordance with the condition B19 of the DA consent.

We trust that this certificate meets with your requirements. Please contact the author if further clarification is required.

NB CONSULTING ENGINEERS P/L



THE CERTIFICATION GROUP PTY LTD APPROVED CONSTRUCTION CERTIFICATE DOCUMENTATION.

N:\ENG NBC\2004\041124\SC002.doc

COUNCIL COPY

DIRECTORS Bruce Lewis Lucas Molloy-Rick Wray Stewart MELECTO 15

Design Certificate

Date: Client:

4th March 2005 Tom McClean

Job No.

041124

Engineer: LM

Site: 3A Dygal Street, Mona Vale

We hereby certify that the plans prepared by NB Consulting Engineers P/L (Job No: 041124 drawings S02B) are in accordance with the condition B29 of the DA consent.

We trust that this certificate meets with your requirements. Please contact the author if further clarification is required.


NB CONSULTING ENGINEERS P/L



THE CERTIFICATION GROUP PTY LTD APPROVED CONSTRUCTION CERTIFICATE DOCUMENTATION.

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Commenter the Condition of the Condition Sharp 201, All Plane: He of the Why, New 2008 18: 4934 2000 Sax 2004 Face Bending sense assengence out

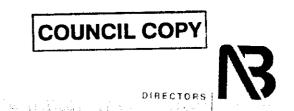

Stormwater Certificate

Date:

31 January 2005

Job No.

041124

Client: Tom McClean

Engineer: LM

Site: 3A Dygal Street Mona Vale

We hereby certify that the plans prepared by NB Consulting Engineers P/L (Job No: 041124 drawings D01 to D02) for the residential development at the above property address are in accordance with the intention of Councils Policy and Guidelines for the on-site detention of stormwater.

We trust that this certificate meets with your requirements. Please contact the author if further clarification is required.

NB CONSULTING ENGINEERS P/L

Per Lucas Molloy
BE MIEA CPEng NPER
Director NBConsulting

N: ENG NBC\2004\041124\SC001.doc

THE CERTIFICATION GROUP PTY LTD
APPROVED CONSTRUCTION CERTIFICATE
DOCUMENTATION.





the certification group

enhancing building performance

APPLICATION FORM

Made under the Environmental Planning and Assessment Act 1979, Sections 81A(2)(4), 84A, 85A, & 109C (1)(b), Environmental Planning and Assessment Regulation 2000, clauses 126(1),139(1), or 157(1)

To complete this form, please place a cross in the boxes and fill out the white sections as appropriate.

Application Sought	¥70			
Complying Development Certificate Coccupation Certificate	Construction Certificate Principal Certifying Authority			in taba <u>ndari ya</u>
Subject Land			- United the Country of the War Print	itanis, a - Adribito folialis de esta transferio de esta de est
Address 34 DYGAL ST	REET MONA VALE			
Lot No, DP, SP, vol/fol. Etc	DP 217045		<u> </u>	
Details of the applicant Name /Company	M-LEAN	Contact Perso	on	
Postal Address 78 NARRAGE	MENSO)	Postcode	2102	State_ NSW_
E-mail	UEW39) 	Daytime telep	hone <i>991</i>	3 7407
Fax	Mobile 04/8 /6	5/29		
Applicant Signature Ton On On On On One	Xor		Date	15/12/04
Consent of Owner(s)				
	uthorise for either Mark Wysman, or Wayne Tr			
Appointment of the Principal Certifying Authority for the st	ubject building works, including site inspections ority with the relevant Council.	s and to lodge the	Notice of C	ommencement /
Name(s)/ Company MRS A. M	clear a mes c foltok			
Address 78 NARRASS	CLEAN I MRS C PORTER	Postcode	2102	State NSW
	Mobile			
Signature of Registered owner(s). Company	• • • • • • • • • • • • • • • • • • • •			
_ ~ \ \ \ \ \ \ \ \ \ \ \ \ \ \ \ \ \ \				
- Malas				

Description of the work proposed
Type of work proposed:
New Building Additions / Alterations
Class of Building under Building Code of Australia
Description of the work CONSTRUCTION OF 2 DETACHED DWELLINGS
Construction Cost of Works \$ 593,000
Details of Builder
Contact Person
Name / Company ABCO CONSTRUCTIONS PL LICENCE NO 9864
Fax 8437 5050 Mobile Daytime telephone 8437 5000 Email Sydney @ Odcoconstruct. com. au Builders address Po 80x 995 CROWS NEST NSW Postcode 2065
Daytime telephone 8437 5000 Email Sydney @ adaptonstruct. com. au
Builders address Po 80x 995 CROWS NEST NSW Postcode 2065
Details of the relevant Development Consent granted Consent No. No 972 / 03 Date the consent was granted 22-11-04
Applicant Checklist
Complete Application Form – Pages & 2
Attach supporting documentation as nominated on Page 3
Complete statistical Return on Page 4
Private Policy
The information you provide in this notice is required under the Environmental Planning and Assessment Act 1979 if you are going to
erect a building. If you do not provide the information to the consent authority, you cannot commence the work. The information will be
held by the consent authority and by the council (if the council is not the consent authority). Please contact the certification group if the
information you have provided in this notice is incorrect or changes.
Date of receipt (To be completed by Certifying Authority)
Date 15/12/2004

STATISTICAL RETURN FOR AUSTRALIAN BUREAU OF STATISTICS

What is the site area of land?		Area in square meters 1361				
Gross floor area of existing building? If no existing building, write NIL		Area in s	Area in square meters			
What is the existing building or site used for at present?		Main Us	es DWELLING	Contract Con		
		Other Uses NIL				
Does the site contain dual occupancy?			□Yes ズNo			
Gross floor area of proposed building?		In square meters AROUT DWG 3/2-2 REAR 357. L				
What will the proposed building be used for?		Main Uses SEPP 5				
		Other Uses M/L				
How many dwellings?				Christian Committee Commit		
Are pre-existing at this property?		Dualisa	1			
Western and the state of the st		and the Ta	Dwellings			
Are proposed to be demolished?		Dwellings /				
Are proposed to be constructed?		Dwellings 2				
Are attached to an existing building?		Dwellings M/L				
Are attached to a new building?		Dwellings NIC				
How many storeys will the building consist of?		Storeys 2				
What are the main building ma	terials? (Please tick appropriate boxes)		200000000000000000000000000000000000000			
WALLS	ROOF	_	000			
☐ Full Brick	Aluminium		OOR Concrete or slate	FRAME		
Brick Veneer	☐ Concrete or Slate		Timber	Timber		
Concrete or Stone	☐ Tile		Other	□ Steel		
Steel	Fibrous Cement		Unknown	☐ Aluminium		
☐ Fibrous Cement	Steel		JIINIOWII	□ Other □ Unknown		
Timber/weatherboard	Other		Unkn			
Cladding- aluminium	Unknown					
Curtain glass						
Other						
Unknown						

THE CERTIFICATION GROUP - 28 Cook Terrace Mona Vale NSW 2103 . PO Box 870 Narrabeen NSW 2101 tel 9944 8222 . fax 9944 6330 . email: info@thecgroup.com.au . www.thecgroup.com.au . acn 111 092 632







3A Dyane Serre 1 PE FRE 2005.

ROAD RESERVE FROM BN

(18./OOKING WEST) AND IS AN

ACCORDER REPERSENTATION OF THE

SCENE DEPICACO

3A Dycoe STERRE LOOKING FROM NORTH ROBB RESERVE LOOKING FROM NORTH AND IS AN ACCULATED REPEGRATATION OF THE SCHOOL SEPICEORD

3A Dycon Strukt 19 FRB 2005

ROSS RESKRUE LOOKING SOUTH

AND IS AN ACCURATE

REPRESENTATION OF THE SCENE DEPICTED





3A. Dy CAL STRIKE 18 PRES 2005.

ROBO RESERVE (PRONT ON)

Tè LOOKING WEST AND 18 AN


ACCURDA REPERSENTATION OF THE

SCRIE DEPICTED

53065

RODO RASKEVE TRONZ ON (12 LOOKING NEED) AND IS AN ACCURATE REPERSENTATION OF THE SCENE DEPCIED

53063

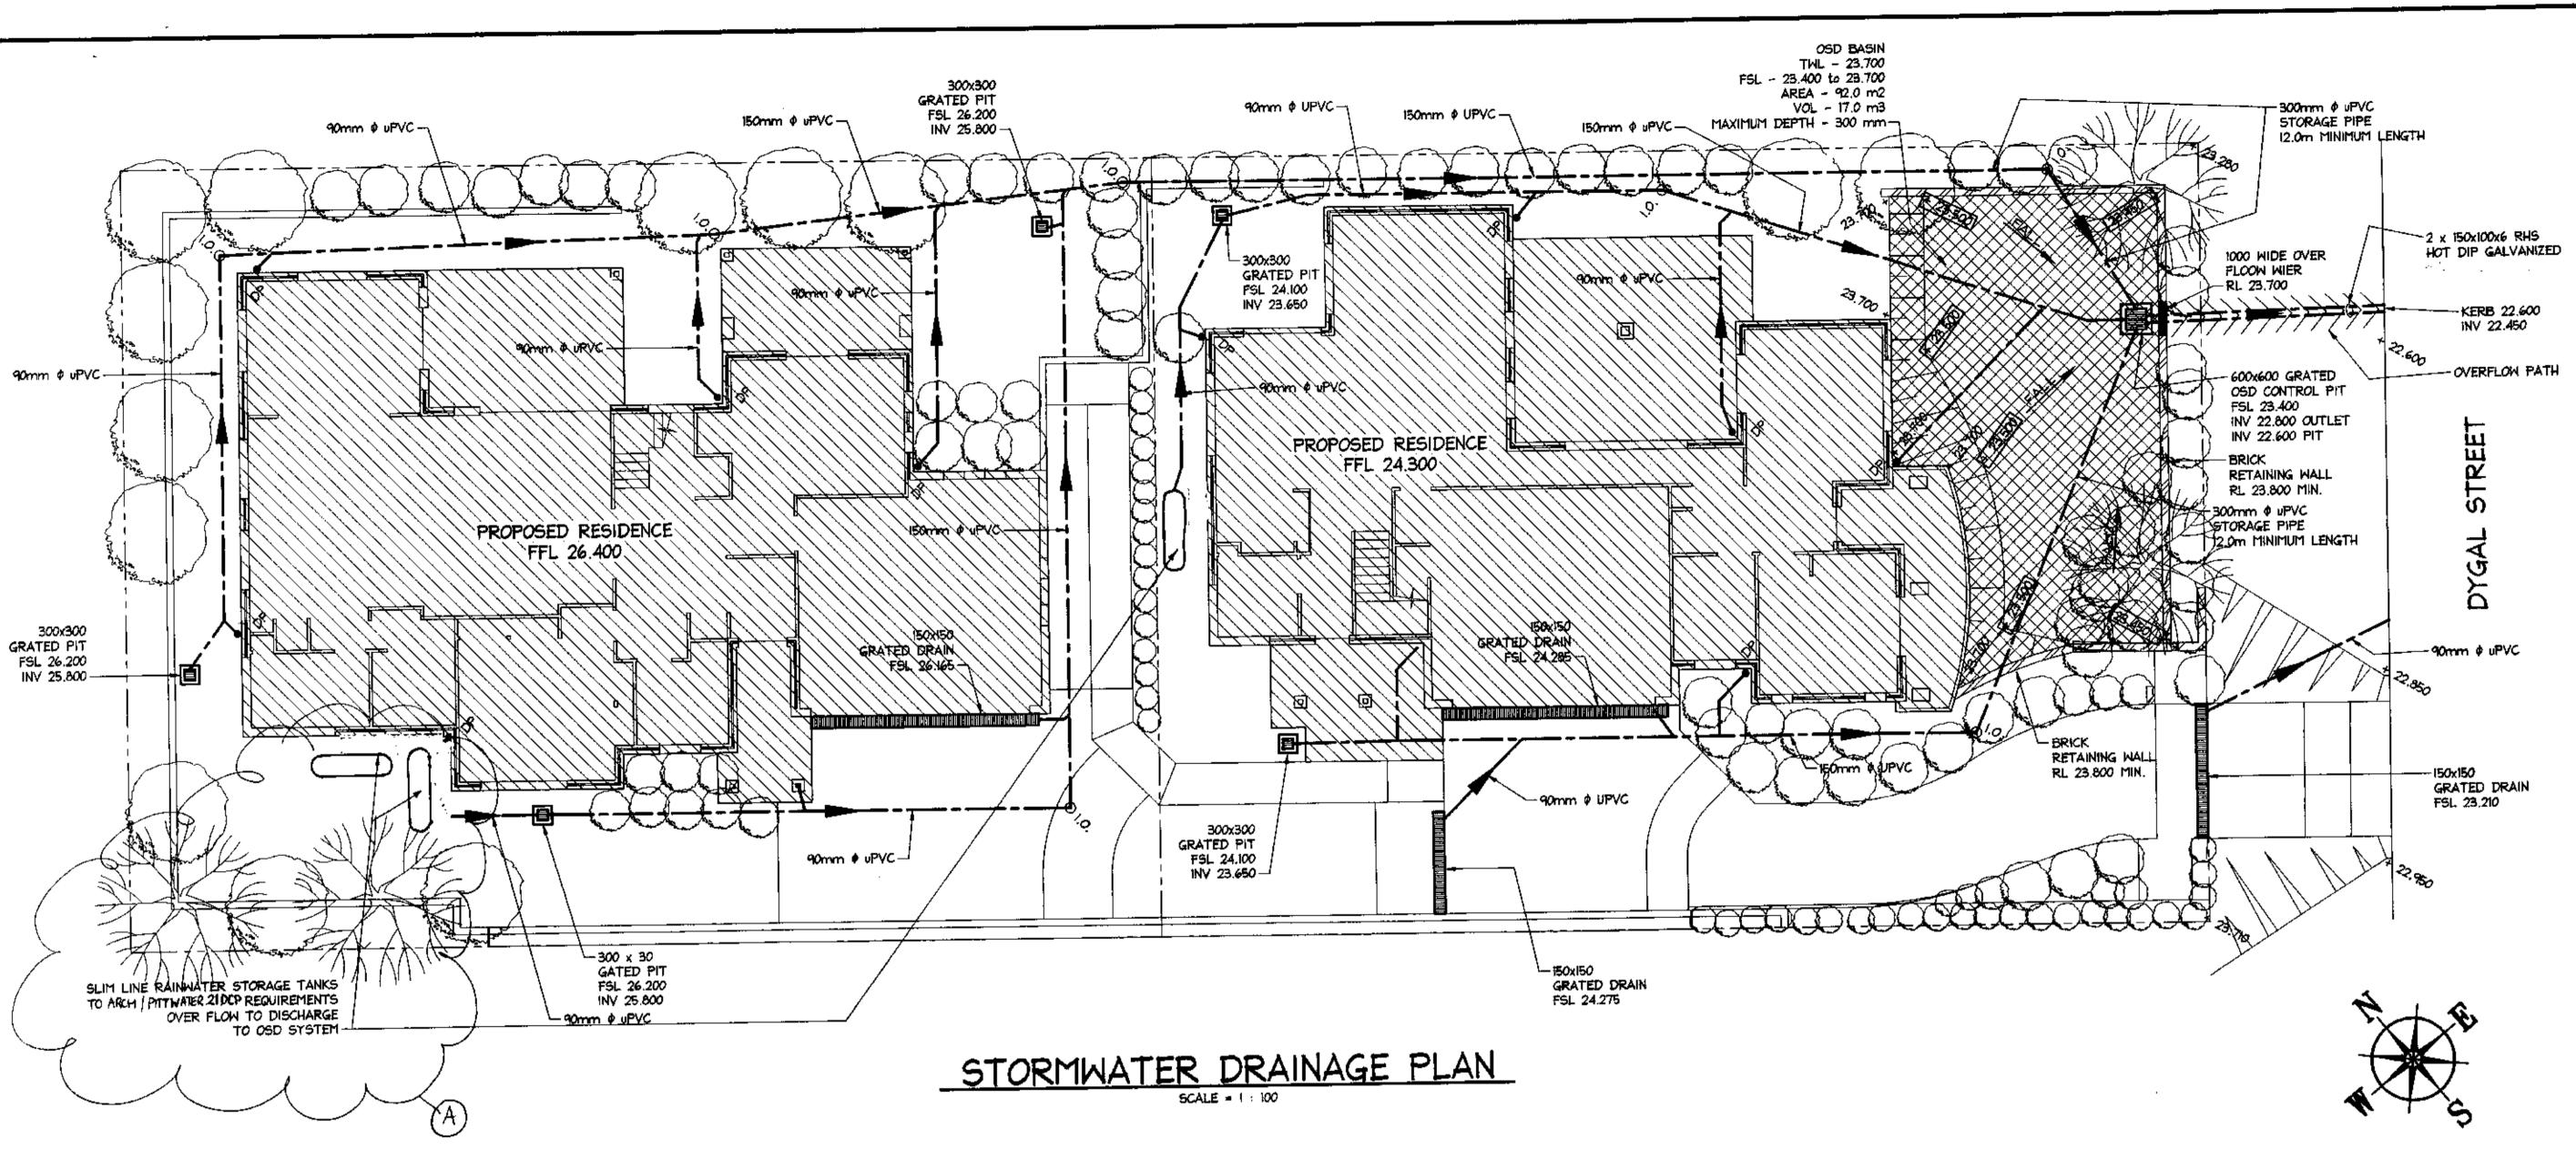

STORMWATER NOTES:

- I ALL PIPES TO BE 90mm & UNLESS NOTED OTHERWISE.
- 2 ALL PIPES TO BE UPVC TO AS 1254-1973 UNLESS NOTED OTHERWISE. 3 - ALL PIPES TO BE LAYED AT 1 % MINIMUM GRADE UNLESS NOTED OTHERWISE.
- 4 ALL PIPES SHALL BE LAID ON A 75mm SAND BED, COMPACTED TO
- 100% S.M.D.D. BELOW PAVEMENTS. (NO COMPACTION REQUIRED BELOW LANDSCAPING) COVER TO SURFACE FROM TOP OF PIPE TO BE 300mm MINIMUM. BACKFILL TO BE ADEQUATELY CONSOLIDATED AROUND PIPES BY METHOD OF RAMMING AND WATERING IN. TRENCHES TO BE FILLED
- 5 ALL DOWN PIPES TO BE 90mm & UNLESS NOTED OTHERWISE.
- 6 DOWN PIPE LOCATIONS ARE INDICATIVE ONLY. LOCATIONS TO BE CONFIRMED WITH ARCHITECT PRIOR TO COMMENCEMENT WITH WORK.
- 7 PROVIDE CLEANING EYES AT ALL DOWNPIPES.

WITH GRANULAR MATERIAL AS SPECIFIED.

8 - ALL PITS TO BE CAST INSITU OR, IF PRECAST, APPROVED BY ENGINEER. CAST INSITU PITS TO HAVE ISOMM THICK CONCRETE WALLS AND BASE. WALLS TO BE REINFORCED WITH I NIZ TOP TIE UNLESS NOTED OTHERWISE. CAST INSITU PITS GREATER THAN 1000 DEEP TO BE MINIMUM 900x600 AND TO HAVE 150mm THICK CONCRETE WALLS AND BASE. WALLS TO BE REINFORCED WITH NIZ AT 300 EACH WAY UNLESS NOTED OTHERWISE.

- 9 ALL PITS GREATER THAN 1000mm DEEP SHALL HAVE STEP IRONS AS PER COUNCIL STANDARDS.
- 10 ALL WORK TO BE IN ACCORDANCE WITH LOCAL COUNCIL STANDARDS
- AND SPECIFICATIONS. 11 - PRIOR TO COMMENCING ANY SITE WORKS THE CONTRACTOR SHALL IMPLEMENT EROSION CONTROL MEASURES TO EPA GUIDELINES AND
- COUNCIL SPECIFICATIONS, ALL MEASURES TO REMAIN IN PLACE UNTIL COMPLETION AND STABILIZATION OF THE SITE TO COUNCIL SATISFACTION. 12 - ALL LEVELS SHOWN ARE TO AHD
- 13 ENSURE THAT ALL PITS AND STORMMATER PIPES ARE LOCATED CLEAR
- FROM TREE ROOT SYSTEMS. 14 - ALL EXISTING EARTHENWARE PIPES TO BE UPGRADED TO UPVC.
- 15 ALL WORKS TO BE IN ACCORDANCE WITH AS 3500-1990 NATIONAL PLUMBING DRAINAGE CODE PART 3 - STORMWATER DRAINAGE.
- 16. 90mm \$ x 3000 LONG TAIL OUT SUSOIL LINE TO BE PROVIDED ON THE UPSTREAM SIDE OF ALL PITS. SUBSOIL LINE TO BE COVERED WITH GEOTEXTILE FILTER SOCK FOR THE FULL LENGTH AND END COVERED.

ONSITE DETENTION CALCULATIONS ACCORDING TO PITTWATER DCP 21 1361 m² TOTAL SITE AREA 211 m EXISTING IMPERVIOUS AREA = 900 m PROPOSED IMPERVIOUS AREA ADDITIONAL IMPERVIOUS AREA = 789 m = 16,000 l REQUIRED OSD VOLUME **≖** 30 1/s REQUIRED OSD PSD = 2 x 87 mm ¢ ORIFICE OSD VOLUME PROVIDED (2 m3 BELOW GROUND (17 m3 ABOVE GROUND) NOTE: EST OF AREA WITHIN OSD BASIN CRITICAL TO THE OSD VOLUME REQUIREMENT. ANY VARIATIONS TO BE REVIEWED BY THE ENGINEER BEFORE FINAL INSPECTION THE ON-SITE DETENTION FACILITIES WILL MEET THE DESIGN OBJECTIVES OF COUNCILS POLICY AND GUIDELINES FOR ON SITE DETENTION OF STORMWHER-FEB 1996. AS REQUIRED BY CONDITION BIP OF THE DA CONSENT

WARNI G PLEASE NOTE: The stamping of this plan by The Gentification Group P/. down not relieve the Applicant's responsibility to obtain approval from Sychey Water or other Authority or utilities prior to commencement of any works.

DIAL BEFORE ∴!G 1100

THE CERTIFICATION GROUP PTY LTD,

NOTES:

ALL DIMENSIONS TO BE VERIFIED ON SITE BEFORE COMMENCING WITH WORK.

2. FOR GENERAL NOTES AND DRAWING SCHEDULE REFER TO DRAWING NUMBER: SOI.

DOCUMENT CERTIFICATION A BIG CERT NOTE ADDED + STANKE TANK NOTE ACT. Lucas Molloy **dogs**ulting Engineers) (Director Northern Beaches Amendment:

I am a qualified Structural/Civil Engineer. I hold the following apolifications: BE(Civil), CPEng, MIEAust., NPER. Institute of Engineers Membership No. 788184 I hereby state that this drawing is in comptionce with the provisions of the Building Code of Australia and/or relevant Australian/Industry Standards.

NORTHERN BEACHES Consulting Engineers P/L. A.C.N. 076 121 618 A.B.N. 24 078 121 618 Suite 207, 30 FISHER ROAD DEE WHY N.S.W. 2099 Ph: (02) 9984 7000 Fax: (02) 9984 7444 us.mail: nb@nbconsutting.com.su

PROPOSED HOUSES at: 3A Dygal Street Mona Vale for: Tom McClean

Drawing Title: STORMWATER DRAINAGE PLAN The copyright of this drawing remains with Northern Seaches Consulting Engineers PfL.


ISSUED FOR


CONSTRUCTION


CERTIFICATE


SUBMISSION ONLY


Checked: Drawn: Paul R Bruce L.M. Nov 2004 OMIEAust. Drawing No: 041124

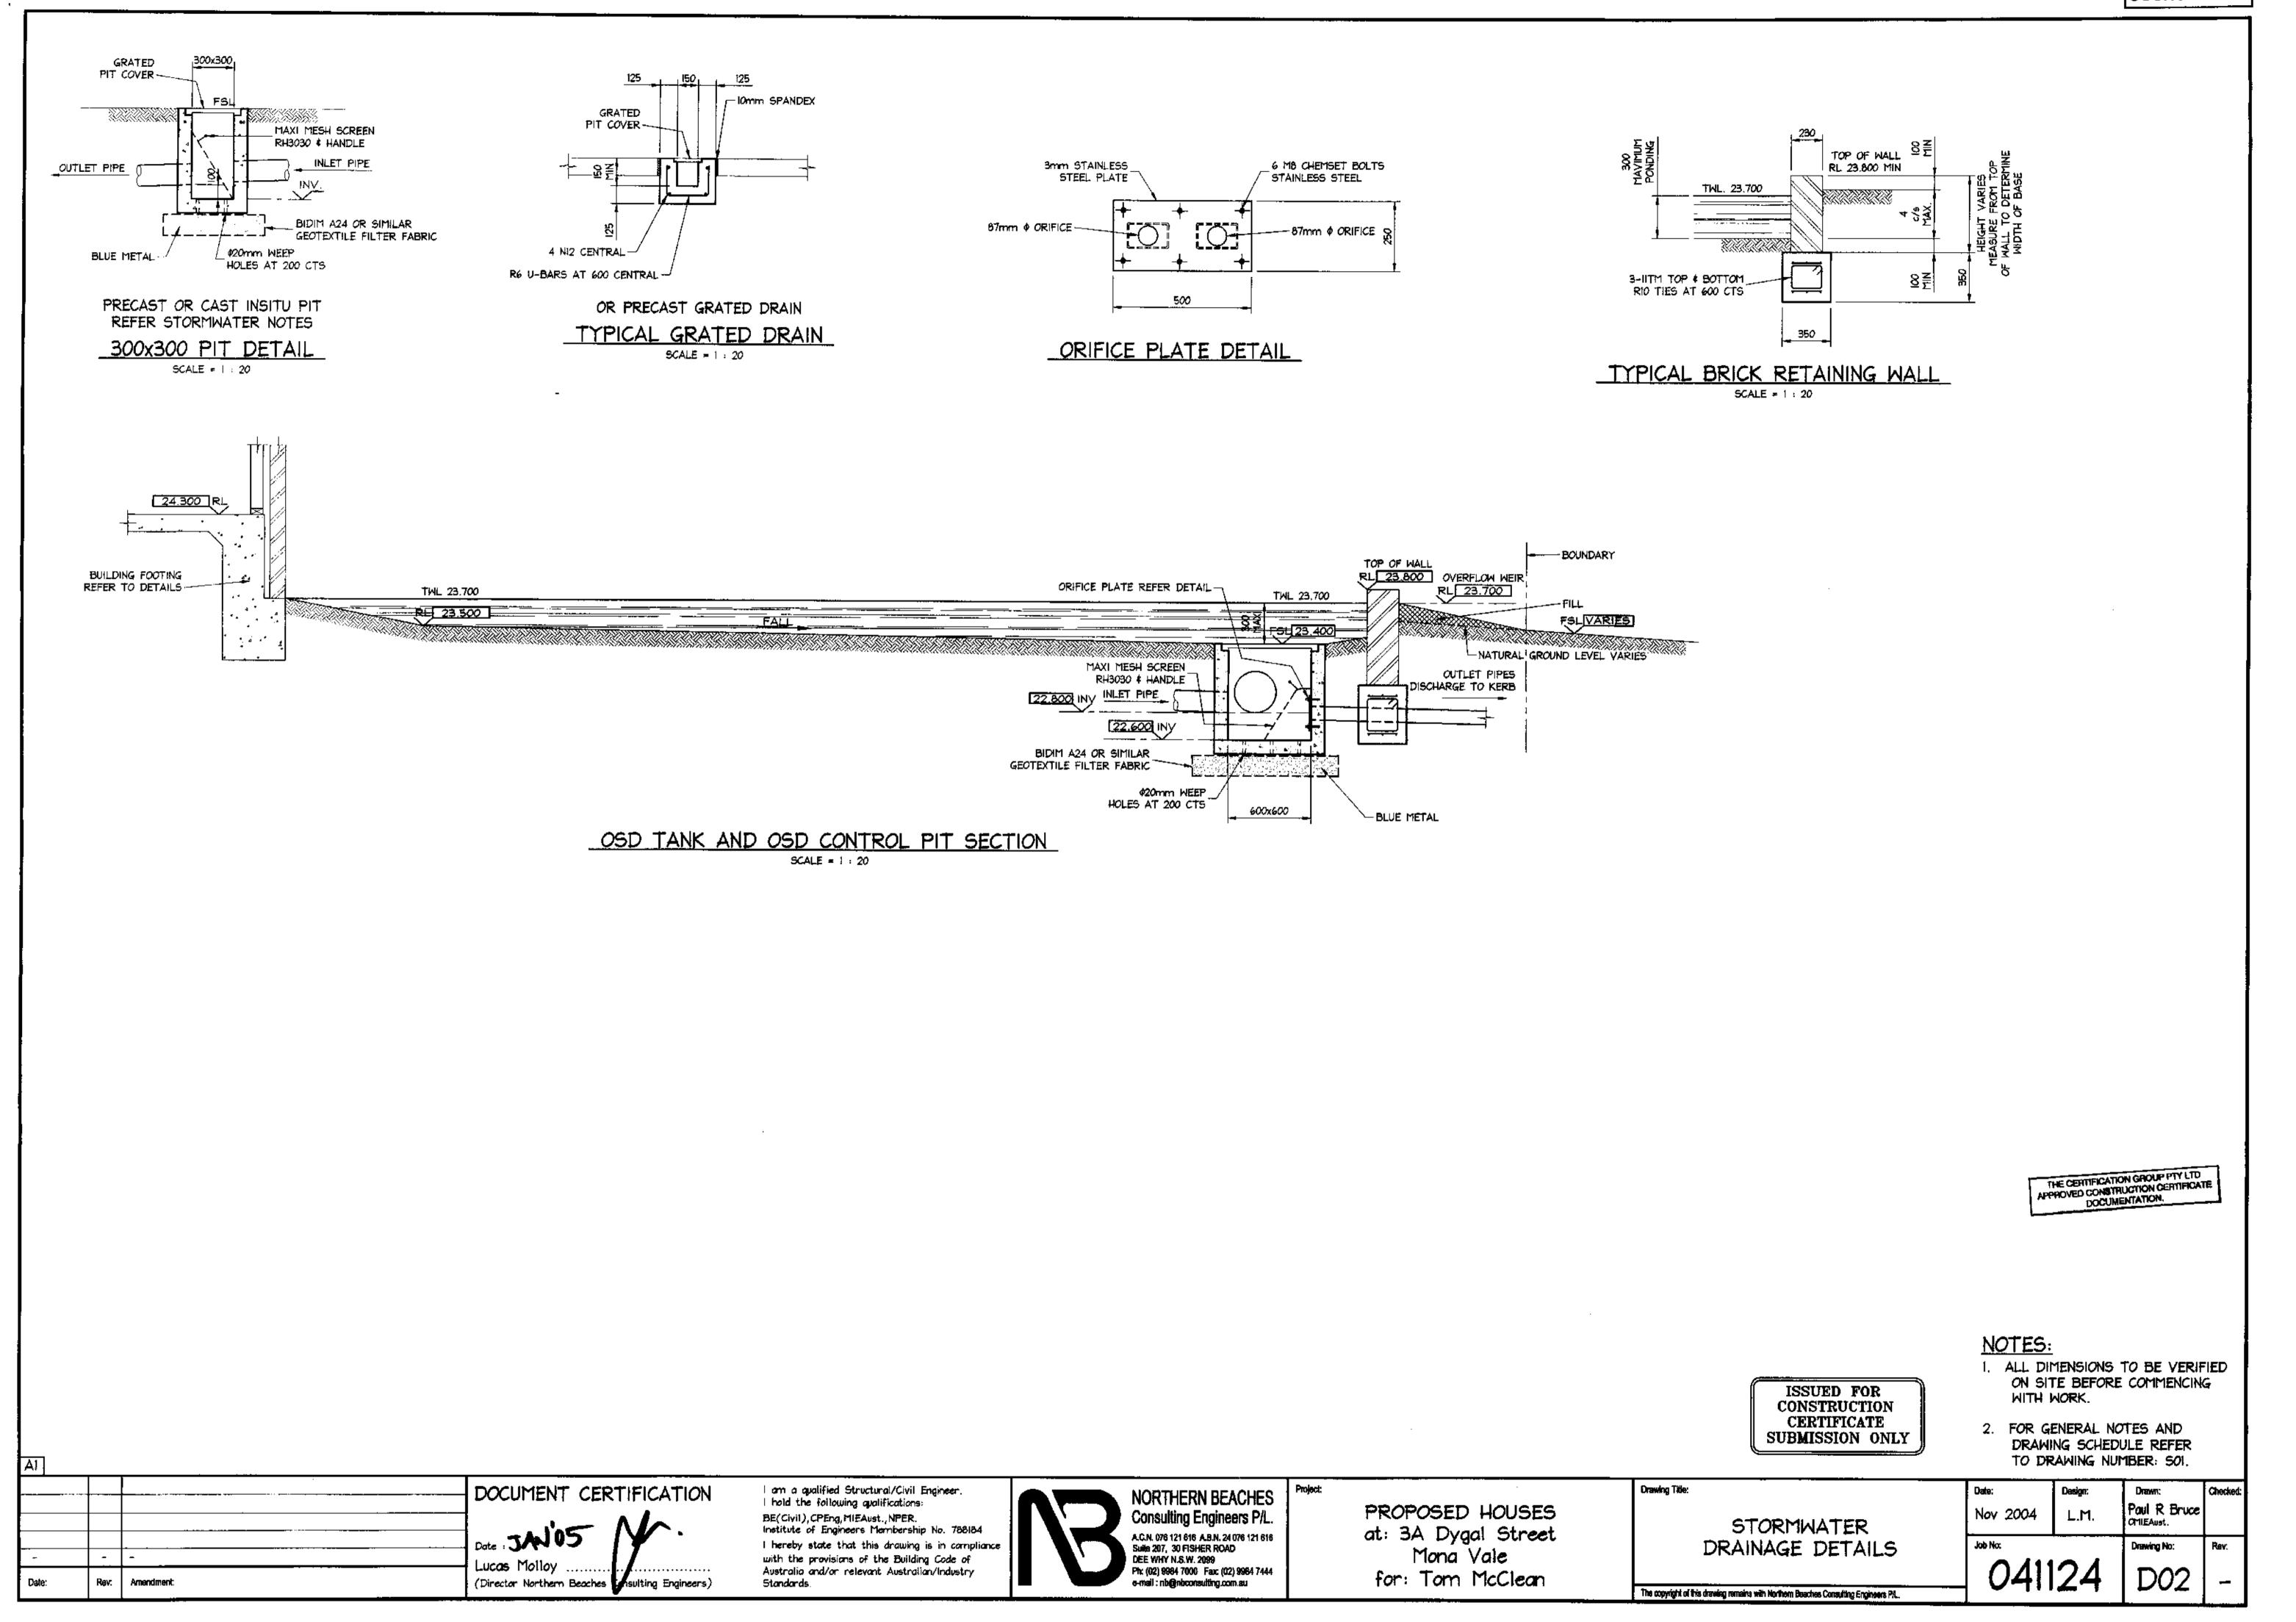


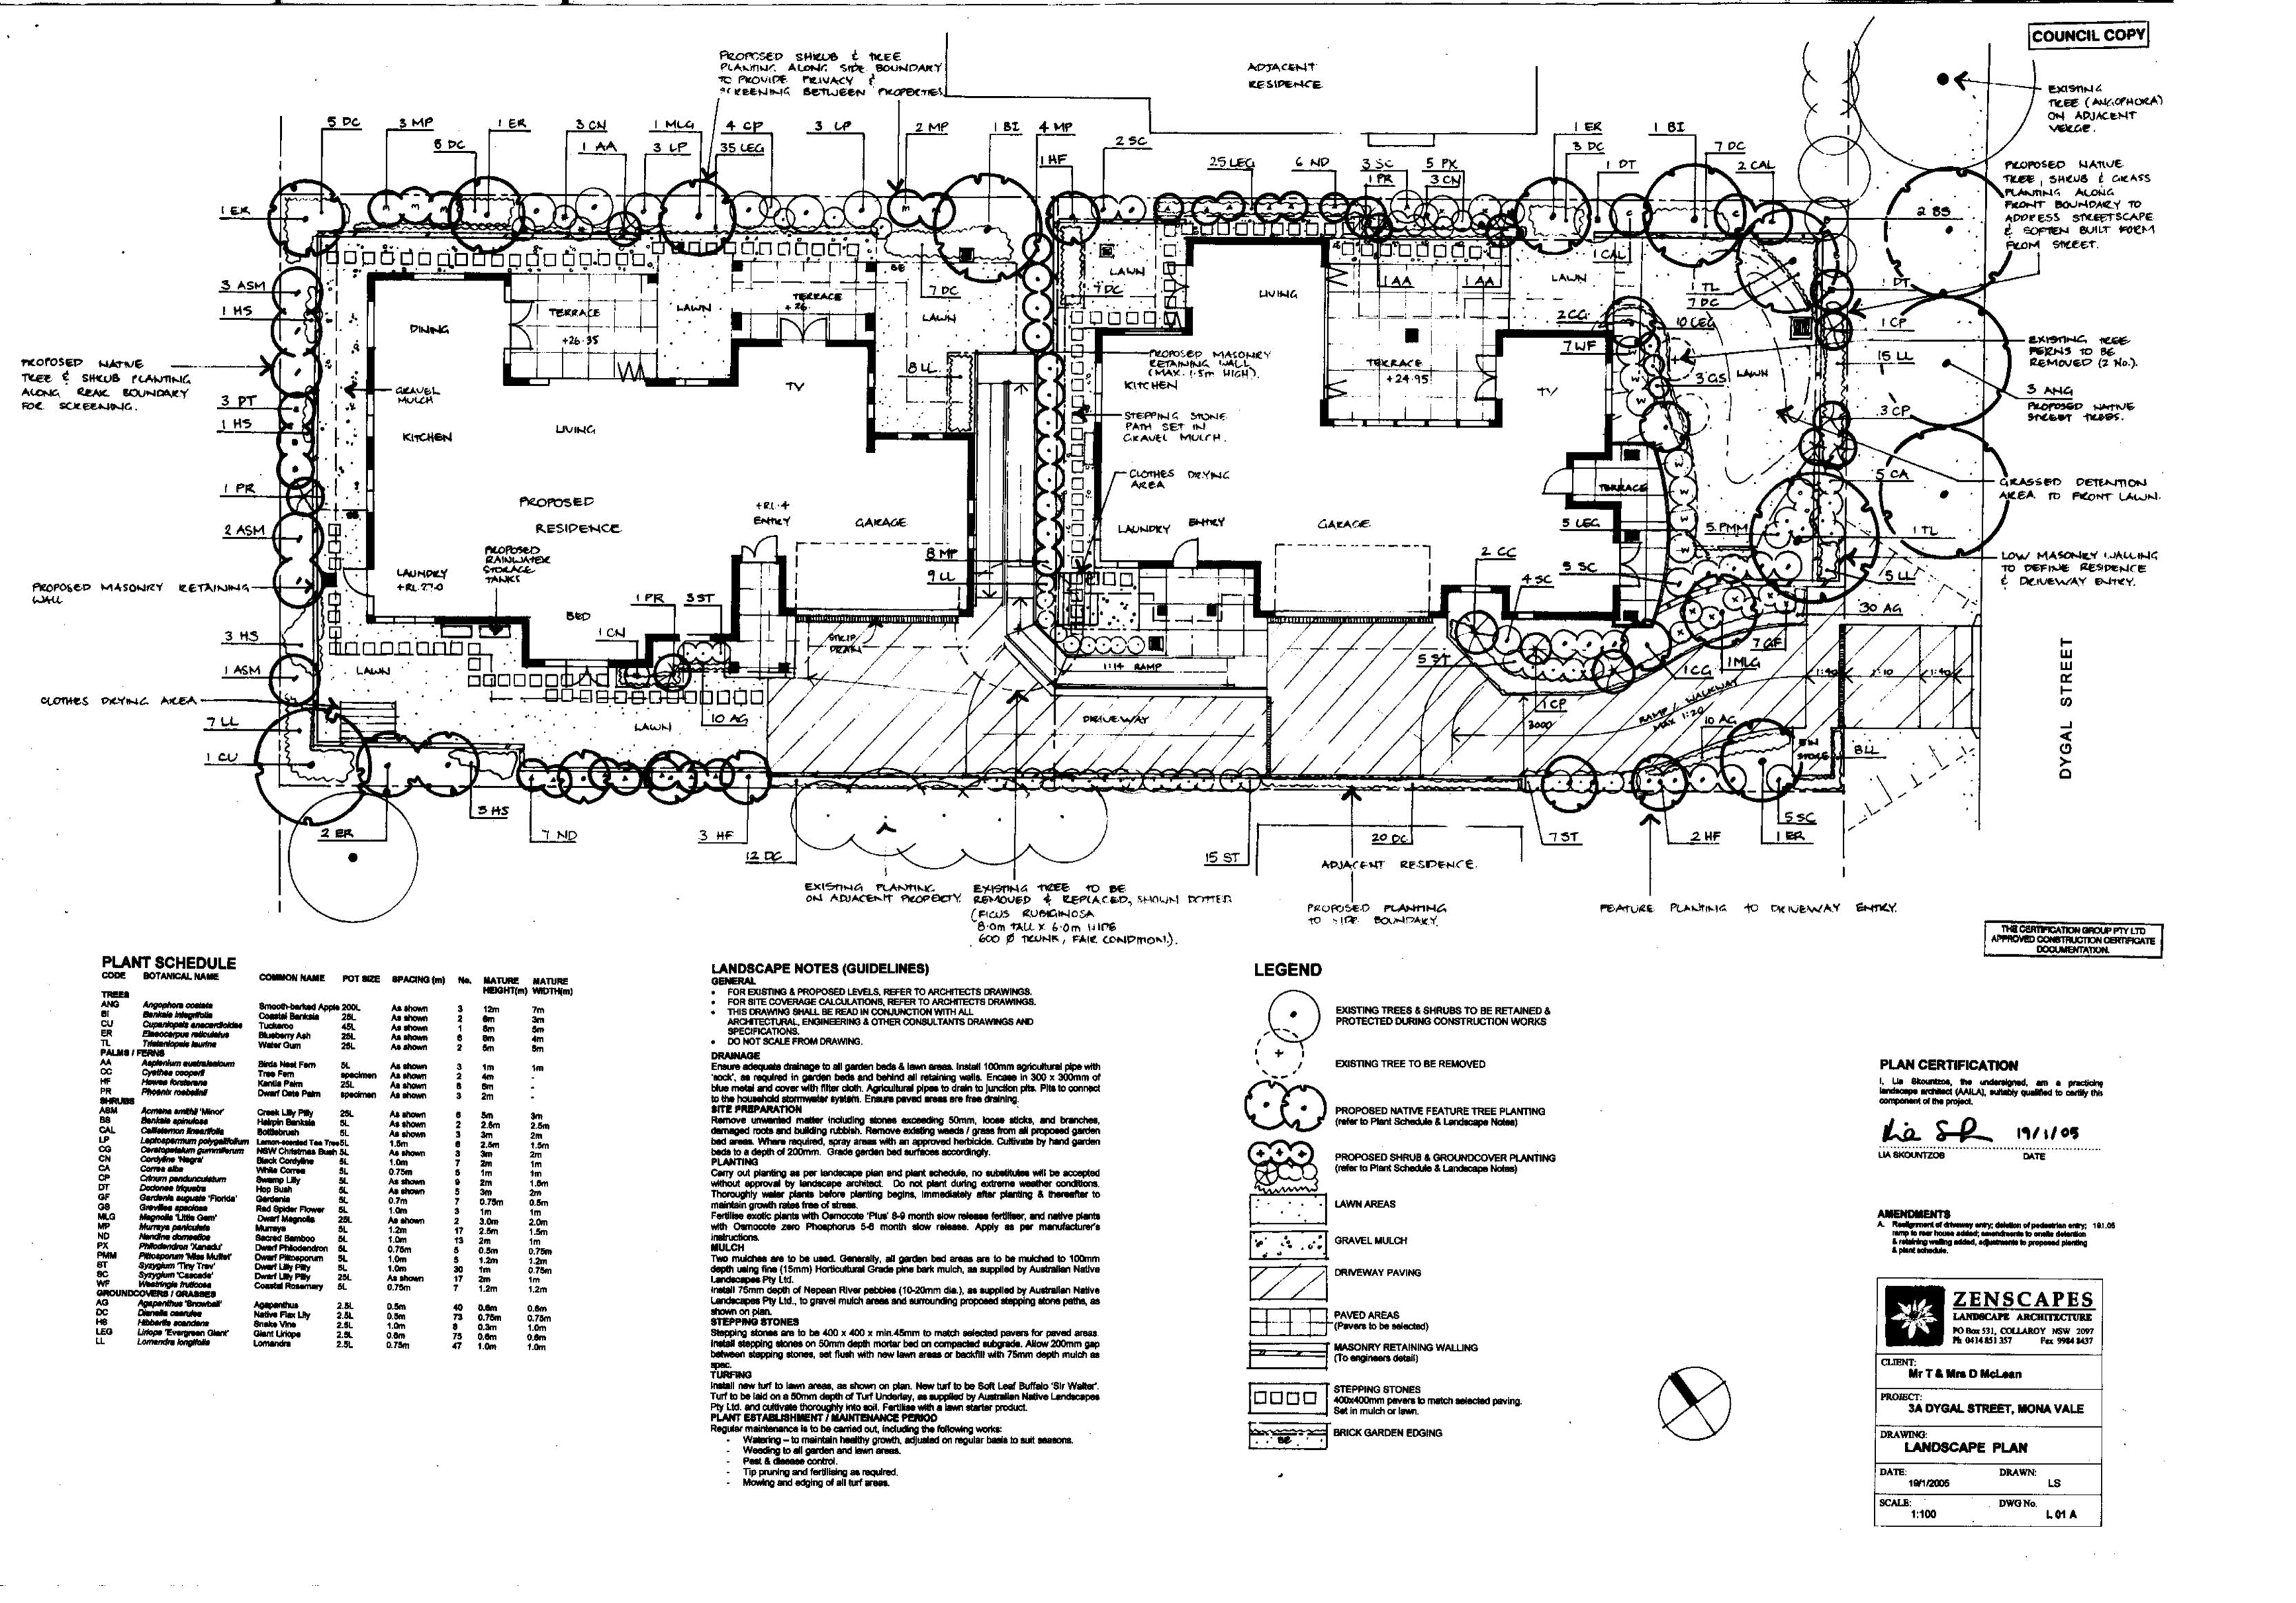

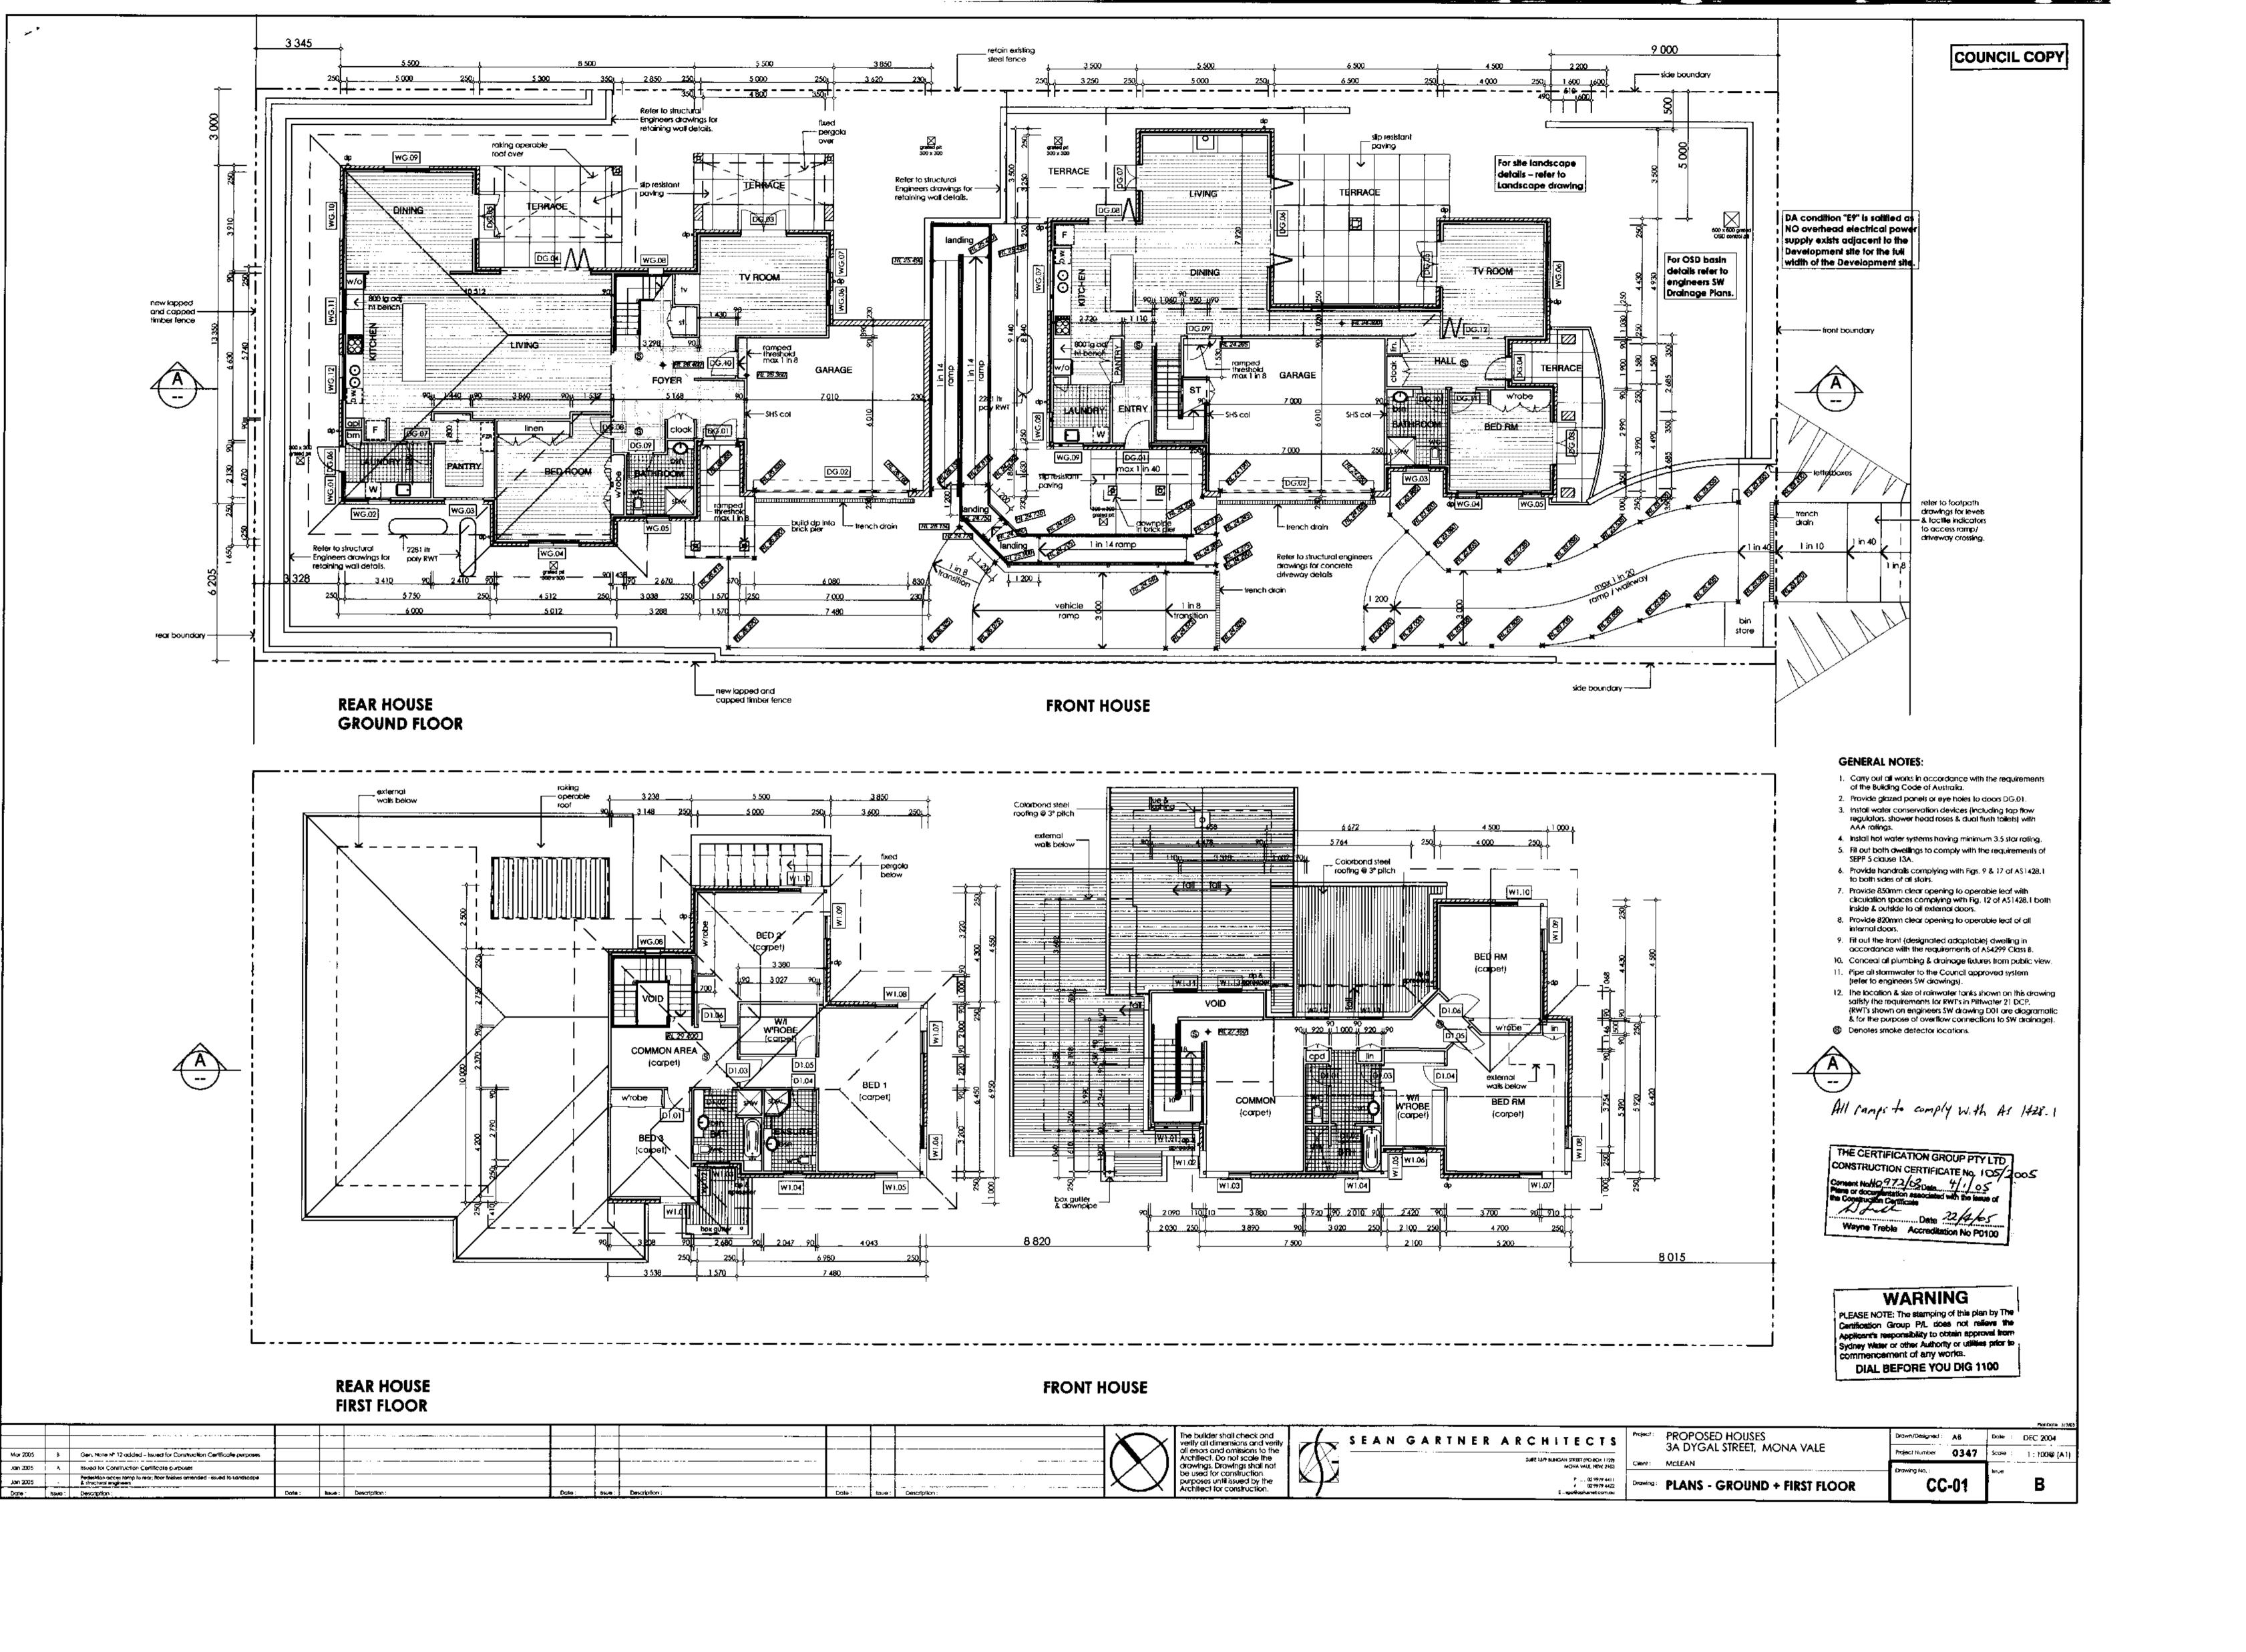


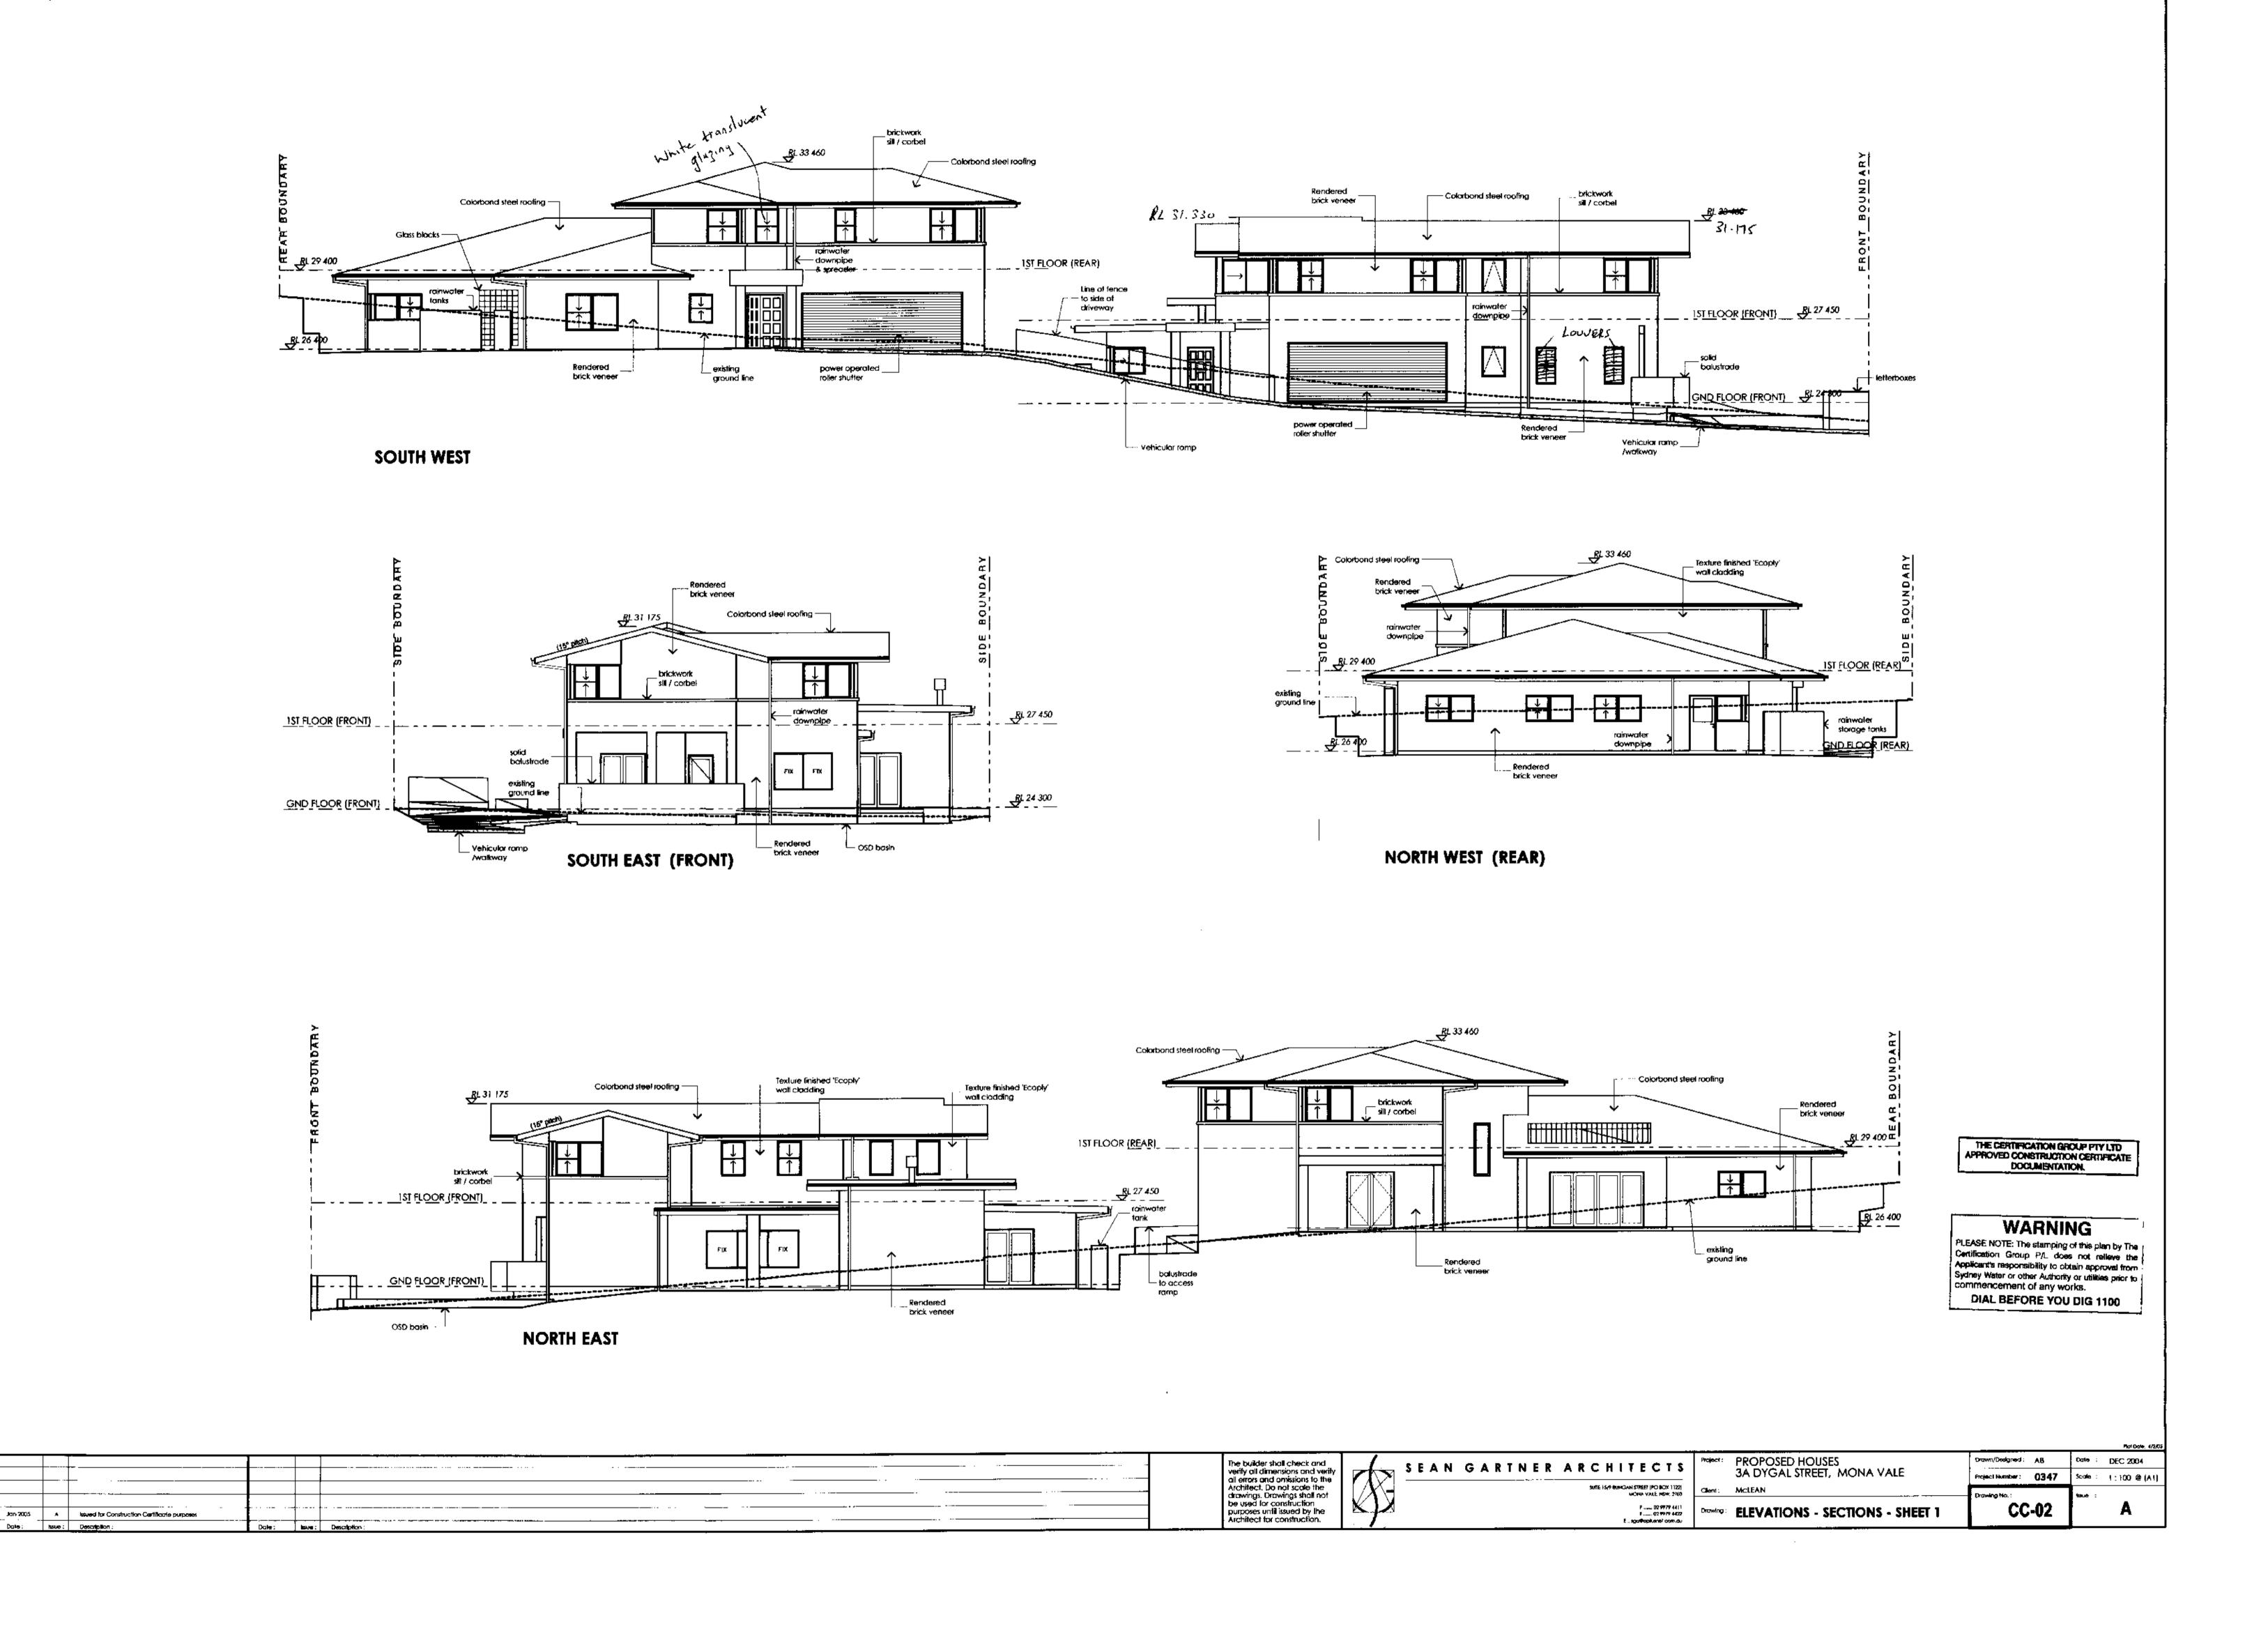

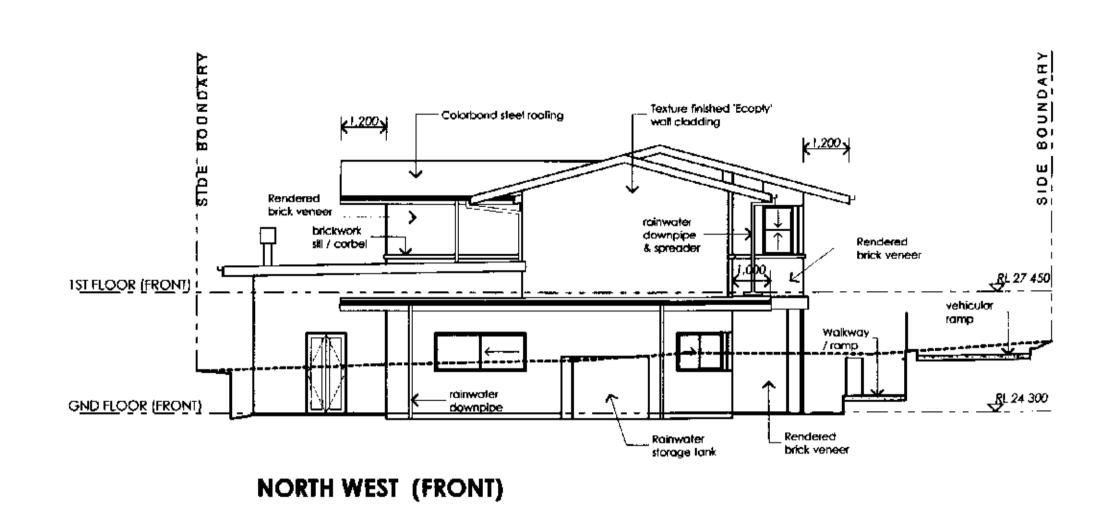

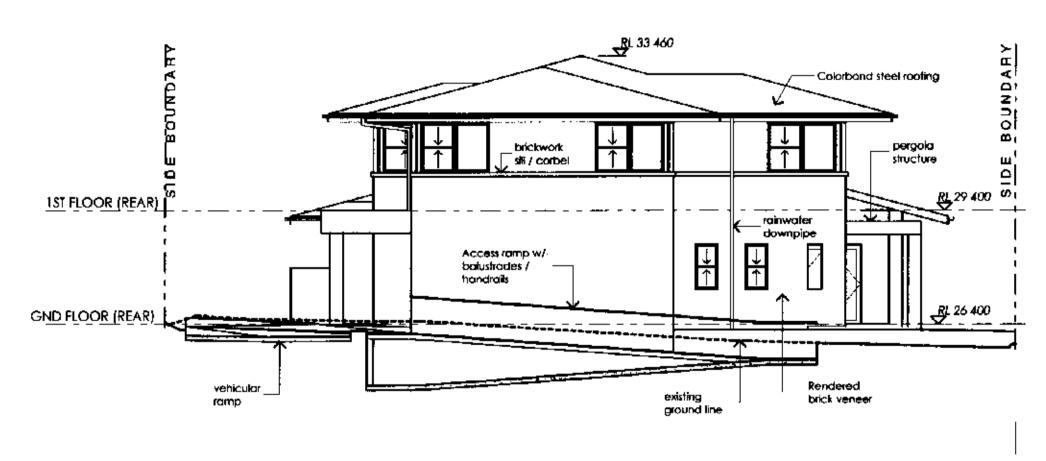

SOUTH EAST (REAR)

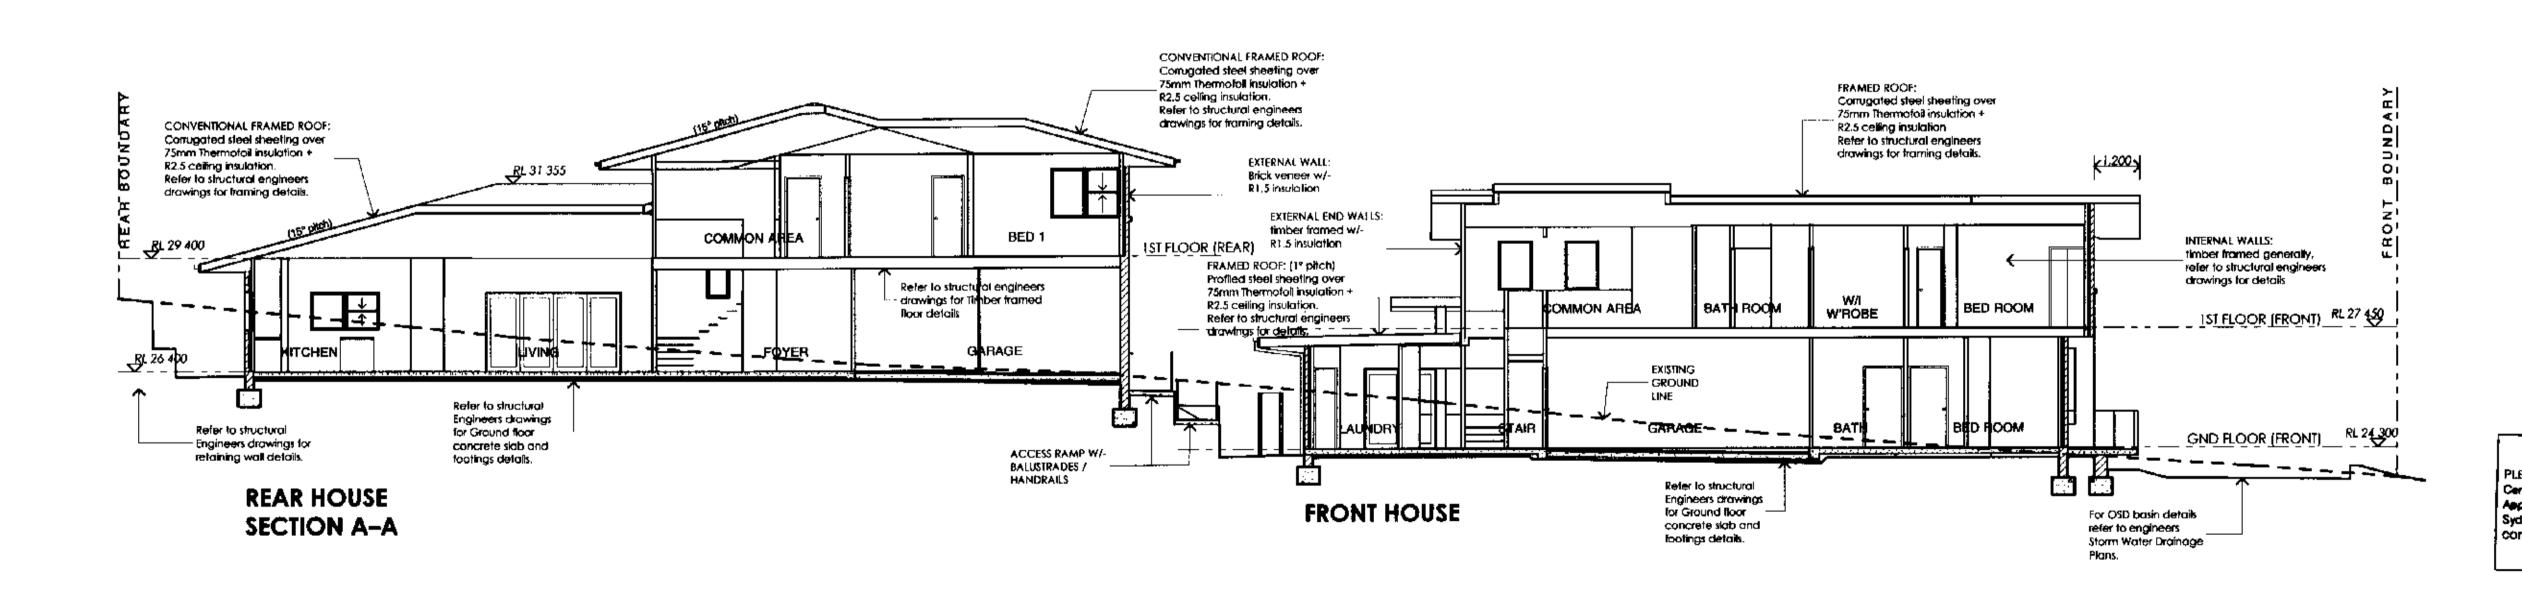

WARNING

PLEASE NOTE: The stamping of this plan by The Certification Group P/L does not relieve the Applicant's responsibility to obtain approval from Sydney Water or other Authority or utilities prior to commencement of any works.


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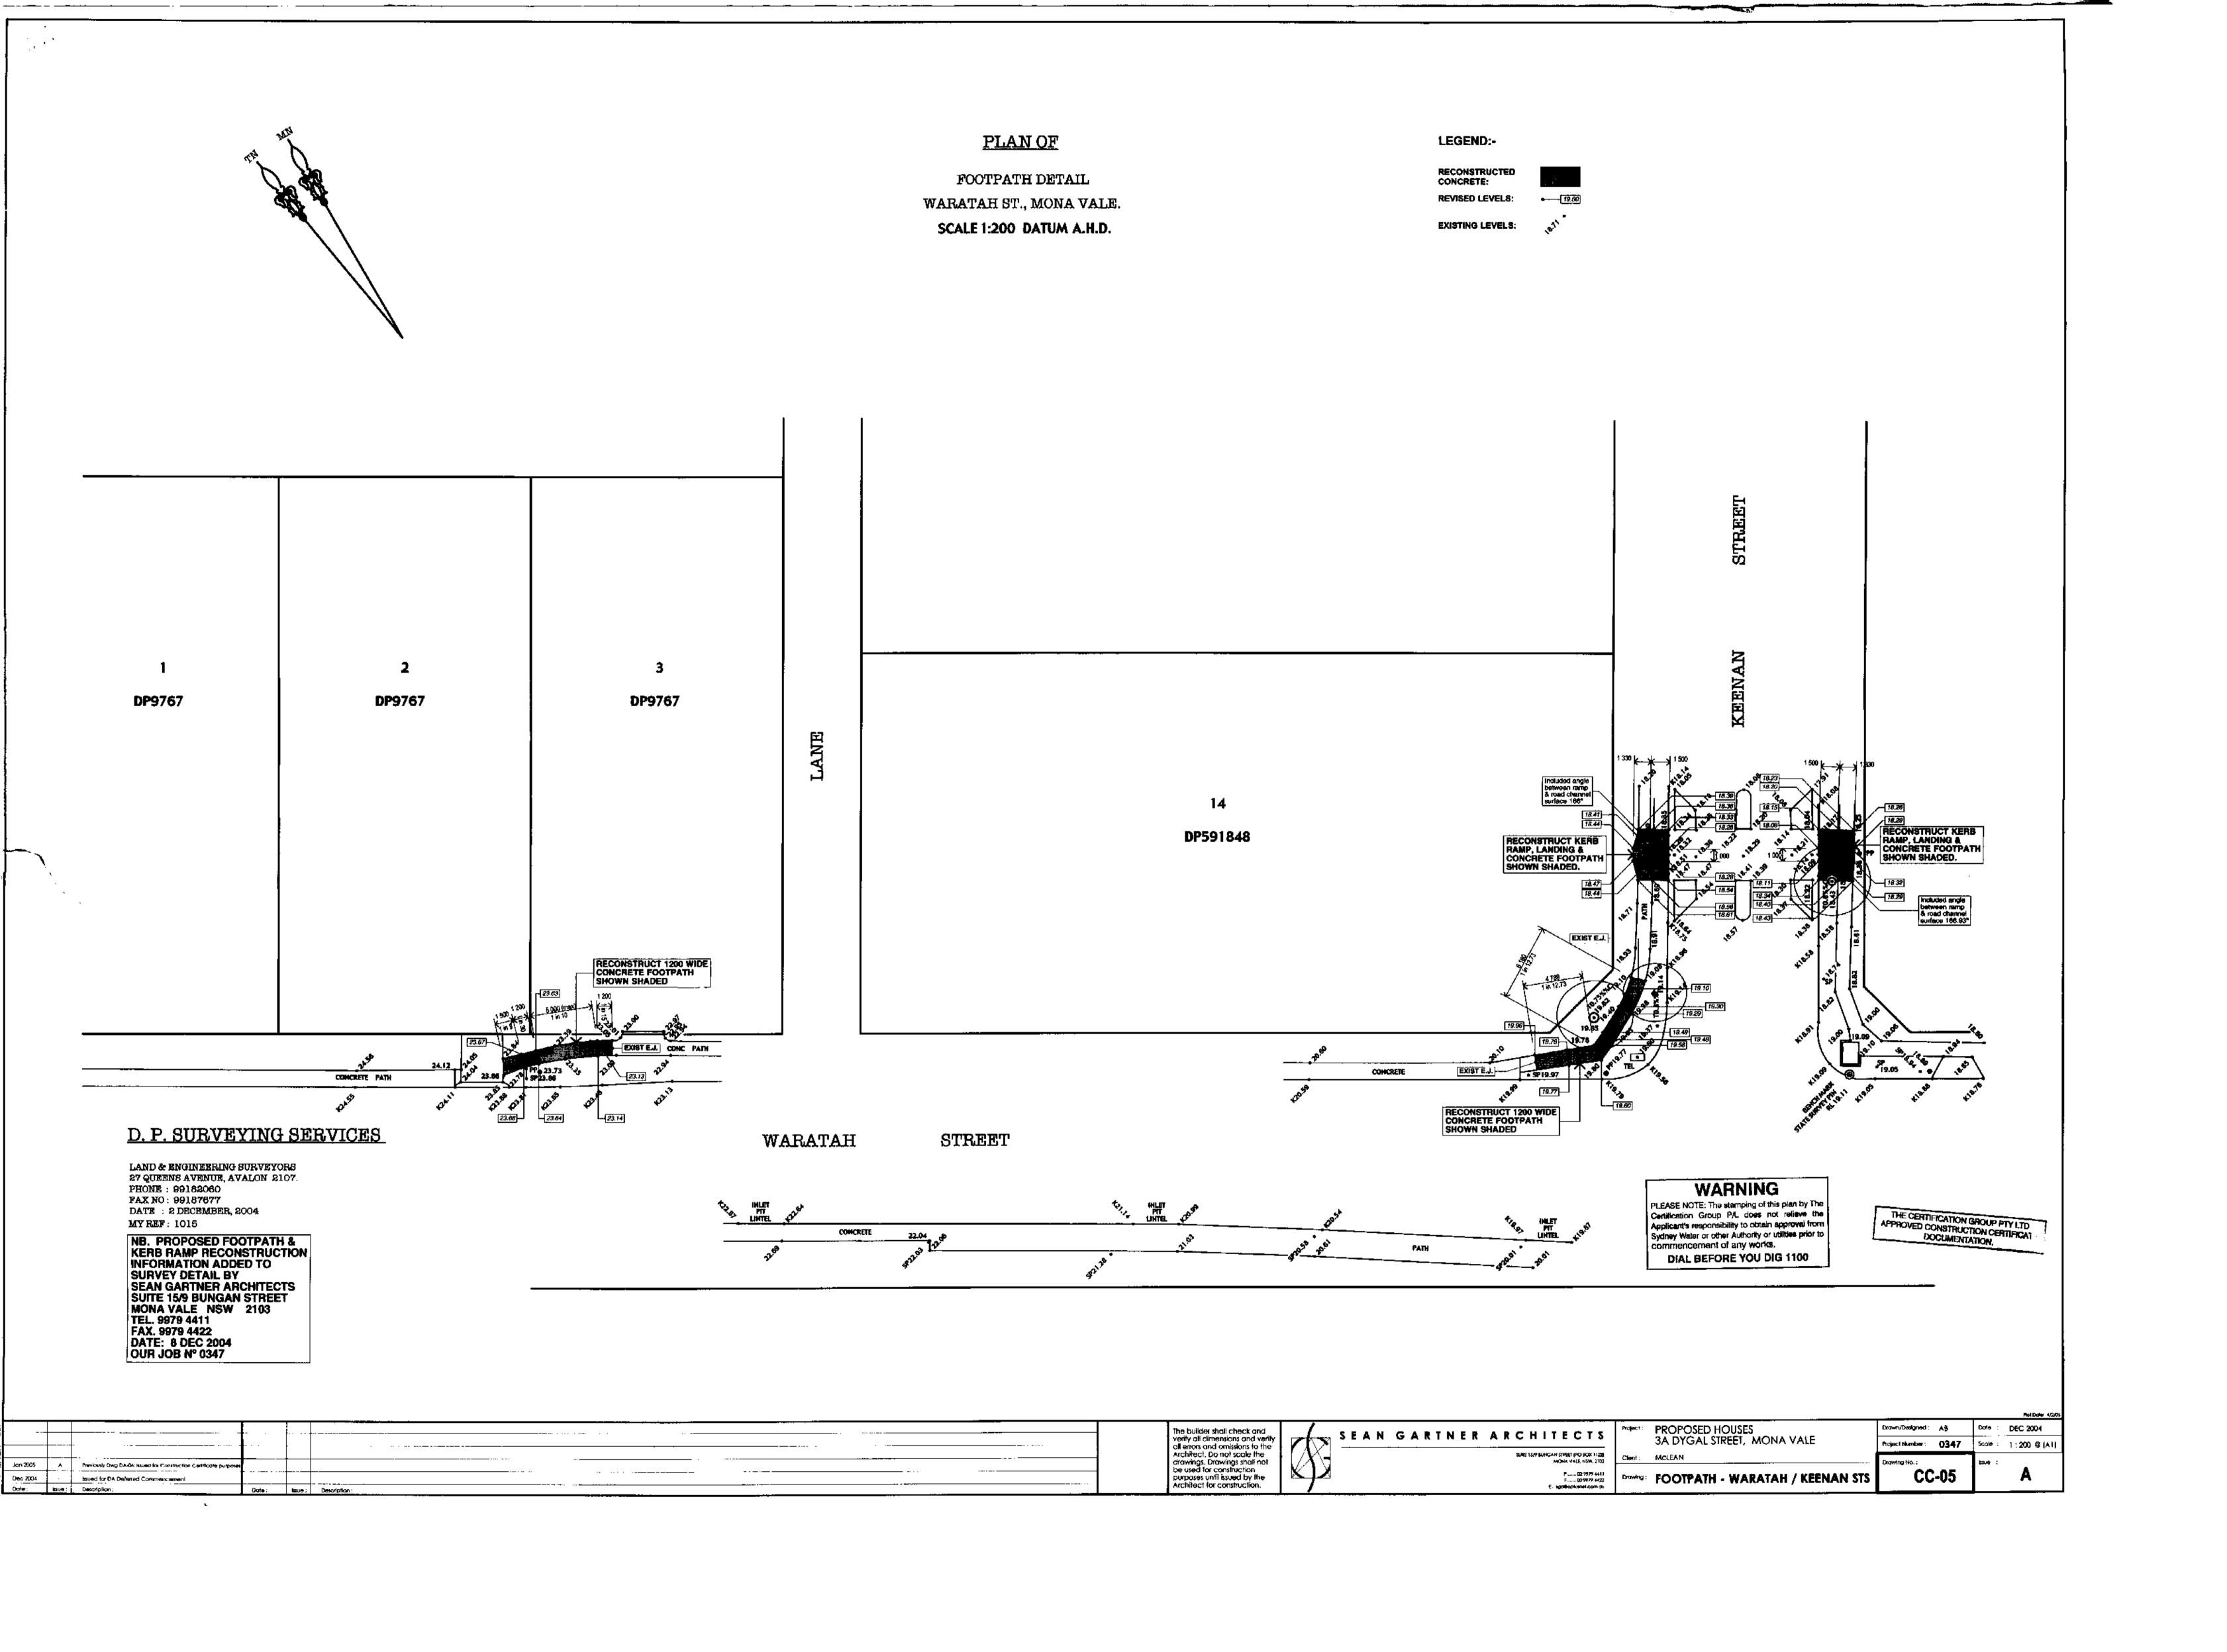
THE CERTIFICATION GROUP PTY LTD

APPHOVED CONSTRUCTION CERTIFICATE

DOCUMENTATION.

				Pol Cole: 4/7/05
		The builder shall check and verify all dimensions and verify all errors and emissions to the	R ARCHITECTS PROPOSED HOUSES 3A DYGAL STREET, MONA VALE	Project Number: 0347 Scale: 1:100 @ (A1)
		Architect, Do not scale the drawings. Drawings shall not	SUITE 15/9 BUMSAN STREET [PO BOX 1122] MONA VALE MSM. 2163 CRAM: MCLEAN	— Drawling No. : Issue :
Jan 2005	A Insued for Construction Certificate purposes	be used for construction purposes until issued by the Architect for construction.	P 92997 4411 F. 10 19 19 74 4422 E. 100 90 70 4422 E. 100 90 70 4422	CC-03 A
Dole: k	se: Description.	Date: Issue: Description:		



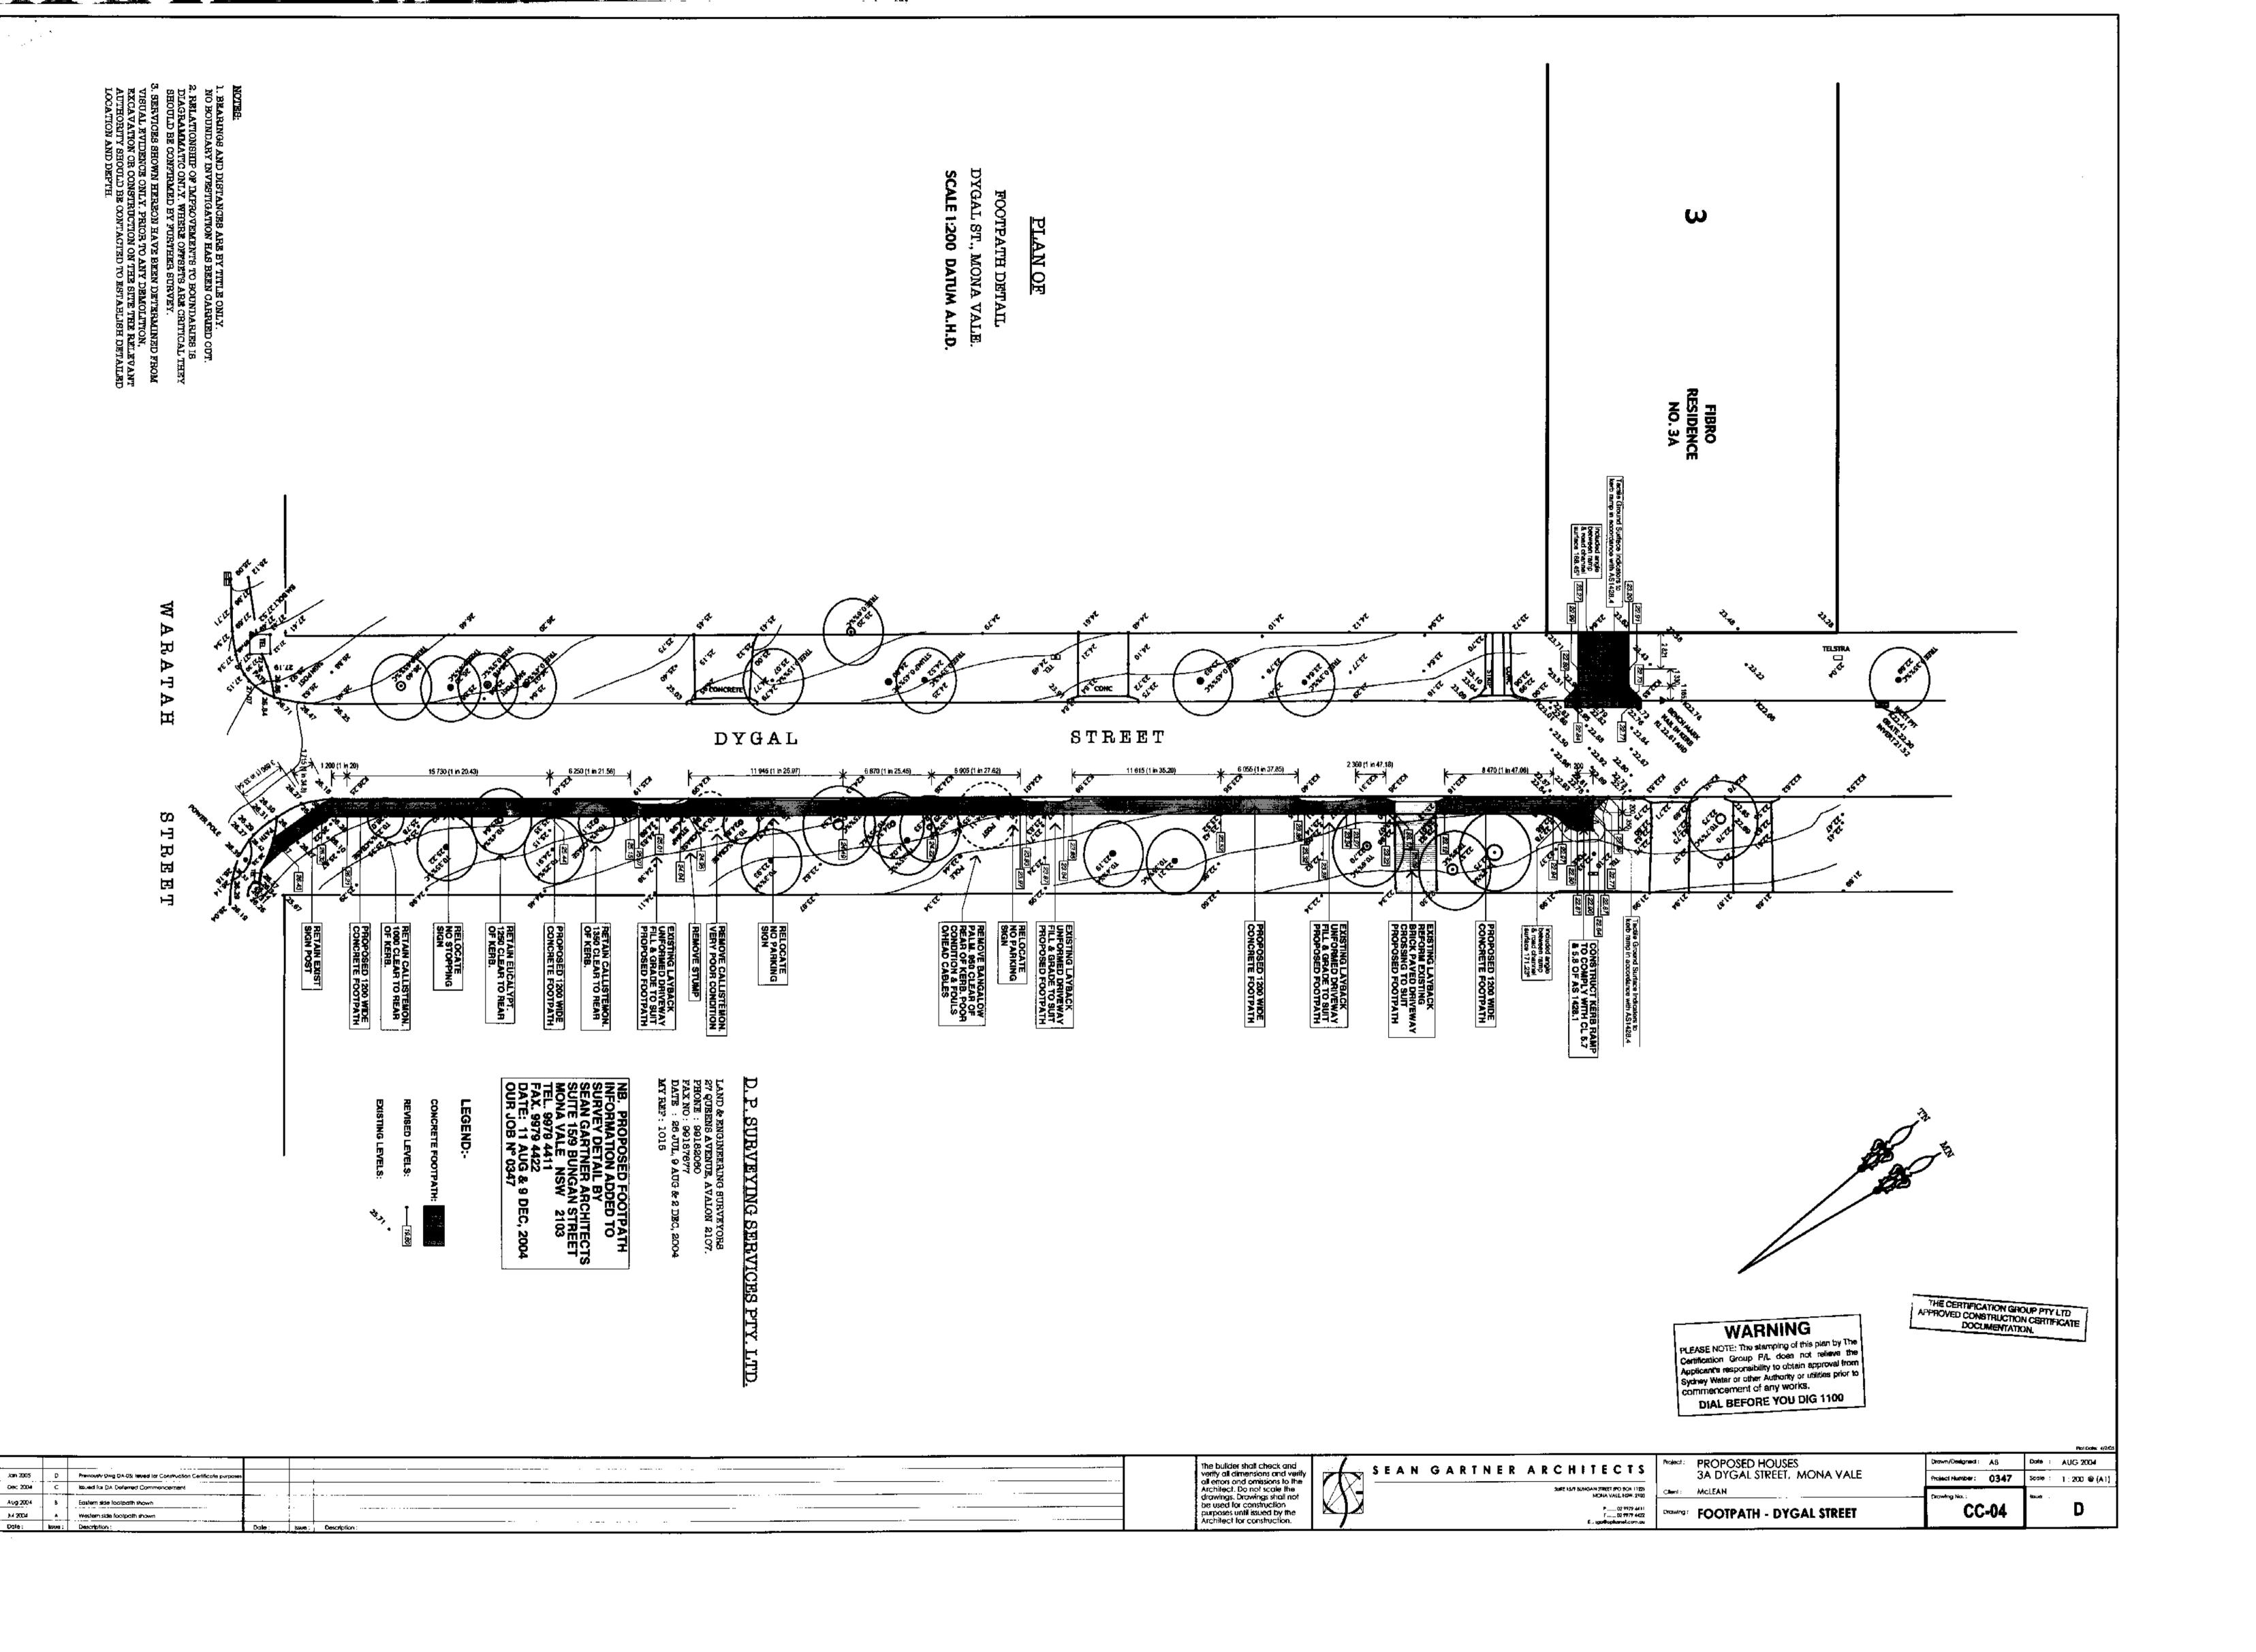

GENERAL NOTES:

GENERAL

- G). The drawings are to be read together with all Architects drawings and
- G2. Dimensions shall not be obtained by scaling from the drawings. All setting out dimensions shall be verified and discrepancies shall be referred to the Engineer prior to commencement of work.
- G3. Care is required during construction so that structural elements are not over stressed and that the works and excavations required therefore are kept stable at all times.
- G4. Design, materials and workmanship are to be in accordance with current S.A.A standards and statutory authority regulations except where varied by these documents.
- G5. Design live loads are in accordance with AS 1170.1
- G6. Builder to ensure stability of existing structures in the vicinity of excavation works.

FOOTINGS

- FI FOUNDATION STRATA IS ASSUMED FOR DESIGN PURPOSES IN ACCORDANCE AS 2870. SEE FOOTNOTE. CLASSIFICATION TO BE VERIFIED BY A GEOTECHNICAL ENGINEER COMMISSIONED BY THE CLIENT FOR CERTIFICATION OF FOUNDATIONS.
- F2. Footings to be constructed and back filled as soon as possible following excavation to avoid softening by rain or drying out by exposure.
- F3. Footings must bear into undisturbed natural ground clear of organic material. Refer to details.
- F4. If rock or variable bearing strata is encountered during excavation of the footings all footings/piers are to be excavated to similar material of greater bearing capacity. The Engineer is to be contacted at that time for approval or review.
- F5. Footings to be cost in approved material having an allowable capacity as follows:

Sand Foundations:

SA1. Required bearing capacity 100 kPa.

SA2. Trenches must be cleaned of all debris and hand compacted prior to placement of reinforcement.

Clay Foundations:

- CL1. Required bearing capacity 150 kPa.
- CL2. Trenches must be cleaned of all debris. Soft spots must be cut out and filled as per compacted fill notes, prior to placement of reinforcement.

Shale Foundations:

- SHI. Required bearing capacity 400 kPa.
- SH2. Excavation for footings into shale must be cost or capped with plain concrete on the same day as excavation.

Sandstone Foundations:

- 551, Required bearing capacity 600 kPa.
- 552. Scrape weathered surface to remove cleaved sandstone under footings.

Refer adjacent for assumed Design bearing strata.

F6. Future development of neighboring properties may effect ground water conditions on this site. Consequently, reactivity in subgrade beneath footings may be locally altered therefore putting footing at risk of differential settlement. We recommend that, particularly in clay subgrades, agricultural drainage is installed to the upstream perimeter of the building at a distance from the building which is outside the zone of influence of the footings. The agricultural drain must be installed below the fluctuating seasonal zone which should be identified by geotechnical investigation.

CONCRETE

- Cl. All workmanship and materials shall be in accordance with AS 3600.
- C2. Concrete quality shall be as follows and shall be verified by tests.
- C3. All concrete unless otherwise noted shall have a slump of 80mm at point of placement, a max. aggregate size of 20 mm. No water shall be added to the mix prior to or during placement of concrete. Strength as specified on plans.
- C4. Clear concrete cover to reinforcement shall be as follows unless otherwise shown∽

ELEMENT	INTERIOR	EXTERIOR	EXTERIOR CAST AGAINST GROUND
FOOTINGS	-	-	50
COLUMNS/PEDESTALS	30 UNO	REFER TO PLAN	
SLABS/WALLS	25	REFER TO PLAN	40 ON MEMBRANE
BEAMS	25 UNO	REFER TO PLAN	50
BLOCKWORK	55	FACE	

- C5. Sizes of concrete elements do not include thickness of applied finishes.
- C6. All Construction Joints locations shall be approved by the Structural Engineer.
- C7. Beam depths are written first and include slab thickness, if any.
- C8. No holes or chases other than those shown on the structural drowings shall be made in concrete elements without the prior approval of the
- C9. Shrinkage reducing admixtures such as 'Eclipse' or approved equivalent, if specified, must be added to mix prior to pour.

- CIO. Water reducing agents, if specified, must be added to mix prior to pour. No extra water is to be added to increase slump.
- C11. Where vertical slab/beam surfaces are formed against a masonry (or other) wall, provide 10 mm styrene separation material.
- CI2. Water must not be added to concrete mix prior to placement of concrete.
- CI3. Above covers may have to be adjusted if fire rating is a requirement.

REINFORCEMENT

- RI. All reinforcement specified is Grade D500 unless noted otherwise.
- R2. Reinforcement is represented diagrammatically it is not necessarily shown in true projection.
- R3. Top reinforcement is to be continuous over supports. Bottom reinforcement to be lapped at supports.
- R4. Welding of reinforcement shall not be permitted unless shown on the structural drawinas.
- R5. Pipes or conduits shall not be placed within the zone of concrete cover to the reinforcement without the approval of the engineer.
- R6. All reinforcing bars and fabric shall comply with AS 4671-2001.
- R7. Reinforcement symbols:
 - N Grade 500N deformed bar (D500) Normal Ductility R - Grade 250N plain round bar (R250) Normal Ductility
- SL Grade 500L welded deformed ribbed mesh (D500)
- Square Low Ductility. RL - Grade 500L welded deformed ribbed mesh (D500)
- Rectangular Law Ductility. The number immediately following these symbols is the number of millimeters in the bar diameter.
- Example 8 N12-250, denotes 8. Grade 500N deformed bars, 12 mm diameter at 250 cts.
- R8. Fabric reinforcement to be lapped 1 complete square + 25 mm unless noted otherwise.
- R9 All reinforcement shall be firmly supported on bar chairs spaced at a maximum of 750 centres both ways under rod and fabric reinforcement. Reinforcement shall be tied at alternate intersections.

FORMWORK

- FWI. Formwork must be cleaned of all debris prior to costing of concrete.
- FW2. Minimum stripping times for form work shall be as recommended in AS 1509 or as directed by the engineer.
- FW3. The finished concrete shall be a dense homogeneous mass, completely filling the form work, thoroughly embedding the reinforcement and free of stone pockets. All concrete elements including slabs on ground and footings shall be compacted with mechanical vibrators.
- FW4. Curing of all concrete is to be achieved by keeping surfaces continuously wet for a period of 3 days, followed by prevention of loss of moisture for seven days followed by a gradual drying out. Approved sprayed on curing compounds may be used where no floor finishes are proposed. Polythene sheeting or wet hession may be used if protected from wind and traffic.

BRICKWORK

- BRI. Brickwork is to be constructed to AS 3700.
- BR2. Two layers of approved greased metal based slip material shall be used over all load bearing walls that support concrete slabs and placed on smooth brickwork or trawelled mortar finish. Non load-bearing walls shall have 10 mm compressible material and ties to the slab soffit.
- BR3. No brickwork shall be constructed on suspended slabs until all propping has been removed from the underside of the slab and the
- concrete has the specified 28 day cylinder strength verified by tests. BR4. Control joints to be placed at a maximum of 8m centres
- or in accordance with AS 3700. BR5. Exposure grade bricks to be used below damp proof course.
- BR6. Vertical control joint material where specified on plan between slabs and brick walls shall be: 10 mm Spandex External UNO. Bitumastic fibreboard internal UNO.
- BR7. Provide stainless steel wall ties below DPC to AS 3700. Provide galvanized wall ties above DPC to AS 3700 \$ Local Council Specifications.

BLOCKWORK

- BLI. Concrete blacks shall have a minimum compressive strength of 15 MPa and conform to AS 1500. Masonry to be constructed to AS 3700.
- BL2. Where cores of hollow blocks are to be filled, properly compacted 20MPa concrete with 10 mm aggregate and 230 mm slump shall be used. Clean out openings must be utilized for all cores.
- BL3. Location of actual starters is critical to suit block cores, allow 55 mm cover from the outside face of blackwork. All reinforcement lap lenaths to conform to AS 3600.
- BL4. Control joints to be placed at a maximum of 8 m centres or in accordance with AS 3700.
- BL5. Vertical control joint material where specified on plan between slabs and brick walls shall be: 10 mm Spandex External UNO. Bitumastic fibreboard internal UNO.

- BL6. Retaining walls or any reinforced and concrete core filled block walls to be of Double 'U' Block Construction.
- BL7. No blockwork shall be constructed on suspended slabs until all propping has been removed from the underside of the slab and the concrete has the specified 28 day cylinder strength verified by tests. unless approved by the Structural Engineer.
- BL8. Max. pour height for unrestrained blockwork is 2000.

- St. All Structural steelwork to be Grade 300 or greater. Design, fabrication and erection to be in accordance
- 52. Materials and workmanship shall comply with AS 1250 1981, SAA Steel
- Structures Code and the specification for Structural Steel. 53. Rolled steel sections including steel plates shall comply with AS 3678 - 1990.
- 54. Cold formed steel sections shall be Grade 450 Zinc coated in accordance with AS 1538-1988.
- 55. Welded and seamless steel hollow sections shall comply with AS 1163. Grade 350.
- S6. Bolt Designation: 4.65 - Commercial bolts Grade 4.6, snug tightened.
- 8.85 High Strength structural bolts Grade 8.8, snug tightened. 8.8TB - High Strength structural bolts Grade 8.8, fully tightened to AS 1511
- and acting as a Bearing Joint. 8.8TF - High Strength structural bolts Grade 8.8, fully tensioned to AS 1511 and acting as a Bearing Joint.
- Unless noted otherwise, all boits will be 8.85. 57. Unless shown otherwise, minimum connection shall be 2M16 bolts, 10 thick
- ausset plates, 6mm continuous fillet welds, 58. Load indicating washers shall be used in all fully tensioned joints. (8.8TF \$ 8.8TB). 59. All welding shall be carried out in accordance with AS 1554 SAA Structural Steel
- Welding Code \$10. Unless noted otherwise all welds shall be category SP using E41xx Electrodes. All butt welds shall be complete penetration butt welds category SP.
- SII. Grouting of anchor bolt sleeves and base plates shall be completed by the contractor using High Strength, Non-Shrink grout.
- S12. Fabrication and erection tolerances for Structural Steelwork shall be in
- accordance with AS 4100.
- S13. Purlin boits shall be M12 4.65 galvanised. SI4. Steel work shall have one of the following grades of corrosion protection:-
- INTERNAL a. Thoroughly cleaned wire brushing, followed by two coats of zinc
 - phosphate primer equivalent to Dulux Luxaprime applied by hand using brushes to achieve a total dry film thickness of 70 microns.

EXTERNAL ELEMENTS, & ELEMENTS WITHIN EITHER SKIN OF EXTERNAL CAVITY WALLS

- b. Preparation Blast clean to a minimum standard Class 2.5 in accordance with AS 1627 Part 4. Primer 2-pack epoxy phosphate at dft 75 microns (Dulux Durepon PI4). Barrier Coat 2-pack epoxy micaeous iron oxide, dft 100 microns Finish Coat 2-pack epoxy high gloss acrylic to dft 75 microns (e.g. Dulux Acrathane I F) in an approved colour.
- c. Hot dipped galvanized to AS 4680. Where the galvanic (Hot Dip Galvanized) coating is opmpromised by welding, bolting or damage, inorganic zinc-rich paint (minimum 95% zinc content) is to be applied after wire brushing affected area (use 3 coats minimum). or Hot Metal Spray in accordance with AS 4680.
- 515. Workshop drawings shall be prepared and two copies submitted to the engineer for review prior to fabrication commencement.

- TI. All workmanship and materials to be in accordance with AS 1684, AS 1720 and as 3959. All soft wood to be Grade F7 unless noted otherwise. All hardwood to be minimum Grade FI4 unless otherwise noted. Exposed timber to be CCA treated (to A5 1604) redried after full impregnation, or durability class I or 2.
- T2. All joists deeper than 150 to have blocking over support bearers and at a maximum 3000 centres.
- T3. Roof trueses to be designed by the manufacturer to the relevant standards. Pre comber to be an amount equal to dead load deflection u.n.o.
- T4. All holes for bolts to be exact size. Washers to be used under all heads and nuts and to be at least 2.5 times the bolt diameter. Bolts to be MI6 grade 4.6 unless noted otherwise.
- T5. Treat all exposed cut ends with Reseal by Protim to manufacturers specification to achieve required Hazard Level Exposure Classification.
- T6. Battens for T & G to be Kiln Dried to 12 %. 38mm minimum deep treated pine or as recommended by supplier. Flooring to be installed no sooner than 28 days after slab pour.
- T7. Hot dip galvanized nails/clouts/screws to be used with all timber connections.
- T8. Continuous nailing must not be used for any timber connections.
- T9. All exposed CCA treated pine to have an application of penetrating sealer to reduce warping and twist of the timber due to varying moisture content in service.

COMPACTED FILL

- CFI. Only to be used with approval Engineer # to be certified by
- a geotechnicai Engineer.
- CF2. Clear organic material and topsoil under proposed slabs/footings. CF3. Filling shall be granular material compacted in not more than 200 mm
- of 98 percent. CF4. During clearing and excavation for slabs and footings cut out soft spots and fill as above.

layers to a minimum dry density ratio (AS 1289/E4.2 1982)

DRAWING SCHEDULE:

SOI - GENERAL NOTES AND DRAWING SCHEDULE

SO2 - EXTERNAL WORKS PLAN

FOOTINGS AND RETAINING WALLS

SO3 - EXTERNAL WORKS SLAB PLAN

SO4 - EXTERNAL WORKS DETAILS FOOTINGS AND RETAINING WALLS

505 - EXTERNAL WORKS SLAB DETAILS

506 - FOOTINGS AND GROUND FLOOR SLAB PLAN


SO7 - FOOTINGS AND GROUND FLOOR SLAB DETAILS 508 - FIRST FLOOR AND LOWER ROOF FRAMING PLAN

SO9 - UPPER ROOF FRAMING PLAN

SIO - FRAMING DETAILS

- STORMWATER DRAINAGE PLAN

DO2 - STORMWATER DRAINAGE DETAILS

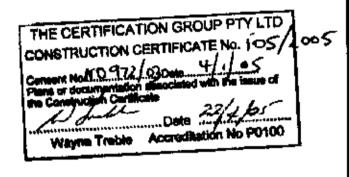

COUNCIL COPY

WARNING

PLEASE NOTE: The stamping of this plan by The Certification Group P/L does not relieve the Applicant's responsibility to obtain approval from Sydney Water or other Authority or utilities prior to commencement of any works. DIAL BEFORE YOU DIG 1100

ISSUED FOR CONSTRUCTION CERTIFICATE SUBMISSION ONLY

INSPECTIONS BY ENGINEER

- 48 HOURS NOTICE IS REQUIRED BEFORE ANY SITE INSPECTION
- Bearing strata of all footings prior to concrete pour.

Any reinforcement prior to concrete pour.

- Timber and Steel framing prior to cladding or lining.
- 4. Steel lintels after installation. CONTACT YOUR PCA (Principal Certifying Authority) AS TO REQUIREMENTS FOR MANDATORY CRITICAL STAGE INSPECTIONS IN ACCORDANCE WITH REVISED EP\$A ACT REGULATIONS EFFECTIVE JULY 1, 2004.

ASSUMED FOUNDATION CLASSIFICATION FOR DESIGN PURPOSES - 'M' ASSUMED BEARING STRATA FOR DESIGN PURPOSES - CLAY, 150 kPa. CONTRACTOR TO VERIFY FOUNDATION CLASSIFICATION

Date: GENERAL NOTES

Nov 2004 AND DRAWING SCHEDULE

OMIEAust. Drawing No: Job No: 501

Drawn:

Paul R Bruce

Design:

L.M.

DOCUMENT CERTIFICATION

I am a qualified Structural/Civil Engineer. I hold the following qualifications: BE(Civil), CPEng, MIEAuet., NPER. Institute of Engineers Membership No. 788184 I hereby state that this drawing is in compliance with the provisions of the Building Code of Australia and/or relevant Australian/Industry





PROPOSED HOUSES at: 3A Dygal Street Mona Vale for: Tom McClean

Drawing Title:

The copyright of this drawing remains with Northern Beaches Consulting Engineers P/L

Lucas Molloy (Director Northern Beaches Consulting Engineers) Rev: Amendment:

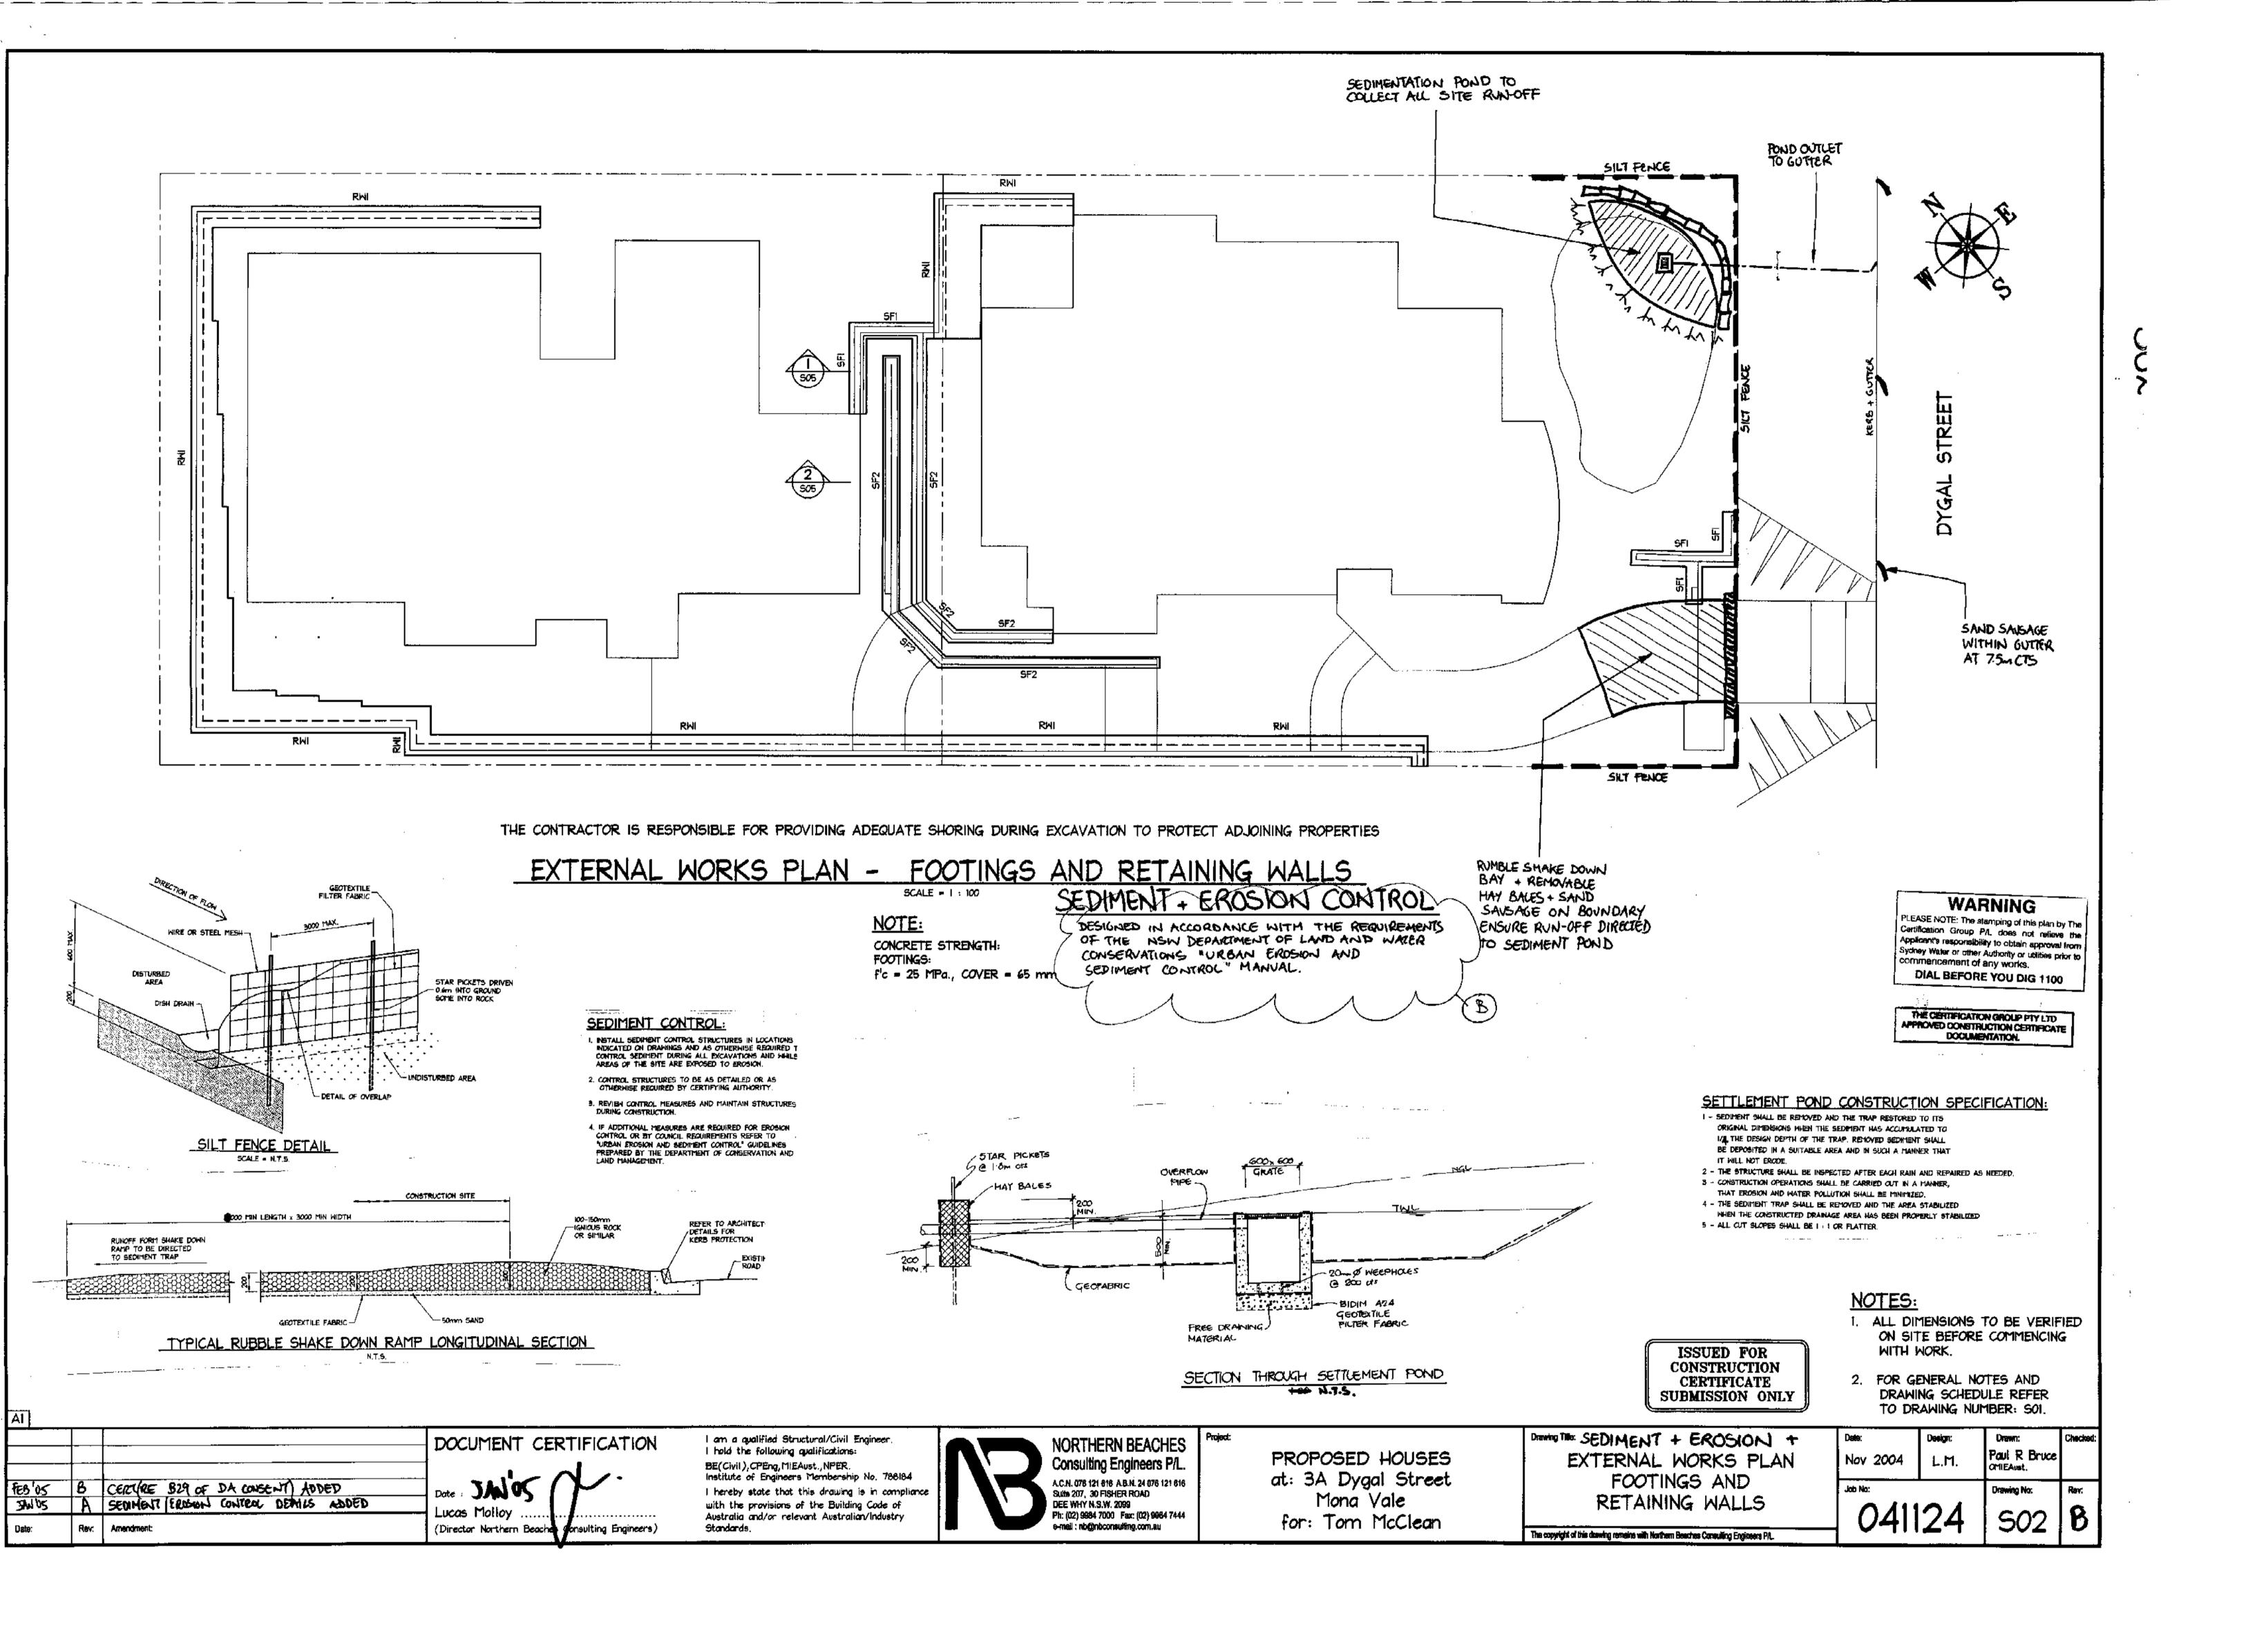

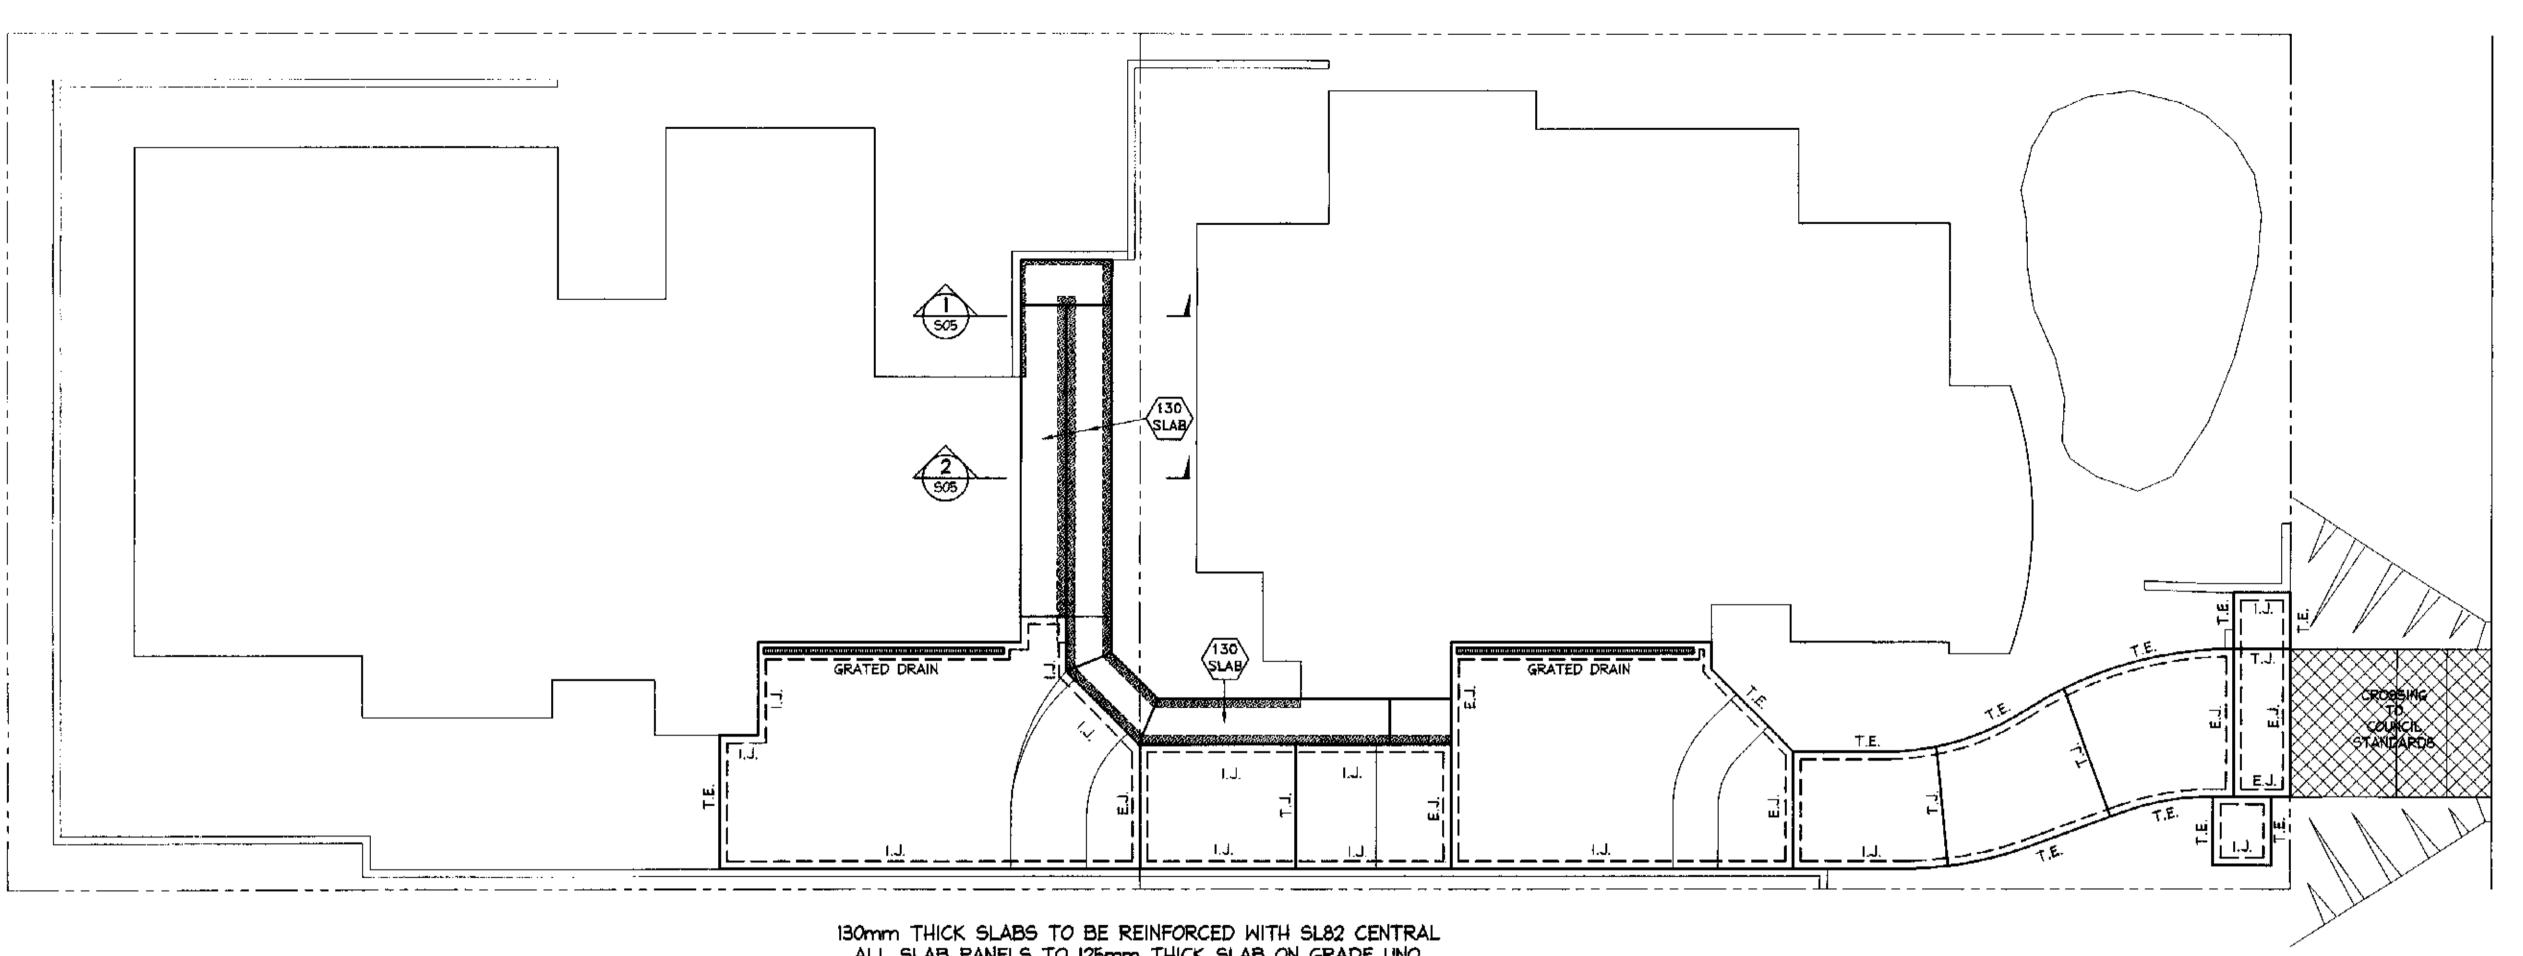

ALL SLAB PANELS TO 125mm THICK SLAB ON GRADE UNO. ALL SLAB PANELS TO BE REINFORCED WITH SLB2 TOP UNO

EXTERNAL WORKS SLAB PLAN

NOTE:

CONCRETE STRENGTH: EXTERNAL SLABS: f'c = 40 MPa., COVER = 45 mm

THE GERTIFICATION GROUP PTY LTD APPROVED CONSTRUCTION CERTIFICATE DOCUMENTATION.

NOTES:

- 1. ALL DIMENSIONS TO BE VERIFIED ON SITE BEFORE COMMENCING WITH WORK.
- FOR GENERAL NOTES AND DRAWING SCHEDULE REFER TO DRAWING NUMBER: SOI.

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CERTIFICATE
SUBMISSION ONLY

	DOCUMENT CERTIFICATION
	 0 1 1
<u>.</u>	Date: JANGS /
-	Lucas Mallay

(Director Northern Beaches Consulting Engineers)

A1

Rev: Amendment:

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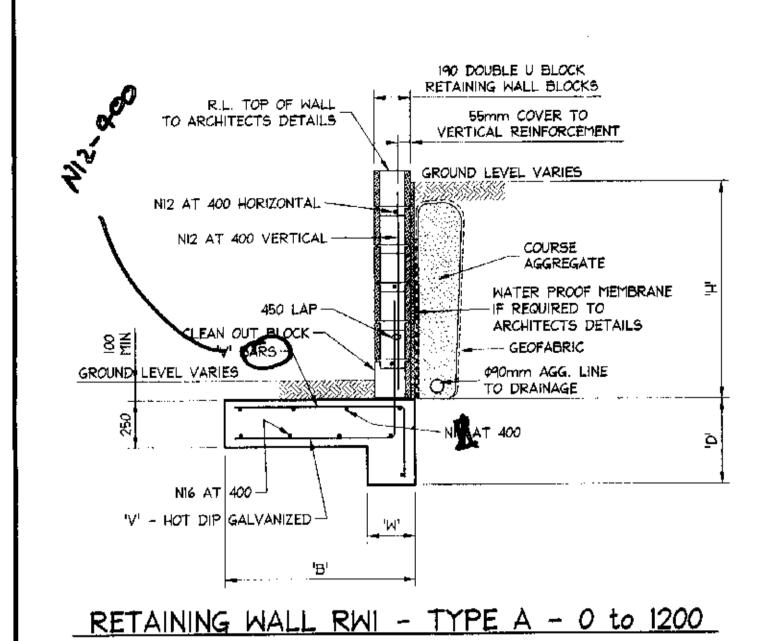



PROPOSED HOUSES at: 3A Dygai Street Mona Vale for: Tom McClean


EXTERNAL WORKS SLAB PLAN
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Drawing Title:


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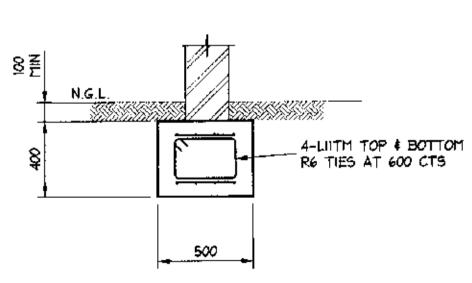





RETAINING WALL RWI - TYPE B - 1400 to 2000

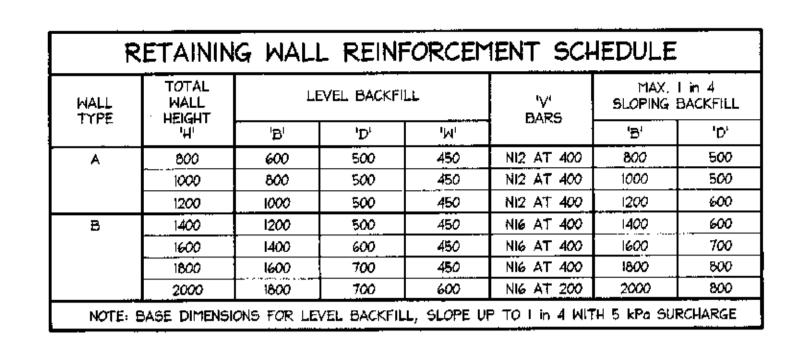

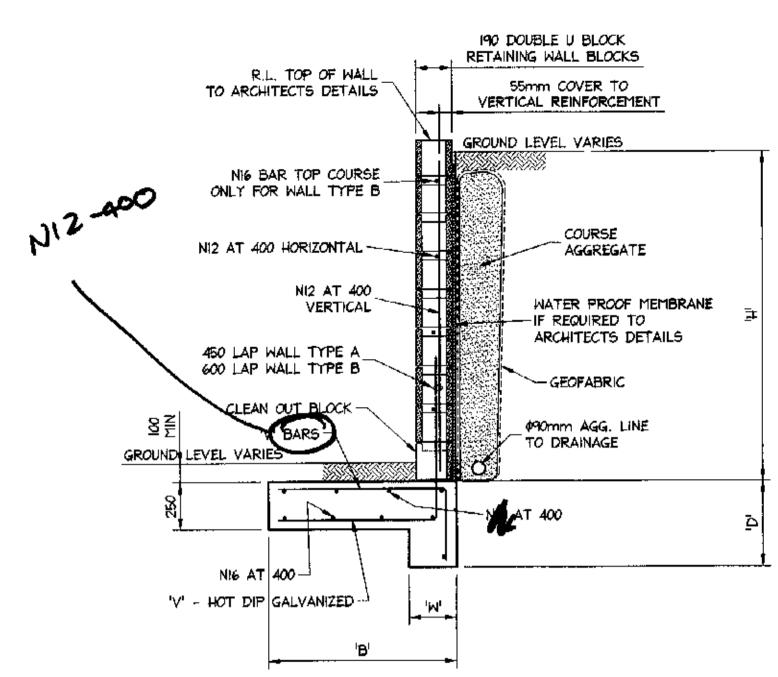


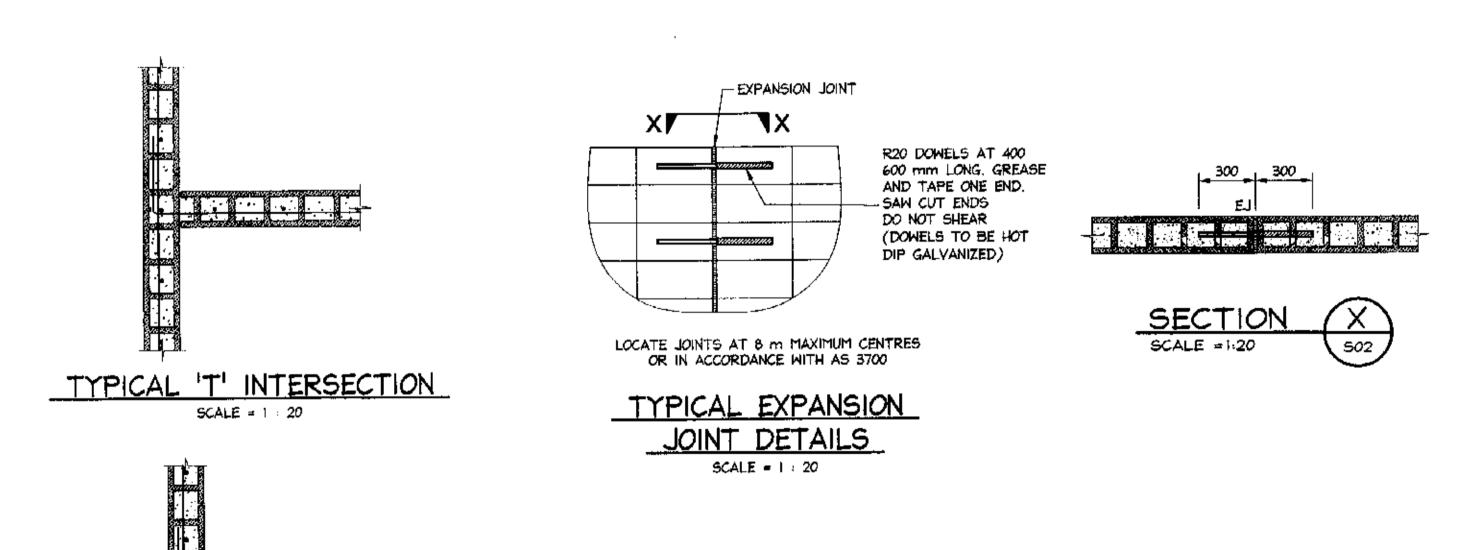

TYPE 'SFI' STRIP FOOTING

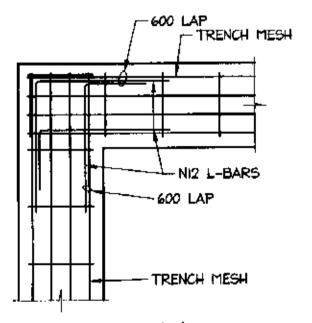


PLAN FOOTING CORNER SCALE = 1 : 20

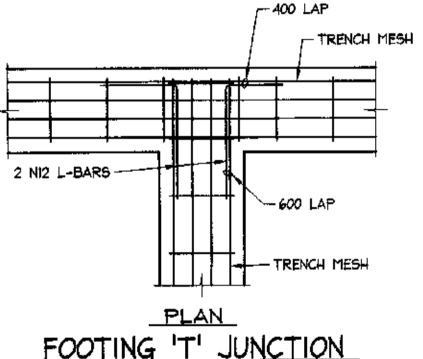

FOOTING 'T' JUNCTION

SCALE = 1 : 20

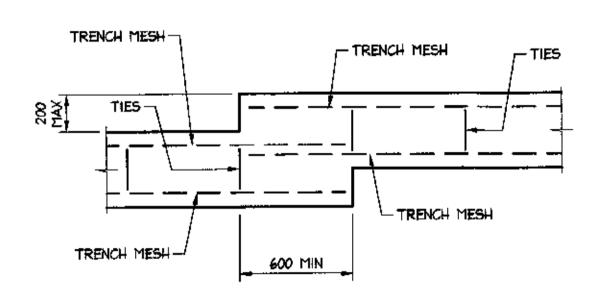

TYPICAL STEP FOOTING DETAILS

THE CERTIFICATION GROUP PTY LTD
APPROVED CONSTRUCTION CERTIFICATE
DOCUMENTATION.

NOTES:

- I. ALL DIMENSIONS TO BE VERIFIED ON SITE BEFORE COMMENCING WITH WORK.
- FOR GENERAL NOTES AND DRAWING SCHEDULE REFER TO DRAWING NUMBER: SOI.

\ }			
	-		DOCUMENT CERTIFICATION
-	-		Date: Jan 5 Lucas Molloy (Director Northern Beaches Consulting Engineers)
Date:	Rev:	Amendment:	(Director Northern Beaches Northulting Engineers)

I am a qualified Structural/Civil Engineer.
I hold the following qualifications:
BE(Civil), CPEng, MIEAust., NPER.
Institute of Engineers Membership No. 788184
I hereby state that this drawing is in compliance with the provisions of the Building Code of Australia and/or relevant Australian/Industry Standards.



PROPOSED HOUSES at: 3A Dygal Street Mona Vale for: Tom McClean EXTERNAL WORKS DETAILS
FOOTINGS AND
RETAINING WALLS

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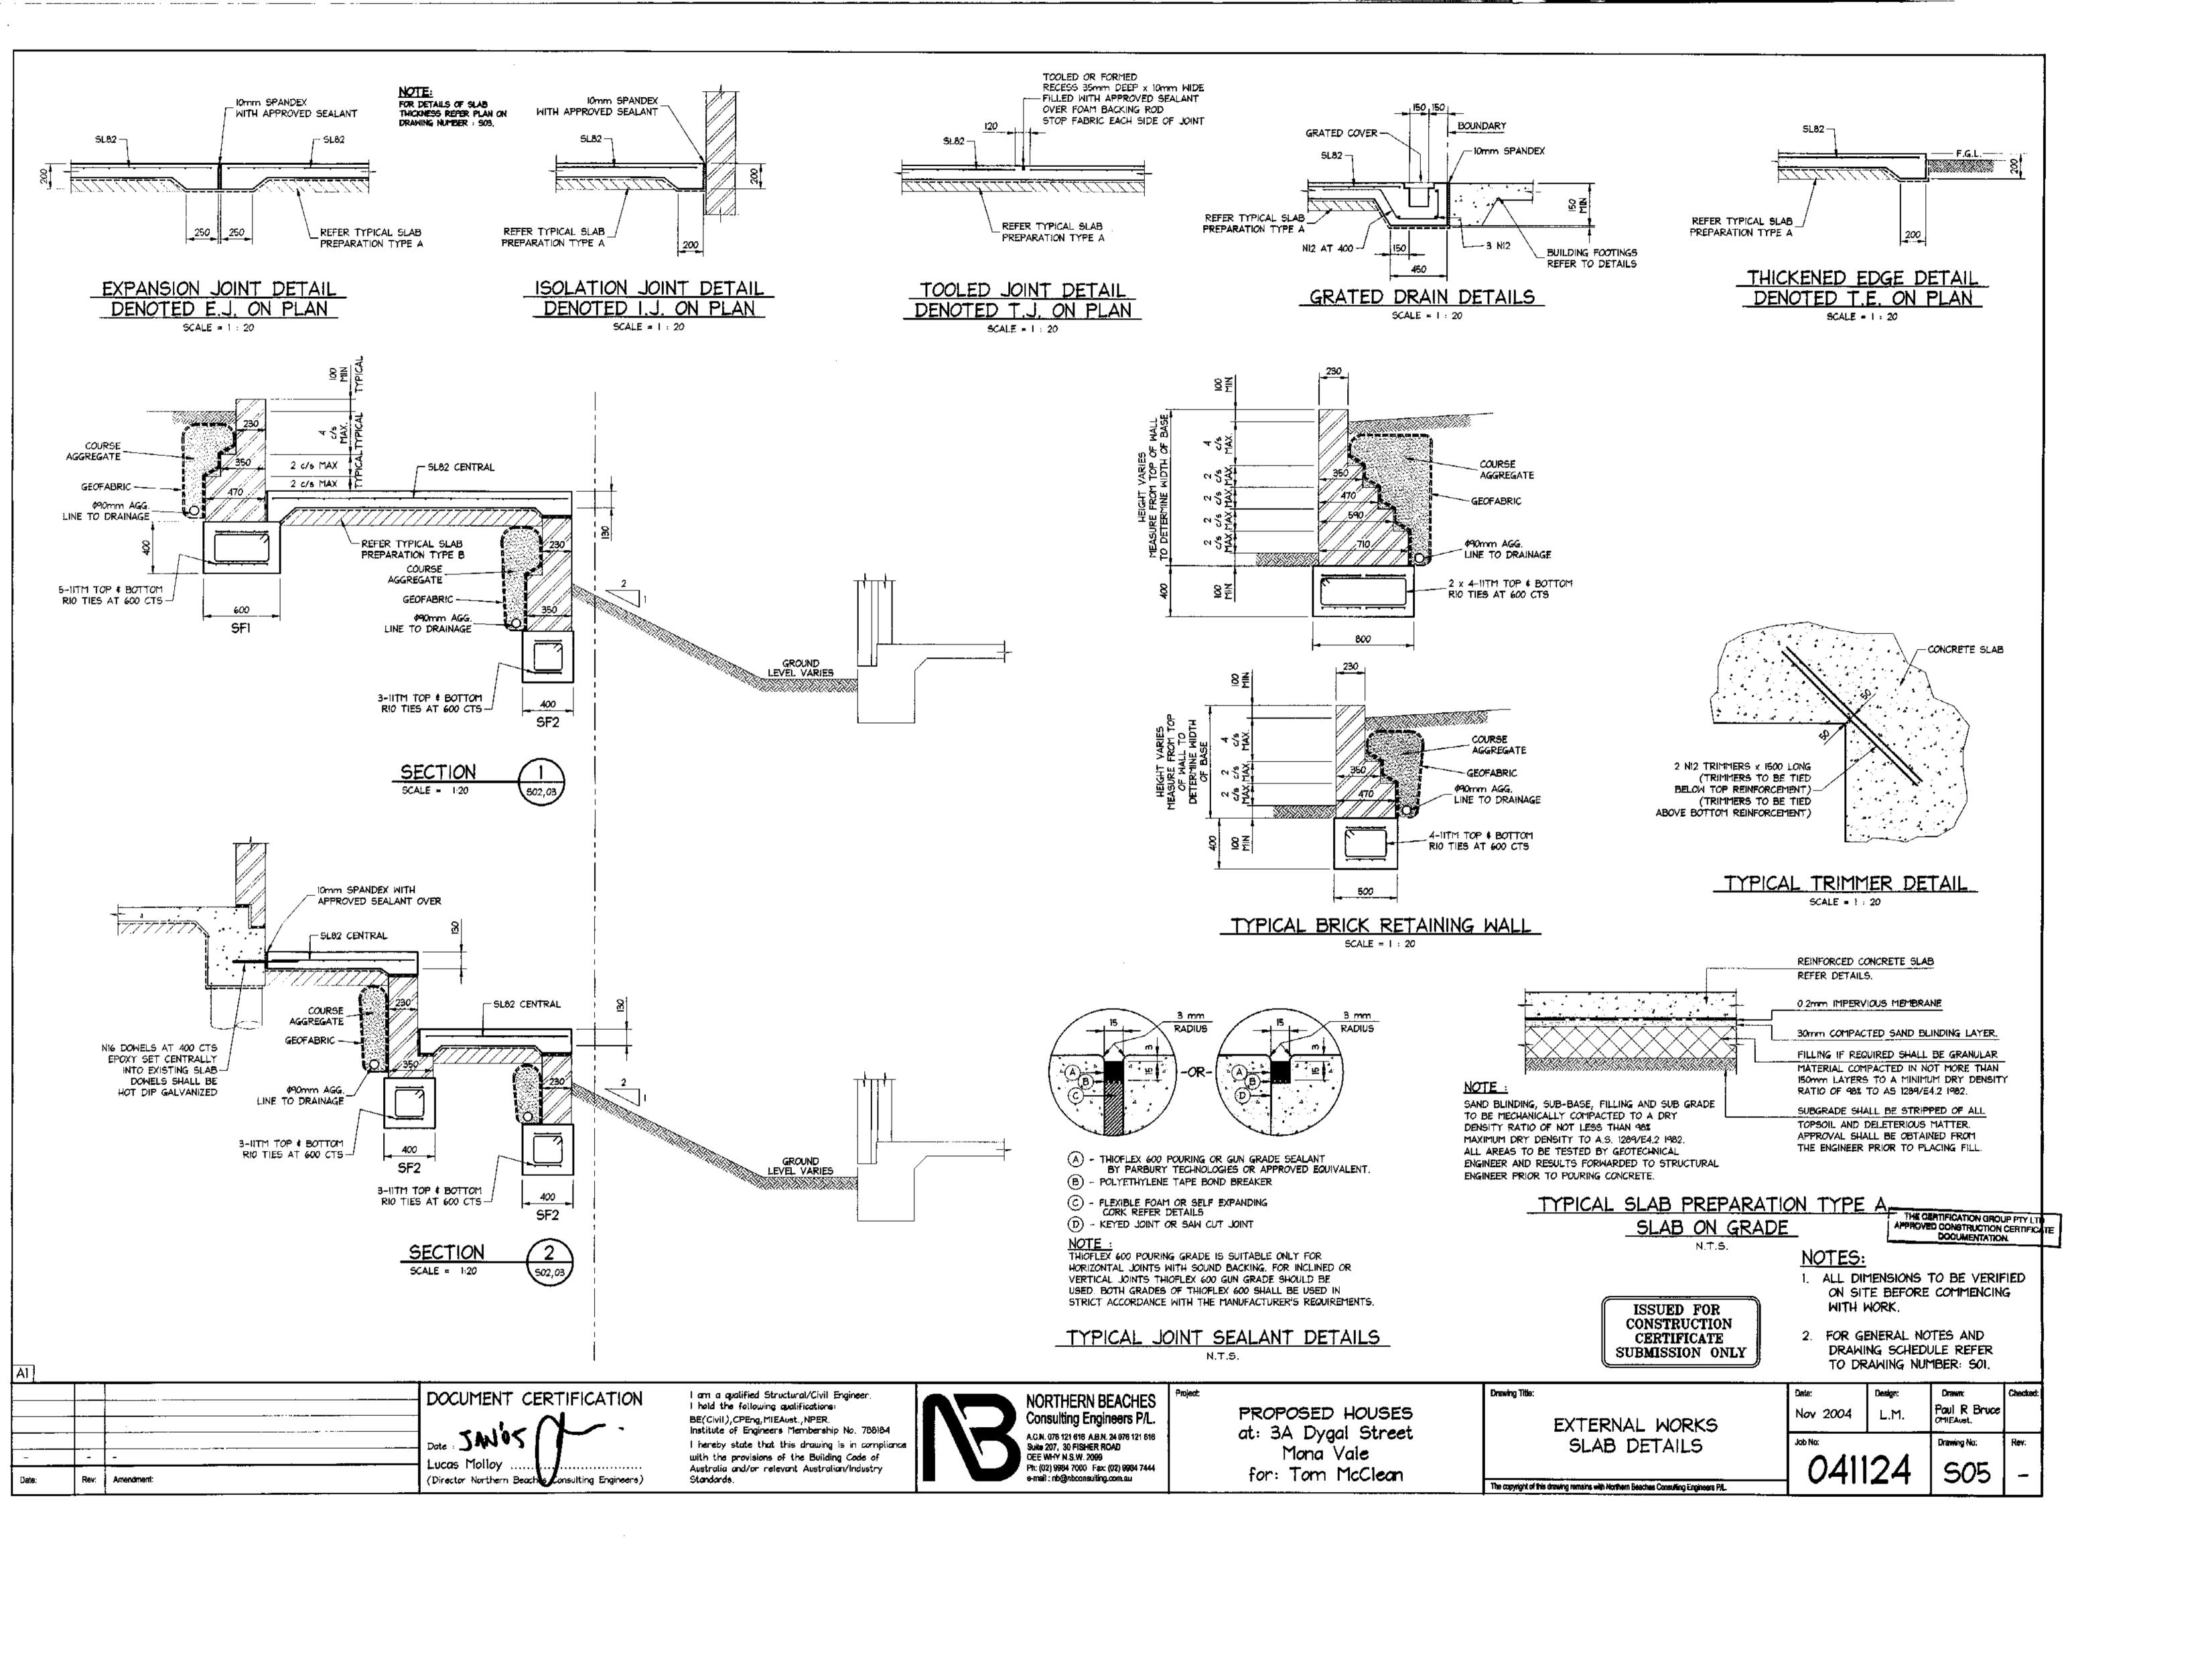
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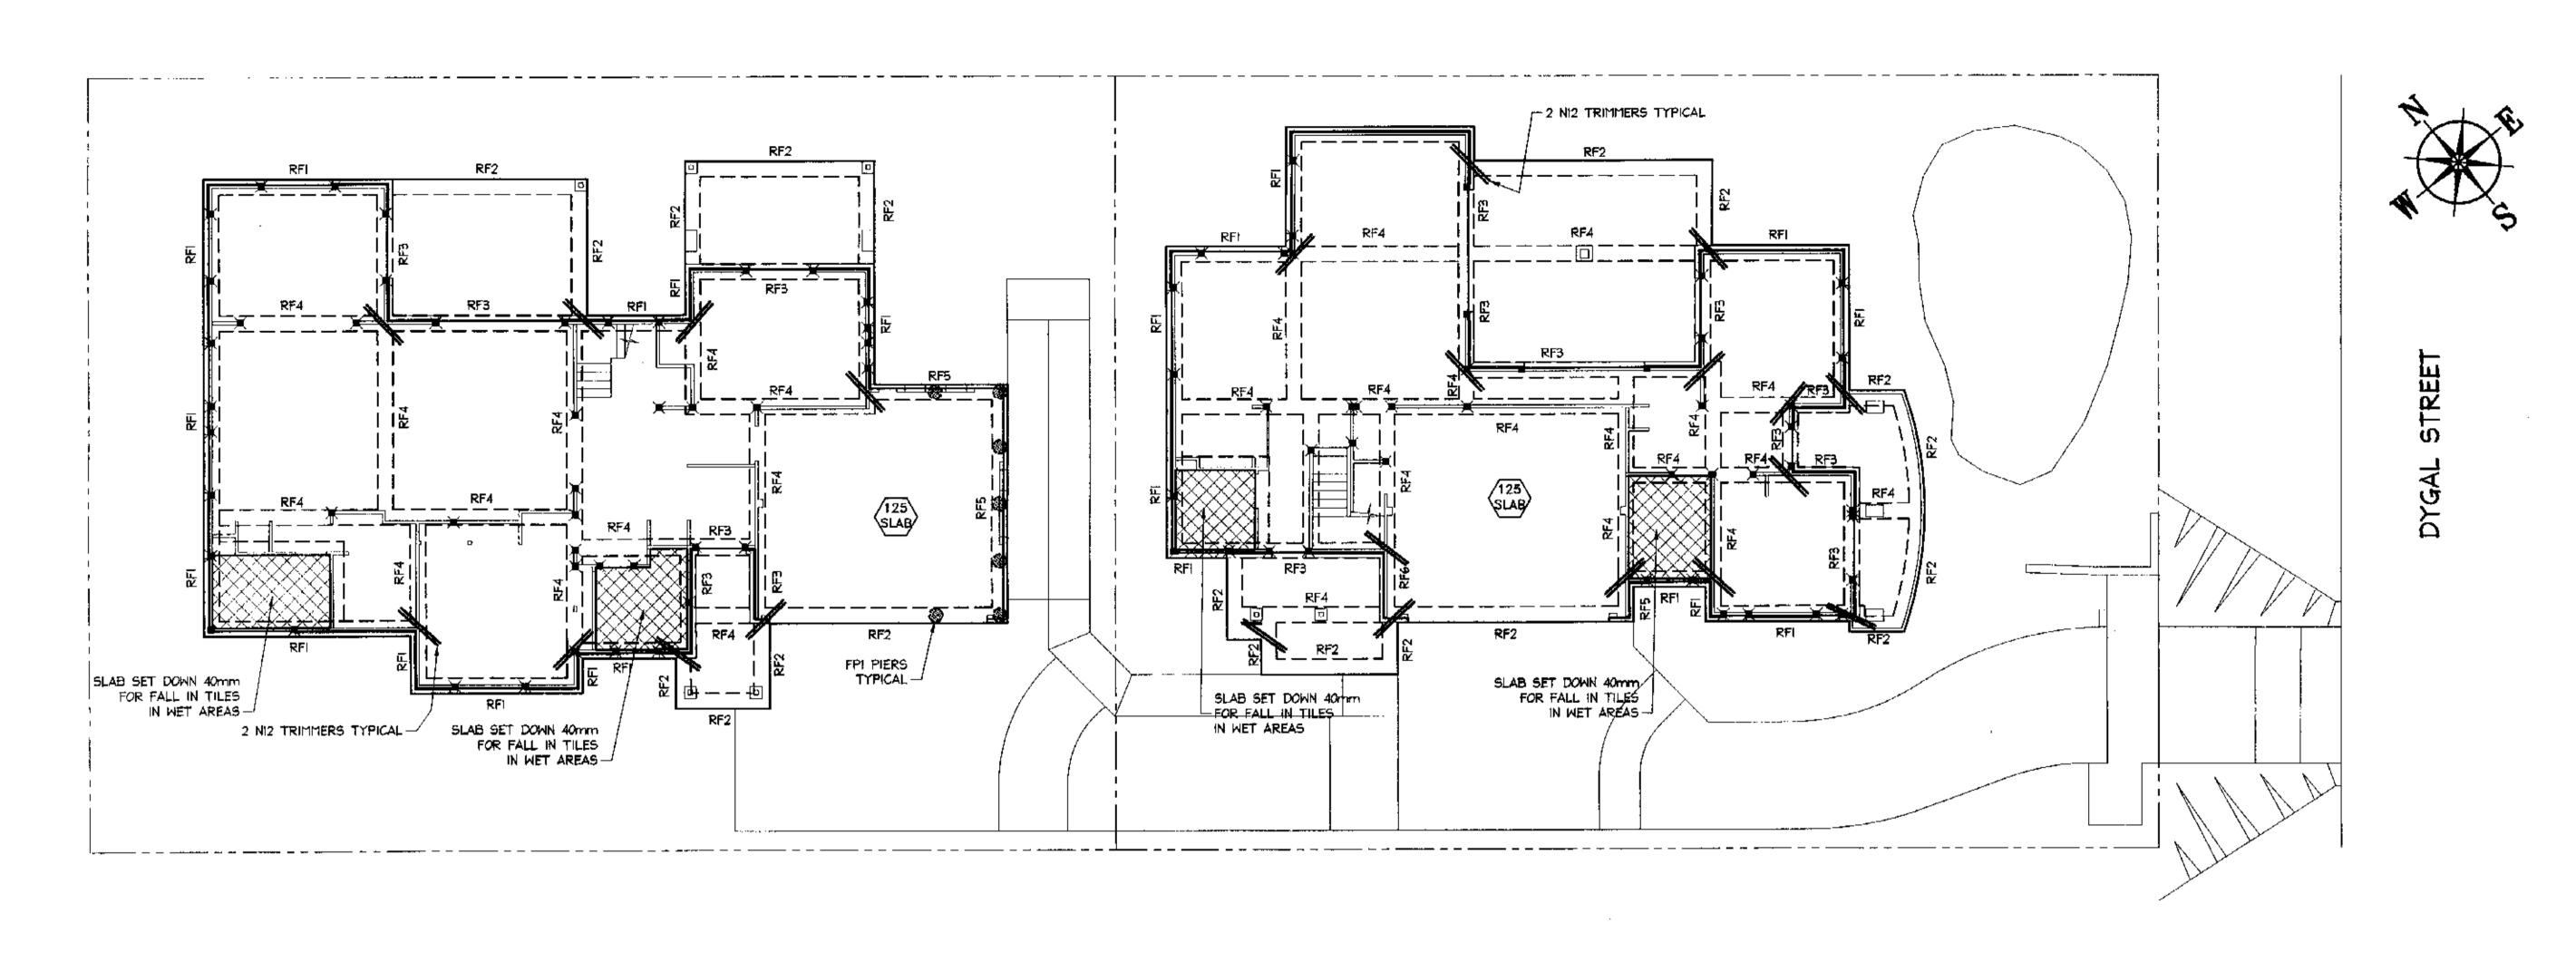
CONSTRUCTION

CERTIFICATE

SUBMISSION ONLY

Job No: Drewing No:	
041124 so4	Rev:





ALL SLAB PANELS TO HOMM THICK SLAB ON GRADE UNO. ALL SLAB PANELS TO BE REINFORCED WITH SL82 TOP UNO

FOOTING AND GROUND FLOOR SLAB PLAN SCALE = 1 : 100

NOTE:

CONCRETE STRENGTH: FOOTINGS:

f'c = 25 MPa., COVER = 65 mm

INTERNAL SLABS:

f'c = 32 MPa., COVER = 30 mm

EXTERNAL SLABS: f'c = 40 MPa., COVER = 45 mm

THE BERTIFICATION GROUP PTY LTD
APPROVED CONSTRUCTION CERTIFICATE
DOCUMENTATION.

NOTES:

ISSUED FOR CONSTRUCTION

CERTIFICATE

FOOTING AND GROUND

FLOOR SLAB PLAN

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Drawing Title:

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- 1. ALL DIMENSIONS TO BE VERIFIED ON SITE BEFORE COMMENCING WITH WORK.
- DRAWING SCHEDULE REFER

2. FOR GENERAL NOTES AND

TO DRAWING NUMBER: SOI.

Paul R Bruce OMIEAust. Nov 2004 L.M. Job Ne: Drawing No: S06


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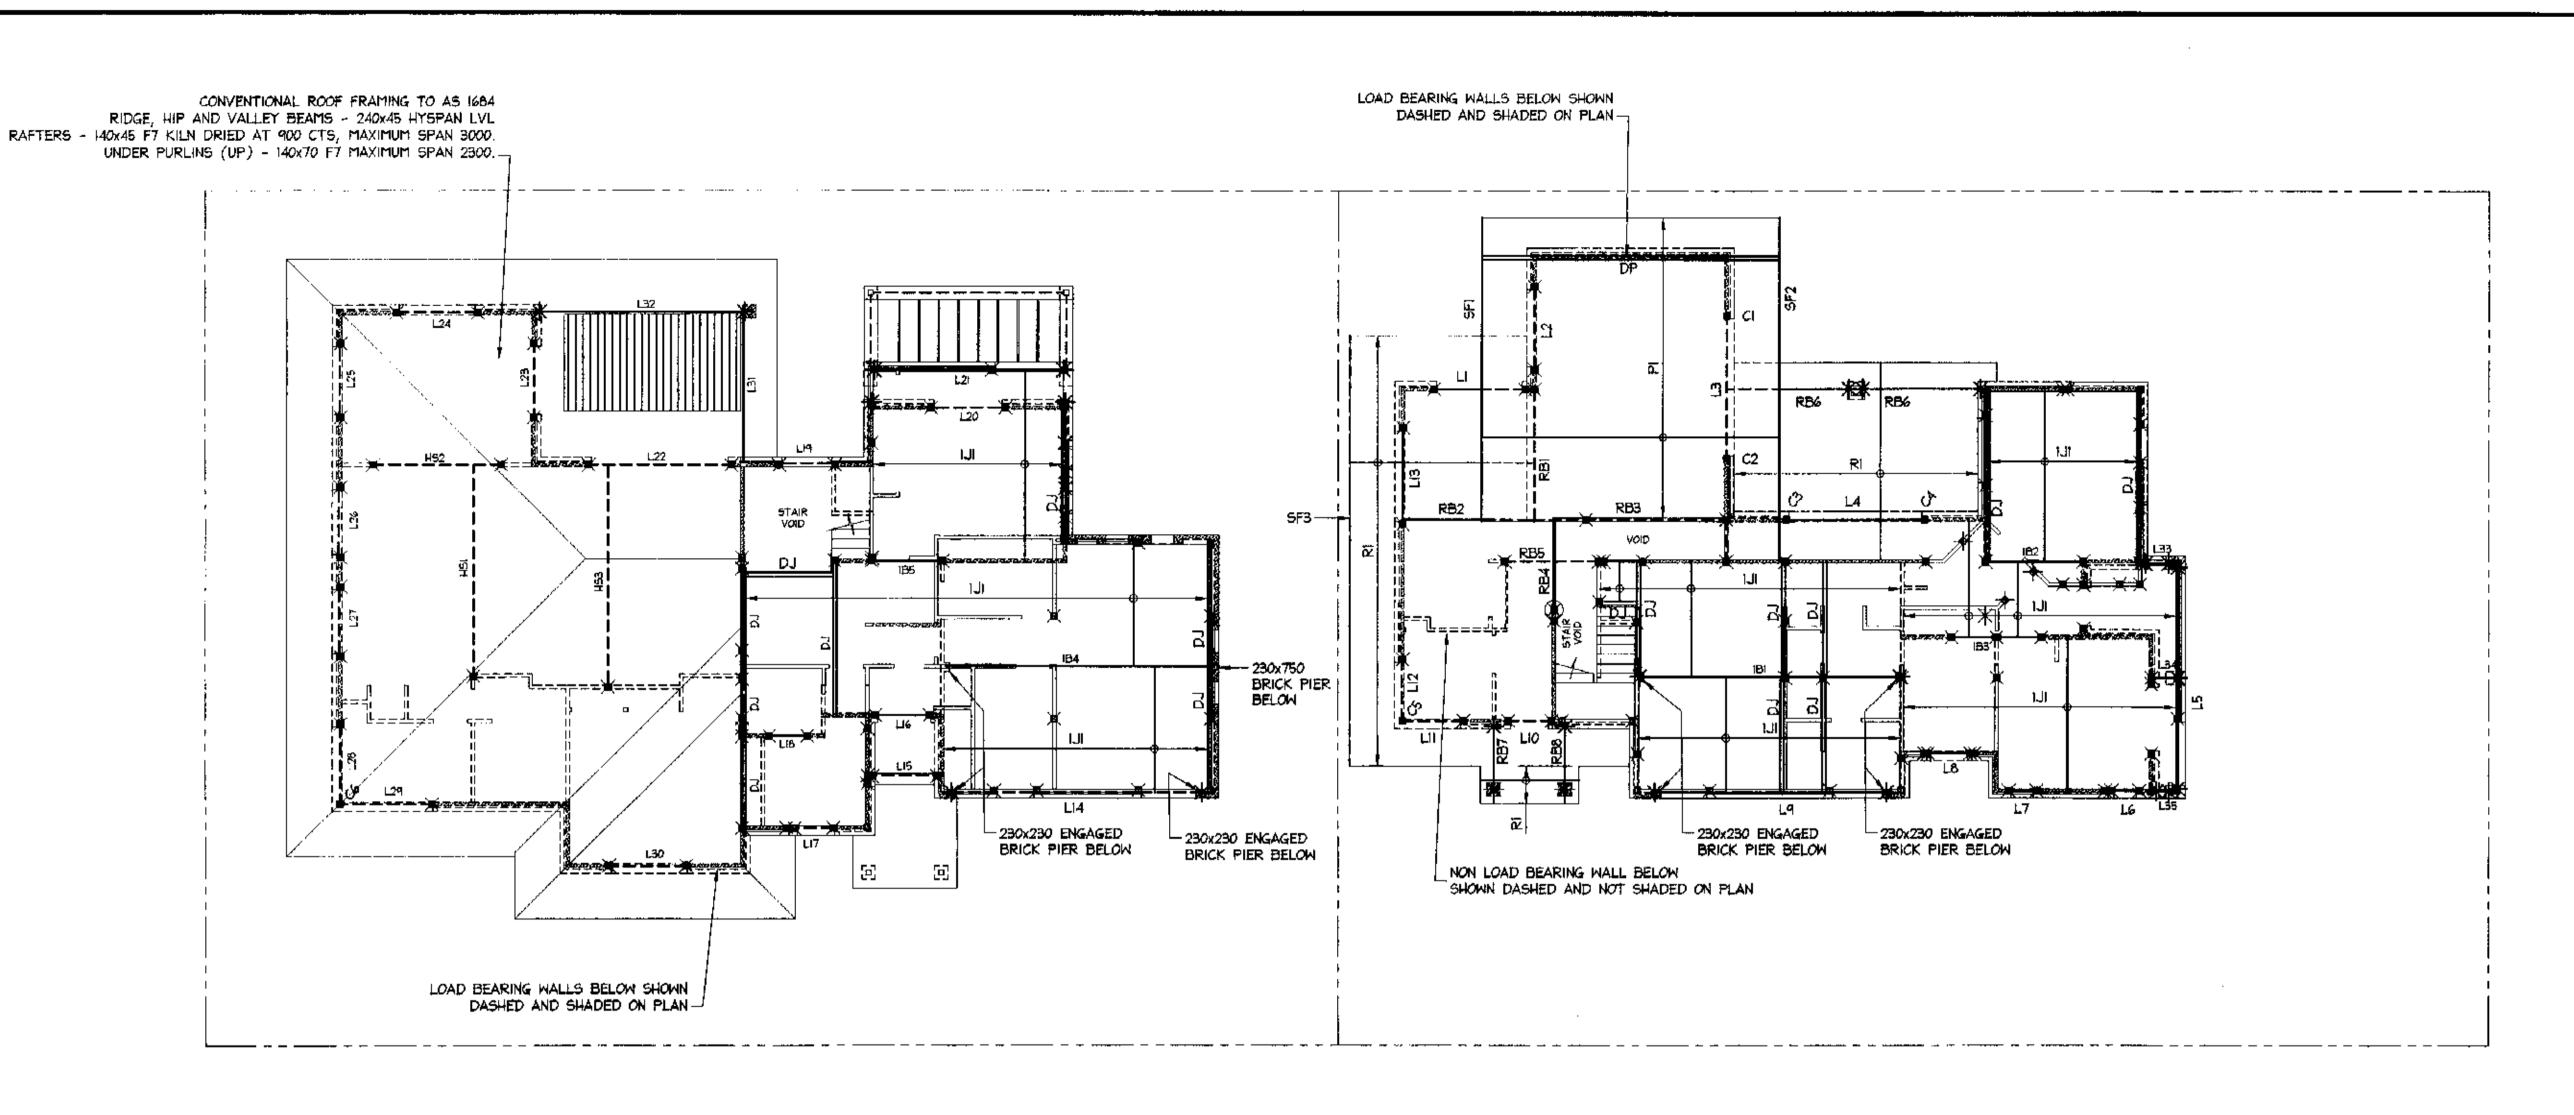
CERTIFICATION ches Compulting Engineers)

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PROPOSED HOUSES at: 3A Dygal Street Mona Vale for: Tom McClean





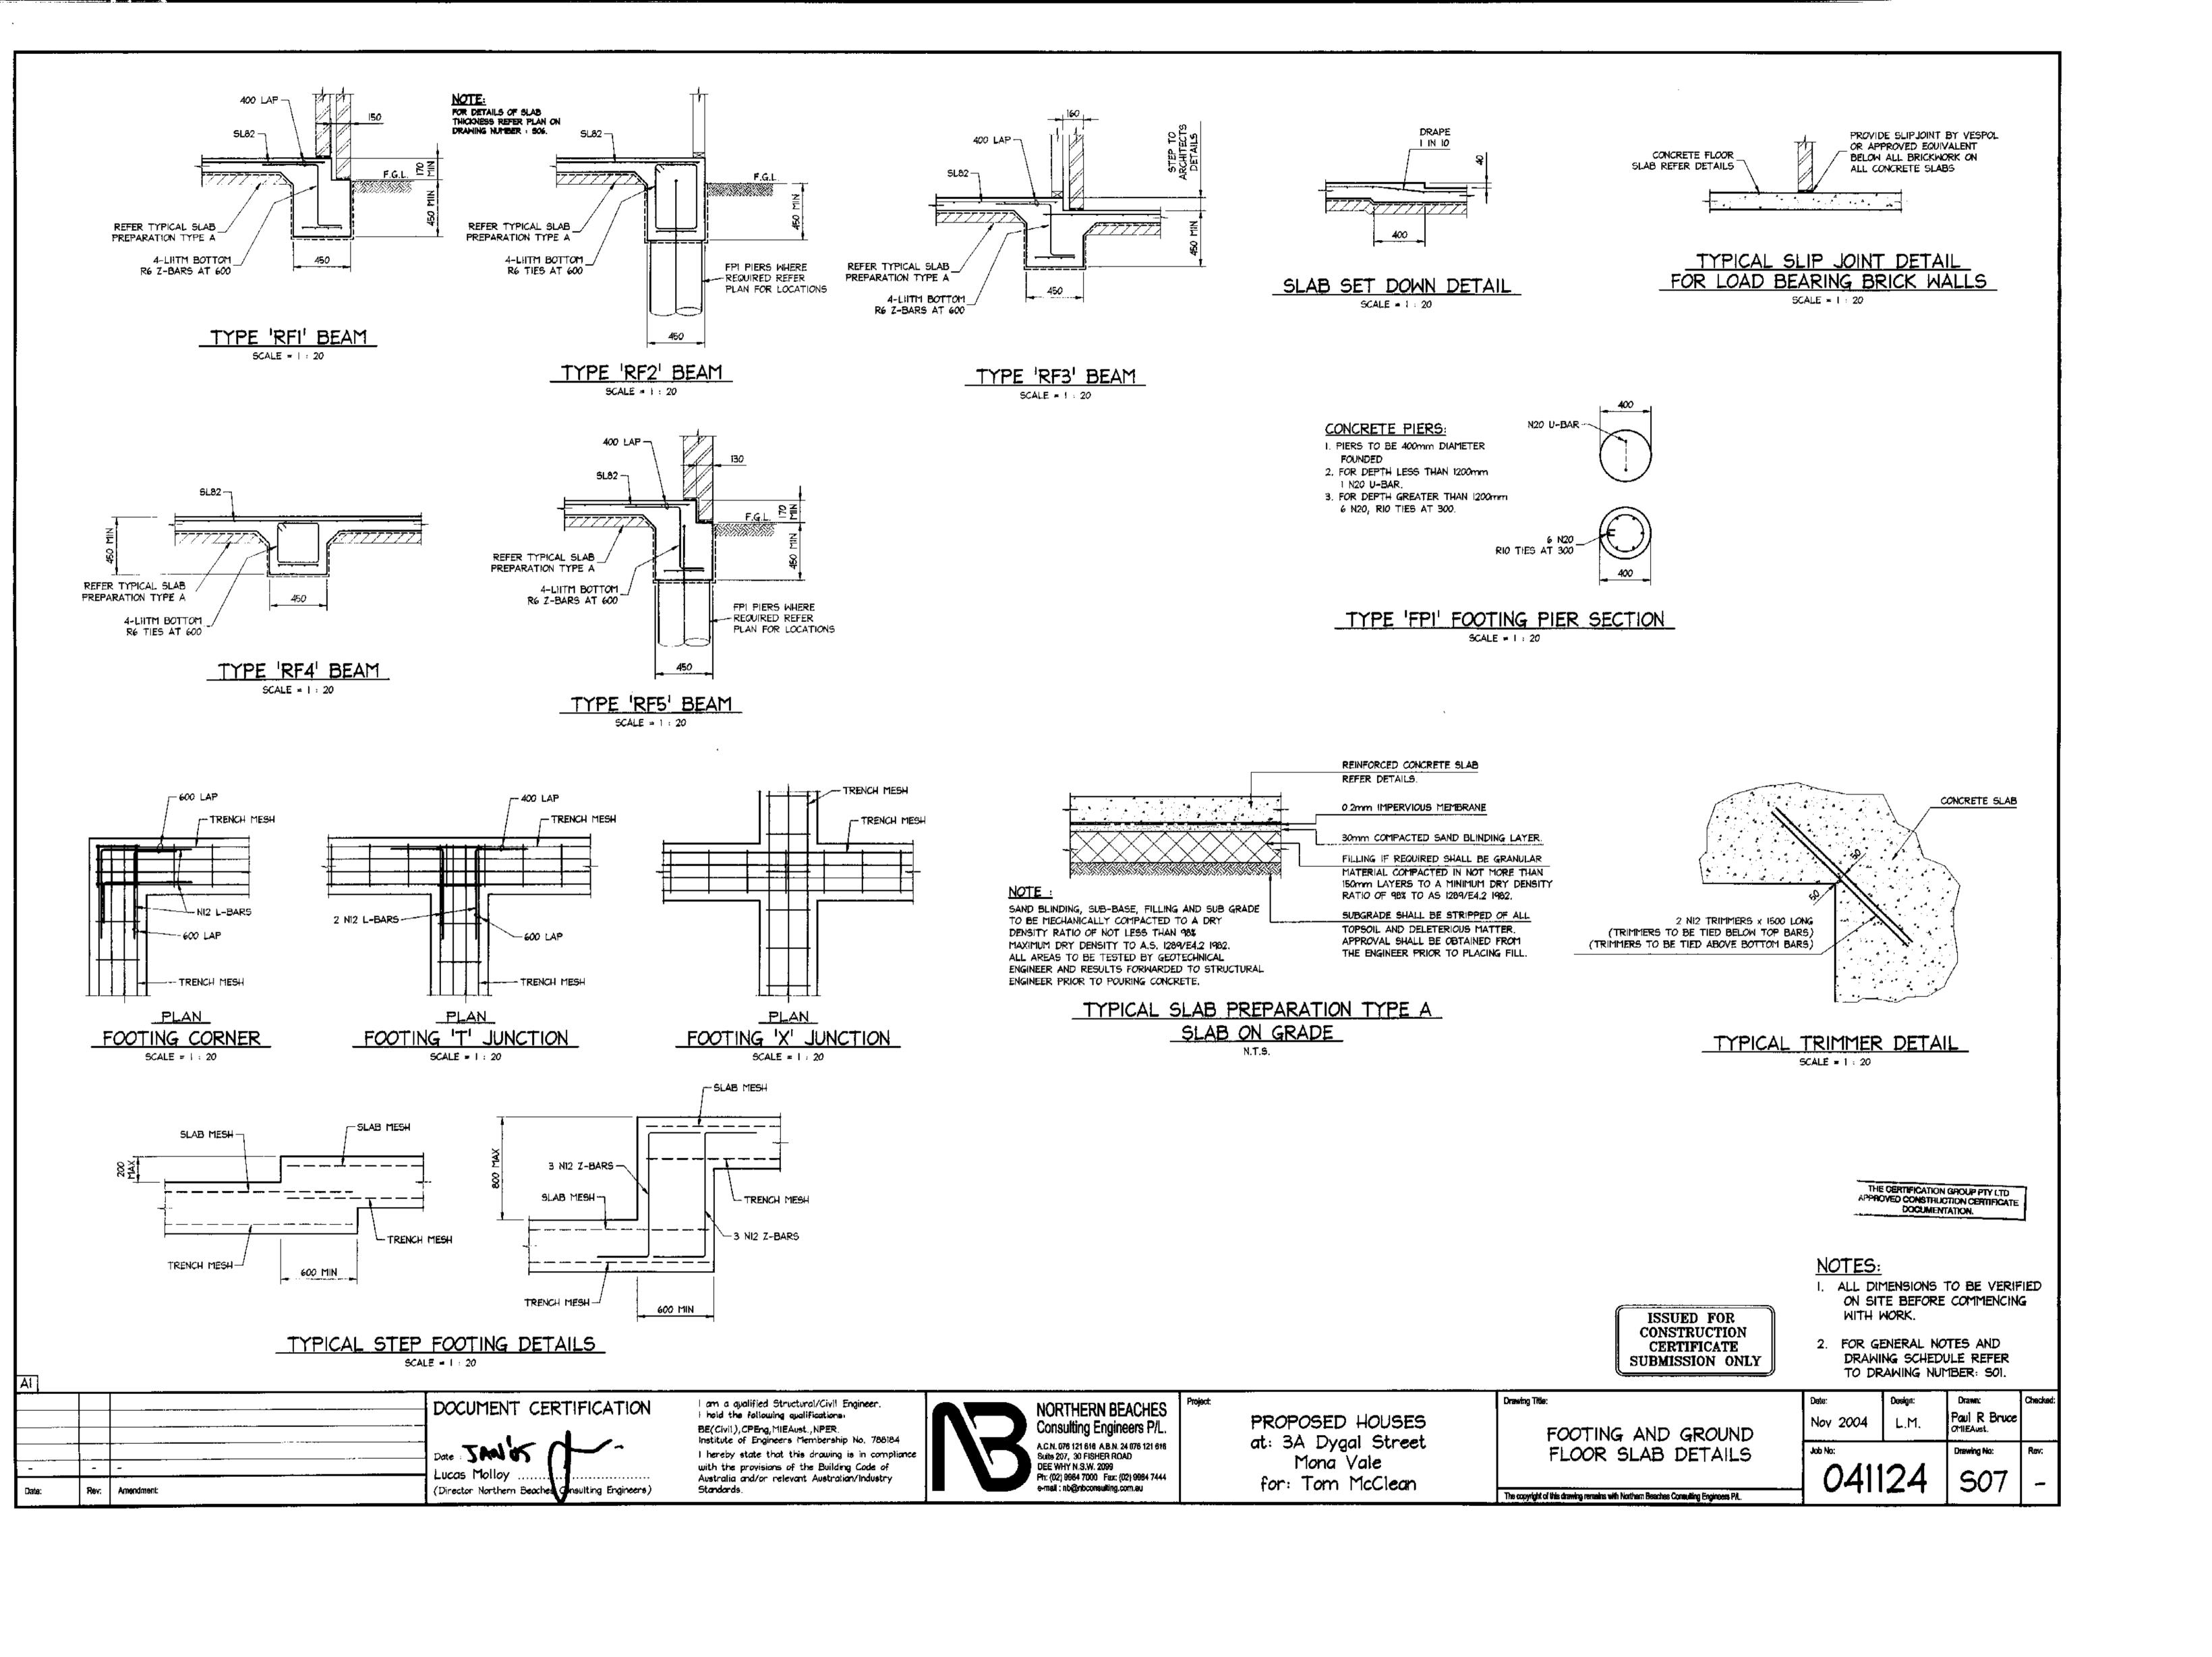

FIRST FLOOR AND LOWER ROOF FRAMING PLAN

MARK	MEMBER	REMARKS
FIRST FLOOR FR	AMING	·-·· · / · · · · · · · · · · · · · · · ·
Cl - C6 incl	89x89x3 SH5	COLUMNS
IBI	310 UB 46	BEAM
182, IB3, IB5	240x45 F7 KILN DRIED or 200x45 HYSPAN LVL	BEAM
1B4	310 UB 46	BEAM
IJI	240x45 F7 KILN DRIED or 200x45 HYSPAN LVL	FLOOR JOISTS AT 450 CTS
L1, L2, L11, L12	140x70 F7 INTERNAL SKIN + 100x100 GALINTEL EXTERNAL SKIN	LINTEL
L3, L4	150 PFC + 250x12 PLATE HOT DIP GALVANIZED	LINTEL
L5	190x70 F7 INTERNAL SKIN + 150x100 GALINTEL EXTERNAL SKIN	LINTEL
L6, L7, L8, L10	90x70 F7 INTERNAL SKIN + 100x100 GALINTEL EXTERNAL SKIN	LINTEL
L9, L14	380 PFC + 250x16 PLATE HOT DIP GALVANIZED	LINTEL
L13	190x70 F7 INTERNAL SKIN + 150x100 GALINTEL EXTERNAL SKIN	LINTEL
L15, L16, L20	140x70 F7 INTERNAL SKIN + 100x100 GALINTEL EXTERNAL SKIN	LINTEL
L17, L19	90x70 F7 INTERNAL SKIN + 100x100 GALINTEL EXTERNAL SKIN	LINTEL
L18	90×70 F7	LINTEL
L2t	250 PFC + 250x12 PLATE HOT DIP GALVANIZED	LINTEL
22	250 PFC + 250x12 PLATE HOT DIP GALVANIZED	LINTEL
L23 - L30 incl	140x70 F7 INTERNAL SKIN + 100x100 GALINTEL EXTERNAL SKIN	LINTEL
L3I, L32	2 x 300x45 HYSPAN LVL GLUE AND NAIL LAMINATED	LINTEL
L 33, L34, L 35	140x70 F7	LINTEL
LOWER ROOF FRA	AMING	
RBI, RB2, RB3	200x63 HYSPAN LVL	BEAM
RB4	200 PFC (I Im MAXIMUM CANTILIVER TO SUPPORT RB2 + RB3)	BEAM
RB5	200 PFC	BEAM
RB6	200x63 HYSPAN LVL	Beam
RB7, RB8	190X70 F7	BEAM
PI	200x45 HYSPAN LVL	PURLINS AT 900 CTS
RI	190x45 F7 KILN DRIED	RAFTERS AT 900 CTS
HSI, HS2, HS3	400x63 HYSPAN LVL	HANGING/STRUTTING BEAM

MARK	MEMBER	REMARKS		
GENERAL FRA	MING			
58	PRYDA STRAP BRACING WITH TENSIONERS TO UNDER SIDE OF FLOOR JOISTS AND RAFTERS WHERE INDICATED ON PLAN			
A	ANGLE BRACING TO WALLS REFER TYPICAL	ANGLE BRACING TO WALLS REFER TYPICAL DETAILS		
В	PLY BRACING TO WALLS REFER TYPICAL DI	PLY BRACING TO WALLS REFER TYPICAL DETAILS		
DJ	DOUBLE JOISTS GLUE AND NAIL LAMINATED			
DR	DOUBLE RAFTERS GLUE AND NAIL LAMINATED			
DP	DOUBLE PURLING GLUE AND NAIL LAMINATED			
NPI	45mm THICK F7 KILN DRIED NAILING PLATE DEPTH TO MATCH ADJACENT MEMBER. FIX TO BRICK WALL WITH MIZ EPOXY SET ANCHORS AT 900 CTS			
NP2	•	45mm THICK F7 KILN DRIED NAILING PLATE DEPTH TO MATCH ADJACENT MEMBER. FIX TO STUD WALL WITH MIZ COACH BOLTS AT 900 CTS		
×	LOAD CONCENTRATION POINT OVER	LOAD CONCENTRATION POINT OVER COLUMN OVER		
В	COLUMN OVER			
*	BEAM SUPPORT LOCATIONS DIRECT ONTO B WALL BEARING - 100mm MINIMUM END BEA	· · · · · · · · · · · · · · · · · · ·		
×	2 STUDS NAIL LAMINATED & 40x40 F7 POST	LOAD CONCENTRATION POINT BELOW		
®	MIO THREADED ROD TIE DOWN TO FLOOR SLAB, HOT DIP GALVANIZED	TIE DOWN LOCATION		

2. ALL TIMBER SHALL BE KILN DRIED, DO NOT USE GREEN TIMBER.

3. ALL SOFTWOOD TIMBER FRAMING TO HAVE A MINIMUM TREATMENT PROTECTION OF H2 or T2 TREATED FOR TERMITE PROTECTION UNLESS NOTED OTHERWISE.

- 1. ORGANIC TERMITE TREATMENT TO BE CARRIED OUT TO PERIMETER OF ENTIRE BUILDING AND SUB-FLOOR AREAS. ANNUAL INSPECTIONS AND TREATMENT AS REQUIRED SHALL BE THE RESPONSIBILITY OF THE PROPRIETOR.
- WALL FRAMING SHALL BE IN ACCORDANCE WITH AS 1664 TIMBER FRAMING CODE AND NSW TIMBER FRAMING MANUAL, 90x45 F7 KILN DRIED T2 TREATED STUDS AT 450 CTS.
- 3. BRACE WALLS AND ROOF IN ACCORDANCE WITH AS 1684 TIMBER FRAMING CODE AND NSW TIMBER FRAMING MANUAL.
- 4. PROVIDE DOUBLE JOISTS BELOW ALL LOAD BEARING WALLS UNLESS NOTED OTHERWISE.
- 5. THE DOWNS TO ROOF RAFTERS AND BEAMS SHALL BE IN ACCORDANCE WITH AS 1684 TIMBER FRAMING CODE AND AS 1170,2 WIND LOADING CODE.
- 6. TRIM FLOOR/ROOF OPENINGS WITH EQUIVALENT JOIST/RAFTER SIZES UNLESS NOTED OTHERWISE. 7. EXTERNAL/EXPOSED HYSPAN LVL OR TASBEAM MEMBERS TO BE SUITABLY PRESERVATIVE TREATED TO HB LEVEL (AS 1604) THEN STAINED OR PAINTED.
- 8. EXTERNAL/EXPOSED HARDWOOD MEMBERS TO BE DURABILITY CLASS 2 OR BETTER (AS 1604) THEN STAINED OR PAINTED.
- 4. ENGINEER TO INSPECT AND CERTIFY ALL FRAMING AND BRACING PRIOR TO SHEETING.

THE CERTIFICATION GROUP PTY LTD APPROVED CONSTRUCTION CERTIFICATE DOCUMENTATION.

NOTES:

- ALL DIMENSIONS TO BE VERIFIED ON SITE BEFORE COMMENCING WITH WORK.
- 2. FOR GENERAL NOTES AND DRAWING SCHEDULE REFER

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	<u> </u>
	Drawing Title:
	FIRST FLOOR
1	

AND LOWER ROOF FRAMING PLAN


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ISSUED FOR

Date: Nov 2004	Design: L.M.	Paul R Bruce OMIEAust.	Checked
Job No: 0411	24	Drawing No: 508	Rev:
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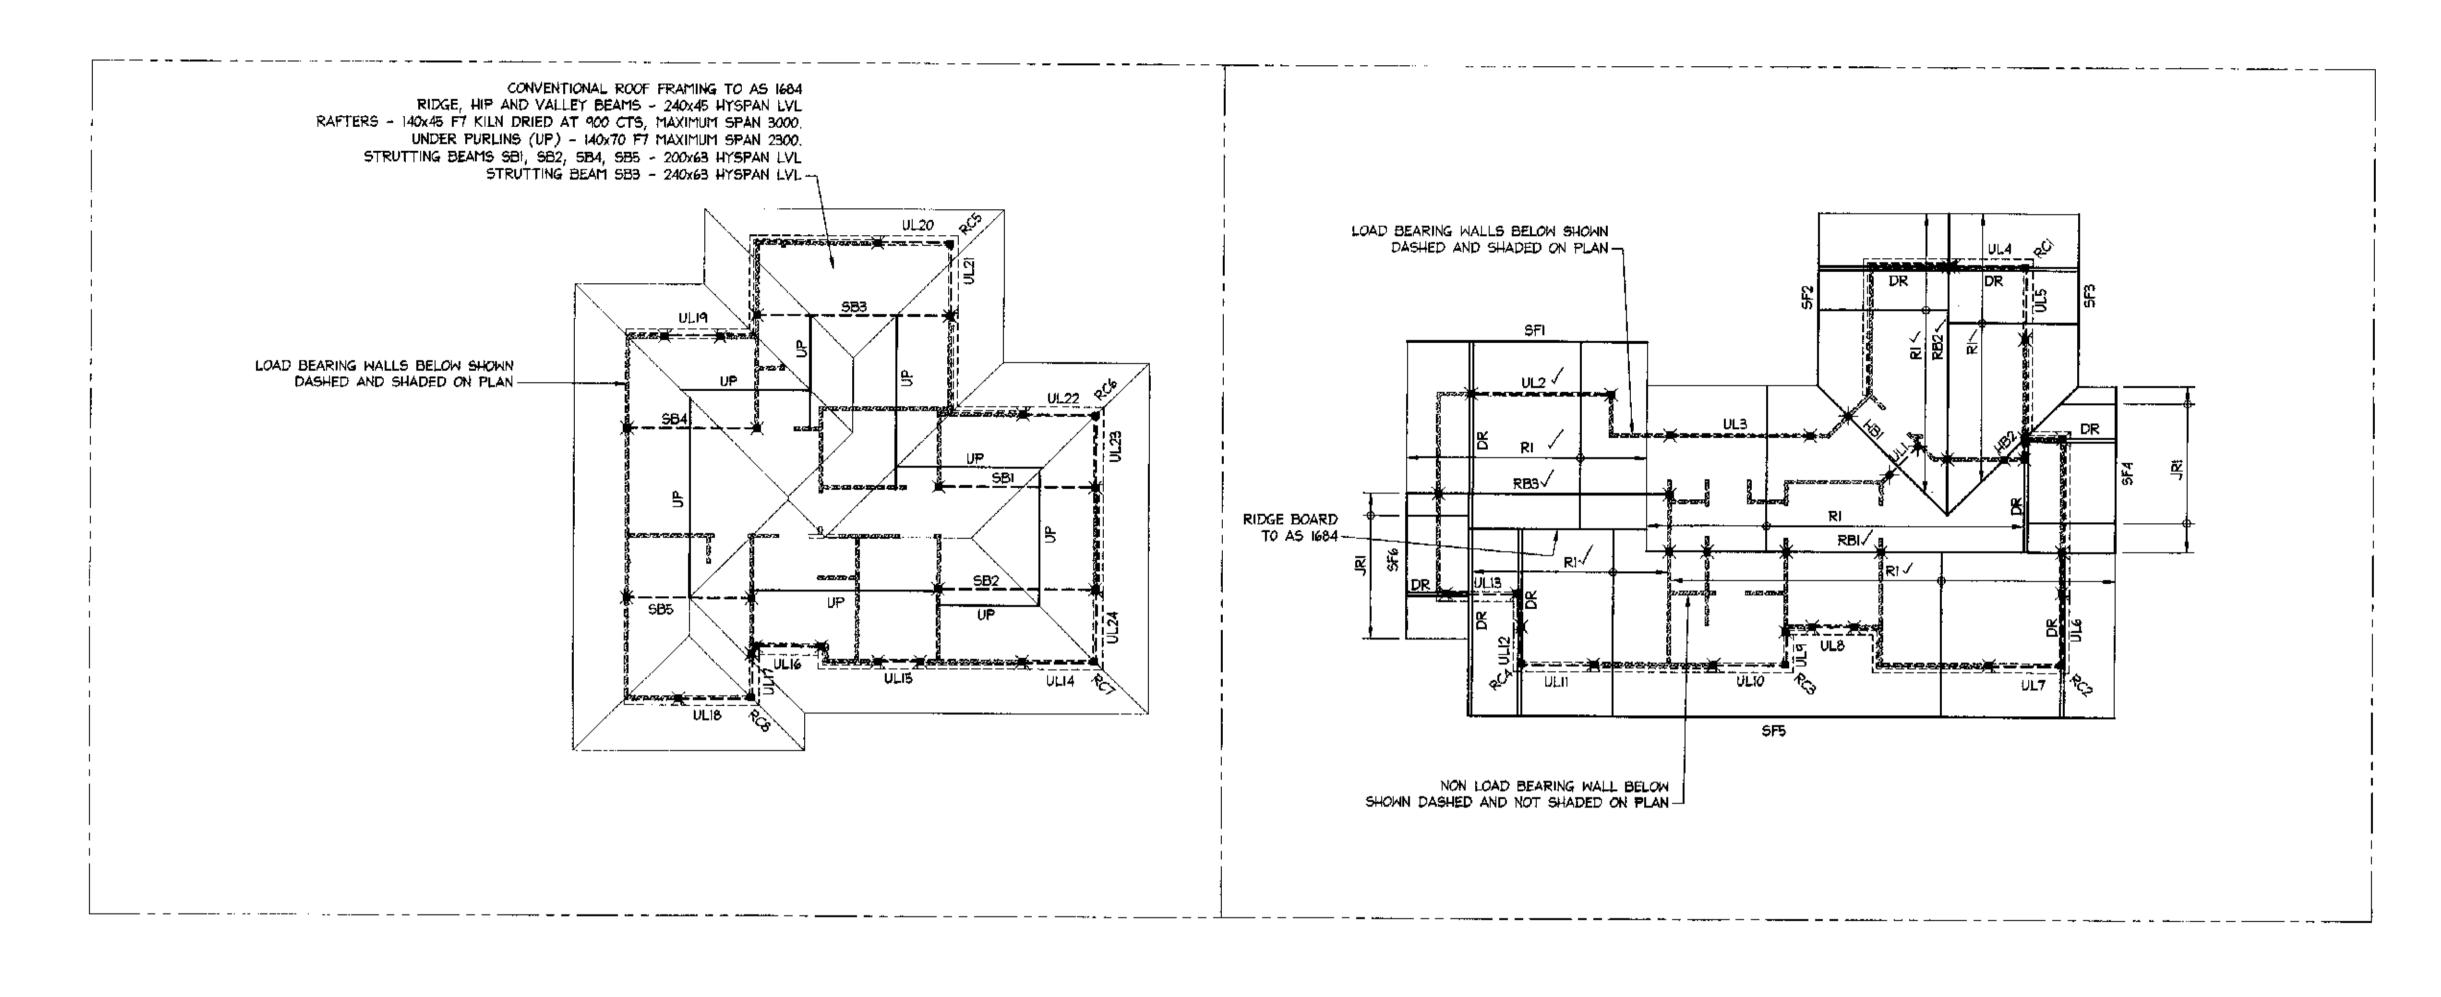
DOCUMENT CERTIFICATION

i am a qualified Structural/Civil Engineer. I hold the following qualifications: BE(Civil), CPEng, MIEAust., NPER. Institute of Engineers Membership No. 788184 I hereby state that this drawing is in compliance with the provisions of the Building Code of Australia and/or relevant Australian/Industry



PROPOSED HOUSES at: 3A Dygal Street Mona Vale for: Tom McClean

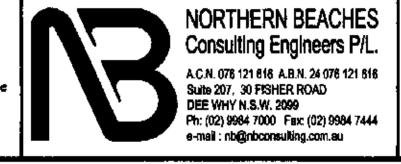(Director Northern Beaches Consulting Engineers) Amendment:



UPPER ROOF FRAMING PLAN

MARK	MEMBER	REMARKS	
UPPER ROOF FRA	MING		
RCI - RC8 incl	89x89x5 SH5 HOT DIP GALVANIZED	COLUMN	
RBI, RB2	300x63 HYSPAN LVL	BEAM	
RB3	200 UB IB or 400x63 HYSTAM LVL	BEAM	
HB1, HB2	300x63 HYSPAN LVL	HIP BEAM	
SFI - SF6 incl	200x45 HYSPAN LVL	STRUCTURAL FASCIA	
RI, JRI	190x45 FT KILN DRIED (MAXIMUM OVERHANG 1350)	RAFTERS AT 900 CTS	
ULł	140x70 F7	LINTEL	
UL2, UL3	240x70 F7 or 200x63 HYSPAN LVL	LINTEL	
UL4 - UL7 incl	140x70 F7 INTERNAL SKIN + HOOXIOO GALINTEL EXTERNAL SKIN	LINTEL	
ULB, UL9, UL12	90x70 F7 INTERNAL SKIN + 100x100 GALINTEL EXTERNAL SKIN	LINTEL	
ULIO, ULII, ULIB	140x70 F7 INTERNAL SKIN + 100x100 GALINTEL EXTERNAL SKIN	LINTEL	
ULI4, ULI6, ULI8	140x70 F7 INTERNAL SKIN + 100x100 GALINTEL EXTERNAL SKIN	LINTEL	
ULIS, ULI7, ULI9	90x70 F7 INTERNAL SKIN + 100x100 GALINTEL EXTERNAL SKIN	LINTEL	
UL20 - UL24 incl	140x70 F7 INTERNAL SKIN + 100x100 GALINTEL EXTERNAL SKIN	LINTEL	
GENERAL FRAMIN		•	
5B	PRIDA STRAP BRACING WITH TENSIONERS TO UNDER SIDE OF FLOOR JOISTS AND RAFTERS WHERE INDICATED ON PLAN		
A	ANGLE BRACING TO WALLS REFER TYPICAL DETAILS		
β	PLY BRACING TO WALLS REFER TYPICAL DETAILS		
DR	DOUBLE RAFTERS GLUE AND NAIL LAMINATED		
×	2 STUDS NAIL LAMINATED or 90x90 F7 POST	LOAD CONCENTRATION POINT BELOW	
®	MIO THREADED ROD TIE DOWN TO FLOOR FRAMING, HOT DIP GALVANIZED	PRENDENISHNEDCATION	

I. ORGANIC TERMITE TREATMENT TO BE CARRIED OUT TO PERIMETER OF ENTIRE BUILDING AND SUB-FLOOR AREAS. ANNUAL INSPECTIONS AND TREATMENT AS REQUIRED SHALL BE THE RESPONSIBILITY OF THE PROPRIETOR.

WALL FRAMING SHALL BE IN ACCORDANCE WITH AS 1684 TIMBER FRAMING CODE AND NSW TIMBER FRAMING MANUAL. 90x45 F7 KILN DRIED 12 TREATED STUDS AT 450 CTS

3. BRACE WALLS AND ROOF IN ACCORDANCE WITH AS 1684 TIMBER FRAMING CODE AND NSW TIMBER FRAMING MANUAL.

4. TIE DOWNS TO ROOF RAFTERS AND BEAMS SHALL BE IN ACCORDANCE WITH AS 1684 TIMBER FRAMING CODE AND AS 1170.2 WIND LOADING CODE.

5. TRIM ROOF OPENINGS WITH EQUIVALENT RAFTER SIZES UNLESS NOTED OTHERWISE.

6. EXTERNAL/EXPOSED HYSPAN LVL OR TASBEAM MEMBERS TO BE SUITABLY PRESERVATIVE TREATED TO HE LEVEL (AS 1604) THEN STAINED OR PAINTED.

7. EXTERNAL/EXPOSED HARDWOOD MEMBERS TO BE DURABILITY CLASS 2 OR BETTER (AS 1604) THEN STAINED OR PAINTED.

8. ENGINEER TO INSPECT AND CERTIFY ALL FRAMING AND BRACING PRIOR TO SHEETING.

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UPPER ROOF

FRAMING PLAN

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Drawing Title:

Paul R Bruce Nov 2004 OMIEAust. Drawing No:

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NORTHERN BEACHES Consulting Engineers P/L.


PROPOSED HOUSES at: 3A Dygal Street Mona Vale


A.C.N. 078 121 816 A.S.N. 24 076 121 616 Suite 207, 30 FISHER ROAD DEE WHY N.S.W. 2099 Ph: (02) 9984 7000 Fax: (02) 9984 7444 e-meil : nb@nbconsulting.com.au for: Tom McClean

DOCUMENT CERTIFICATION (Director Northern Beaches Consulting Engineers)

Αl


H2 or T2 TREATED FOR TERMITE PROTECTION UNLESS NOTED OTHERWISE.

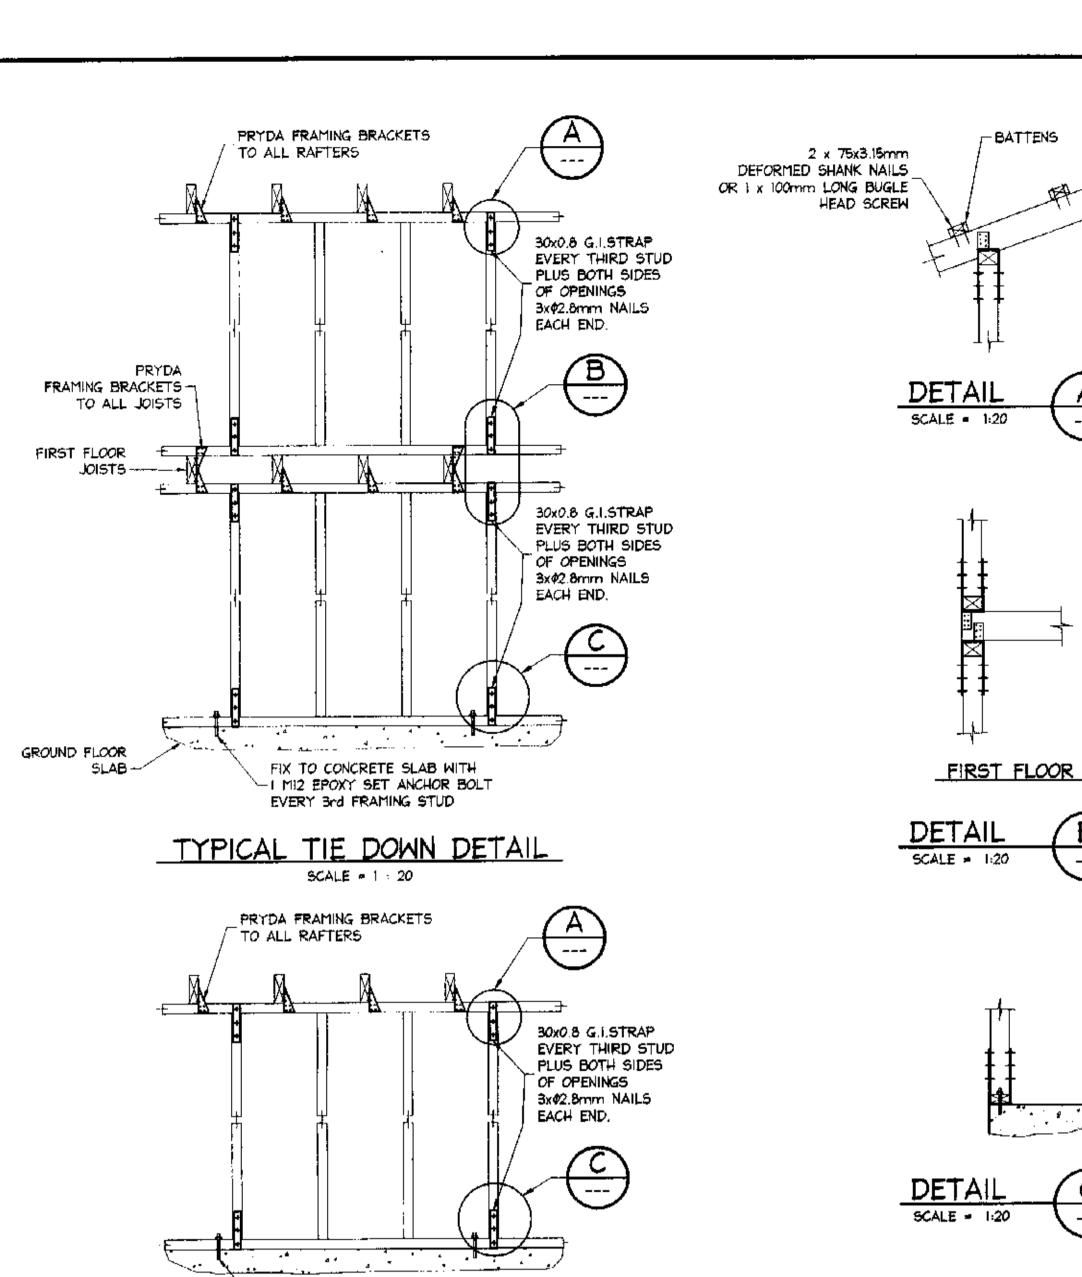

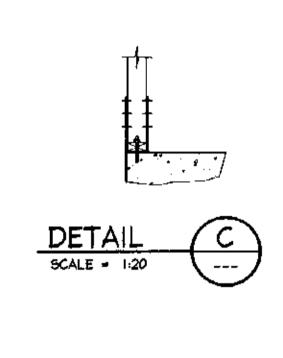

-- 10mm PLATE

_2 M16 EPOXY SET BOLTS

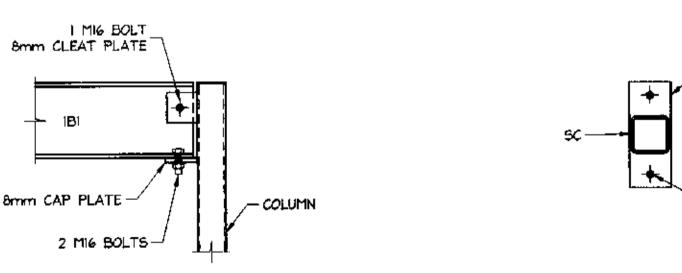


COLUMN BASE PLATE DETAILS

(Director Northern Beaches Consulting Engineers)

METAL TENSION STRAP BRACING:

PRYDA MAXI BRACE (ANGLE BRACING) FIXED WITH TWO GALVANISED FLATHEAD NAILS 08.15mm x 30mm LONG TO EACH STUD, AND THE FACE OF THE TOP AND BOTTOM PLATE. AND FOUR GALVANISED FLATHEAD NAILS

43.15mm x 30mm LONG TO THE STRAP RETURN OVER THE TOP PLATE ABD UNDER THE BOTTOM PLATE.

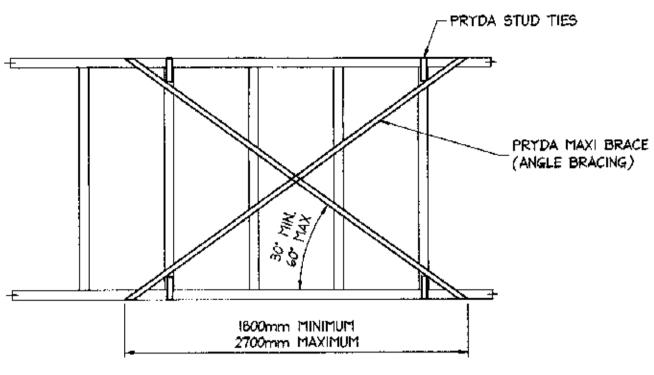


I. FOR POWER DRIVEN NAILS AND STAPLES REFER ABOVE. 2. NOGGINGS HAVE BEEN OMITTED FOR CLARITY.

TYPE A - WALL BRACING UNIT SCALE = 1 : 20

PLYWOOD BRACING:

FIX PLYWOOD PANELS WITH GALVANISED FLATHEAD NAILS #2.8mm x 30mm LONG MINIMUM OR EQUIVALENT AT 50mm CENTRES ALONG TOP AND BOTTOM PLATES, ISOmm CENTRES ALONG VERTICAL EDGES AND 300mm CENTRES ALONG INTERMEDIATE STUDS.

NAILS SHALL BE LOCATED A MINIMUM OF 7mm FROM PANEL EDGES POWER DRIVEN GALVANISED NAILS OR COATED STAPLES MAY BE USED WHERE THEY PROVIDE AT LEAST THE EQUIVALENT STRENGTH TO HAND DRIVES \$2.8mm x 30mm LONG GALVANISED CLOUTS OR FLATHEAD NAILS, IN THE CASE OF POWER DRIVEN STAPLES, STAPLE SPACING SHALL BE 35mm CENTRES AT TOP AND BOTTOM PLATES, 100mm CENTRES AT VERTICAL PLYWOOD EDGES AND 200mm CENTRES ALONG INTERMEDIATE STUDS.

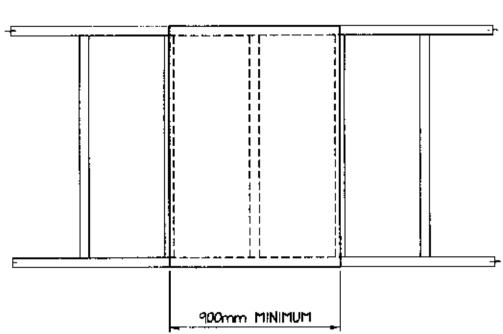

- I. FOR PLYWOOD THICKNESS REFER TO TABLE.


 2. FOR POWER DRIVEN NAILS AND STAPLES REFER ABOVE.

 3. PANEL EDGES SHALL BE SUPPORTED BY STUDS.
- 4. NOGGINGS HAVE BEEN OMITTED FOR CLARITY.


TYPE B - WALL BRACING UNIT SCALE ■ 1 : 20

LINTE! No. OF NAILS F 30mmx0.8mm G.1.		ACH END	OF STRA	
OPENING	TIE DOWN DISTANCE			
WIDTH	2. 5 m	3,6m	5.2m	6.7m
1200mm	3	3	3	4
1800mm	3	3	4	6
3000mm	3	6	<u> </u>	-
4800mm	6	<u> </u>	T -	-


PLYWOOD THICKNESS						
PLYWOOD STRESS	PLYWOOD THICKNESS					
	MAXIMUM STUD SPACING					
GRADE	450mm	600mm				
F8	7,0mm	9.0mm				
F11	6.0mm	7,0mm				
F14	4.0mm	6,0mm				
F27	4.0mm	4,5mm				

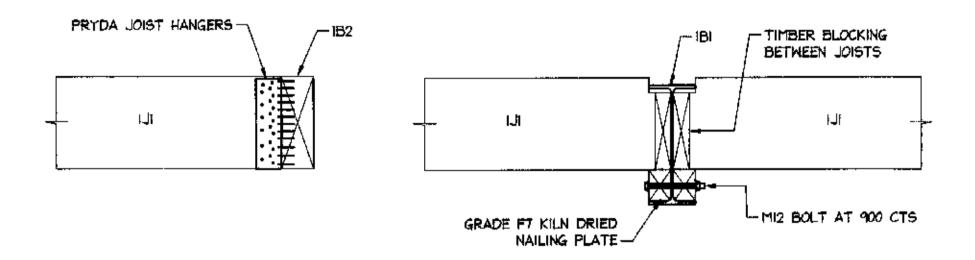

TYPICAL FLOOR JOIST CONNECTION DETAILS

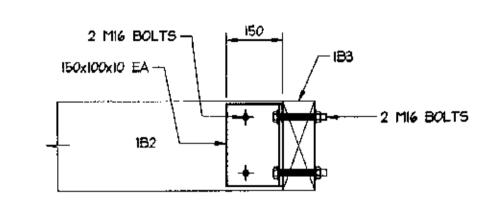

TIMBER BEAM CONNECTION DETAIL SCALE = 1 : 10

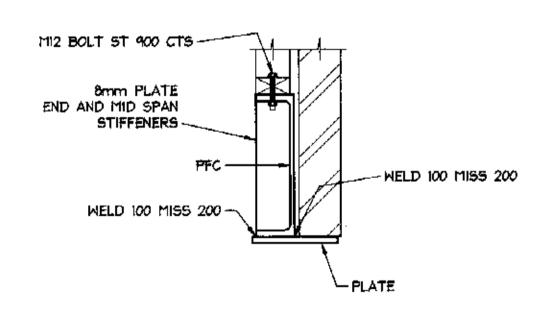

TYPICAL LINTEL SECTION SCALE - I : 10

Drawing Title:

THE CERTIFICATION GROUP PTY LTD
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DOCUMENTATION.

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ISSUED FOR CONSTRUCTION CERTIFICATE SUBMISSION ONLY

DOCUMENT CERTIFICATION

Amendment:

TYPICAL BEAM TO COLUMN

CONNECTION DETAILS SCALE = 1 : 10

FIX TO CONCRETE SLAB WITH I MIZ EPOXY SET ANCHOR BOLT EVERY 3-d FRAMING STUD

TYPICAL TIE DOWN DETAIL

SCALE - 1 : 20

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PROPOSED HOUSES at: 3A Dygai Street Mona Vale for: Tom McClean

FRAMING **DETAILS**

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	Date:	Design:	Drawn:	Checked:				
	Nov 2004	L.M.	Paul R Bruce omiEAust.					
	Job No:		Drawing No:	Rev:				
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