

DISTURBED AREA

OIRECTION
OIR
FLOW

POSTS DRIVEN
0.6m INTO
GROUND

WIRE OR STEEL MESH
(WHERE REQUIRED)

VUNDISTURBED
AREA

V

SEDIMENT FENCE

DUST CONTROL :

TO REDUCE DUST GENERATED BY WIND ACTION, THE REMOVAL OF THE TOP SOIL IS TO BE MINIMISED. TO PREVENT DUST GENERATION, WATERING DOWN OF THE SITE, ESPECIALLY DURING THE MOVEMENT OF MACHINERY IS REQUIRED. WHERE EXCAVATING INTO ROCK, KEEP THE SURFACE MOIST TO MINIMISE DUST. CONSTRUCT A GRAVEL ENTRY/EXIT POINT USING BLUE METAL AND RESTRICT ALL VEHICLE MOVEMENTS WITHIN THE SITE TO A MINIMUM. ENSURE WIND BREAKS, SUCH AS EXISTING FENCES ARE MAINTAINED DURING THE CONSTRUCTION PHASE UNTIL NEW LANDSCAPING IS PROVIDED OR REINSTATED. PREVENT DUST BY COVERING STOCKPILES

## SEDIMENT NOTE:

1. ALL EROSION AND SEDIMENT CONTROL MEASURES TO BE INSPECTED AND MAINTAINED DAILY BY THE SITE MANAGER.

2. MINIMISE DISTURBED AREAS, REMOVE EXCESS SOIL FROM EXCAVATED AREA AS SOON AS POSSIBLE.
3. ALL MATERIAL STOCKPILE TO BE CLEAR FROM DRAINS, GUTTERS AND FOOTPATHS, OR WITHIN SEDIMENT FENCE AREA.

4. DRAINAGE TO BE CONNECTED TO STORMWATER AS SOON AS POSSIBLE. IF STORED ON SITE, IT MUST BE FILTERED BEFORE RELEASING INTO STORMWATER SYSTEM OR WATERWAYS

5. ROADS AND FOOTPATHS TO BE SWEPT DAILY.

## STOCKPILES:

ALL STOCKPILES ARE TO BE KEPT ON-SITE WHERE POSSIBLE. ANY MATERIALS PLACED ON THE FOOTPATHS OR NATURE STRIPS REQUIRE COUNCIL'S PERMISSION.

ALL STOCKPILES ARE TO BE PLACED AWAY FROM THE DRAINAGE LINES AND STREET GUTTERS. IT IS BEST TO LOCATE THESE ON THE HIGHEST PART OF THE SITE IF POSSIBLE. PLACE WATERPROOF COVERING OVER STOCKPILES.

IF REQUIRED PROVIDE DIVERSION DRAIN & BANK AROUND STOCKPILES.

## **GUTTER PROTECTION:**

PROVIDE PROTECTION TO DOWNHILL GRATE IN GUTTER BY MEANS OF SAND BAGS OR BLUE METAL WRAPPED IN GEOTEXTILE FABRIC. WHEN SOIL OR SAND BUILDS UP AROUND THIS SEDIMENT BARRIER, THE MATERIAL SHOULD BE RELOCATED BACK TO THE SITE FOR DISPOSAL.


NOTE: ALL PROPOSED STORMWATER TO CONNECT WITH EXISTING

ACTION PLANS

m: 0426 957 518 e:operations@actionplans.com.au w: www.actionplans.com.au REV.


DATE

COMMENTS

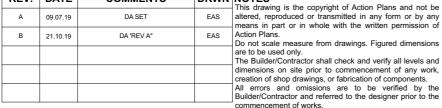

DRWN NOTES

SITE / ROOF / SEDIMENT EROSION / WASTE MANAGEMENT / STORMWATER CONCEPT PLAN

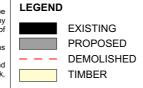

CLIENT

beaches

THIS PLAN IS TO BE READ IN

**CONJUNCTION WITH** 

THE CONDITIONS OF DEVELOPMENT

CONSENT

DA2019/0907

ELIZABETH & ANDREW SWEENEY

1:200

PROJECT ADDRESS 43 QUINTON ROAD, MANLY, 2095 DRAWING NO.

DA02


DATE
Monday, 21 October 2019


DRAWING NAME

SITE / ROOF / SEDIMENT EROSION / WASTE MANAGEMENT / STORMWATER CONCEPT PLAN

SCALE


1:200 @A3

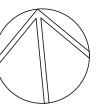

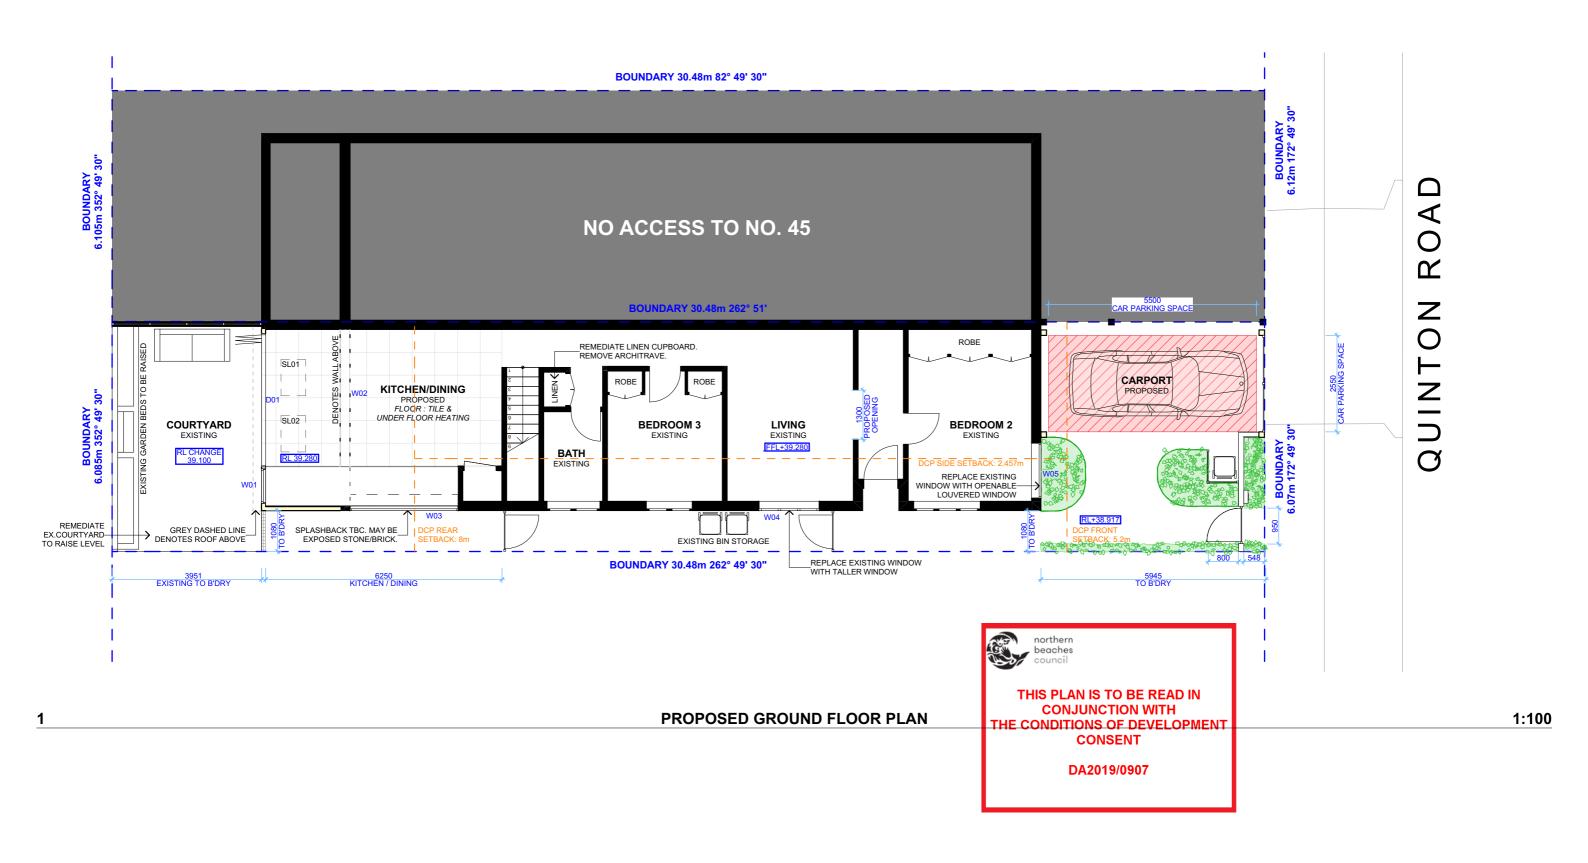



REV.	DATE	COMMENTS	DRWN	NOTES
А	09.07.19	DA SET	EAS	This drawing is the copyright of Action Plans and not be altered, reproduced or transmitted in any form or by any means in part or in whole with the written permission of
В	21.10.19	DA 'REV A"	EAS	Action Plans.  Do not scale measure from drawings. Figured dimensions
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				All errors and omissions are to be verified by the Builder/Contractor and referred to the designer prior to the
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PROJECT ADDRESS 43 QUINTON ROAD, MANLY, 2095 DRAWING NO.

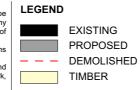DA05

**DATE**Monday, 21 October


2019

DRAWING NAME
PROPOSED GROUND FLOOR

PLAN

SCALE 1:100 @A3



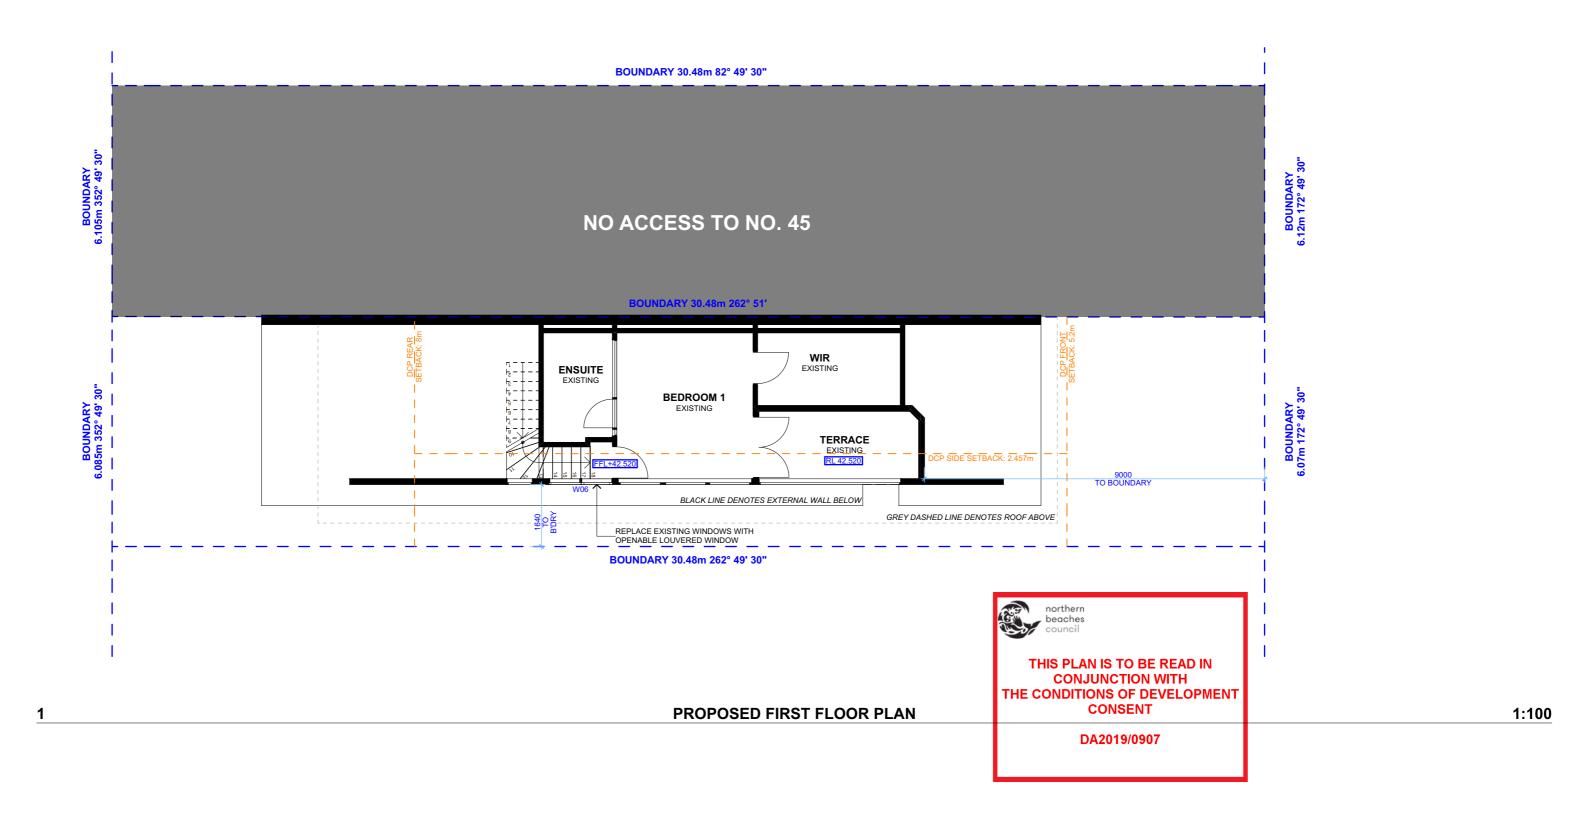



REV. DATE

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				All errors and omissions are to be verified by the Builder/Contractor and referred to the designer prior to the	
				commencement of works.	

DRWN NOTES



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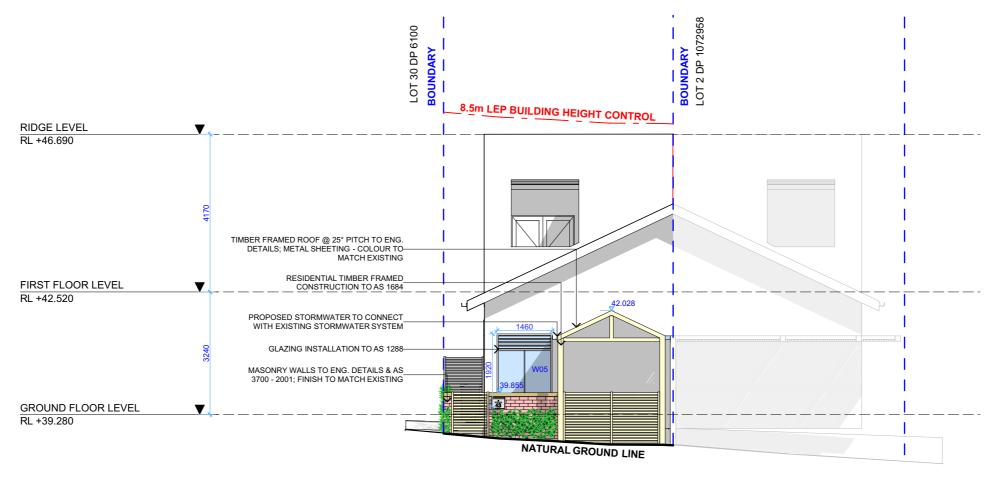
DA06

DATE Monday, 21 October 2019 DRAWING NAME


PROPOSED FIRST FLOOR PLAN

SCALE 1:100 @A3





**EAST ELEVATION** 1:100

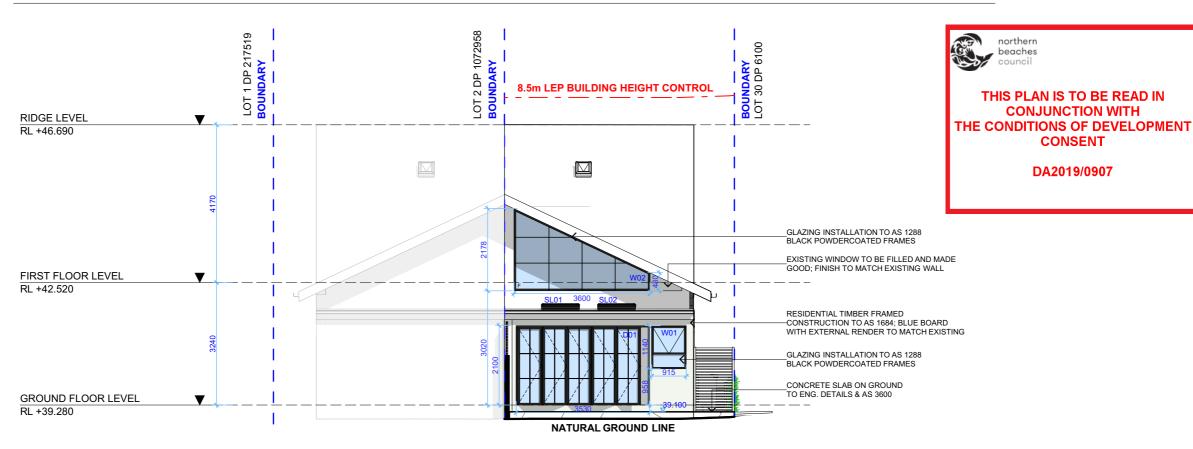

**WEST ELEVATION** 1:100



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DRWN NOTES

COMMENTS



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43 QUINTON ROAD,

MANLY, 2095

CLIENT

EENEY	
O IECT ADDRESS	

<b>DA07</b>	

DRAWING NO.

EAST / WEST ELEVATION

DATE
Monday, 21 October
2019

SCALE

1:100 @A3

DRAWING NAME



