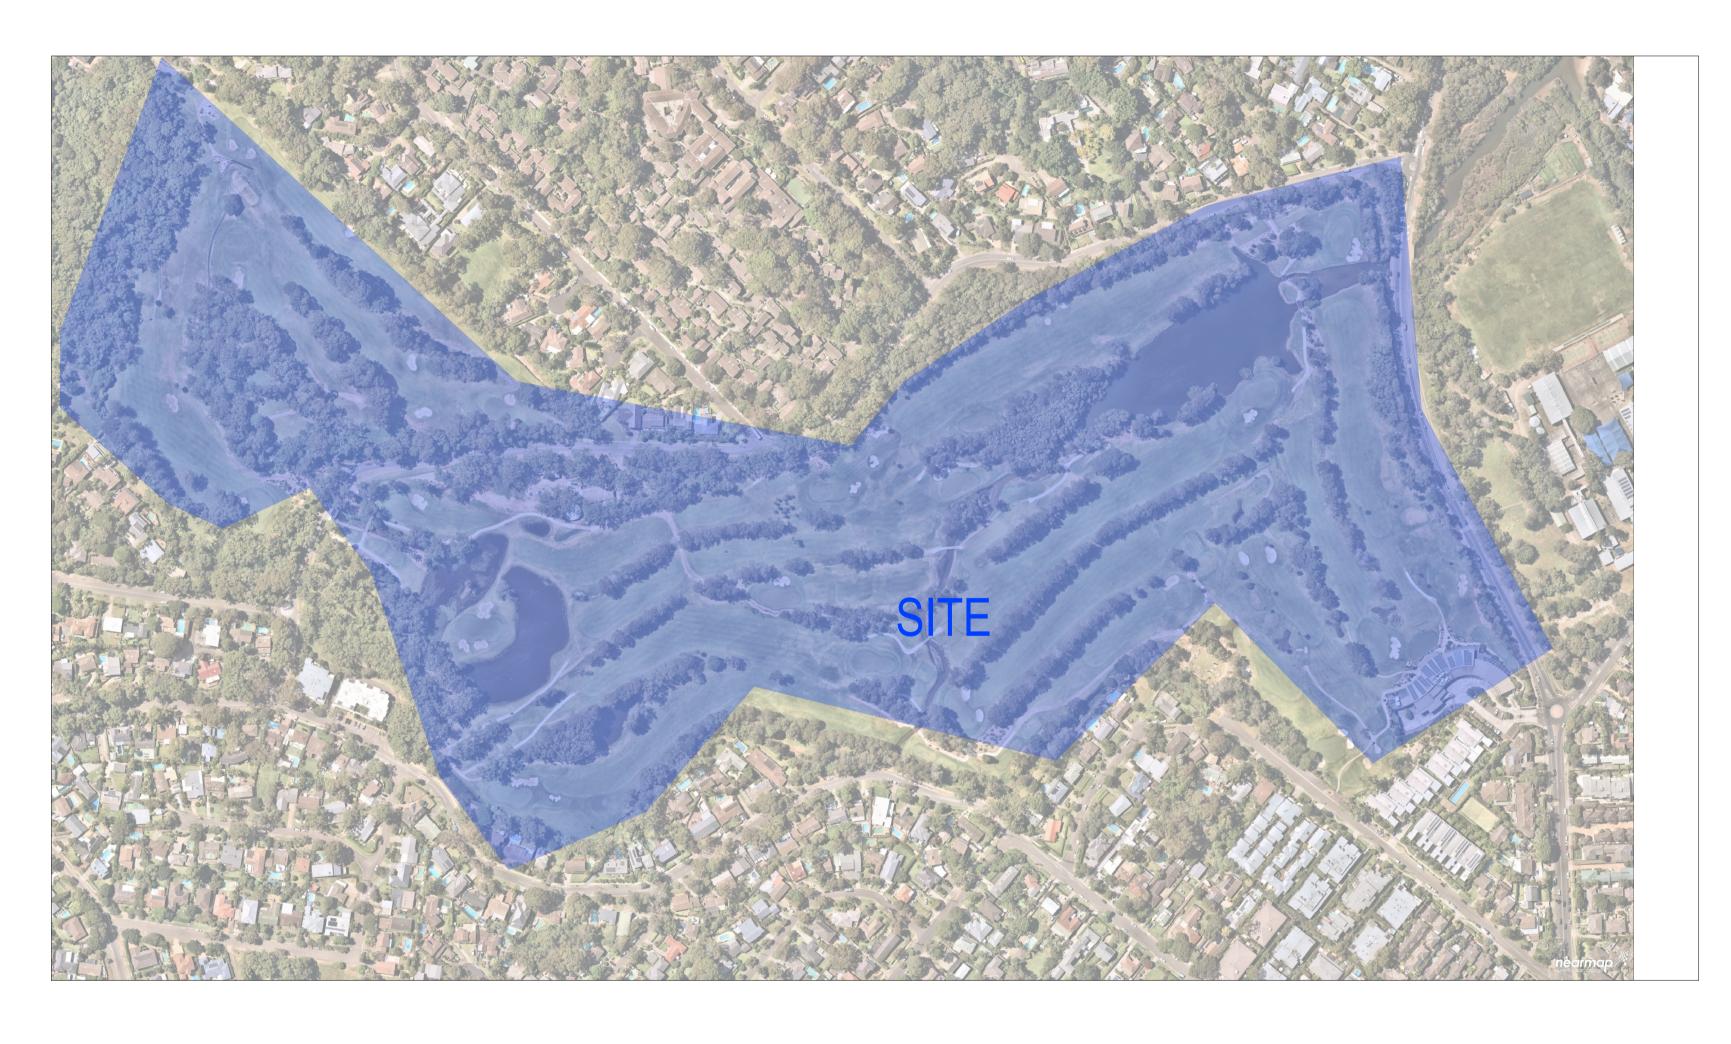
SEDIMENT & EROSION CONTROL STORWATER & SOIL MANAGEMENT PLAN BAYVIEW GOLF CLUB

	DRAWING LIST									
DRAWING No.	DRAWING TITLE									
C100	TITLE PAGE & LOCALITY PLAN									
C105	SEDIMENT & EROSION CONTROL DETAILS									
C110	ZONE MAP AREAS & GENERAL WORKS									
C111	1 ST GREEN DETAIL PLAN									
C112	2 ND GREEN DETAIL PLAN									
C113	3 RD GREEN DETAIL PLAN									
C114	4 TH GREEN DETAIL PLAN									
C115	5 TH GREEN DETAIL PLAN									
C116	6 TH GREEN DETAIL PLAN									
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C118	8 TH GREEN DETAIL PLAN									
C119	10 TH GREEN DETAIL PLAN									
C120	11 TH GREEN DETAIL PLAN									
C121	12 TH GREEN DETAIL PLAN									
C122	13 TH GREEN DETAIL PLAN									



LOCALITY PLAN 1825 PITTWATER ROAD, MONA VALE NSW, 2103, AUSTRALIA

BEFORE YOU DIG AUSTRALIA



IMPORTANT: THE CONTRACTOR IS TO MAINTAIN A CURRENT SET OF "BEFORE YOU DIG AUSTRALIA" DRAWINGS ON SITE AT ALL TIMES.

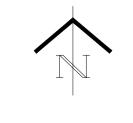
ISSUE FOR DEVELOPMENT APPLICATION

REV	DATE	REVISION DESCRIPTION		
Α	27.02.2023	ISSUE FOR REVIEW AND COMMENT	TITLE	NAME
В	06.03.2023	ISSUE FOR APPROVAL	- DRAWN	DI
			DESIGNED	CP
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SEDIMENT AND EROSION CONTROL & STORMWATER MANAGEMENT BAYVIEW GOLF CLUB

TITLE PAGE & LOCALITY PLAN

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SCALE @ A1 SHEET NO C100

EROSION AND SEDIMENT CONTROL

GENERAL INSTRUCTIONS

- 1. THIS PLAN IS TO BE READ IN CONJUNCTION WITH THE ENGINEERING PLANS, AND ANY OTHER PLANS OR WRITTEN INSTRUCTIONS THAT MAY BE ISSUED AND RELATING TO DEVELOPMENT AT THE SUBJECT SITE.
- 2. THE SITE SUPERINTENDENT WILL ENSURE THAT ALL SOIL AND WATER MANAGEMENT WORKS ARE LOCATED AS INSTRUCTED IN THIS SPECIFICATION.
- 3. ALL BUILDERS AND SUB-CONTRACTORS WILL BE INFORMED OF THEIR RESPONSIBILITIES IN MINIMISING THE POTENTIAL FOR SOIL EROSION AND POLLUTION TO DOWNSLOPE LANDS AND WATERWAYS.

CONSTRUCTION SEQUENCE

- 4. THE SOIL EROSION POTENTIAL ON THIS SITE SHALL BE MINIMISED. HENCE WORKS SHALL BE UNDERTAKEN IN THE FOLLOWING SEQUENCE:
- a. INSTALL SEDIMENT FENCES, TEMPORARY CONSTRUCTION EXIT AND SANDBAG KERB INLET SEDIMENT TRAP. b. UNDERTAKE SITE DEVELOPMENT WORKS IN ACCORDANCE WITH THE ENGINEERING PLANS. PHASE DEVELOPMENT SO THAT LAND

DISTURBANCE IS CONFINED TO AREAS OF WORKABLE SIZE.

EROSION CONTROL

- 5. DURING WINDY CONDITIONS, LARGE, UNPROTECTED AREAS WILL BE KEPT MOIST (NOT WET) BY SPRINKLING WITH WATER TO KEEP DUST UNDER CONTROL.
- 6. FINAL SITE LANDSCAPING WILL BE UNDERTAKEN AS SOON AS POSSIBLE AND WITHIN 20 WORKING DAYS FROM COMPLETION OF CONSTRUCTION ACTIVITIES.

<u>FENCING</u>

- 7. STOCKPILES WILL NOT BE LOCATED WITHIN 2 METRES OF HAZARD AREAS, INCLUDING LIKELY AREAS OF CONCENTRATED OR HIGH VELOCITY FLOWS SUCH AS WATERWAYS. WHERE THEY ARE BETWEEN 2 AND 5 METRES FROM SUCH AREAS, SPECIAL SEDIMENT CONTROL MEASURES SHOULD BE TAKEN TO MINIMISE POSSIBLE POLLUTION TO DOWNSLOPE WATERS, E.G. THROUGH INSTALLATION OF SEDIMENT FENCING.
- 8. ANY SAND USED IN THE CONCRETE CURING PROCESS (SPREAD OVER THE SURFACE) WILL BE REMOVED AS SOON AS POSSIBLE AND WITHIN 10 WORKING DAYS FROM PLACEMENT.
- 9. WATER WILL BE PREVENTED FROM ENTERING THE PERMANENT DRAINAGE SYSTEM UNLESS IT IS RELATIVELY SEDIMENT FREE, I.E. THE CATCHMENT AREA HAS BEEN PERMANENTLY LANDSCAPED AND/OR ANY LIKELY SEDIMENT HAS BEEN FILTERED THROUGH AN APPROVED STRUCTURE.
- 10. TEMPORARY SOIL AND WATER MANAGEMENT STRUCTURES WILL BE REMOVED ONLY AFTER THE LANDS THEY ARE PROTECTING ARE REHABILITATED.

OTHER MATTERS

- 11. ACCEPTABLE RECEPTORS WILL BE PROVIDED FOR CONCRETE AND MORTAR SLURRIES, PAINTS, ACID WASHINGS, LIGHT-WEIGHT WASTE MATERIALS AND LITTER.
- 12. RECEPTORS FOR CONCRETE AND MORTAR SLURRIES, PAINTS, ACID WASHINGS, LIGHT-WEIGHT WASTE MATERIALS AND LITTER ARE TO BE EMPTIED AS NECESSARY. DISPOSAL OF WASTE SHALL BE IN A MANNER APPROVED BY THE SITE SUPERINTENDENT.

SITE INSPECTION & MAINTENANCE

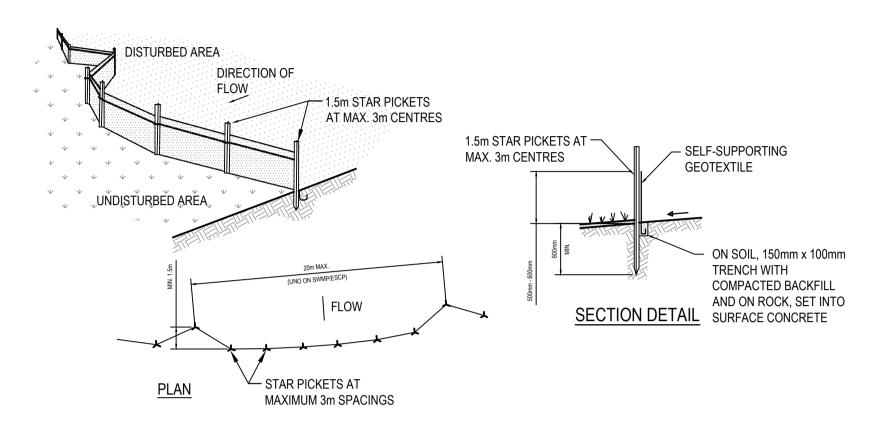
- 13. EROSION AND SEDIMENT CONTROL MEASURES SHALL BE INSPECTED AFTER RAINFALL EVENTS TO ENSURE THAT THEY OPERATE EFFECTIVELY. REPAIR AND OR MAINTENANCE SHALL BE UNDERTAKEN AS REQUIRED.
- ALL STRIPPED TOPSOIL AND EARTHWORKS IS TO BE RELOCATED ON SITE AT THE DISCRETION OF THE CLIENT AND ARBORIST. FOR MATERIAL WHICH CANNOT BE RE-USED ON SITE, IT IS TO BE STOCKPILED AND REMOVED FROM SITE

SEDIMENT & EROSION CONTROL LEGEND

SEDIMENT FENCE



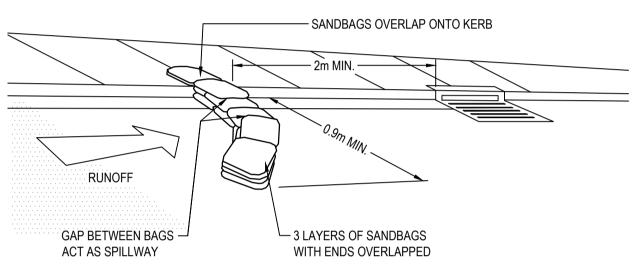
SAND BAG SEDIMENT TRAP TO BE USED AT ALL CONSTRUCTED OR EXISTING PITS SAND BAG CAN BE USED FOR SUBSTITUTE TO SEDIMENT FENCE WHERE INSTALLATION OF STAKES IS NOT POSSIBLE SUCH AS ADJACENT TO TREES, IN ROCK OR AT INTERFACE WITH PATHWAYS



CONSTRUCTION NOTES

- 1. CONSTRUCT SEDIMENT FENCE AS CLOSE AS POSSIBLE TO PARALLEL TO THE CONTOURS
- DRIVE 1.5m LONG STAR PICKETS INTO GROUND, 3 METERS APART. 3. DIG A 150mm DEEP TRENCH ALONG THE UPSLOPE LINE OF THE FENCE FOR THE BOTTOM
- OF THE FABRIC TO BE ENTRENCHED.
- 4. BACKFILL TRENCH OVER BASE OF FABRIC. 5. FIX SELF-SUPPORTING GEOTEXTILE TO UPSLOPE SIDE OF POSTS WITH WIRE TIES OR AS
- RECOMMENDED BY GEOTEXTILE MANUFACTURER.
- 6. JOIN SECTIONS OF FABRIC AT A SUPPORT POST WITH A 150mm OVERLAP.

SEDIMENT CONTROL FENCE



SANDBAG SEDIMENT TRAP

ISSUE FOR DEVELOPMENT APPLICATION

REV DATE REVISION DESCRIPTION NAME A 27.02.2023 ISSUE FOR REVIEW AND COMMENT B 06.03.2023 ISSUE FOR APPROVAL CP DESIGNED . CP DRG CHECK . AL DESIGN CHECK CP APPROVED



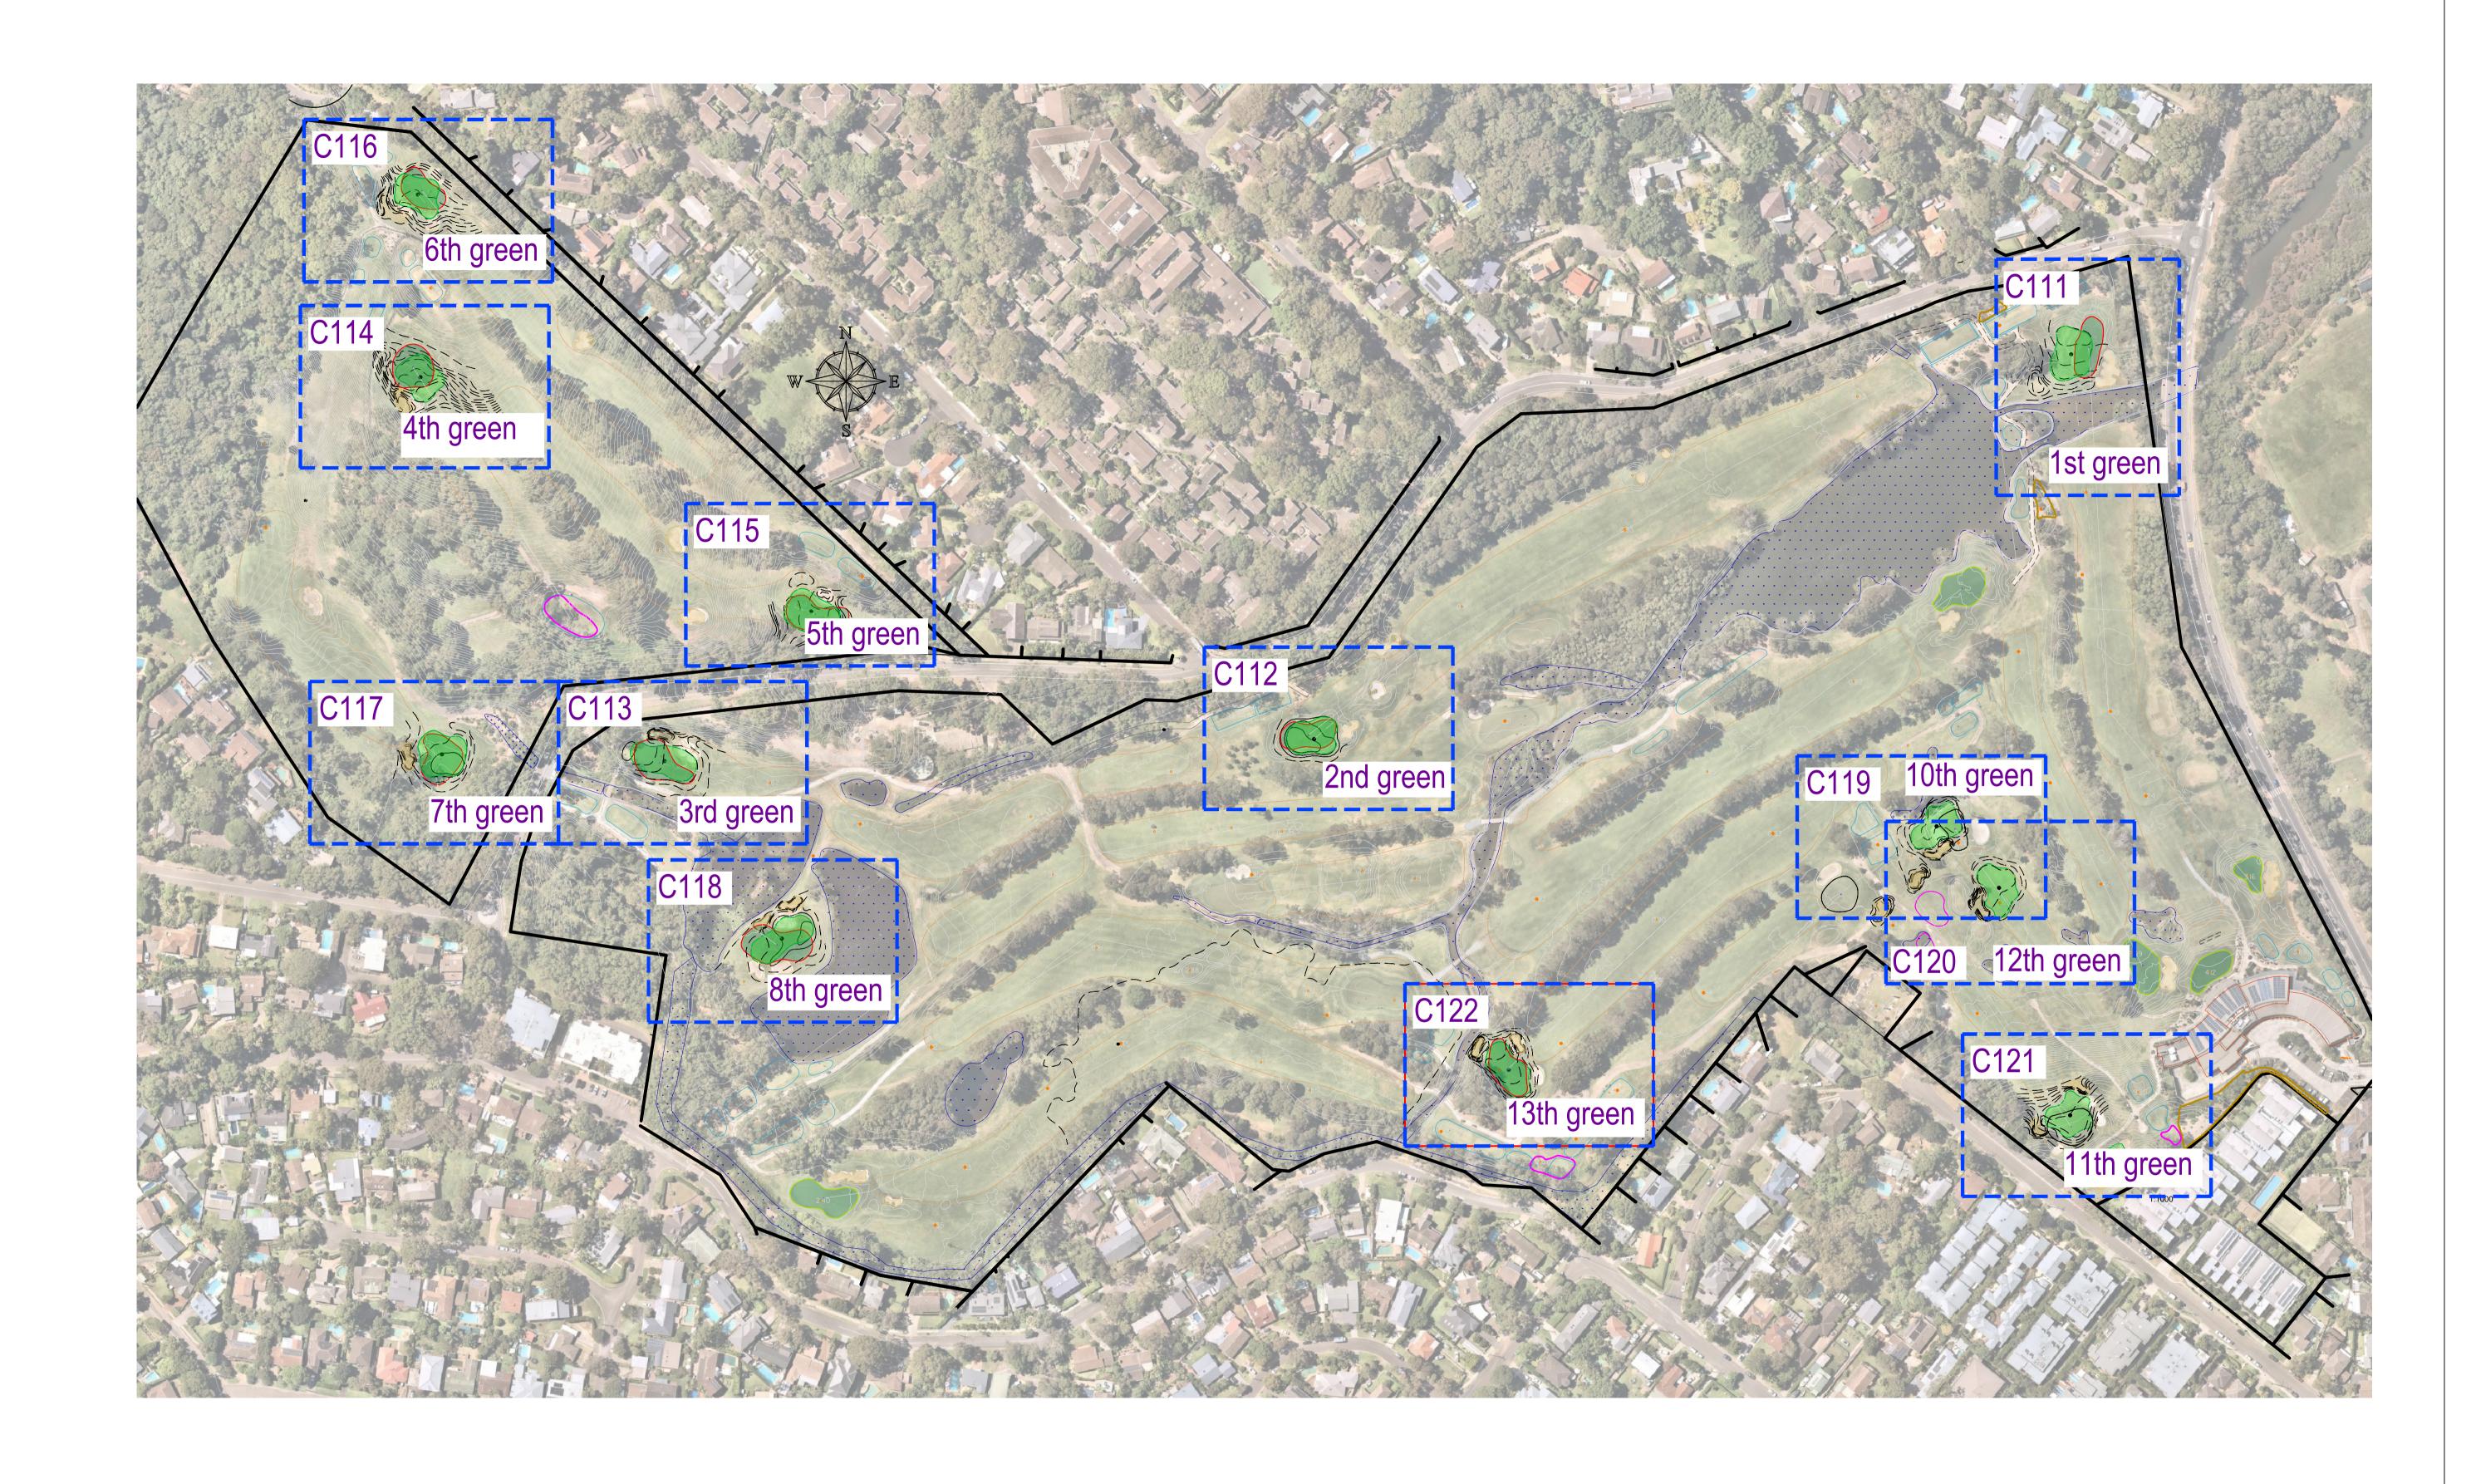


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SEDIMENT AND EROSION CONTROL & STORMWATER MANAGEMENT BAYVIEW GOLF CLUB

SEDIMENT & EROSION CONTROL DETAILS

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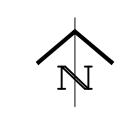
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BAYVIEW GOLF CLUB

ZONE MAP AREAS & GENERAL WORKS

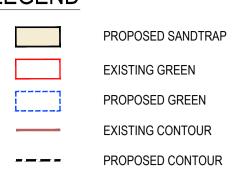
STORMWATER MANAGEMENT

SEDIMENT AND EROSION CONTROL &

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B NUMBER: 3003

SCALE @ A1 SHEET No REV B



SEDIMENT FENCE

CUT & FILL LEGEND

FROM	<u>TO</u>
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-1.75	-1.50
-1.50	-1.25
-1.25	-1.00
-1.00	-0.75
-0.75	-0.50
-0.50	-0.25
-0.25	-0.001
-0.000	0.000
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0.25	0.50
0.50	0.75
0.75	1.00
1.00	1.25
1.25	1.50
	-2.00 -1.75 -1.50 -1.25 -1.00 -0.75 -0.50 -0.25 -0.000 0.001 0.25 0.50 0.75 1.00

CUT AND FILL VOLUMES

Assessment Surfaces	Volumes	noie noie											TOTAL	
	m3	1st	2nd	3rd	4th	5th	6th	7th	8th	10th	11th	12th	13th	m3
Final Surface	Cut	26	40	102	1230	35	1026	103	193	5	1060	0	6	3826
V	Fill	461	149	188	3	199	38	125	44	549	7	470	432	2665
Existing Surface	Balance	435	109	86	-1227	164	-988	22	-149	544	-1053	470	426	-1161



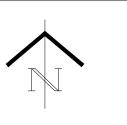
ISSUE FOR DEVELOPMENT APPLICATION

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SEDIMENT AND EROSION CONTROL & STORMWATER MANAGEMENT BAYVIEW GOLF CLUB

1ST GREEN DETAIL PLAN

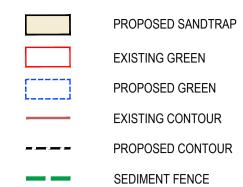
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CUT & FILL LEGEND

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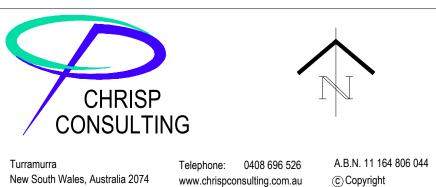


CUT AND FILL VOLUMES

ISSUE FOR DEVELOPMENT APPLICATION

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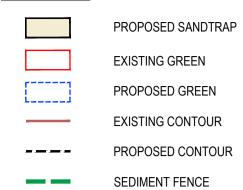


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2ND GREEN DETAIL PLAN

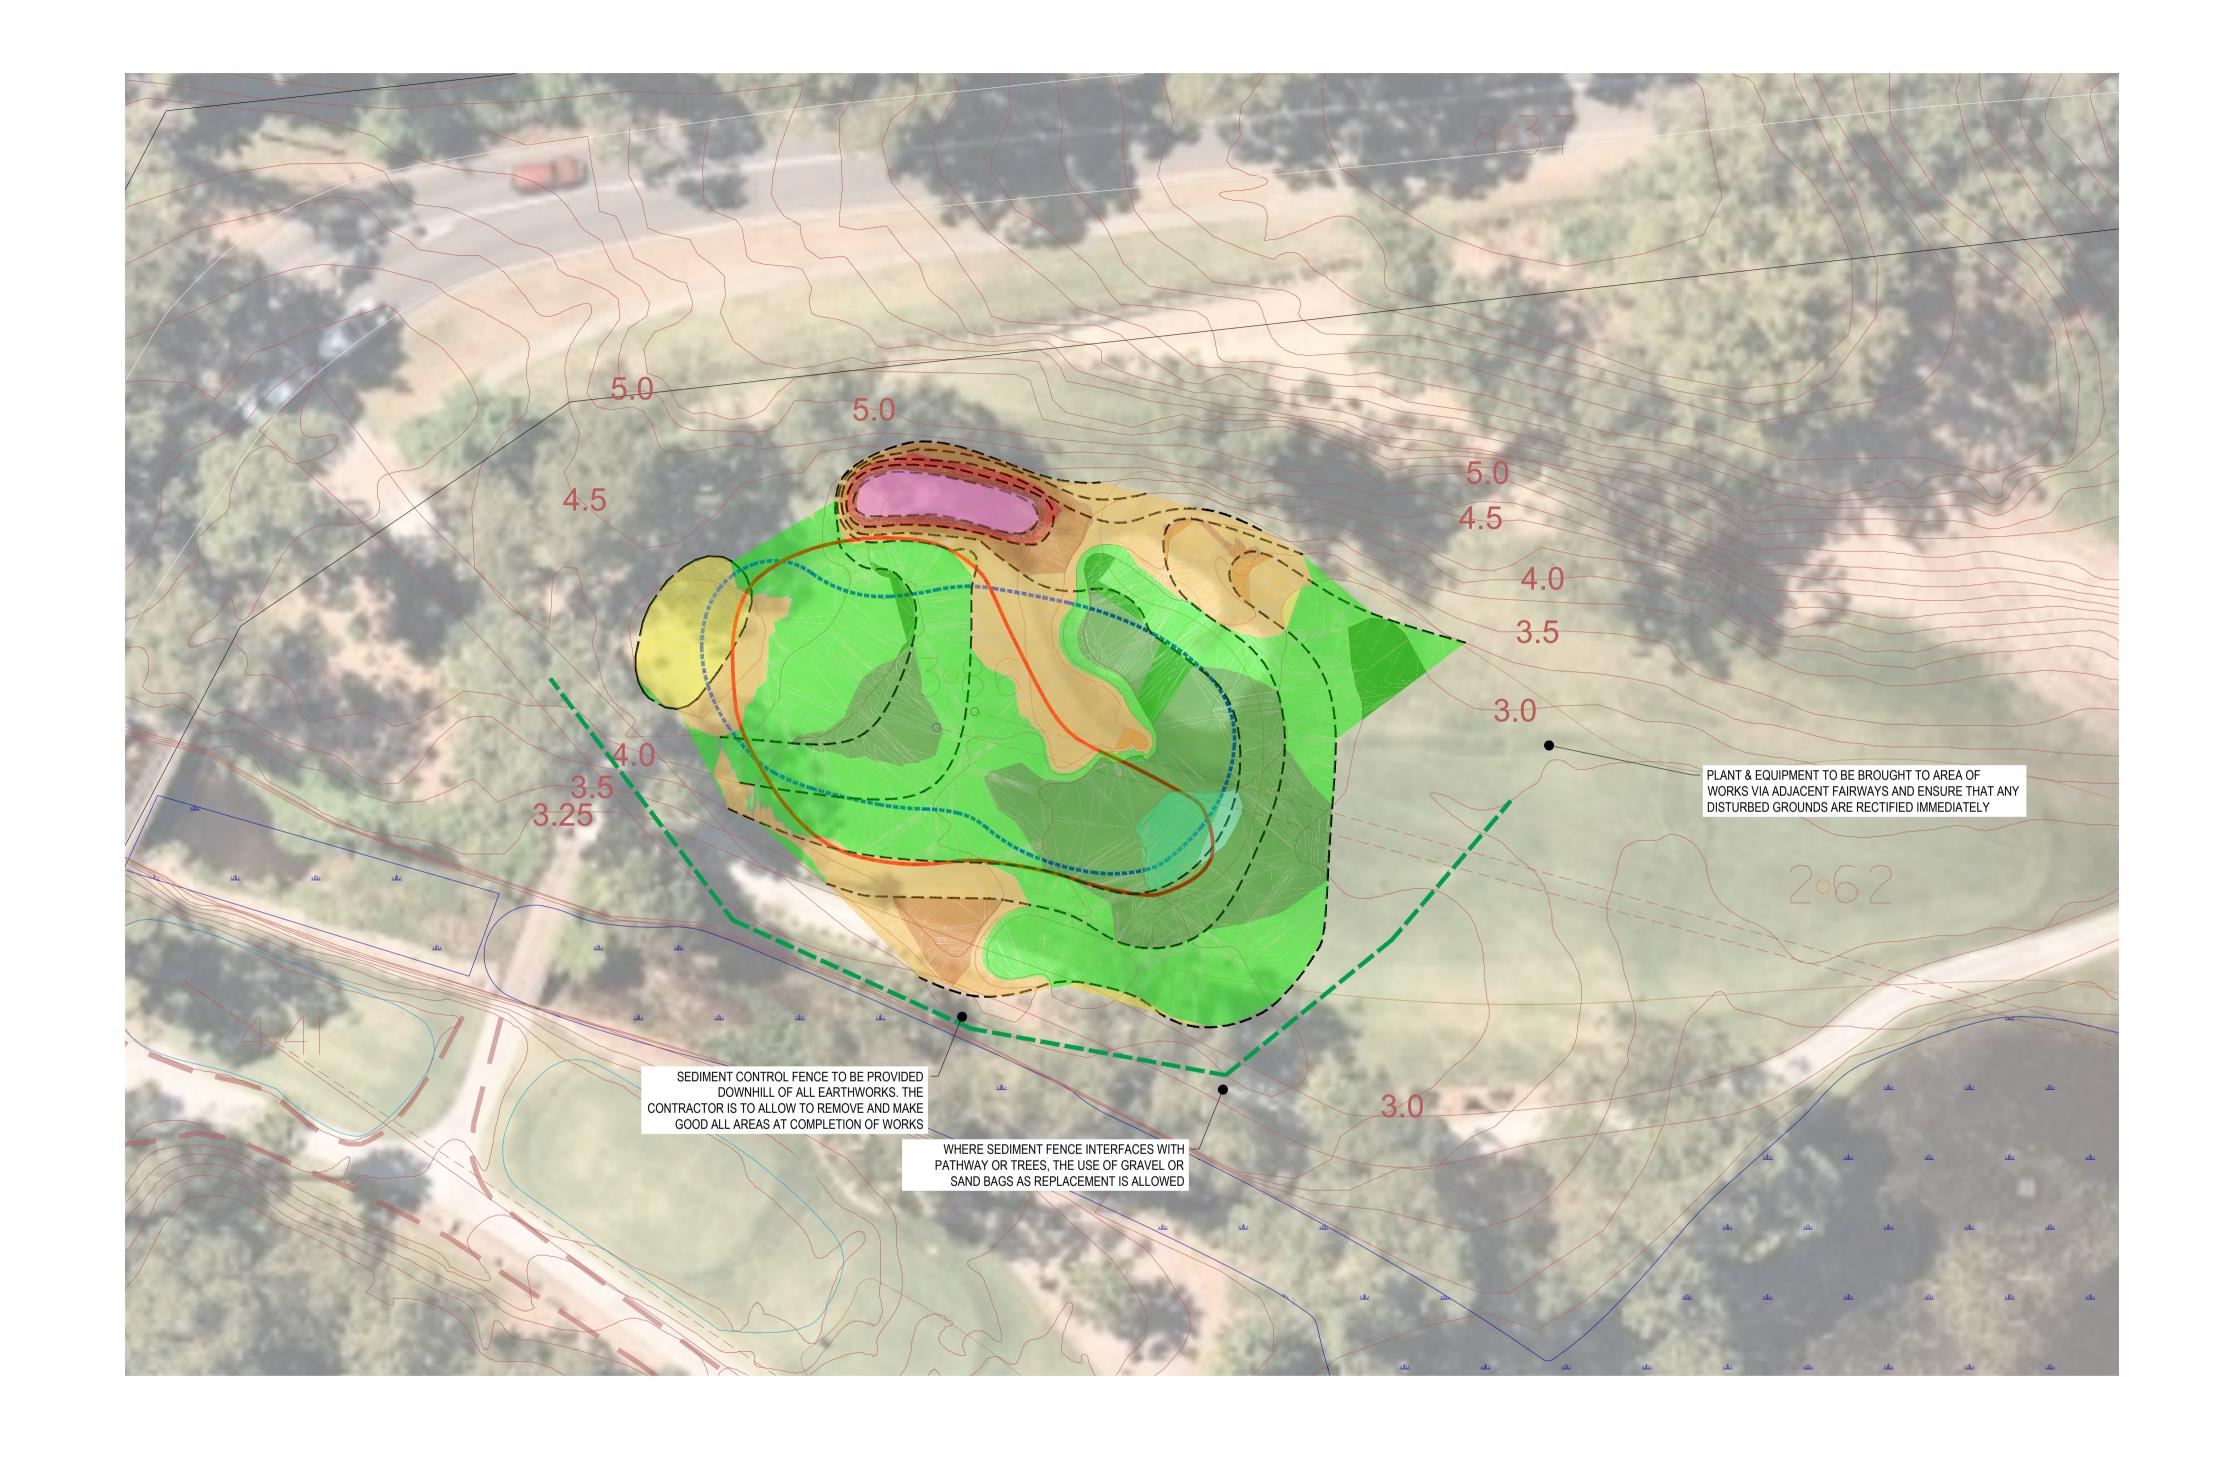
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CUT & FILL LEGEND

001 41		
	FROM	<u>TO</u>
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	-1.75	-1.50
	-1.50	-1.25
	-1.25	-1.00
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	-0.50	-0.25
	-0.25	-0.001
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	1.25	1.50



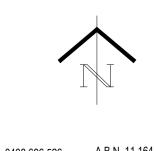
CUT AND FILL VOLUMES

SCALE 1:250 @ A1 SCALE 1:500 @ A3

Assessment Surfaces	Volumes		Hole											TOTAL
	m3	1st	2nd	3rd	4th	5th	6th	7th	8th	10th	11th	12th	13th	m3
Final Surface	Cut	26	40	102	1230	35	1026	103	193	5	1060	0	6	3826
V	Fill	461	149	188	3	199	38	125	44	549	7	470	432	2665
Existing Surface	Balance	435	109	86	-1227	164	-988	22	-149	544	-1053	470	426	-1161

ISSUE FOR DEVELOPMENT APPLICATION

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SEDIMENT AND EROSION CONTROL & STORMWATER MANAGEMENT BAYVIEW GOLF CLUB

3RD GREEN DETAIL PLAN

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GOLF CLUB

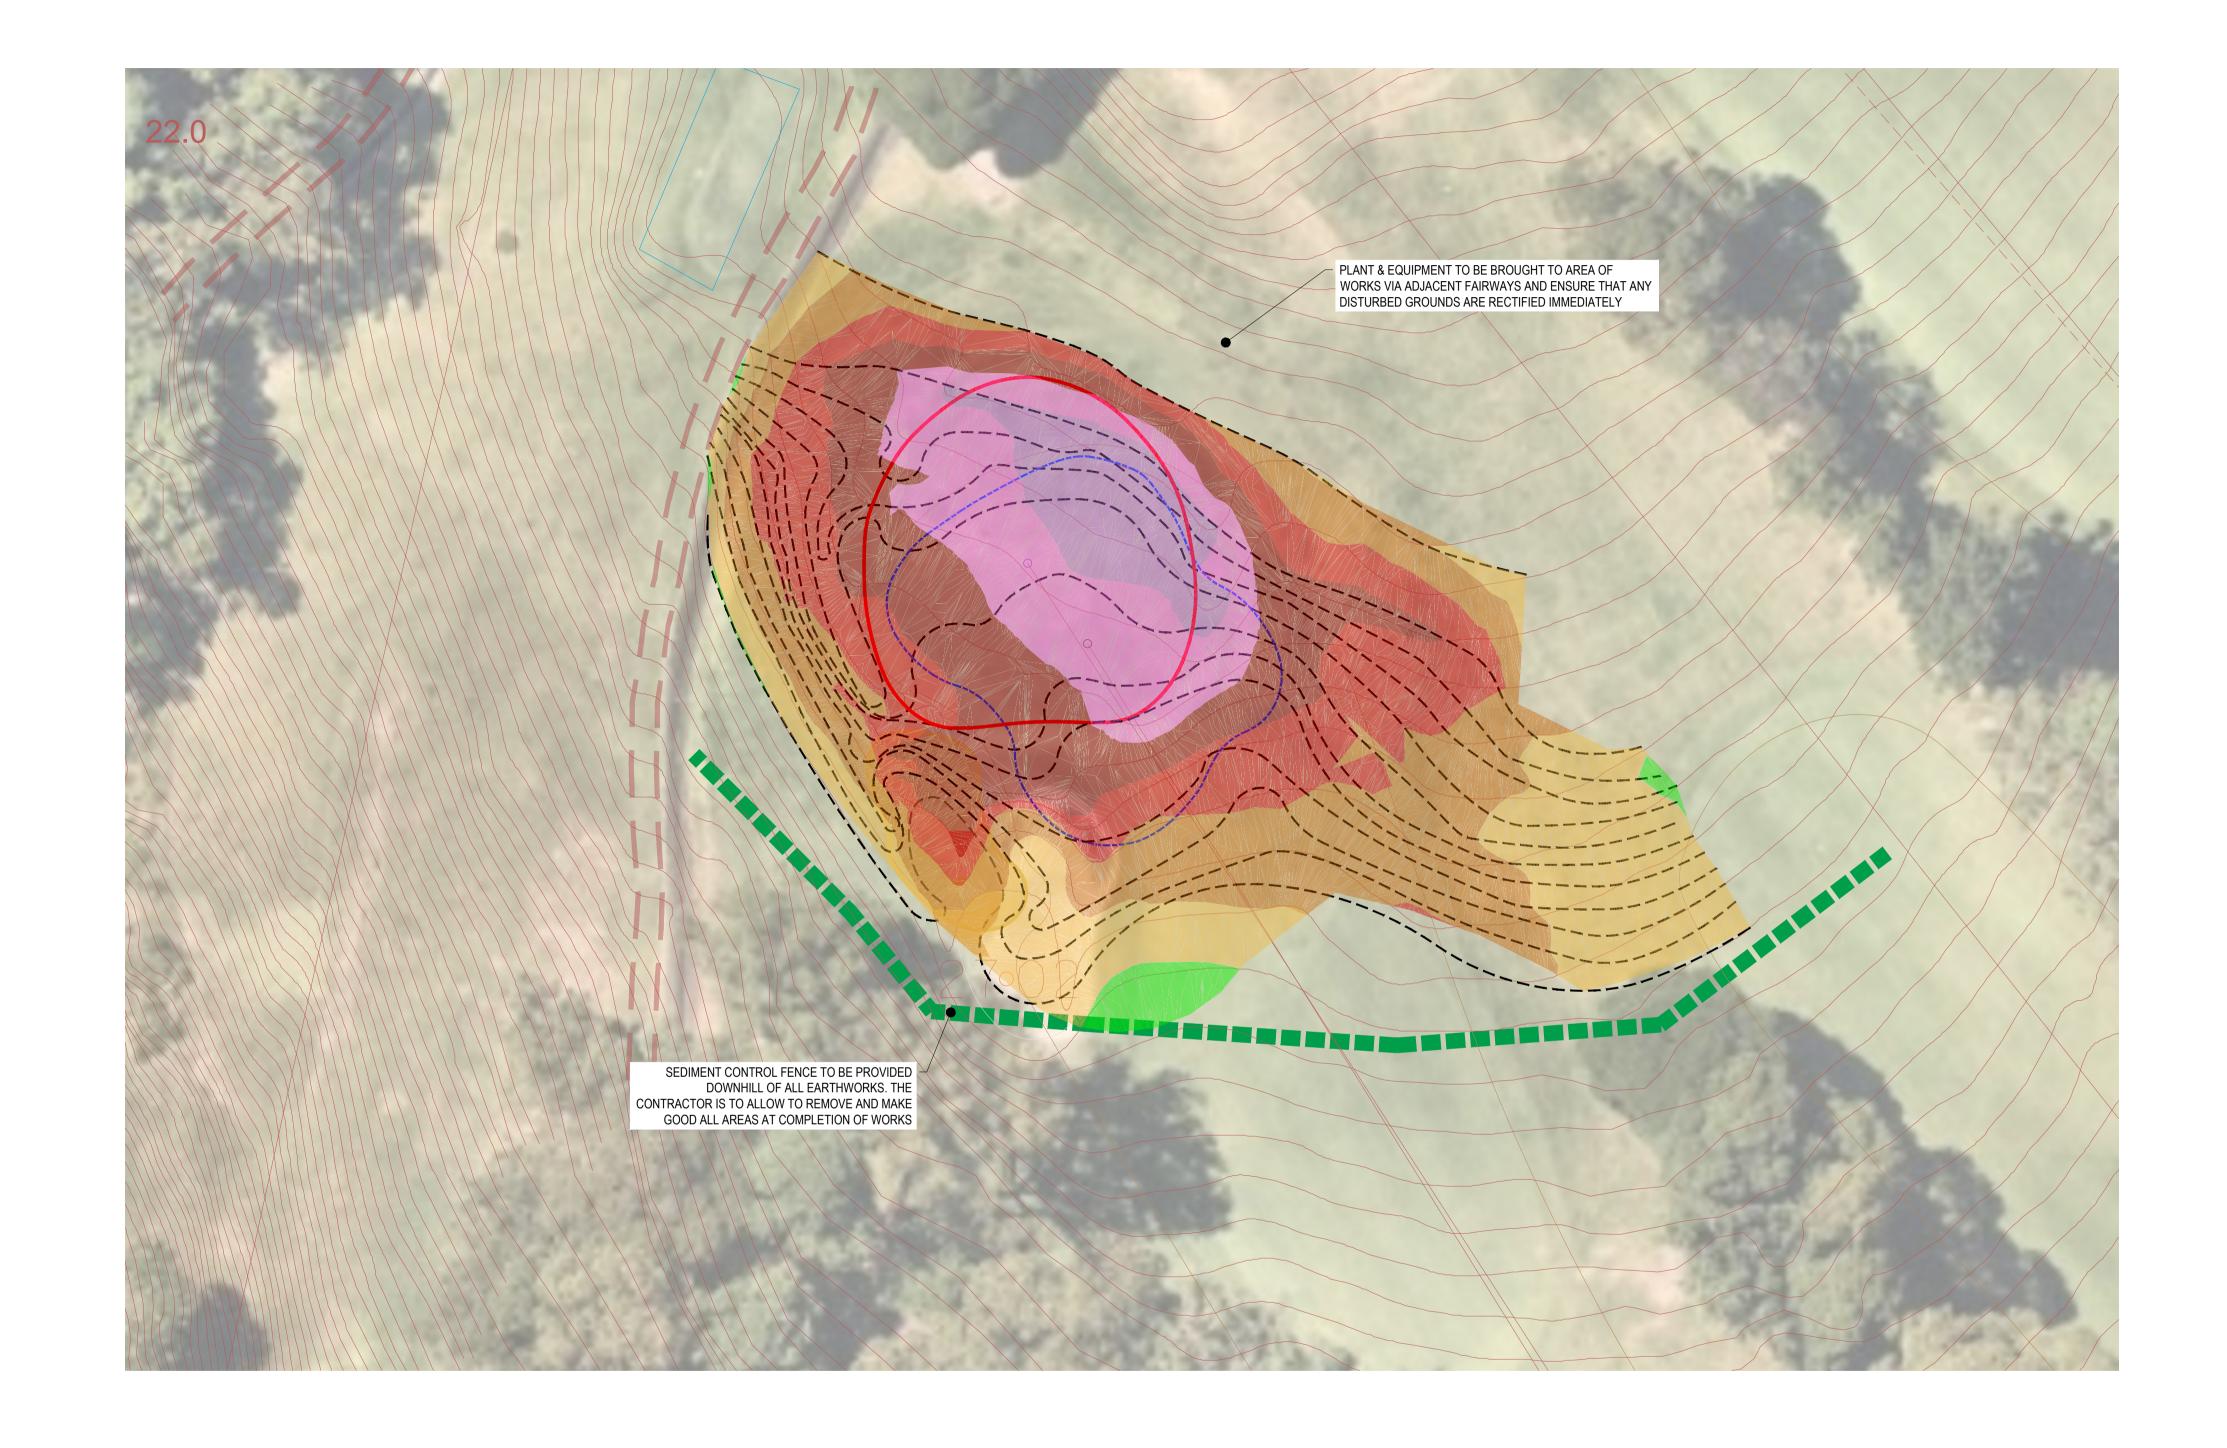
Telephone: 0408 696 526 A.B.N. 11 164 806 044





CUT & FILL LEGEND

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	-0.25	-0.001
	-0.000	0.000
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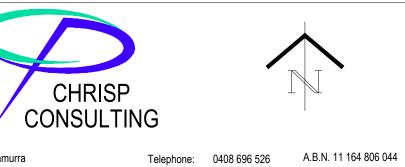


CUT AND FILL VOLUMES

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SEDIMENT AND EROSION CONTROL & STORMWATER MANAGEMENT BAYVIEW GOLF CLUB

4TH GREEN DETAIL PLAN

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PROPOSED SANDTRAP **EXISTING GREEN** PROPOSED GREEN EXISTING CONTOUR PROPOSED CONTOUR

SEDIMENT FENCE

FROM TO

CUT & FILL LEGEND

	-2.00	-1.75
	-1.75	-1.50
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	0.25	0.50
	0.50	0.75
	0.75	1.00
	1.00	1.25
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CUT AND FILL VOLUMES

Assessment Surfaces	Volumes		Hole											
	m3	1st	2nd	3rd	4th	5th	6th	7th	8th	10th	11th	12th	13th	m3
Final Surface	Cut	26	40	102	1230	35	1026	103	193	5	1060	0	6	3826
V	Fill	461	149	188	3	199	38	125	44	549	7	470	432	2665
Existing Surface	Balance	435	109	86	-1227	164	-988	22	-149	544	-1053	470	426	-1161

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SEDIMENT AND EROSION CONTROL & STORMWATER MANAGEMENT BAYVIEW GOLF CLUB

5TH GREEN DETAIL PLAN

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REV DATE REVISION DESCRIPTION

C 06.03.2023 ISSUE FOR APPROVAL

A 27.02.2023 ISSUE FOR REVIEW AND COMMENT

B 28.02.2023 CUT & FILL COLOURS ADDED AND UPDATED QUANTITIES

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CP

CP

GOLF CLUB

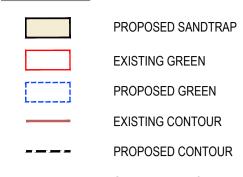
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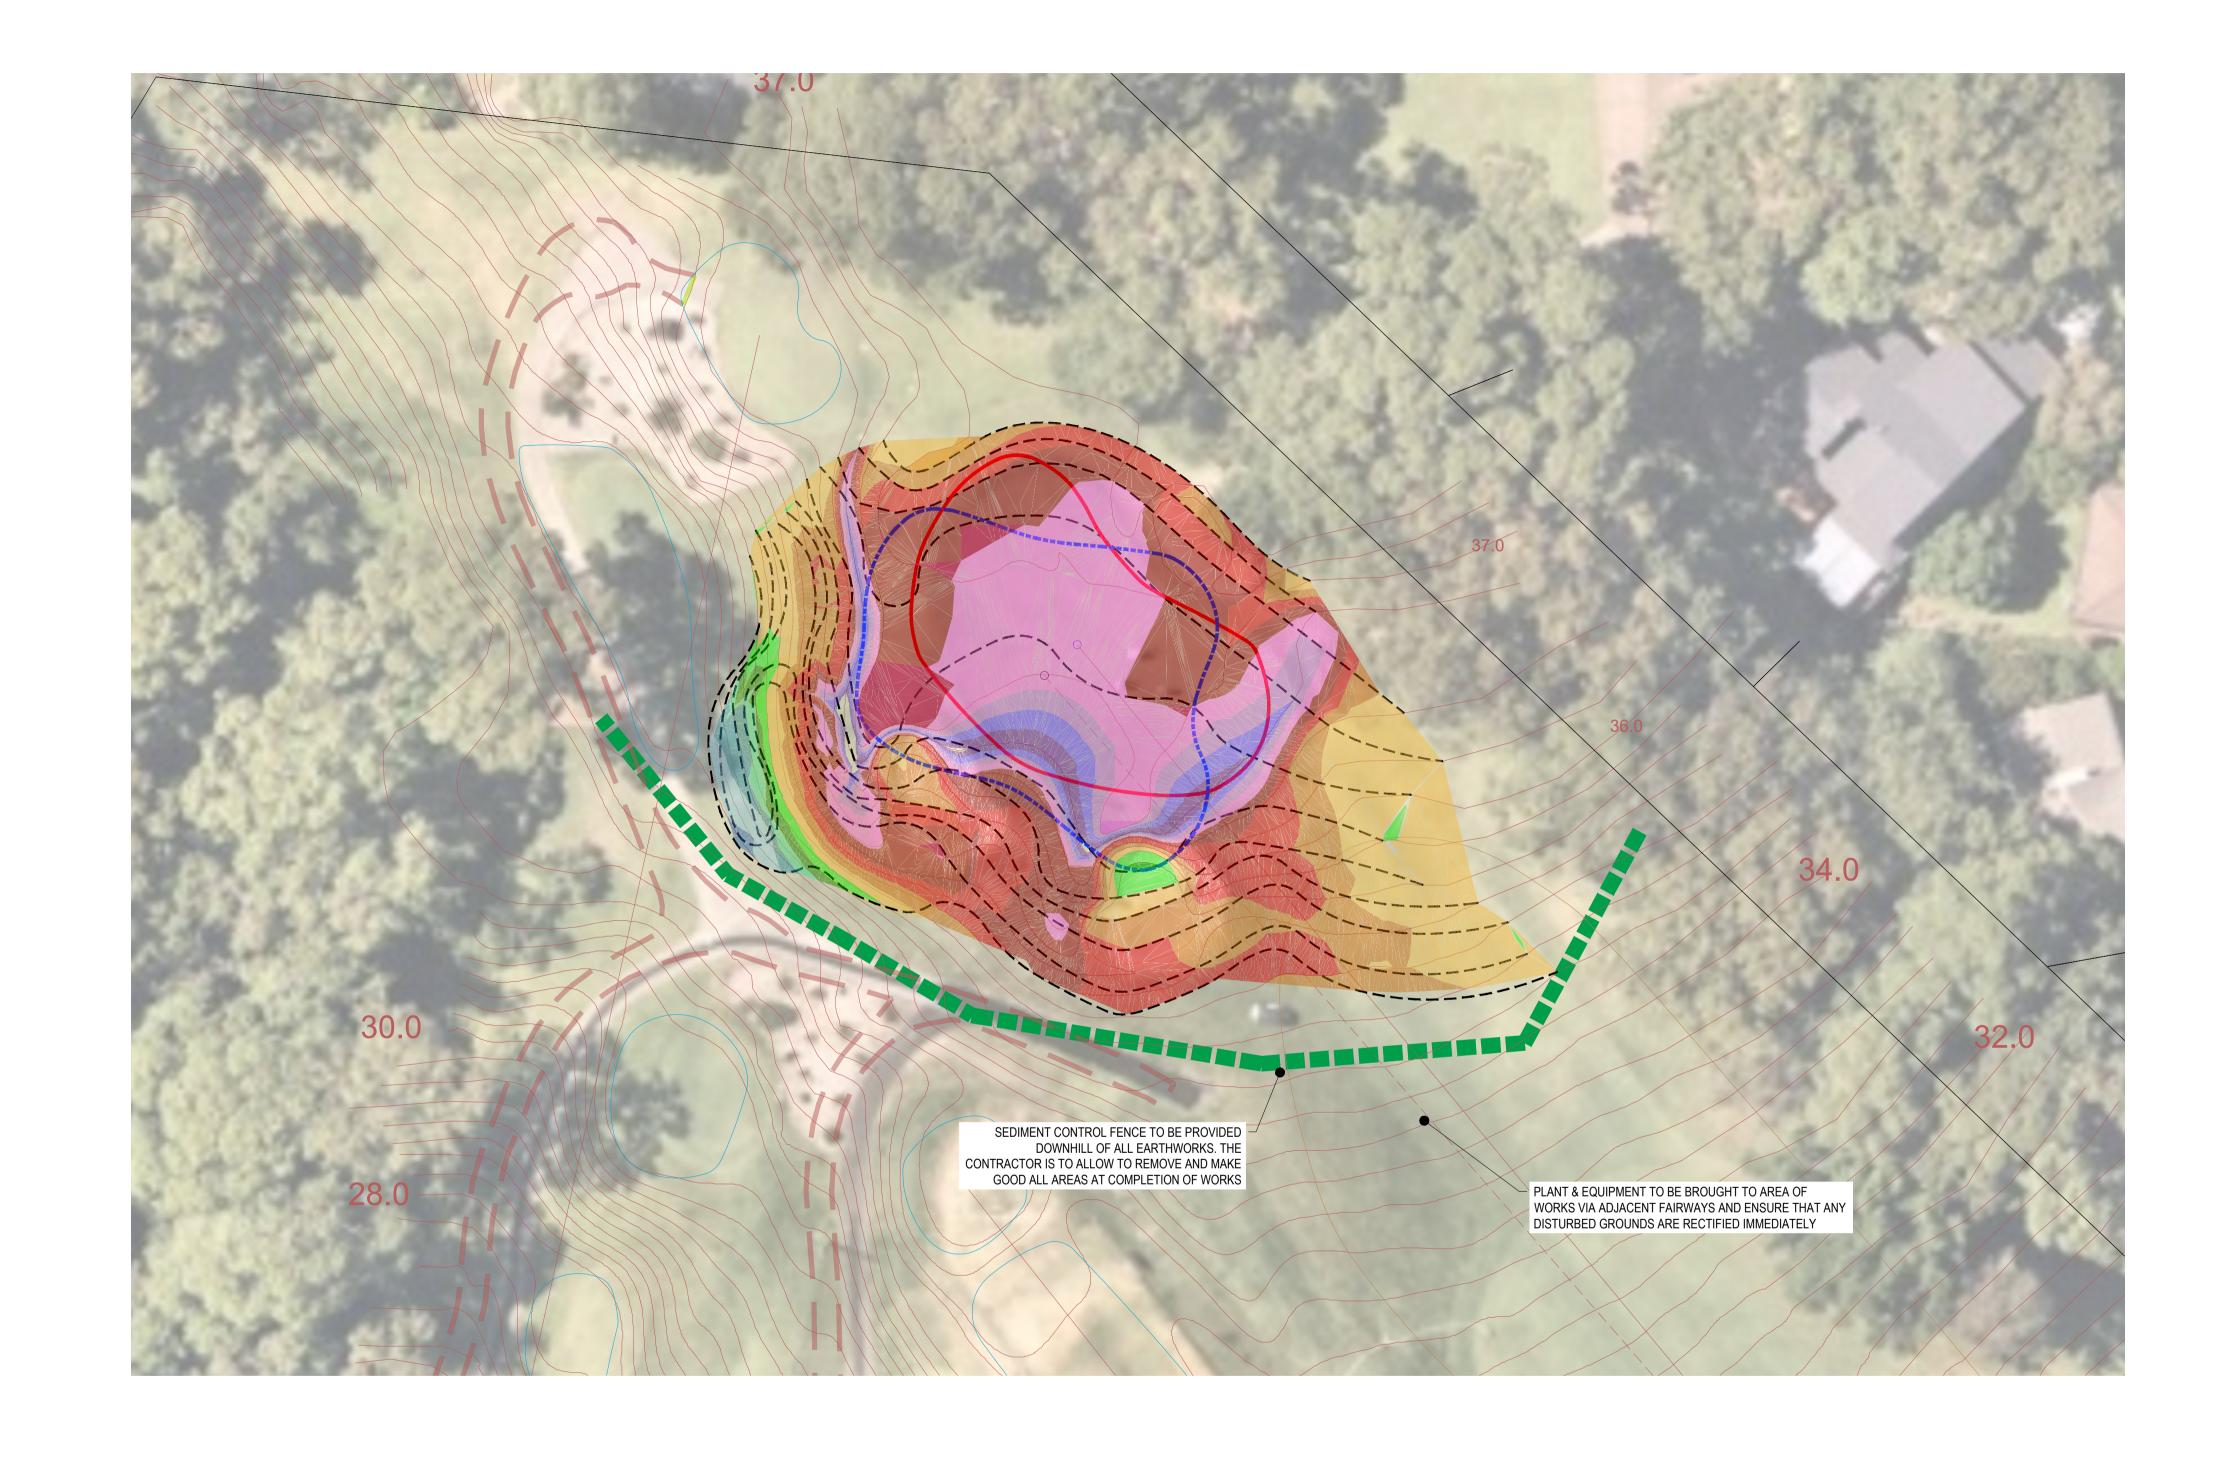
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CUT & FILL LEGEND

		
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	0.25	0.50
	0.50	0.75
	0.75	1.00
	1.00	1.25
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CUT AND FILL VOLUMES

Assessment Surfaces	Volumes		Hole											
	m3	1st	2nd	3rd	4th	5th	6th	7th	8th	10th	11th	12th	13th	m3
Final Surface	Cut	26	40	102	1230	35	1026	103	193	5	1060	0	6	3826
V	Fill	461	149	188	3	199	38	125	44	549	7	470	432	2665
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SEDIMENT AND EROSION CONTROL & STORMWATER MANAGEMENT BAYVIEW GOLF CLUB

6TH GREEN DETAIL PLAN

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GOLF CLUB DRG CHECK _ DESIGN CHECK

CP

TITLE

DESIGNED

SCALE 1:250 @ A1 SCALE 1:500 @ A3 CP APPROVED

B 28.02.2023 CUT & FILL COLOURS ADDED AND UPDATED QUANTITIES

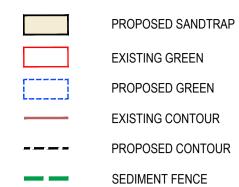
REV DATE REVISION DESCRIPTION

C 06.03.2023 ISSUE FOR APPROVAL

A 27.02.2023 ISSUE FOR REVIEW AND COMMENT

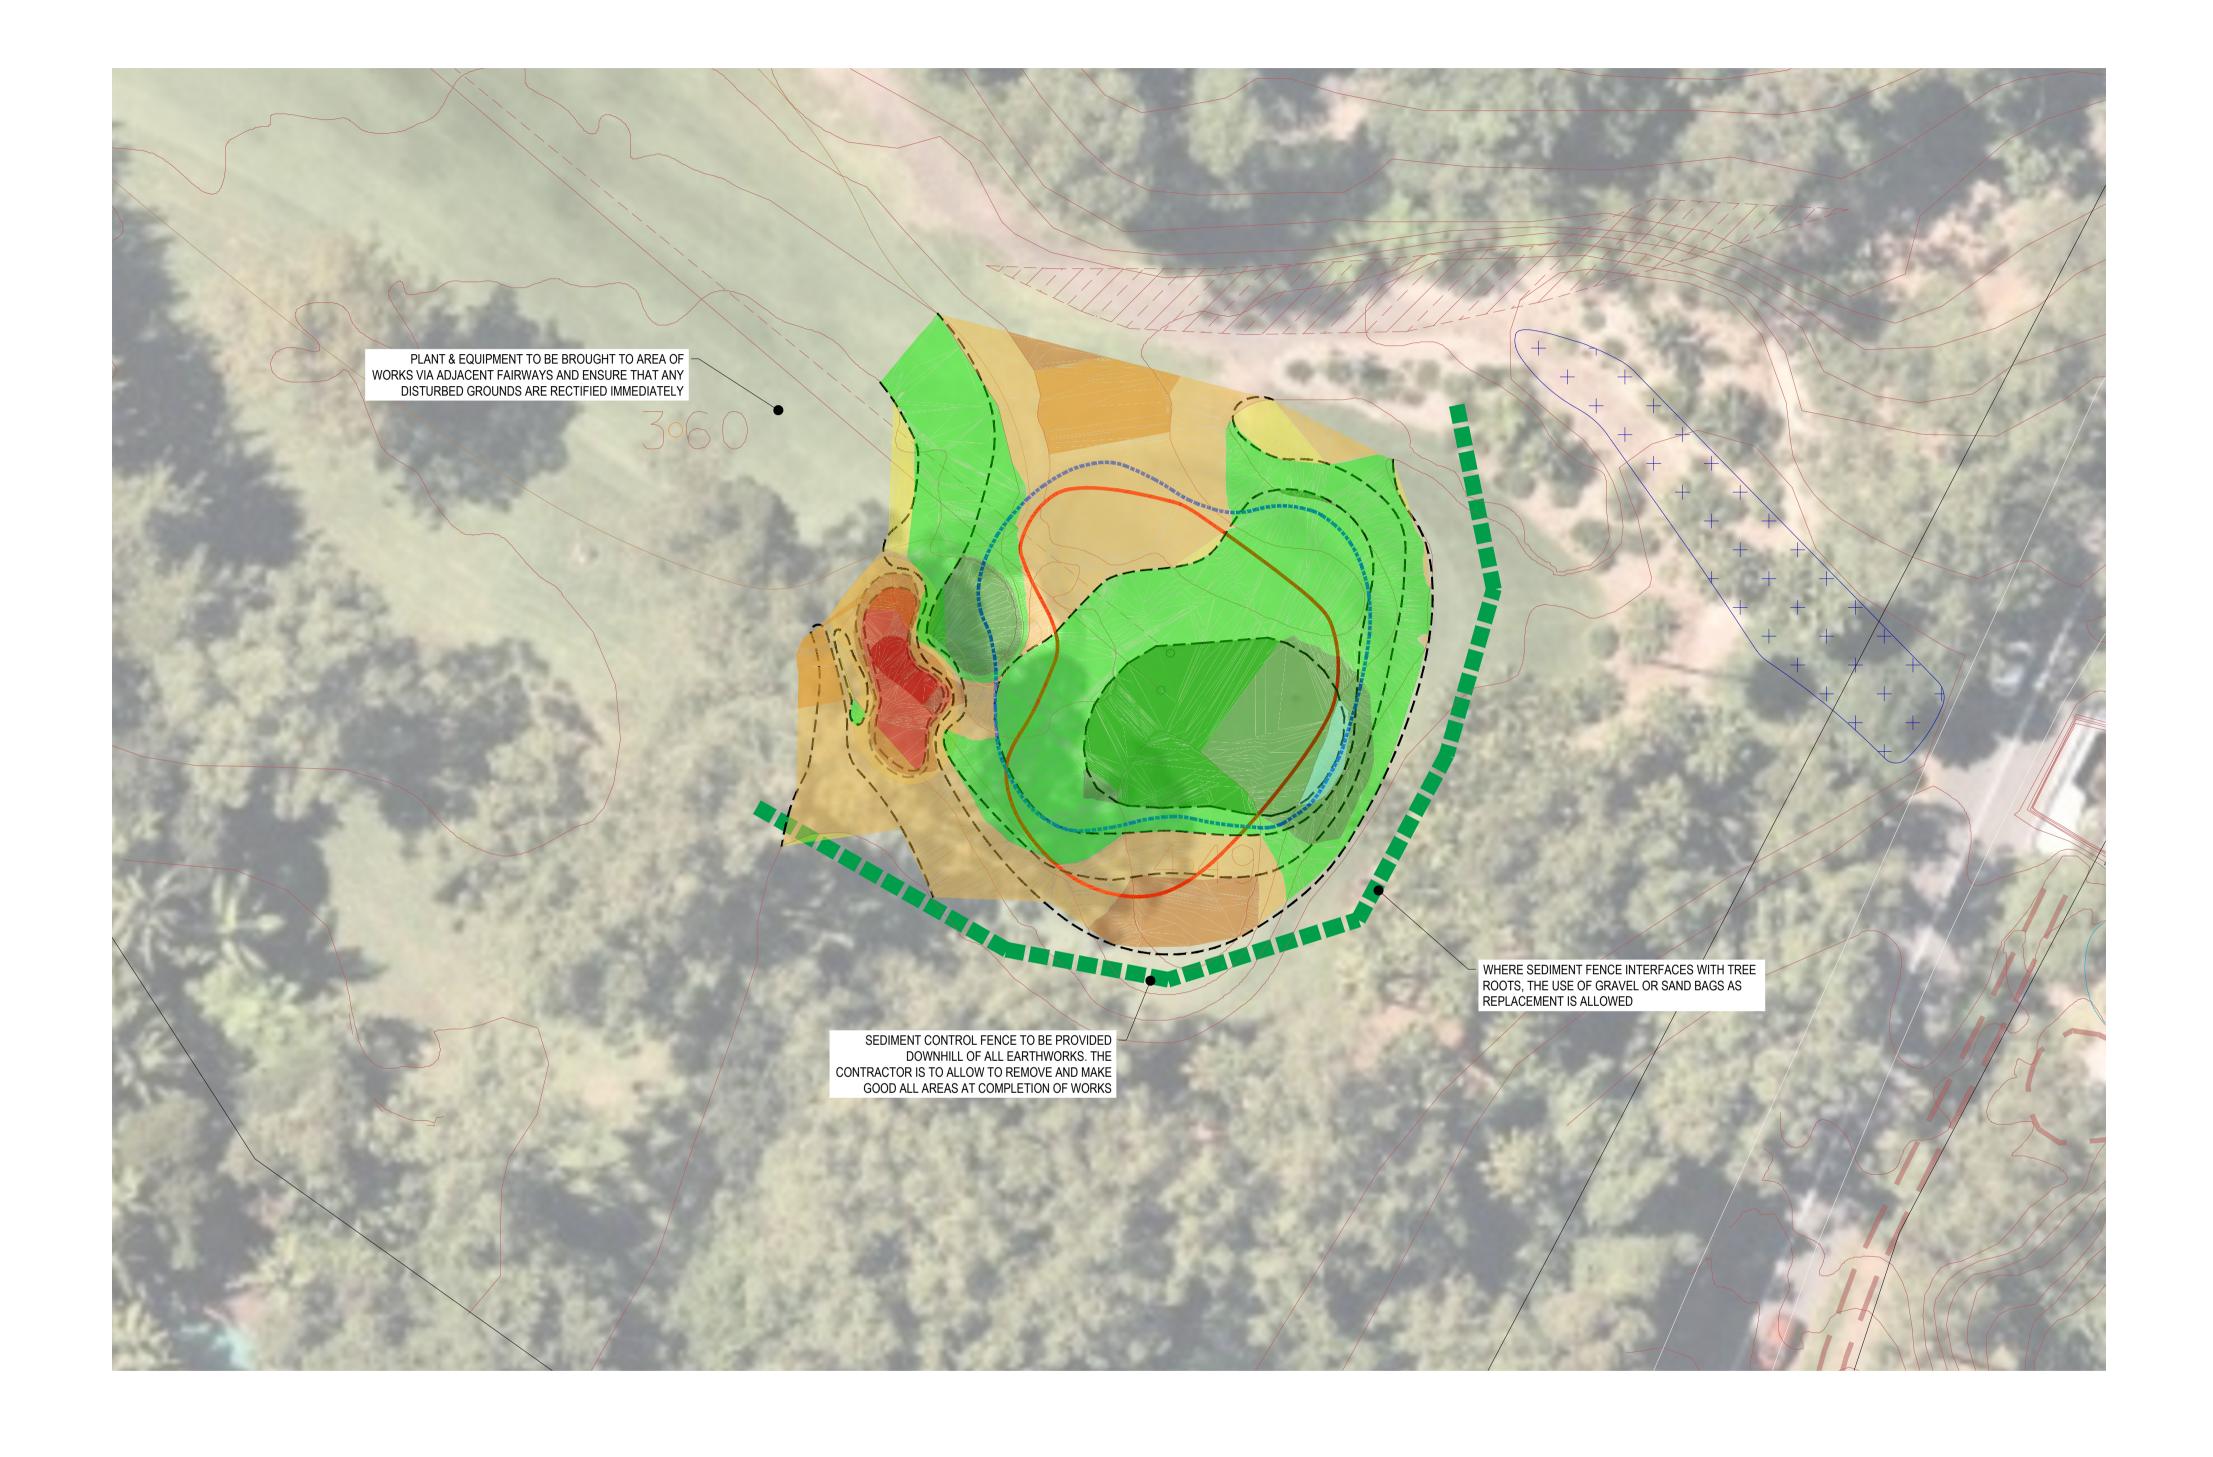
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SCALE @ A1 | SHEET No | REV | C | 1:250 | C | C |



CUT & FILL LEGEND

FROM	<u>TO</u>
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-1.75	-1.50
-1.50	-1.25
-1.25	-1.00
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0.75	1.00
1.00	1.25
1.25	1.50
	-2.00 -1.75 -1.50 -1.25 -1.00 -0.75 -0.50 -0.25 -0.000 0.001 0.25 0.50 0.75 1.00



CUT AND FILL VOLUMES

SCALE 1:250 @ A1 SCALE 1:500 @ A3

Assessment Surfaces	Volumes						Ho	ole						TOTAL
	m3	1st	2nd	3rd	4th	5th	6th	7th	8th	10th	11th	12th	13th	m3
Final Surface	Cut	26	40	102	1230	35	1026	103	193	5	1060	0	6	3826
V	Fill	461	149	188	3	199	38	125	44	549	7	470	432	2665
Existing Surface	Balance	435	109	86	-1227	164	-988	22	-149	544	-1053	470	426	-1161

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BAYVIEW GOLF CLUB

7TH GREEN DETAIL PLAN

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GOLF CLUB DRG CHECK _

C 06.03.2023 ISSUE FOR APPROVAL CP DESIGNED DESIGN CHECK CP APPROVED

TITLE

REV DATE REVISION DESCRIPTION

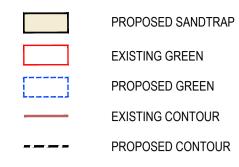
A 27.02.2023 ISSUE FOR REVIEW AND COMMENT

B 28.02.2023 CUT & FILL COLOURS ADDED AND UPDATED QUANTITIES

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SEDIMENT AND EROSION CONTROL &

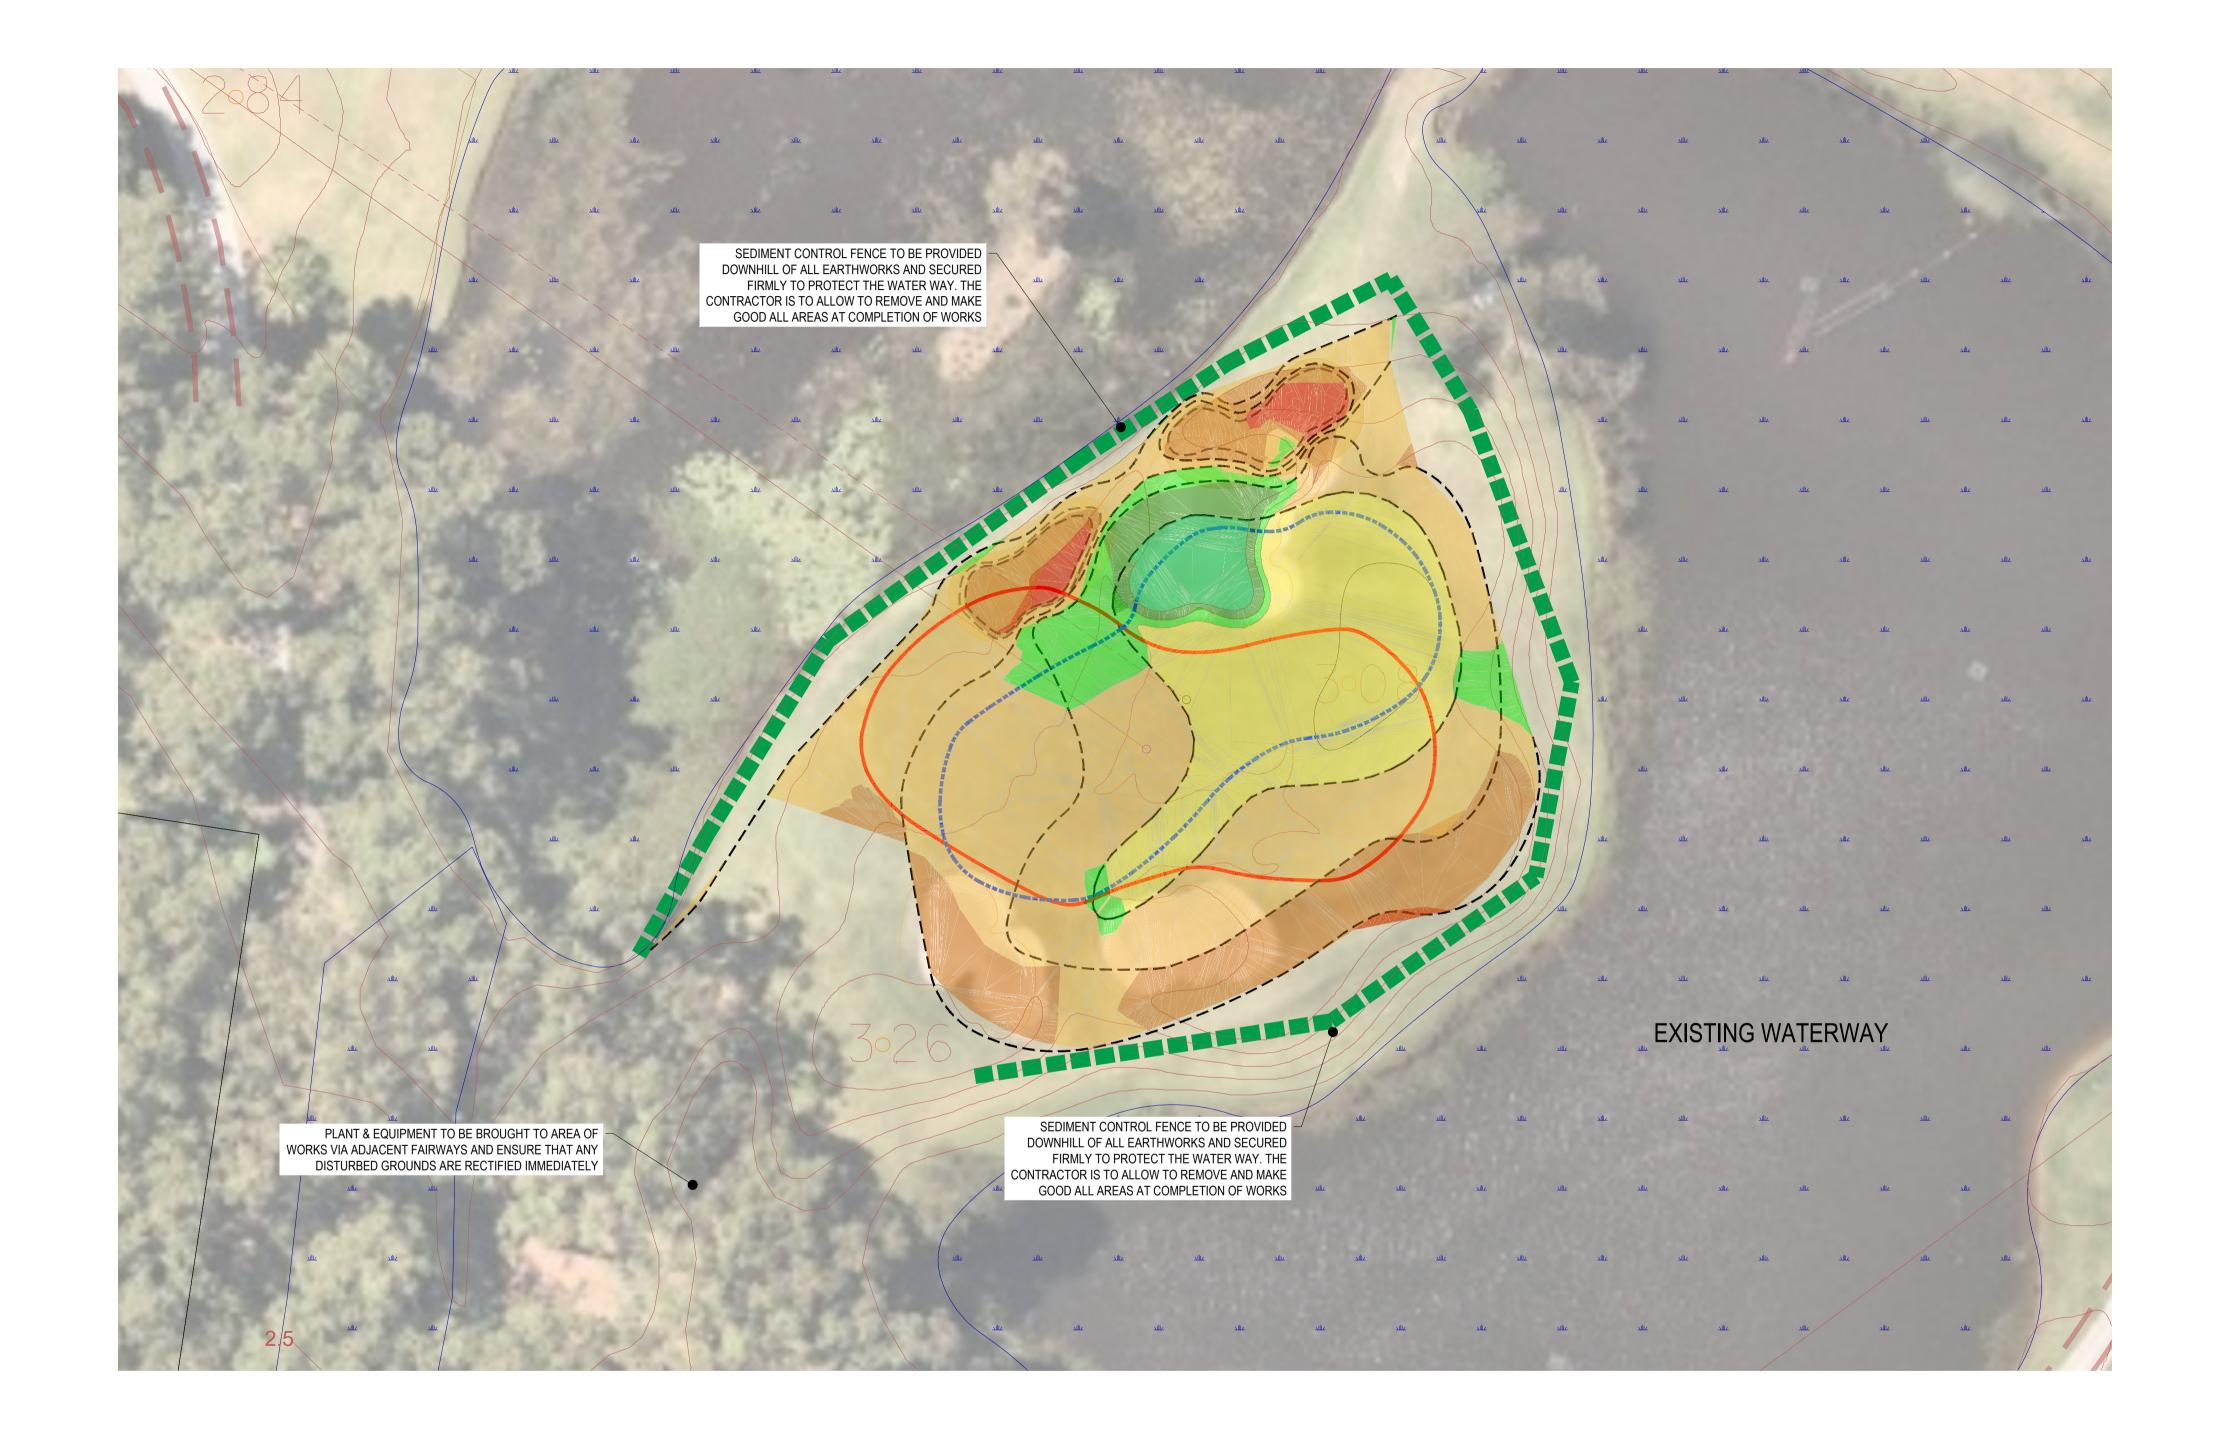
STORMWATER MANAGEMENT



SEDIMENT FENCE

CUT & FILL LEGEND





CUT AND FILL VOLUMES

Assessment Surfaces	Volumes						Ho	ole						TOTAL
	m3	1st	2nd	3rd	4th	5th	6th	7th	8th	10th	11th	12th	13th	m3
Final Surface	Cut	26	40	102	1230	35	1026	103	193	5	1060	0	6	3826
V	Fill	461	149	188	3	199	38	125	44	549	7	470	432	2665
Existing Surface	Balance	435	109	86	-1227	164	-988	22	-149	544	-1053	470	426	-1161

ISSUE FOR DEVELOPMENT APPLICATION

GOLF CLUB

CP

CP

CP

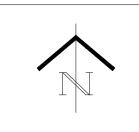
DESIGNED

DRG CHECK .

APPROVED

DESIGN CHECK





BAYVIEW GOLF CLUB

8TH GREEN DETAIL PLAN

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SCALE 1:250 @ A1 SCALE 1:500 @ A3

REV DATE REVISION DESCRIPTION

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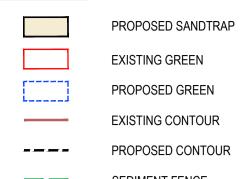
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SEDIMENT AND EROSION CONTROL &

STORMWATER MANAGEMENT



CUT & FILL LEGEND

		
	FROM	<u>TO</u>
	-2.00	-1.75
	-1.75	-1.50
	-1.50	-1.25
	-1.25	-1.00
	-1.00	-0.75
	-0.75	-0.50
	-0.50	-0.25
	-0.25	-0.001
	-0.000	0.000
	0.001	0.25
	0.25	0.50
	0.50	0.75
	0.75	1.00
	1.00	1.25
	1.25	1.50



TITLE

DESIGNED

DRG CHECK _

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DESIGN CHECK

CP

CP

REV DATE REVISION DESCRIPTION

C 06.03.2023 ISSUE FOR APPROVAL

A 27.02.2023 ISSUE FOR REVIEW AND COMMENT

B 28.02.2023 CUT & FILL COLOURS ADDED AND UPDATED QUANTITIES

CUT AND FILL VOLUMES

SCALE 1:250 @ A1 SCALE 1:500 @ A3

Assessment Surfaces	Volumes		Hole										TOTAL	
	m3	1st	2nd	3rd	4th	5th	6th	7th	8th	10th	11th	12th	13th	m3
Final Surface	Cut	26	40	102	1230	35	1026	103	193	5	1060	0	6	3826
V	Fill	461	149	188	3	199	38	125	44	549	7	470	432	2665
Existing Surface	Balance	435	109	86	-1227	164	-988	22	-149	544	-1053	470	426	-1161

ISSUE FOR DEVELOPMENT APPLICATION

GOLF CLUB



SEDIMENT AND EROSION CONTROL & STORMWATER MANAGEMENT BAYVIEW GOLF CLUB

10TH GREEN DETAIL PLAN

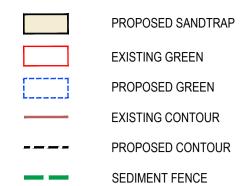
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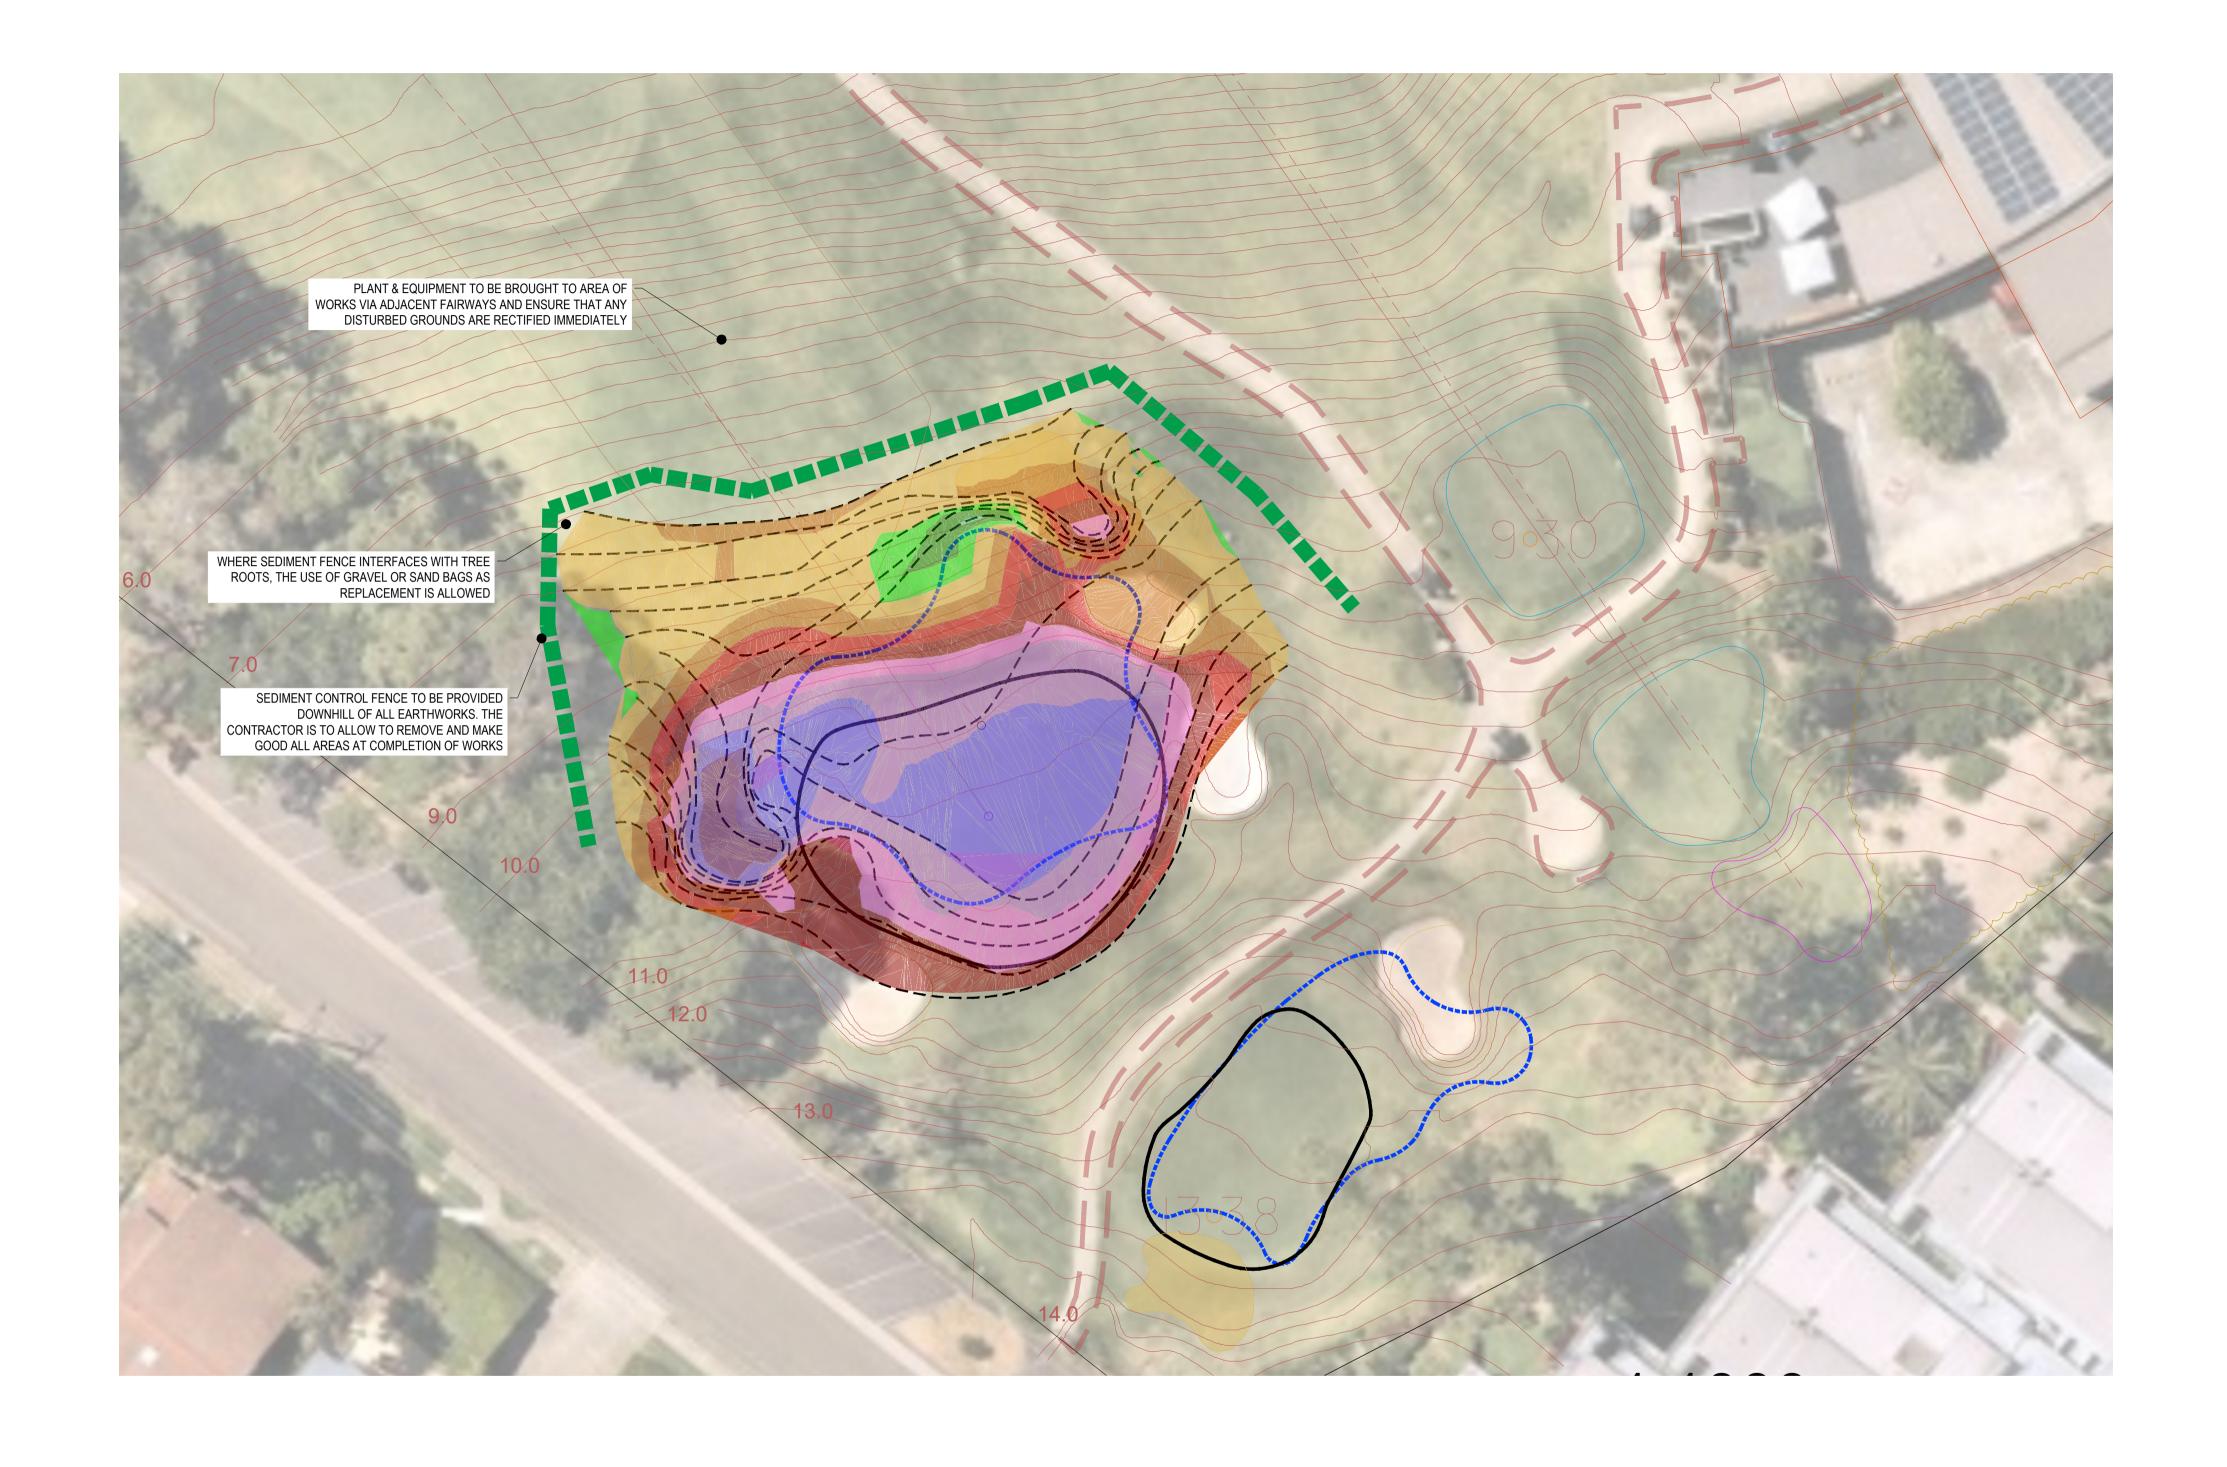
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SCALE @ A1 SHEET No C REV C



CUT & FILL LEGEND

FROM	<u>TO</u>
-2.00	-1.75
-1.75	-1.50
-1.50	-1.25
-1.25	-1.00
-1.00	-0.75
-0.75	-0.50
-0.50	-0.25
-0.25	-0.001
-0.000	0.000
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0.25	0.50
0.50	0.75
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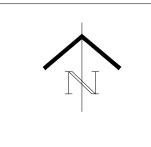
CUT AND FILL VOLUMES

Assessment Surfaces	Volumes						Но	ole						TOTAL
	m3	1st	2nd	3rd	4th	5th	6th	7th	8th	10th	11th	12th	13th	m3
Final Surface	Cut	26	40	102	1230	35	1026	103	193	5	1060	0	6	3826
V	Fill	461	149	188	3	199	38	125	44	549	7	470	432	2665
Existing Surface	Balance	435	109	86	-1227	164	-988	22	-149	544	-1053	470	426	-1161

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11TH GREEN DETAIL PLAN

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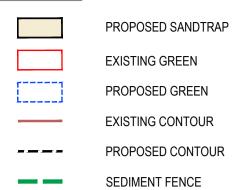
JOB NUMBER:

23003

SCALE @ A1 1:250

REV C120

REV DATE REVISION DESCRIPTION



CUT & FILL LEGEND



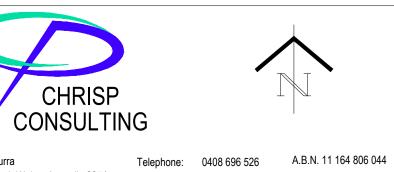


CUT AND FILL VOLUMES

Assessment Surfaces	Volumes						Но	ole						TOTAL
	m3	1st	2nd	3rd	4th	5th	6th	7th	8th	10th	11th	12th	13th	m3
Final Surface	Cut	26	40	102	1230	35	1026	103	193	5	1060	0	6	3826
V	Fill	461	149	188	3	199	38	125	44	549	7	470	432	2665
Existing Surface	Balance	435	109	86	-1227	164	-988	22	-149	544	-1053	470	426	-1161

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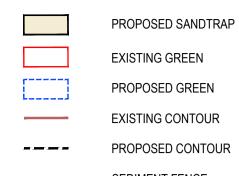
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SCALE @ A1 SHEET No C 121 C

SCALE 1:250 @ A1 SCALE 1:500 @ A3

TITLE A 27.02.2023 ISSUE FOR REVIEW AND COMMENT B 28.02.2023 CUT & FILL COLOURS ADDED AND UPDATED QUANTITIES C 06.03.2023 ISSUE FOR APPROVAL CP DESIGNED DRG CHECK _ DESIGN CHECK CP APPROVED

REV DATE REVISION DESCRIPTION



CUT & FILL LEGEND

FROM	<u>TO</u>
-2.00	-1.75
-1.75	-1.50
-1.50	-1.25
-1.25	-1.00
-1.00	-0.75
-0.75	-0.50
-0.50	-0.25
-0.25	-0.001
-0.000	0.000
0.001	0.25
0.25	0.50
0.50	0.75
0.75	1.00
1.00	1.25
1.25	1.50



TITLE

CUT AND FILL VOLUMES

Assessment Surfaces	Volumes						Но	ole						TOTAL
	m3	1st	2nd	3rd	4th	5th	6th	7th	8th	10th	11th	12th	13th	m3
Final Surface	Cut	26	40	102	1230	35	1026	103	193	5	1060	0	6	3826
V	Fill	461	149	188	3	199	38	125	44	549	7	470	432	2665
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13TH GREEN DETAIL PLAN

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REV DATE REVISION DESCRIPTION

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