







Certificate date: 34 Whale Beach Road Avalon Beach, NSW

0003847852-01 Terry Chapman 20920 20 Jan 2020



TRUE NORTH:



- NOTES:

 All structures including stormwater & drainage to engineer's details.

 Do not obtain dimensions by scaling drawings.

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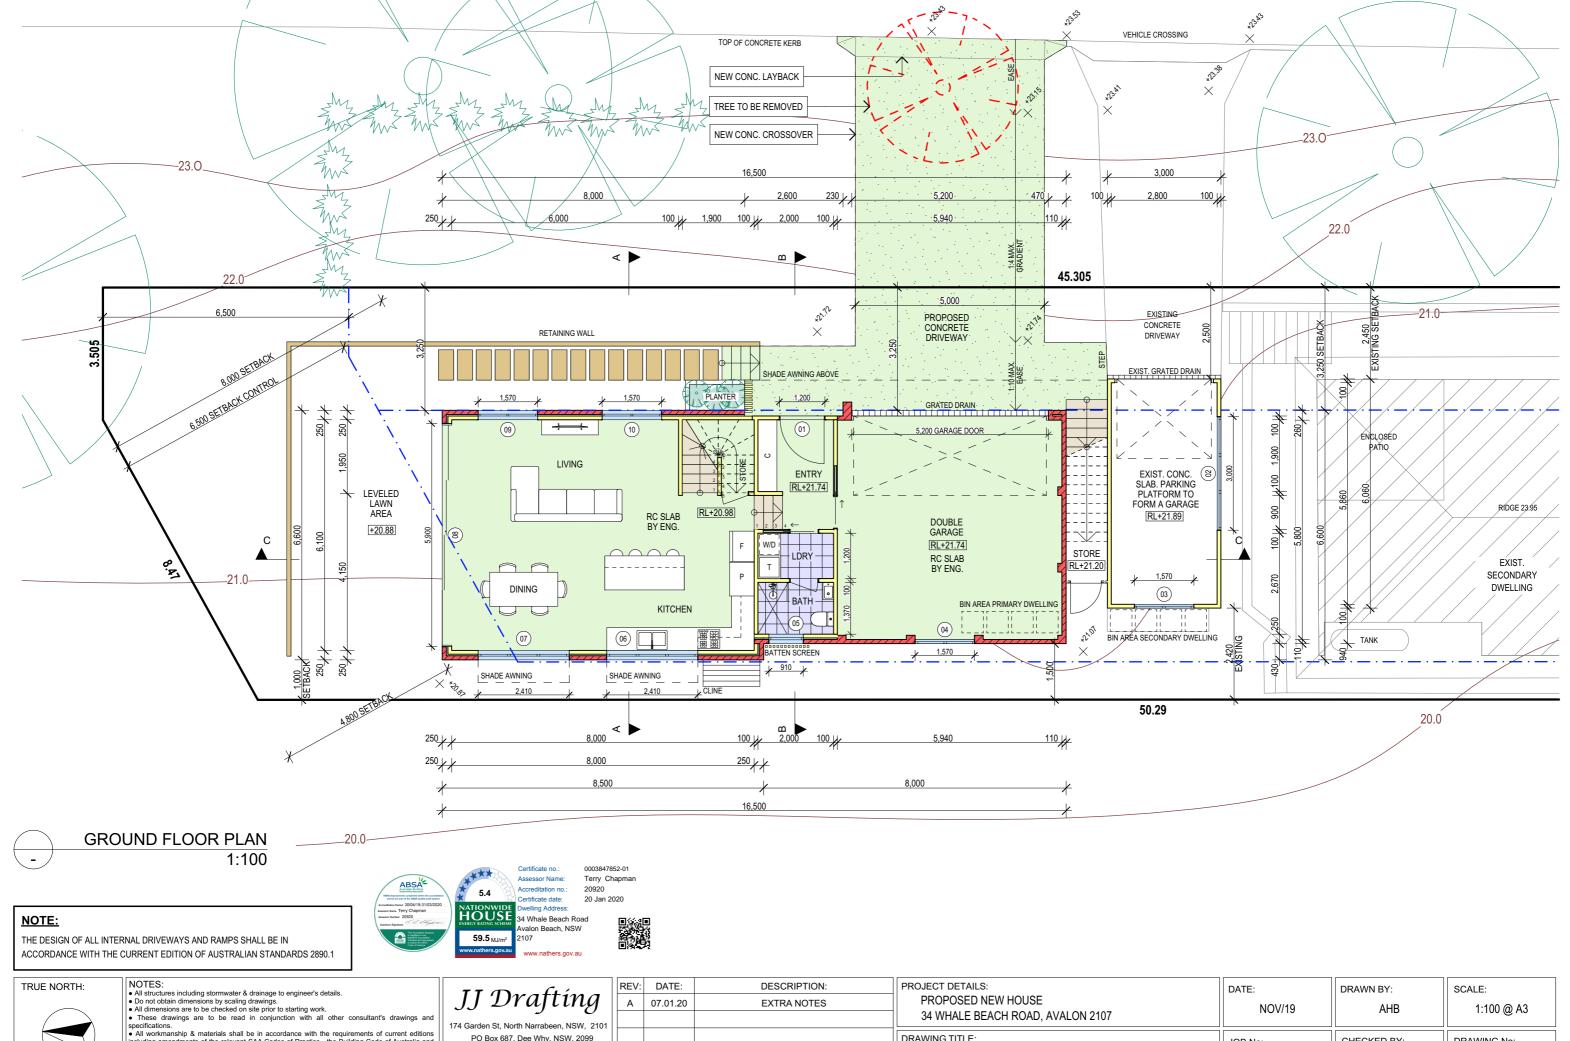
REV: DATE: JJ Drafting

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	Α	07.01.20	EXTRA NOTES	
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DESCRIPTION:

PROJECT DETAILS: PROPOSED NEW HOUSE 34 WHALE BEACH ROAD, AVALON 2107	DATE: NOV/19	DRAWN BY:	SCALE: 1:100 @ A3
DRAWING TITLE: DEMOLITION PLAN	JOB No: 692a/19	CHECKED BY:	DRAWING No: DA.02



- including amendments of the relevant SAA Codes of Practice, the Building Code of Australia and
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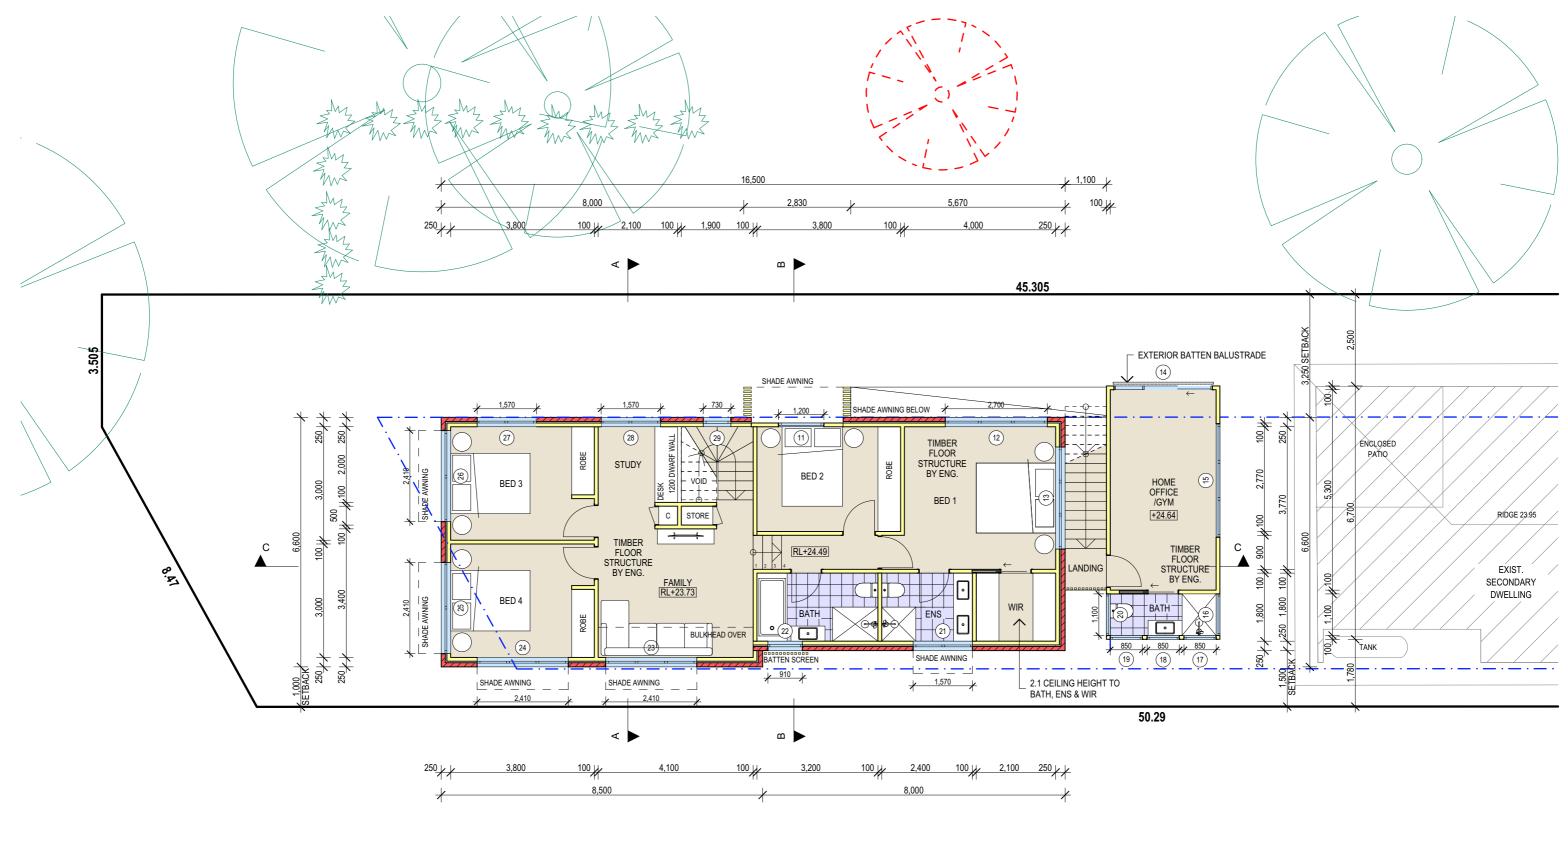
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PROJECT DETAILS: PROPOSED NEW HOUSE 34 WHALE BEACH ROAD, AVALON 2107	DATE: NOV/19	DRAWN BY:	SCALE: 1:100 @ A3
DRAWING TITLE: GROUND FLOOR PLAN	JOB No: 692a/19	CHECKED BY:	DRAWING No: DA.03







0003847852-01 Accreditation no.: elling Address

Terry Chapman 20920 20 Jan 2020 34 Whale Beach Road 2107





FIRST FLOOR PLAN 1:100





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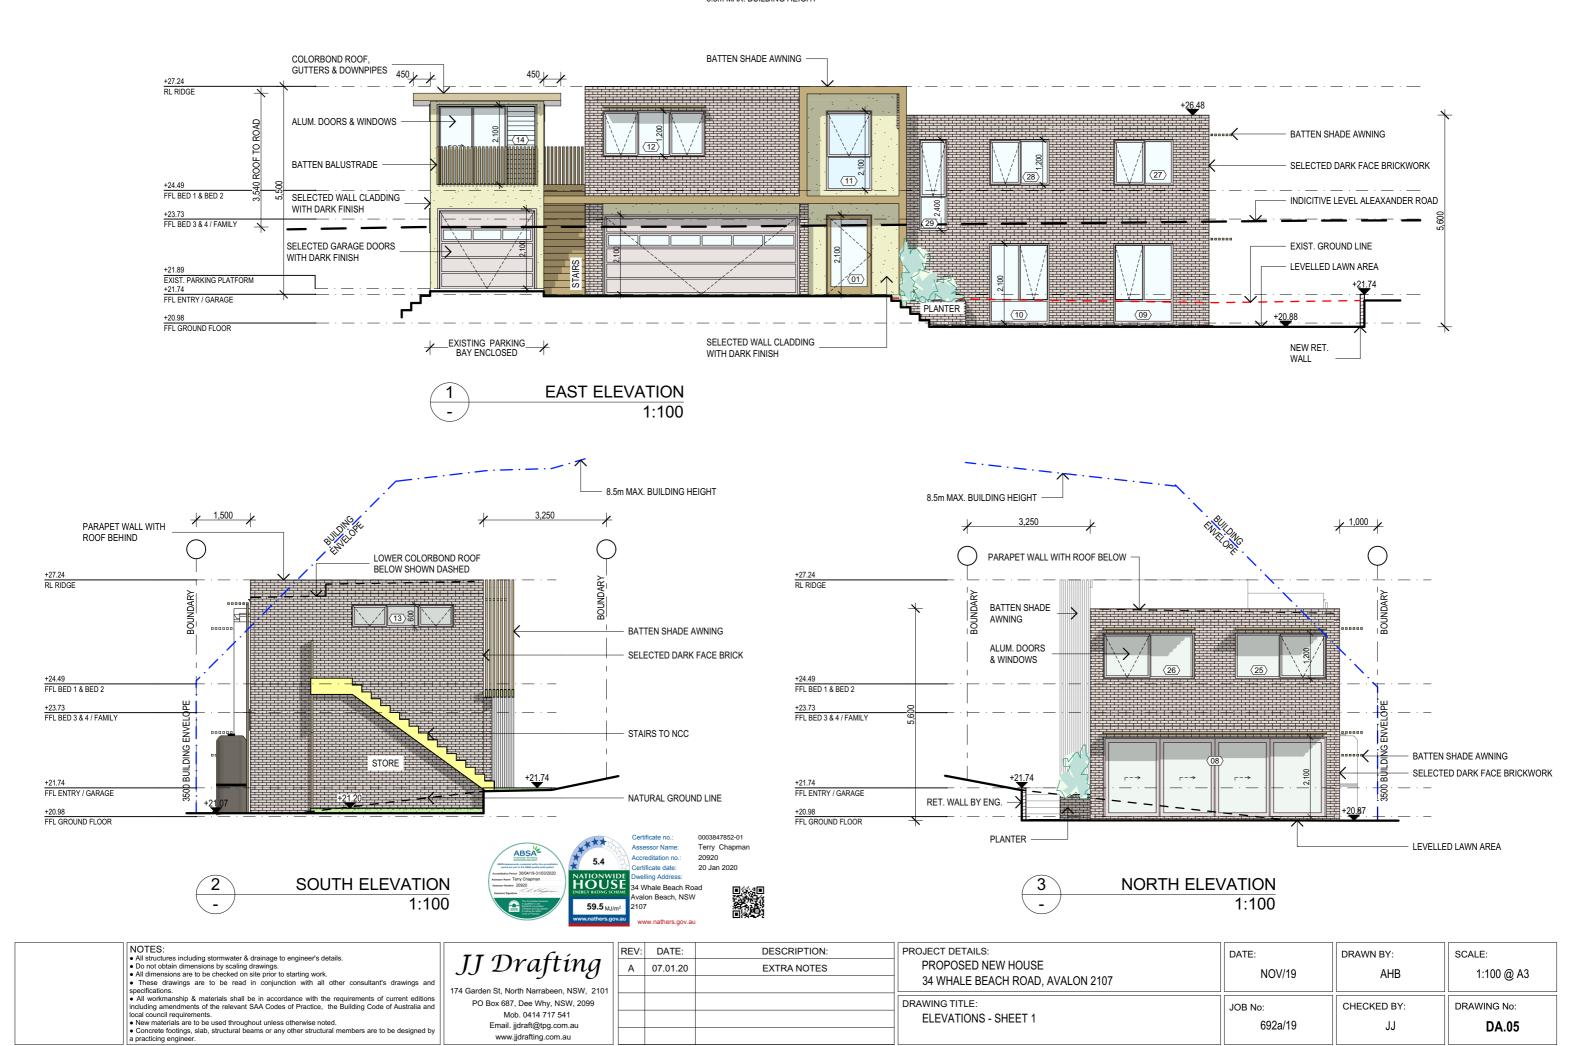
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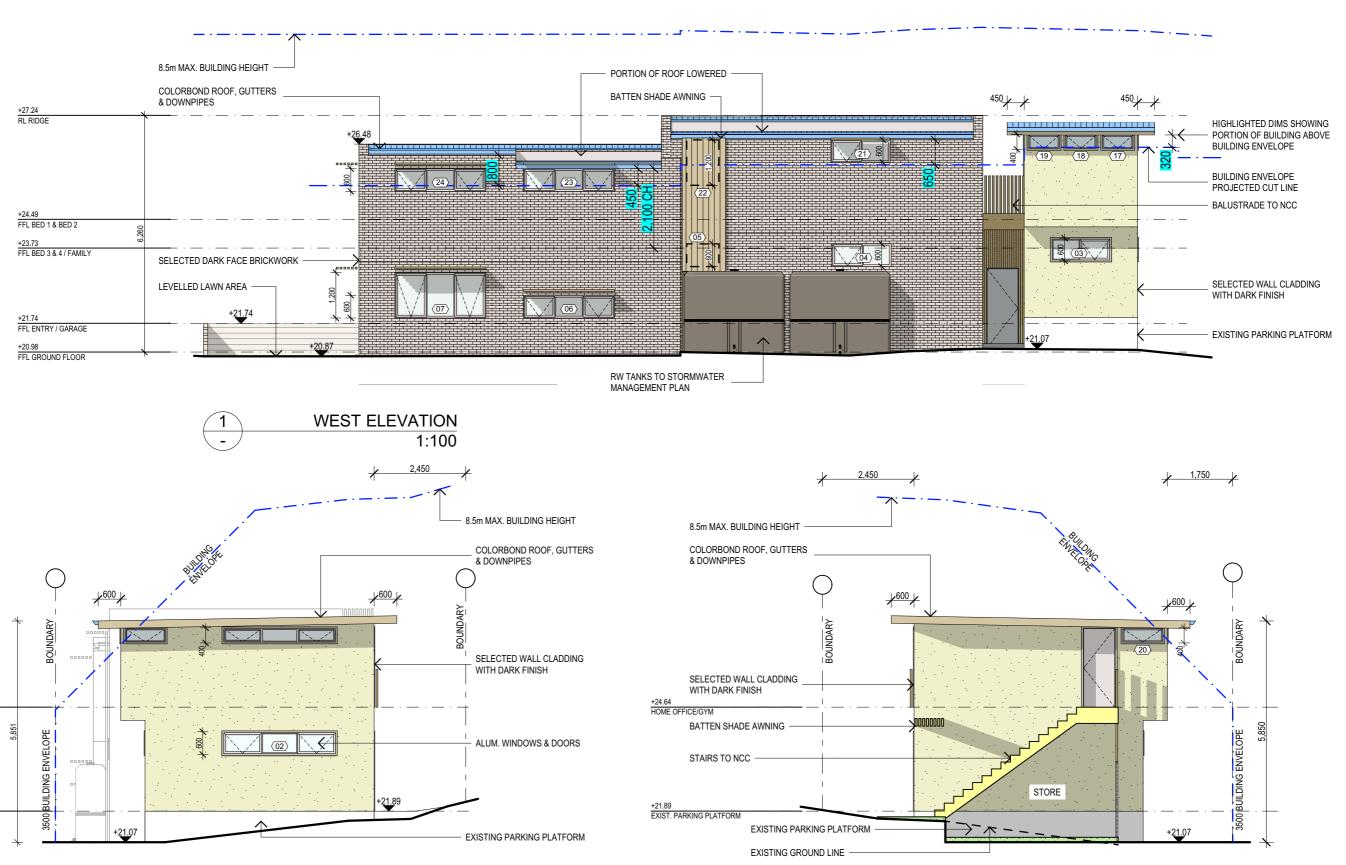
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PROJECT DETAILS: PROPOSED NEW HOUSE 34 WHALE BEACH ROAD, AVALON 2107	DATE
DRAWING TITLE: FIRST FLOOR PLAN	JOB I

692a/19	JJ	DA.04
JOB No:	CHECKED BY:	DRAWING No:
NOV/19	AHB	1:100 @ A3
DATE:	DRAWN BY:	SCALE:



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SOUTH ELEVATION 1:100



Assessor Name: 5.4 NATIONWIDE HOUSE elling Address 34 Whale Beach Road valon Beach, NSW **59.5** MJ/m

0003847852-01 Terry Chapman 20920 20 Jan 2020

NORTH ELEVATION 1:100

NOTES:

+24.64 HOME OFFICE/GYM

+21.89 EXIST. PARKING PLATFORM

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PROJECT DETAILS: PROPOSED NEW HOUSE 34 WHALE BEACH ROAD, AVALON 2107	DAT
DRAWING TITLE: FI EVATIONS - SHEET 2	JOB

DATE:	DRAWN BY:	SCALE:
NOV/19	AHB	1:100 @ A3
JOB No:	CHECKED BY:	DRAWING No:
692a/19	JJ	DA.06





0003847852-01 Certificate date:

Terry Chapman 20920 20 Jan 2020

valon Beach, NSW



Group A | ALM-001-03 | U-Value 5.40 or less | SHGC 0.49 +/- 5% AF single glazed LowE Group B | ALM-002-03 | U-Value 5.40 or less | SHGC 0.58 +/- 5% to all windows and glazed doors unless noted otherwise Windows and Doors Group A doors are Bifold, Entry, French or Hinged oup A windows are Awning, Bifold, Casement or Tilt'n'turn

Group B doors are Sliding or Stacker

BASIX REQUIREMENTS:

BASIX Inclusions for 34 Whale Beach Road, Avalon 2107

oup B windows are Do

<u>INSULATION</u>

Wall Insulation; Ceiling Insulation; Min. R2.5 Min. R4.0

<u>GLAZING</u>

ALM-001-03 A Aluminium A SG High Solar Gain Low-E

<u>WATER</u>

- Shower Rating; - Toilet Rating; Minimum 3 Star Minimum 4 Star - Kitchen Taps Rating; - Bathroom Basin Taps Rating; Minimum 5 Star

Must install a rainwater tank of at least 3000 litres on site. Must connect at least 1 outdoor tap to the rainwater tank.

CONSTRUCTION Floor

HOT WATER

- Concrete slab on ground - Suspended floor above garage

- Gas instantaneous hot water system;

Minimum 5 Stars

COOLING SYSTEM

- Living areas must not incorporate any cooling system, or any ducting which is designed to accommodate a

- Bedrooms must not incorporate any cooling system, or any ducting which is designed to accommodate a cooling

HEATING SYSTEM

Must install a gas fixed flued heater (or similar) in at least 1 living area. Minimum 3 Star Rating.
 Must not incorporate any heating system, or ducting which is designed to accommodate a heating system in all

VENTILATION

The following exhaust systems must be installed:

At least 1 bathroom - individual fan, not ducted, operation control: manual on/off switch.
 Kitchen - ducted to facade or roof, operation control: manual on/off switch.

- Laundry - individual fan, not ducted, operation control: manual on/off switch.

"Primary type of of artificial lighting" is fluorescent or light emitting diode (LED) lighting in each of the following rooms, and where the word "dedicated" appears, the fittings for those lights must only be capable of accepting fluorescent or light emitting diode (LED) lamps.

at least 4 of the bedrooms / study;at least 2 of the living / dining rooms; dedicated dedicated - the kitchen; - all bathrooms / toilets dedicated dedicated - the laundry; dedicated

NATURAL LIGHTING

- Must install a window and/or skylight in the kitchen of the dwelling for natural lighting. - Must install a window and/or skylight in 3 bathroom(s)/toilet(s) in the development for natural lighting.

<u>OTHER</u>

TRUE NORTH:

Must install a gas cooktop & electric oven in the kitchen.
 Must install a fixed clothes drying line.

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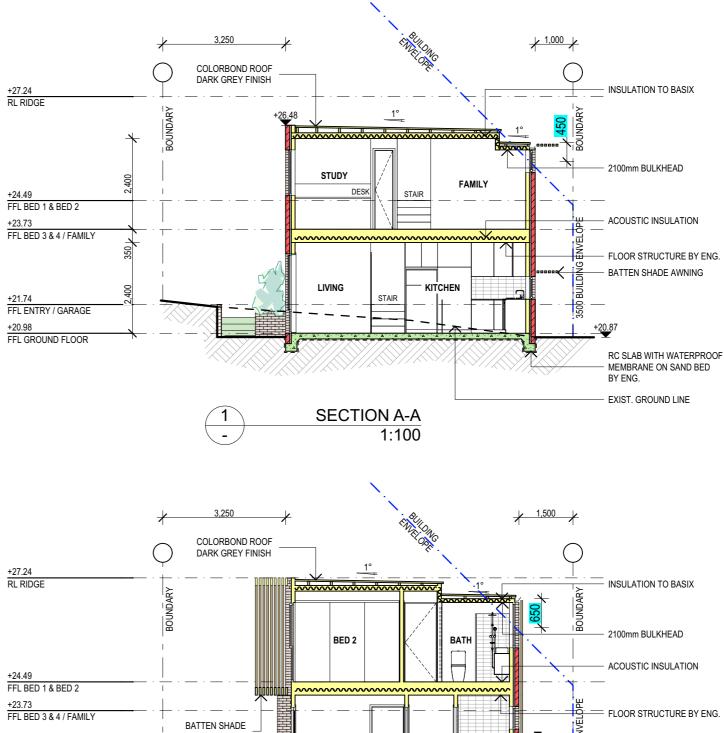
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DRAWING TITLE: SECTION A-A, SECTION B-B / BASIX	JOB No: 692a/19	CHECKED BY:	DRAWING No: DA.07




AWNING ENTRY LDRY **BATH** +21.74 FFL ENTRY / GARAGE FFL GROUND FLOOR

RC SLAB WITH WATERPROOF MEMBRANE ON SAND BED BY FNG EXIST. GROUND LINE

SECTION B-B 1:100

HIGHLIGHTED DIMS SHOWING PORTION OF BUILDING ABOVE BUILDING ENVELOPE

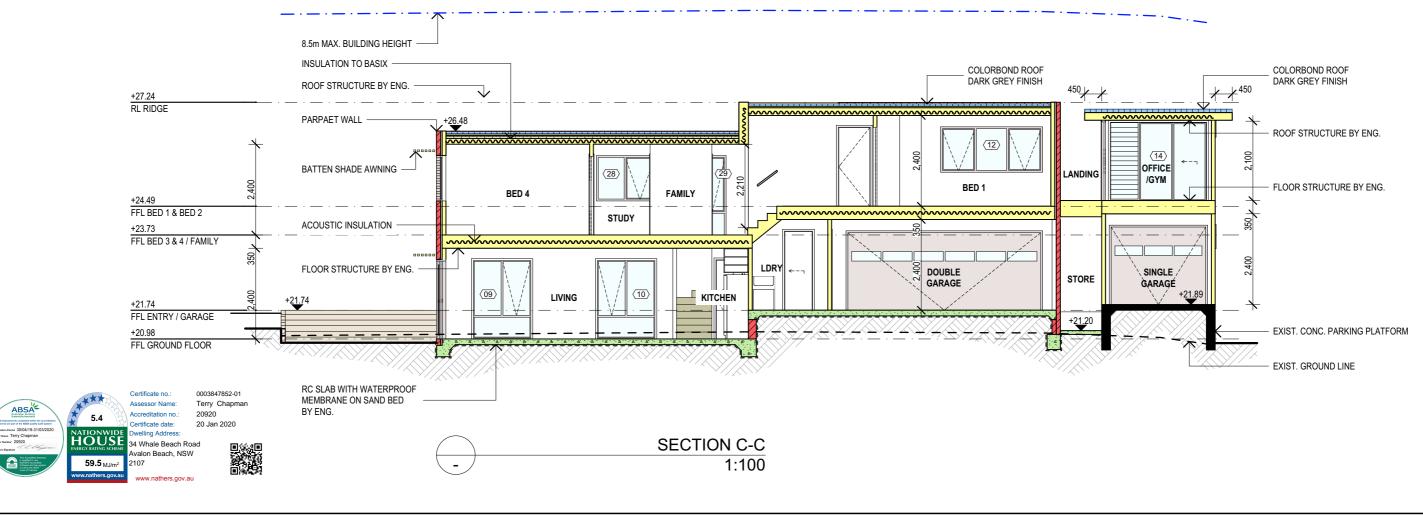

SPECIFICATION NOTES:

INTERNAL LINING:

PROVIDE PLASTERBOARD LINING

EXTERNAL WALLS:
- BRICK VENEER WALLS WITH SELECTED BRICKS TO DWELLING. - LIGHTWEIGHT TIMBER CLADDING OR SIMILAR TO SINGLE GARAGE/GYM.

- GROUND FLOOR TO BE REINFORCED CONCRETE SLAB IN ACCORDANCE WITH AS2870.
- FIRST FLOOR TO BE TIMBER FRAMED FINISHED WITH T&G HARDWOOD FLOORING.

- PROVIDE A GUARANTEED FLEXIBLE WATERPROOF MEMBRANE TO ALL WET AREA FLOORS & SHOWERS WALLS TO MANUFACTURES INSTRUCTIONS

- ALL WATERPROOFING TO AS 3740

BEARERS AND JOISTS:

- SHALL BE INSTALLED TO COMPLY WITH AS1684 AS AMENDED FOR TIMBER COMPONENTS OR AS3620 FOR LIGTHWEIGHT STEEL FRAMING SECTIONS OR AS PER THE NASH ALTERNATIVES TO AS 3623.

ANT CAPS:

- SHALL BE INSTALLED IN ACCORDANCE WITH AS3660.

PROFILED STEEL ROOF: NCC VOL.2 PART 3.5.1

- DESIGN AND INSTALLATION SHALL BE IN ACCORDANCE WITH AS/NZS 1562.

ROOFING:
- COLORBOND ROOF CLADDING

- SHALL BE IN ACCORDANCE WITH NCC VOL.1 PART B1.4 OR VOL.2 PART 3.2.3. ALL WORKMANSHIP AND MATERIALS SHALL BE IN ACCORDANCE WITH CURRENT EDITIONS OF THE

CONCRETE BLOCKS OR BRICKS:

- TO COMPLY WITH TO AS4455 MANSORY BUILDING BLOCKS/PAVER.

- FOOTINGS TO BE IN ACCORDANCE WITH AS1480.
- FOOTINGS TO BE IN ACCORDANCE WITH NCC VOL.2 PARTS 3.2.3, 3.2.4 AND 3.2.5
- ALL REINFORCEMENTS SHALL CONFORM TO AS1302, AS1303 AND AS1304.

BRICK AND BLOCKWORK:

- CONSTRUCTION OF MASONRY BUILDINGS SHALL BE AS PER AS3700 OR AS4773.

- TIMBER TO COMPLY WITH AS1170.2 OR AS4055.
- ALL WORKMANSHIP AND MATERIALS SHALL BE IN ACCORDANCE WITH AS1684 AND 1720 AS APPLICABLE.

- TO COMPLY WITH NCC VOL.2 PART 3.4
- GROUND FLOOR TIMBERS SHALL BE ONLY OF HARDWOOD, CYPRESS PINE OR PRESSURE TREATED RADIATA OR CANADA PINE BELOW A HEIGHT OF 300mm ABOVE FINISHED GROUND LEVEL AND MUST NOT BE BUILT INTO BRICKWORK.
- SUBFLOOR VENTILATION SHALL CONFORM TO NCC VOL.2 PART 3.4.1.
- IN BUSHFIRE PRONE AREAS SPECIAL CONDITIONS APPLY.
- WHERE TERMITE BARRIERS NEED TO BE INSPECTED, 400mm CLEARANCE IS REQUIRED BETWEEN THE UNDERSIDE OF BEARER AND GROUND SURFACE.
- USE TREATED TIMBER WHERE REQUIRED FOR DURABILITY
- DO NOT USE TIMBER UNSUITABLE FOR EXPOSURE TO MOISTURE IN EXPOSED LOCATION.
- PROVIDE STRUCTURE BRACING IN ACCORDANCE WITH AS1684 - PROVIDE STRUCTURE TIEDOWN IN ACCORDANCE WITH AS1684
- USE GALVANISED FIXINGS WHERE EXPOSED TO WEATHER.

- TERMITE CONTROL:
 TO BE IN ACCORDANCE WITH TO AS3660.1
- SHALL BE IN ACCORDANCE WITH NCC VOL.2 PART 3.1.3 OR VOL.1 PART B1.4.

- SELECTION AND INSTALLATION OF METAL RAINWATER GOODS REFER TO AS2180
- FLASH PROJECTIONS ABOVE THE ROOF WITH TWO PART FLASHINGS CONSISTING OF AN APRON FLASHING AND OVER FLASHING, WITH AT LEAST 100mm OVERLAP.
- PROVIDE FOR INDEPENDENT MOVEMENT BETWEEN ROOF AND PROJECTION.

- 40% OF NEW OR ALTERED LIGHT FIXTURES TO BE FITTED WITH FLUORESCENT, COMPACT FLUORESCENT, OR LIGHT-EMITTING-DIODE (LED) LAMPS

- ALL FRAMED WINDOWS SHALL BE INSTALLED IN ACCORDANCE WITH AS2047-48 FOR ALUMINIUM WINDOWS AND AS2047 FOR TIMBER WINDOWS.
- ALUMINIUM FRAMED WINDOWS AND DOORS.
- WEATHER STRIPPING IS TO BE PROVIDED TO ALL EXTERNAL WINDOWS AND DOORS.

STAIRS, HANDRAILS AND BALUSTRADES:

- SOLID COLORBOND BALUSTRADE.
- NCC VOL.2 PARTS 3.9.1 AND 3.9.2
- RELATIONSHIP OF RISER TO GOING SHALL BE BETWEEN 1:2 AND 1:1.35 UNLESS OTHERWISE DIRECTED TO GOING SHALL BE BETWEEN 1:2 AND 1:1.35 UNLESS OTHERWISE DIRECTED OR AS PERMITTED IN
- BALUSTRADES SHALL BE PROVIDED TO ALL LANDINGS, RAMPS, DECKS, ROOFS AND OTHER ELEVATED PLATFORMS WHERE THE VERTICAL DISTANCE FROM THAT LEVEL IS MORE THAN 1m ABOVE THE ADJOINING FLOOR OR FINISHED GROUND LEVEL.
- THE HEIGHT OF BALUSTRADE MUST BE A MINIMUM OF 1m HIGH ABOVE LANDING AND NOT LESS THAN 865mm ABOVE THE NOSINGS OF ANY STAIR TREADS OR FLOOR RAMP AND HAVE NO OPENING GREATER
- THE HEIGHT OF BALUSTRADE TO THE NEW STAIR CASES IS TO BE MEASURED A MINIMUM 865mm ABOVE THE NOSING LINE AND HAVE NO OPENING GREATER NO OPENING GREATER THAN 125mm.

- MATERIALS TO BE USED FOR SURFACES OF FLOORS, STAIR LANDING, STEPS AND NOSINGS SHALL BE IN ACCORDANCE WITH THE CLASSIFICATIONS FOR SLIP RESISTANCE AS APPLY IN AS4586 AND

EAVES GUTTERS, VALLEY GUTTERS AND DOWPIPES

- TO COMPLY WITH AS/NZS 2179 FOR METAL AND AS1273 FOR UPVC COMPONENTS.
- NEW DOWNPIPES TO BE CONNECTED INTO EXISTING STORMWATER LINE COLORBOND GUTTERS AND DOWNPIPES
- MINIMUM SLOPE OF EAVES AND GUTTERS 1:200

-NCC VOL.1 PARTS B 1.4, D 3.12, F1.13 OR NCC VOL.2 PART 3.6

SMOKE DETECTORS/ALARMS:

- NCC VOL 2 PART 3.7.2, FIRE/SMOKE DETECTORS COMPLYING WITH THE REQUIREMENTS OF THE LOCAL GOVERNMENT ACT AND/OR STATE OR TERRITORY REGULATIONS MUST BE FITTED IN THE LOCATIONS REQUIRED AND APPROVED BY THE AUTHORITY AND SHALL BE INSTALLED IN ACCORDANCE WITH AS3786
- INSTALLATIONS IN BUILDINGS OTHER THAN CLASS 1 AND 10 MUST BE INSTALLED AND MANAGED TO
- COMPLY WITH NCC SPEC. E2.2a.
 MULTIPLE ALARMS WITHIN HOUSES AND SOLE OCCUPANCY UNITS MUST BE HARD WIRED AND

WASTE MANAGEMENT:

- ALL WASTE SHALL BE TAKEN AWAY BY TRUCKS TO A SUITABLE LANDFILL OR RECYCLE DEPOT. ALL WASTE SHALL BE COVERED DURING TRANSPORTATION.
- WASTE GENERATED DURING CONSTRUCTION SHALL BE PLACED IN STEEL BINS AND TAKEN AWAY BY AN APPROVED CONTRACTOR TO A APPROVED LANDFILL SITE.

SEDIMENT CONTROL:

- A FILTER CLOTH SYSTEM SHALL BE INSTALLED TO STOP ANY SEDIMENT ENTERING COUNCILS STORMWATER SYSTEM.

ALL PLANS ARE TO BE READ IN CONJUNCTION AND COMPLY WITH THE BASIX CERTIFICATE. ANY RELEVANT REPORTS

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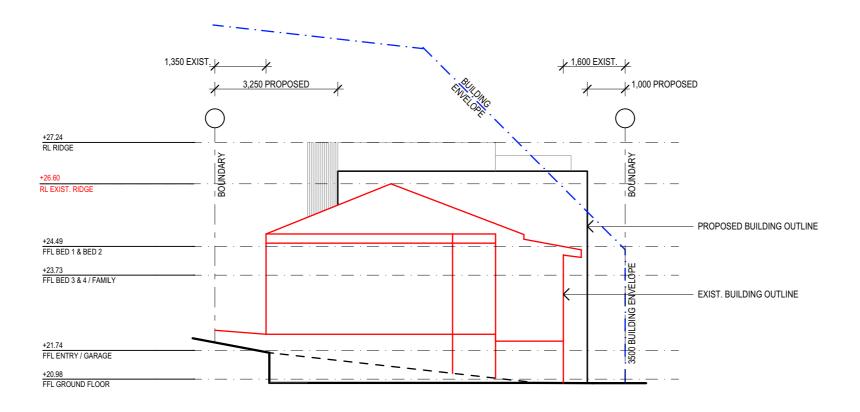
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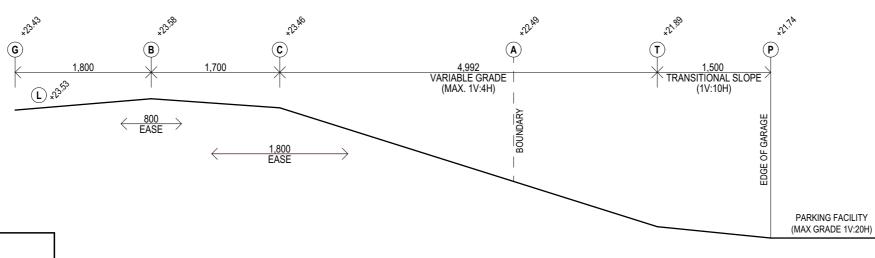
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REV: DATE: DESCRIPTION		DESCRIPTION:	
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DRAWING TITLE: SECTION C-C / SPECIFICATIONS	JOB No: 692a/19	CHECKED BY:	DRAWING No: DA.08



EXIST. & NEW STRUCTURE MASSING 1:100



POINT	REMARK	LEVELS
G	Gutter invert	23.43
L	Rear of layback	23.53
В	1800 behind gutter invert	23.58
С	3500 Behind gutter invert	23.46
A	Boundary alignment	22.49 approx.
Т .	1500 Before parking facility	21.89
P	Parking facility	21.74

THE PROPOSED DRIVEWAY HAS BEEN DESIGNED TO MEET THE SPECIFICATIONS OF THE NORTHERN BEACHES COUNCIL EXTRA LOW STANDRAD VEHICLE CROSSING

ertificate date: 34 Whale Beach Road valon Beach, NSW

THE DESIGN OF ALL DRIVEWAYS SHALL BE IN ACCORDANCE WITH AUSTRALIAN STANDARD AS2890 Part 1 Off Street Car Parking.

DRIVEWAY PROFILE 1:50

NOTES:

5.4

59.5 MJ/m

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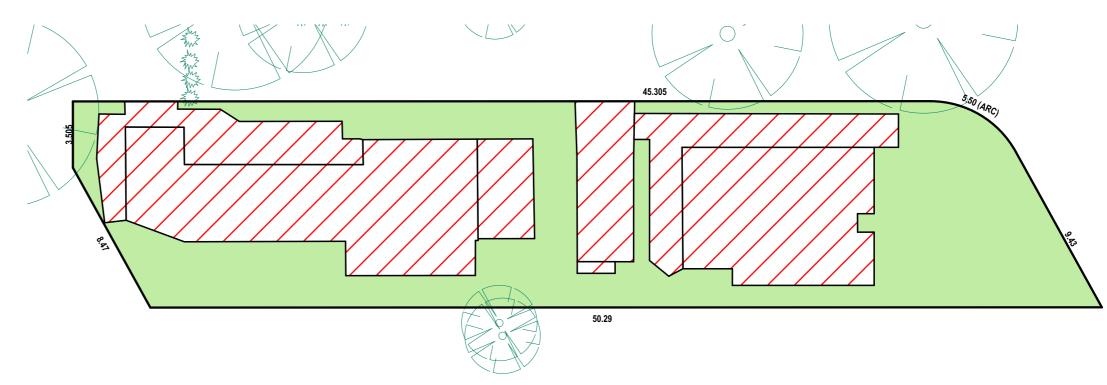
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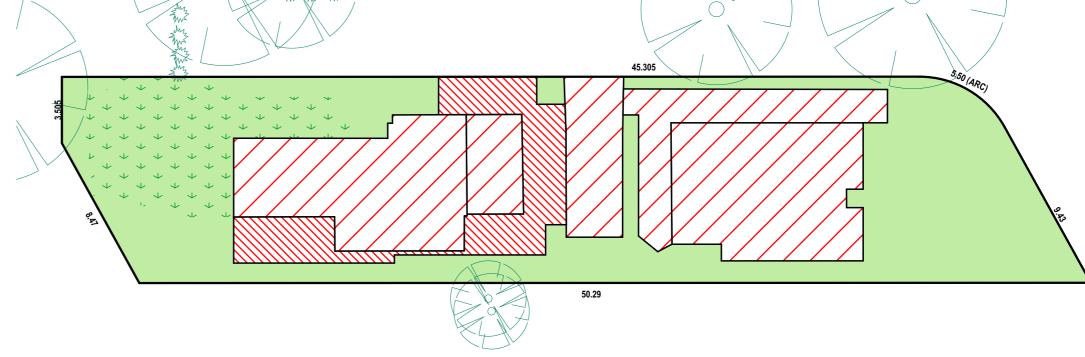
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				DRAWING TITLE: DRIVEWAY PROFILE / MASSING ELEVATION	JOB No: 692a/19	CHECKED BY:	DRAWING No: DA.09



LANDSCAPED AREA CALCULATION PLAN - EXISTING



1:200


2 LANDSCAPED AREA CALCULATION PLAN - PROPOSED





Assessor Name: 34 Whale Beach Road

Terry Chapman 20920 20 Jan 2020

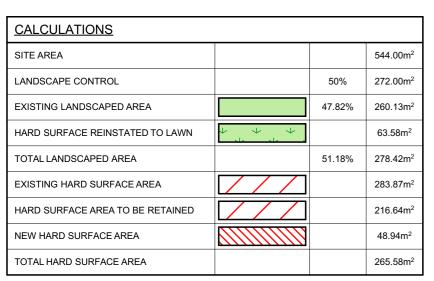

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			DRAWING TITLE:	JOB No:	CHECKED BY:	DRAWING No:
			LANDSCAPED AREA CALCULATION PLAN	692a/19	JJ	DA.10
						271110

NOTES:

DESIGNATED SITE MANAGER/BUILDER

PRIOR TO COMMENCEMENT OF WORK A SITE MANAGER OR BUILDER MUST BE NOMINATED. THE SITE MANAGER OR BUILDER WILL BE RESPONSIBLE AND LIABLE FOR ALL WORKS CARRIED OUT ON THE SITE. THIS ASSUMES THE RESPONSIBILITY FOR THE ACTIONS OF ALL SUBCONTRACTED PARTIES AS WELL AS ADVISING THEM OF COUNCIL'S REQUIREMENTS WHEN CARRYING OUT WORKS

TOPSOIL MANAGEMENT

PRIOR TO THE STRIPPING OF TOPSOIL, THE VEGETATIVE COVER MUST BE REDUCED BY EITHER SLASHING OR MOWING. ALL TOPSOIL IS TO BE RETAINED AND PROTECTED FOR REUSE ON SITE. SOIL STOCKPILES MUST NOT BE LOCATED ON NATURE STRIPS, FOOTPATHS, ROADWAYS, KERBS, ACCESSWAYS, WITHIN DRAINAGE LINES/FLOWS/PATHS OR AROUND OR AGAINST TREE SHRUBS SEDIMENT CONTROL MEASURES MUST BE INCORPORATED WITH ANY RESULTING STOCKPILE. THE STOCKPILE CAN BE PROTECTED FROM EROSION BY COVERING T WITH AN IMPERVIOUS MATERIAL. IN CONJUNCTION WITH THE INSTALLATION OF A SEDIMENT FENCE AROUND IT, IF STOCKPILES ARE TO REMAIN FOR MORE THAN ONE MONTH THEY ARE TO BE GRASSED IMMEDIATELY AND STABILISED WITHIN FOURTEEN DAYS. SURPLUS TOPSOIL MUST BE REASONABLY REMOVED FROM

BUILDING MATERIAL STOCKPILING

SUFFICIENT AREA MUST BE ALLOCATED WITHIN THE SITE FOR SUCH STORAGE OF BUILDING MATERIALS, DEMOLITION WASTE, WASTE CONTAINERS, ETC. AS WILL

SEDIMENT FENCES

A SEDIMENT FENCE SHOULD BE LOCATED ALONG THE DOWNSLOPE BOUNDARY (S) OF THE SITE, ON THE CONSTRUCTION SIDE OF THE TURF FILTER STRIP OR NATIVE VEGETATION, AND AROUND ALL STOCKPILES OF MATERIAL ON THE SITE.

ALL TRUCKS/UTES MUST COVER THEIR LOADS AT ALL TIMES. APPROPRIATE METHODS ARE TO BE EMPLOYED TO PREVENT BLOWING DUST CREATING AN UNACCEPTABLE HAZARD OR NUISANCE ON THE SITE OR DOWN WIND. PRODUCTION OF DUST CAN BE MINIMISED BY LIMITING AREA OF EARTHWORKS, WATERING AND PROGRESSIVE VEGETATION. WHERE DUST IS CREATED AS A RESULT WORKS AND/OR SOIL EXPOSURE, THE BARE SOIL AREAS MUST BE WATERED, DURING AND/OR AT THE END OF EACH DAY TO LAY THE DUST. EARTH MOVING ACTIVITIES SHOULD BE AVOIDED WHERE WINDS ARE SUFFICIENTLY STRONG ENOUGH TO RAISE VISIBLE DUST

EROSION & SEDIMENT CONTROLS

APPROPRIATE EROSION AND SEDIMENT CONTROLS MUST BE IMPLEMENTED ON ALL SITES THAT INVOLVE SOIL DISTURBANCE. THE MEASURES MUST BE IN PLACE PRIOR TO THE COMMENCEMENT OF WORK. THOSE CONTROLS ARE TO BE MONITORED AND MAINTAINED IN ORDER TO SERVE THEIR INTENDED FUNCTION FOR THE DURATION OF THE WORKS OR UNTIL SUCH TIME AS THE SITE IS FULLY STABILISED. IF ANY CONTROLS ARE DAMAGED OR BECOME INEFFECTIVE DURING THE COURSE OF THE WORKS THEY ARE TO BE REINSTATED OR REPLACED IMMEDIATELY. SUFFICIENT ACCESS TO THESE CONTROLS MUST BE PROVIDED IN CASE OF THE NEED TO REPAIR


WHERE A SEDIMENT FENCE IS NOT USED APPROPRIATE SEDIMENT TRAPS SHOULD BE LOCATED AT ALL POINTS WHERE STORMWATER LEAVES THE CONSTRUCTION SITE OR LEAVES THE GUTTER AND ENTERS THE DRAINAGE SYSTEM. A COMMON TECHNIQUE IS THE GRAVEL SAUSAGE

DIVERSION CHANNELS

A DIVERSION CHANNEL IS AN EXCAVATED EARTH DITCH OR PATH. THESE STRUCTURES ARE USED TO INTERCEPT AND DIRECT RUN-OFF TO A DESIRED LOCATION WHERE POSSIBLE. ALL STORMWATER RUN-OFF FLOWING ONTO DISTURBED AREAS, INCLUDING STOCKPILES, MUST BE INTERCEPTED, DIVERTED AND/OR SAFELY DISPOSED OF. THIS CAN BE ACHIEVED BY CONSTRUCTING A TEMPORARY EARTH BANK AROUND THE UPSLOPE EXTENT OF THE CONSTRUCTION SITE WHERE THE DIVERSION DOES NOT AFFECT THE NEIGHBOURING PROPERTIES.

VEHICLE MOVEMENTS


TO LIMIT DISTURBANCE TO THE SITE AND TRACKING OF MATERIAL ONTO THE STREET ALL VEHICLES AND PLANT EQUIPMENT ARE TO USE A SINGLE ENTRY/EXIT POINT UNLESS COUNCIL HAS APPROVED ALTERNATIVE ARRANGEMENTS. ACCESS POINTS AND PARKING AREAS ARE TO BE STABILISED WITH COMPACTED SUB-GRADE ASAP AFTER THEIR FORMATION. IF SPILLAGE DOES OCCUR IT IS TO BE CONTAINED IMMEDIATELY AND CAREFULLY REMOVED. THE AREA AFFECTED IS TO BE RESTORED TO A STANDARD EQUAL TO OR BETTER THAN ITS PREVIOUS CONDITION. ALL VEHICLES ARE TO BE WASHED PRIOR TO EXISTING THE SITE. THIS SERVES THE PURPOSE OF REMOVING SITE MATERIAL ON THE VEHICLE AND PREVENTS IT FROM BEING DEPOSITED ON THE ROAD NETWORK ADJACENT TO THE SITE AND THUS, THE STORMWATER SYSTEM. NO VEHICLE ASSOCIATED WITH THE WORK IS TO BE PARKED ON A FOOTPATH OR PUBLIC RESERVE. ALL VEHICLES /ISITING THE SITE DURING DEMOLITION, EXCAVATION AND/OR CONSTRUCTION WORKS, ARE TO COMPLY WITH THE PARKING REQUIREMENTS IN THAT AREA.

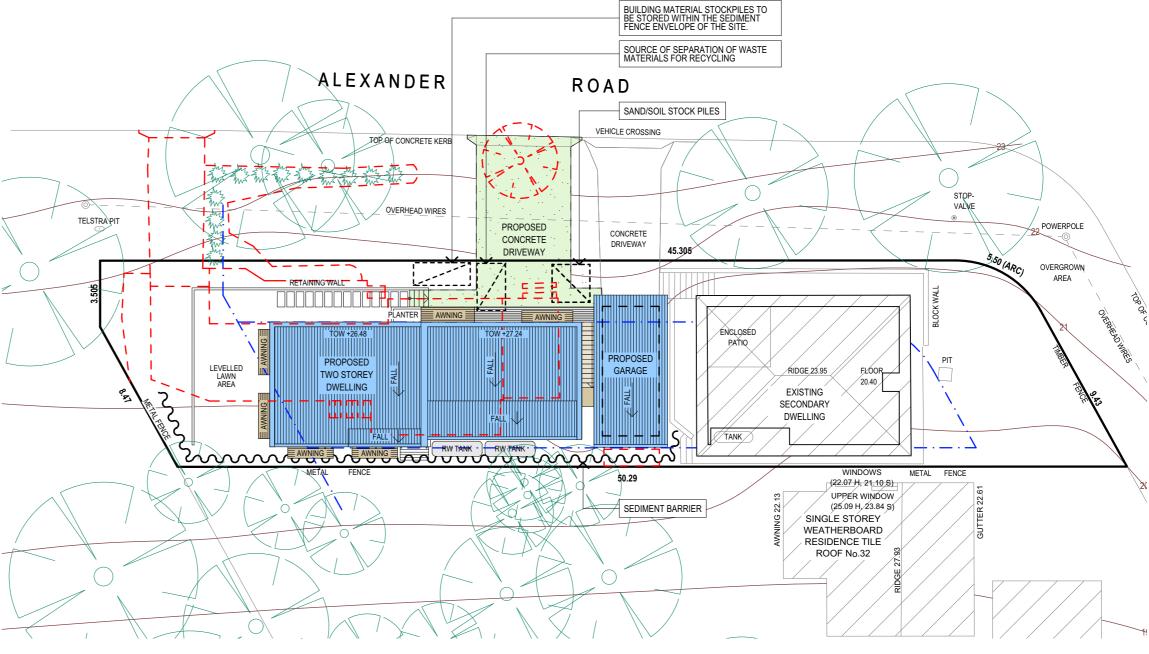

EROSION & SEDIMENT CONTROL / WASTE MANAGEMENT PLAN 1:200

DESCRIPTIO

EXTRA NOTE

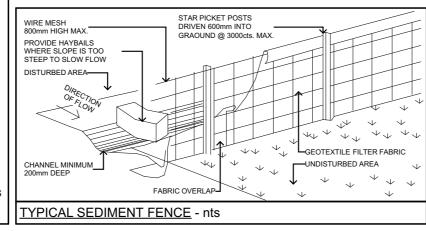


REV:

Α

DATE:

07.01.20

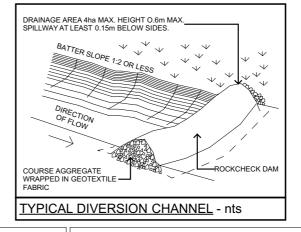





692a/19

0003847852-01 Terry Chapman 20920 20 Jan 2020







All structures including stormwater & drainage to engineer's details

- Do not obtain dimensions by scaling drawings.

 All dimensions are to be checked on site prior to starting work.

 These drawings are to be read in conjunction with all other consultant's drawings and
- All workmanship & materials shall be in accordance with the requirements of current edition including amendments of the relevant SAA Codes of Practice, the Building Code of Australia and
- romaterials are to be used throughout unless otherwise noted.

 crete footings, slab, structural beams or any other structural members are to be designed by


JJ Drafting
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N:	PROJECT DETAILS:
ES	PROPOSED NEW HOUSE
	34 WHALE BEACH ROAD, AVALON 2107
	DRAWING TITLE:
	EROSION & SEDIMENT CONTROL / WASTE MANAGEMENT
	PLAN

DATE:	DRAWN BY:	SCALE:	
NOV/19	AHB	1:200 @ A3	
JOB No:	CHECKED BY:	DRAWING No:	

JJ

DA.11

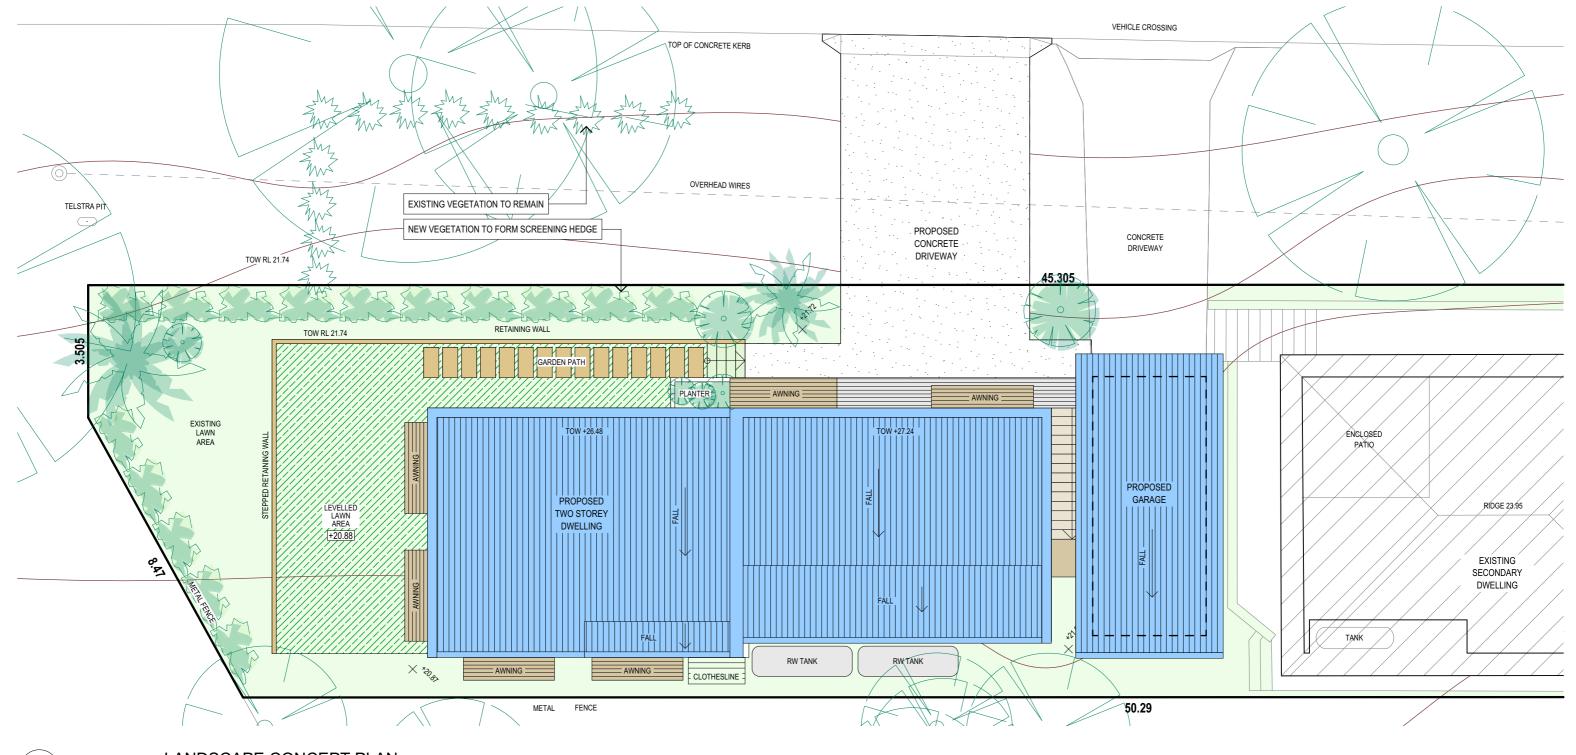


DESCRIPTION:

EXTRA NOTES

LANDSCAPE CONCEPT PLAN 1:100

SYMBOL	COMMON NAME	SCIENTIFIC NAME	HEIGHT	SPREAD	QTY
A.	Willow Bottlebrush	Callistemon salignus	7m	5m	2
E.B	Lilly Pilly	Syzygium cascade	3m	2m	15
	Dwarf magnolia 'little gem'	Magnolia grandiflora	4m	2.5m	6
8	Existing trees - varies	-	-	-	-
ZMZ MAZ	Existing shrubs - varies	-	-	-	-

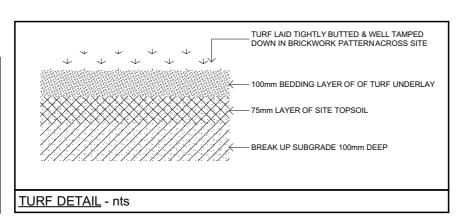

REV: DATE:

07.01.20

Α





0003847852-01 Terry Chapman

20920 20 Jan 2020



TRUE NORTH:

NOTES:

- NOTES:

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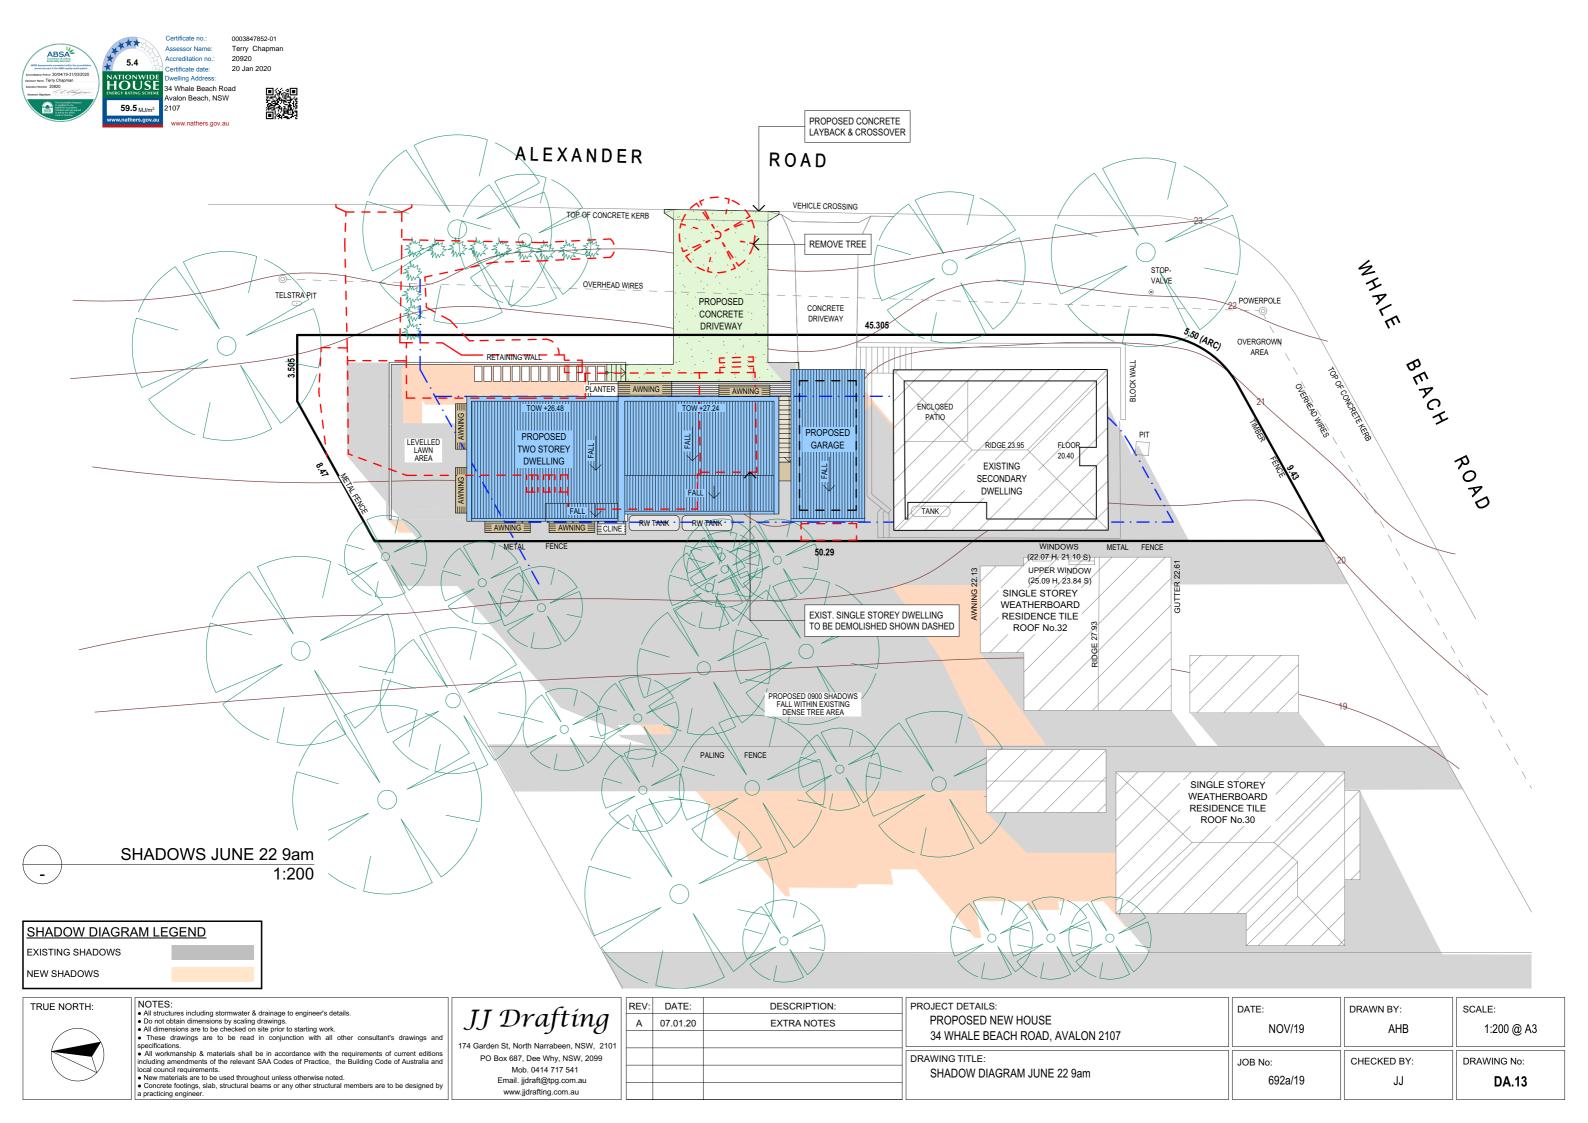
 All workmanship & materials shall be in accordance with the requirements of current editions including amendments of the relevant SAA Codes of Practice, the Building Code of Australia and local council requirements.


 New materials are to be used throughout unless otherwise noted.


 Concrete footings, slab, structural beams or any other structural members are to be designed by a practicing engineer.

)	\mathcal{O}
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PO Box 687, De	ee Why, N	SW, 2099
Mob. 0	0414 717 5	541
Email. jjdra	aft@tpg.co	m.au
www jidr	afting com	au

PROJECT DETAILS: PROPOSED NEW HOUSE 34 WHALE BEACH ROAD, AVALON 2107	DATE: NOV/19	DRAWN BY:	SCALE: 1:100, 1:200 @ A3
DRAWING TITLE: LANDSCAPE CONCEPT PLAN	JOB No: 692a/19	CHECKED BY:	DRAWING No: DA.12



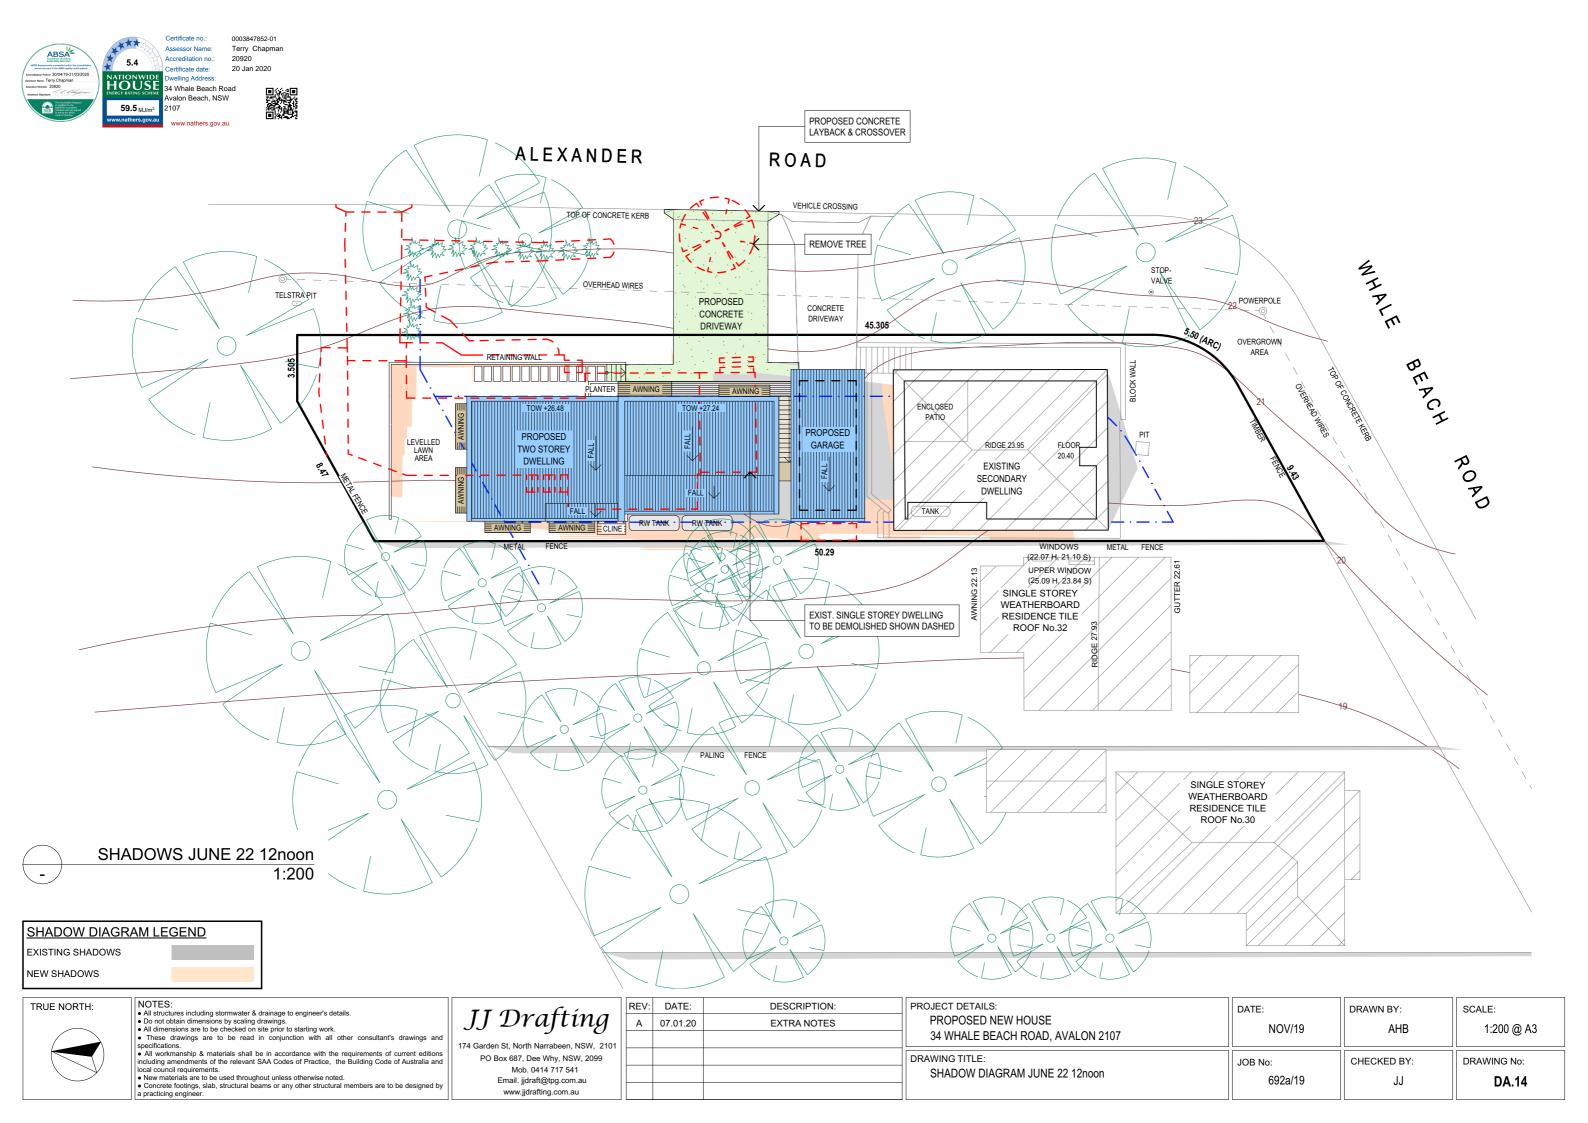

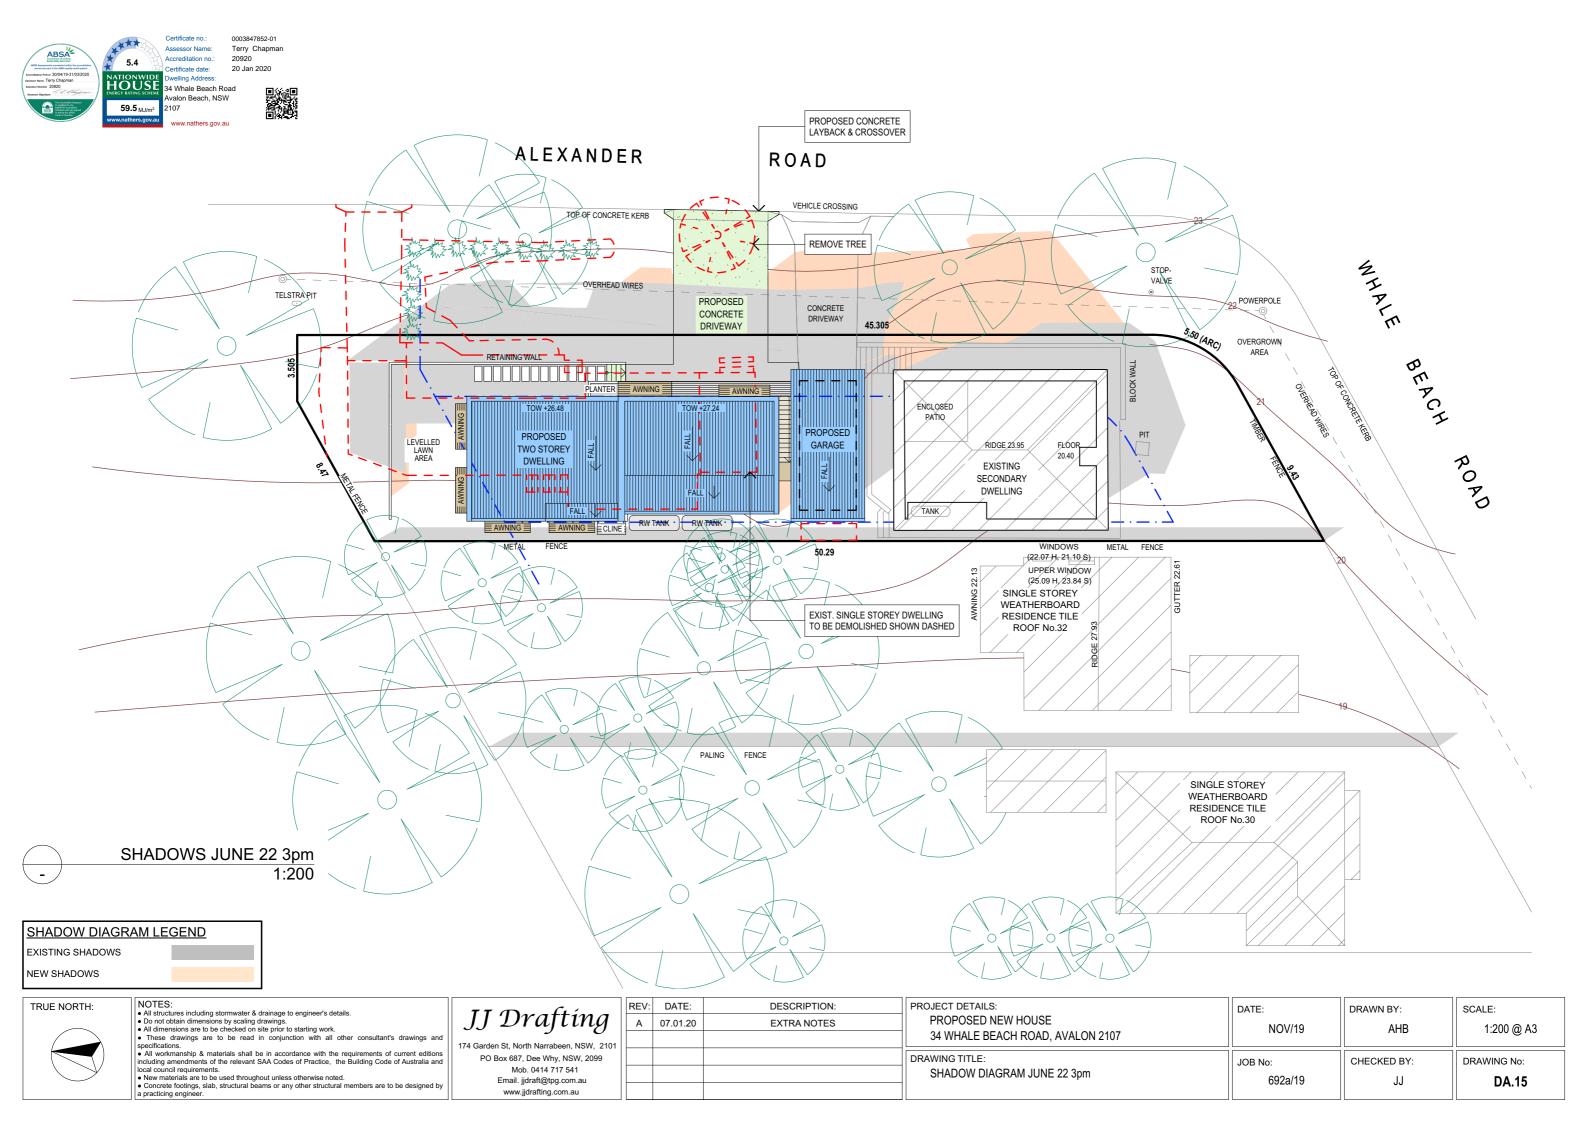





LOOKING SOUTH FROM ALEXANDER RD

LOOKING NORTH WEST FROM ALEXANDER RD

MATERIALS & COLOURS PALETTE



Selected, dark brick face brickwork.



Selected, dark window & door frames.



Selected dark wall cladding finish.

DESCRIPTION:



Timber or timber-look facade articulation feature.



HOUSE

59.5 MJ/

Terry Chapman 20920 20 Jan 2020

34 Whale Beach Road

Timber or timber-look batten shade awnings.

- NOTES:

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	Α	07.01.20
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	Α	07.01.20	EXTRA NOTES	
1				

	PROJECT DETAILS:
	PROPOSED NEW HOUSE
1	34 WHALE BEACH ROAD, AVALON 2107
	DRAWING TITLE:
	3D PERSPECTIVES & MATERIALS PALETTE

DATE:	DRAWN BY:	SCALE:
NOV/19	АНВ	@ A3
JOB No:	CHECKED BY:	DRAWING No:
692a/19	JJ	DA.16