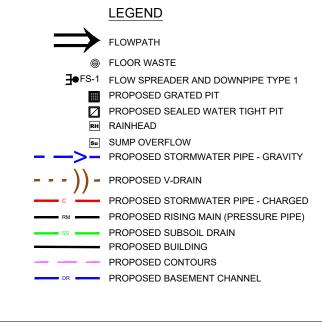
STORMWATER MANAGEMENT PLAN

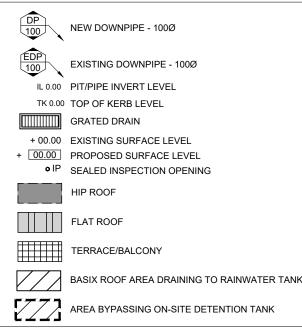
LOT 4 ORCHARD STREET 1. ALL PROPOSED PITS TO BE 450 x 450 CAST IN-SITU OR PRECAST PITS UNLESS SHOWN OTHERWISE. WARRIEWOOD



BE (Civil), MIEAust, CPEng No. 449924

SHEET INDEX:								
SHEET No.	TITLE	AMMENDMENT No.						
1	INDEX SHEET	0						
2	STORMWATER DETAIL PLAN	0						
3	LOWER GROUND FLOOR PLAN	0						
4	GROUND FLOOR PLAN	0						
5	ROOF PLAN	0						
6	RAINWATER TANK DETAILS	0						
7	EROSION AND SEDIMENT CONTROL PLAN	0						





- ALL CHARGED LINE PIPES TO BE 100Ø uPVC SEWER CLASS UNLESS SHOWN OTHERWISE
- ALL DOWNPIPES TO BE 90Ø uPVC OR 100 x 50 UNLESS OTHERWISE SHOWN
- ALL NON-PRESSURE STORMWATER PIPES TO BE 1000 uPVC UNLESS SHOWN OTHERWISE
- ALL GRATED DRAINS TO BE MINIMUM 150 WIDE GALVANIZED HEAVY DUTY GRATES.
- ALL NON-TRAFFICABLE PITS TO BE LIGHT DUTY. PITS IN TRAFFICABLE AREAS TO BE HEAVY DUTY
- ALL WORK SHALL BE CARRIED OUT IN ACCORDANCE WITH COUNCILS SPECIFICATIONS.
- ALL PITS GREATER THAN 1.2m DEPTH SHALL INCLUDE STEP IRONS AND HAVE MINIMUM CLEAR DIMENSIONS OF
- ALL PITS ARE TO BE BENCHED TO ALLOW SMOOTH FLOW OF WATER THROUGH PITS
- ALL DOWNPIPES SHALL CONFORM TO AS/NZS 1866 FOR ALUMINIUM PIPES AND AS 1254, AS/NZS 1260, AS 1273,
- ALL BOX GUTTERS SHALL COMPLY WITH AS/NZS 2179.1
- ALL BOX GUTTERS SHALL BE CONSTRUCTED WITH A MINIMUM 1:200 GRADE TO SUMP/DOWNPIPES

DOWNPIPE	CROSS SECTION	DOWNPIPE SIZES					
TYPE	AREA MIN. (mm2)	ROUND	RECTANGULAR				
1	8600	90Ø	100 X 50				
2	11000	100Ø	100 X 75				
3	12900	125Ø	100 X 75				
4	17100	125Ø	100 X 100				
5	21500	150Ø	125 X 100				
6	24700	150Ø	150 X 150				

FOR DA APPROVAL

SURVEYOR	0	DA ISSUE	08/04/24				C.
YSCO GEOMATICS							ABN
ARCHITECT							49
POPOVBASS							RC
CONSULTANT	No.	AMMENDMENT	DATE	No.	AMMENDMENT	DATE	MC
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K. ENGINEERING SERVICES 9 FLORA ST OSELANDS, NSW 2196 OB: 0403 329 327 EMAIL: ckatsoulas@gmail.com

INDEX **POPOVBASS** LOT 4 ORCHARD STREET WARRIEWOOD

DRAWING TITLE

DRAWN: S.C. SIGNED:

DATE: APRIL 2024 SCALE: AS SHOWN DATUM: AHD 1 OF 7 ISSUE: 0

JOB & DRAWING No: 222022-L4





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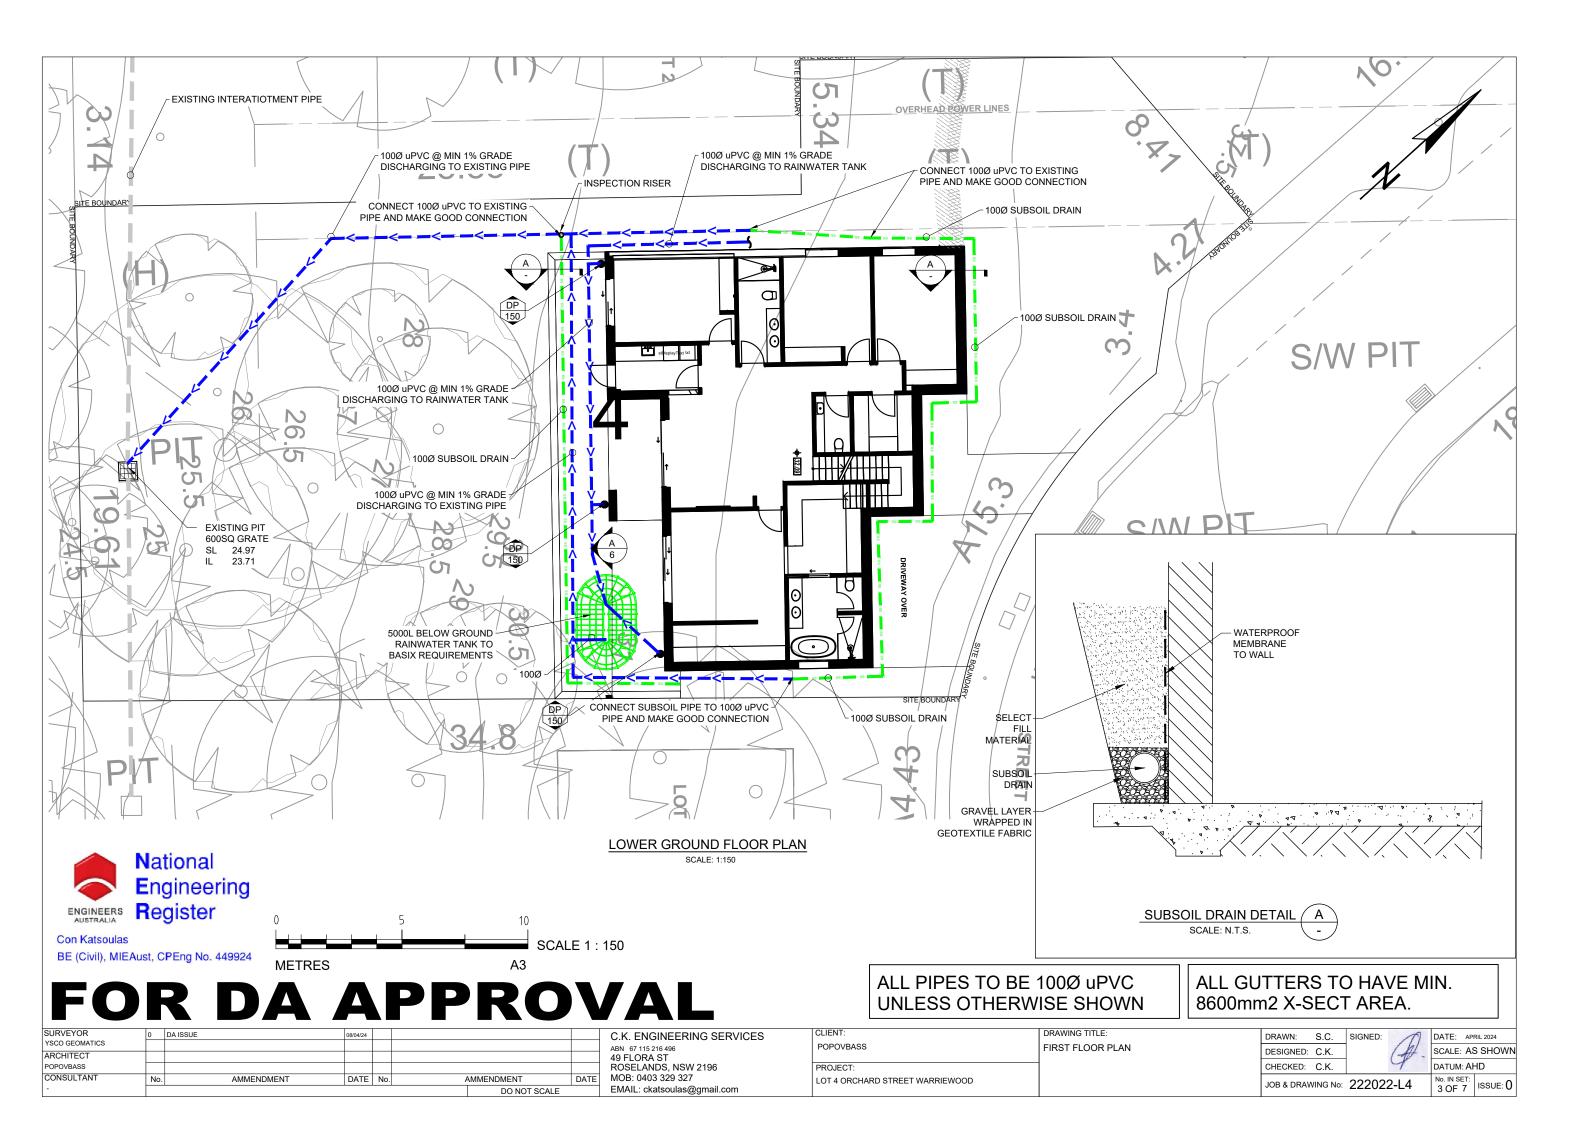
C.K. ENGINEERING SERVICES ABN 67 115 216 496 49 FLORA ST ROSELANDS, NSW 2196 MOB: 0403 329 327 EMAIL: ckatsoulas@gmail.com

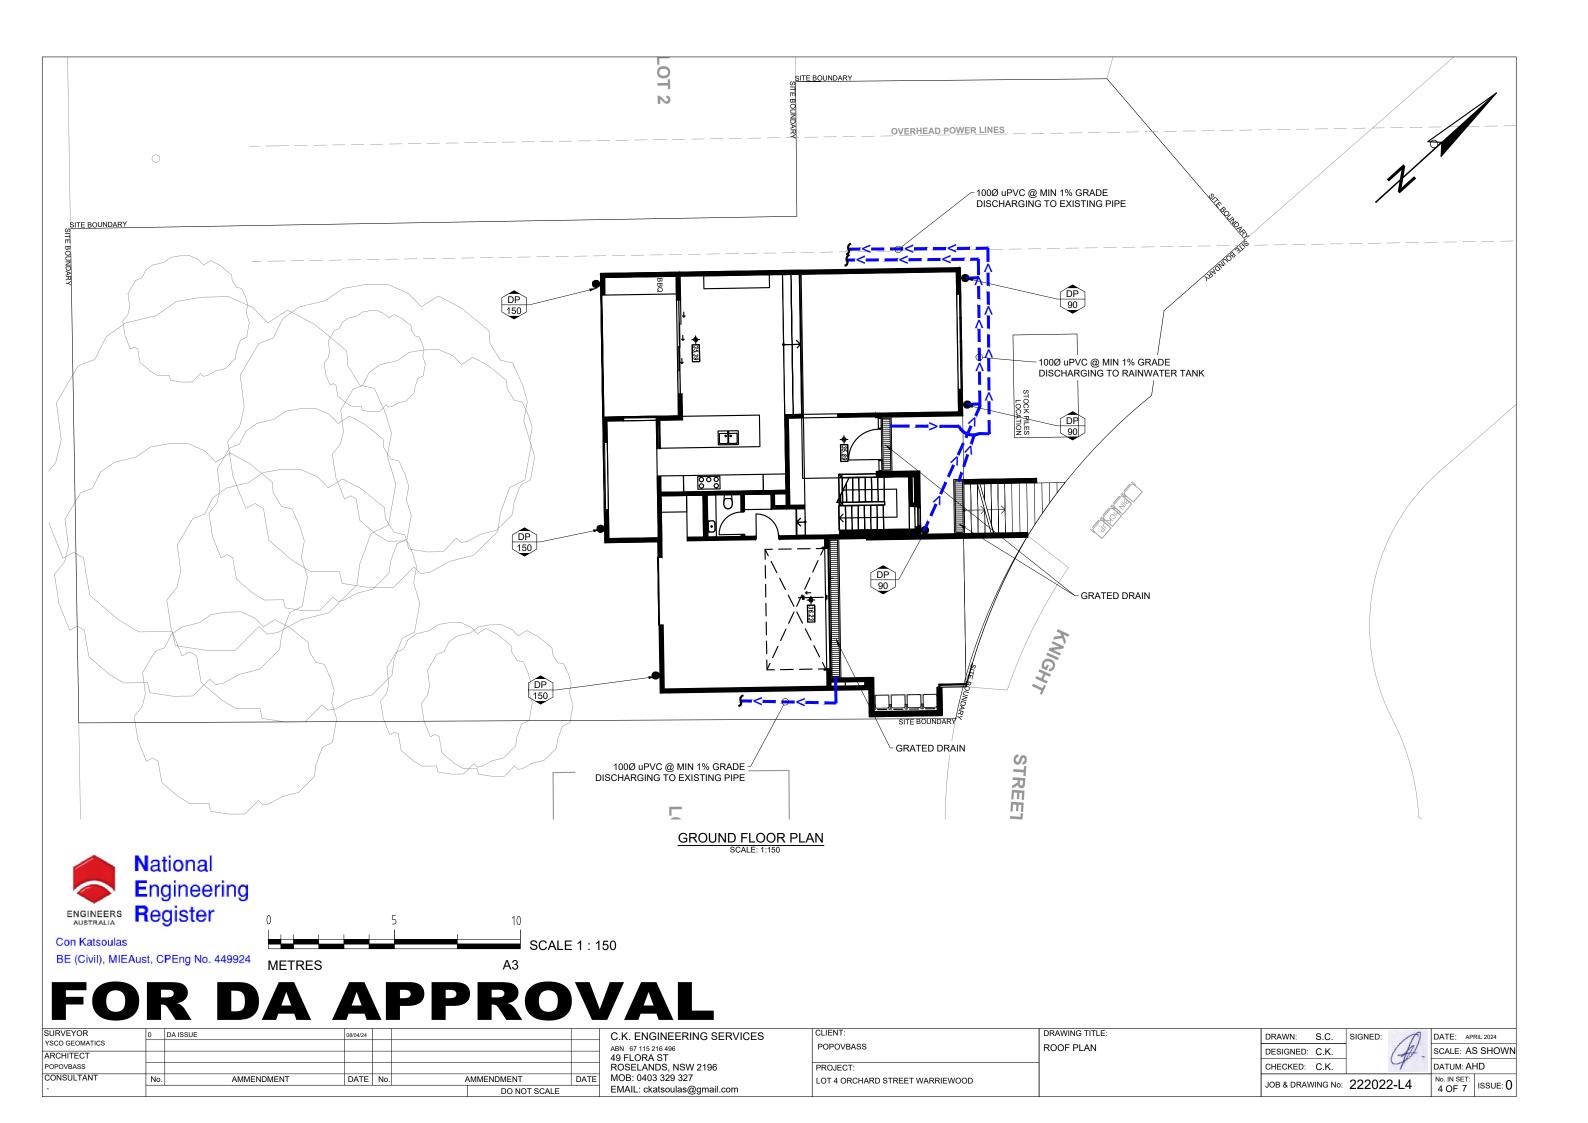
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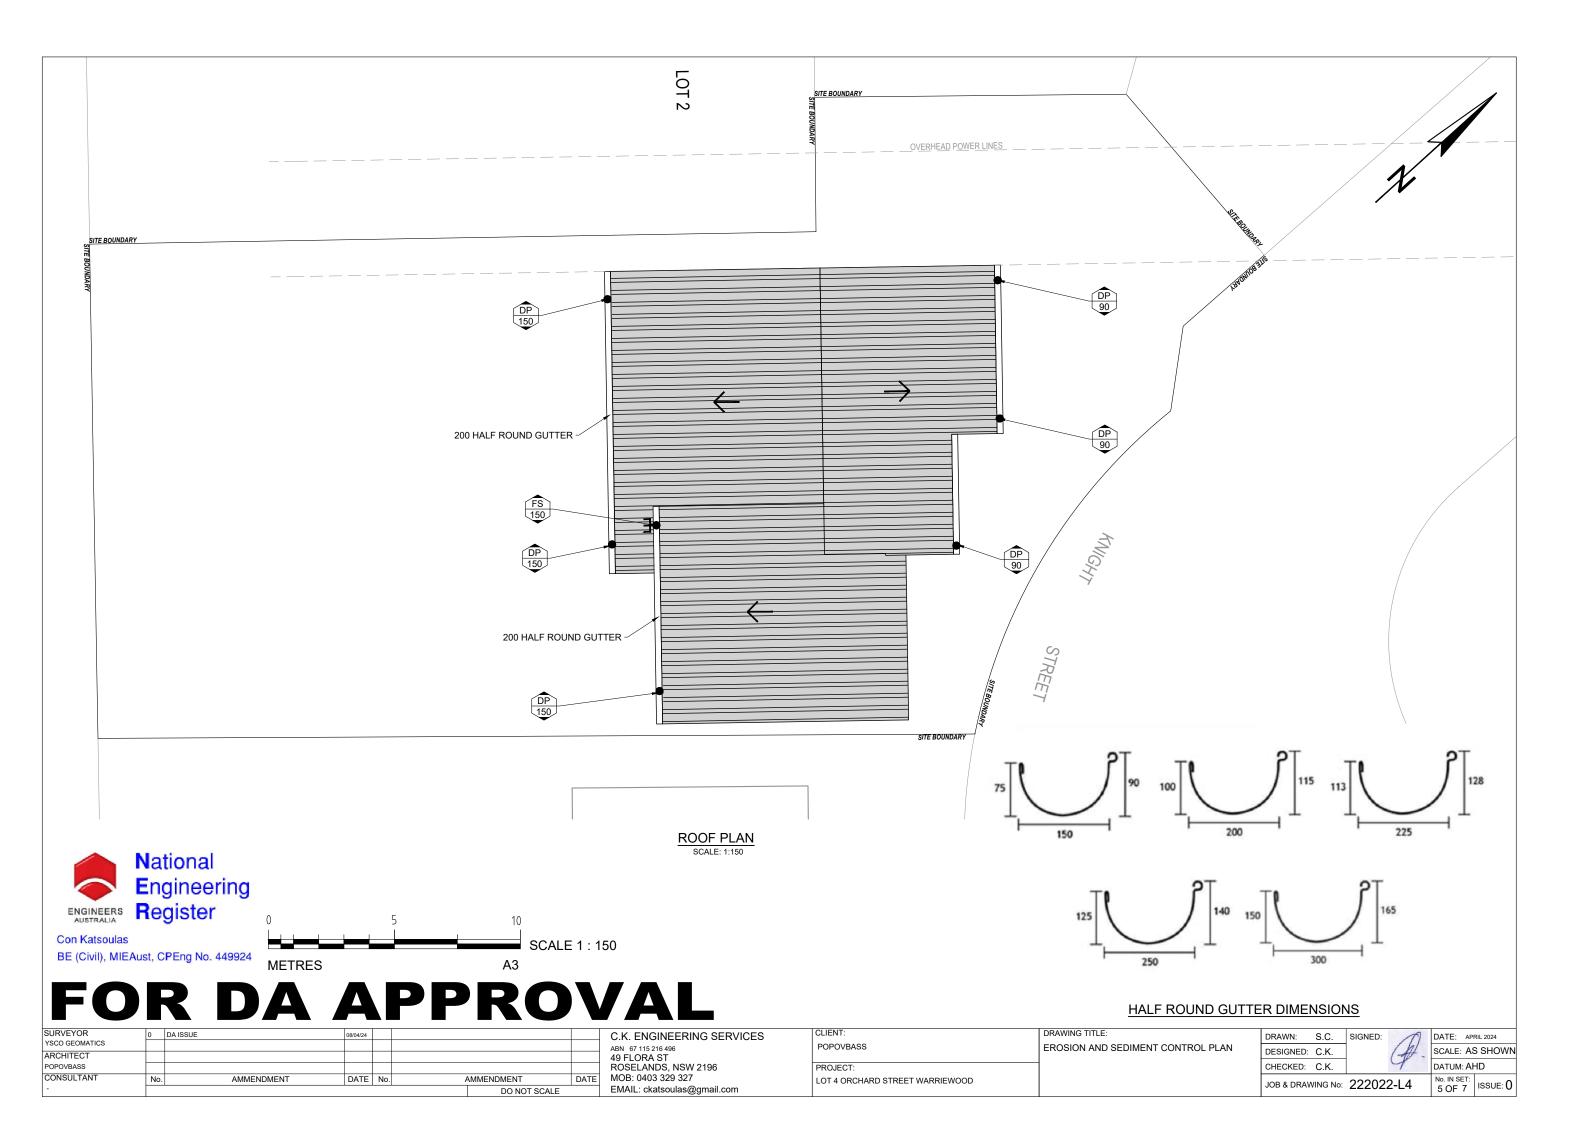
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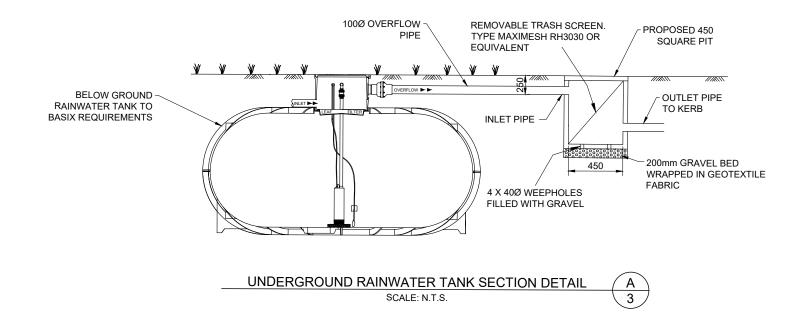
DATE: APRIL 2024 JOB & DRAWING No: 222022-L4

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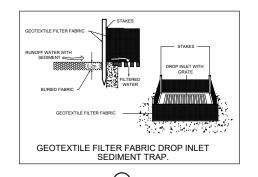


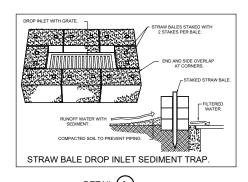


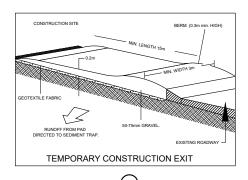
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BE (Civil), MIEAust, CPEng No. 449924

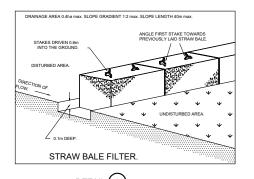
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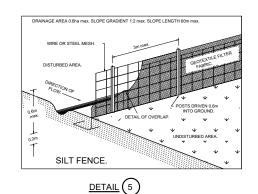
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ARCHITECT						49 FLORA ST					- (-	
POPOVBASS						ROSELANDS, NSW 2196	PROJECT:		CHECKED	C.K.		7	DATUM: AHD
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DETAIL (3) DETAIL (1) DETAIL (2) DETAIL (4) IZ.JU SILT FENCE 28.83 🕠 STOCKPILE AREA Dx SILT FENCE S/W 7. PROVIDE TEMPORARY CONSTRUCTION ENTRY

EROSION CONTROL NOTES:

- ALL WORK SHALL BE CARRIED OUT IN ACCORDANCE WITH COUNCIL'S STANDARD SPECIFICATIONS AND TO THE SATISFACTION OF COUNCIL'S ENGINEER.
- EROSION AND SEDIMENTATION CONTROLS SHALL BE CONSTRUCTED AS SHOWN ON SHEET 2 AND 3 OF THIS PLAN AND/OR WHERE DIRECTED BY COUNCIL'S ENGINEER.
- SEDIMENTATION AND EROSION CONTROL DEVICES SHALL BE IMPLEMENTED PRIOR TO OR IN CONJUNCTION WITH THE FIRST PHASE OF EARTHWORKS AND SHALL BE REMOVED ONLY WHEN THE AREAS ABOVE IT HAVE BEEN STABILISED. EACH SEDIMENTATION AND EROSION CONTROL DEVICE SHALL BE INSPECTED AFTER EACH STORM FOR STRUCTURAL DAMAGE OR CLOGGING BY SILT AND OTHER DEBRIS AND PROMPTLY DESILTED, REPAIRED OR REPLACED IF REQUIRED.
- TOPSOIL STOCKPILES SHALL BE LOCATED OUTSIDE HAZARD AREAS SUCH AS DRAINAGE DEPRESSIONS.
 - ALL AREAS NOT SUBJECT TO CONSTRUCTION WORKS SHALL BE RETAINED FREE FROM DISTURBANCE OR DAMAGE FOR THE DURATION OF THE WORKS.
 - TREES TO BE RETAINED SHALL BE PROTECTED DURING SITE WORKS AND CONSTRUCTION BY THE ERECTION OF SOLID BARRICADES AT THE DRIP LINE OR AS SPECIFIED BY COUNCIL'S ENGINEER.
 - THE DEVELOPER OR CONTRACTOR WILL TAKE ALL MEASURES TO PREVENT DAMAGE TO TREES AND ROOT SYSTEMS DURING SITE WORKS AND CONSTRUCTION ACTIVITIES INCLUDING THE PROVISION OF WATER, SEWERAGE AND STORMWATER DRAINAGE SERVICES. IN PARTICULAR, WORKS, ERECTION OF STRUCTURES, EXCAVATION OR CHANGES TO SOIL LEVELS WITHIN 4 METRES OF THE TRUNKS OF TREES TO BE RETAINED ARE NOT PERMITTED UNLESS PART OF THE DEVELOPMENT AS APPROVED, AND THE STORAGE OF SPOIL, BUILDING MATERIALS, SOILS OR THE DRIVING OR PARKING OF ANY VEHICLE OR MACHINERY WITHIN 4 METRES OF THE TRUNK OF A TREE TO BE RETAINED, IS NOT PERMITTED.
 - WETTING OF THE SITE SHOULD BE CARRIED OUT AS OFTEN AS NECESSARY AS A FORM OF DUST CONTROL.
 - SILT FENCES TO BE CONSTRUCTED WHERE EVER NATURAL SURFACE SLOPES AWAY FROM DISTURBED AREAS OR WHERE DIRECTED BY THE ENGINEER.

FOR DA APPROVAL

EROSION AND SEDIMENT CONTROL PLAN

ENGINEERS
AUSTRALIA
Con Katsoulas
BE (Civil), MIE

	SURVEYOR	0	DA ISSUE	08/04/24					C.K. ENGINEERING SERVICES	CLIENT:
	YSCO GEOMATICS								ABN 67 115 216 496	POPOVBASS
	ARCHITECT								49 FLORA ST	
	POPOVBASS								ROSELANDS, NSW 2196	PROJECT:
	CONSULTANT	No	AMMENDMENT	DATE	No.	IMA	MENDMENT	DATE	MOB: 0403 329 327	LOT 4 ORCHARD STREE
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DRAWING TITLE:
EROSION AND SEDIMENT CONTROL PLAN
ECT:
ORCHARD STREET WARRIEWOOD

DRAWN: S.C. SIGNED: DATE: APRIL 2024

DESIGNED: C.K. SCALE: AS SHOW

DRAWN: S.C.
DESIGNED: C.K.
CHECKED: C.K.

JOB & DRAWING NO: 222022-L4

DATE: APRIL 2024
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