

Energy Commitments	Show on DA plans	Show on CC/CDC plans & specs	Certifier check
Hot water			
The applicant must install the following hot water system in the development, or a system with a higher energy rating: gas instantaneous with a performance of 4 stars.	~	<b>~</b>	~
Cooling system			
The applicant must install the following cooling system, or a system with a higher energy rating, in at least 1 living area: 3-phase airconditioning; Energy rating: EER 3.0 - 3.5		~	~
The applicant must install the following cooling system, or a system with a higher energy rating, in at least 1 bedroom: 3-phase airconditioning; Energy rating: EER 3.0 - 3.5		<b>~</b>	~
The cooling system must provide for day/night zoning between living areas and bedrooms.		<b>~</b>	~
Heating system			
The applicant must install the following heating system, or a system with a higher energy rating, in at least 1 living area: 3-phase airconditioning; Energy rating: EER 3.0 - 3.5		~	~
The applicant must install the following heating system, or a system with a higher energy rating, in at least 1 bedroom: 3-phase airconditioning; Energy rating: EER 3.0 - 3.5		<ul> <li></li> </ul>	~
The heating system must provide for day/night zoning between living areas and bedrooms.		~	~
Ventilation			
The applicant must install the following exhaust systems in the development:			
At least 1 Bathroom: individual fan, ducted to façade or roof; Operation control: manual switch on/off		~	~
Kitchen: individual fan, ducted to façade or roof; Operation control: manual switch on/off		<ul> <li></li> </ul>	~
Laundry: individual fan, not ducted; Operation control: manual switch on/off		<ul> <li>Image: A set of the set of the</li></ul>	~
Artificial lighting			
The applicant must ensure that the "primary type of artificial lighting" is fluorescent or light emitting diode (LED) lighting in each of the following rooms, and where the word "dedicated" appears, the fittings for those lights must only be capable of accepting fluorescent light emitting diode (LED) lamps:			
<ul> <li>at least 4 of the bedrooms / study;</li> </ul>		<b>_</b>	

SASIA - ENERGI			
Energy Commitments	Show on DA plans	Show on CC/CDC plans & specs	Certifier check
at least 2 of the living / dining rooms;		<b>~</b>	~
the kitchen;			
all bathrooms/toilets;			5
the laundry;			
all hallways;		~	~
Natural lighting		1	
The applicant must install a window and/or skylight in the kitchen of the dwelling for natural lighting.	~	~	~
The applicant must install a window and/or skylight in 4 bathroom(s)/toilet(s) in the development for natural lighting.	~	<ul> <li>Image: A set of the set of the</li></ul>	~
Alternative energy			
The applicant must install a photovoltaic system with the capacity to generate at least 0.5 peak kilowatts of electricity as part of the development. The applicant must connect this system to the development's electrical system.	~	<ul> <li></li> </ul>	~
Other			
The applicant must install a gas cooktop & electric oven in the kitchen of the dwelling.		~	

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EGE	ND		Architects Pty Ltd		
	existing tree to be removed	reproduced in Builder to ref	ngs are subject to copyright and may not be cop any way without the express permission of Jar er to DA consent conditions and DA approved of	misa Architects Pt drawings.	iy Ltd
	existing tree to be retained		orks to comply with relevant provisions of the E A) & National Construction Code (NCC) 2019		
	proposed tree		Australian Standards.		
t	ceramic tiles	REVISION	DESCRIPTION	DATE	
р	downpipe	Α	DEVELOPMENT APPLICATION	09/2020	
0	drainage outlet				
wt	rain water tank				
f	overflow				
shr	outdoor shower				
m	gas meter				
21.10	existing RL's				
_	outline of existing buildings to be demolished				
.O.W.	top of wall				
.O.P.	top of parapet				


## **BDAV ASSESSMENT**

THERMAL PERFORMANCE REQUIREMENTS				
13 Pacific Road, Palm Bea	ach NSW 2108			
New Dwellin	g			
See NatHERs Certificate for sulation and glazing requirements i	full information in NatHERs Certificate prior to construction			
on and glazing must meet BCA and	Australian Standard requirements			
Construction	Added Insulation			
ouble cavity brick	270mm double cavity brick with R1.8 rigid			
ouble cavity brick	insulation to:			
ouble brick	<ul> <li>Southern wall of lower ground floor (bath, bad 4 and rumpup)</li> </ul>			
FS Logic wall	<ul> <li>bed 4 and rumpus)</li> <li>Southern wall of ground floor (WC, pantry)</li> </ul>			
dark colour	and kitchen)			
ghtweight cladding – medium colour	<ul> <li>Southern and eastern wall of entry of first floor.</li> </ul>			
	110mm lightweight cladding to ensuite of first floor - R2.5 bulk insulation + reflective foil.			
	Remaining external walls, no insulation required.			
round Floor – 110mm single brick er stud with 90mm timber framed	No insulation added to internal walls			
Floor – 110mm single brick; double k; 90mm timber stud wall and AFS				
or - 90mm timber framed				
round Floor & Ground Floor - slab on ground and suspended slab enclosed	No insulation added to external floors			
or – Section of ensuite, suspended slab over courtyard below				
ed concrete slab with plasterboard eath	Lower Ground & Ground Floors – R2.0 bulk insulation to ceilings between levels			
roof structure with plasterboard eath	R2.0 bulk insulation to ceiling			
roof	No insulation added			
et areas, kitchen and pantry				
poring to remaining living, hallways, s and WIR				
n frames (draft sealed)	Single glazed clear, U-value 6.70 SHGC 0.57 &			
sessment with default windows – window values: Only a +/- 5% erance is allowed with this rating.	0.70 to all glazed doors and windows.			
tolerance only applies to SHGC, the an always be lower but not higher ralues stated				
	This assessment has been rated with LED downlights and exhaust fans			

Assessment 4 dated 7/9/2020

N


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ES		

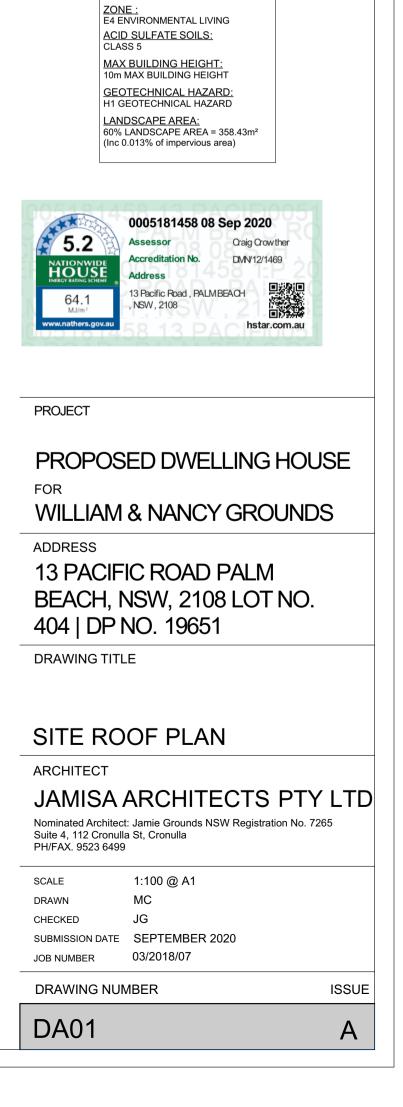


CONTROLS

### WALL LEGEND

Symbol	Туре	Finish
×	280mm Double Cavity Brick	Rendered
	200mm AFS Logic Wall	
	110mm Single Brick	Face Brick
	90mm Timber Framed	

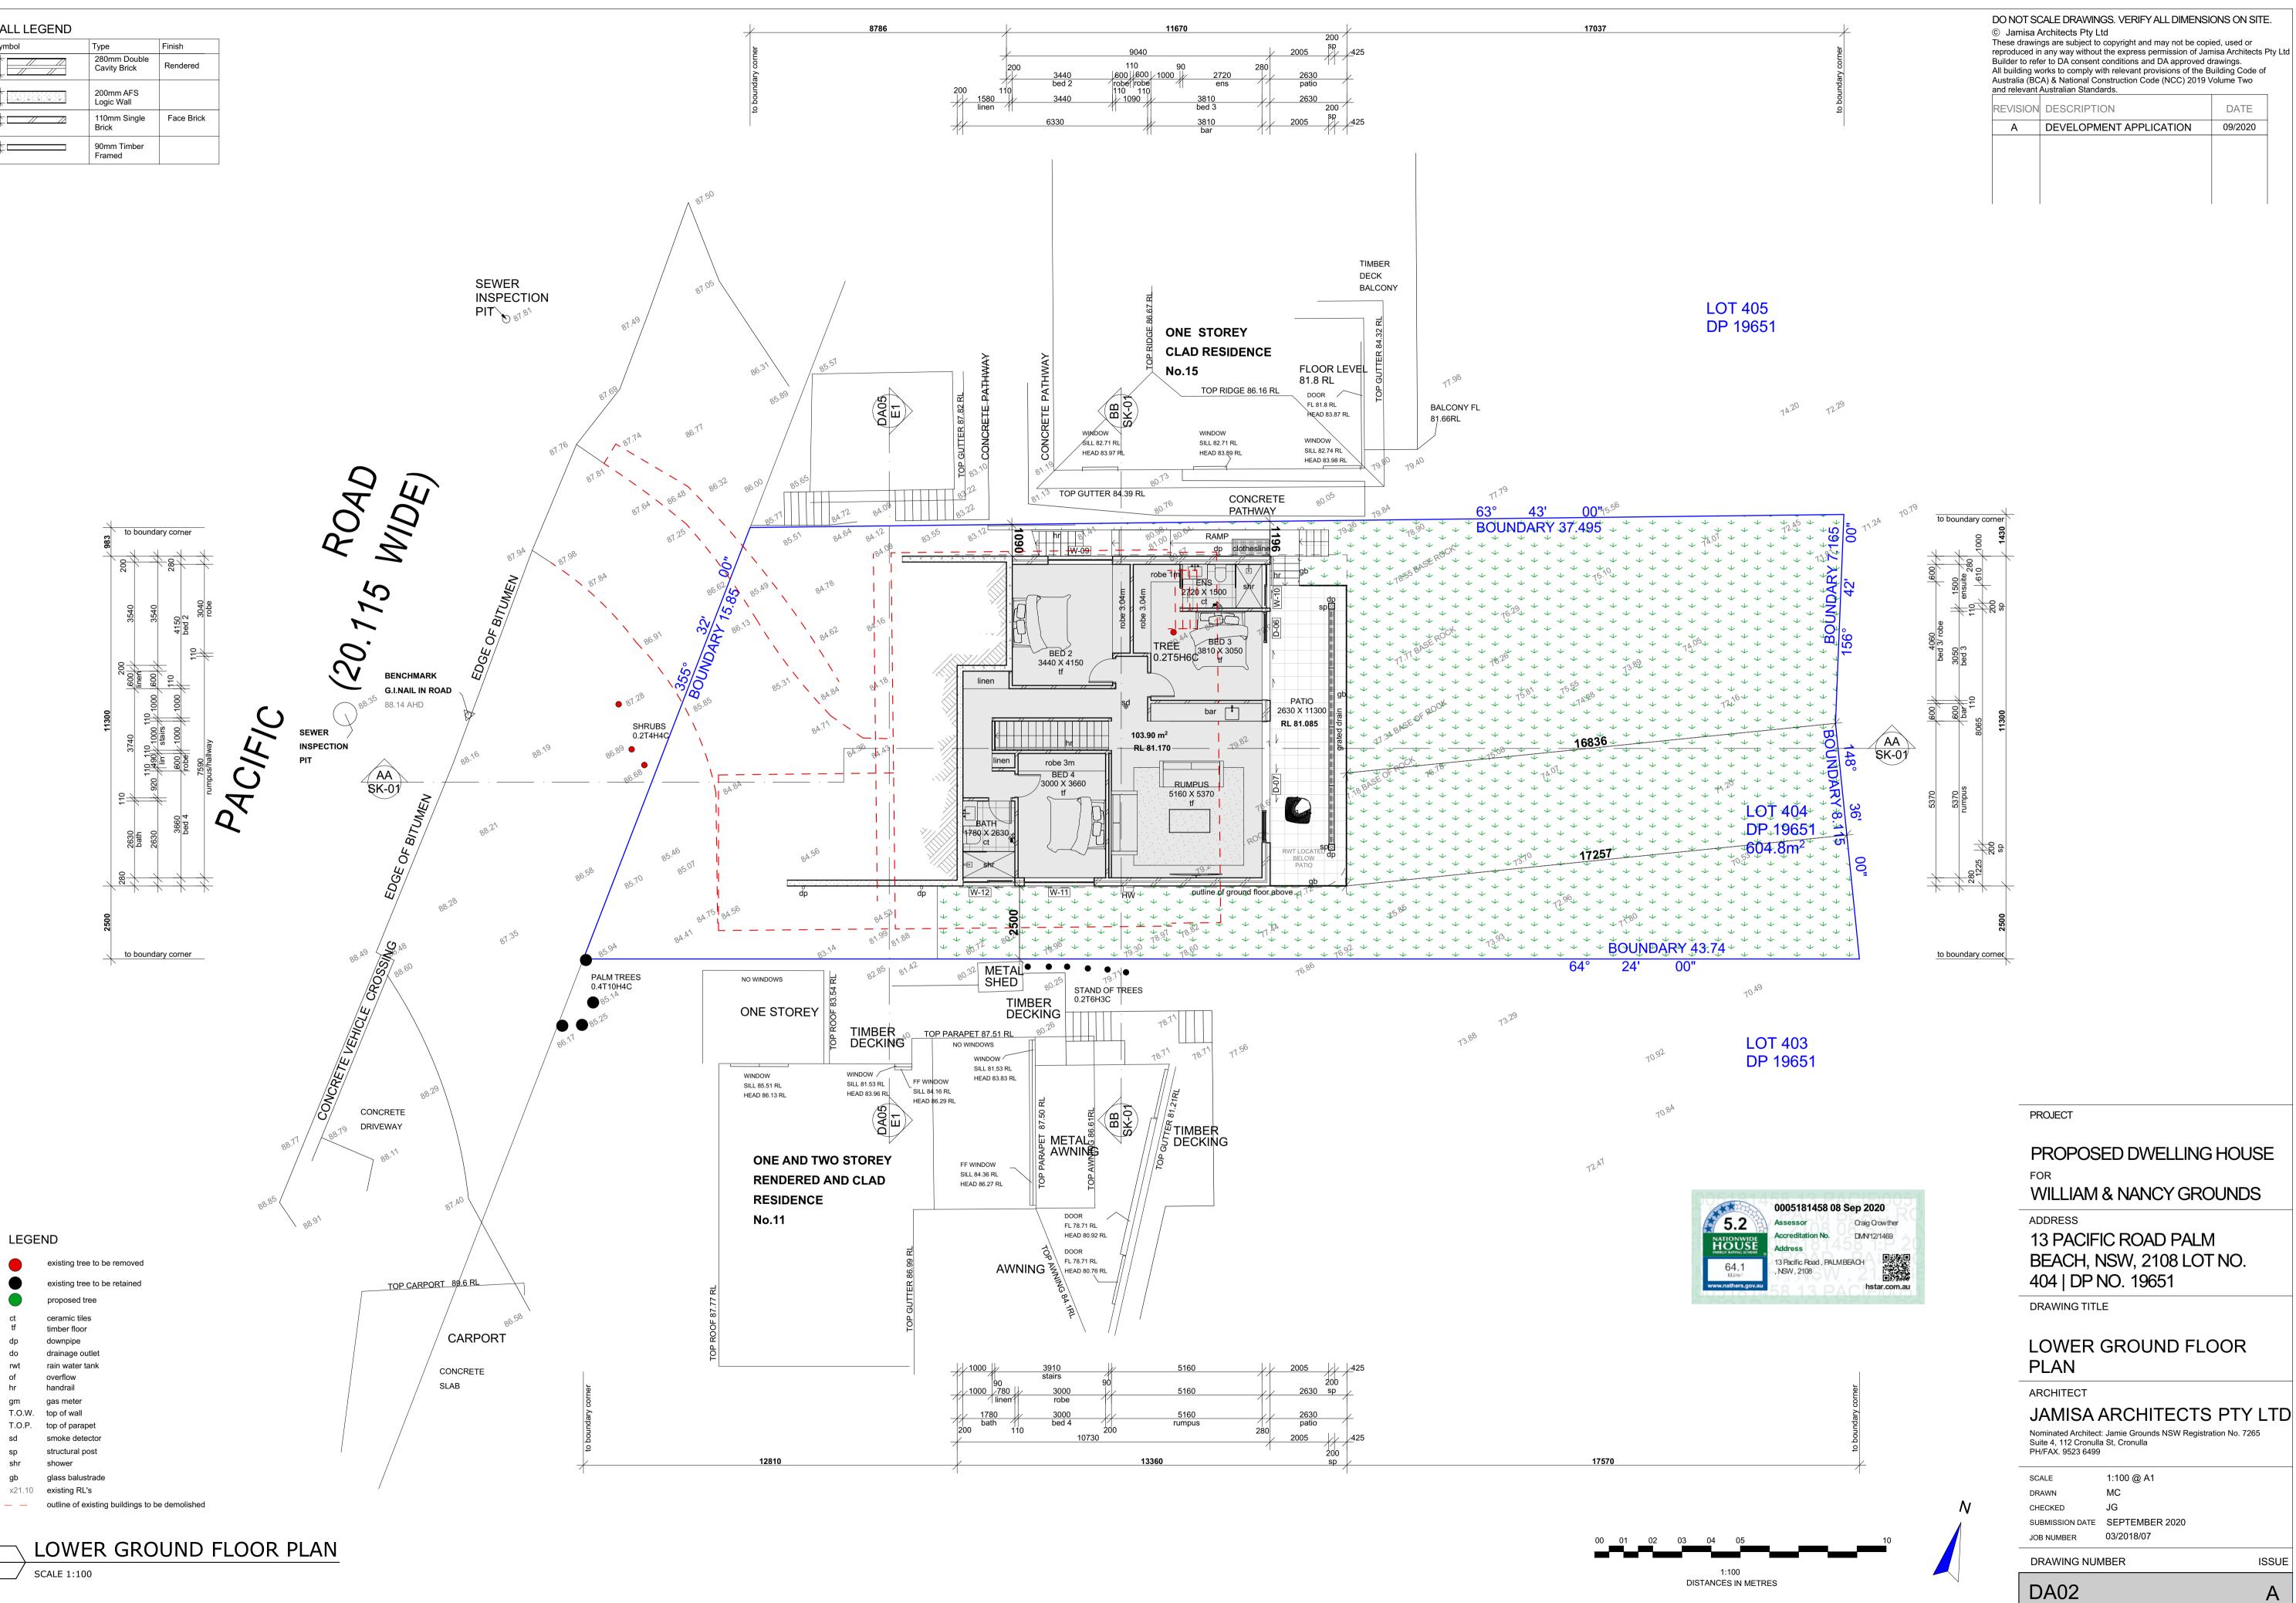


to boundary corner	© Jamisa A These drawin reproduced in Builder to refe All building w Australia (BC	CALE DRAWINGS. VERIFY ALL DIMENS Architects Pty Ltd logs are subject to copyright and may not be cop any way without the express permission of Ja er to DA consent conditions and DA approved orks to comply with relevant provisions of the f A) & National Construction Code (NCC) 2019 Australian Standards.	bied, used or misa Architects Pty drawings. Building Code of	Ltd
to po	REVISION	DESCRIPTION	DATE	
	Α	DEVELOPMENT APPLICATION	09/2020	

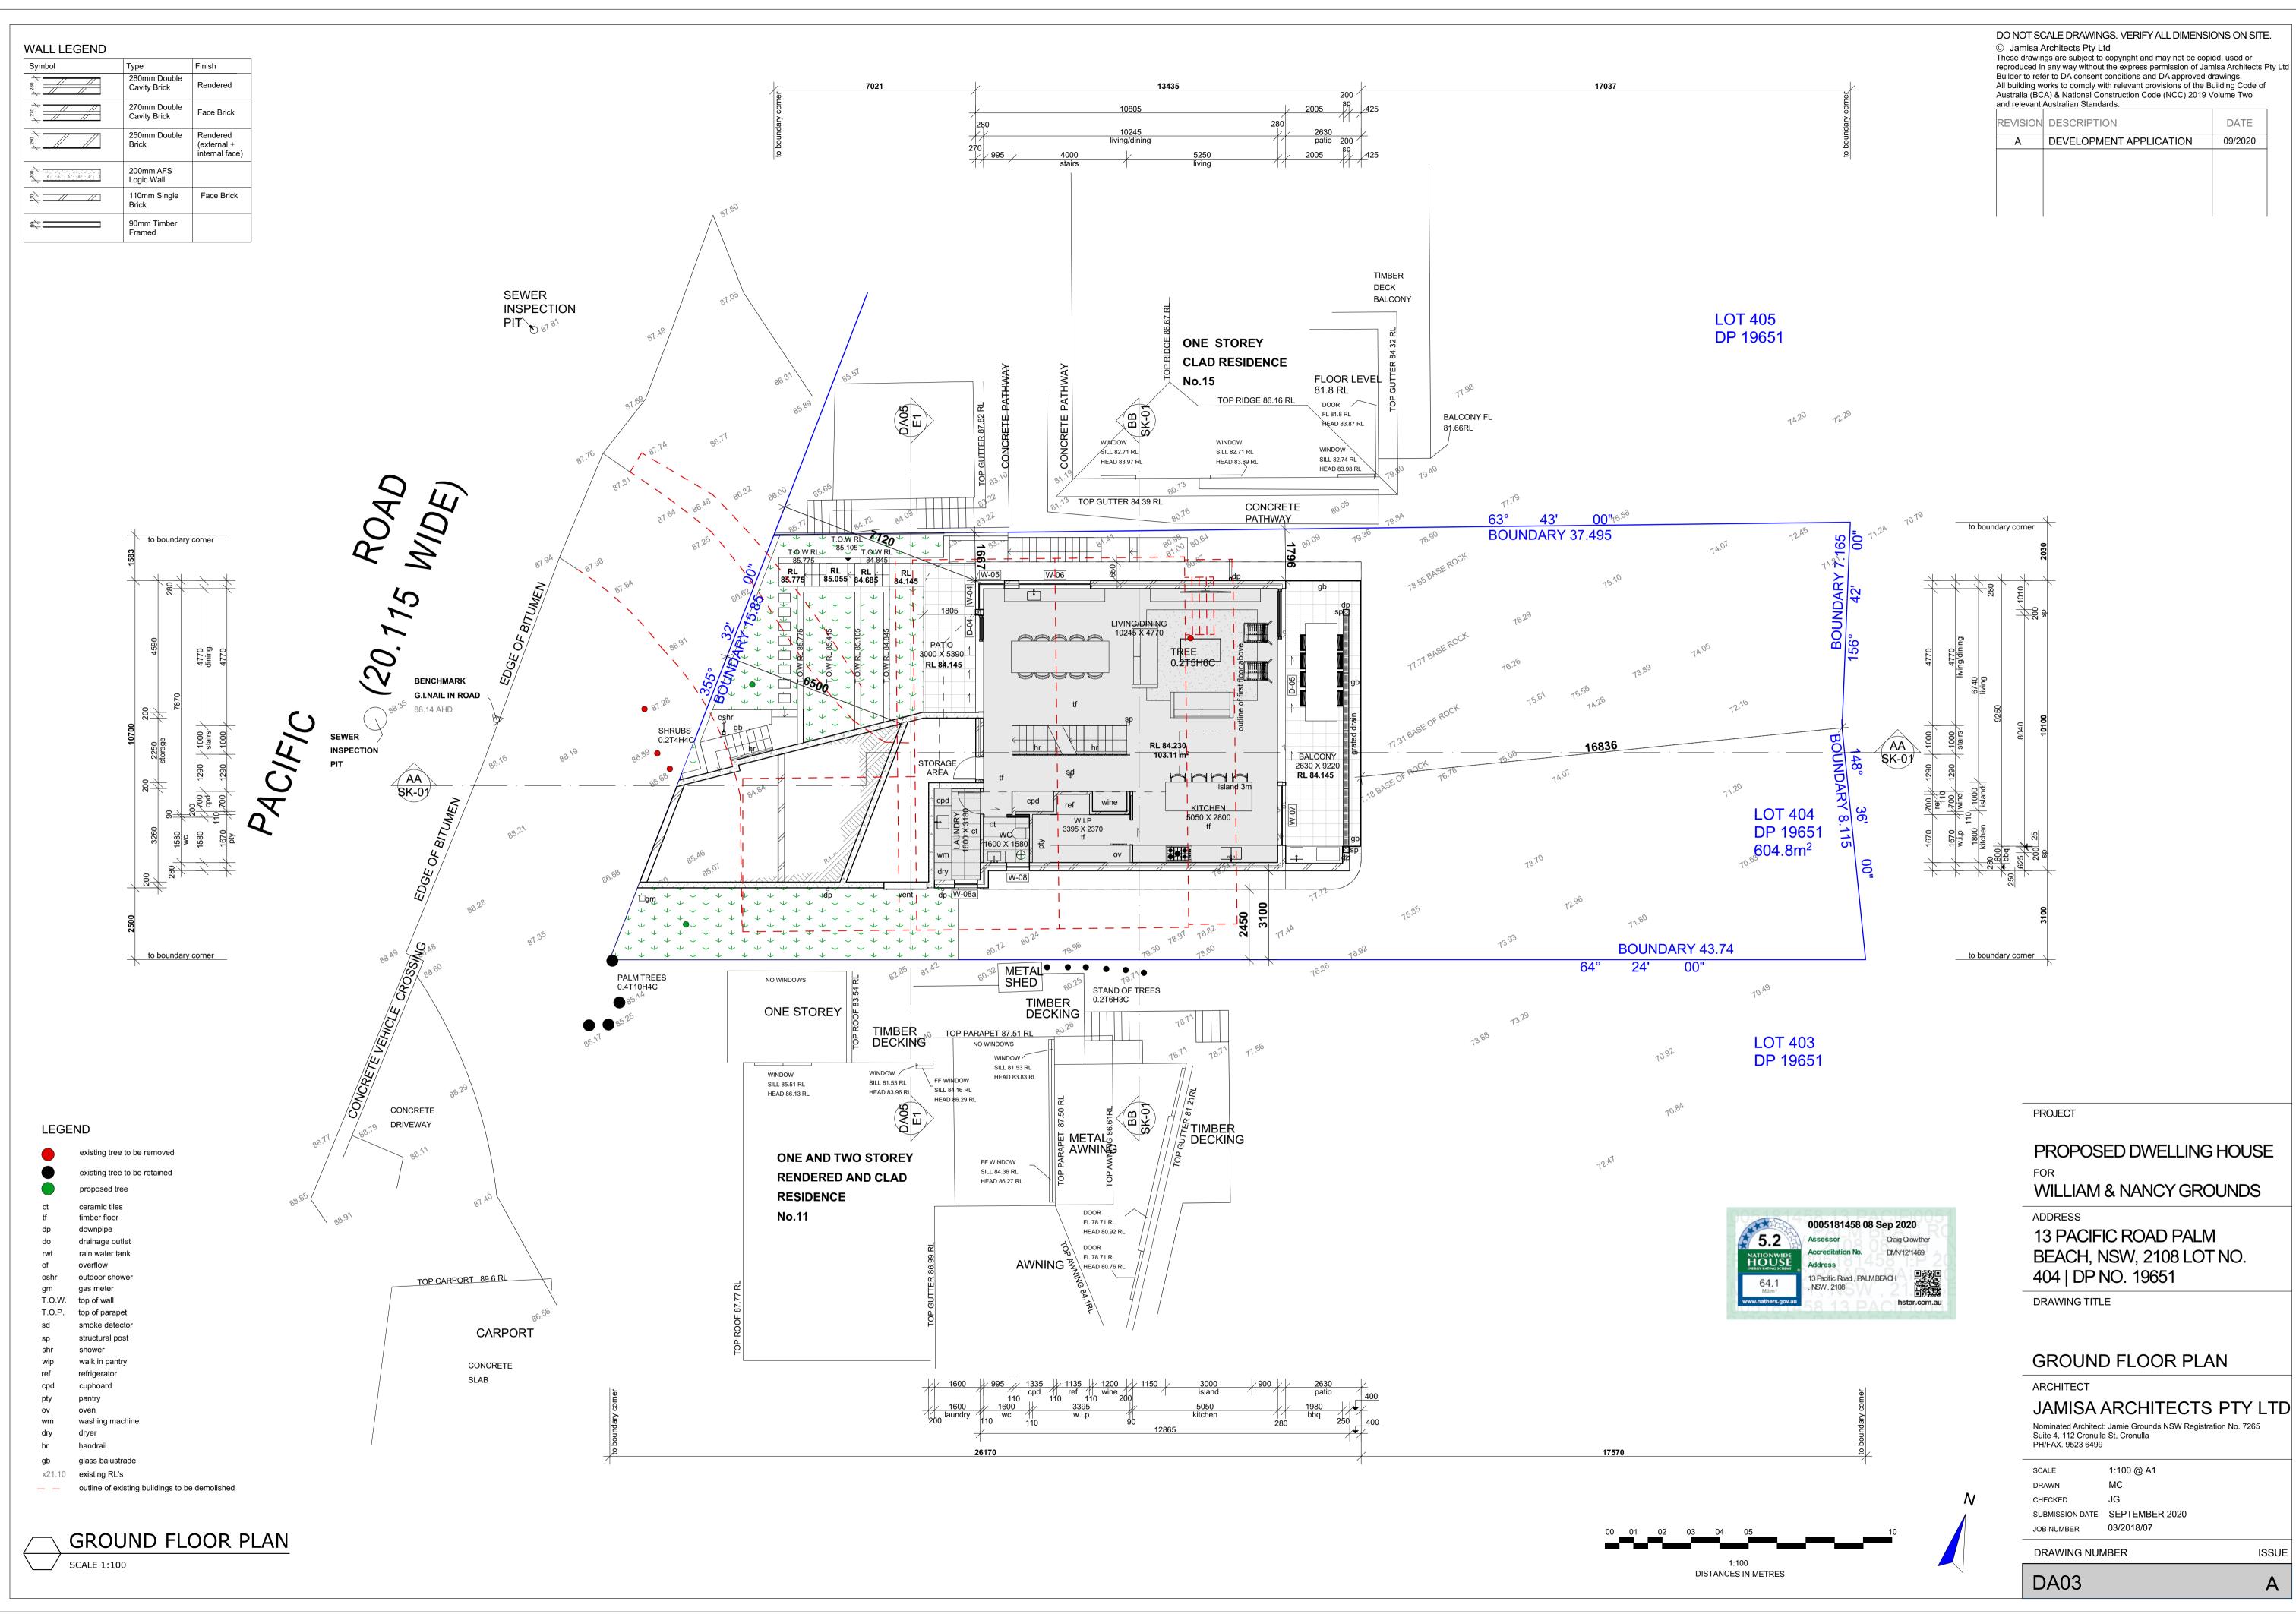

### WALL LEGEND

Symbol	Туре	Finish
× 280	280mm Double Cavity Brick	Rendered
+ <sup>250</sup> +	250mm Double Brick	Rendered (external + internal face)
	110mm Timber Framed	Lightweight Cladding
	90mm Timber Framed	

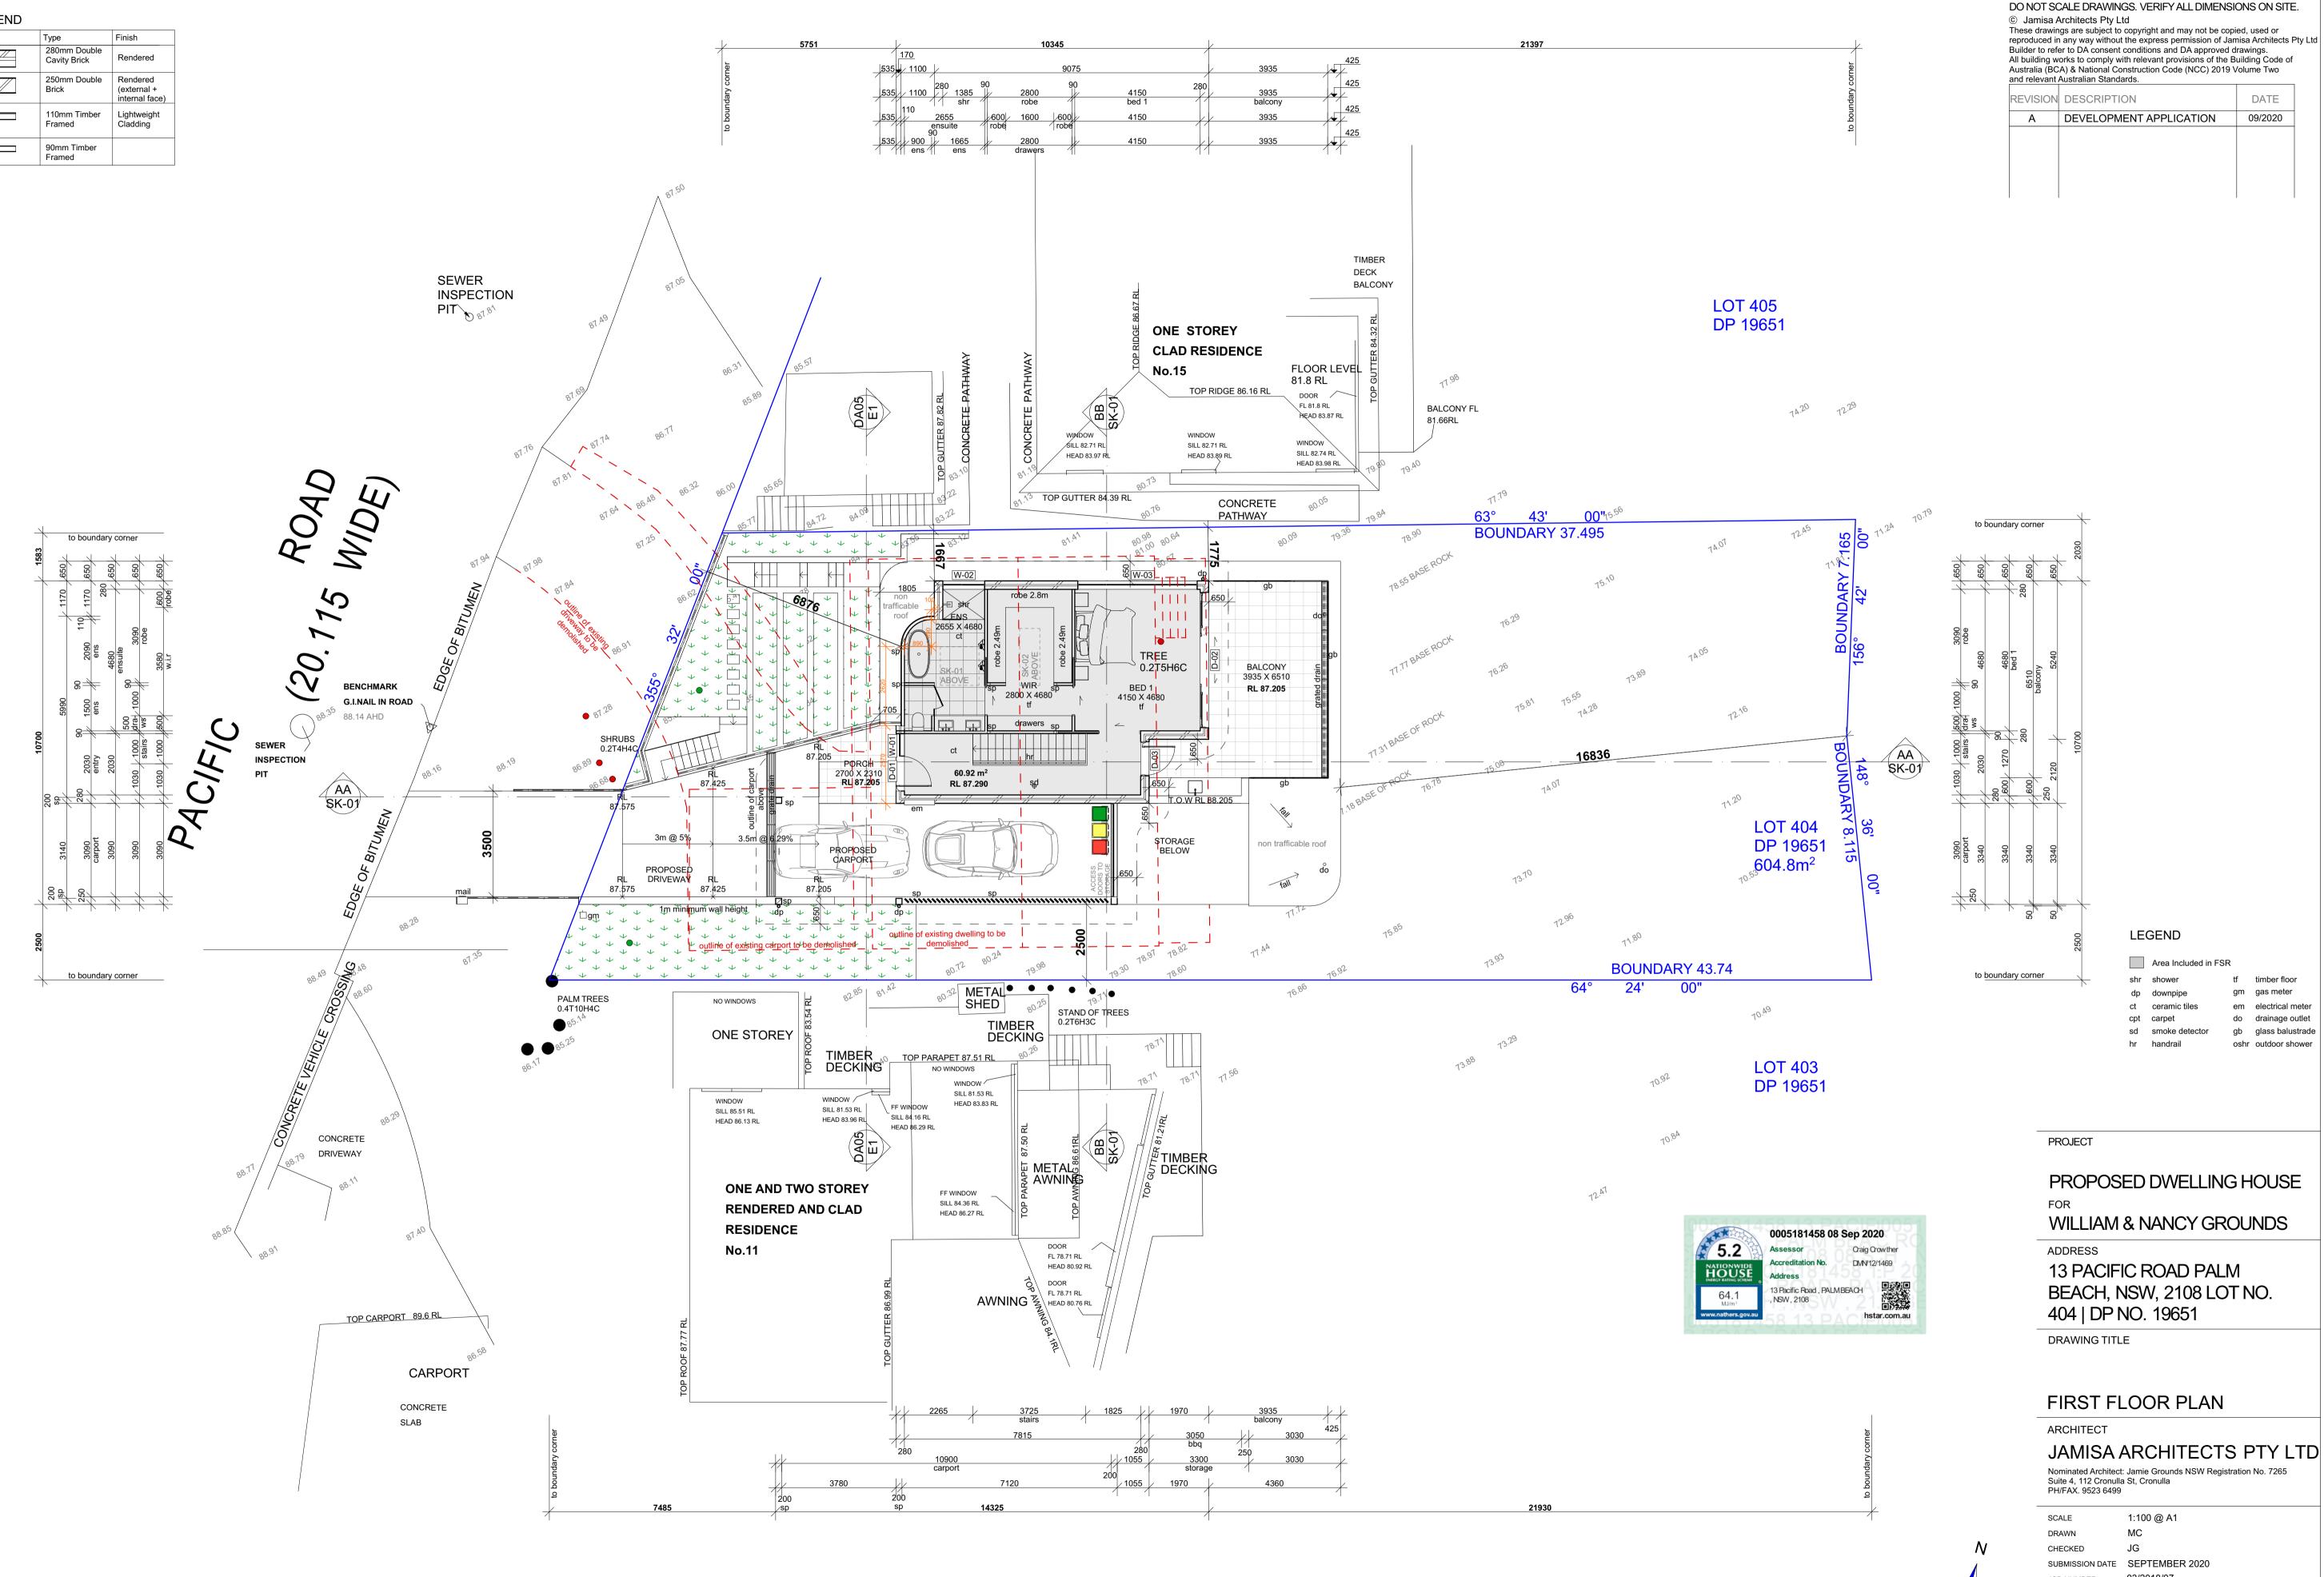

FIRST FLOOR PLAN SCALE 1:100




03/2018/07 JOB NUMBER

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DA04

DRAWING NUMBER



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REVISION DESCRIPTION DATE						
	А	DEVELOPMENT APPLICATION	09/2020			
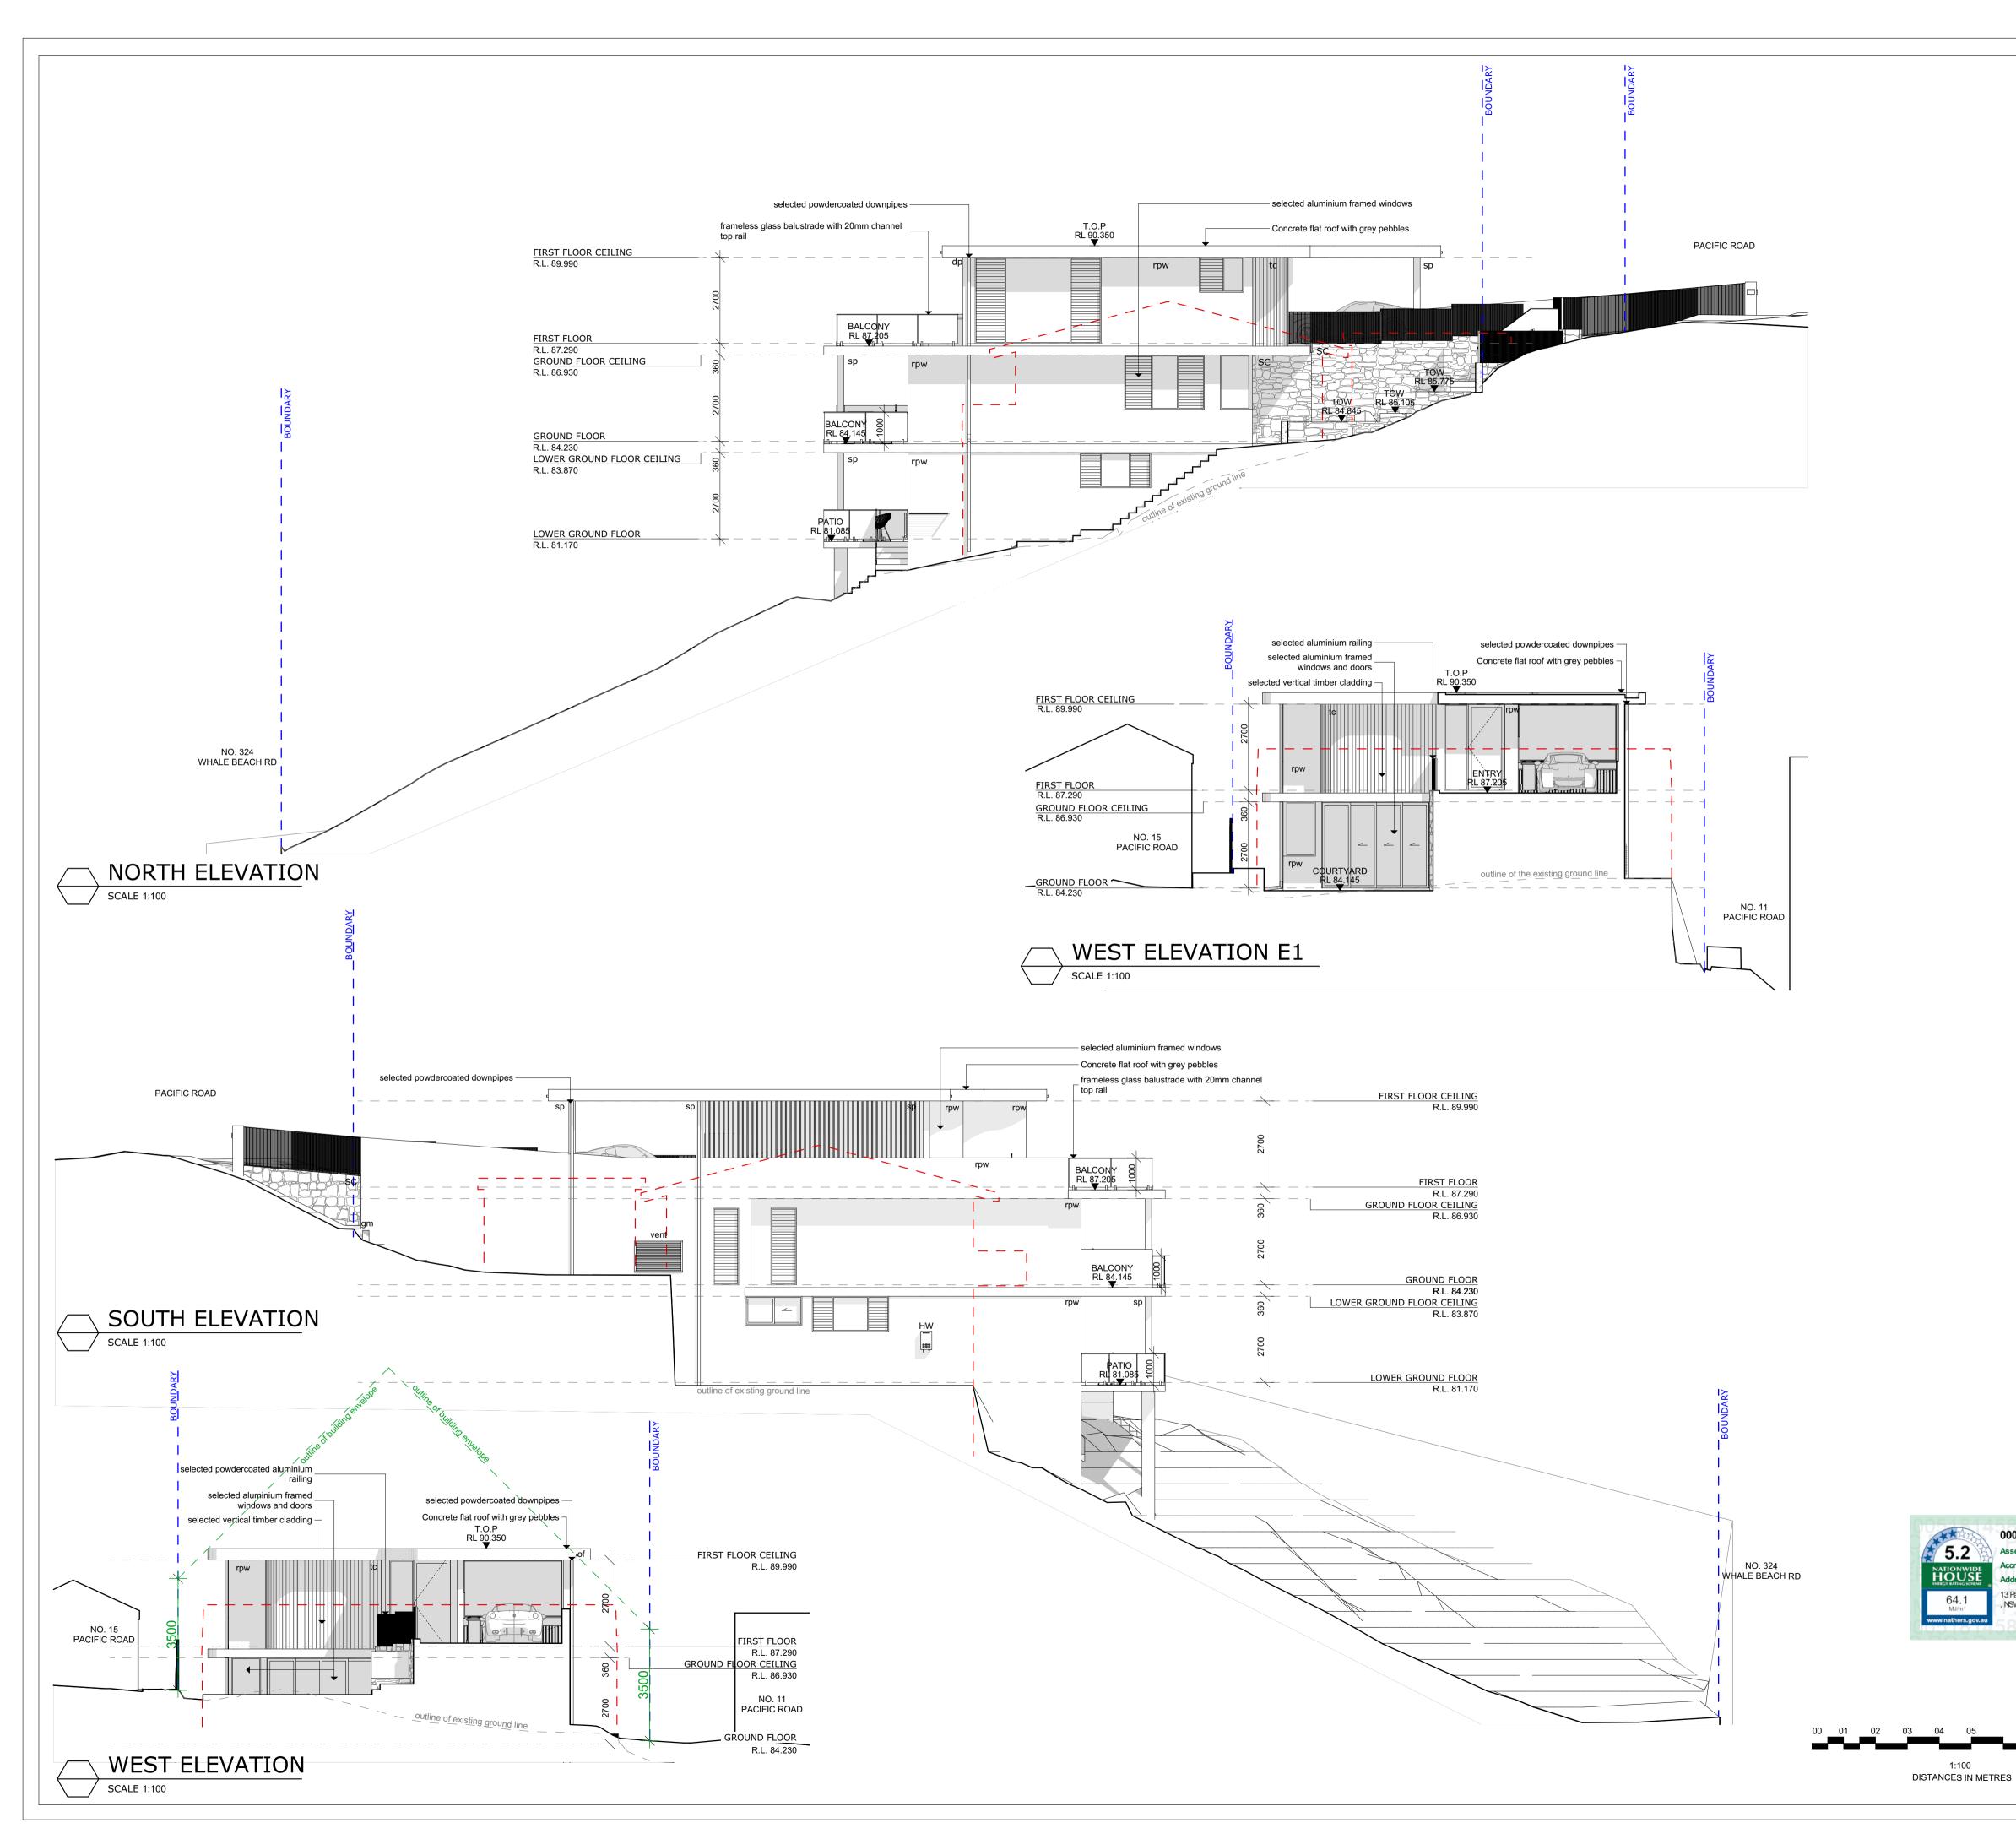
#### LEGEND

### of overflow

#### dp downpipe tc timber cladding

- T.O.P top of parapet
- rpw rendered & painted masonry wall
- hw hot water system
- em elec. meter
- gm gas meter
- outline of existing buildings to be demolished
- SC stone cladding

### PROJECT

### PROPOSED DWELLING HOUSE FOR

## WILLIAM & NANCY GROUNDS

ADDRESS 13 PACIFIC ROAD PALM BEACH, NSW, 2108 LOT NO. 404 | DP NO. 19651

DRAWING TITLE

## ELEVATIONS

### ARCHITECT

# JAMISA ARCHITECTS PTY LTD Nominated Architect: Jamie Grounds NSW Registration No. 7265 Suite 4, 112 Cronulla St, Cronulla PH/FAX. 9523 6499

1:100 @ A1 SCALE MC DRAWN JG CHECKED

SUBMISSION DATE SEPTEMBER 2020 03/2018/07 JOB NUMBER


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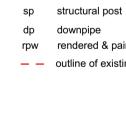
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1:100 DISTANCES IN METRES

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	А	DEVELOPMENT APPLICATION	09/2020		

LEGEND of overflow

rpw rendered & painted masonry wall – outline of existing buildings to be demolished

0005181458 08 Sep 2020

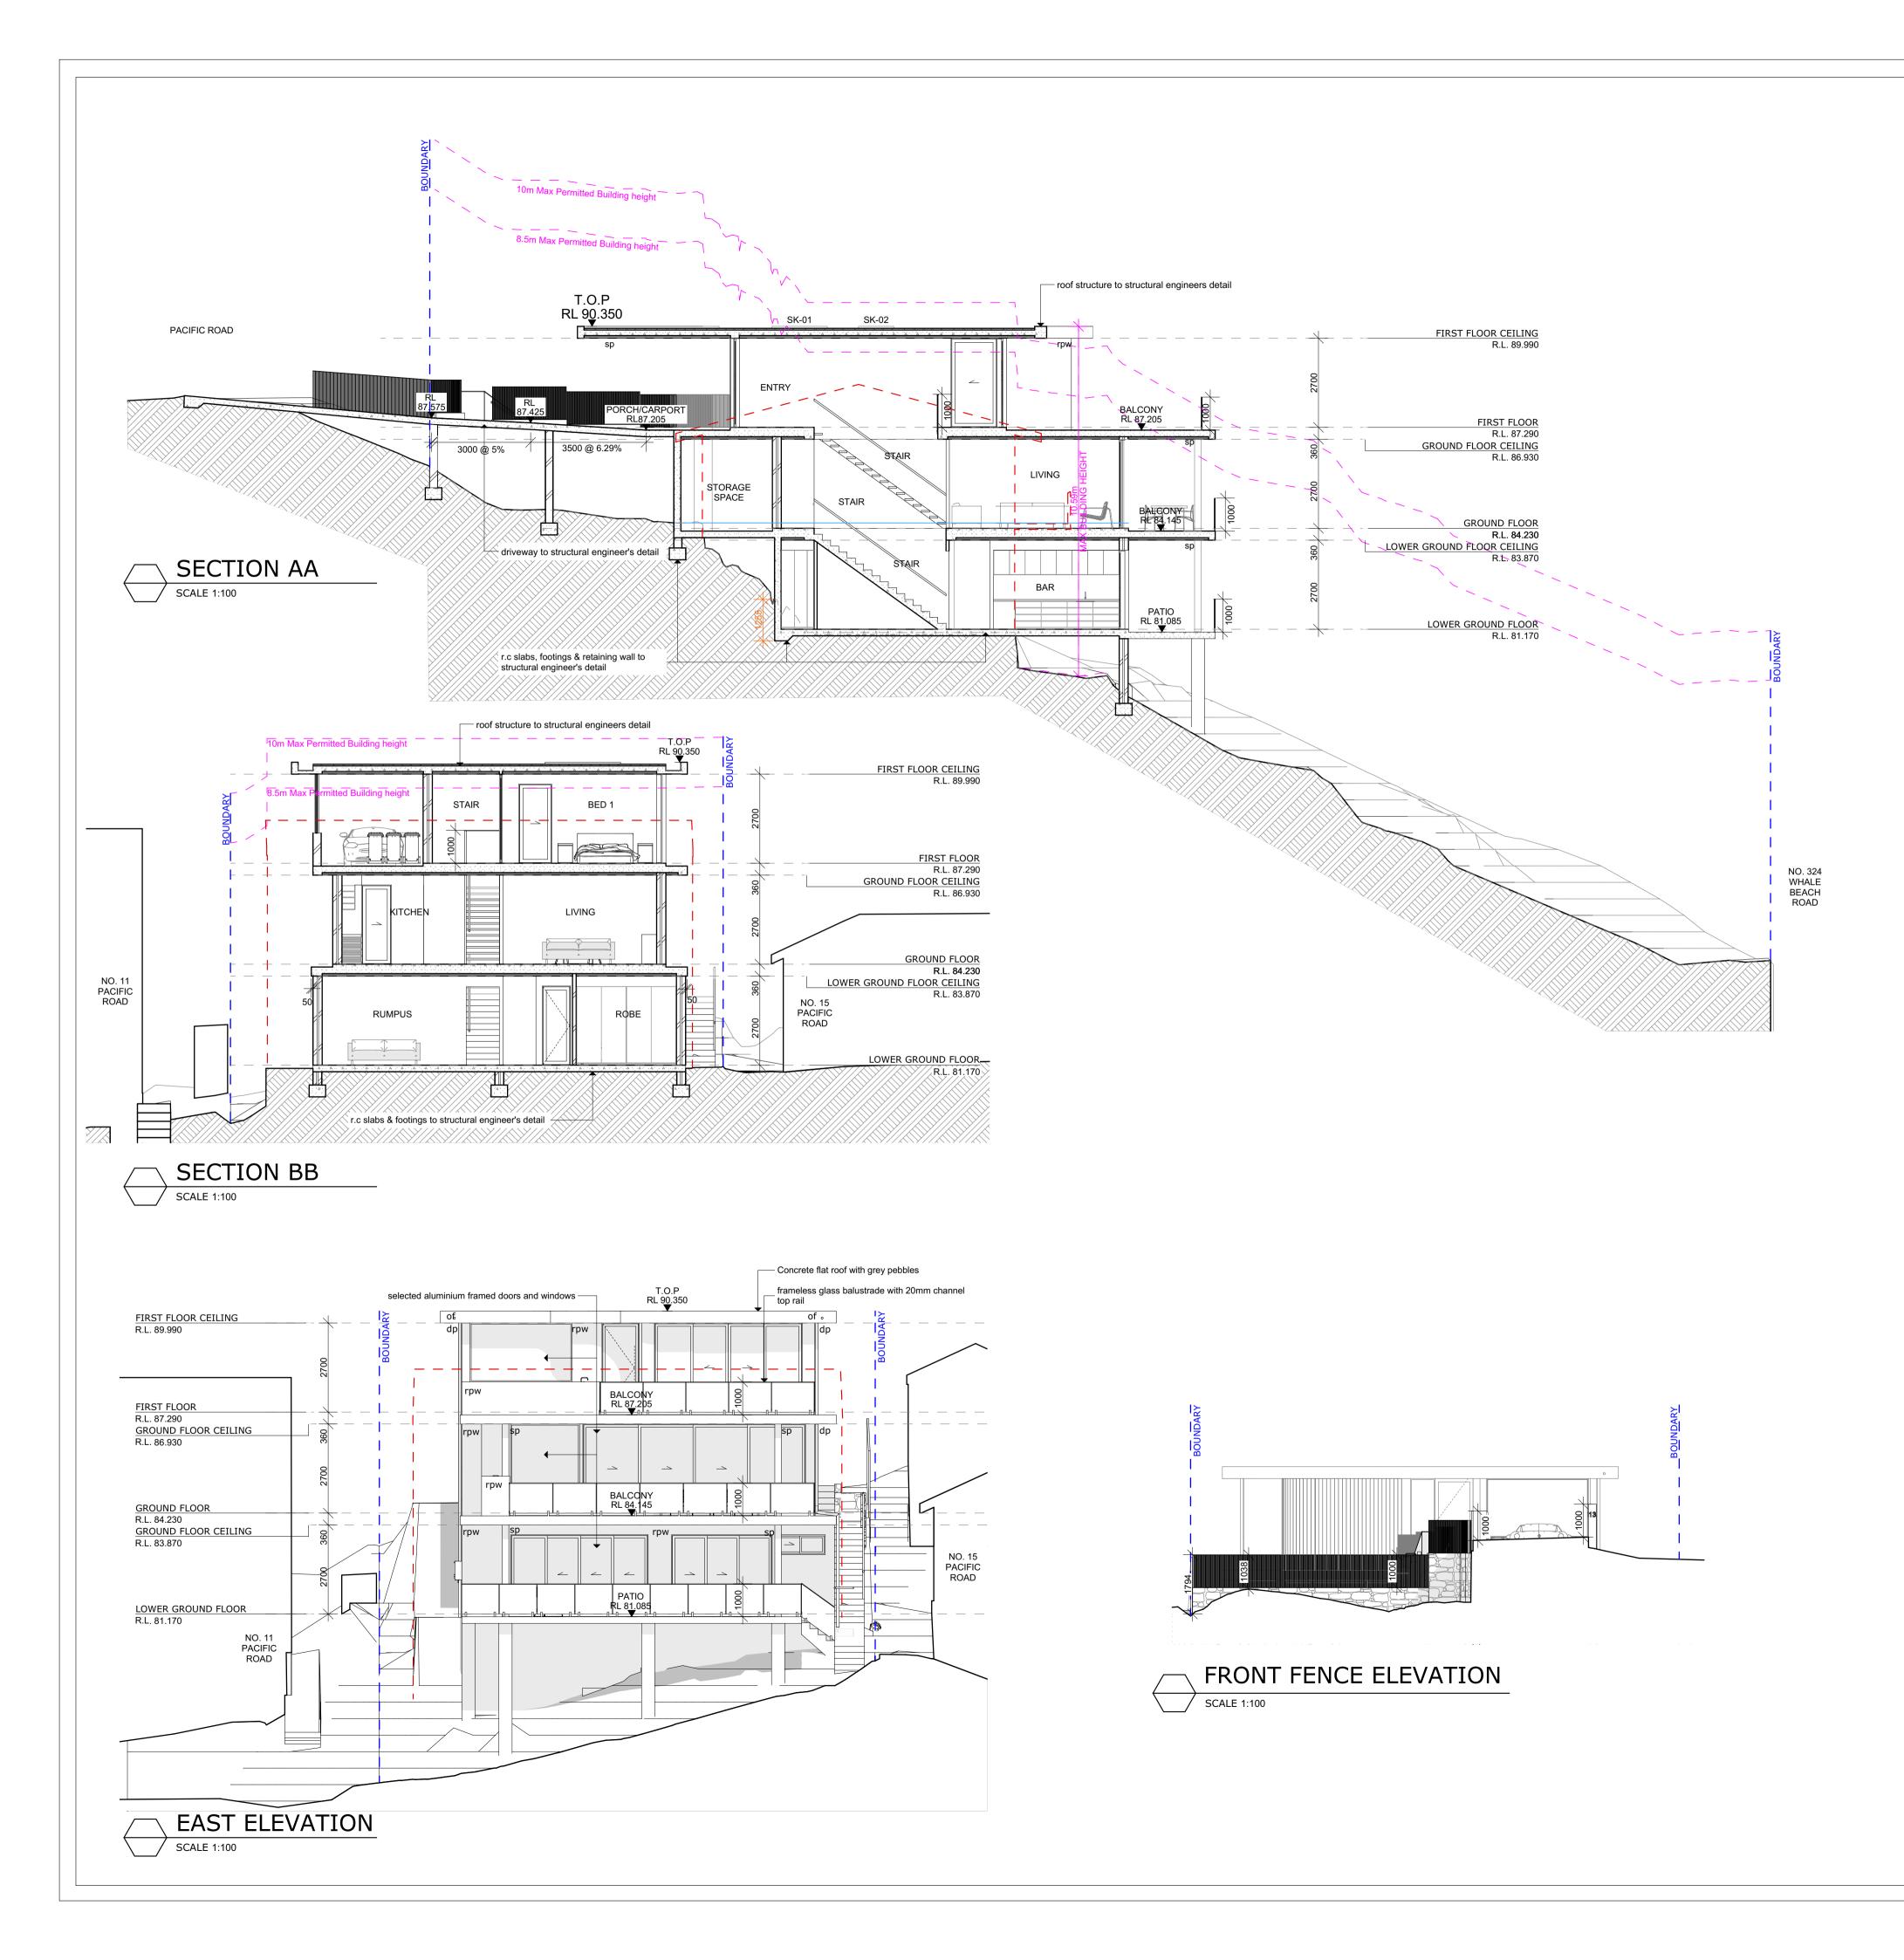13 Pacific Road , PALM BEACH

Assessor

Address

, NSW, 2108

Accreditation No.

Oraig Orow ther

DMN/12/1469

hstar.com.au

### ADDRESS 13 PACIFIC ROAD PALM BEACH, NSW, 2108 LOT NO. 404 | DP NO. 19651 DRAWING TITLE SECTIONS ARCHITECT JAMISA ARCHITECTS PTY LTD Nominated Architect: Jamie Grounds NSW Registration No. 7265 Suite 4, 112 Cronulla St, Cronulla PH/FAX. 9523 6499 1:100 @ A1 SCALE MC DRAWN JG CHECKED SUBMISSION DATE SEPTEMBER 2020 03/2018/07 JOB NUMBER DRAWING NUMBER ISSUE DA06 Α

PROPOSED DWELLING HOUSE

WILLIAM & NANCY GROUNDS

PROJECT

FOR



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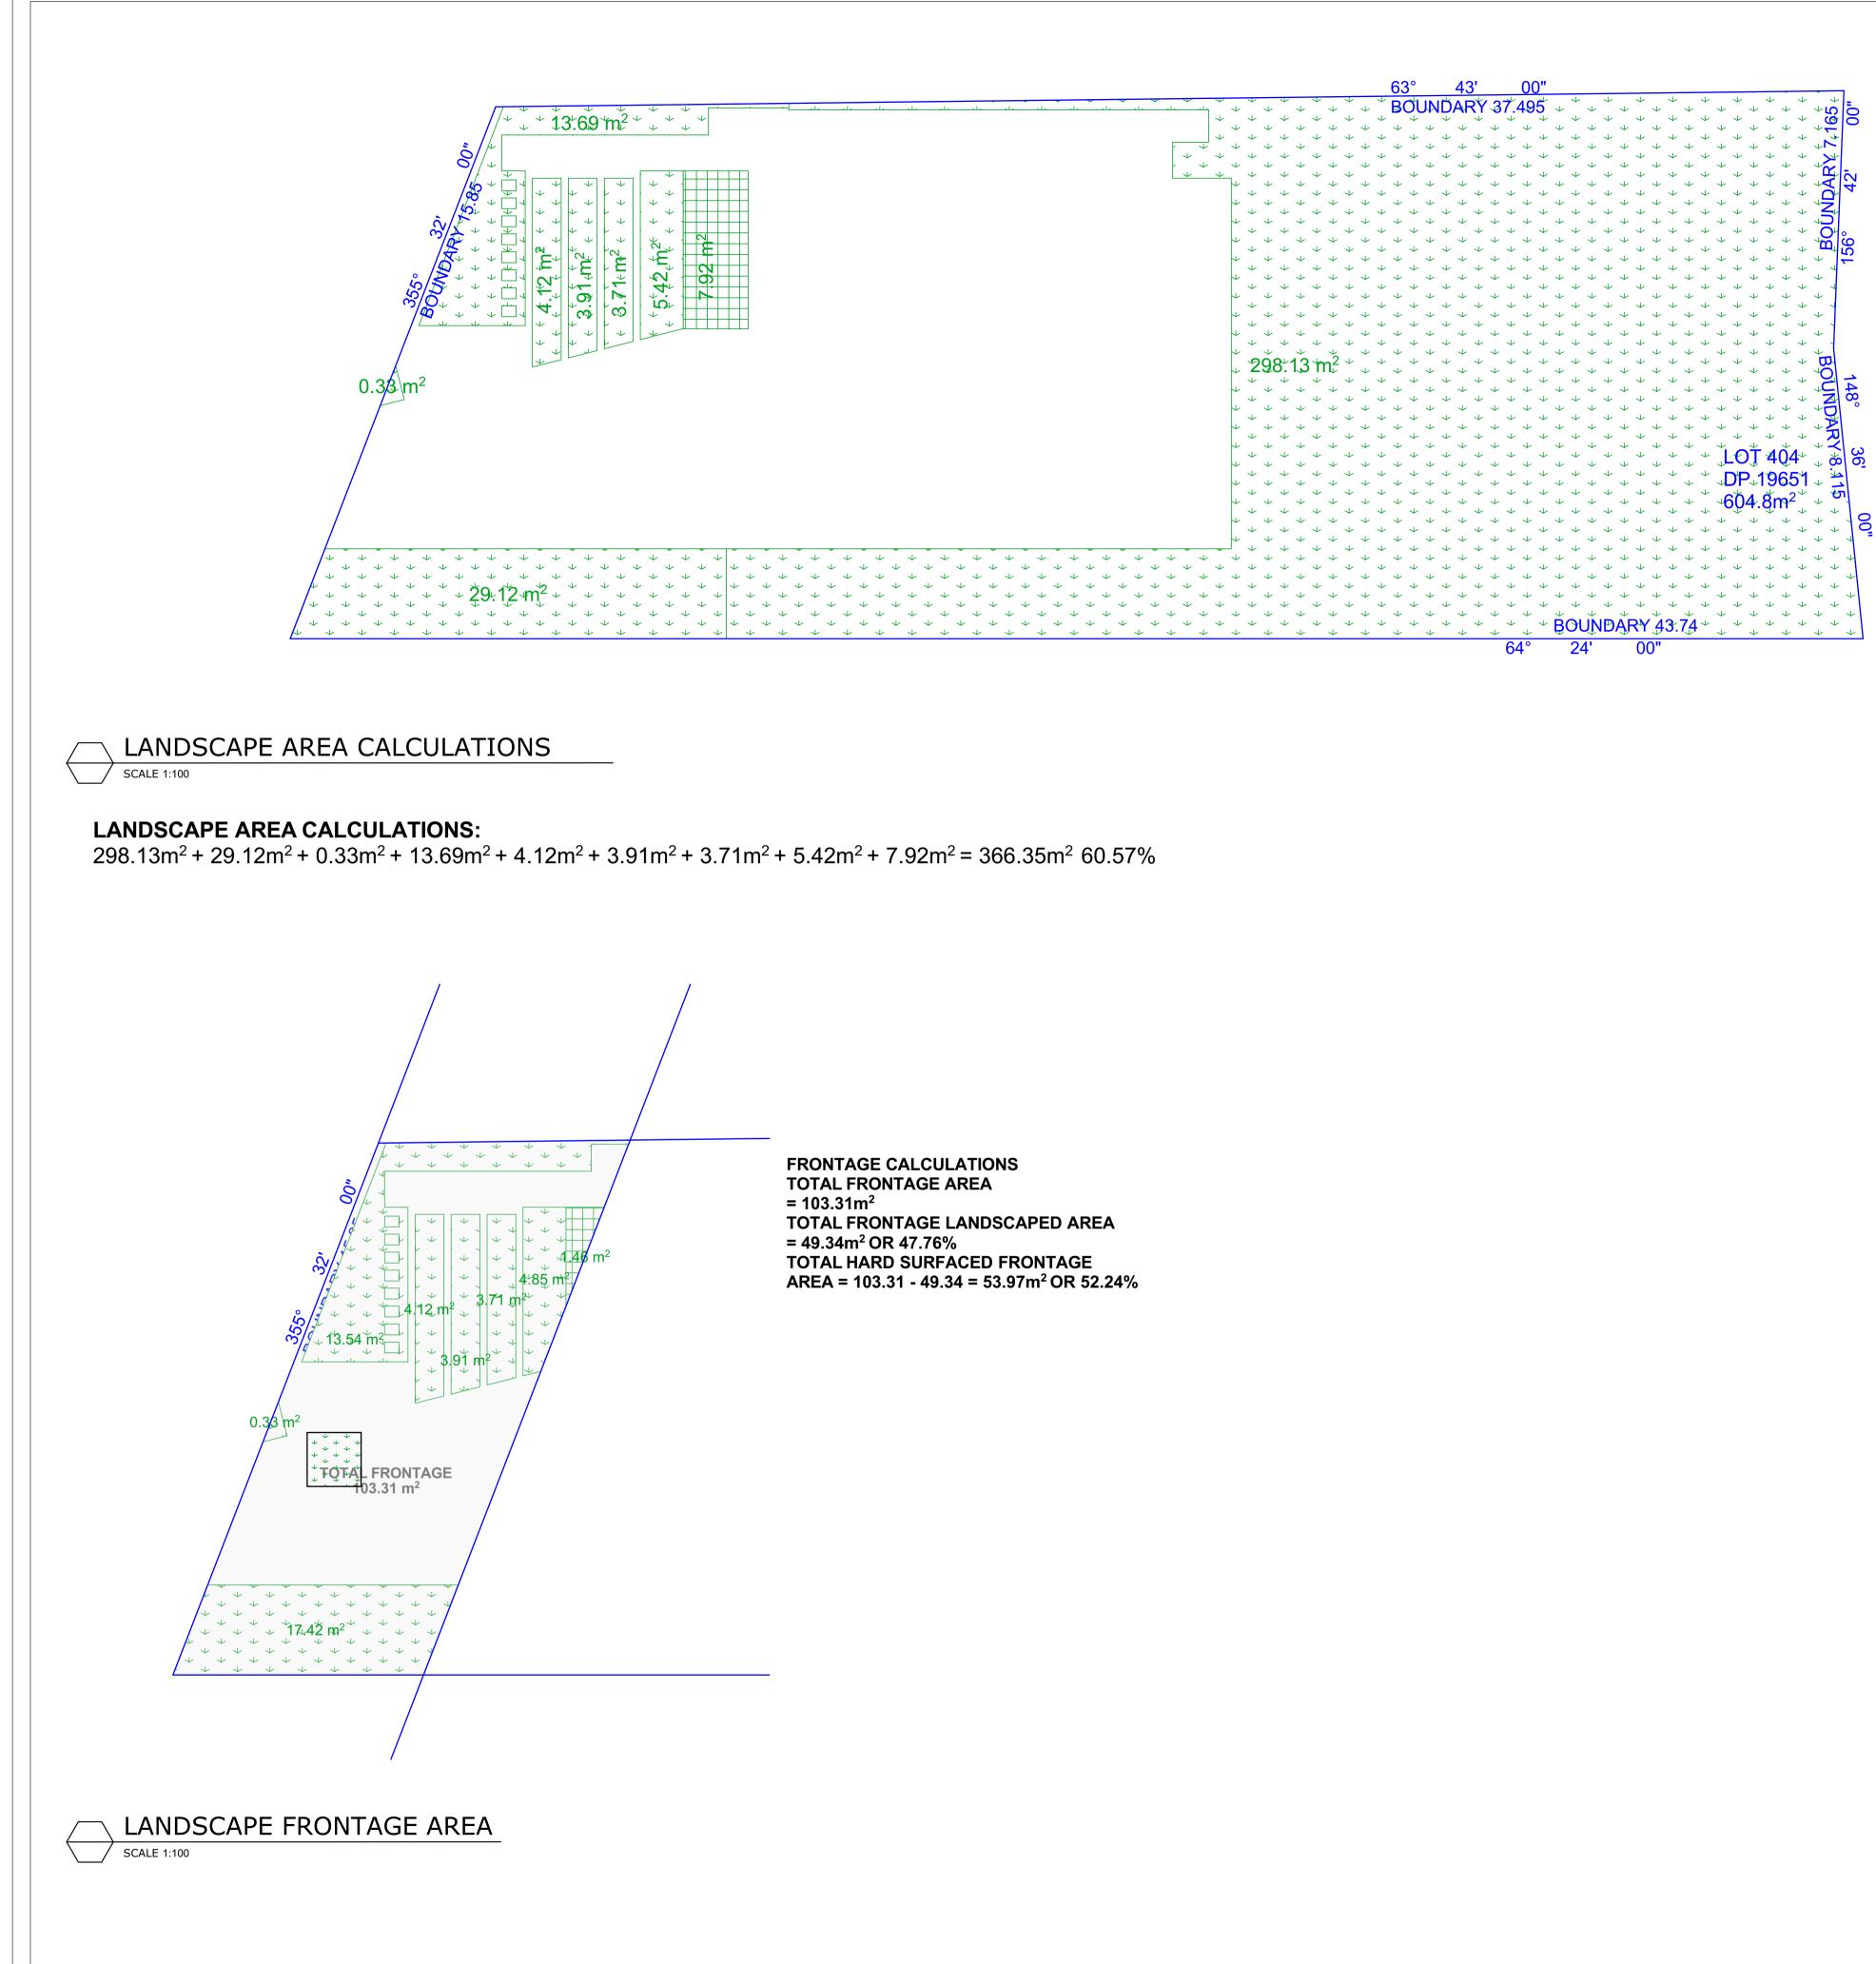
### LEGEND


Silt Fence RACT SAND

**Gravel Access** Stockpiles Geotextile Fabric filled with Gravel emporary Fencing Rainwater tank outline of demolition 240L Garden Waste Bin 240L Mobile Recycling Bin 120L Mobile Waste Bin

Area of Excavation

PROJECT					
PROJECT	FROJECT				
PROPOS	ED DWELLING HO	JSE			
FOR					
WILLIAM	& NANCY GROUNE	DS			
ADDRESS					
13 PACIF	IC ROAD PALM				
BEACH, N	NSW, 2108 LOT NO	-			
404   DP N	NO. 19651				
DRAWING TITL	E				
DEMO/E	XCAVATION/WAS	TE			
MNGT/E	ROS SEDIMENT	CNTL			
PLAN					
ARCHITECT					
JAMISA /	ARCHITECTS PT	Y LTD			
Nominated Architect Suite 4, 112 Cronulla PH/FAX. 9523 6499	: Jamie Grounds NSW Registration No. a St, Cronulla	7265			
SCALE	1:100 @ A1				
DRAWN	MC				
CHECKED SUBMISSION DATE	JG SEPTEMBER 2020				
JOB NUMBER	03/2018/07				
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	Australia (BCA) & National Construction Code (NCC) 2019 Volume Two and relevant Australian Standards.				
REVISION	DESCRIPTION	DATE			
Α	DEVELOPMENT APPLICATION	09/2020			

LEGEND

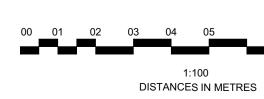PERVIOUS LANDSCAPE

IMPERVIOUS LANDSCAPE incl in area calculations (max 6% of site)

PROJECT

### PROPOSED DWELLING HOUSE FOR

# WILLIAM & NANCY GROUNDS

ADDRESS 13 PACIFIC ROAD PALM BEACH, NSW, 2108 LOT NO. 404 | DP NO. 19651

DRAWING TITLE

### LANDSCAPE AREA CALCULATIONS

# ARCHITECT

JAMISA ARCHITECTS PTY LTD Nominated Architect: Jamie Grounds NSW Registration No. 7265 Suite 4, 112 Cronulla St, Cronulla PH/FAX. 9523 6499

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DA08

MC JG SUBMISSION DATE SEPTEMBER 2020 JOB NUMBER 03/2018/07

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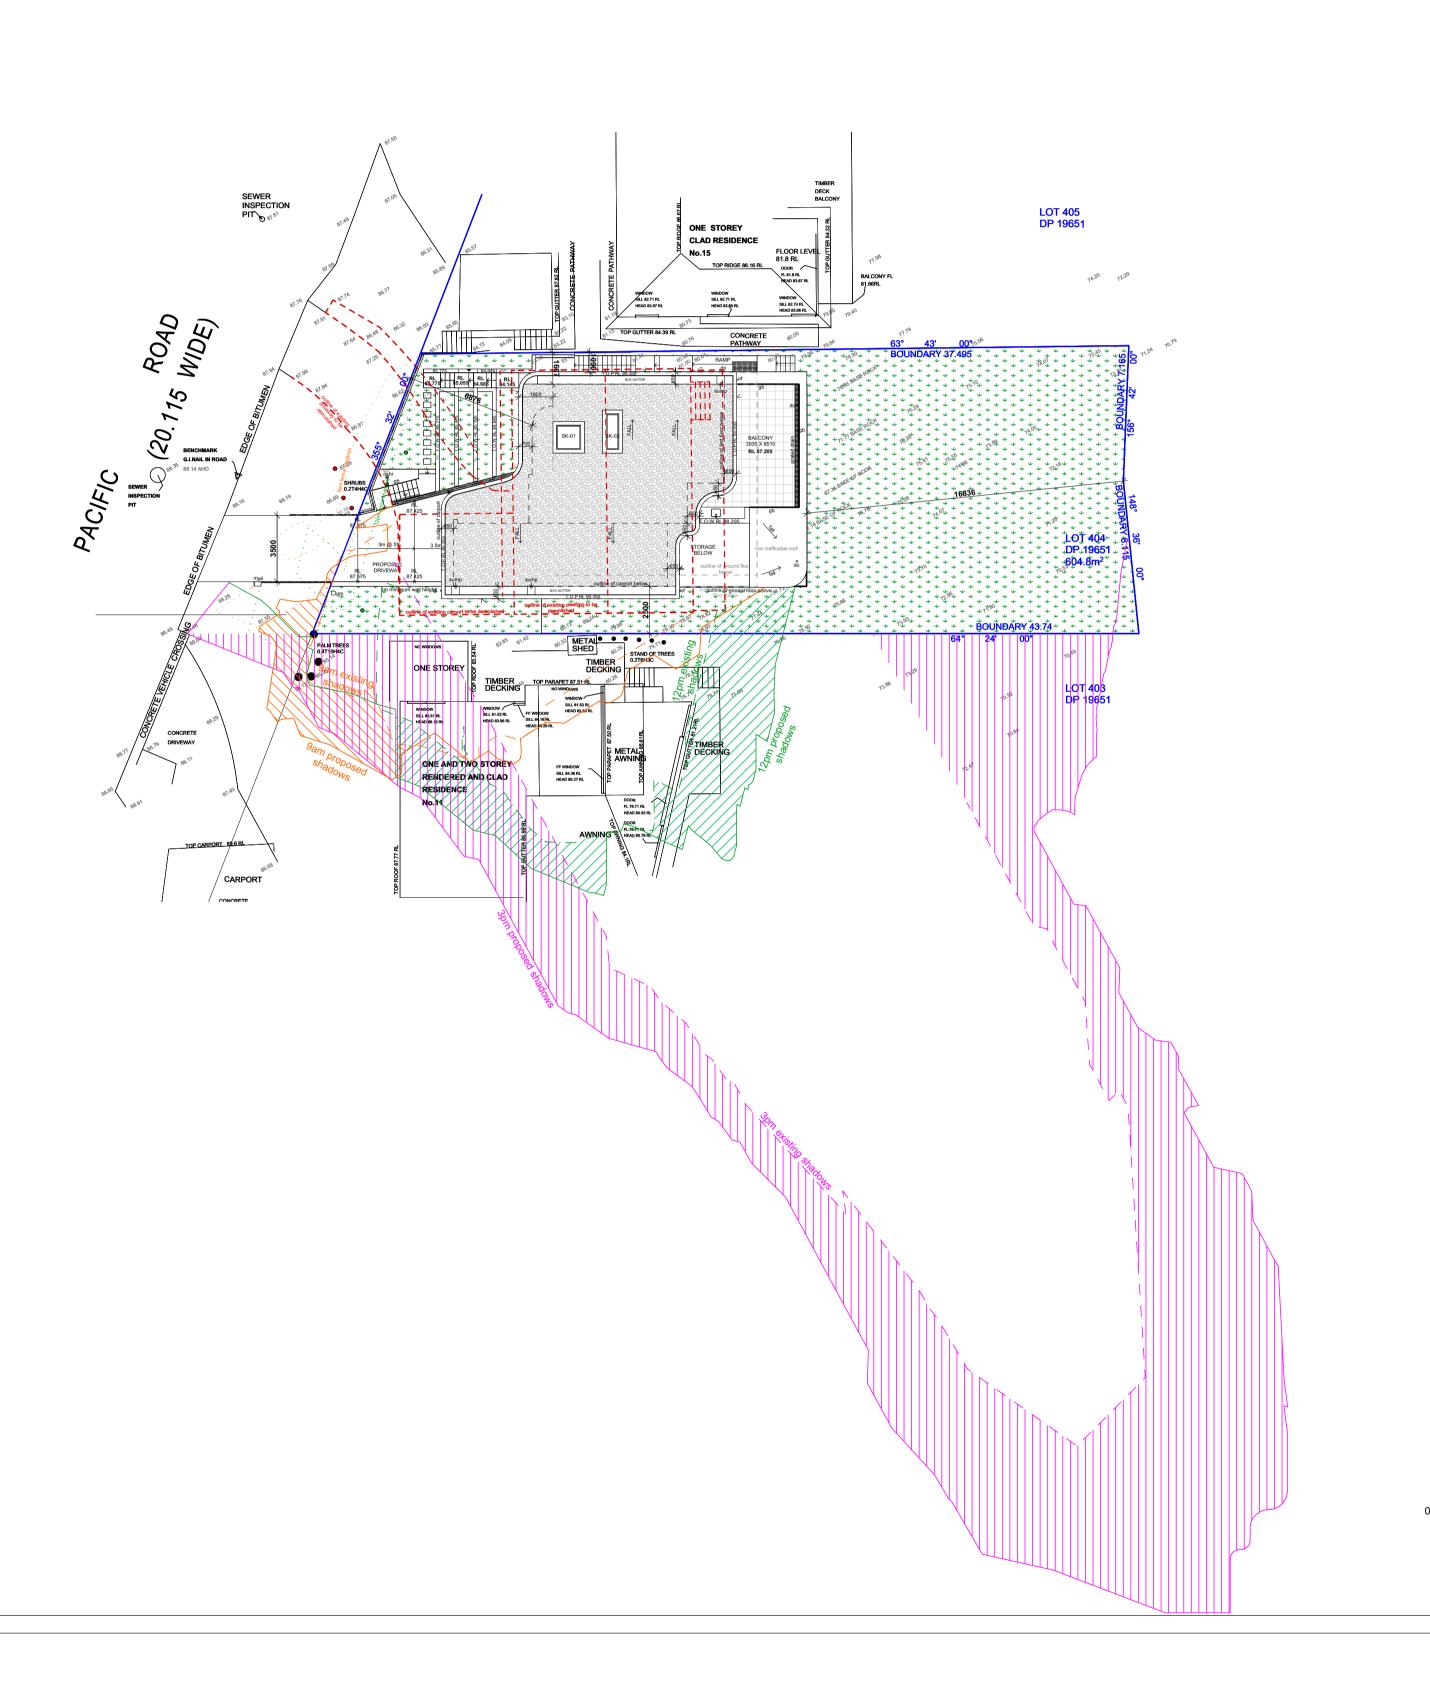
Existing overshadowing on No.11 Pacific Road



Proposed overshadowing on No.11 Pacific Road



June 21st - 12pm Existing overshadowing on No.11 Pacific Road



### LEGEND

∃ = = = Existing shadows

Proposed shadows

Fence shadows

Extent of additional overshadowing on adjoining properties due to proposed development at 9:00am on June 21<sup>st</sup>

Extent of additional overshadowing on adjoining properties due to proposed development at 12:00pm on June 21st


Extent of additional overshadowing on adjoining properties due to proposed development at 3:00pm on June 21<sup>st</sup>  $\nabla \nabla$  $\overline{777}$ 

Extent of additional sunlight on adjoining properties due to proposed development on June 21<sup>st</sup>

## SHADOW DIAGRAMS - JUNE 21<sup>st</sup>

1:200 SCALE



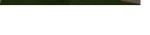



Proposed overshadowing on No.9 Pacific Road



June 21st - 3pm Existing overshadowing on No.11 Pacific Road



June 21st - 3pm Proposed overshadowing on No.11 Pacific Road

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Builder to refer to DA consent conditions and DA approved drawings. All building works to comply with relevant provisions of the Building Code of Australia (BCA) & National Construction Code (NCC) 2019 Volume Two and relevant Australian Standards.					
REVISION	DESCRIPTION	DATE			
Α	DEVELOPMENT APPLICATION	09/2020			

### PROJECT PROPOSED DWELLING HOUSE FOR WILLIAM & NANCY GROUNDS ADDRESS 13 PACIFIC ROAD PALM BEACH, NSW, 2108 LOT NO. 404 | DP NO. 19651 DRAWING TITLE SHADOWS DIAGRAMS JUNE 21 ARCHITECT JAMISA ARCHITECTS PTY LTD Nominated Architect: Jamie Grounds NSW Registration No. 7265 Suite 4, 112 Cronulla St, Cronulla PH/FAX. 9523 6499 1:200 @ A1 SCALE MC DRAWN

1:200 DISTANCES IN METRES




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ISSUE

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DA09

DRAWING NUMBER




REVISION	DESCRIPTION	DATE
А	DEVELOPMENT APPLICATION	09/2020

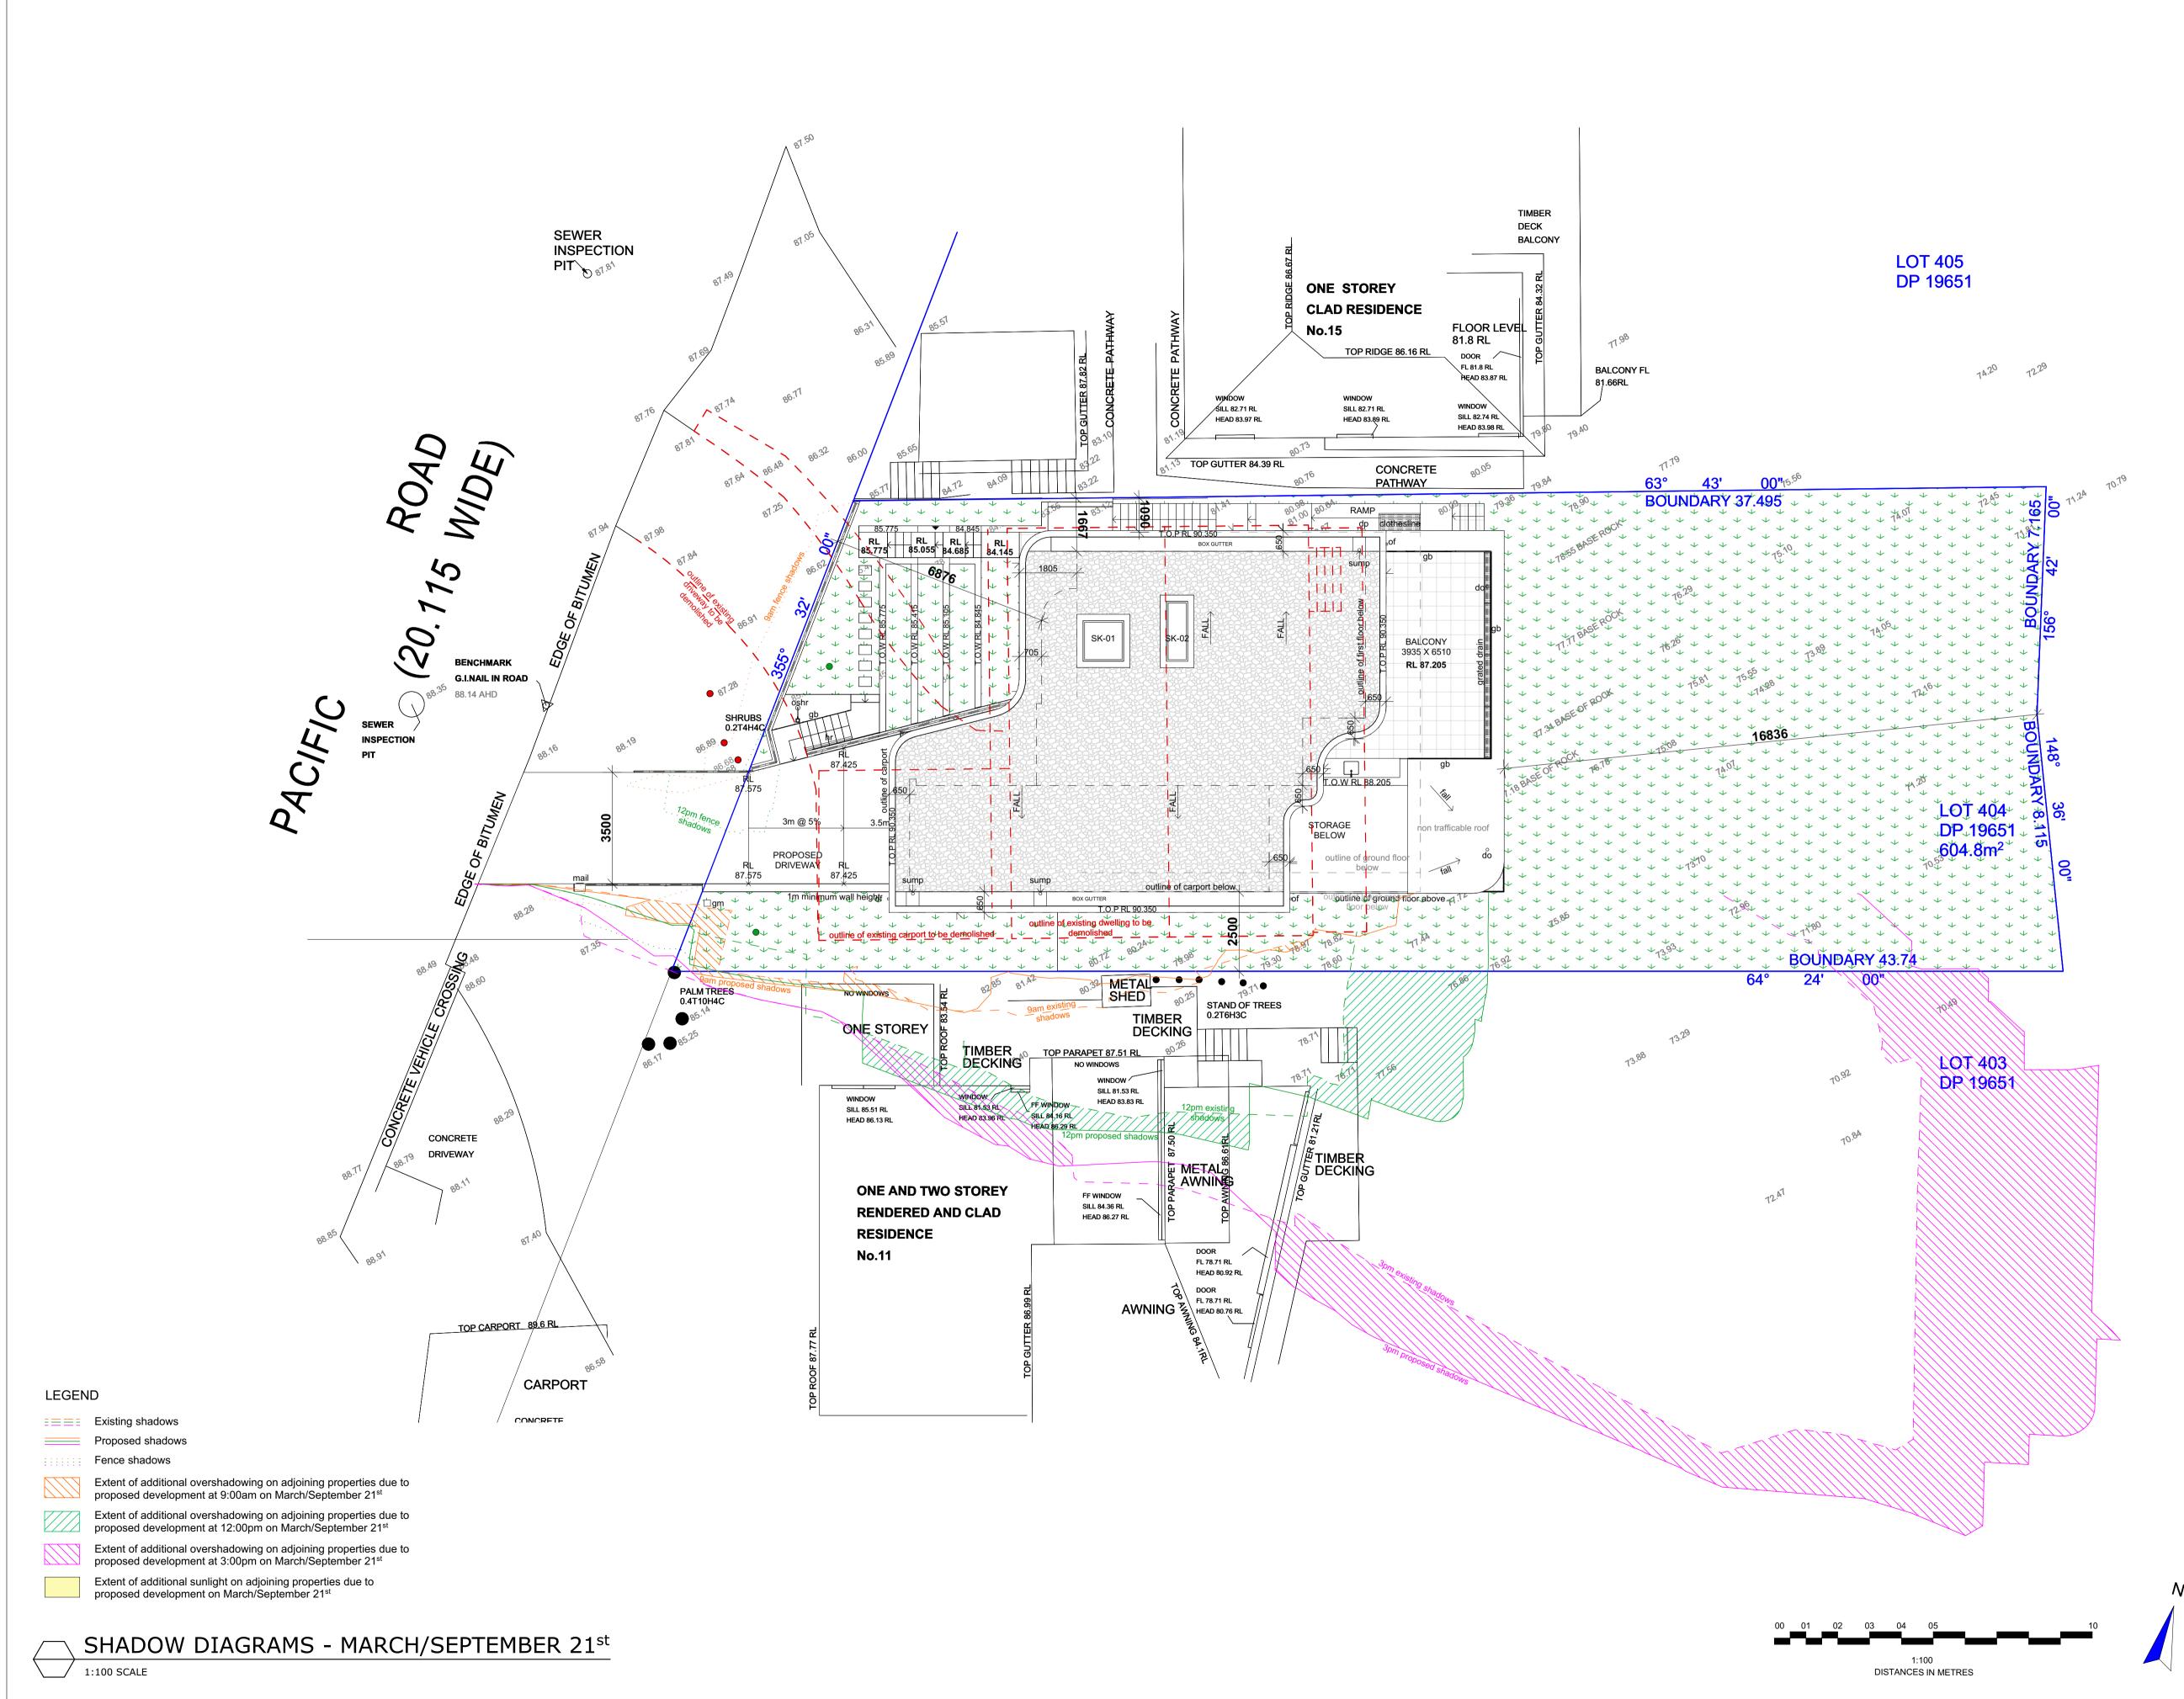
PROJECT		
PROPOS	ED DWELLING HOU	SE
FOR		
WILLIAM	& NANCY GROUND	S
ADDRESS		
13 PACIE	IC ROAD PALM	
	NSW, 2108 LOT NO.	
	,	
404   DP I	NO. 19651	
DRAWING TITL	V DIAGRAMS	
DRAWING TITL SHADOV MARCH/	_	
DRAWING TITL SHADOV MARCH/ ARCHITECT	V DIAGRAMS SEPTEMBER 21	
DRAWING TITL SHADOV MARCH/ ARCHITECT JAMISA	V DIAGRAMS SEPTEMBER 21 ARCHITECTS PTY : Jamie Grounds NSW Registration No. 72 a St, Cronulla	
DRAWING TITL SHADOV MARCH/ ARCHITECT JAMISA / Nominated Architect Suite 4, 112 Cronulla	V DIAGRAMS SEPTEMBER 21 ARCHITECTS PTY : Jamie Grounds NSW Registration No. 72 a St, Cronulla	
DRAWING TITL SHADOV MARCH/ ARCHITECT JAMISA Nominated Architect Suite 4, 112 Cronulla PH/FAX. 9523 6499	V DIAGRAMS SEPTEMBER 21 ARCHITECTS PTY :: Jamie Grounds NSW Registration No. 72 a St, Cronulla	
DRAWING TITL SHADOV MARCH/ ARCHITECT JAMISA / Nominated Architect Suite 4, 112 Cronulla PH/FAX. 9523 6499	V DIAGRAMS SEPTEMBER 21 ARCHITECTS PTY : Jamie Grounds NSW Registration No. 72 a St, Cronulla	
DRAWING TITL SHADOV MARCH/ ARCHITECT JAMISA / Nominated Architect Suite 4, 112 Cronulla PH/FAX. 9523 6499 SCALE DRAWN CHECKED SUBMISSION DATE	V DIAGRAMS SEPTEMBER 21 ARCHITECTS PTY : Jamie Grounds NSW Registration No. 72 a St, Cronulla 1:100 @ A1 MC JG SEPTEMBER 2020	
DRAWING TITL SHADOV MARCH/ ARCHITECT JAMISA / Nominated Architect Suite 4, 112 Cronulla PH/FAX. 9523 6499 SCALE DRAWN CHECKED	V DIAGRAMS SEPTEMBER 21 ARCHITECTS PTY : Jamie Grounds NSW Registration No. 72 a St, Cronulla	
DRAWING TITL SHADOV MARCH/ ARCHITECT JAMISA Nominated Architect Suite 4, 112 Cronulla PH/FAX. 9523 6499 SCALE DRAWN CHECKED SUBMISSION DATE	V DIAGRAMS SEPTEMBER 21 ARCHITECTS PTY : Jamie Grounds NSW Registration No. 72 a St, Cronulla 1:100 @ A1 MC JG SEPTEMBER 2020 03/2018/07	

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DA10

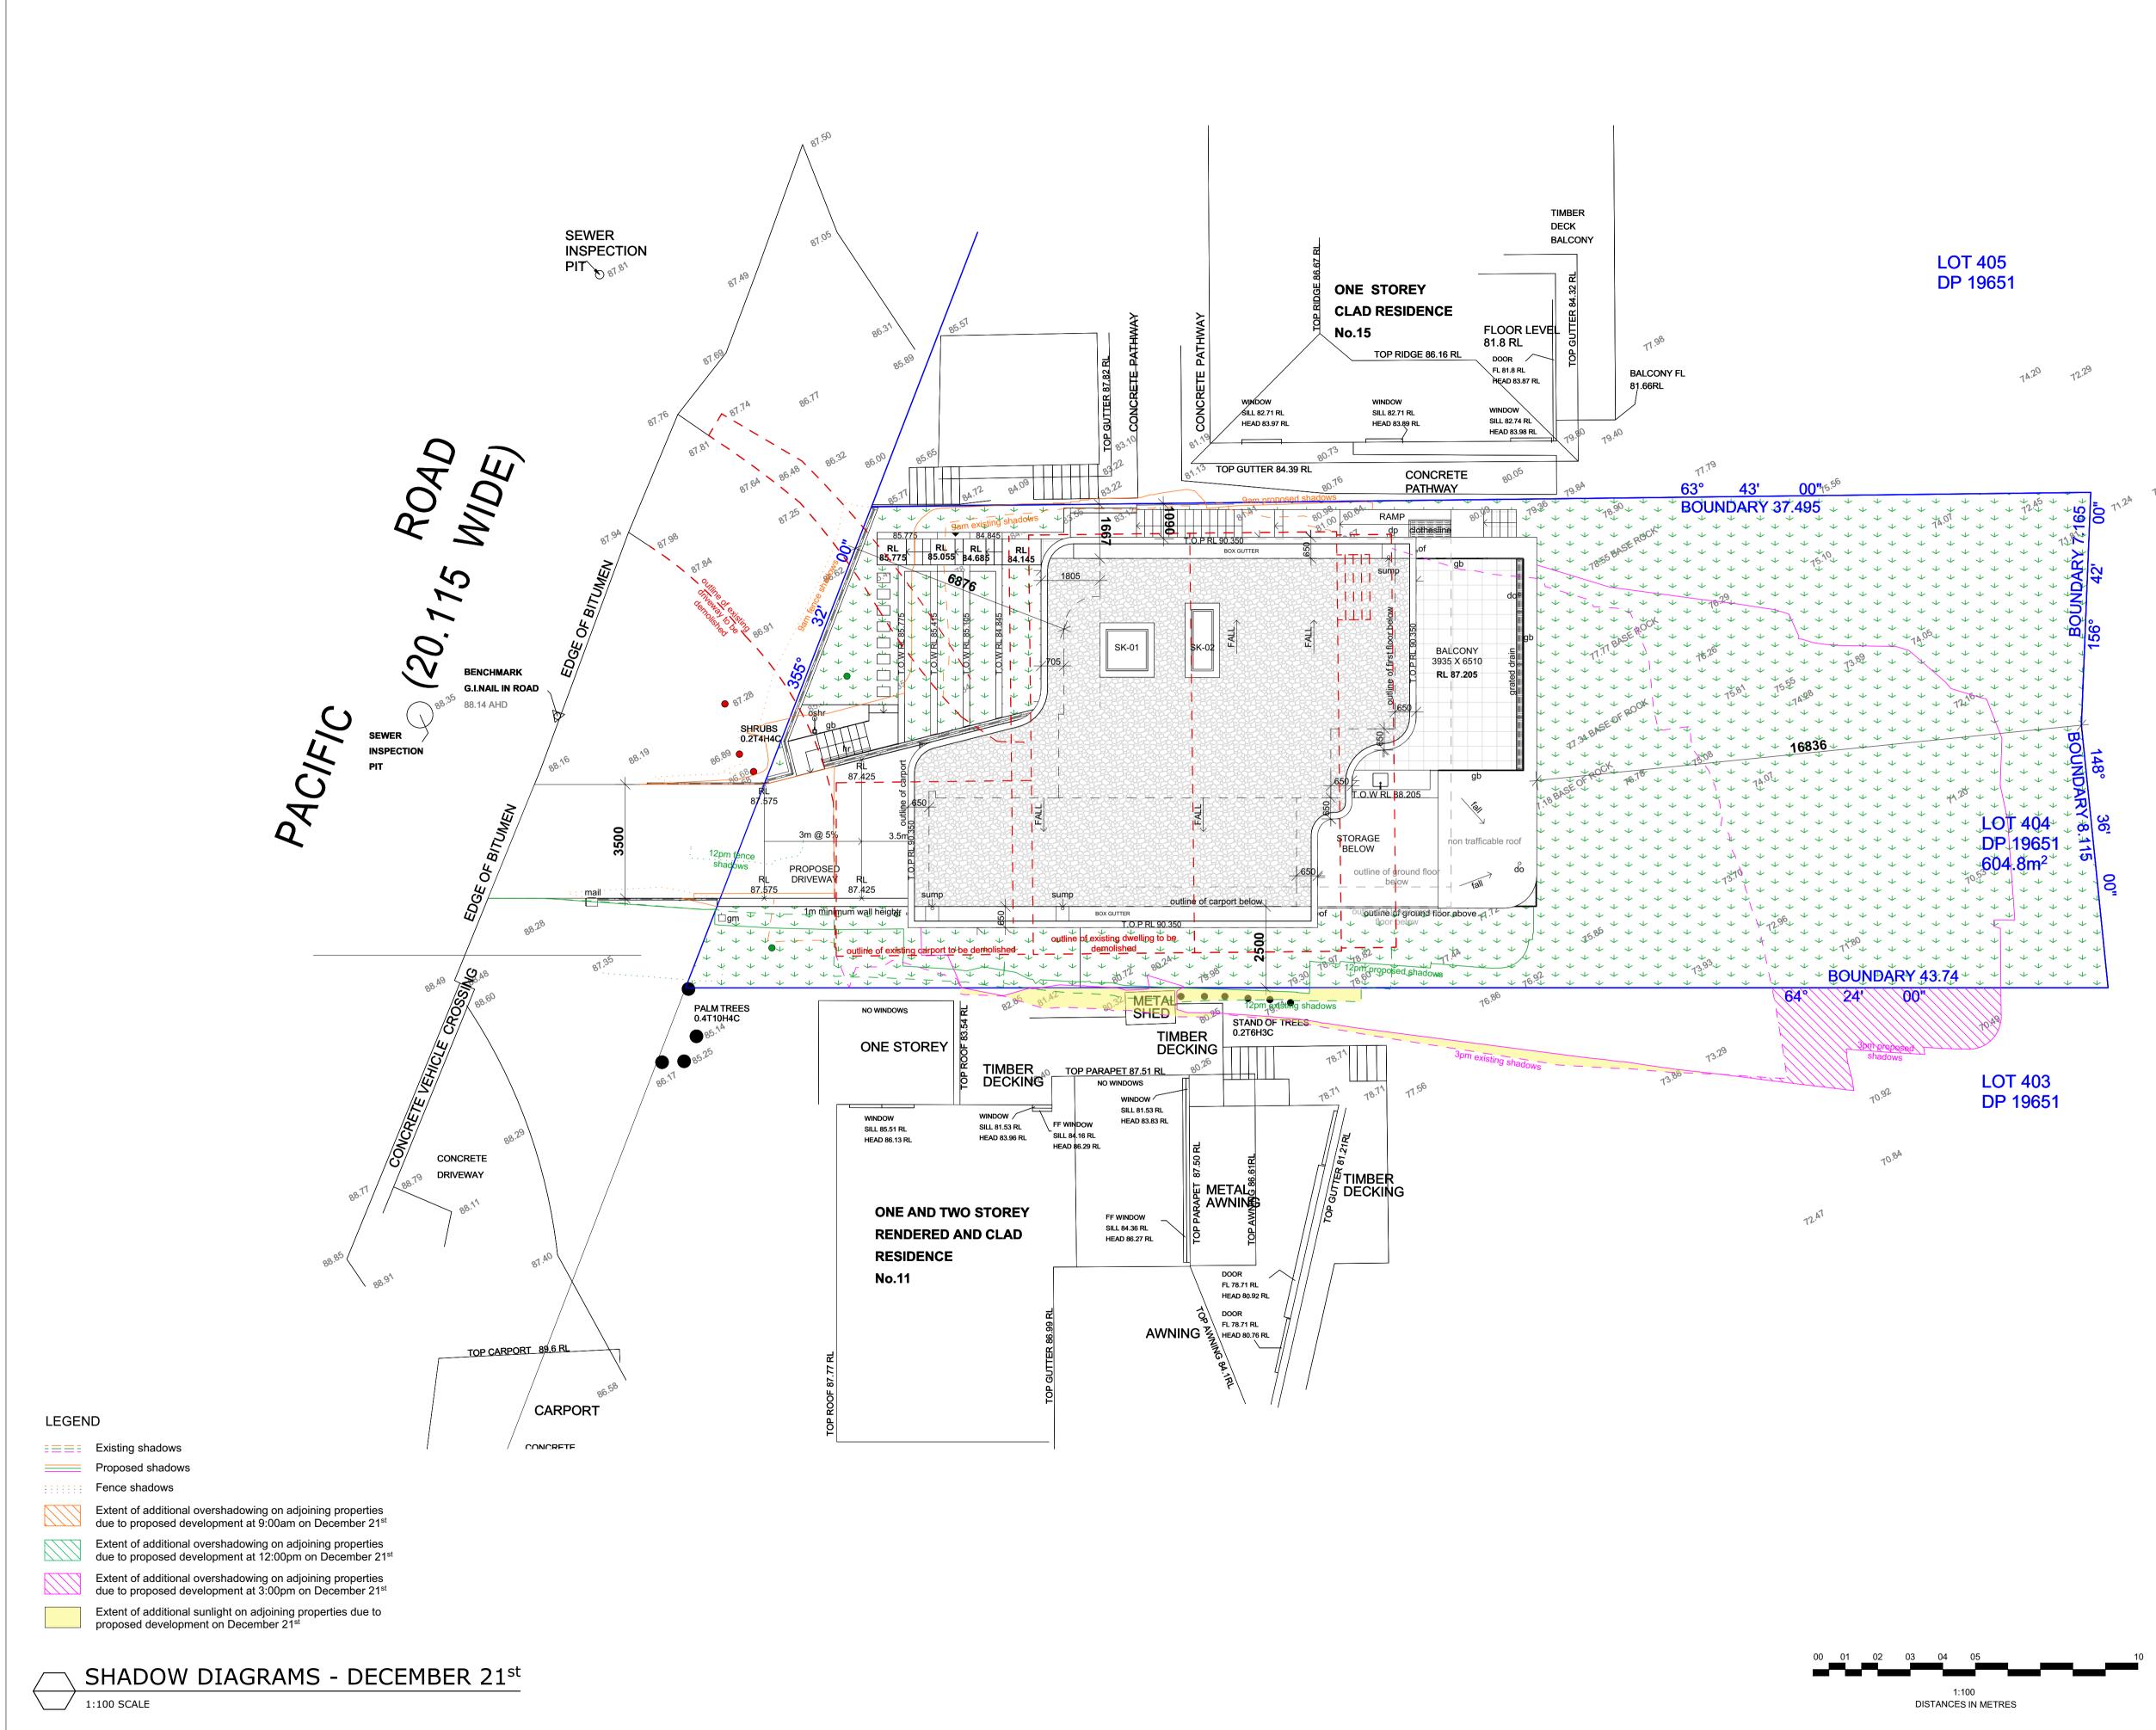

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	DESCRIPTION	
		DATE
A	DEVELOPMENT APPLICATION	09/2020



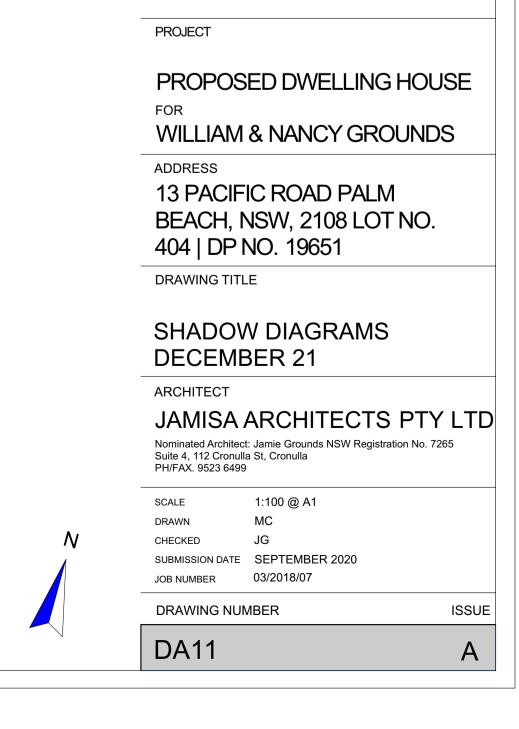



Stone Clad Wall Colour: Eco Outdoor Freeform 'Wamberal' — Dulux Powdercoat-'Black Matt' Eco Outdoor freeform stone wall Colour: 'Wamberal' Eco Outdoor freeform stone wall Colour: 'Wamberal' Dulux 'Lexicon Quarter' Dulux - 'Monument'

Note: Dulux & Colorbond colours can be replaced by similiar products



colour: Dulux 'Monument' or similar

colour: Dulux Duralloy 'Black Matt' or similar



Note: Dulux & Colorbond colours can be replaced by similiar products

### selected frameless glass balustrade with \_ 20mm powdercoated channel top rail



Acrylic render with painted finish. Colour: 'Dulux Lexicon Quarter' or similar

selected powdercoated aluminium windows & doors colour: Dulux Duralloy 'Black Matt' or

rendered & painted walls colour: Dulux 'Monument' or similar

selected gutters & downpipes colour: Colorbond 'monument' or

Oraig Orow ther

DMN/12/1469

hstar.com.au



Dulux Powdercoat-'Black Matt' Eco Outdoor freeform stone wall Colour: 'Wamberal' Eco Outdoor freeform stone wall Colour: 'Wamberal' Dulux 'Lexicon Quarter' Dulux - 'Monument'

#### DRAWING SCHEDULE

Sheet	Drawing Title	Scale	Size
AD.DA.00	Drawing Schedule & Notes	N/A	A1
AD.DA.01	Landscape Plan	1:100	A1

#### GENERAL NOTES

FOR DEVELOPMENT APPLICATION ONLY.

Do not scale from drawings.

All discrepancies or conflict should be brought to the attention of Azurea Design.

Larger scale drawings and written dimensions take preference.

All dimensions in mm unless otherwise stated. All tree dimensions and RLs in metres.

Use figured dimensions only.

Verify all dimensions on site before the commencement of any works.

Contractors shall locate and protect all services prior to construction.

All work shall be carried out in accordance with ASA, BCA and Local Government Regulations. Structural Details shall be subject to Engineer's Specifications.

Drainage & Water Feature Details shall be subject to Hydraulic Engineer's Specifications.

All work shall be carried out in a professional manner by Qualified Tradesmen according to

Landscape Drawings and Engineer's Specifications.

Protect all adjoining property building, walls and paving. Damaged elements are to be replaced. No responsibility will be taken by Azurea Design for any variations in design, construction method, materials specified, and general specifications without permission from the Project Engineer or Landscape Architect.

Service location on plans are indicative only . Azurea Design accepts no responsibility for the accuracy of service location. It is the responsibility of the contractor to determine service locations prior to the commencement of work. Any damages remains the responsibility of the contractor. This Drawing is copyright to Azurea Design Pty Ltd.

#### **IRRIGATION NOTES**

Irrigation by specialist D&C Irrigation Consultant. Refer to Irrigation Consultant documentation for details and requirements of landscape irrigation system.

Irrigation is to comply with Council Conditions of Consent and Water Authorities.

All garden beds within the site boundary are to be irrigated unless stated otherwise. Irrigation must be spaced at min. 200 centres and adjusted according to plant setout to provide adequate irrigation to all plants.

Drip irrigation is to be fully concealed by 75mm minimum of mulch.

#### PLANTING NOTES

Adjust final location of planting locally to suit service infrastructure including service lines, pillars, valves and the like.

Adjust final variation of plant material as directed by Project Landscape Architect to suit final extent of each planting area.

All trees in landscape grass seeded batter and turf areas are, unless otherwise noted, to be provided with a mulch ring with spade finish edge.

Provide plants with the following characteristics:

Large healthy root systems, with no evidence of root curl, restriction or damage.

Vigorous, well established, free from disease and pests, of good form consistent with the species or variety.

Hardened off, not soft or forced, and suitable for planting in the natural climatic conditions prevailing at the site.

Project Landscape Architect to inspect and approve all Plant material prior to delivery to site.

Plant substitutes shall be approved by the Project Landscape Architect prior to ordering All planting areas to be mulched, typically 75mm depth. Organic mulch to conform to AS 4454 - 2003 Compost, Soil Conditioners and Mulches.

Soils to conform to AS 4419 - 2003 Soils for Landscaping and Garden Use Soil Depths Sediment and erosion barriers to be installed at required locations on site during construction to prevent run-off into neighbouring properties, stormwater or sewer networks.

#### PLANT ESTABLISHMENT NOTES

The planting establishment period commences at the date of practical completion. Required period: 52 weeks on a weekly basis, or as specified by Contract. Throughout the planting establishment period, carry out maintenance work including watering, mowing, weeding, rubbish removal, fertilising, pest and disease control, reseeding, returfing, staking and tying, replanting, cultivating, pruning, hedge clipping, aerating, reinstatement of mulch, renovating, top dressing, and keeping the site neat and tidy.

#### DESIGN STATEMENT

Azurea Design has been consulted to provide Landscape Architecture Documentation supporting a proposal for a new residential home, designed by Jamisa Architects, in the beach side suburb of Palm Beach. Azurea Design has produced a refined landscape design that responds to the North Sydney Council development guidelines to support a new environmentally and socially sustainable residential home.

With regards to 'Pittwater Coastal Flora and Fauna Study' and 'Pittwater Natural Areas POM', the landscape design embraces the local character and vegetation communities. The landscape design simultaneously compliments the Architecture softening its built elements and creating a sense of depth in narrower spaces.

Where pedestrian access is not required, the boundaries are dense with canopy and layered understory planting inclusive of trees, tall palms and tree ferns wrapped in vines to establish scale and varied canopy. This planting conceals the bulk of the house from existing neighbours and street with the aid of topography. The front garden provides a calm transition from the public street with planting tumbling down the tiered stone planters to the private courtyard space. The specially selected tree canopy provides colours and habitat while casting dappled shade over a sheltered courtyard and interior. The interior feasts on the delightful views both East and West.

By retaining the landscape to the rear of the property the proposal intends to set the large expressive home beside a bush reserve. The rear area has a level drop of approximately 7.3 metres with natural sandstone outcrops and established local vegetation including tree ferns, palms and canopy trees. The natural featues and views are retained via this approached and enhanced by light bush regeneration.

The planting holistically appreciates the site conditions and incoporates designed maintenace. A lush and textured plant palette that celebrates Sydney's sub tropical climate, accented with naturalised and exotic species. The palette strives to achieve an equilibrium within the gardens as seasons change and plant growth rates vary. Layered planting, from canopy to groundcovers, aims to ensure healthy microclimates are established and voids are minimal. The plant palette is hardy, biodiverse and embracing of the local conditions while suited to the various microclimatic conditions expected at the future site. The strong palette of proven perfoming plants tolerant of low water conditions is paramount in ensuring planting longevity within a low maintenance environment. The palette's species variation in different applications aims to ensure seasonal change as well as a consistent level of amenity, should one of the species underperform.

The irrigation design to future detail shall consider both planting selection and the preliminary design of soil specification and profile. The planters will be fertilised and fed up to twice per year, the form and delivery of fertiliser varying accordingly to plant species.

#### LOCAL CHARACTER IMAGERY



#### INDICATIVE PLANT SCHEDULE

ID	Botanical Name
Trees	
Ang LG	Angophora costata 'Little Gumball'
Ban int	Banksia integrifolia
Cya aus	Cyathea australis
Wat Swe	Waterhousea floribunda 'Sweeper'
Liv aus	Livistona australis
Shrubs & Perennials	
Bae imb	Baeckea imbricata
Ban spi	Banksia spinulosa
Eri kar	Erigeron karvinskianus
Pit Nan	Pittosporum 'Nanum'
Syn Pix	Syngonium 'Pixie'
Wes fru	Westringia fruticosa
Grasses & Lilies	
Alo bri	Alocasia brisbanensis
Dia cae	Dianella caerulea
Fic nod	Ficinia nodosa
Lom Kat	Lomandra 'Katrinus'
Mis sin	Miscanthus sinensis
Zan aet	Zantedeschia aethiopica
Ferns	
Asp aus	Asplenium australasicum
Ground Covers	
Chr api	Chrysocephalum apiculatum
Myo par	Myoporum parvifolium
Vio hed	Viola hederacea
Climbers	
Hib sca	Hibbertia scandens
Total	

Contractors shall locate and protect all services prior to construction All work shall be carried out in accordance with ASA, BCA and Local Government Regulations. Structural Details shall be subject to Engineer's Specifications.

Drainage & Water Feature Details shall be subject to Hydraulic Engineer's Specifications. All work shall be carried out in a professional manner by Qualified Tradesman according to Landscape Drawings and Engineer's Specifications. An rotation to control of an inprocession manner by control indication of control indication for any variations in design, construction permission from the Project Engineer or Landscape Architecture for any variations in design, construction . This Drawing is copyright to Azurea Landscape Architecture.

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FOR DA APPROVAL ONLY NOT FOR CONSTRUCTION





Common Name	Size	Qty	Height
Dwarf Sydney Red Gum	100L	2	6m
Coastal Banksia	45L	6	3m
Rough Tree Fern	300mm	4	3m
Sweeper Lilly Pilly	45L	13	4m
Cabbage Palm	300mm	7	Up to 15m
Heath Myrtle	200mm	13	0.8m
Hairpin Banksia	200mm	13	1m
Sea Side Daisy	200mm	54	<0.5m
Mock Orange	300mm	9	0.5m
Butterfly Plant	200mm	14	<0.5m
Coastal Rosemary	200mm	13	1.5m
Cunjevoi	200mm	2	1m
Flax Lily	150mm	103	<0.5m
Knobby Club-rush	150mm	8	<0.5m
Katrinus Mat Rush	150mm	49	<0.5m
Maiden Grass	150mm	27	1m
Arum Lily	200mm	68	1m
Birds Nest Fern	300mm	2	<0.5m
Yellow Buttons	150mm	23	<0.5m
Creeping Boobiala	150mm	15	<0.5m
Native Violet	150mm	12	<0.5m
Golden Guinea Flower	200mm	81	
		538	
 1			

### PLANTING PALETTE





Banksia integrifolia 'Sentinel' Coastal Banksia



L. longifolia 'Katrinus' Matt Rush

Ficinia nodosa Knobby Club Rush

Yellow Button



Erigeron karvinskianus Sea Side Daisy




Myoporum parvifolium Creeping Boobialla



Syngonium sp. Arrow Head Plant




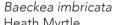



Elephants Ear

Heath Myrtle

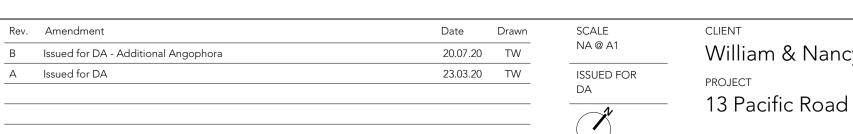

A. costata 'Little Gumball' Dwarf Syd Red Gum





Chrysocephalum apiculatum



Asplenium australis Birds Nest Fern



Alocasia brisbanensis



Banksia spinulosa Hair Pin Banksia



Waterhousia floribunda 'Whisper' Weeping Myrtle



Dianella caerulea Flax Lilly



Miscanthus sinensis Maiden Grass



Plttosporum tobira "Nanum' Mock Orange



Viola hederacea Native Violet



Westringa fructosia Native Rosmary



Cyathea australis Rough Tree Fern



Livistona australis Cabbage Palm



Hibbertia scandens Snake Vine




Zantedeschia aethiopica Arum Lilly



William & Nancy Grounds

DWG. TITLE Schedules & Notes SHEET NO. AD\_DA\_00

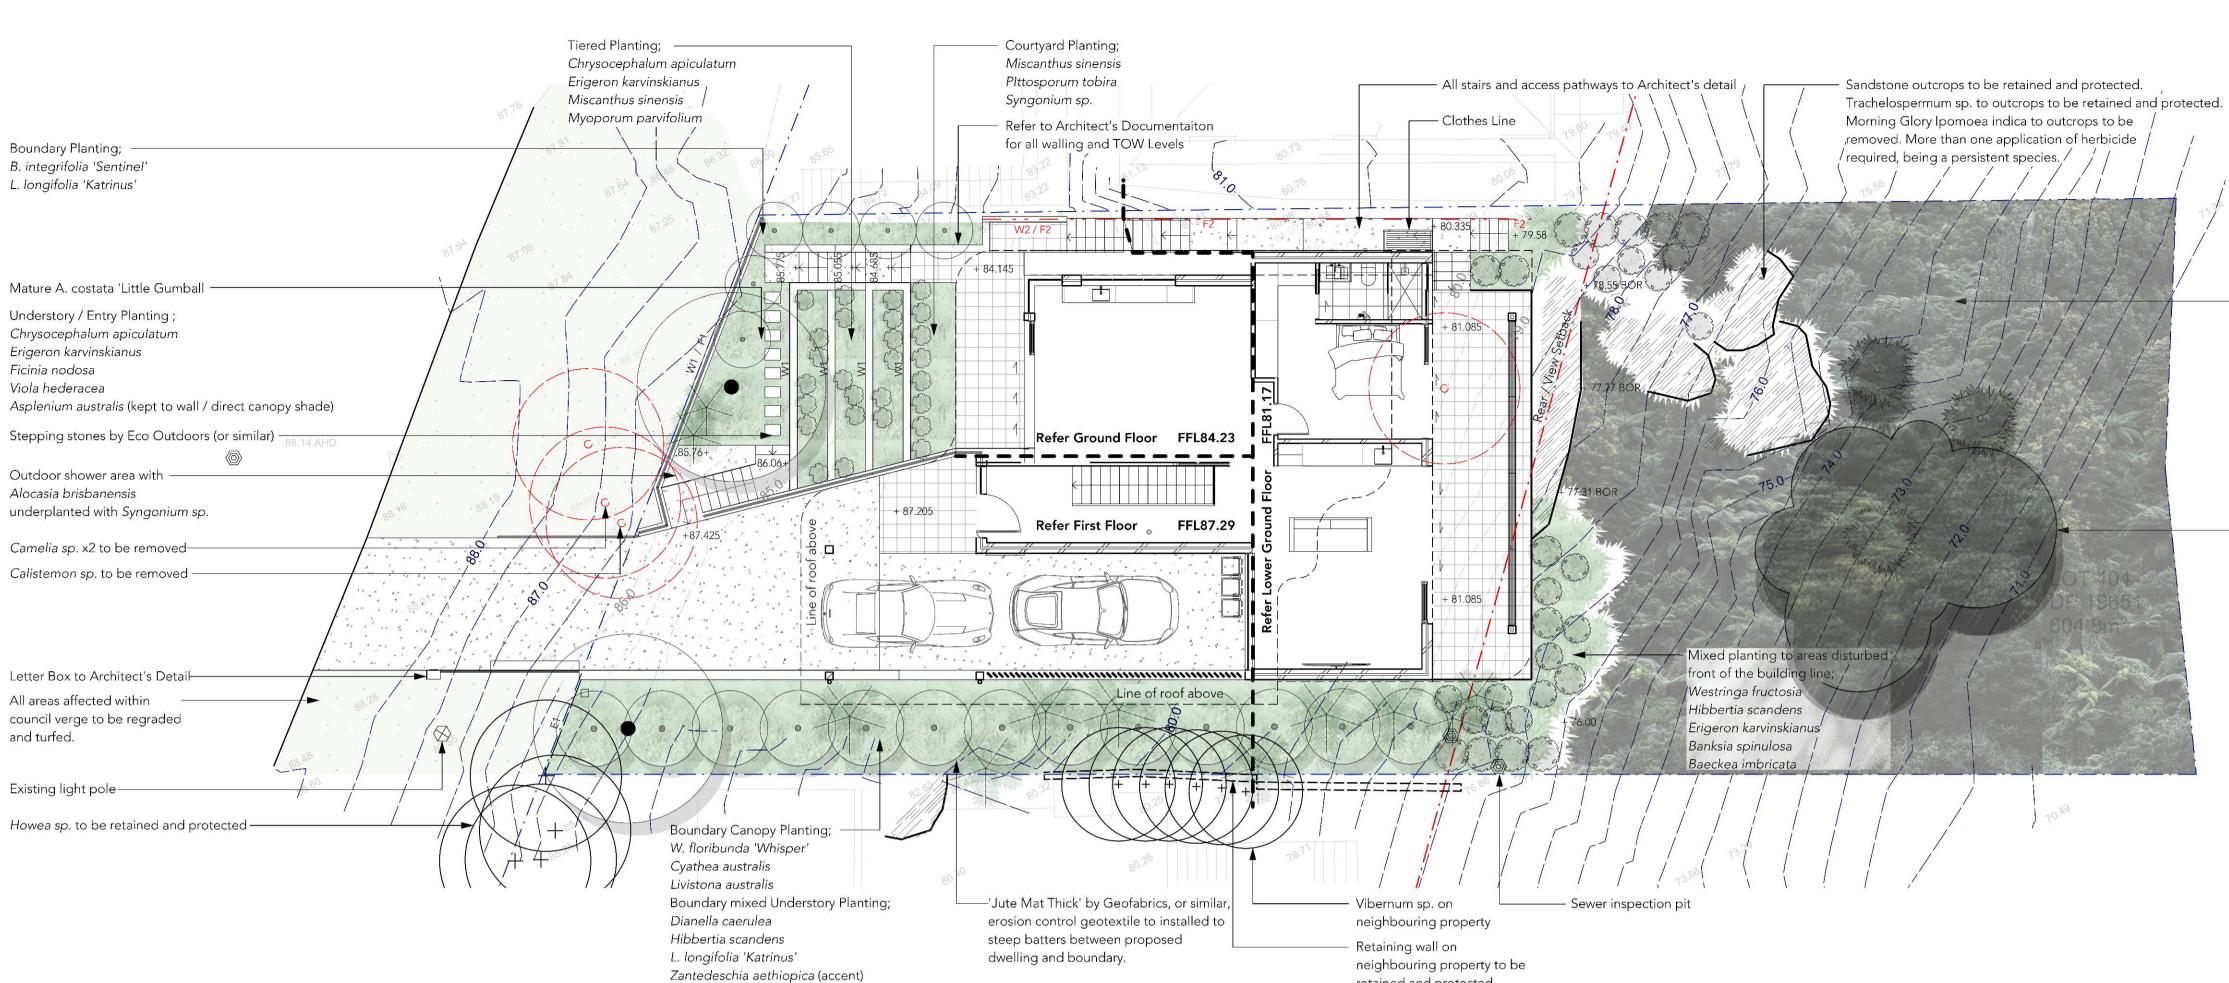

#### Finishes Schedule - Hardworks

Code	Туре	Finish	
P1	Paving Type 1	Pedestrian to Architect's Specification	
P2	Paving Type 2	Vehicle to Architect's Specification	
W1	Wall Type 1	Stone Clad Wall (Refer Arch FS01)	Eco Outdo
W2	Wall Type 2	Rendered Wall (Refer Arch FS01)	Dulux '
E1	Fence Type 1	Vertical Powdercoated Aluminium Railing	Dulux
F2	Fence Type 2	1.8M(H) Colorbond	Dulux '
E1	Edge Type 1	Flush steel edge	1

#### Legend & Schedule - Softworks

Code	Туре	Finish	Colour / Size	
$\overline{\cdot}$	Tree to be retained and protected	Refer notes for type	-	
$\odot$	Tree to be removed	Refer notes for type	-	
$\overline{\mathbf{\cdot}}$	Proposed Tree	Refer Planting Palette	50mm hardwood Stakes x2 with 50mm hessain tie in figure eight	
	Planting Bed	Planting Bed on grade with Mulch	Mulch to be Forest Fines or alike	
	Turf	Sir Walter Buffalow or alike	-	

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retained and protected.

### Notes:

For hardsurfaces, walling, stairs, letter boxes, fencing
and gate detail and specification refer to Architects
Documentation.

For all levels and grading of paved surfaces refer to Architects Documentation

For existing structures and demolition plan refer to Architects Documentation.

Existing trees to be retained are to be protected to Council and Project Arborist's requirements. No vehicular traffic, stockpiling or storage of materials within Tree Protection Zones (TPZ's)


## Calculations:

SITE AREA

605m<sup>2</sup>

Landscape Requirement Proposed Landscape Area Proposed built upon area:

60% 358.43m<sup>2</sup> ( 60% Shown in Green) 265m<sup>2</sup>

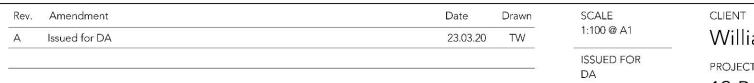

Colour / Size -141 door Freeform 'Wamberal' 'Monument' or similar x Duralloy 'Black Matt' 'Monument' or similar 100 x 6mm thick



- Retain existing landscape i.e. natural features and vegetation. Where possible, remove introduced vegetation and weeds. Introduced plants and weeds are to be controlled using industry accepted techniques including 'cut and paint herbicide' for woody weeds. Following weed control and removal of debris, bare areas may require revegetation. Only plants of the Plant Palette are to be used for revegetation. A light covering of forest fines mulch to a depth of 50mm is to be applied only to highly disturbed areas. Maintenance is to be undertaken by a suitably qualified landscape contractor.

- Care is to be exercised to protect and retain existing indigenous trees, shrubs and groundcovers. Areas of vegetation are not to be used for the storage of materials, equipment or machinery. Native vegetation includes but not limited to; Casuarina glauca Livistona australis Glochidion ferdinandi

