







NOTE: ALL DEMOLISHED ELEMENTS TO ENG. SPECIFICATIONS AND AS. 2601 - 2001



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au					are to be used only. The Builder/Contractor shall check and verify all levels and dimensions on site prior to commencement of any work, creation of shop drawings, or fabrication of components. All errors and omissions are to be verified by the Builder/Contractor and referred to the designer prior to the	P E E
					commencement of works.	



EXISTING EX. DOWNPIPE DP. PROPOSED PROP. DP. DOWNPIPE

ELKE & BRAD DUPERE

CLIENT

PROJECT ADDRESS 122 PARKES ROAD COLLAROY PLATEAU NSW 2097

DRAWING NO.


DA01


DATE Friday, 21 February 2020

DRAWING NAME SITE ANALYSIS

SCALE

1:200 @A3

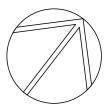

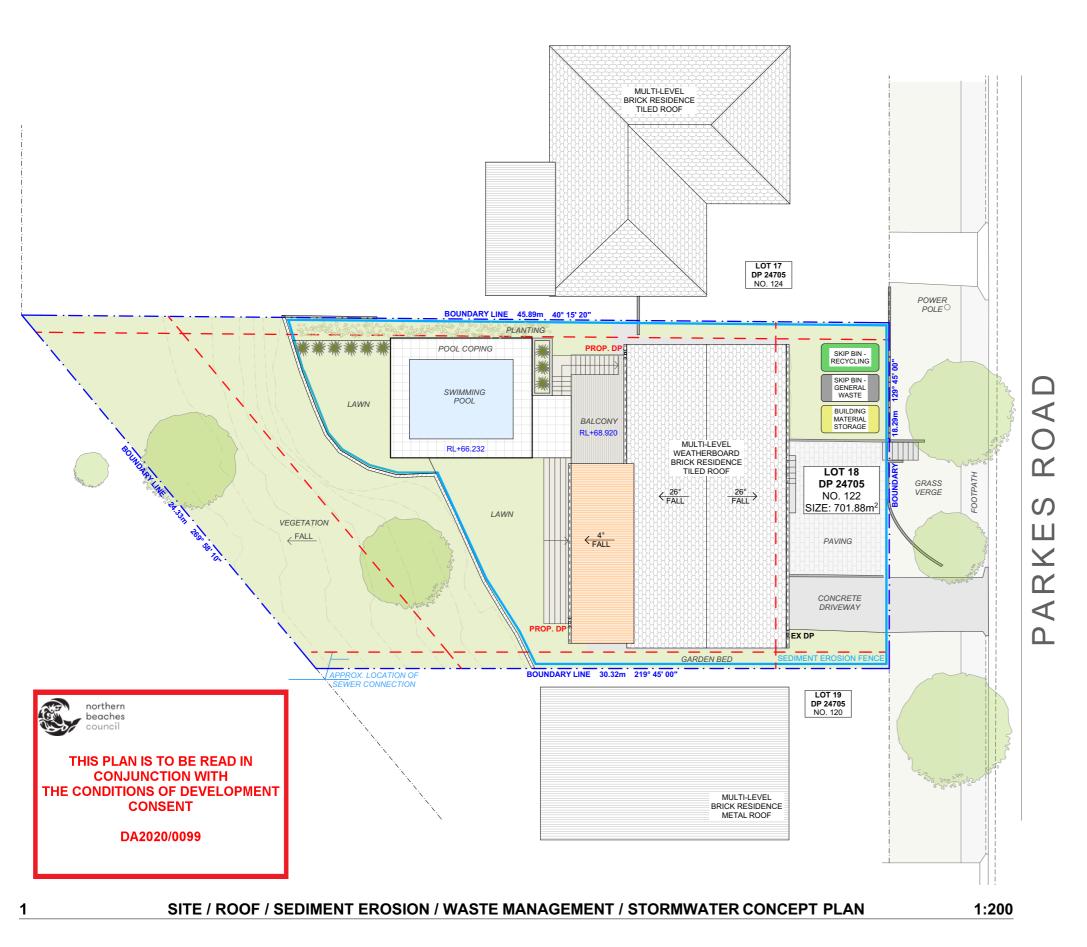

3m MAX DISTURBED AREA POSTS DRIVEN 0.6m INTO GROUND DETAIL OF OVERLAP WIRE OR STEEL MESH (WHERE REQUIRED) ↓ UNDISTURBED AREA **SEDIMENT FENCE**

DUST CONTROL:

TO REDUCE DUST GENERATED BY WIND ACTION, THE REMOVAL OF THE TOP SOIL IS TO BE MINIMISED. TO PREVENT DUST GENERATION, WATERING DOWN OF THE SITE, ESPECIALLY DURING THE MOVEMENT OF MACHINERY IS REQUIRED. WHERE EXCAVATING INTO ROCK, KEEP THE SURFACE MOIST TO MINIMISE DUST. CONSTRUCT A GRAVEL ENTRY/EXIT POINT USING BLUE METAL AND RESTRICT ALL VEHICLE MOVEMENTS WITHIN THE SITE TO A MINIMUM. ENSURE WIND BREAKS, SUCH AS EXISTING FENCES ARE MAINTAINED DURING THE CONSTRUCTION PHASE UNTIL NEW LANDSCAPING IS PROVIDED OR REINSTATED. PREVENT DUST BY COVERING STOCKPILES

SEDIMENT NOTE:

1. ALL EROSION AND SEDIMENT CONTROL MEASURES TO BE INSPECTED AND MAINTAINED DAILY BY THE SITE MANAGER.

2. MINIMISE DISTURBED AREAS, REMOVE EXCESS SOIL FROM EXCAVATEDAREA AS SOON AS POSSIBLE. 3. ALL MATERIAL STOCKPILE TO BE CLEAR FROM DRAINS, GUTTERS AND FOOTPATHS, OR WITHIN SEDIMENT FENCE AREA.

4. DRAINAGE TO BE CONNECTED TO STORMWATER AS SOON AS POSSIBLE. IF STORED ON SITE, IT MUST BE FILTERED BEFORE RELEASING INTO STORMWATER SYSTEM OR WATERWAYS

5. ROADS AND FOOTPATHS TO BE SWEPT DAILY.

STOCKPILES:

ALL STOCKPILES ARE TO BE KEPT ON-SITE WHERE POSSIBLE. ANY MATERIALS PLACED ON THE FOOTPATHS OR NATURE STRIPS REQUIRE COUNCIL'S PERMISSION

ALL STOCKPILES ARE TO BE PLACED AWAY FROM THE DRAINAGE LINES AND STREET GUTTERS. IT IS BEST TO LOCATE THESE ON THE HIGHEST PART OF THE SITE IF POSSIBLE. PLACE WATERPROOF COVERING OVER STOCKPILES.

IF REQUIRED PROVIDE DIVERSION DRAIN & BANK AROUND STOCKPILES.

GUTTER PROTECTION:

PROVIDE PROTECTION TO DOWNHILL GRATE IN GUTTER BY MEANS OF SAND BAGS OR BLUE METAL WRAPPED IN GEOTEXTILE FABRIC. WHEN SOIL OR SAND BUILDS UP AROUND THIS SEDIMENT BARRIER, THE MATERIAL SHOULD BE RELOCATED BACK TO THE SITE FOR DISPOSAL.


NOTE: ALL PROPOSED STORMWATER TO CONNECT WITH EXISTING

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COMMENTS

DEV DATE



SOFT LANDSCAPE HARD LANDSCAPE PROPOSED **EXISTING** DEMOLISHED

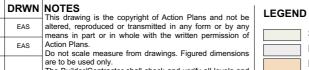EX. **EXISTING** DP. DOWNPIPE PROP. PROPOSED DP. DOWNPIPE

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PROJECT ADDRESS 122 PARKES ROAD COLLAROY PLATEAU NSW 2097

DRAWING NO.

DA02

DATE


Friday, 21 February 2020

DRAWING NAME


SITE / ROOF / SEDIMENT EROSION / WASTE MANAGEMENT / STORMWATER CONCEPT PLAN

SCALE

1:200 @A3

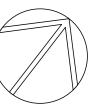




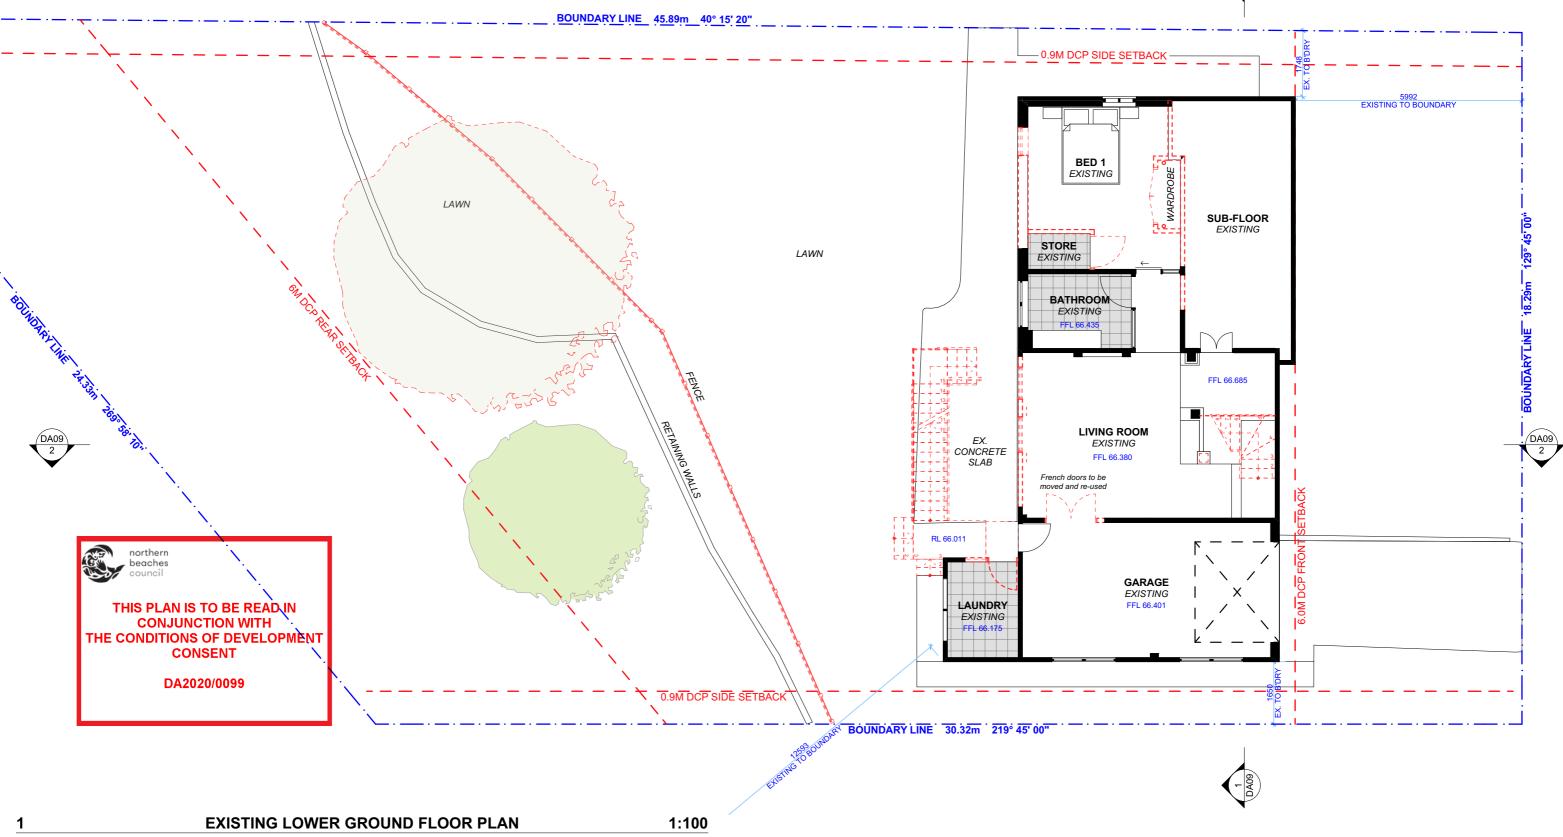

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PROJECT ADDRESS
122 PARKES ROAD
COLLAROY PLATEAU
NSW 2097

DRAWING NO. **DA03**


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DRAWING NAME EXISTING LOWER GROUND FLOOR PLAN

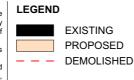SCALE

1:100 @A3



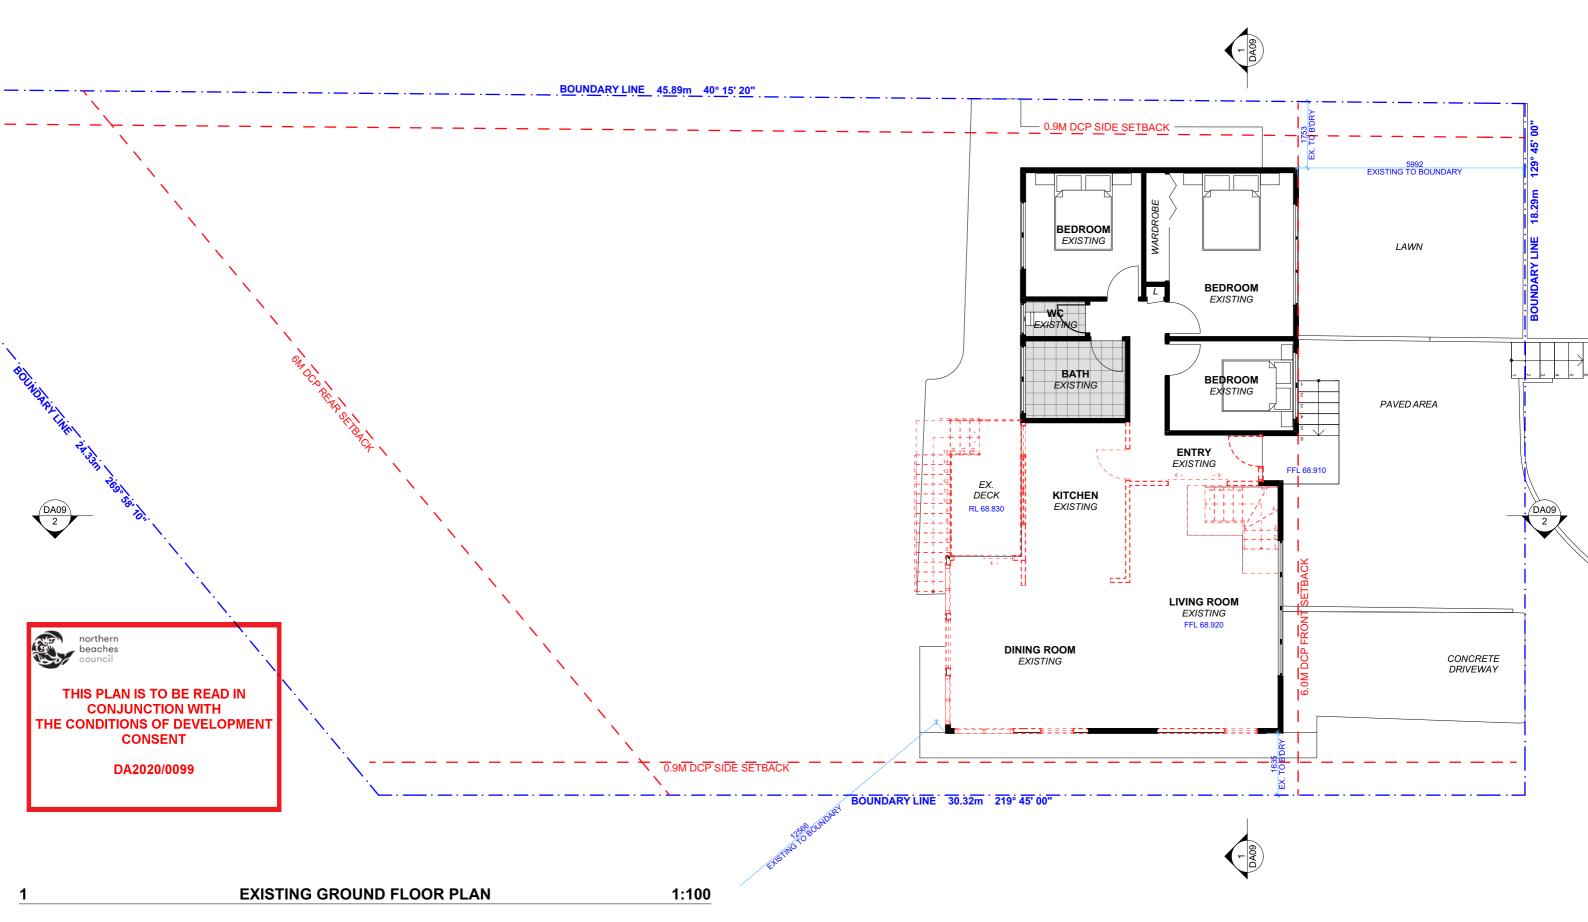

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122 PARKES ROAD	
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NSW 2097	

DA04


DRAWING NO.

.04 EXISTING GROUND FLOOR PLAN

DRAWING NAME


DATE
Friday, 21 February SCALE
2020 1:100 @A3



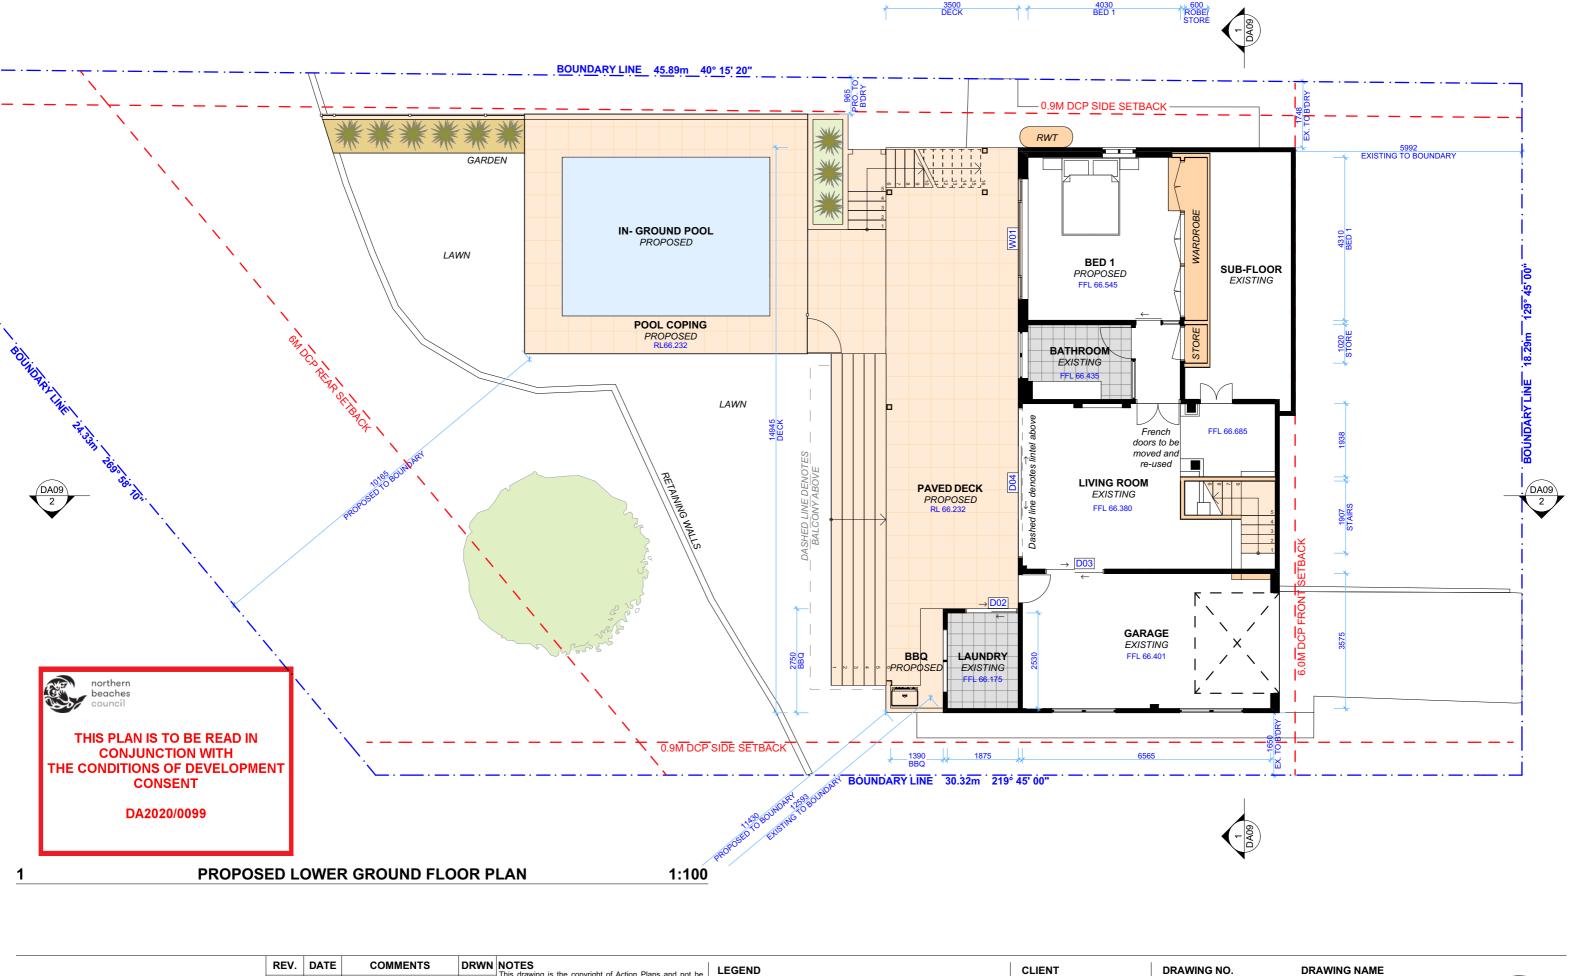



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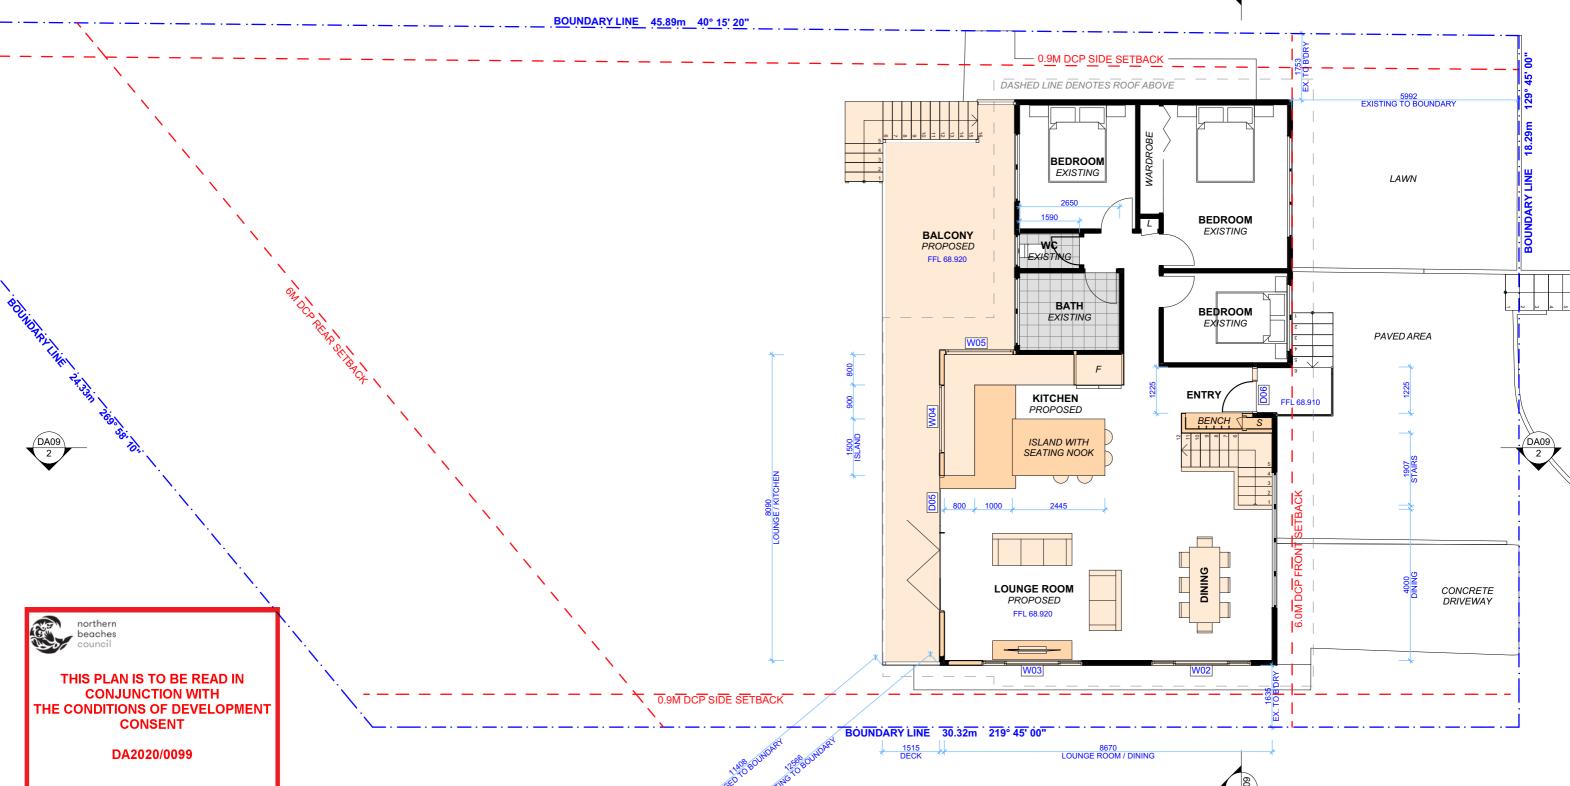
DATEFriday, 21 February 2020

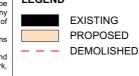PROPOSED LOWER GROUND FLOOR PLAN

SCALE 1:100 @A3








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PROPOSED GROUND FLOOR PLAN



1:100

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PROJECT ADDRESS 122 PARKES ROAD COLLAROY PLATEAU NSW 2097

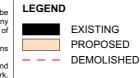
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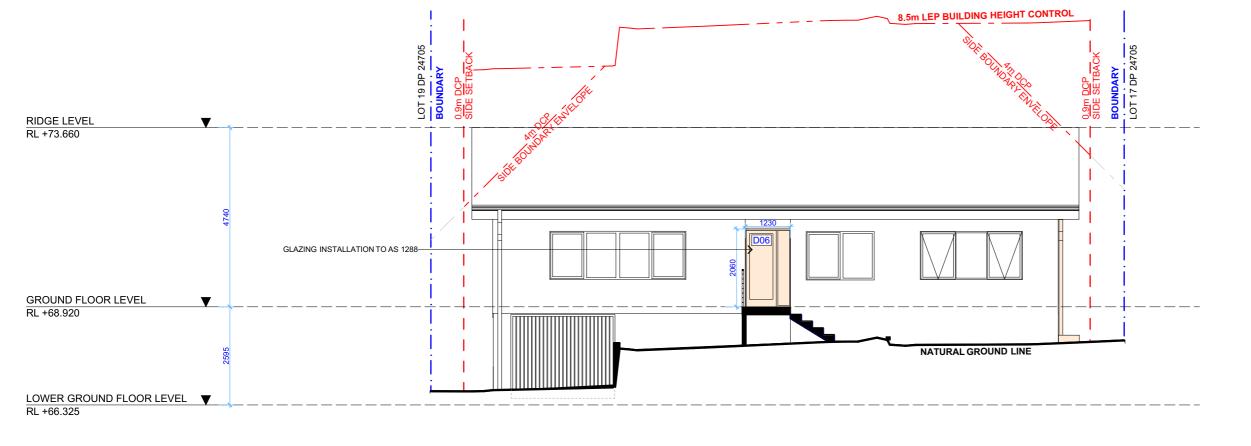
Friday, 21 February 2020

PROPOSED GROUND FLOOR PLAN DATE



DRAWING NAME




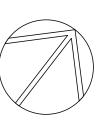



THIS PLAN IS TO BE READ IN **CONJUNCTION WITH** THE CONDITIONS OF DEVELOPMENT CONSENT

DA2020/0099

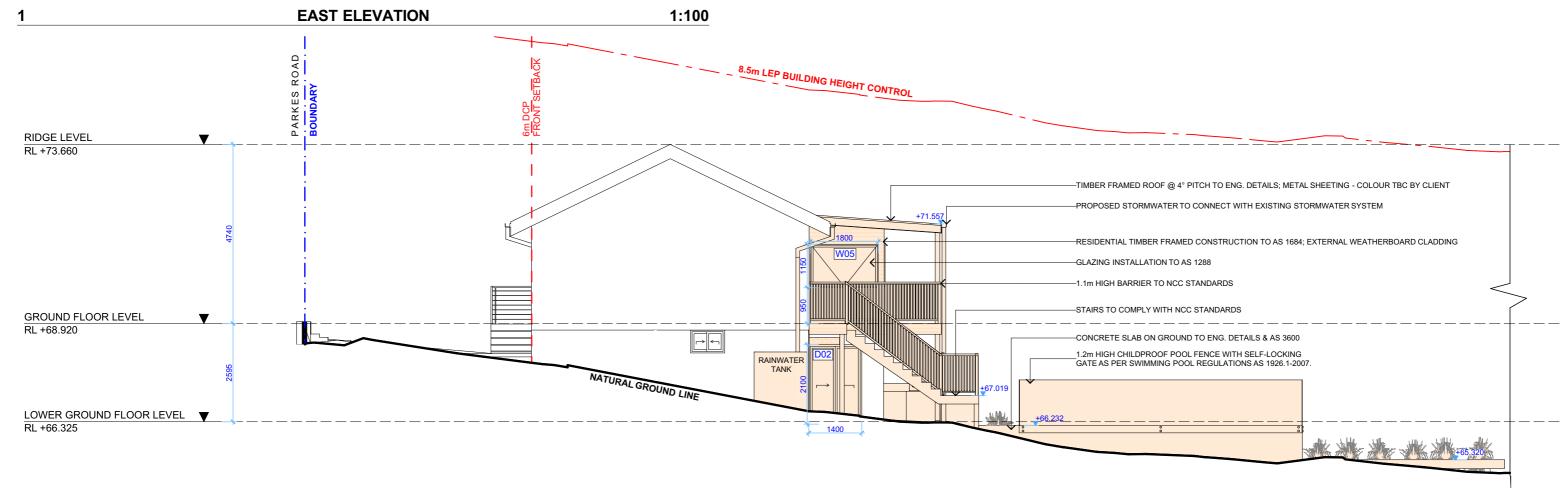

1:100



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NORTH ELEVATION




CLIENT	DRAWING NO.
ELKE & BRAD DUPERE	DA07
PROJECT ADDRESS	DATE


NORTH / EAST ELEVATION 07


PROJEC1 122 PARKES ROAD Friday, 21 February 2020 COLLAROY PLATEAU NSW 2097

SCALE 1:100 @A3

DRAWING NAME

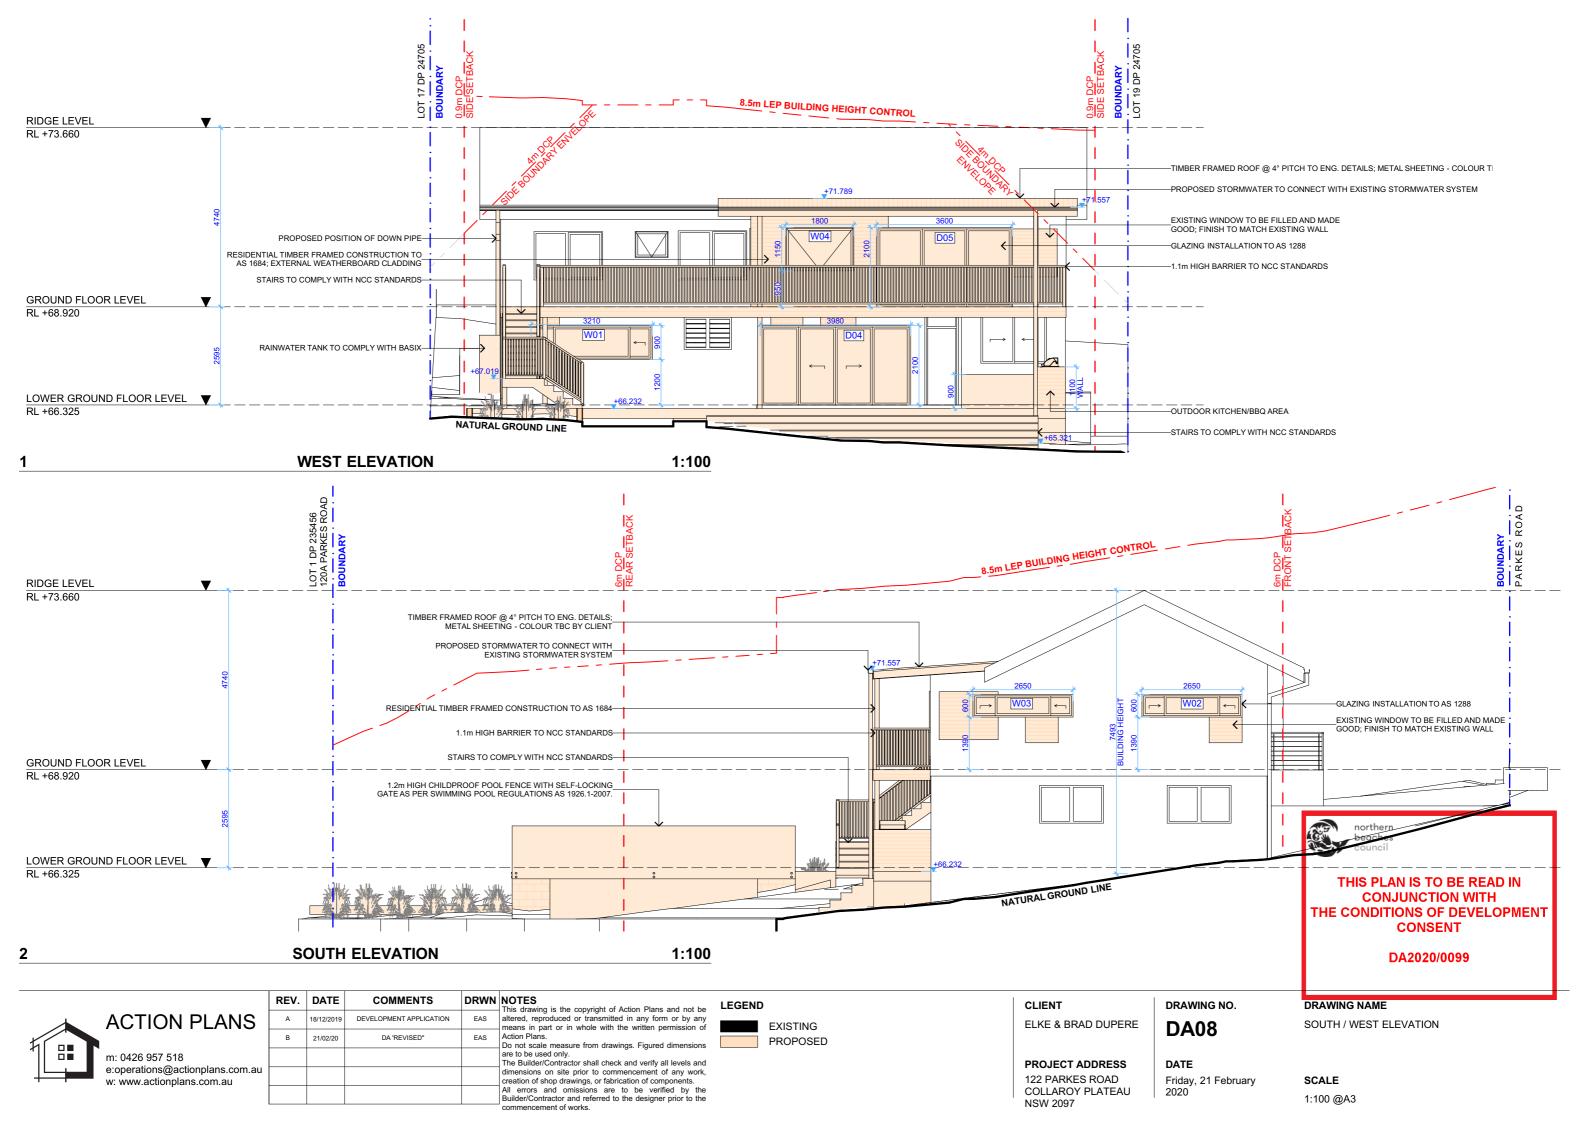

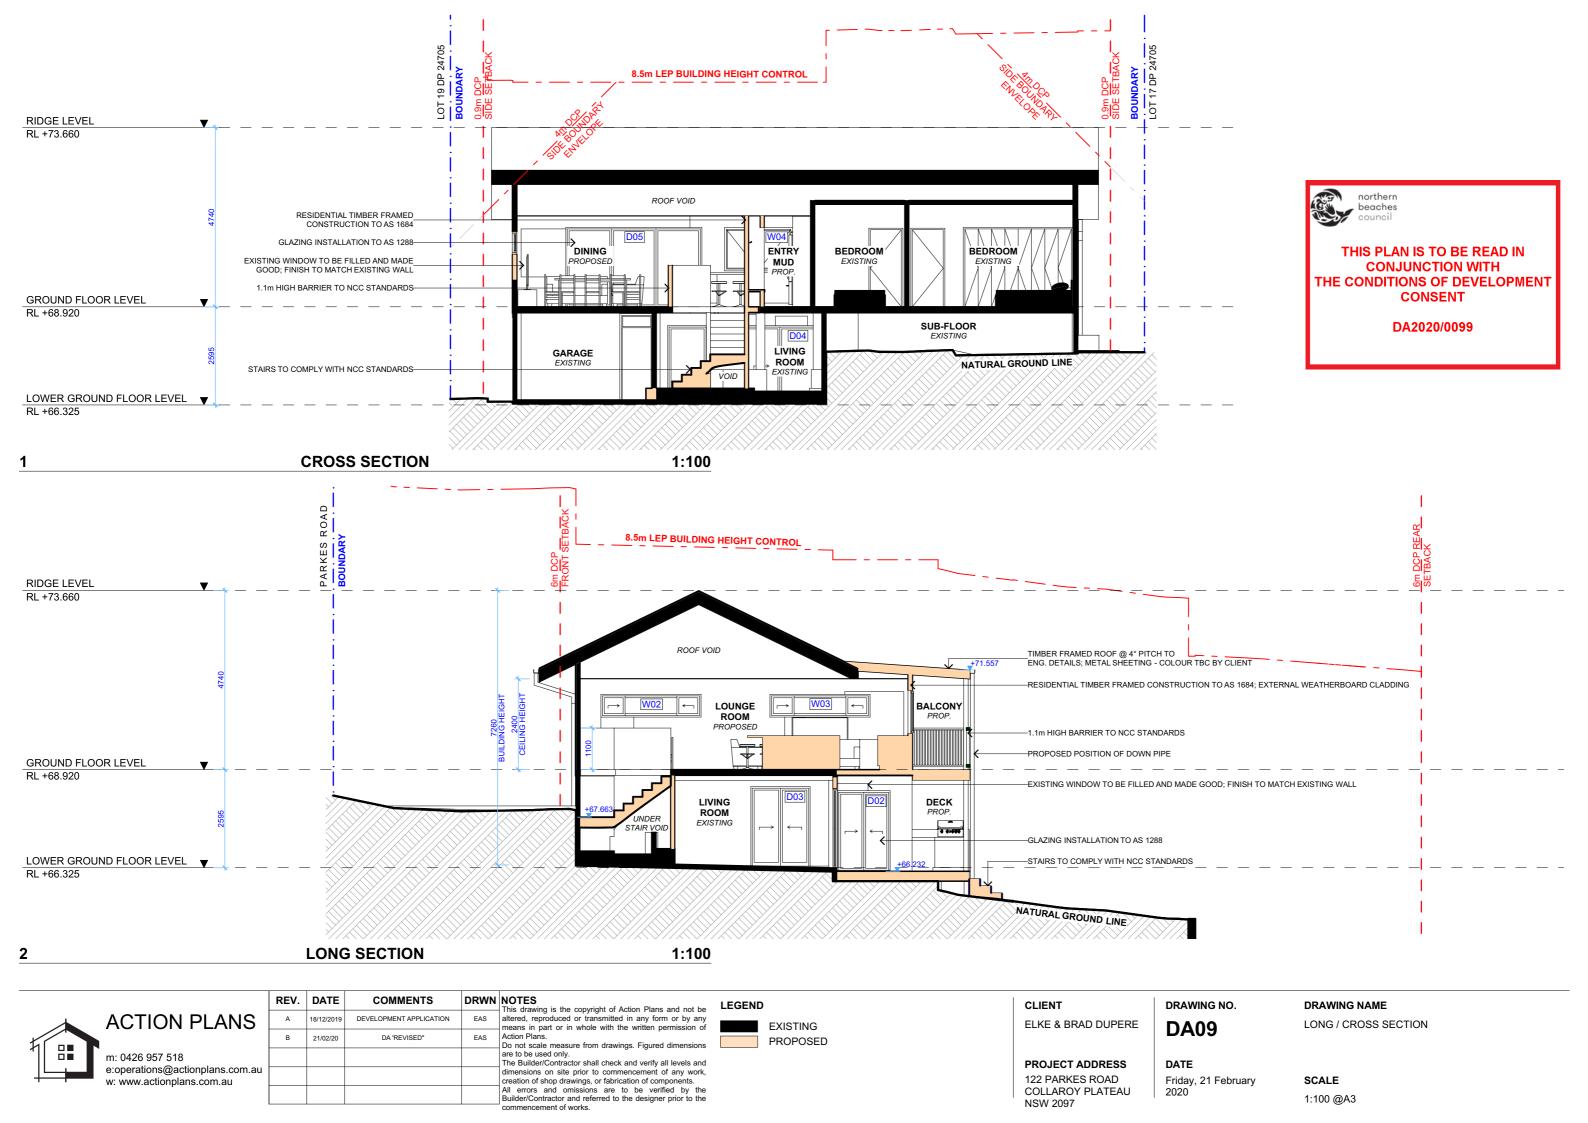

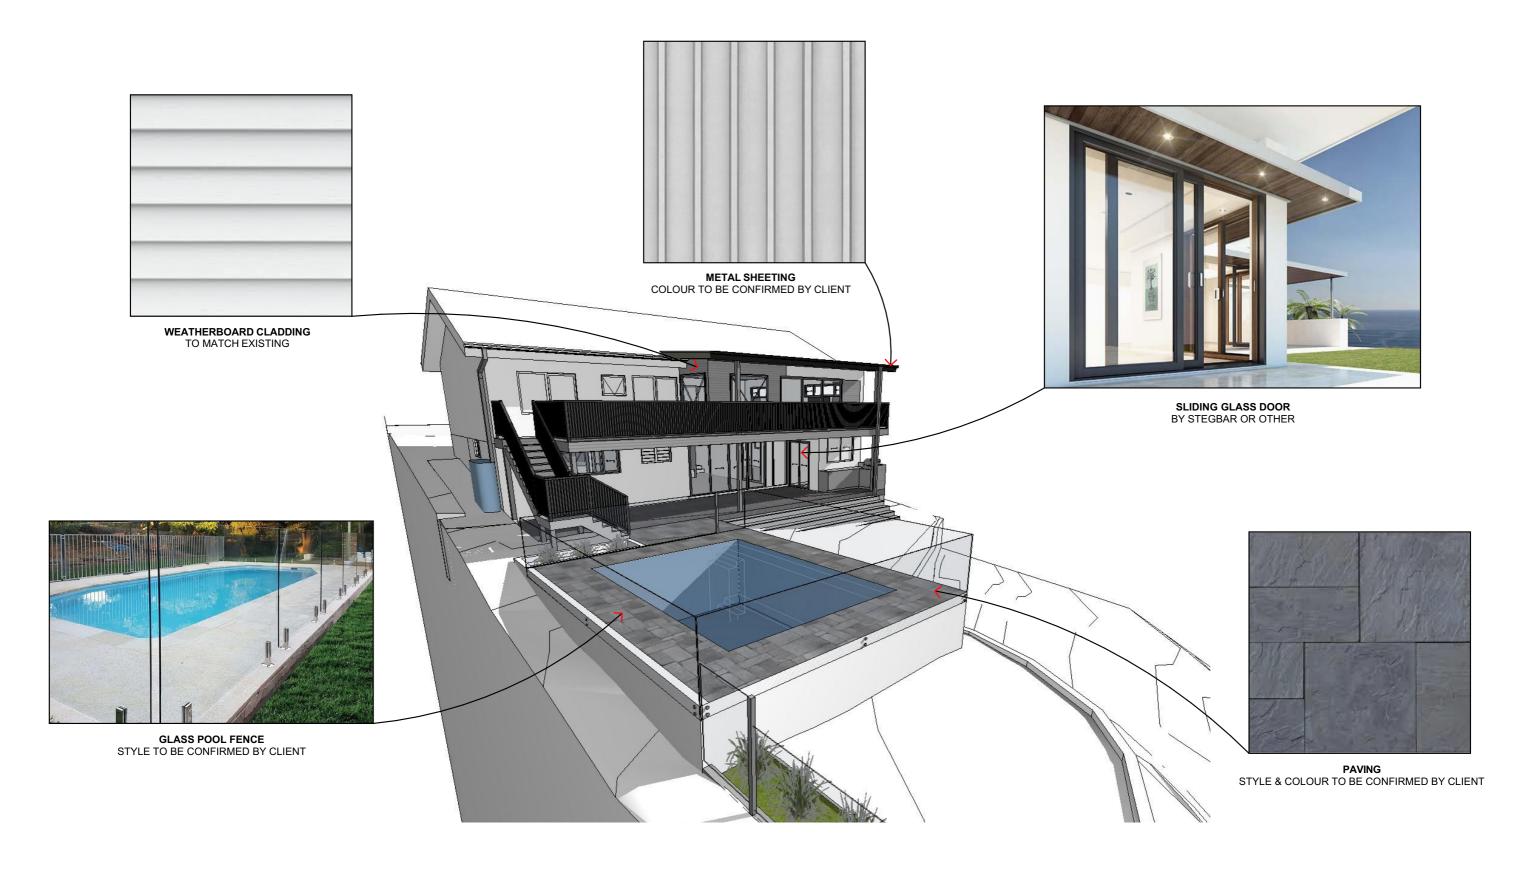

SAMPLE BOARD



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THIS PLAN IS TO BE READ IN

CONJUNCTION WITH

LEGENDTHE CONDITIONS OF DEVELOPMENT

CONSENT

DA2020/0099

CLIENT DRA


ELKE & BRAD DUPERE

PROJECT ADDRESS 122 PARKES ROAD COLLAROY PLATEAU NSW 2097 DRAWING NO.

DRAWING NAMESAMPLE BOARD

DATE

Friday, 21 February 2020 SCALE @A3

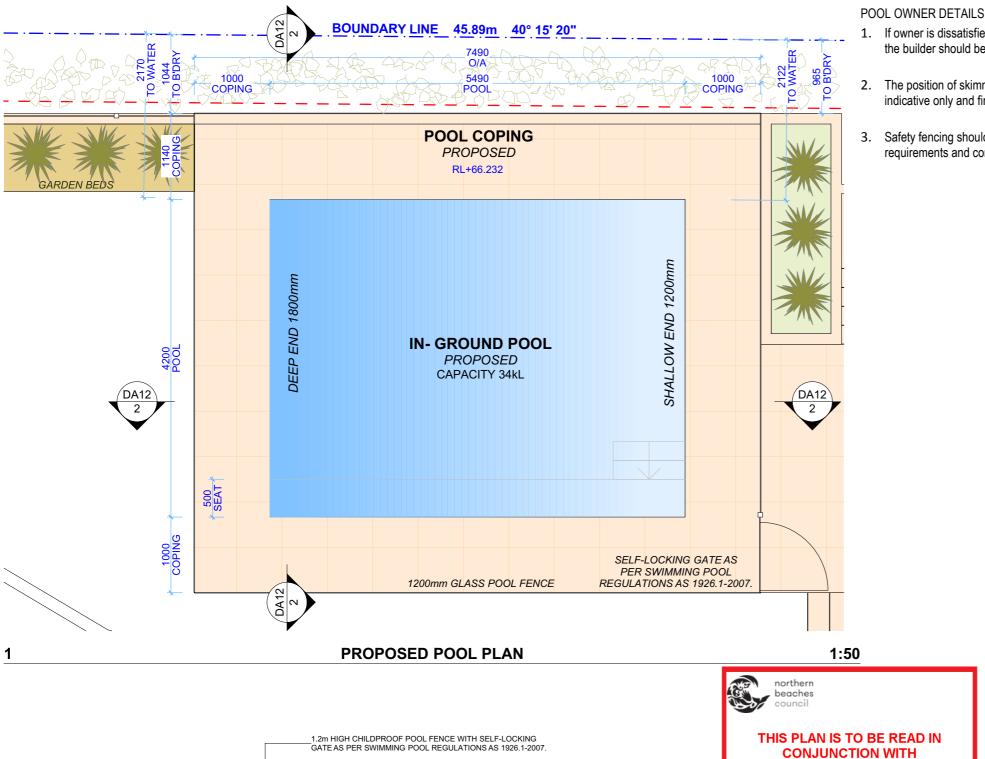

1. If owner is dissatisfied with initial pool set out, location or depths, the builder should be notified BEFORE steel reinforcement is fixed.

2. The position of skimmers, lights, return lines etc. on this drawing is indicative only and final position to be determined on site

COPING END LEVEL


SHALLOW END LEVEL

RL +65.032 DEEP END LEVEL

RL +66.232

RL +64.432

3. Safety fencing should be in accordance with local councils requirements and conform to Australian standards

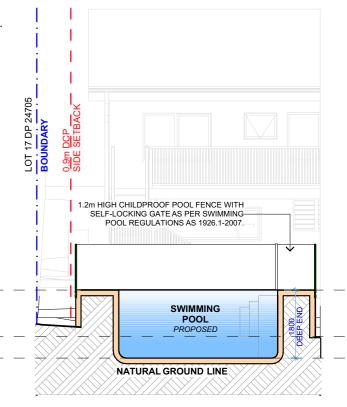

3 POOL CROSS SECTION

	Design Specification	Building Code of Australia (BCA) requirement		
		(for version of BCA applicable as on the date of		
		submission of CC or CDC)		
1.	All glazing including decals shall comply with AS 1288.1-2006, AS 2047-1999 and AS 1170.1-2002	Part 3.6 Glazing, requires all glazing to comply with AS 1288-2006 and AS 2047-1999. The BCA requires glazing members to comply with Structural Loading Code AS 2280.1-2002. Glass with a high potential for human impact shall strictly comply with the human impact safety requirements of the BCA		
2.	Swimming Pool Safety Fencing	Part 3.9.3, of the BCA specifies all requirements of swimming pool safety fencing. Compliance with As1926.1-2012, including 1800mm high boundary fencing acting as pool fence/barriers. 1200mm high pool fence/barriers shall surround the pool with no doors of building permitted to open onto pool areas. Any windows shall be sufficiently protected in accordance with AS1926.1-2012. NCZ shall be provided to all swimming pool safety fence/barriers in accordance with AS1926.1-2012. AS 1288 2006 specifies glazing requirements when glass is incorporated into a pool fence/barrier. Certification post construction will be required.		
3.	Swimming Pool Recirculation Systems	Part 3.9.4. of the BCA specifies all requirements of swimming pool and spa recirculation systems. AS1926.3-2010 shall be complied with and certified post construction		

DA2020/0099 Building Code of Australia (BCA) requirement (for version of BCA applicable as on the date of submission of CC or CDC) Design Specification Part 3.6 Glazing, requires all glazing to comply with AS 1288-2006 and AS 2047-1999. The BCA requires glazing members to comply with Structural Loading Code AS All glazing including decals shall comply with AS 1288.1-2006, AS 2047-1999 and AS 1170.1-2002 2280.1-2002. Glass with a high potential for human impact shall strictly comply with the human impact safety requirements of the BCA Swimming Pool Safety Fencing Part 3.9.3, of the BCA specifies all requirements of swimming pool safety fencing. Compliance with As1926.1-2012, including 1800mm high boundary fencing acting as pool fence/barriers. 1200mm high pool fence/barriers shall surround the pool with no doors of building permitted to open onto pool areas. Any windows shall be sufficiently protected in accordance with AS1926.1-2012. NCZ shall be provided to all swimming pool safety fence/barriers in accordance with AS1926.1-2012. AS 1288 2006 specifies glazing requirements when glass is incorporated into a pool fence/barrier. Certification post construction will be required. Swimming Pool Recirculation Systems Part 3.9.4. of the BCA specifies all requirements of swimming pool and spa recirculation systems. AS1926.3-2010 shall be complied with and certified post construction



COPING END LEVEL

SHALLOW END LEVEL

RL +65.032 DEEP END LEVEL

RL +66.232

RL +64.432

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1:100

SWIMMING POOL

NATURAL GROUND LINE

POOL LONG SECTION

LEGEND

THE CONDITIONS OF DEVELOPMENT CONSENT

PROJECT ADDRESS

122 PARKES ROAD

COLLAROY PLATEAU

ELKE & BRAD DUPERE

CLIENT

NSW 2097

DA12

DRAWING NO.


DATE Friday, 21 February

POOL PLAN

DRAWING NAME

1:50, 1:100 @A3

SCALE

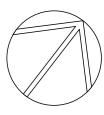

1:100