Sheet List		
Sheet Number	Sheet Name	Drawn By
1	FACADE VIEW	PM
A1.1	BASIX	AB
A1.2	CONSTRUCTION NOTES	AB
A1.3	SEDIMENT CONTROL PLAN	AB
A1.4	SITE ANALYSIS	AB
A1.4.2	SITE PLAN	AB
A1.5	GROUND FLOOR PLAN	AB
A1.6	FIRST FLOOR PLAN	AB
A1.7	ROOF PLAN	AB
A1.8	ELEVATION SHEET 1	AB
A1.9	ELEVATION SHEET 2	AB
A1.10	MATERIAL SCHEDULE	AB
A1.11	SECTIONS	AB
A1.12	CONCRETE SLAB PLAN	AB
A1.13	CUT AND FILL PLAN	AB
A1.14	STORMWATER PLAN	AB
A1.15	LANDSCAPE PLAN	AB
A1.16	SHADOW DIAGRAMS	AB
A1.17	NOTIFICATION PLAN	AB

Area Schedule - 259.3 M2			
Name	Area	SQ.	
GROUND FLOOR LIVING	85.16 m ²	9.2	
GARAGE	22.25 m ²	2.4	
ALFRESCO	6.18 m ²	0.7	
PORCH	1.10 m ²	0.1	
FIRST FLOOR LIVING	106.16 m ²	11.4	
BALCONY	4.29 m ²	0.5	
	225.14 m ²	24.2	

Area Schedule - SITE AREAS		
Name	Area	SQ.
LANDSCAPE AREA	123.09 m ²	13.2
DRIVEWAY	21.52 m ²	2.3
	144.61 m ²	15.6


GROUN	D FLOOR (CALCULATION	
Name	Area	% of SITE	
GARAGE	22.25 m ²	8.58	-
GROUND FLOOR LIVING	85.16 m ²	32.84	
	107 41 m ²	41.42	ī

FIRST FLOOR CALCULATION		
Name	Area	% of SITE
FIRST FLOOR LINEAR	106.16 m ²	40.94
FIRST FLOOR LIVING	106.16 m²	40.94
	106.16 m ²	40.94

LANDS	CAPE AREA	CALCULATION
Name	Area	% OF LANDSCAPING
LANDSCAPE AREA	123.09 m ²	47.47
ENITEDOCALE AREA	123.09 m²	47.47





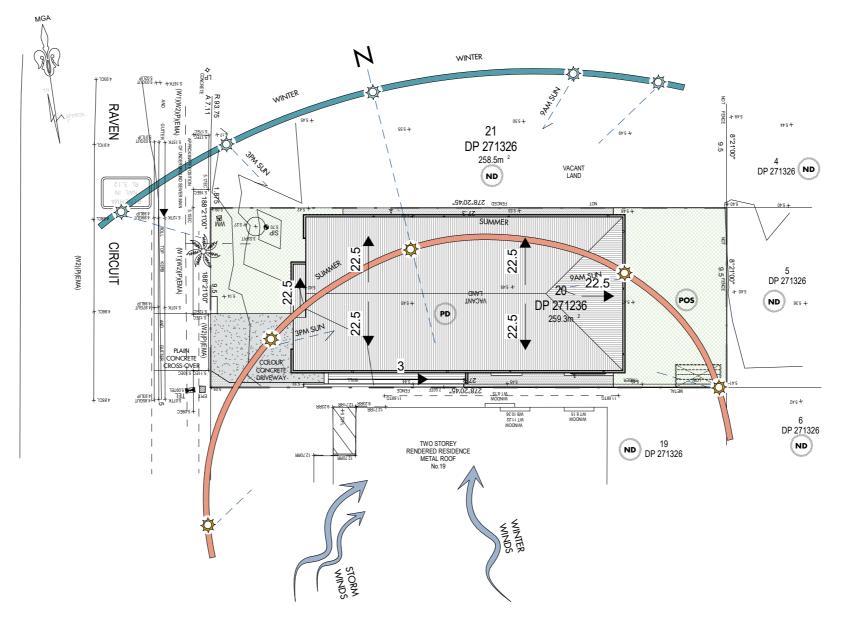

SITE ANALYSIS

1:200



Client Name: NEEV HOMES

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R04	ISSUED TO CLIENT 16.12.2024	PM
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Drawn by	Checked by



Project No




SITE ANALYSIS



Sheet No.



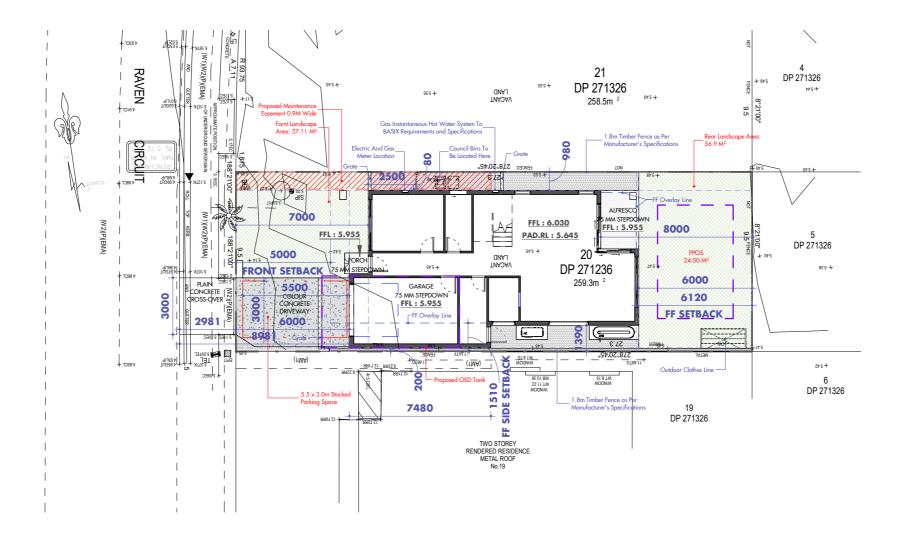

SITE PLAN 1:200



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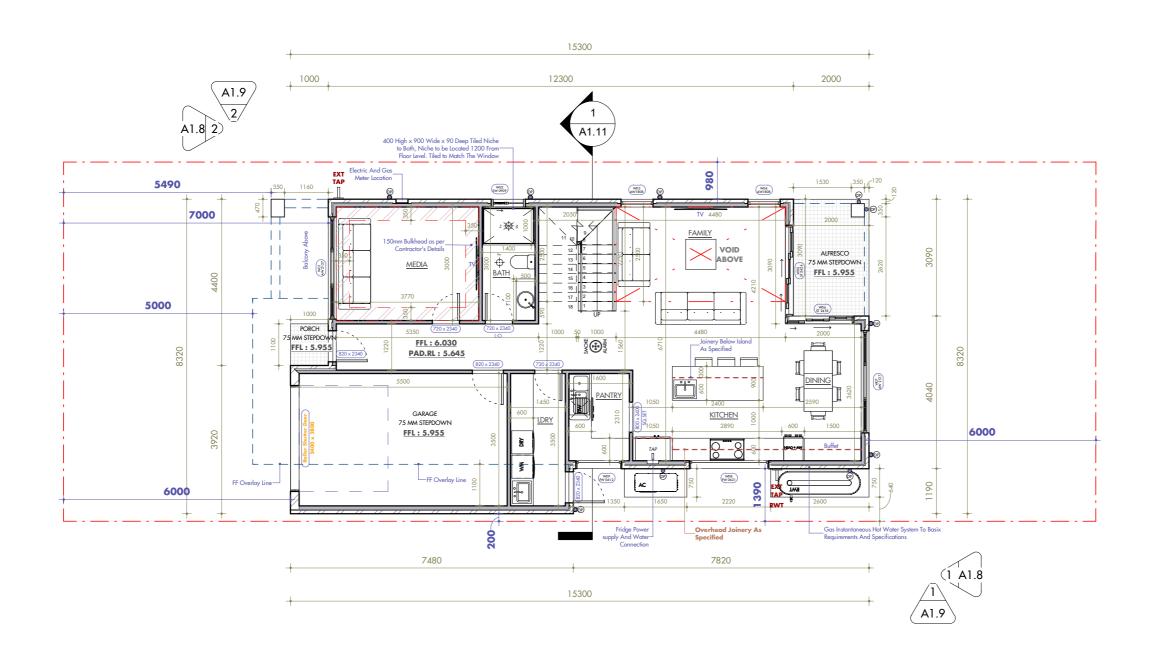
PM	YS
Drawn by	Checked by





1 : 200 @ A3

SITE PLAN







- Stair riser heights are to be calculated and verified by the builder upon selection of final floor finishes.

NOTES

- Provide lift off hinges to the door of all water closets/bathrooms/ensuites if the door is within 1200mm of the closet pan in accordance with Clause 3.8.3.3 of Volume 2 of the BCA

- Architect plan to be in accordance with NCC Volume 2 Building Code of Australia 2022 & Housing Provisions Standard 2022.





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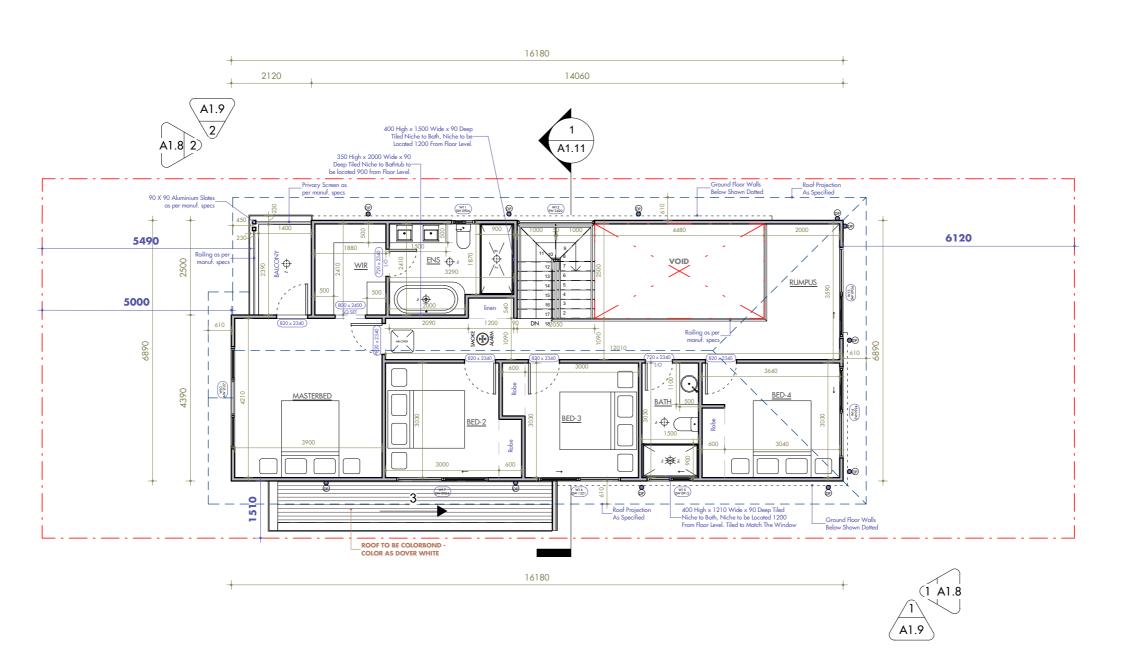


Project N




GROUND FLOOR PLAN

A1.5



1.6 FIRST FLOOR LEVEL
1:100

noi be

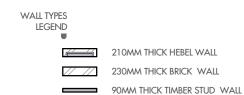

 Stair riser heights are to be calculated and verified by the builder upon selection of final floor finishes.

NOTES

- Provide lift off hinges to the door of all water closets/bathrooms/ensuites if the door is within 1200mm of the closet pan in accordance with Clause 3.8.3.3 of Volume 2 of the BCA


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Project N




FIRST FLOOR PLAN

A1.6

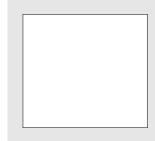

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DA2025/0074

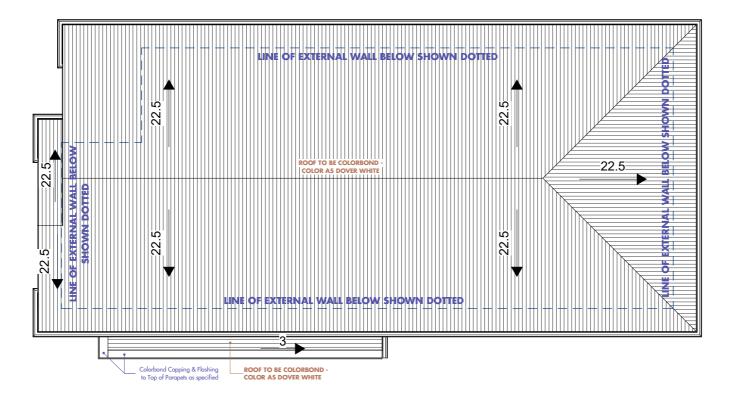


 $\frac{1.7\,\text{ROOF PLAN}}{1:100}$



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1 : 100 @ A3

ROOF PLAN

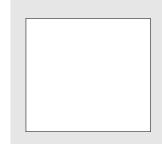			Wi	ndow Sched	ule	
Mark	Туре	Height	Width	Head Height	Sill Height	Level
W01	AW 2127	2100	2700	2400	300	GROUND FLOOR LEVEL
W02	SW 0909	900	900	2400	1500	GROUND FLOOR LEVEL
W03	AW1808	1810	850	2400	590	GROUND FLOOR LEVEL
W04	AW1808	1810	850	2400	590	GROUND FLOOR LEVEL
W05	ST 2424	2400	2400	2400	0	GROUND FLOOR LEVEL
W06	ST 2418	2400	1810	2400	0	GROUND FLOOR LEVEL
W07	AW 2127	2100	2700	2400	300	GROUND FLOOR LEVEL
W08	FW 0621	600	2100	1560	960	GROUND FLOOR LEVEL
W09	FW 0612	600	1210	1560	960	GROUND FLOOR LEVEL
W10	AW 2127	2100	2700	2400	300	FIRST FLOOR LEVEL
W11	SW 0906	900	610	-253	-1153	FIRST FLOOR CEILING LEVEL
W12	FW 2420	2400	2050	-253	-2653	FIRST FLOOR CEILING LEVEL
W13	SW 0924	900	2410	-253	-1153	FIRST FLOOR CEILING LEVEL
W14	SW 0924	900	2410	-253	-1153	FIRST FLOOR CEILING LEVEL
W15	SW 0912	900	1210	-253	-1153	FIRST FLOOR CEILING LEVEL
W16	SW 1221	1200	2170	-253	-1453	FIRST FLOOR CEILING LEVEL
W17	SW 0924	900	2410	-253	-1153	FIRST FLOOR CEILING LEVEL

			Door Schee	dule	
Туре	Height	Width	Head Height	Level	Comments
2400 x 2800	2400	2800	2325	GROUND FLOOR LEVEL	
720 x 2340	2340	720	2340	GROUND FLOOR LEVEL	
820 x 2340	2340	820	2340	GROUND FLOOR LEVEL	
800 x 2400	2400	800	2400	GROUND FLOOR LEVEL	SQ.SET
720 x 2340	2340	720	2340	GROUND FLOOR LEVEL	L-O
820 x 2340	2340	820	2340	GROUND FLOOR LEVEL	
720 x 2340	2340	720	2340	GROUND FLOOR LEVEL	
820 x 2340	2340	820	2340	GROUND FLOOR LEVEL	
820 x 2340	2340	820	2340	FIRST FLOOR LEVEL	
820 x 2340	2340	820	2340	FIRST FLOOR LEVEL	
720 x 2340	2340	720	2340	FIRST FLOOR LEVEL	L-O
820 x 2340	2340	820	2340	FIRST FLOOR LEVEL	
820 x 2340	2340	820	2340	FIRST FLOOR LEVEL	
820 x 2340	2340	820	2340	FIRST FLOOR LEVEL	
820 x 2340	2340	820	2340	FIRST FLOOR LEVEL	
800 x 2400	2400	800	2400	FIRST FLOOR LEVEL	SQ.SET
720 x 2340	2340	720	2340	FIRST FLOOR LEVEL	L-O

NOTES

Mark protection of operable windows clause 11.3.7 of the Housing Provisions 2022

(1)A window opening in a bedroom must be provided with protection, where the floor below the window is 2 m or more above the surface

(2) Where the lowest level of the window opening covered by (1) is less than 1.7 m above the floor, the window opening must comply with the

The openable portion of the window must be protected with—

a device capable of restricting the window opening; or

a screen with secure fittings.

A device or screen required by (a) must—

not permit a 125 mm sphere to pass through the window opening or screen; and

resist an outward horizontal action of 250 N against the-

window restrained by a device; or

screen protecting the opening; and

have a child resistant release mechanism if the screen or device is able to be removed, unlocked or overridden.

(3)Where a device or screen provided in accordance with (2)(a) is able to be removed, unlocked or overridden, a barrier with a height not less than 865 mm above the floor is required to an openable window

addition to window protection.



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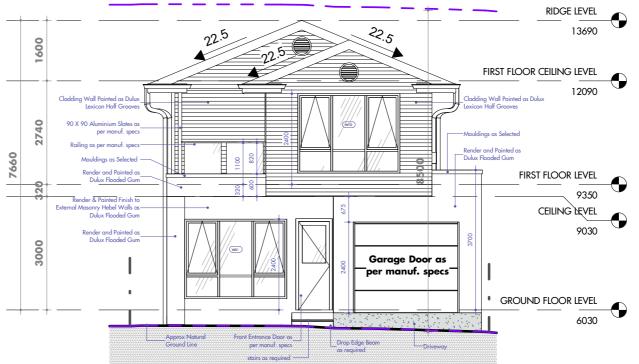
South West 1:100

DA2025/0074


CONJUNCTION WITH

CONSENT

. beaches



North East

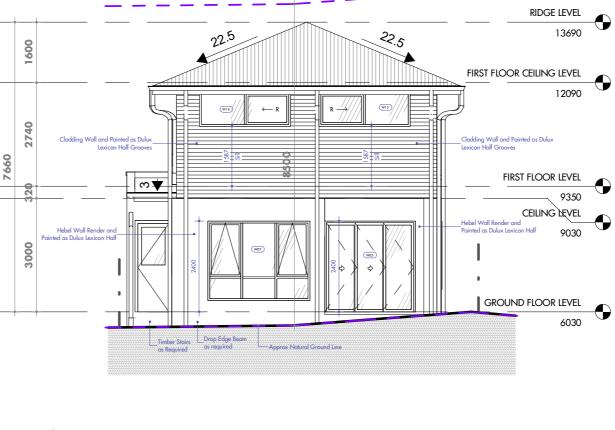



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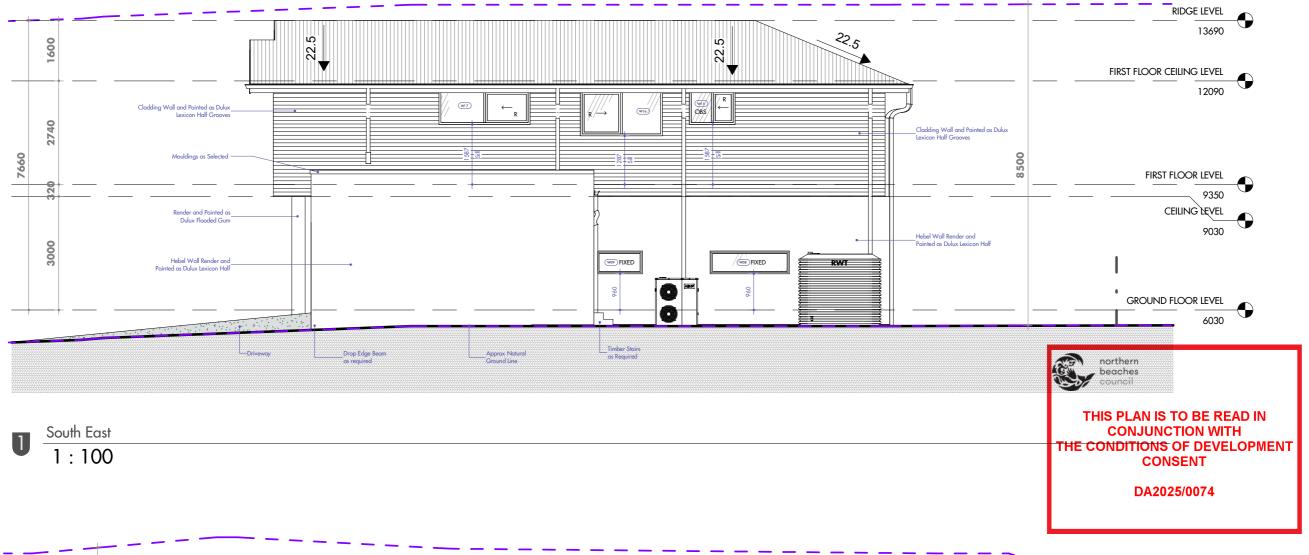
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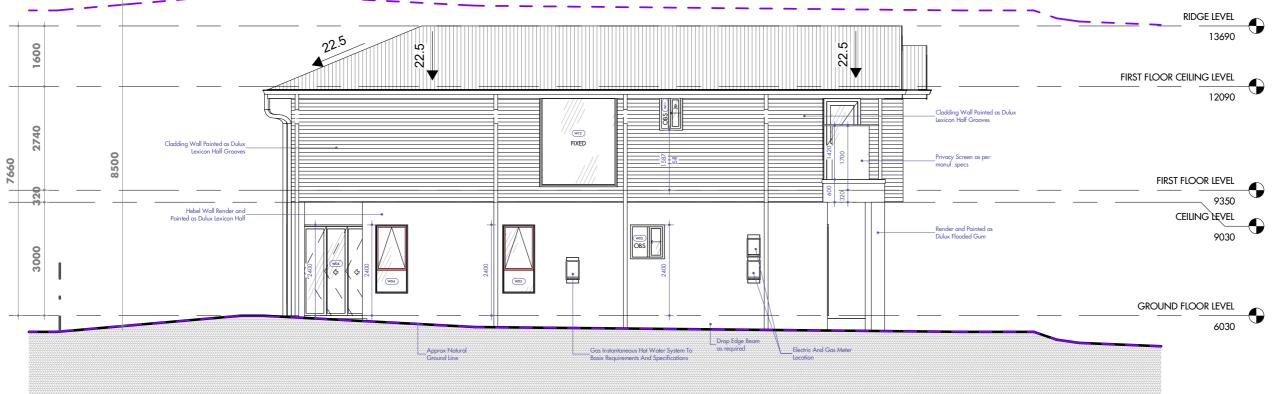




ELEVATION SHEET 1

1:100@A3







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ELEVATION SHEET 2

A1.9

2

1:100





TAG	IMAGE	DESCRIPTION	ITEM
RN1		DULUX FLOODED GUM	RENDER
RN2		DULUX LEXICON HALF	RENDER
CL1		DULUX LEXICON HALF GROOVES	CLADDING
MD		DULUX LEXICON HALF	MOULDING
AS		AS SELECTED	ALUMINIUM POST
RC		COLORBOND DOVER WHITE	ROOF COVERING
GD		AS SELECTED	GARAGE DOOR SLIMLINE SECTIONAL PROFIL
GFC		COLORBOND DOVER WHITE	GUTTER, FASCIA & DOWNPIPES COLORBOND
WDC		COLORBOND MONUMENT	WINDOWS & SLIDING DOORS ALUMINIUM POWDERCOATED
FD		AS SELECTED	FRONT DOOR PMAD104 1200W
CCD		AS SELECTED	COLOURED CONCRETE DRIVEWAY
FC		AS SELECTED	1.8M HIGH LAPPED AND CAPPED TIMBER FENCE

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	14.12.20	24		
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Scale

1 : 200 @ A

A1.10


northern beaches council

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Sheet No.






Section 1 1:100

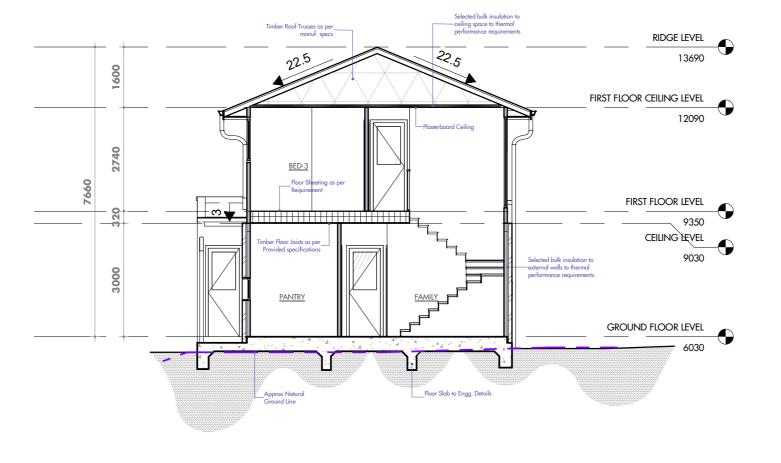

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PM	YS
Drawn by	Checked by



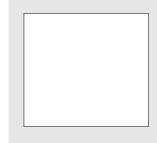

SECTIONS

LANDSCAPE NOTES

1. THIS PLAN INDICATES THE GENERAL LANDSCAPE ARRANGEMENT ONLY AND IS

FOR CONSTRUCTION.

2. ALL WEEDS TO BE REMOVED FROM SITE BY PHYSICAL REMOVAL OR BY SPRAYING

3. ALL LANDSCAPED AREA TO HAVE A MINIMUM 1:100 FALL TO STORMWATER OUTLET

POINT. REFER TO DRAINAGE DIAGRAM.

4. MULCH LEVEL IN GARDEN BEDS IS TO BE MAINTAINED MINIMUM AT 75mm 5. EXCAVATE HOLE FOR PLANTING 200mm DEEPER AND 300mm WIDER THAN THE SIZE

OF THE POT.

6. ALL GARDEN BEDS ARE TO BE PREPARED WITH A MIX OF GOOD QUALITY

AND ORGANIC FERTILIZER TO A DEPTH OF 300mm AS SHOWN IN THE TREE PLANTING

DFTAII

7. TURF AREAS ARE TO BE PREPARED WITH A MINIMUM OF 150mm GOOD QUALITY TOPSOIL


8. ALL PLANTS ARE TO BE PERIODICALLY PRUNED TO AN APPROPRIATE SIZE AND SPREAD.

9. ALL FLOOR LEVELS SHOWN ARE APPROXIMATE ONLY.

10. EXACT LEVELS TO BE DETERMINDED ON SITE.

11. NOMINATED PLATFORM LEVELS MAY VARY PLUS OR MINUS 100mm.

Mark	Туре	NATIVE	POT SIZE	HEIGHT	Count	Image
HEDGE						
SA	Syzygium australe 'Aussie Southern'	YES	200MM	2m	11	
SHRUB	·					
DG	Duranta Mini Gold	YES	150MM	500mm	4	
TREE						
TL	Tristaniopsis laurina 'Luscious'	YES	45L	8M	1	

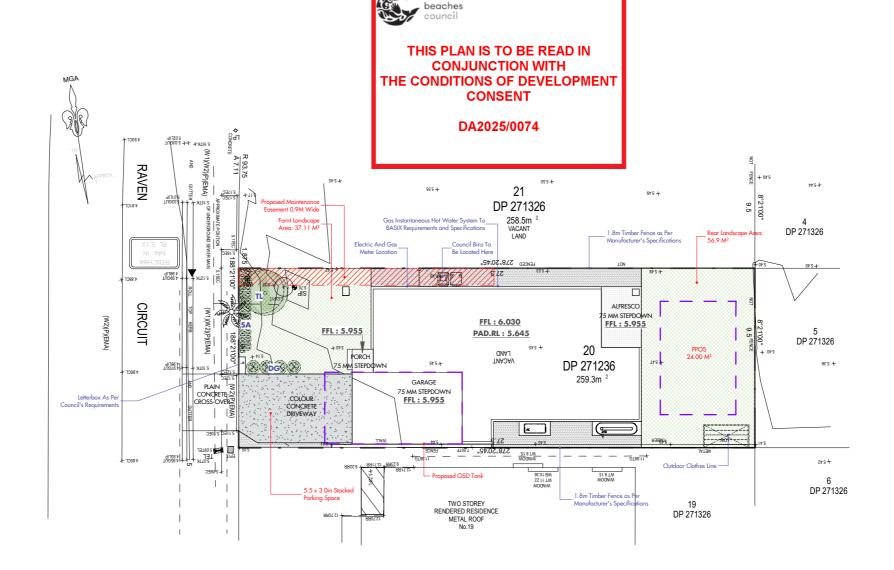



LANDSCAPE PLAN

1:200

100mm Pine Bark Mulch 300 Deep Top Soil 400mm Subgrade Preparation Deep rip to a depth of 400mm Add 50mm of composted organic material and cultivate to a depth of 300mm.

TYPICAL SHRUB/GROUND COVER PLANTING DETAIL Not To Scale

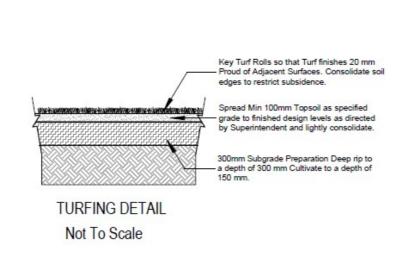

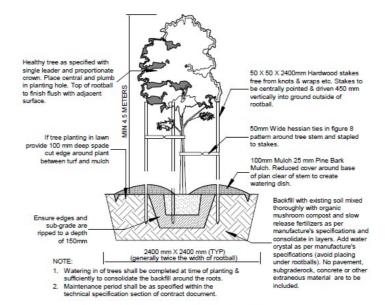

200 It TREE PLANTING DETAIL IN GRASS Not To Scale

to comprise an

25%

THE WHITE PROJECT

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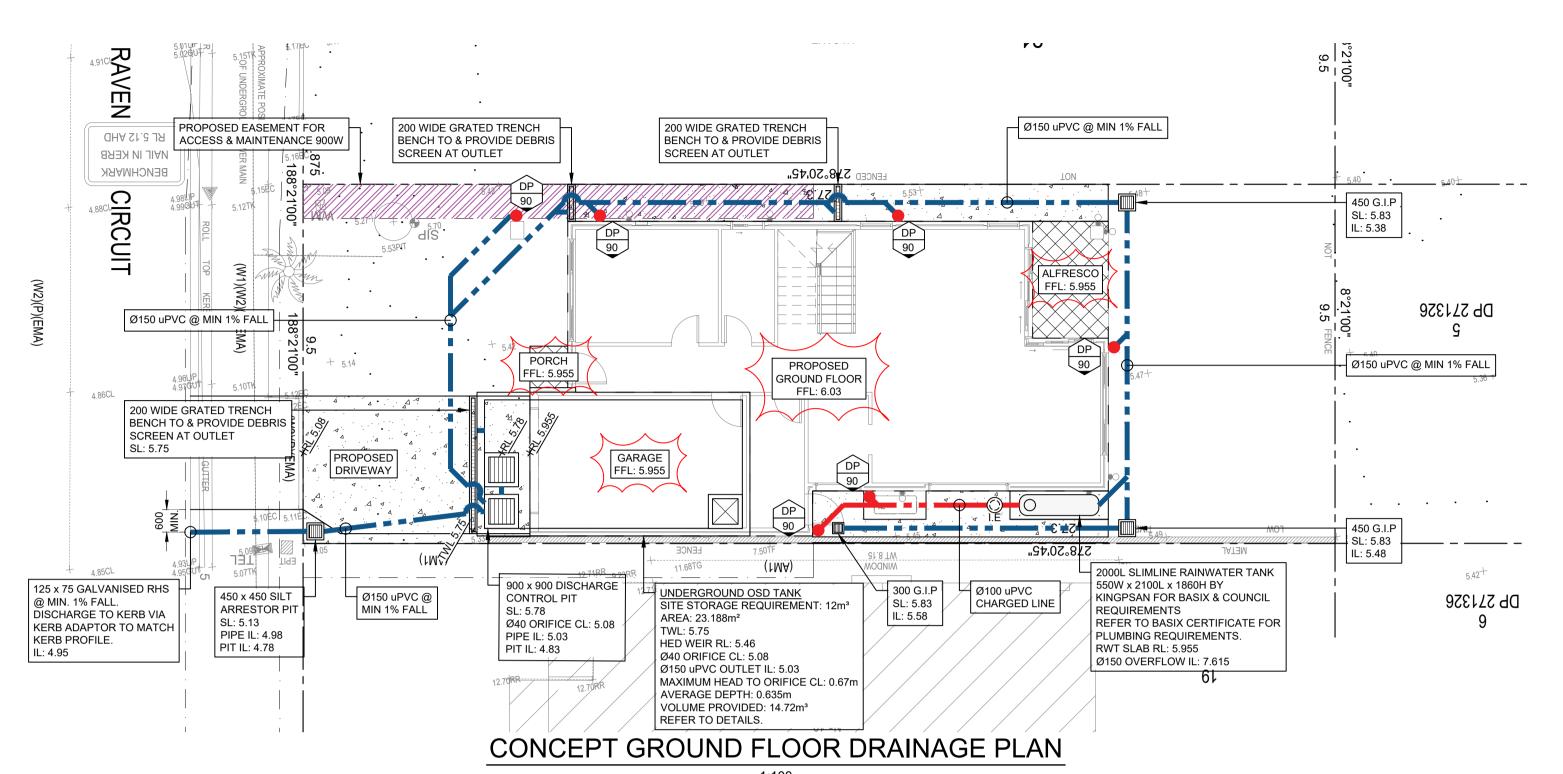
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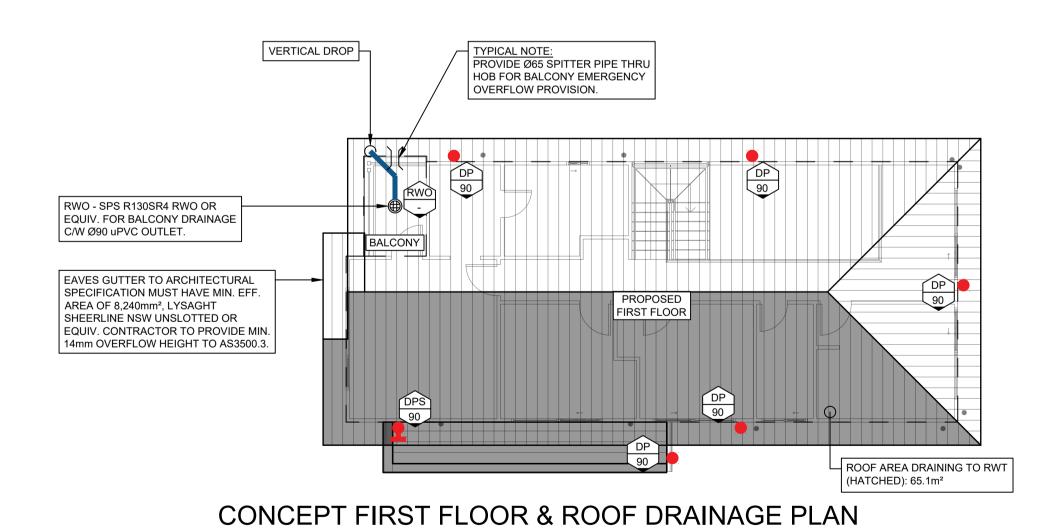
1 : 200 @ A3

LANDSCAPE PLAN






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NORTHERN BEACHES COUNCIL - REGION 1 ON-SITE DETENTION (OSD) WARRANT SITE AREA: 259.3m² PROPOSED INCREASE IN IMPERVIOUS AREA: 176.0m² OSD TANK REQUIREMENTS FROM TABLE 7 SSR: 12,000L PSD: 6L/s REFER TO ON-SITE DETENTION CALCULATION FOR DISCHARGE

CONTROL AND STORAGE CALCULATIONS



ON-SITE DETENTION CALCULATION:

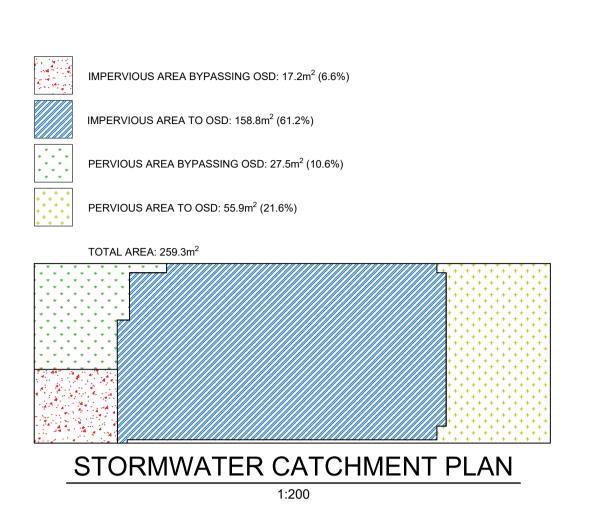PROPOSED SITE AREA = 259.3m²

PRE-DEVELOPMENT CONDITIONS:

ASSUMED PERVIOUS AREA = 259.3m² (100%)

POST-DEVELOPMENT CONDITIONS:

IMPERVIOUS AREA BYPASSING OSD = 17.2m² (6.6%) IMPERVIOUS AREA TO OSD = 158.8m² (61.2%) PERVIOUS AREA BYPASSING OSD = 27.5m² (10.6%) PERVIOUS AREA TO OSD = 55.9m² (21.6%)

VOLUME CALCULATED USING DRAINS SOFTWARE: LIMIT POST-DEVELOPMENT PEAK TO 6L/s FOR ALL STORM EVENTS UP TO THE 1% AEP AS PER COUNCIL REQUIREMENTS.

OUTPUTS
ORIFICE DIAMETER = 40mm
OSD VOLUME REQUIRED = 12m³
OSD VOLUME PROVIDED = 14.72m³

	PRE DEVELOPMENT	POST DEVELOPMENT
STORM EVENT	TOTAL FLOW L/S	TOTAL FLOW L/S
20% AEP	7	3
5% AEP	11	4
1% AEP	15	5

CONCEPT ONLY
NOT FOR CONSTRUCTION

NOTE	
DO NOT SCALE OFF DRAWINGS. REFER TO	
ARCHITECTURAL PLANS FOR LEVELS,	
STEPS, DIMENSIONS AND SETOUT. VERIFY	l
DIMENSIONS ON SITE. THE ENGINEER	
SHALL BE NOTIFIED OF ANY VARIATIONS	
TO THAT SHOWN ON STRUCTURAL PLANS	
BEFORE COMMENCEMENT OF WORKS	

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REV	DATE	DESCRIPTION	BY	·



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PROPOSED	J
SINGLE DWELLING	2
AT: LOT 20 RAVEN CIRCUIT, WARRIEWOOD NSW 2102 FOR: NEEV HOMES	J
CONCERT STORMWATER REALMACE	
CONCEPT STORMWATER DRAINAGE	D

PLAN / NOTES

JOB NUMBER:	DWG NUMBER:	ORIGINAL SIZE:
250018	C001	A1
DESIGNED BY:	DATE:	
J.L	22/01/2025	
DRAWN BY: J.L	SCALE: AS SHOWN	