25 ALLEYNE AVE, NORTH NARRABEEN

TROY CARTER

PROPOSED NEW DWELLING HOUSE & ASSOCIATED LANDSCAPING

25 ALLEYNE AVE NORTH NARRABEEN

DA DOCUMENTATION SCHEDULE

DWG NO.	TITLE	SCALE	REV.	DATE:	DESCRIPTION:
DA 000	Cover Page & Drawing Schedule	NTS	-	21.10.21	DA
DA 001	Site Plan	1:100 @ A1 / 1:200 @ A3	-	21.10.21	DA
DA 100	Lower Ground General Arrangement Floor Plan	1:50 @ A1 / 1:100 @ A3	-	21.10.21	DA
DA_101	Ground Floor General Arrangement Floor Plan	1:50 @ A1 / 1:100 @ A3	-	21.10.21	DA
DA_102	First Floor General Arrangement Floor Plan	1:50 @ A1 / 1:100 @ A3	-	21.10.21	DA
DA_300	Elevations Sheet 01	1:50 @ A1 / 1:100 @ A3	-	21.10.21	DA
DA 301	Elevations Sheet 02	1:50 @ A1 / 1:100 @ A3	-	21.10.21	DA
DA 302	Elevations Sheet 03	1:50 @ A1 / 1:100 @ A3	-	21.10.21	DA
DA 303	Elevations Sheet 04	1:50 @ A1 / 1:100 @ A3	-	21.10.21	DA
DA_400	Section Sheet 01	1:50 @ A1 / 1:100 @ A3	-	21.10.21	DA
DA_401	Section Sheet 02	1:50 @ A1 / 1:100 @ A3	-	21.10.21	DA
DA_500	Landscape Concept Plan	1:100 @ A1 / 1:200 @ A3	-	21.10.21	DA
DA_501	Site Analysis Plan	1:100 @ A1 / 1:200 @ A3	-	21.10.21	DA
DA_502	Waste Management, Sediment Control & Erosion Plan	1:100 @ A1 / 1:200 @ A3	-	21.10.21	DA
DA 503	Vehicle Crossing & Driveway gradient	1:50 @ A1 / 1:100 @ A3	-	21.10.21	DA
DA 900	9am Shadow Diagram Plan	1:100 @ A1 / 1:200 @ A3	-	21.10.21	DA
DA_901	12pm Shadow Diagram Plan	1:100 @ A1 / 1:200 @ A3	-	21.10.21	DA
DA_902	3pm Shadow Diagram Plan	1:100 @ A1 / 1:200 @ A3	-	21.10.21	DA

EXTERNAL FINISHES SCHEDULE



EXTERNAL MATERIALS BOARD

TIAL DWELLING INCL. NEW SWIM







SCHEDULE OF BASIX COMMITTMENTS

Project name - Carter House - Main dwelling Street address - 25 Alleyne Avenue North Narrabeen 2101 Local Government Area Plan type Deposited Plan 7593 Lot no.52 Northern Beaches Council Project type - separate dwelling house No. of bedrooms - 5 Site details Site area (m2) 558 Roof area (m2) 199 Conditioned floor area (m2) 318.3 Unconditioned floor area (m2) 15.0 Total area of garden and lawn (m2) 228

Water Commitments

throughout 80 square metres of the site.

Fixtures

4.5 but <= 6 L/min plus spray force and/or coverage tests) in all showers in Ceiling fan to dining & bed 1 (primary) the development

The applicant must install a toilet flushing system with a minimum rating of Energy Commitments 6 star in each toilet in the development. The applicant must install taps with a minimum rating of 6 star in the kitchen in the development. The applicant must install basin taps with a minimum rating of 6 star in each bathroom in the development.

Alternative water

Rainwater tank The applicant must install a rainwater tank of at least 3000 litres on the site. This rainwater tank must meet, and be installed in accordance with, the requirements of all applicable regulatory authorities. The applicant must configure the rainwater tank to collect rain runoff from at least 150 square metres of the roof area of the development (excluding the area of the roof which drains to any stormwater tank or private dam). The applicant must connect the rainwater tank to:

at least one outdoor tap in the development (Note: NSW Health does not recommend that rainwater be used for human consumption in areas with potable water supply.)

Project name - Carter House - Secondary dwelling

Street address - 25 Alleyne Avenue North Narrabeen 2101 Local Government Area Plan type Deposited Plan 7593 Lot no.52 Northern Beaches Council Project type - separate dwelling house No. of bedrooms - 2 Site details Site area (m2) 558 Roof area (m2) 60 Conditioned floor area (m2) 48 Unconditioned floor area (m2) 12.0 Total area of garden and lawn (m2) 35

Water Commitments

Landscape

throughout 80 square metres of the site.

Fixtures

the development. The applicant must install a toilet flushing system with a minimum rating of accommodate a heating system.

6 star in each toilet in the development. The applicant must install taps with a minimum rating of 6 star in the kitchen in the development. The applicant must install basin taps with a minimum rating of 6 star in each bathroom in the development

Thermal Comfort Commitments

Minimum R2.5 insulation to all external walls R5.0 insulation to ceilings R2.5 insulation to walls between house & subfloor/earth Weatherseals to all external doors & windows Foil + R1.0 insulation blanket underside of roof Medium/dark walls & medium roof colours Default floor covering used in NatHERS rating Insulation must be installed in accordance with NCC and relevant Australian Standards. Recessed downlights have been included in the NatHERS rating(to be

Ventilation The applicant must install the following exhaust systems in the At least 1 Bathroom: individual fan, not ducted; Operation control: manual switch on/off Kitchen: individual fan, ducted to façade or roof; Operation control: manual switch on/off Laundry: natural ventilation only, or no laundry; Operation control: n/a Artificial lighting The applicant must ensure that the "primary type of artificial lighting" is fluorescent or light emitting diode (LED) lighting in each of the following rooms, and where the word "dedicated" appears, the fittings for those lights must only be capable of accepting fluorescent or light emitting diode (LED) lamps: at least 5 of the bedrooms / study; at least 2 of the living / dining rooms: Natural lighting The applicant must install a window and/or skylight in 4 bathroom(s)/toilet(s) in the development for natural lighting. Swimming pool The development must not incorporate any heating system for the swimming pool. The applicant must install a timer for the swimming pool pump in the development. Alternative energy The applicant must install a photovoltaic system with the capacity to generate at least 3 peak kilowatts of electricity as part of the development. The applicant must connect this system to the development's electrical Othe the dwelling. The applicant must construct each refrigerator space in the development so that it is "well ventilated", as defined in the BASIX definitions. Heating system The applicant must install a fixed outdoor clothes drying line as part of the at least 2 of the bedrooms / study: at least 1 of the living / dining rooms; all hallways: dedicated Natural lighting The applicant must install a window and/or skylight in the Kitchen in the development for natural lighting. The applicant must install a window and/or skylight in 1 bathroom(s)/toilets(s) in the development for natural light. Other The applicant must install a gas cooktop & electric oven in the kitchen of the dwelling. The applicant must construct each refrigerator space in the development so that it is "well ventilated", as defined in the BASIX definitions. The applicant must install a fixed outdoor clothes drying line as part of the development

Swimming pool The swimming pool must not have a volume greater than 18 kilolitres. The swimming pool must be outdoors. **Thermal Comfort Commitments** Weatherseals to all external doors & windows Foil + R1.0 insulation blanket underside of roof Medium/dark walls & medium roof colours Default floor covering used in NatHERS rating Insulation must be installed in accordance with NCC and relevant Australian Standards. All windows & glazed doors to have a U value less than or = to 4.90 & with 10% of SHGC 0.33(primary) All windows & glazed doors to be single glazed clear with aluminium Hot water The applicant must install the following hot water system in the development, or a system with a higher energy rating: gas instantaneous. Cooling system The applicant must install the following cooling system, or a system with a The applicant must install the following cooling system, or a system with a The applicant must install a gas cooktop & electric oven in the kitchen of The living areas must not incorporate any heating system, or any ducting which is designed to accommodate a heating system. The bedrooms must development. sealed LED downlights) All windows & glazed doors to have a U value less than or = to 4.90 & with 10% of SHGC 0.33(primary) All windows & glazed doors to be single glazed clear with aluminium frame(Less than or = to U 6.70, within 10% of SHGC 0.70)(secondary) Hot water The applicant must install the following hot water system in the development, or a system with a higher energy rating: gas instantaneous. Cooling system The applicant must install the following cooling system, or a system with a higher energy rating, in at least 1 living area: ceiling fans; Energy rating: n/a Heating system not incorporate any heating system, or any ducting which is designed to Ventilation The applicant must install the following exhaust systems in the

Minimum R2.5 insulation to all external walls R5.0 insulation to ceilings R2.5 insulation to walls between house & subfloor/earth Recessed downlights have been included in the NatHERS rating(to be higher energy rating, in at least 1 living area; ceiling fans; Energy rating; higher energy rating, in at least 1 bedroom: ceiling fans; Energy rating: n/a not incorporate any heating system, or any ducting which is designed to accommodate a heating system. Ceiling fan to dining & bed 1 (primary) **Energy Commitments** higher energy rating, in at least 1 bedroom: ceiling fans; Energy rating: n/a

Landscape Recessed downlights have The applicant must plant indigenous or low water use species of vegetation sealed LED downlights) The applicant must install showerheads with a minimum rating of 4 star (> frame(Less than or = to U 6.70, within 10% of SHGC 0.70)(secondary) The applicant must plant indigenous or low water use species of vegetation The applicant must install the following cooling system, or a system with a The applicant must install showerheads with a minimum rating of 4 star (> The living areas must not incorporate any heating system, or any ducting 4.5 but <= 6 L/min plus spray force and/or coverage tests) in all showers in which is designed to accommodate a heating system. The bedrooms must

development At least 1 Bathroom: individual fan, not ducted; Operation control: manual switch on/off Kitchen: individual fan, ducted to façade or roof; Operation control: manual switch on/off

Laundry: individual fan, ducted to facade or roof; Operation control: manual switch on/off

Artificial lighting

The applicant must ensure that the "primary type of artificial lighting" is fluorescent or light emitting diode (LED) lighting in each of the following rooms, and where the word "dedicated" appears, the fittings for those lights must only be capable of accepting fluorescent or light emitting diode (LED) lamps

LEGEND:	<u>KEY:</u>	PROJECT:	PROJECT STAGE:
Content of the second s	DENOTES PROPOSED STRUCTURES	PROPOSED NEW DWELLING HOUSE	DA
RL 7.10 DENOTES PROPOSED LEVEL DENOTES PROPOSED WALLS DENOTES OUTLINE OF EXISTING	DENOTES OUTLINE OF EXISTING STRUCTURES TO BE DEMOLISHED DENOTES AREA OF SOFT DENOTES AREA OF SOFT	CLIENT: TROY CARTER	DRAWING TITLE: COVER PAGE
TO BE DEMOLISHED NOTE: THESE DRAWINGS ARE NOT FOR CONSTRUCTION. FOR DA APPROVAL ON NOTE: DO NOT SCALE OFF THIS DRAWING NOTE: ALL WORKS TO BE IN ACCORDANCE WITH THE B.C. NOTE: ALL WORKS TO BE IN ACCORDANCE WITH THE RELEVANT AUSTRALIAN S' NOTE: ALL WORKS TO BE IN ACCORDANCE WITH THE BASIX REQUIREMENTS		LOCATION: 25 ALLEYNE AVE, NORTH NARRABEEN, 2101, NSW	SCALE: NTS

DATE OF ISSUE: 14.10.2021	
DRAWING NO. DA-000	

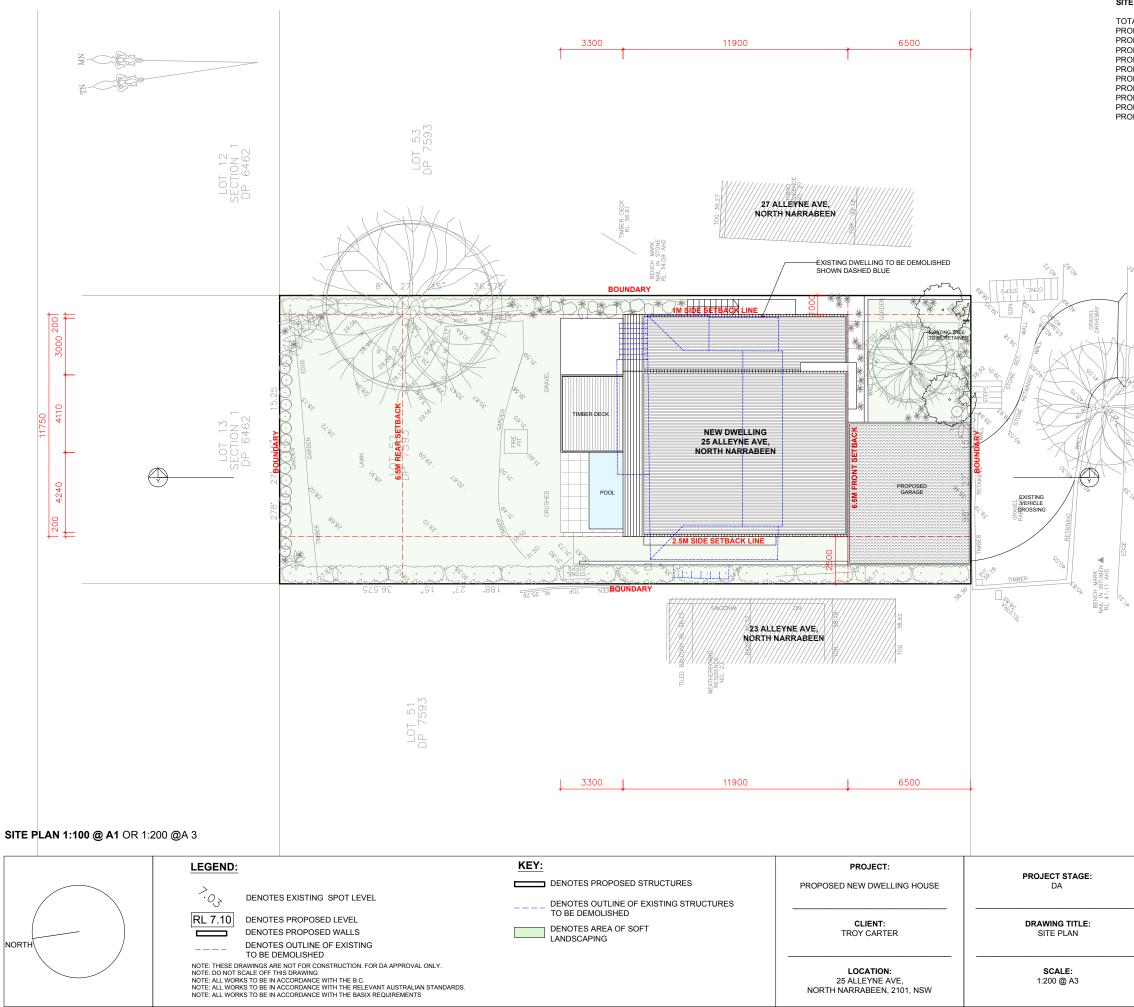
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daniel raymond architect nsw reg. #9788

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e. dan@ra



SITE CALCULATIONS

- TOTAL SITE AREA PROPOSED TOTAL GROSS FLOOR AREA INC. SECONDARY DWELLING PROPOSED GARAGE AREA PROPOSED LOWER GROUND GROSS FLOOR AREA PROPOSED LOWER GROUND GROSS FLOOR AREA PROPOSED GROUND FLOOR GROSS FLOOR AREA PROPOSED FIRST FLOOR GROSS FLOOR AREA PROPOSED ROOF AREA
- PROPOSED SECONDARY DWELLING PROPOSED POOL VOLUME PROPOSED HARD SURFACE AREA
- PROPOSED TOTAL SOFT LANDSCAPE AREA

557.8m² 317m² 37m² 70m² 120m² 67m² 199m² 60m² 18m³ 245 7m² 245.7m² (44%) 312.1m² (56%)

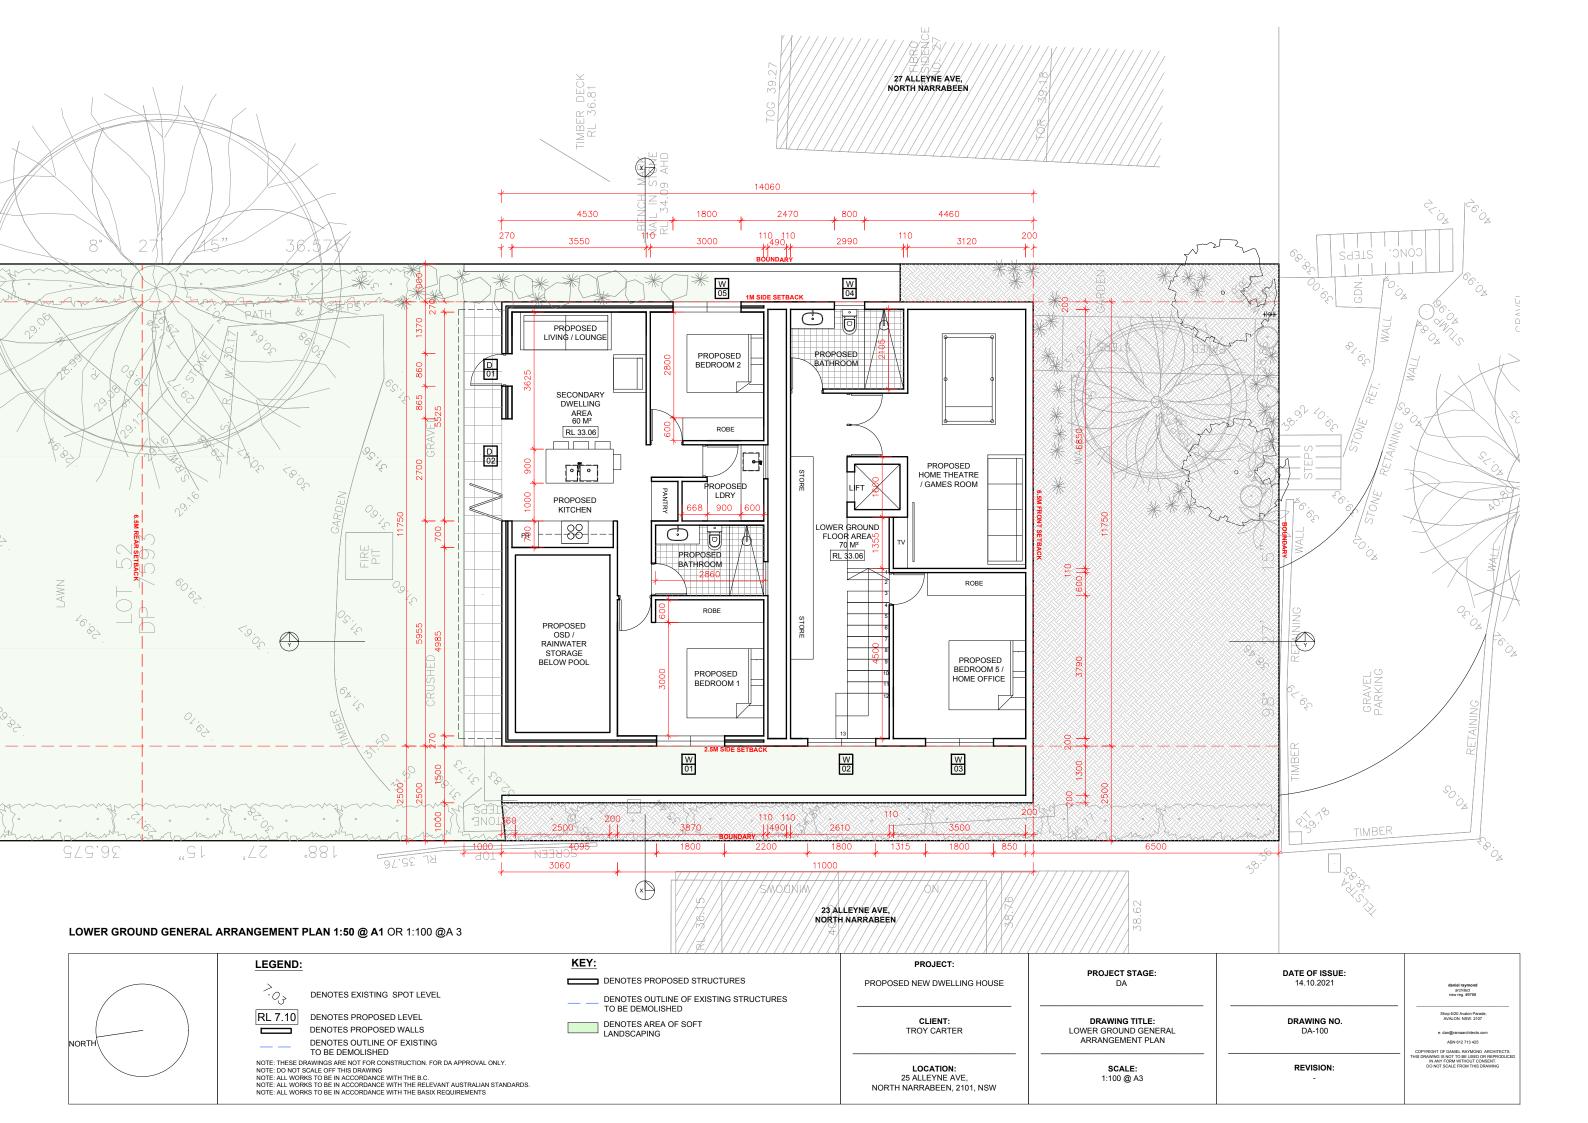


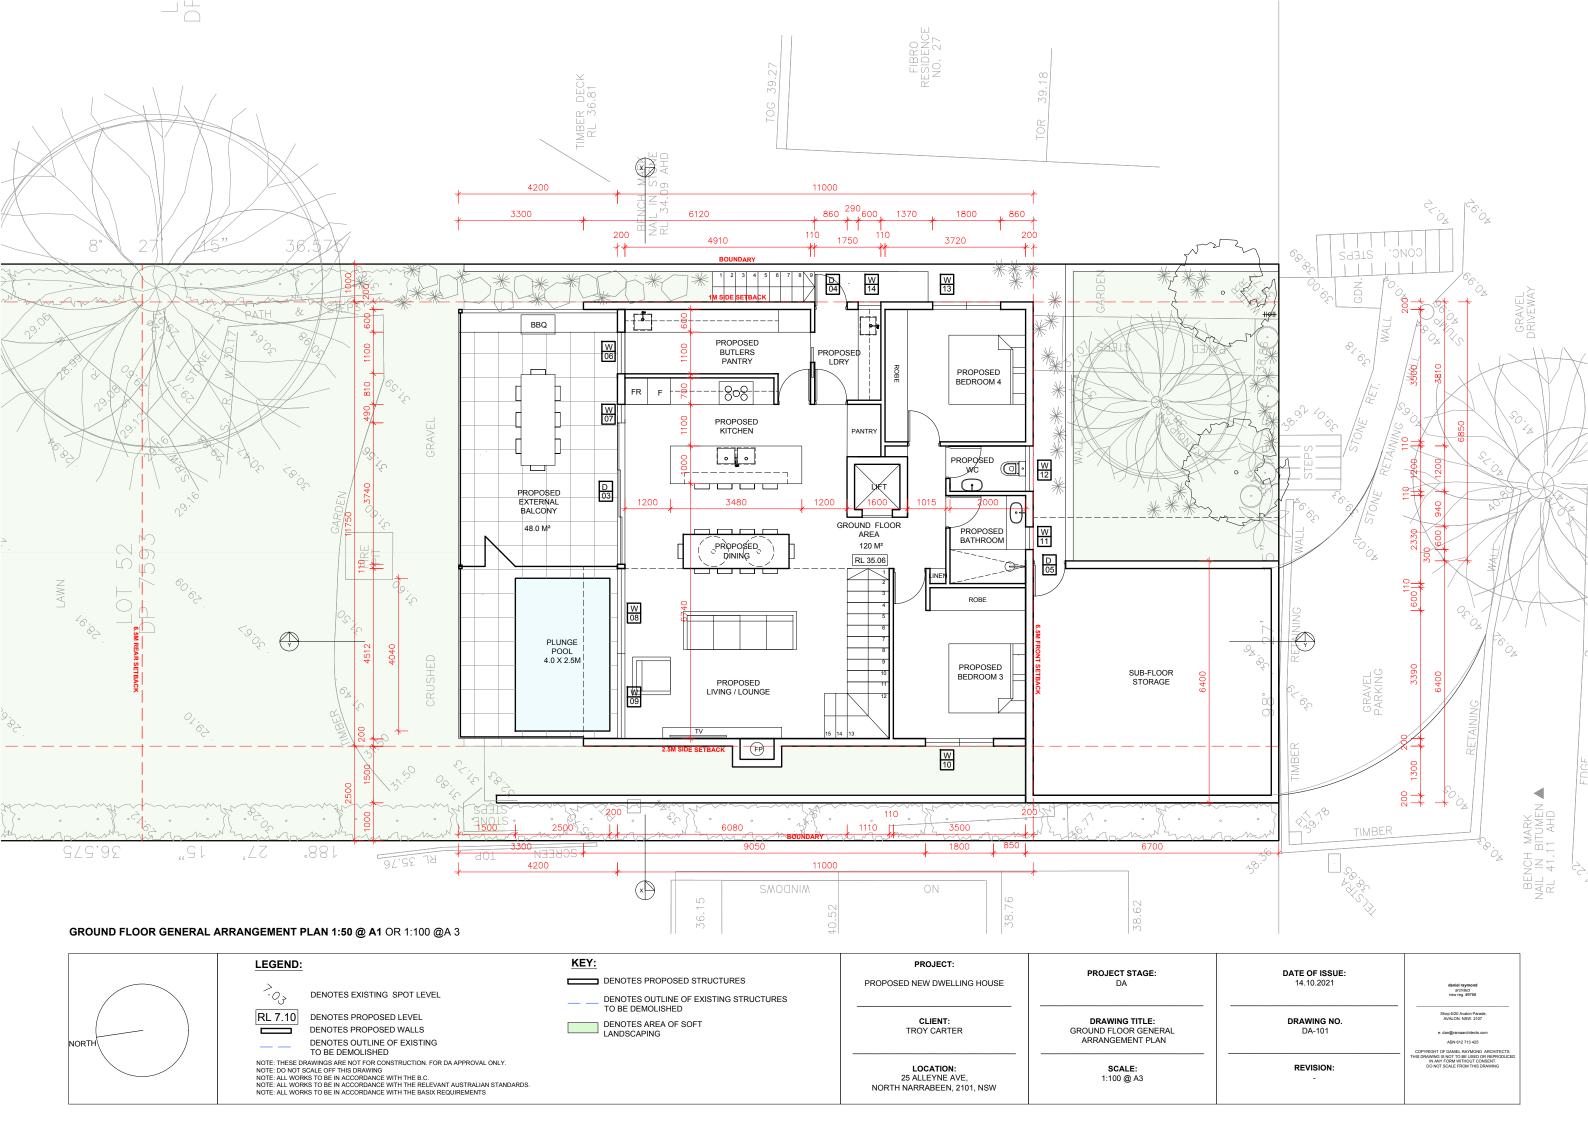
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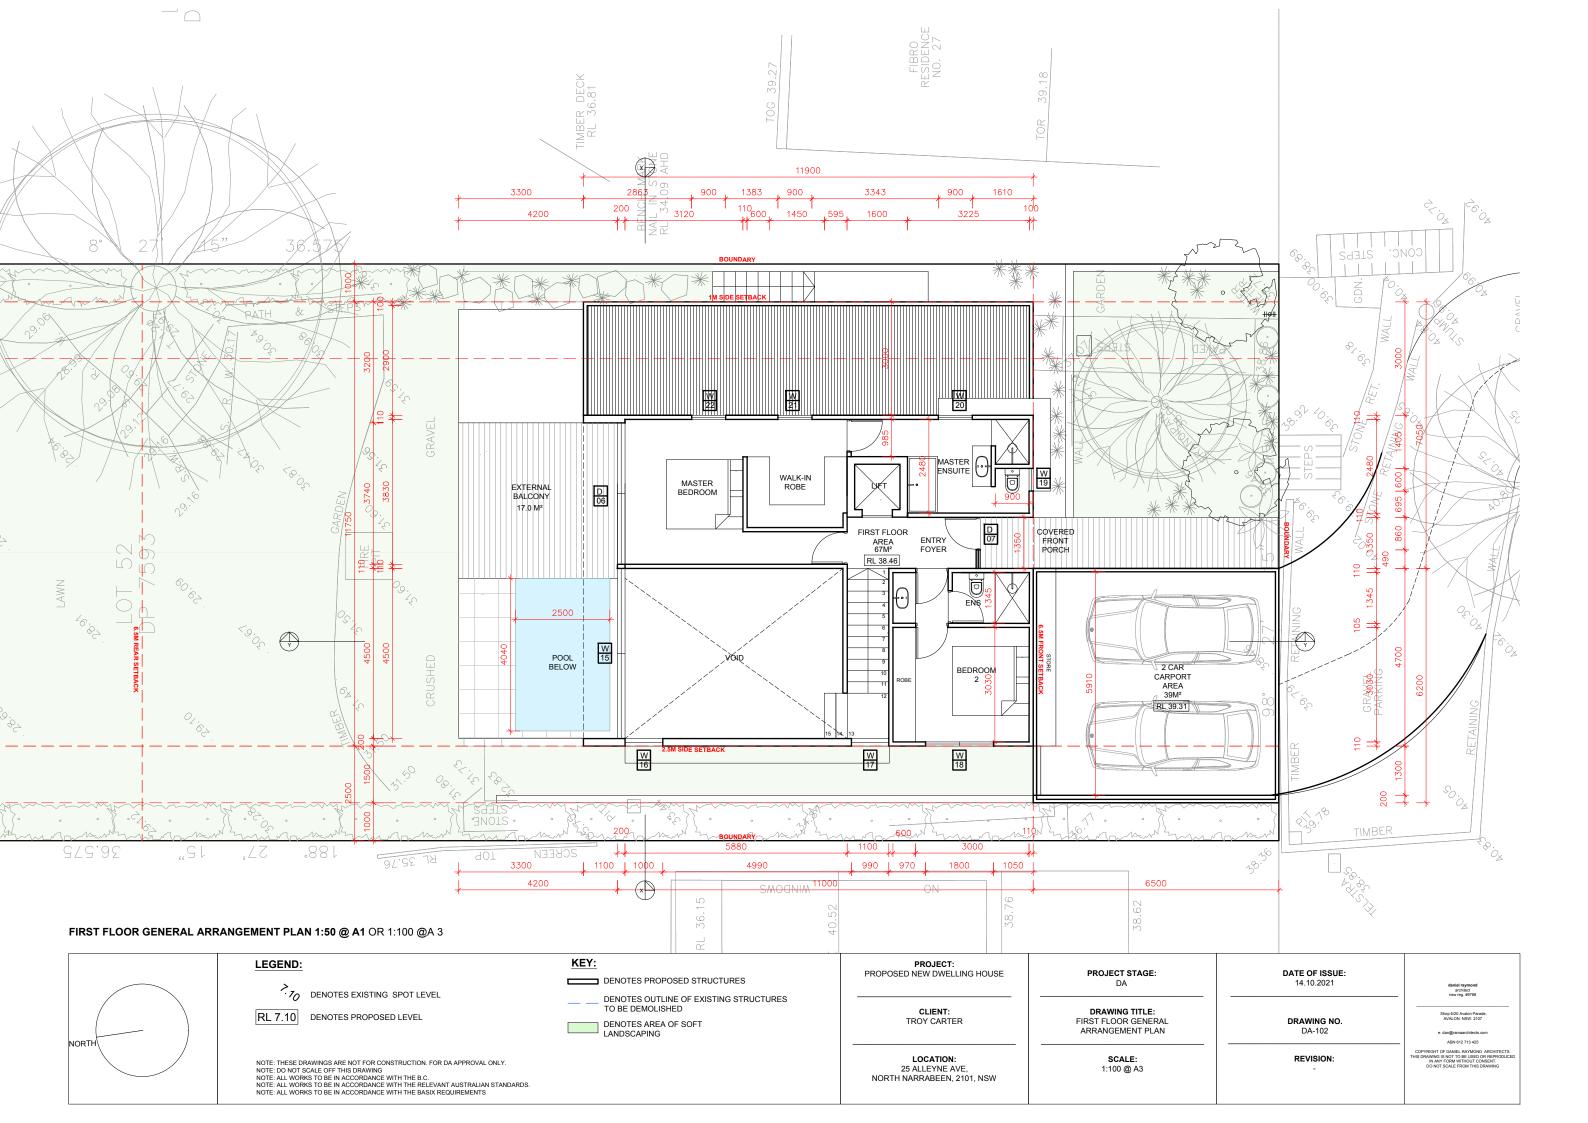
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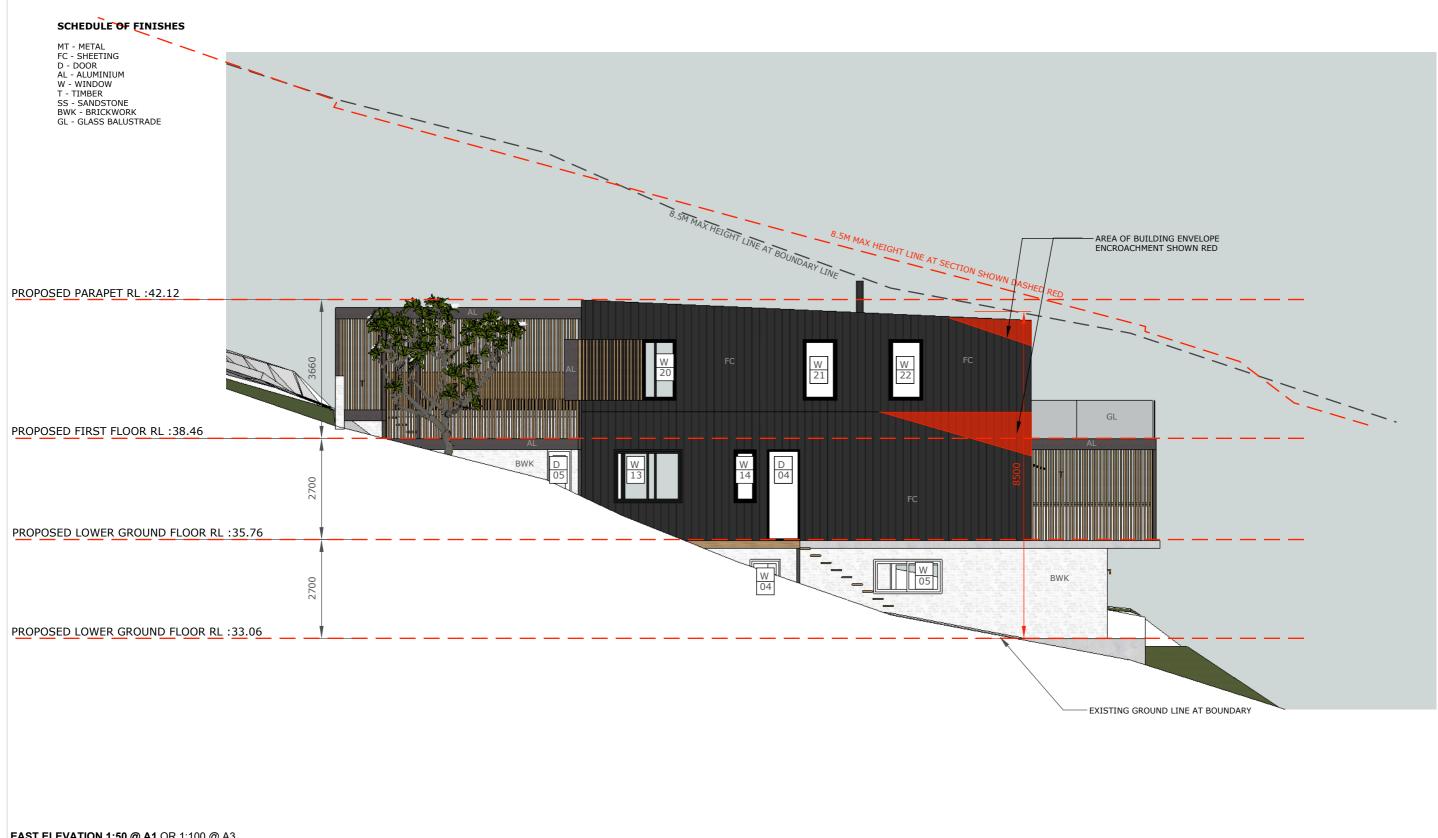


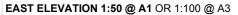
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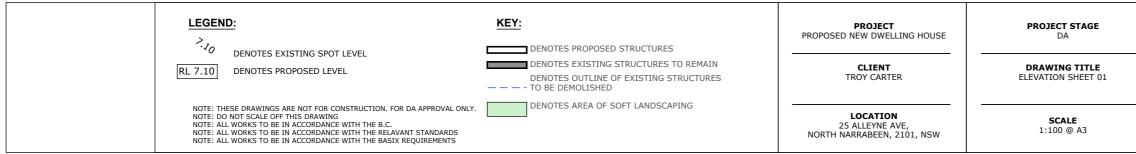




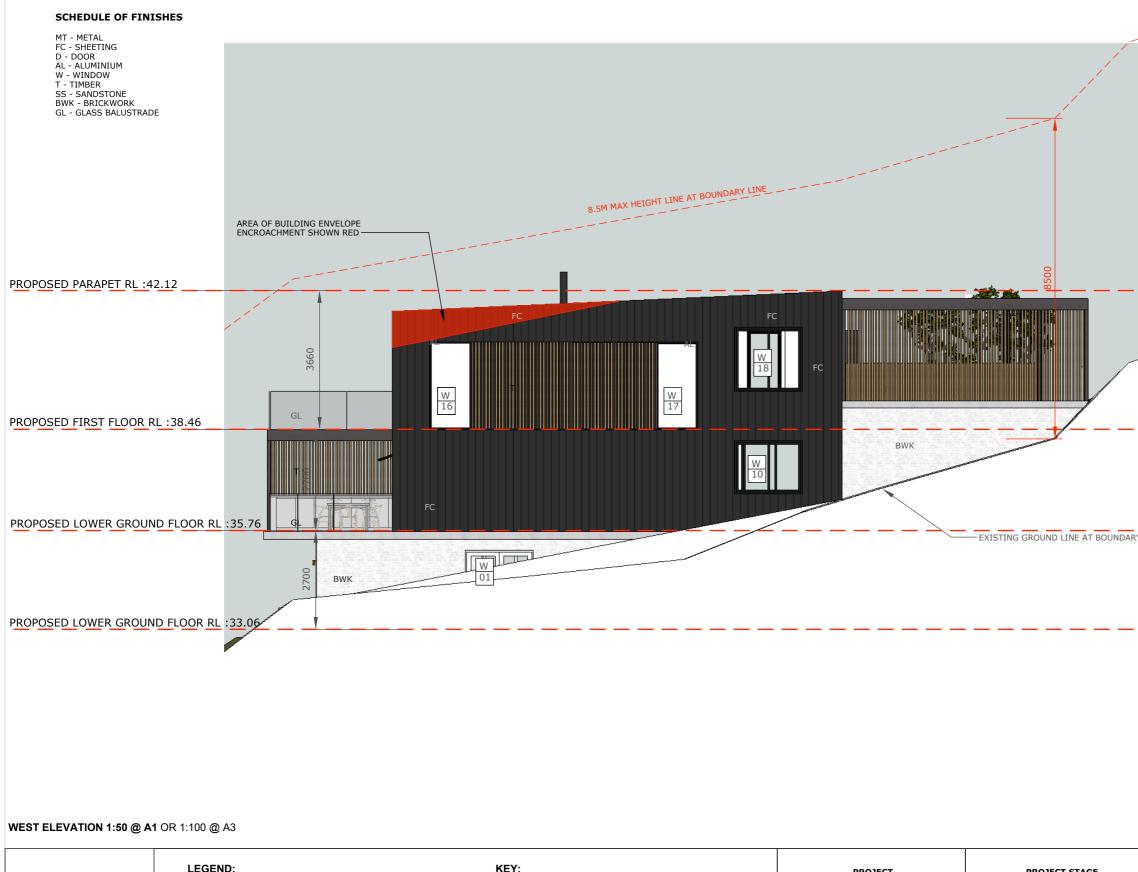


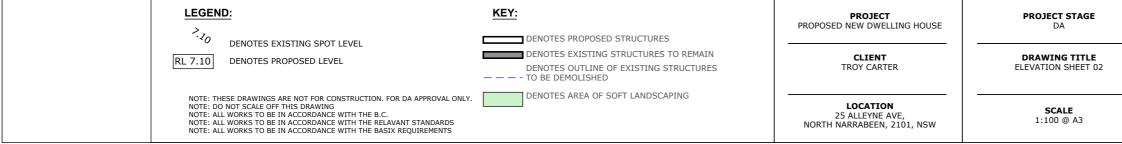






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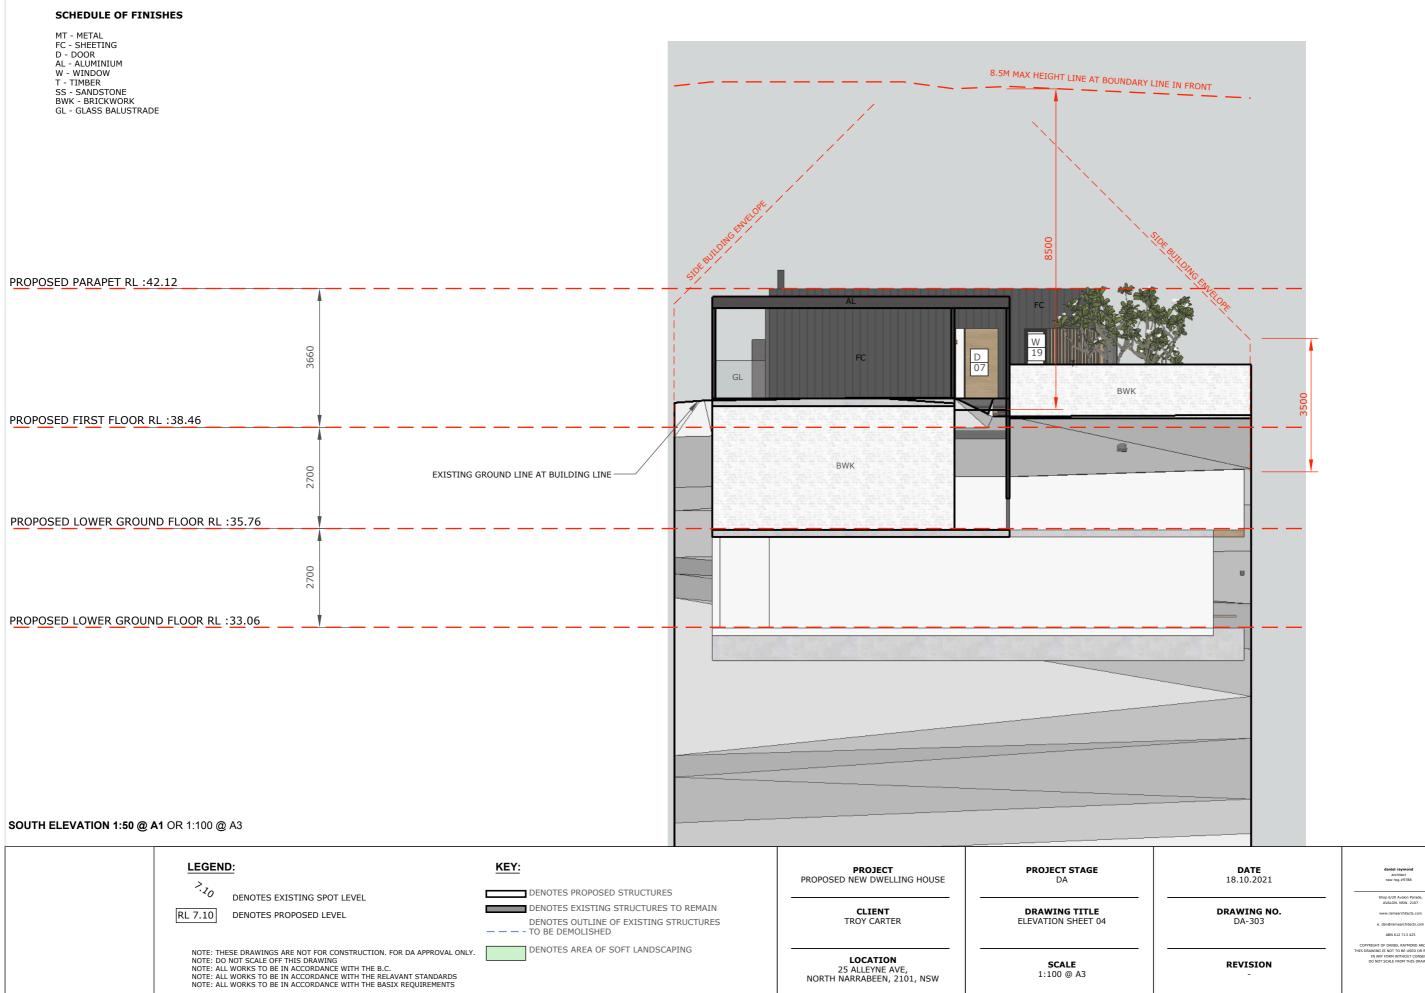
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SCHEDULE OF FINISHES

MT - METAL FC - SHEETING D - DOOR AL - ALUMINIUM W - WINDOW T - TIMBER SS - SANDSTONE BWK - BRICKWORK GL - GLASS BALUSTRADE

PROPOSED FIRST FLOOR RL :38.46 PROPOSED LOWER GROUND FLOOR RL :35.76 PROPOSED LOWER GROUND FLOOR RL :33.06	AREA OF BUILDING ENVELOPE ENCROACHMENT SHOWN RED		
NORTH ELEVATION 1:50 @ A1 OR 1:100 @ A3			
LEGEND:		PROJECT PROPOSED NEW DWELLING HOUSE CLIENT TROY CARTER LOCATION 25 ALLEYNE AVE, NORTH NARRABEEN, 2101, NSW	PROJECT STAGE DA DRAWING TITLE ELEVATION SHEET 03 SCALE 1:100 @ A3





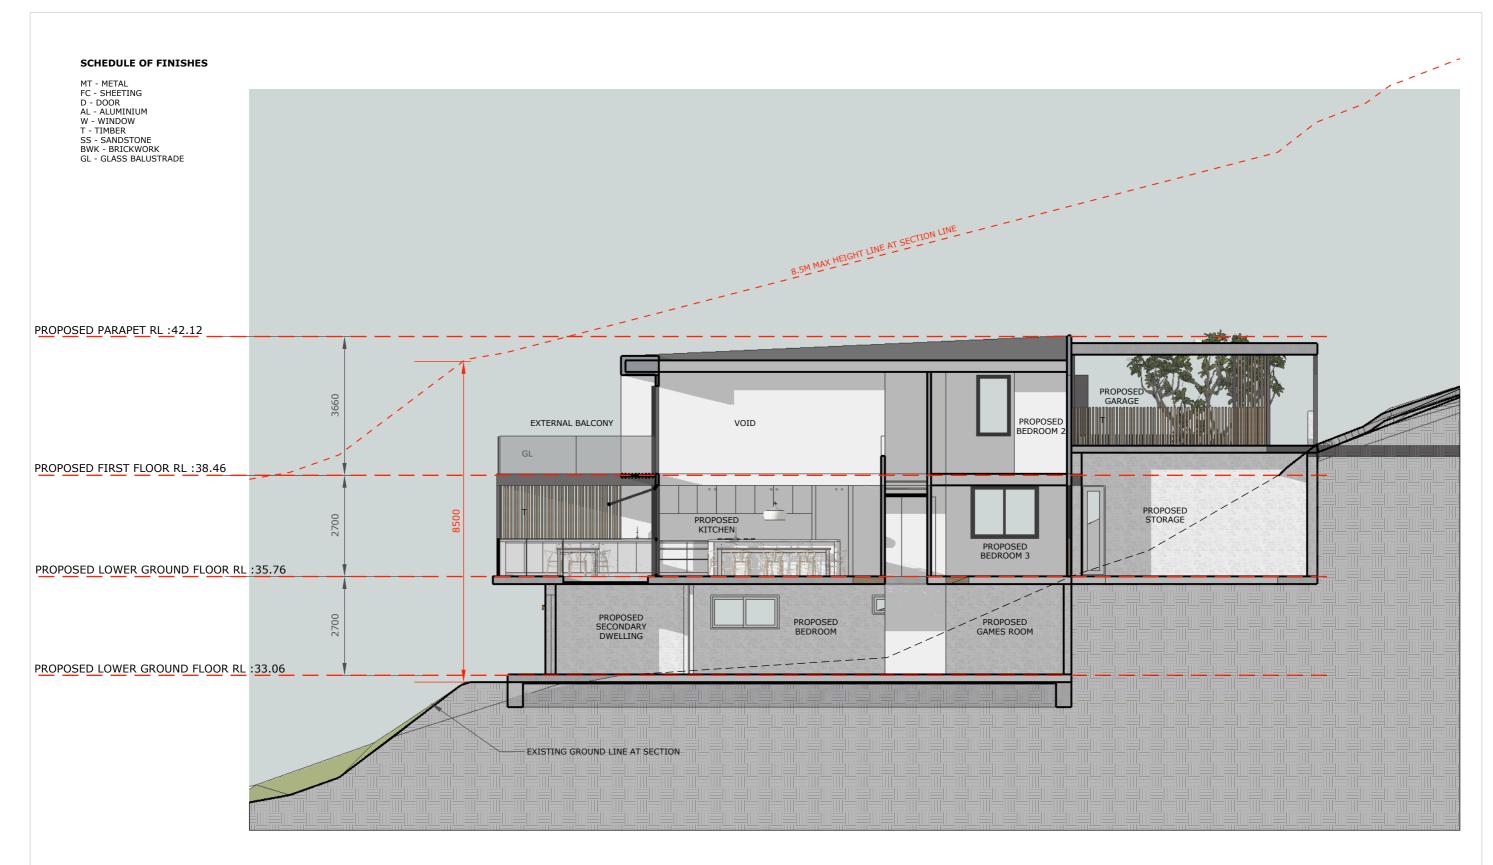
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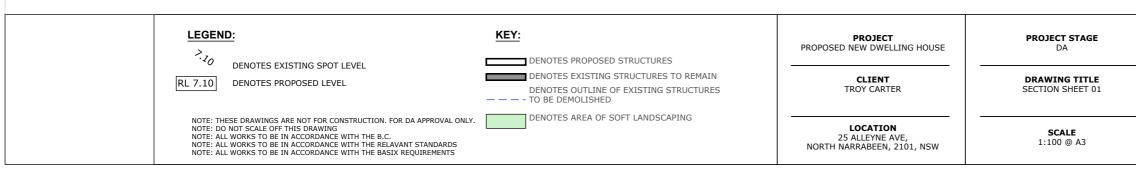
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SECTION Y 1:50 @ A1 OR 1:100 @ A3



	DATE
18	.10.2021

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REVISION

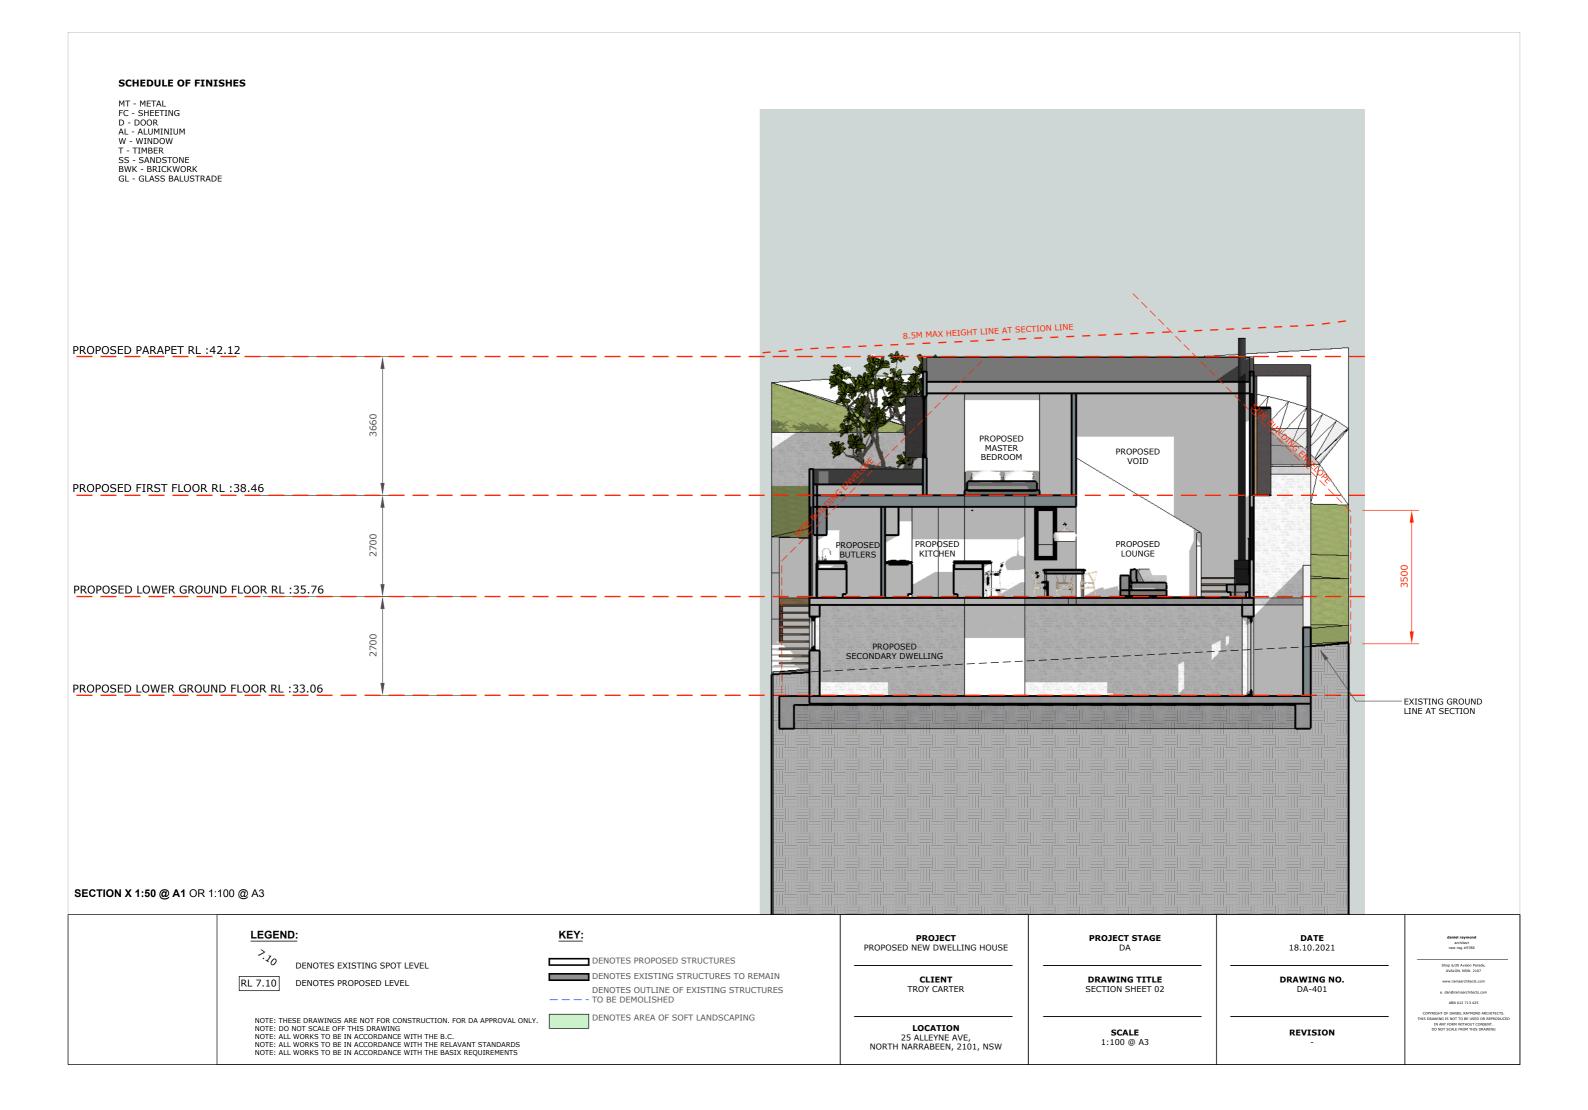
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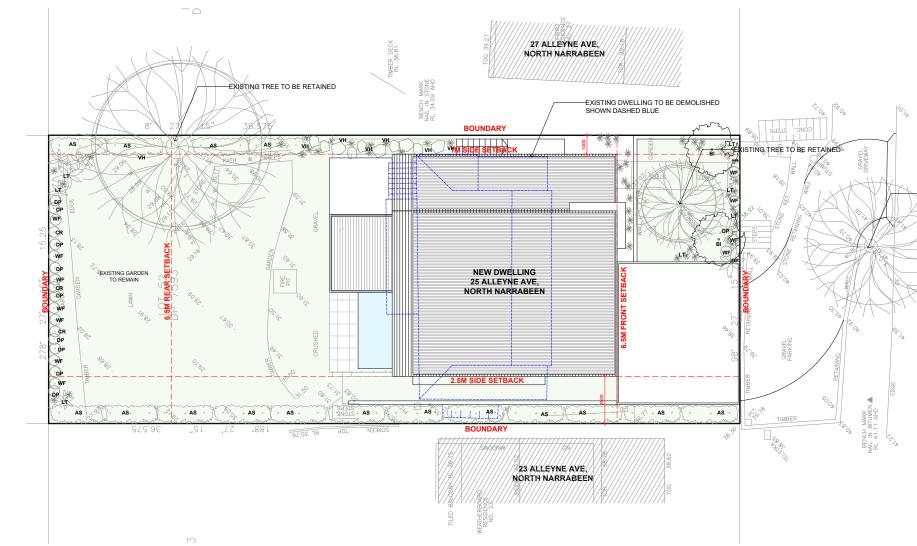
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KEY:

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DENOTES CALCULATED SOFT LANDSCAPE AREA
DENOTES GRASS LAWN AREA
DENOTES CONCRETE DRIVEWAY SURFACE

DENOTES OUTLINE OF EXISTING BUILDING TO BE DEMOLISHED

DENOTES PROPOSED FEATURE TREE

DENOTES EXISTING TREE

DENOTES PROPOSED SHRUB

DENOTES PROPOSED SCREENING HEDGE

DENOTES PRPOSED FEATURE PLANT

ID	QUANTITY	BOTANICAL NAME	COMMON NAME S	SCHEDULED SIZE
TREES				
BI	2	BANKSIA INTEGRIFOLIA	COASTAL BANKSIA	75LT
AS	16	ACMENA SMITHII	BROAD-LEAF LILLYPILLY	45LT
SHRUBS				
WF	11	WESTRINGIA FRUTICOSA	COASTAL ROSEMARY	300MM
CR	3	CORREA REFLEXA	COMMON CORREA	300MM
DP	11	DORYANTHES PALMERI	GYMEA LILLY	300MM
GRASSES/ GROUNDCOVER	<u>s</u>			
LT	7	LOMANDRA LONGIFOLIA	SPINY-HEADED MAT RUS	SH 100MM
VH	12	VIOLA HEDERACEA	NATIVE VIOLET	100MM
LM	-	LIROPE'EVERGREEN GIANT'	GIANT MONDO GRASS	150MM
DR	-	DICHONDRA REPENS	KIDNEY WEED	100MM
с		CARPOBROTUS	PIGFACE	100MM

LANDSCAPE CONSTRUCTION NOTES

TREE PROTECTION. All lees normanised to be retained are to be protected throughout the duration of the demolition and construction periods. All tree protection enclosures must be established prior to commencement of demolition works and shall comprise a fence enclosure around the P2 of the tree. The project Arborist must be present to supervise any excavation, trenching or tunneling within the P2 of any retained trees if required. Keep the area within the enclosure free of construction material and detris. Do not place built materials and harmful materials under or near trees. Do not place spoil from excavations against tree trunks. Prevent wind-blown materia such as cement from harming trees and plants.	ils Tamp pebb
Do not cut tree roots exceeding 50mm diameter. Where it is necessary to cut tree roots, use handsaw, cut deanly, do not rip with machinery and such that the cutil does not undity disturb the remaining root system. If damage does occur to a tree, the project Arborist is to attend prior to repairing damage and during repair work. If a tree is damaged and repair work is considered impractical, or is attempted and falls, give notice and obtain instructions.	All areas n Benedicts \$
SUBSOIL Excavate to bring the subsoil to a minimum of 300mm below finished design levels, to allow for infilling with topsoil mix. Break up the soil to a further depth of 100m Remove all building rubble, waste oil, cement and other material harmful to plant growth from planting beds prior to placement of topsoil.	DECOMPC Decompose m. Gravel is to
Cultivate to a minimum depth of 100mm over areas to be planted or grassed. Do not disturb services or tree rosts, if necessary, cultivate these areas by hand. Duri cultivation, thoroughly mix in materials required to be incorporated in the subsol. Remove stones execeeding 25mm, close's derth exceeding 50mm, and weeds, rubbish or other detetroious material brought to the surface during cultivation. Tim the surface to the required design levels after cultivation. Confirm that the planting beds are fee draining. If no install sub-solar diranape lines and connect to stormwater system.	ng INSTALLA A stretcher 10mm joint
Apply additives after ripping or cultivation and incorporate into the upper 100mm layer of the subsoil.	FERTILISE Fertiliser is
TOPSOIL Where possible use site topsoil and compost mixed at a rate of 4 soil : 1 compost, thoroughly mixed before placement. If imported soil is required soil shall be same similar to Australian Native Landscapes Premium garden mix or similar for garden bed areas or Turf Underday mix for turf areas. Spread topsoil on the prepared subsoil and grade evenly, making the necessary allowances so that required finished levels and contours are achieved after light compaction. Commact light uniform in 1650m lavers. Avoid differential subsidence and excess compaction and produce a finished topsoil surface which is ready for plane.	Ensure ade walls. Agric Engineering
Spread topsoil to the following typical depths: Planting beds: 300mm Grass areas: 100mm	RETAINING Retaining v
PLANTING trees: excavate a plant hole to kvice the diameter of the root ball and at least 100mm deeper than the root ball. break up the base of the hole to a further depth of 100mm, and loosen the compacted sides of the hole. shrubsiground covers: excavate a hole big enough for the plant plus 100mm all round, provide plants which have large healthy root systems, with no evidence of ro curi, restriction or damage, are vigorous, well established, free from disease and pests, of good form consistent with the species or variety; and are hardened off, no soft or forced, and suitable for planting in the natural climatic conditions prevailing at the site. These: provide trees which, unless required to be multi-stemmed, have a single leading shout trees should be staked as specified. Label at least one plant of each species or variety in a batch using a durable, readable tag do not plant in unsuitable weather conditions such as extreme heat, cold wind or rain, in other than sandy solis, suspeed excavation when the solis wet, or during fosts periods: when the hold is of the correct size, remove the plant front container with minimum disturbance to the root ball, ensure that the root ball is moist and place in the final position, in the hole and plumb, with the top soil level of the plant root ball level with the finated surgeon of the surrounding soli, or 73mm below paving level to allow placement of mulch, backfill with topsoil mixture. lightly tamp and water to eliminate air pockets, ensure that topool is not plants before planting and immediately after planting.	MAINTENA Throughou , and diseas he and keepin the
in planting beds and individual plantings, place slow release fertiliser pellets around plants at the time of planting at the rate recommended by the manufacturer. mulching	

mucrung All garden bed areas are to be mulched to 75mm depth with same or similar to Forest Blend. Provide mulch/gravel which is free of deleterious and extraneous matter such as stones, soil, weeds and sticks. Place mulch/gravel dear of plant is terms, and rake to an even surface flush with the surrounding finished levels.

NORTH NARRABEEN, 2101, NSW

KEY: LEGEND: PROJECT: PROJECT STAGE: DENOTES PROPOSED STRUCTURES PROPOSED NEW DWELLING HOUSE DA >. .03 DENOTES EXISTING SPOT LEVEL DENOTES OUTLINE OF EXISTING STRUCTURES TO BE DEMOLISHED RL 7.10 DENOTES PROPOSED LEVEL CLIENT: DRAWING TITLE: DENOTES AREA OF SOFT LANDSCAPING DENOTES PROPOSED WALLS TROY CARTER LANDSCAPE CONCEPT PLAN DENOTES OUTLINE OF EXISTING TO BE DEMOLISHED NOTE: THESE DRAWINGS ARE NOT FOR CONSTRUCTION. FOR DA APPROVAL ONLY. NOTE: DO NOT SCALE OFF THIS DRAWING NOTE: ALL WORKS TO BE IN ACCORDANCE WITH THE B.C. NOTE: ALL WORKS TO BE IN ACCORDANCE WITH THE RELEVANT AUSTRALIAN STANDARDS. NOTE: ALL WORKS TO BE IN ACCORDANCE WITH THE RALEVANT AUSTRALIAN STANDARDS. NOTE: ALL WORKS TO BE IN ACCORDANCE WITH THE BASIX REQUIREMENTS LOCATION: SCALE: 25 ALLEYNE AVE. 1:200 @ A3

DENOTES PROPOSED TERRACE AREA ____ 00 DENOTES PROPOSED STEPPING STONES

*** DENOTES PROPOSED GRASSES AND GROUND COVERS

DENOTES PROPOSED PAVERS

LANDSCAPE CONCEPT PLAN 1:100 @ A1 OR 1:200 @A 3

CR	3	CORREA REFLEXA	COMMON CORREA	300
DP	11	DORYANTHES PALMERI	GYMEA LILLY	300
GRASSES/ GROUNDCOVERS				
<u>LT</u>	7	LOMANDRA LONGIFOLIA	SPINY-HEADED MAT RUSH	100
VH	12	VIOLA HEDERACEA	NATIVE VIOLET	100
LM	-	LIROPE'EVERGREEN GIANT'	GIANT MONDO GRASS	150
DR	-	DICHONDRA REPENS	KIDNEY WEED	100



ALLE

SITE CALCULATIONS

TOTAL SITE AREA 557.8m² PROPOSED TOTAL GROSS FLOOR AREA INC. SECONDARY DWELLING PROPOSED GARAGE AREA 317m² 37m² PROPOSED LOWER GROUND GROSS FLOOR AREA PROPOSED GROUND FLOOR GROSS FLOOR AREA 70m² 120m² 67m² PROPOSED FIRST FLOOR GROSS FLOOR AREA PROPOSED ROOF AREA 199m² PROPOSED SECONDARY DWELLING 60m² PROPOSED POOL VOLUME 18m³ PROPOSED HARD SURFACE AREA 245.7m² (44%) PROPOSED TOTAL SOFT LANDSCAPE AREA 312.1m² (56%)

TIVE GRAVE

A IVE GRAVEL s nominated as Decorative Gravel are to be finished as detailed with sandstone pebbles 10mm-20mm average diameter, same or similar to that supplied by an Native Landscapes. I pebbles are to be free of deleterious and extraneous matter such as stones, cement, soil, weeds and sticks. bbbes to an even surface flush with the surrounding finished levels.

ATIVE ROCK MULCH nominated as Decorative Rock Mulch are to be finished with sandstone spalls, average diameter 80mm-120mm, same or similar to those supplied to Is Sand and Gravel.

POSED GRANITE PAVEMENT

sed granite is to be fine-crushed river gravel (5mm-7mm), to a depth of 50mm, placed on a 50mm bed of coarse gravel on 100mm conso to be compacted and trimmed to provide falls and a free draining surface.

LATION OF BRICK GARDEN EDGE ter or single paver brick edge is to be installed to separate turf and garden beds. Secure pavers on rough mortar footing 100mm thick and ensure uniform ints between each brick to create flush struck joints. Refer to edging and turfing detail.

SER is to be slow release fertiliser equivalent to "Osmocote" and is to be applied at manufacturer's specified rates.

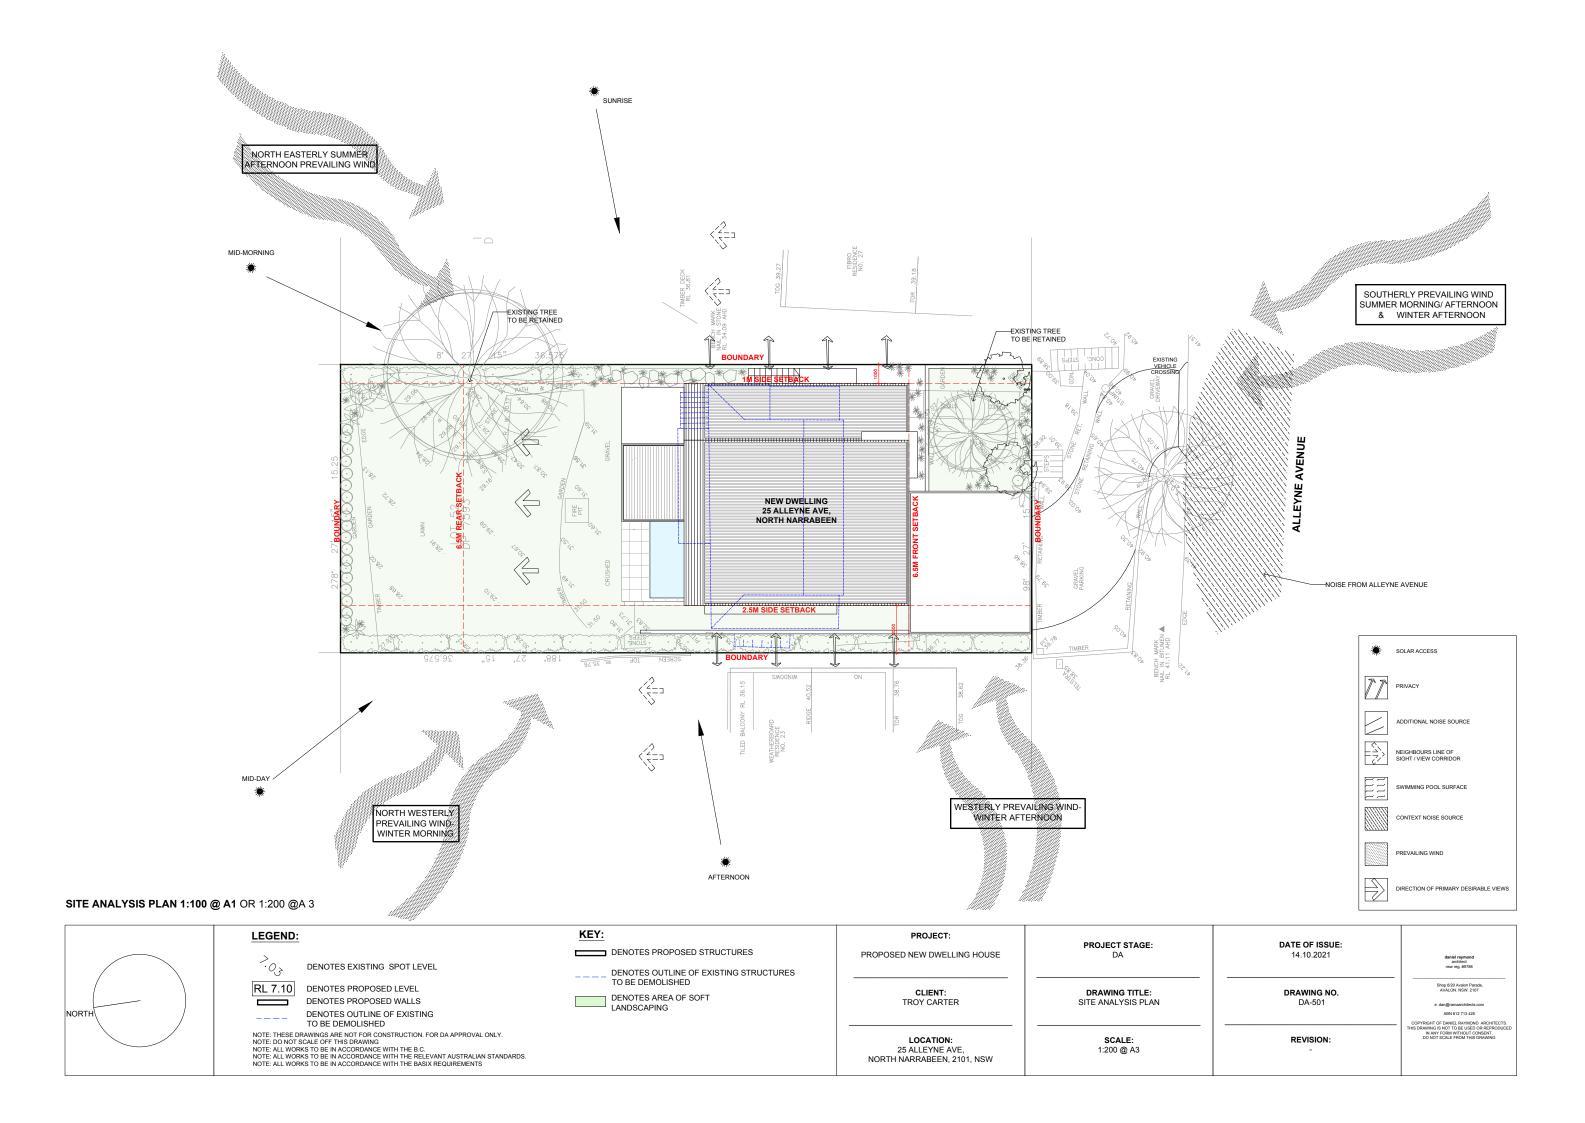
GE dequate drainage to all garden beds, gravel and lawn areas. Install 100mm agricultural pipe with sock as required in garden beds and behind all retaining incultural pipes to drain to junction pits and connect to stormwater system. Ensure paved areas are free draining. Install pits if required. (Refer to Hydraulic ing).

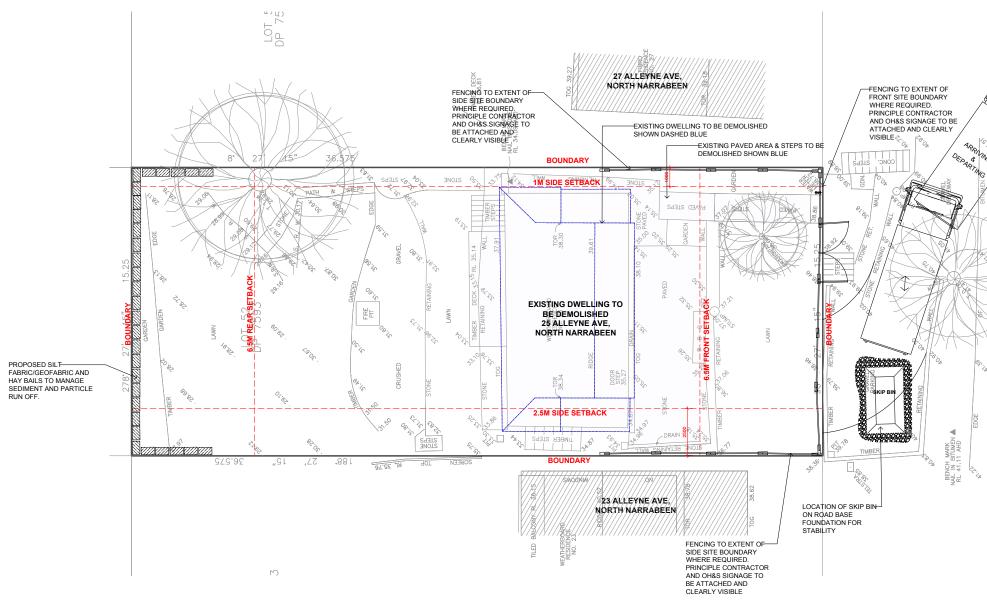
NG WALLS walls to be constructed as per Engineer's details.

STET WORKS s, steps, slabs and footings shall be to Engineer's specification. Is and construction to AS3600 and AS3810. and install ready mixed concrete to AS1379 with selected aggregate. all appropriate PVC conduits for garden lighting and irrigation systems are placed before concrete and paving installation.

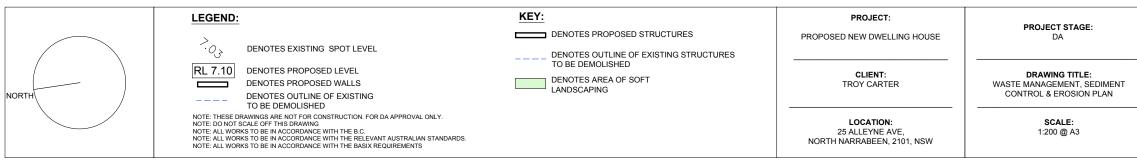
VANCE sut the planting establishment period (minimum 12 weeks), carry out maintenance work including watering, mowing, weeding, rubbish removal, fertilising, pest ase control, reseeding, returting, staking and tying, replanting, cultivating, pruning, hedges clipping, aerating, reinstatement of mulch, renovating, top dressing ing the site neat and tidy. Continue to replace failed, damaged or stolen plants.

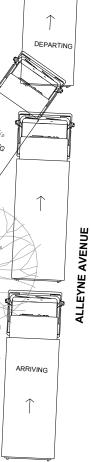
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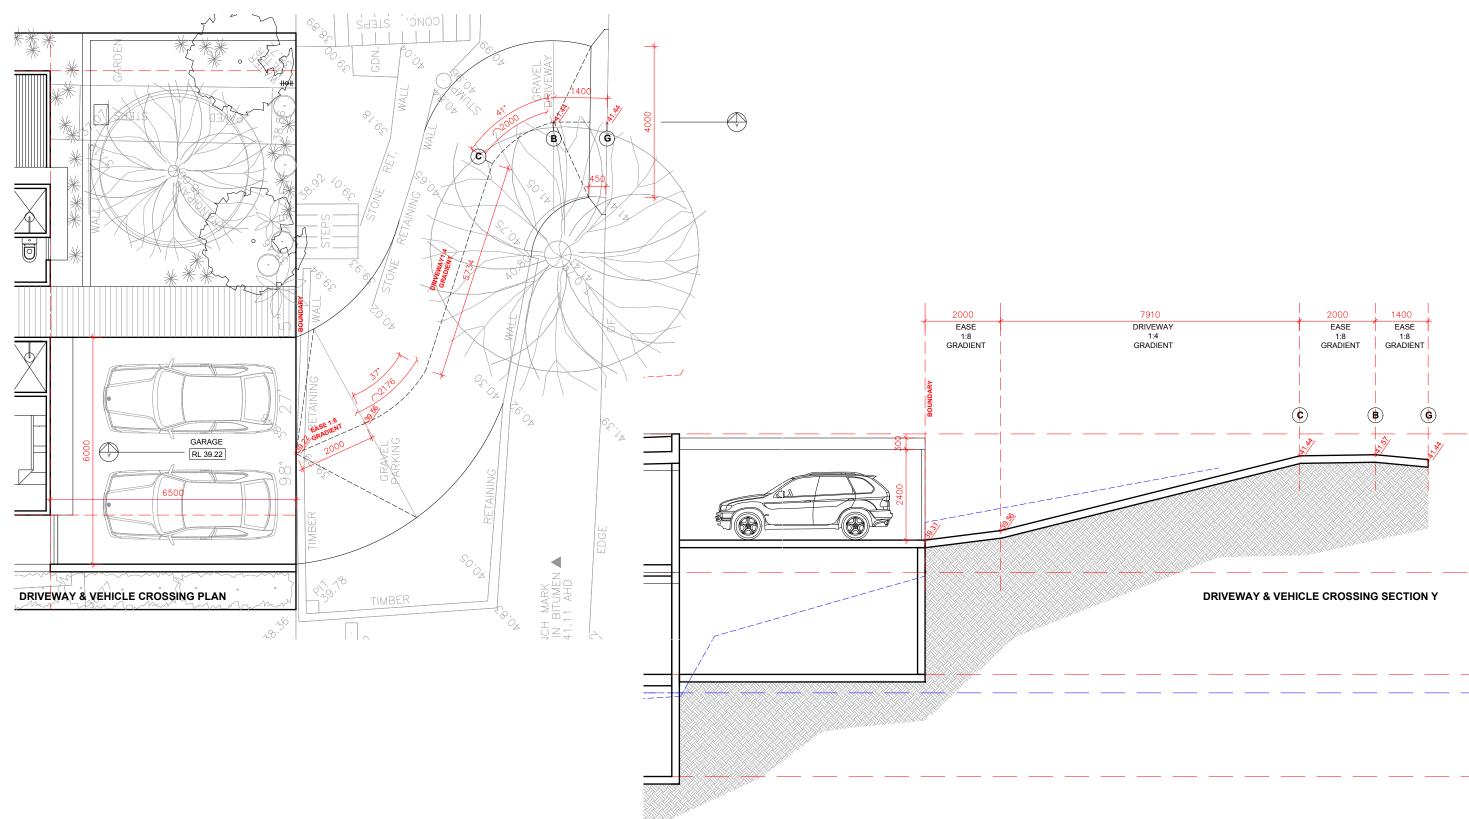


WASTE MANAGEMENT, SEDIMENT CONTROL & EROSION PLAN 1:100 @ A1 OR 1:200 @A 3



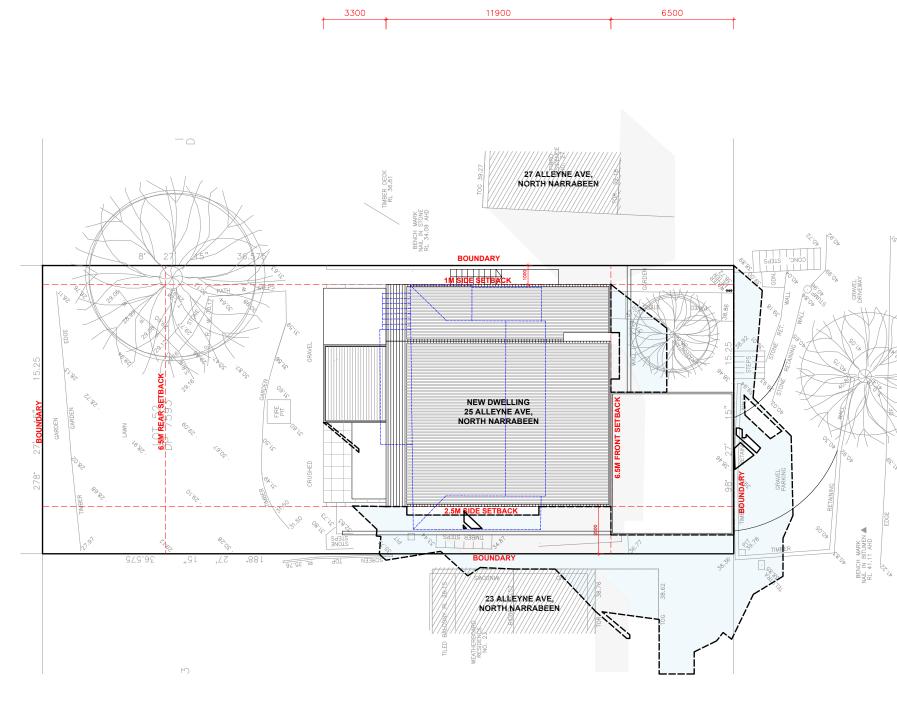


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VEHICLE CROSSING AND DRIVEWAY GRADIENT 1:50 @ A1 OR 1:100 @A 3

	C C					
	LEGEND:	KEY: DENOTES PROPOSED STRUCTURES	PROJECT: PROPOSED NEW DWELLING HOUSE	PROJECT STAGE: DA	DATE OF ISSUE: 14.10.2021	daniel raymond architect nsw reg. 69788
NORTH	RL 7.10 DENOTES PROPOSED LEVEL	DENOTES OUTLINE OF EXISTING STRUCTURES TO BE DEMOLISHED DENOTES AREA OF SOFT LANDSCAPING	CLIENT: TROY CARTER	DRAWING TITLE: VEHICLE CROSSING & DRIVEWAY GRADIENT PLAN	DRAWING NO. DA-503	Shop 620 Avalan Parade, WALON NSW 2107 e. dan@ramaschilects.com ADN 012 713 425
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9AM 21ST JUNE SHADOW DIAGRAM PLAN 1:100 @ A1 OR 1:200 @A 3

	LEGEND:	KEY:	PROJECT:	PROJECT STAGE:
	>	DENOTES PROPOSED WALLS	PROPOSED NEW DWELLING HOUSE	DA
		DENOTES OUTLINE OF EXISTING BUILDING TO BE DEMOLISHED		
	RL 7.10 DENOTES PROPOSED LEVEL		CLIENT:	DRAWING TITLE:
NORTH	DENOTES PROPOSED WALLS DENOTES OUTLINE OF EXISTING	DENOTES AREA OF EXISTING SHADOW TO REMAIN CAST FROM PROPOSED NEW	TROY CARTER	9AM SHADOW DIAGRAM PLAN
	TO BE DEMOLISHED	DWELLING AT 25 ALLEYNE AVE, NORTH NARRABEEN, NSW.		
	NOTE: THESE DRAWINGS ARE NOT FOR CONSTRUCTION. FOR DA APPROVAL ONLY. NOTE: DO NOT SCALE OFF THIS DRAWING NOTE: ALL WORKS TO BE IN ACCORDANCE WITH THE B.C. NOTE: ALL WORKS TO BE IN ACCORDANCE WITH THE RELEVANT AUSTRALIAN STANDARDS. NOTE: ALL WORKS TO BE IN ACCORDANCE WITH THE BASIX REQUIREMENTS	DENOTES AREA OF ADDITIONAL SHADOW CAST FROM PROPOSED NEW DWELLING AT 25 ALLEYNE AVE, NORTH NARRABEEN, NSW.	LOCATION: 25 ALLEYNE AVE, NORTH NARRABEEN, 2101, NSW	SCALE: 1:200 @ A3



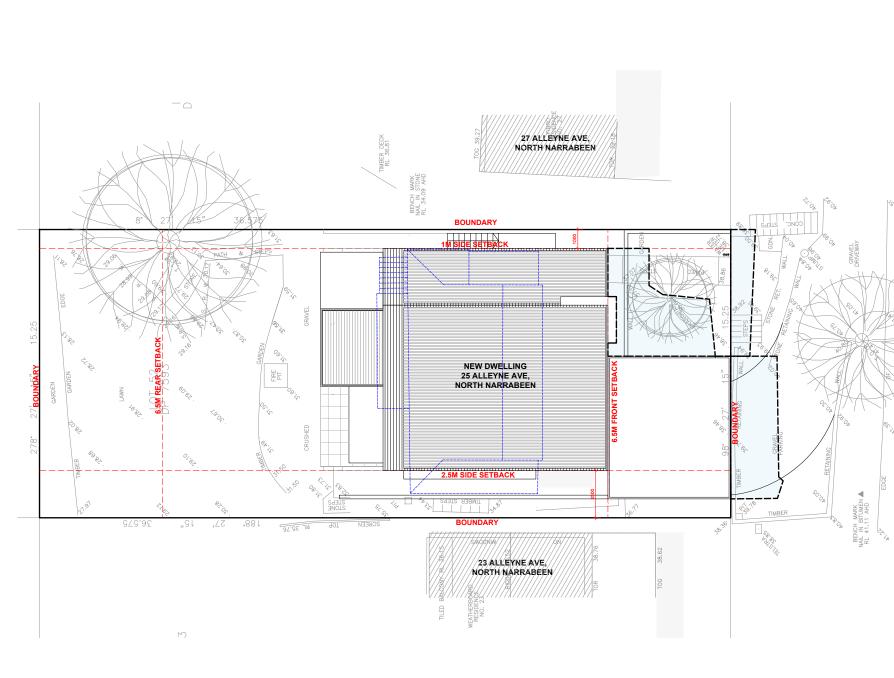


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12PM 21ST JUNE SHADOW DIAGRAM PLAN 1:100 @ A1 OR 1:200 @A 3

	LEGE	ND:	KEY:	PROJECT:	PROJECT STAGE:
			DENOTES PROPOSED WALLS	PROPOSED NEW DWELLING HOUSE	DA
	·03	DENOTES EXISTING SPOT LEVEL	DENOTES OUTLINE OF EXISTING BUILDING TO BE DEMOLISHED		
	RL 7.	0 DENOTES PROPOSED LEVEL 3 DENOTES PROPOSED WALLS	DENOTES AREA OF EXISTING SHADOW TO REMAIN CAST	CLIENT: TROY CARTER	DRAWING TITLE: 12PM SHADOW DIAGRAM PLAN
NORTH	/	_ DENOTES OUTLINE OF EXISTING TO BE DEMOLISHED	FROM PROPOSED NEW DWELLING AT 8 DELECTA AVE, CLAREVILLE, NSW.		
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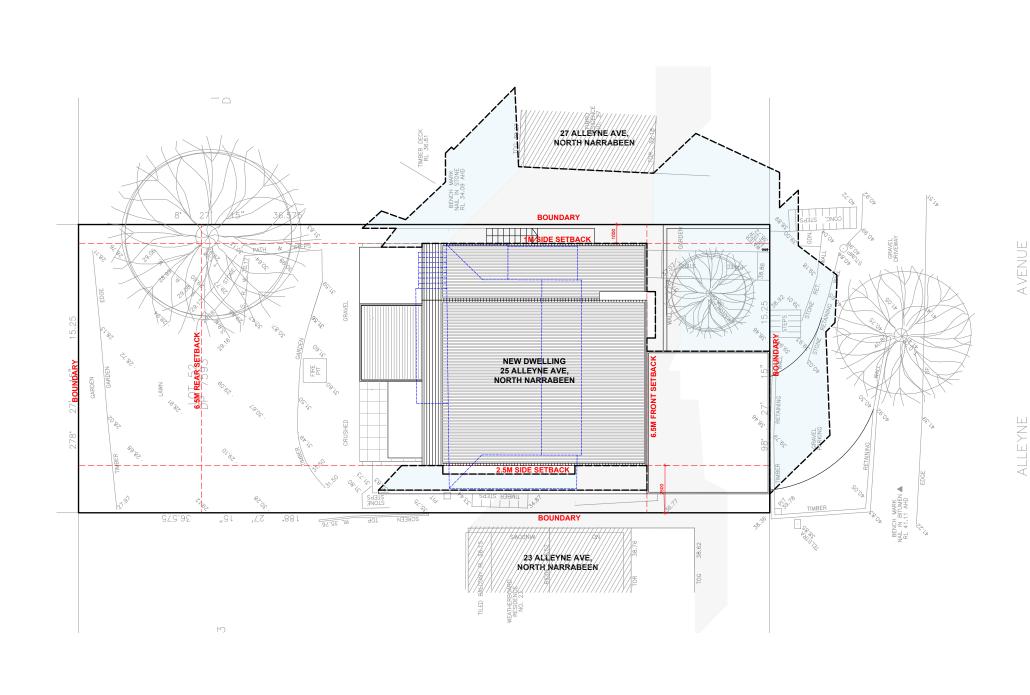


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3PM 21ST JUNE SHADOW DIAGRAM PLAN 1:100 @ A1 OR 1:200 @A 3

		LEGEND:	KEY:	PROJECT:	PROJECT STAGE:
		>	DENOTES PROPOSED WALLS	PROPOSED NEW DWELLING HOUSE	DA
			DENOTES OUTLINE OF EXISTING BUILDING TO BE DEMOLISHED		
		RL 7.10 DENOTES PROPOSED LEVEL	DENOTES AREA OF EXISTING SHADOW TO REMAIN CAST	CLIENT: TROY CARTER	DRAWING TITLE: 3PM SHADOW DIAGRAM PLAN
NOR	тн	DENOTES OUTLINE OF EXISTING TO BE DEMOLISHED	FROM PROPOSED NEW DWELLING AT 8 DELECTA AVE, CLAREVILLE, NSW.		
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