

PROJECT
0487 - Freshwater Hotel

ADDRESS
29 Moore Road, Freshwater, NSW 2096

DATE
20.04.20

ISSUE
FOR DA APPLICATION


DOCUMENT TRANSMITTAL				DAY	20											
AREA	DRAWING NO.	DRAWING TITLE	SCALE @ A1	SCALE @ A3	MONTH	04										
					YEAR	20										
DOCUMENT TRANSMITTAL	DA- A00-000	DOCUMENT TRANSMITTAL	n/a	n/a	YES											
A (BASE BUILD)	DA- AXX-001	SITE & ROOF - EXISTING & DEMOLITION PLAN	1:200	1:400	A											
	DA- A00-001	GROUND FLOOR - EXISTING & DEMOLITION PLAN	1:100	1:200	A											
	DA- A01-001	FIRST FLOOR - EXISTING PLAN	1:100	1:200	A											
D (PLANS)	DA- D00-011	GROUND FLOOR - GENERAL ARRANGEMENT PLAN	1:100	1:200	A											
E (ELEVATIONS)	DA- EXX-001	OVERALL BUILDING - EXTERNAL ELEVATIONS 01	1:100	1:200	A											
	DA- EXX-002	OVERALL BUILDING - EXTERNAL ELEVATIONS 02	1:100	1:200	A											
F (SECTIONS)	DA- FXX-001	OVERALL BUILDING - SECTION AA	1:50	1:100	A											
REASON	METHOD	DISTRIBUTION														
FOR DA APPROVAL	DA	HAND DELIVERED	HD	CLIENT												
FOR CC APPROVAL	CC	MAIL	ML	PROJECT MANAGER												
FOR CDC APPROVAL	CDC	HARD COPY	HC	CONTRACTOR												
PRELIMINARY	PR	ELECTRONIC PDF	EP	COUNCIL	AP-EP											
FOR INFORMATION	IN	ELECTRONIC CAD	EC	TOWN PLANNER												
FOR APPROVAL	AP	DROPBOX	DB	HERITAGE CONS												
FOR TENDER	FT			SUPPLIER												
FOR CONSTRUCTION	FC															
AS BUILT	AB															

AERIAL LOCATION PLAN



LEGEND

- EXISTING WALLS
- DEMOLITION
- PROPOSED WALLS

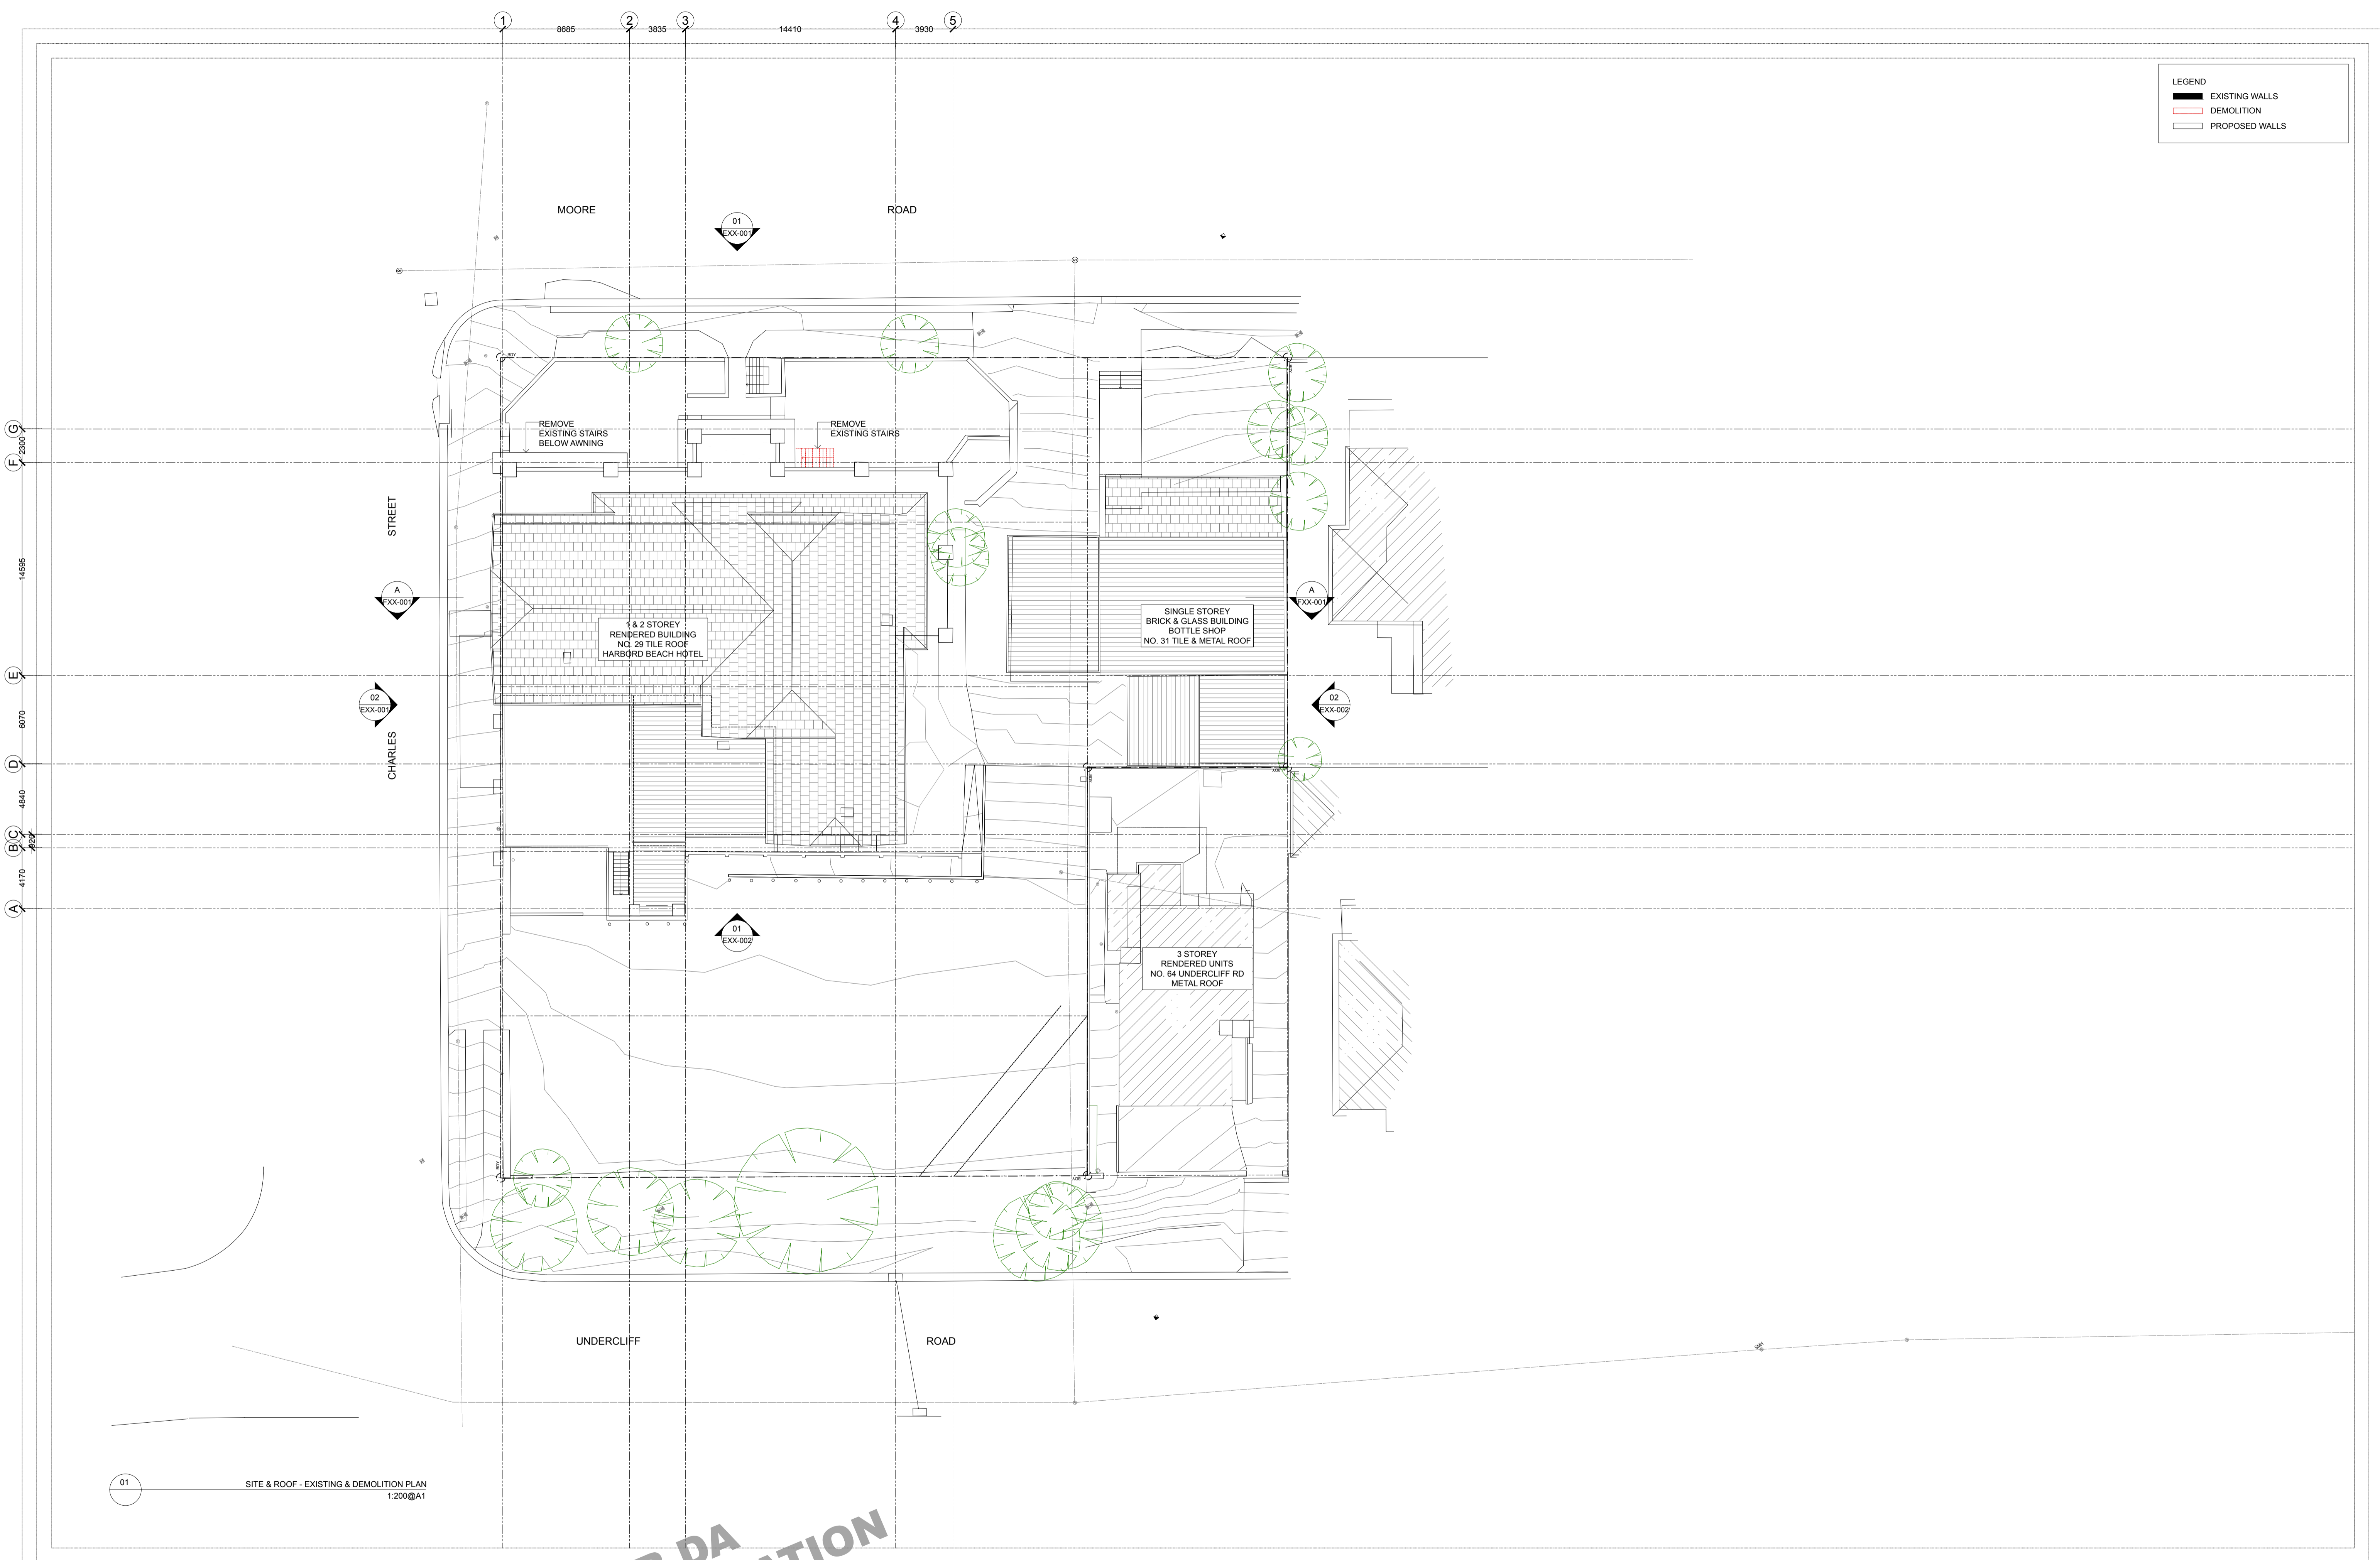

01 SITE & ROOF - EXISTING & DEMOLITION PLAN
1:200@A1


FOR DA APPLICATION

DATE	REVISION	ISSUE REASON
20.04.20	A	FOR DA APPLICATION

ALEXANDER JCO.
 15/10 Green Park Drive, St. Leonards NSW 1585
 02 9439 6666

CLIENT:
GLENN PIPER
MERIDAN AUSTRALIA


PROJECT:
FRESHWATER HOTEL

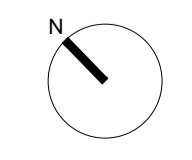

DRAWING:
SITE & ROOF -
EXISTING & DEMOLITION PLAN

CHECK ALL DIMENSIONS ON SITE PRIOR TO THE COMMENCEMENT OF WORK
 USE FIGURED DIMENSIONS ONLY DO NOT SCALE
 COMPLY WITH ALL RELEVANT AUTHORITIES REQUIREMENTS
 COMPLY WITH BUILDING CODE OF AUSTRALIA
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PROJECT NO.	DRAWN
0487	ST
SCALE@A1	SCALE@A3
1:200	1:400
DWG NO.	ISSUE
DA-AXX-001	A

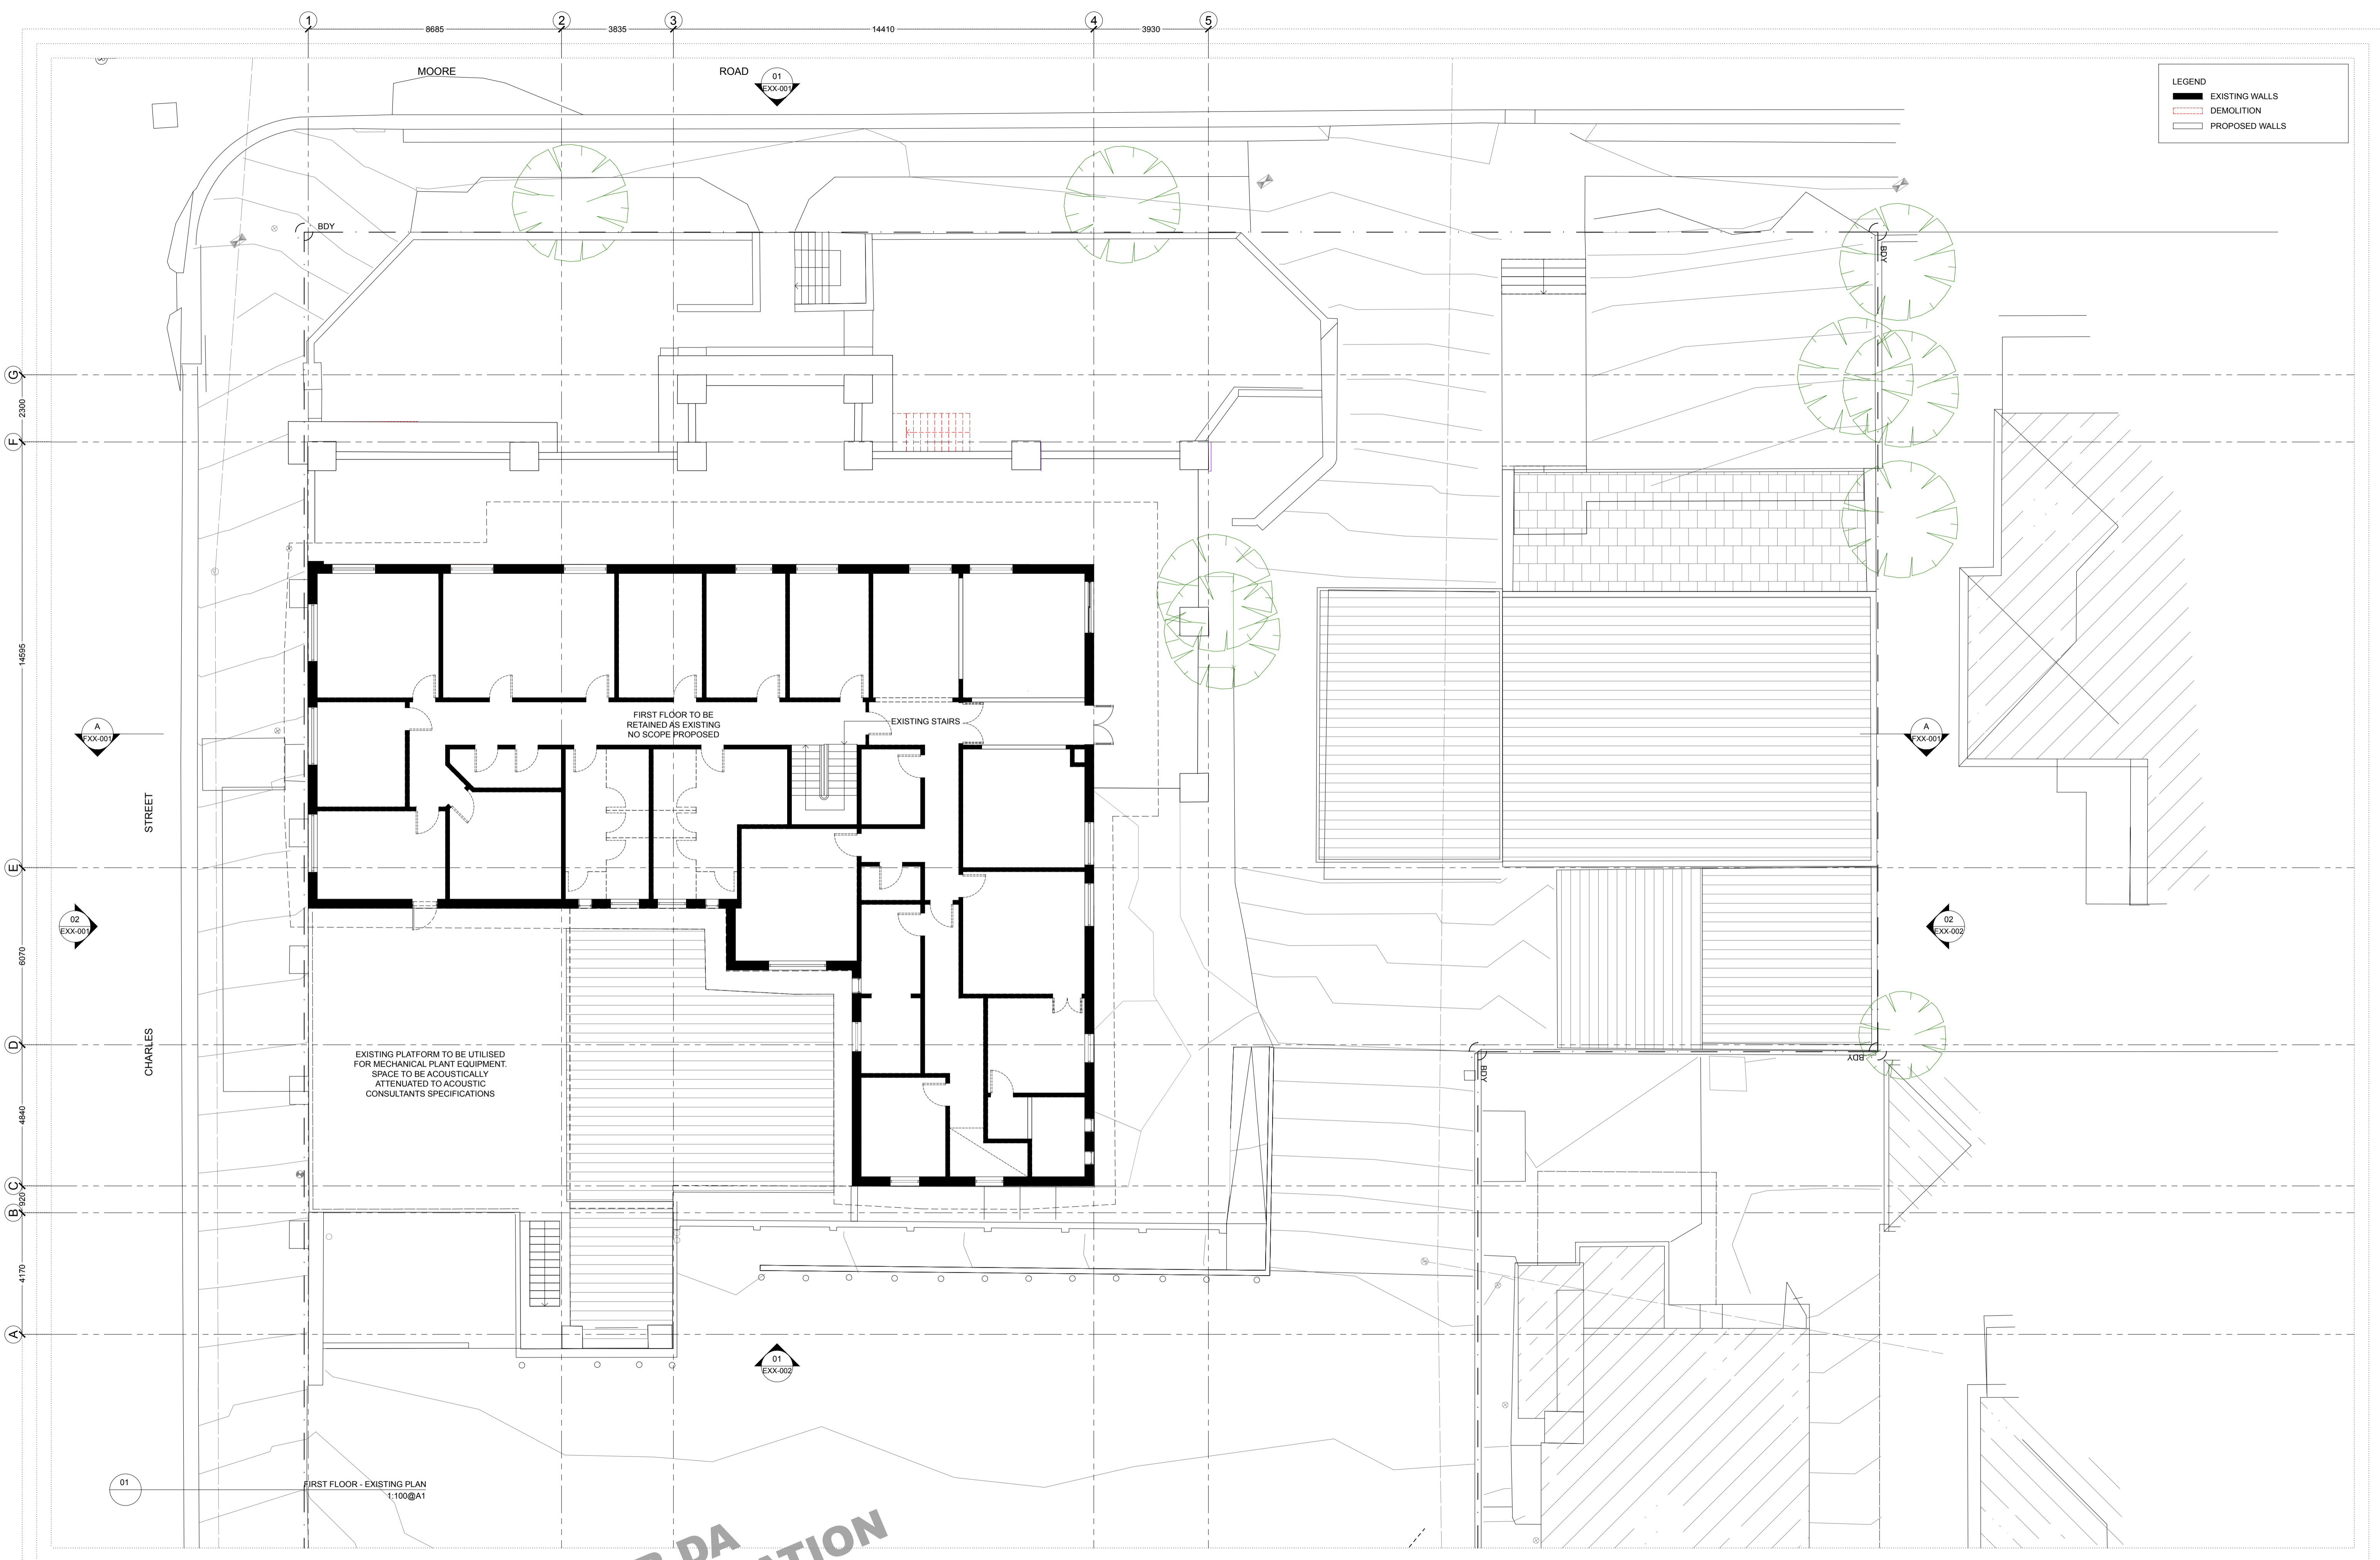

LEGEND
 — EXISTING WALLS
 - - - DEMOLITION
 — PROPOSED WALLS

MOORE ROAD 01 EXX-001

BDY

STREET

CHARLES

01 EXX-001

02 EXX-001

02 EXX-002

01 EXX-002

01

FIRST FLOOR - EXISTING PLAN 1:100@A1

FIRST FLOOR TO BE RETAINED AS EXISTING NO SCOPE PROPOSED

EXISTING STAIRS

EXISTING PLATFORM TO BE UTILISED FOR MECHANICAL PLANT EQUIPMENT. SPACE TO BE ACOUSTICALLY ATTENUATED TO ACOUSTIC CONSULTANTS SPECIFICATIONS


FOR DA APPLICATION

DATE 20.04.20 REVISION A ISSUE REASON DA APPLICATION

ALEXANDER & CO.
 ARCHITECTS
 15-17 Greenfield Road
 Meridan NSW 2170


CLIENT:
 GLENN PIPER
 MERIDAN AUSTRALIA

PROJECT:
 FRESHWATER HOTEL

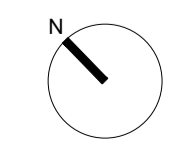

DRAWING:
 FIRST FLOOR - EXISTING PLAN
 CHECK ALL DIMENSIONS ON SITE PRIOR TO THE COMMENCEMENT OF WORK
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PROJECT NO. 0487
 SCALE@A1 SCALE@A3
 1:100 1:200
 DWG NO. DA-A01-001
 DRAWN ST
 CHECKED SH
 ISSUE A

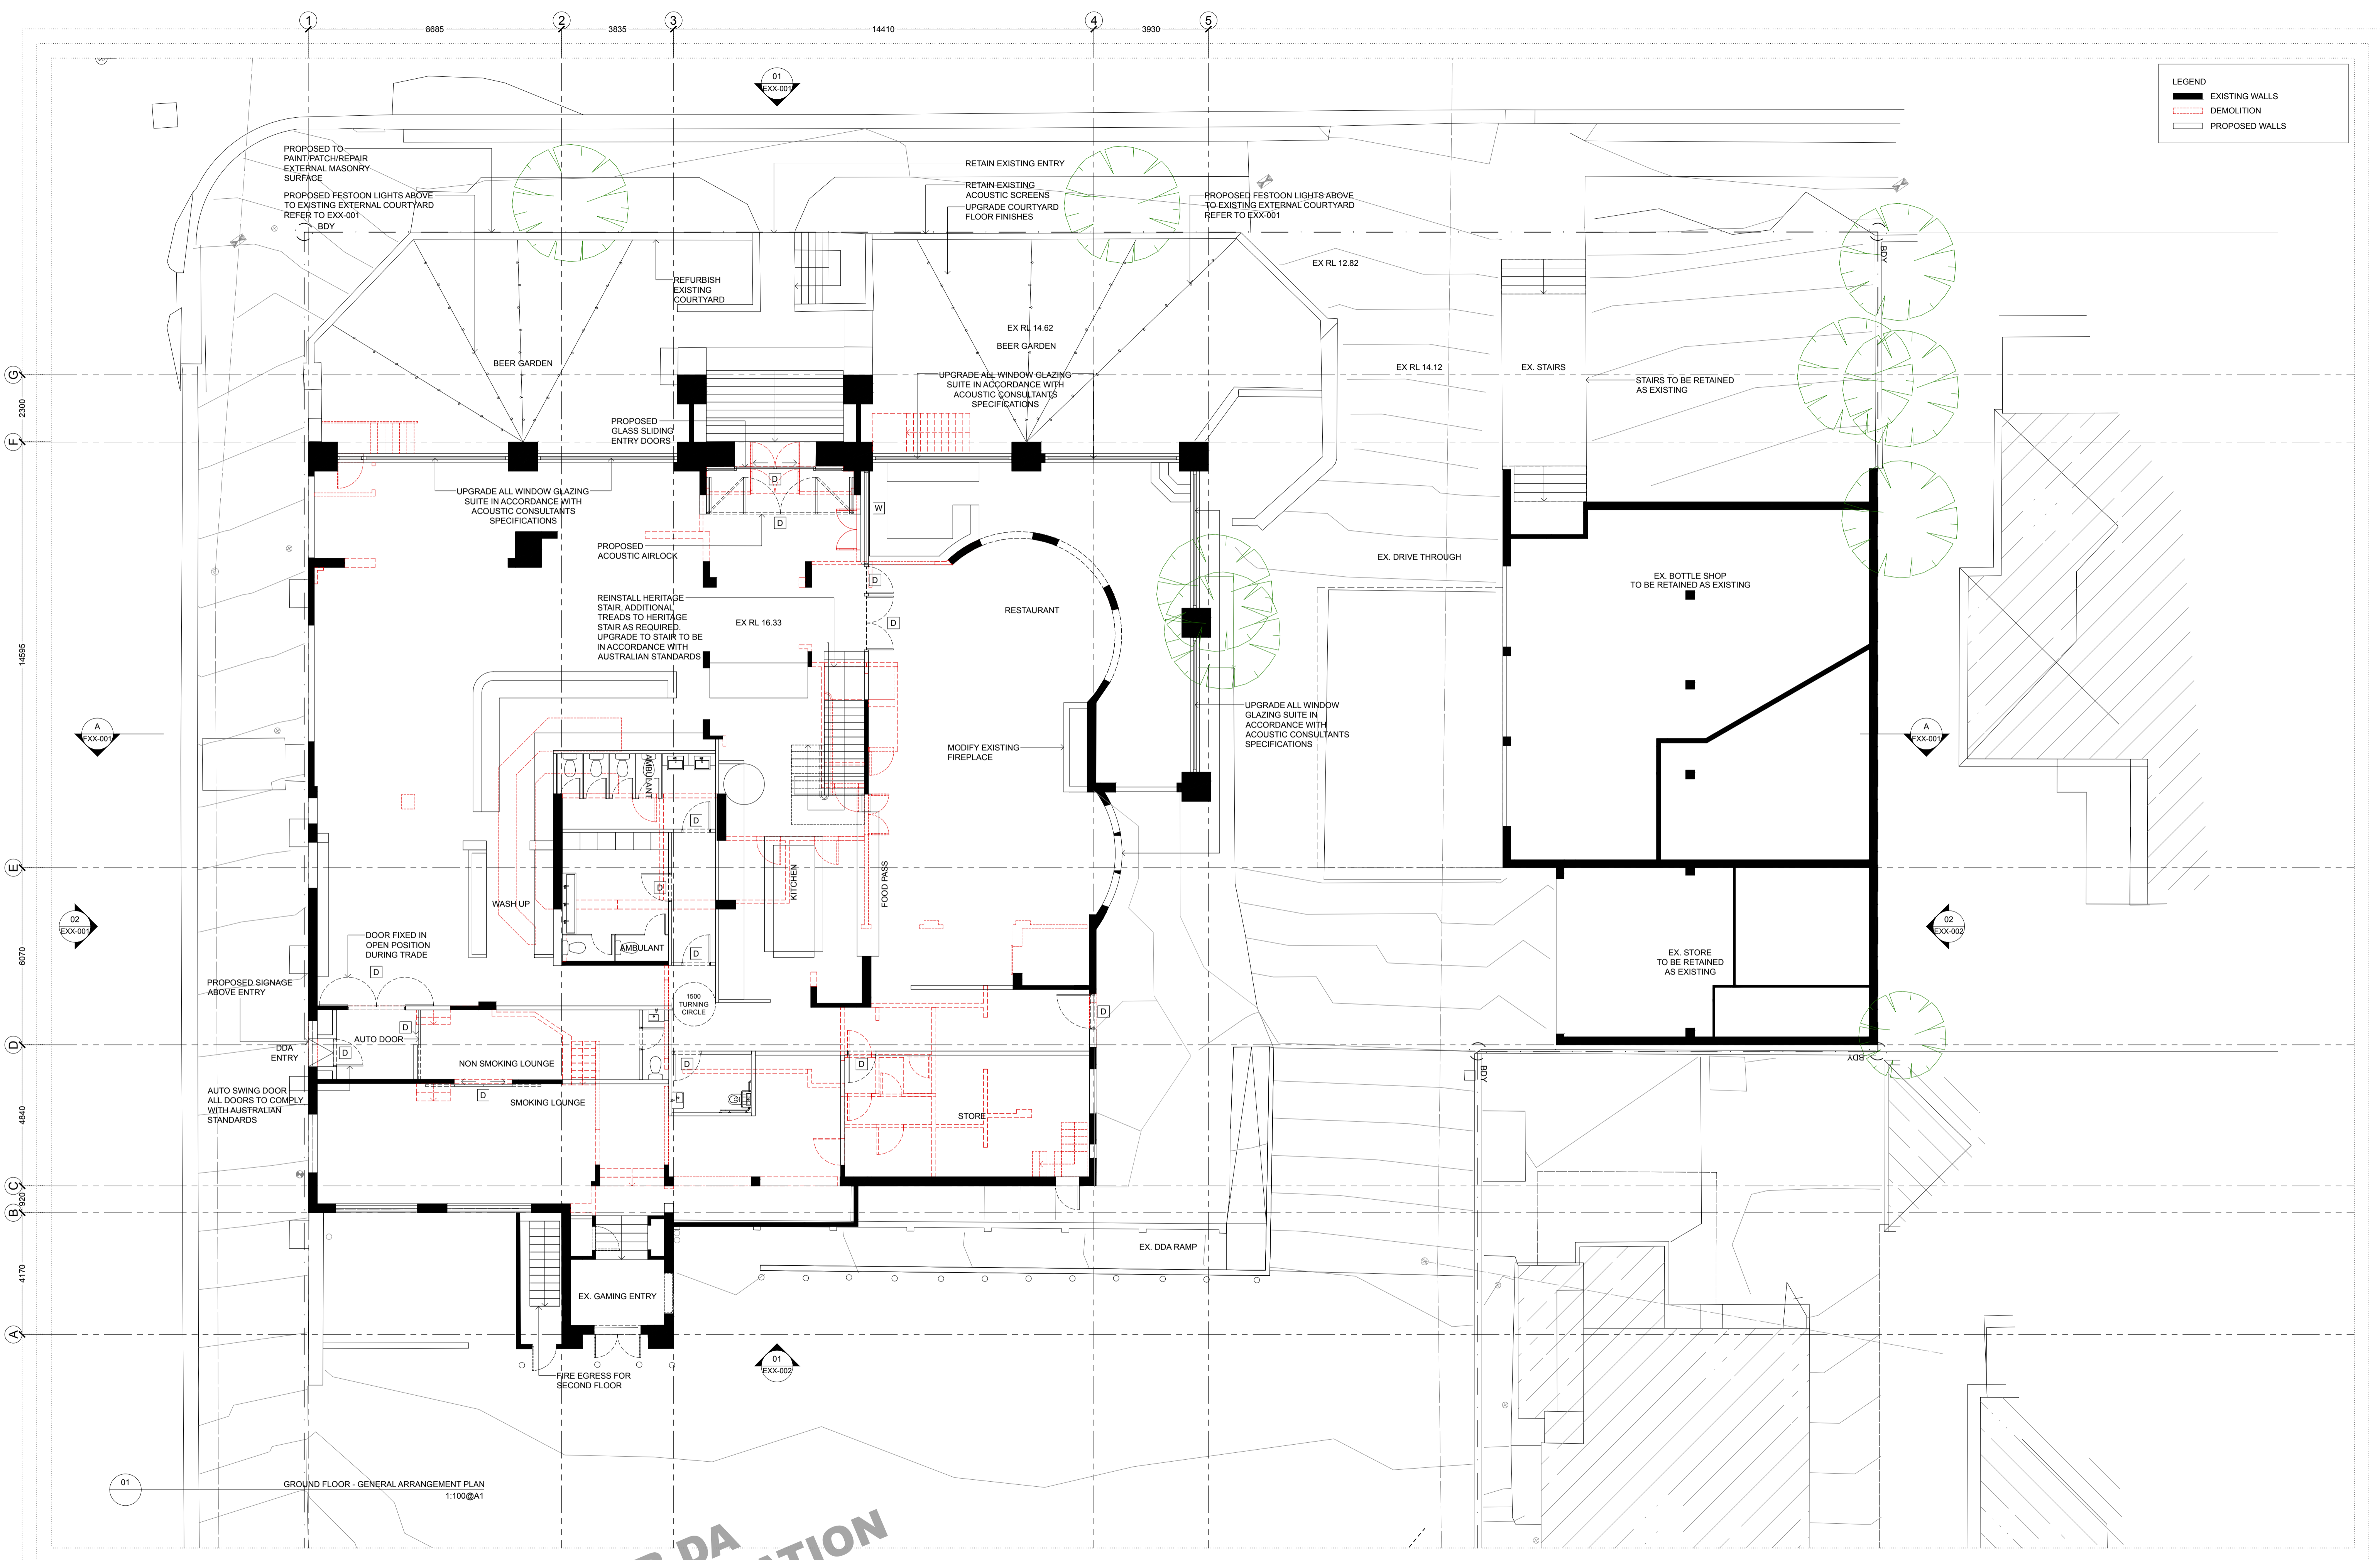

GROUND FLOOR - GENERAL ARRANGEMENT PLAN
1:100@A1


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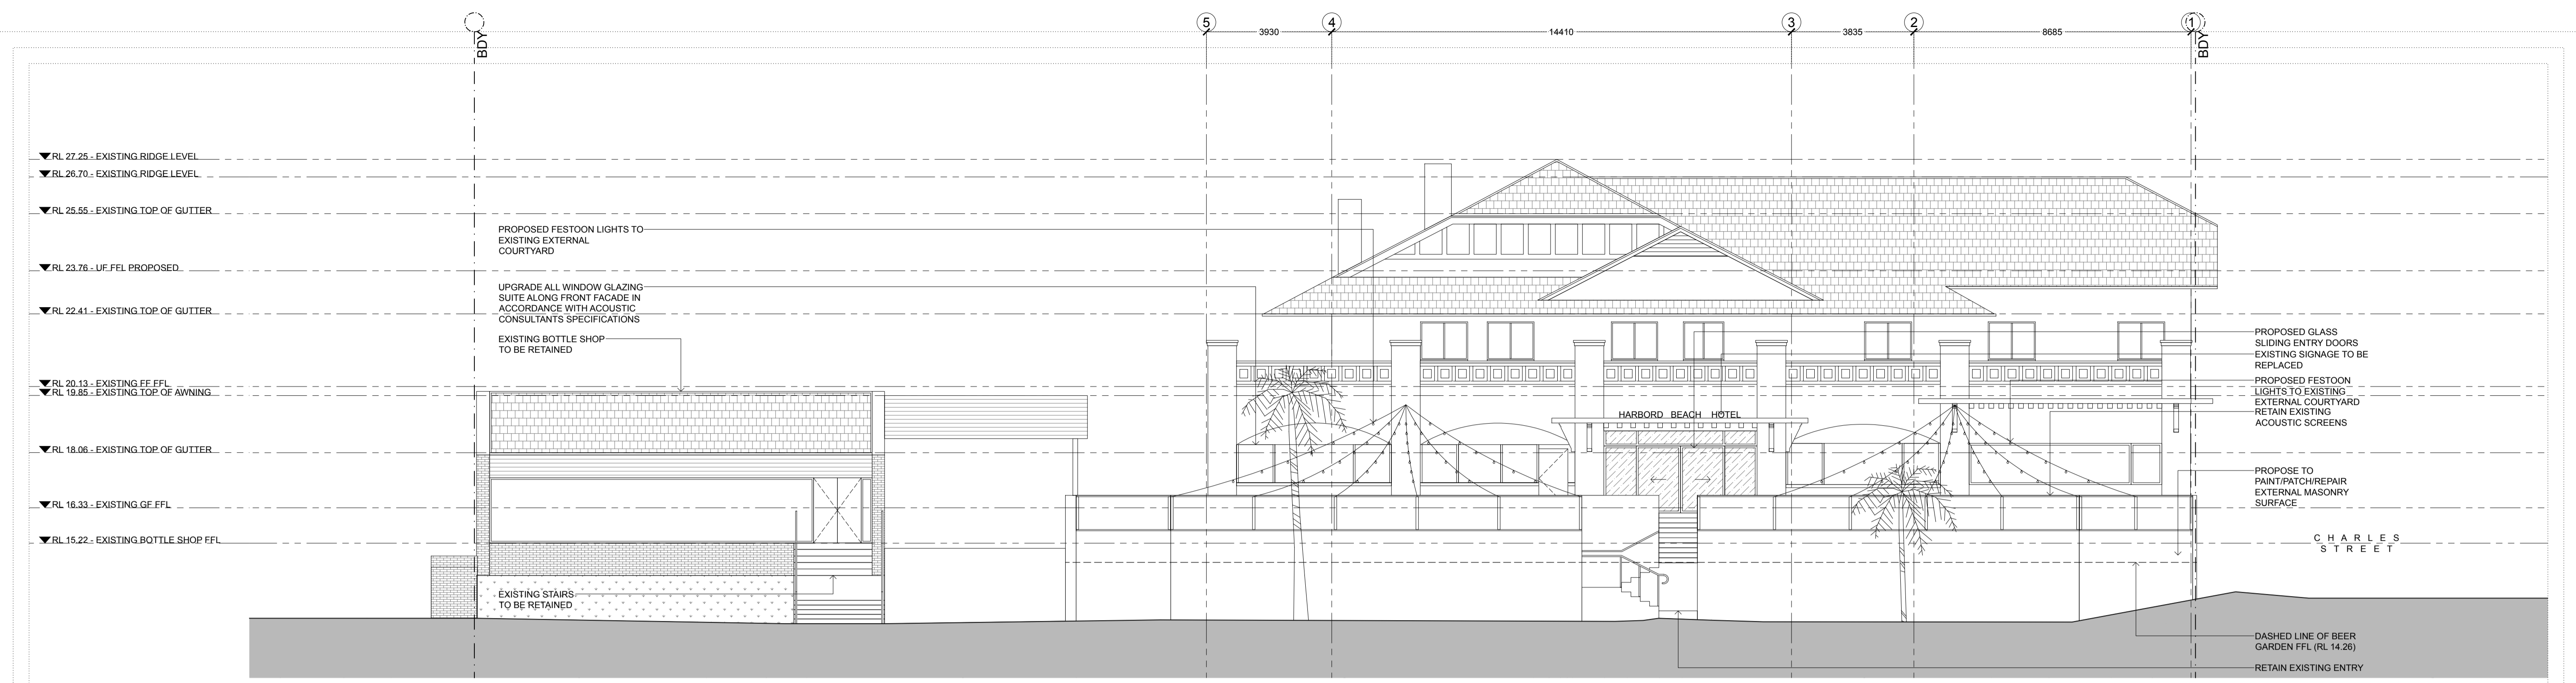
CLIENT: GLENN PIPER
MERIDIAN AUSTRALIA

PROJECT: FRESHWATER HOTEL



DRAWING: GENERAL ARRANGEMENT PLAN
CHECK ALL DIMENSIONS ON SITE PRIOR TO THE COMMENCEMENT OF WORK
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SCALE@A1 1:100 SCALE@A3 1:200
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01 ELEVATION 01 1:100@A1

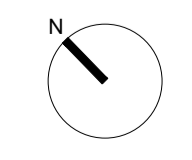

02 ELEVATION 02 1:100@A1

FOR DA APPLICATION

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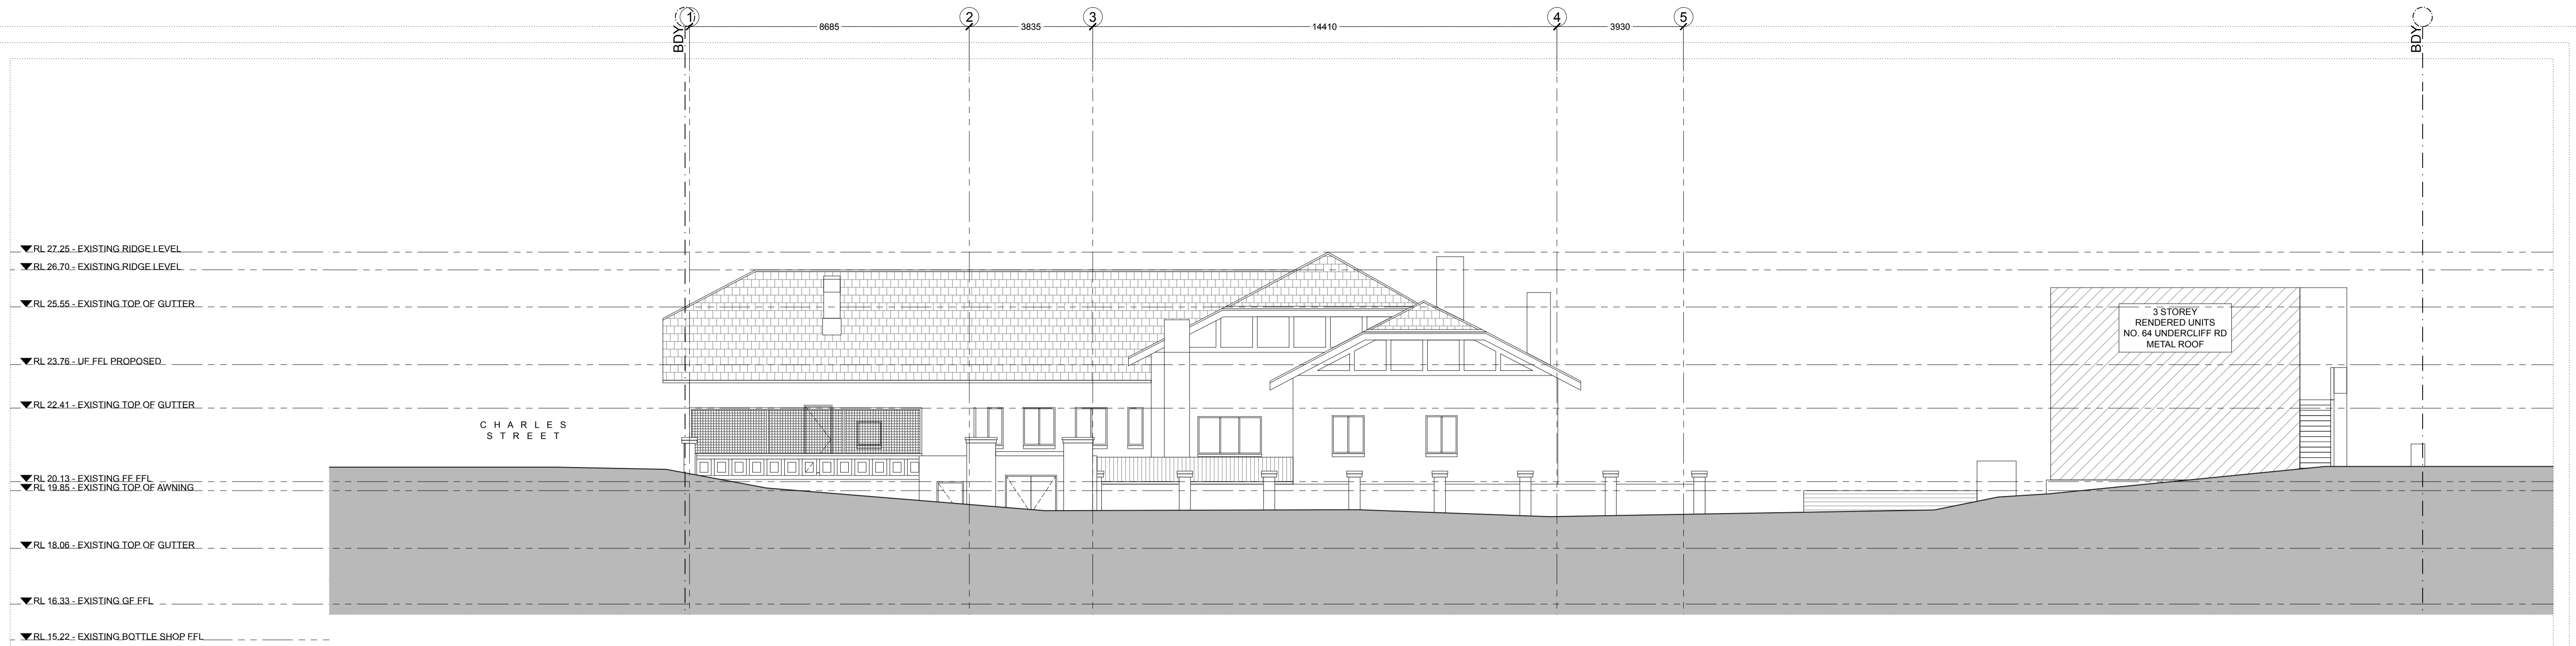
ALEXANDER & CO.
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 Meridan NSW 2550
 02 9841 9888

CLIENT: GLENN PIPER
 MERIDAN AUSTRALIA

PROJECT: FRESHWATER HOTEL

DRAWING: OVERALL BUILDING EXTERNAL ELEVATIONS 01
 CHECK ALL DIMENSIONS ON SITE PRIOR TO THE COMMENCEMENT OF WORK
 USE FIGURED DIMENSIONS ONLY DO NOT SCALE
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 ISSUE A




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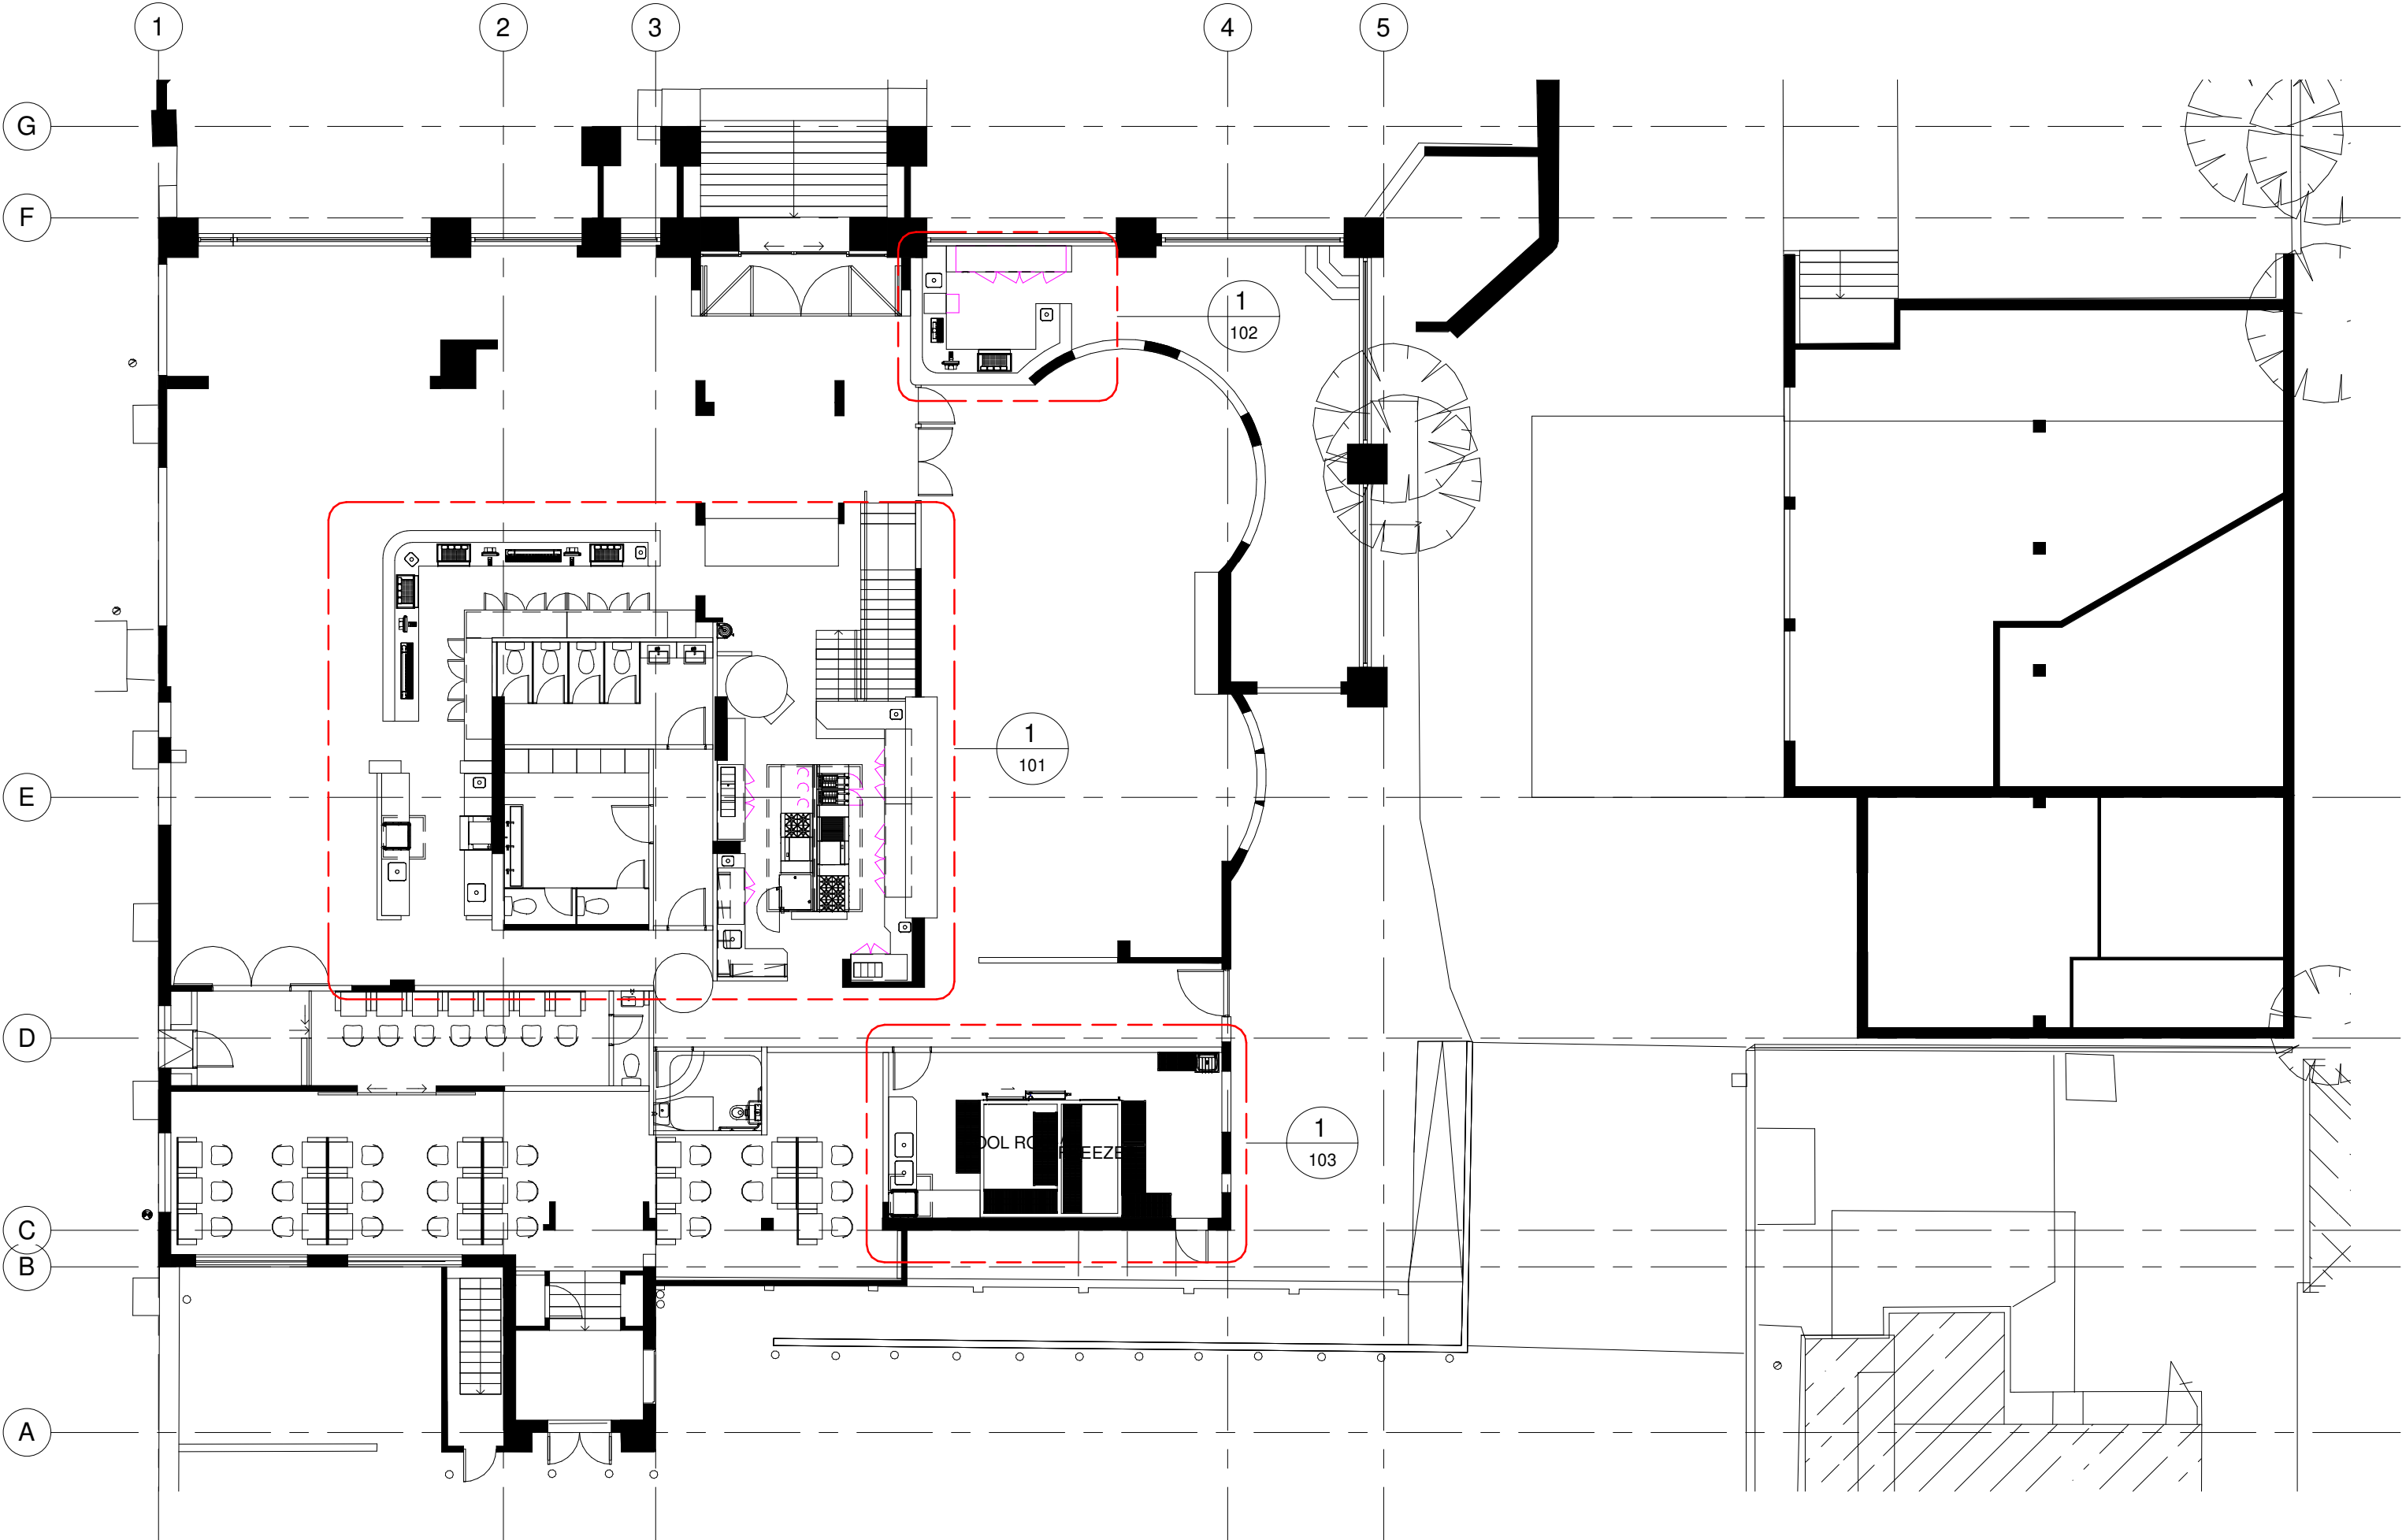
02 ELEVATION 02
1:100@A1

FOR DA APPLICATION



01 SECTION AA
1:100@A1

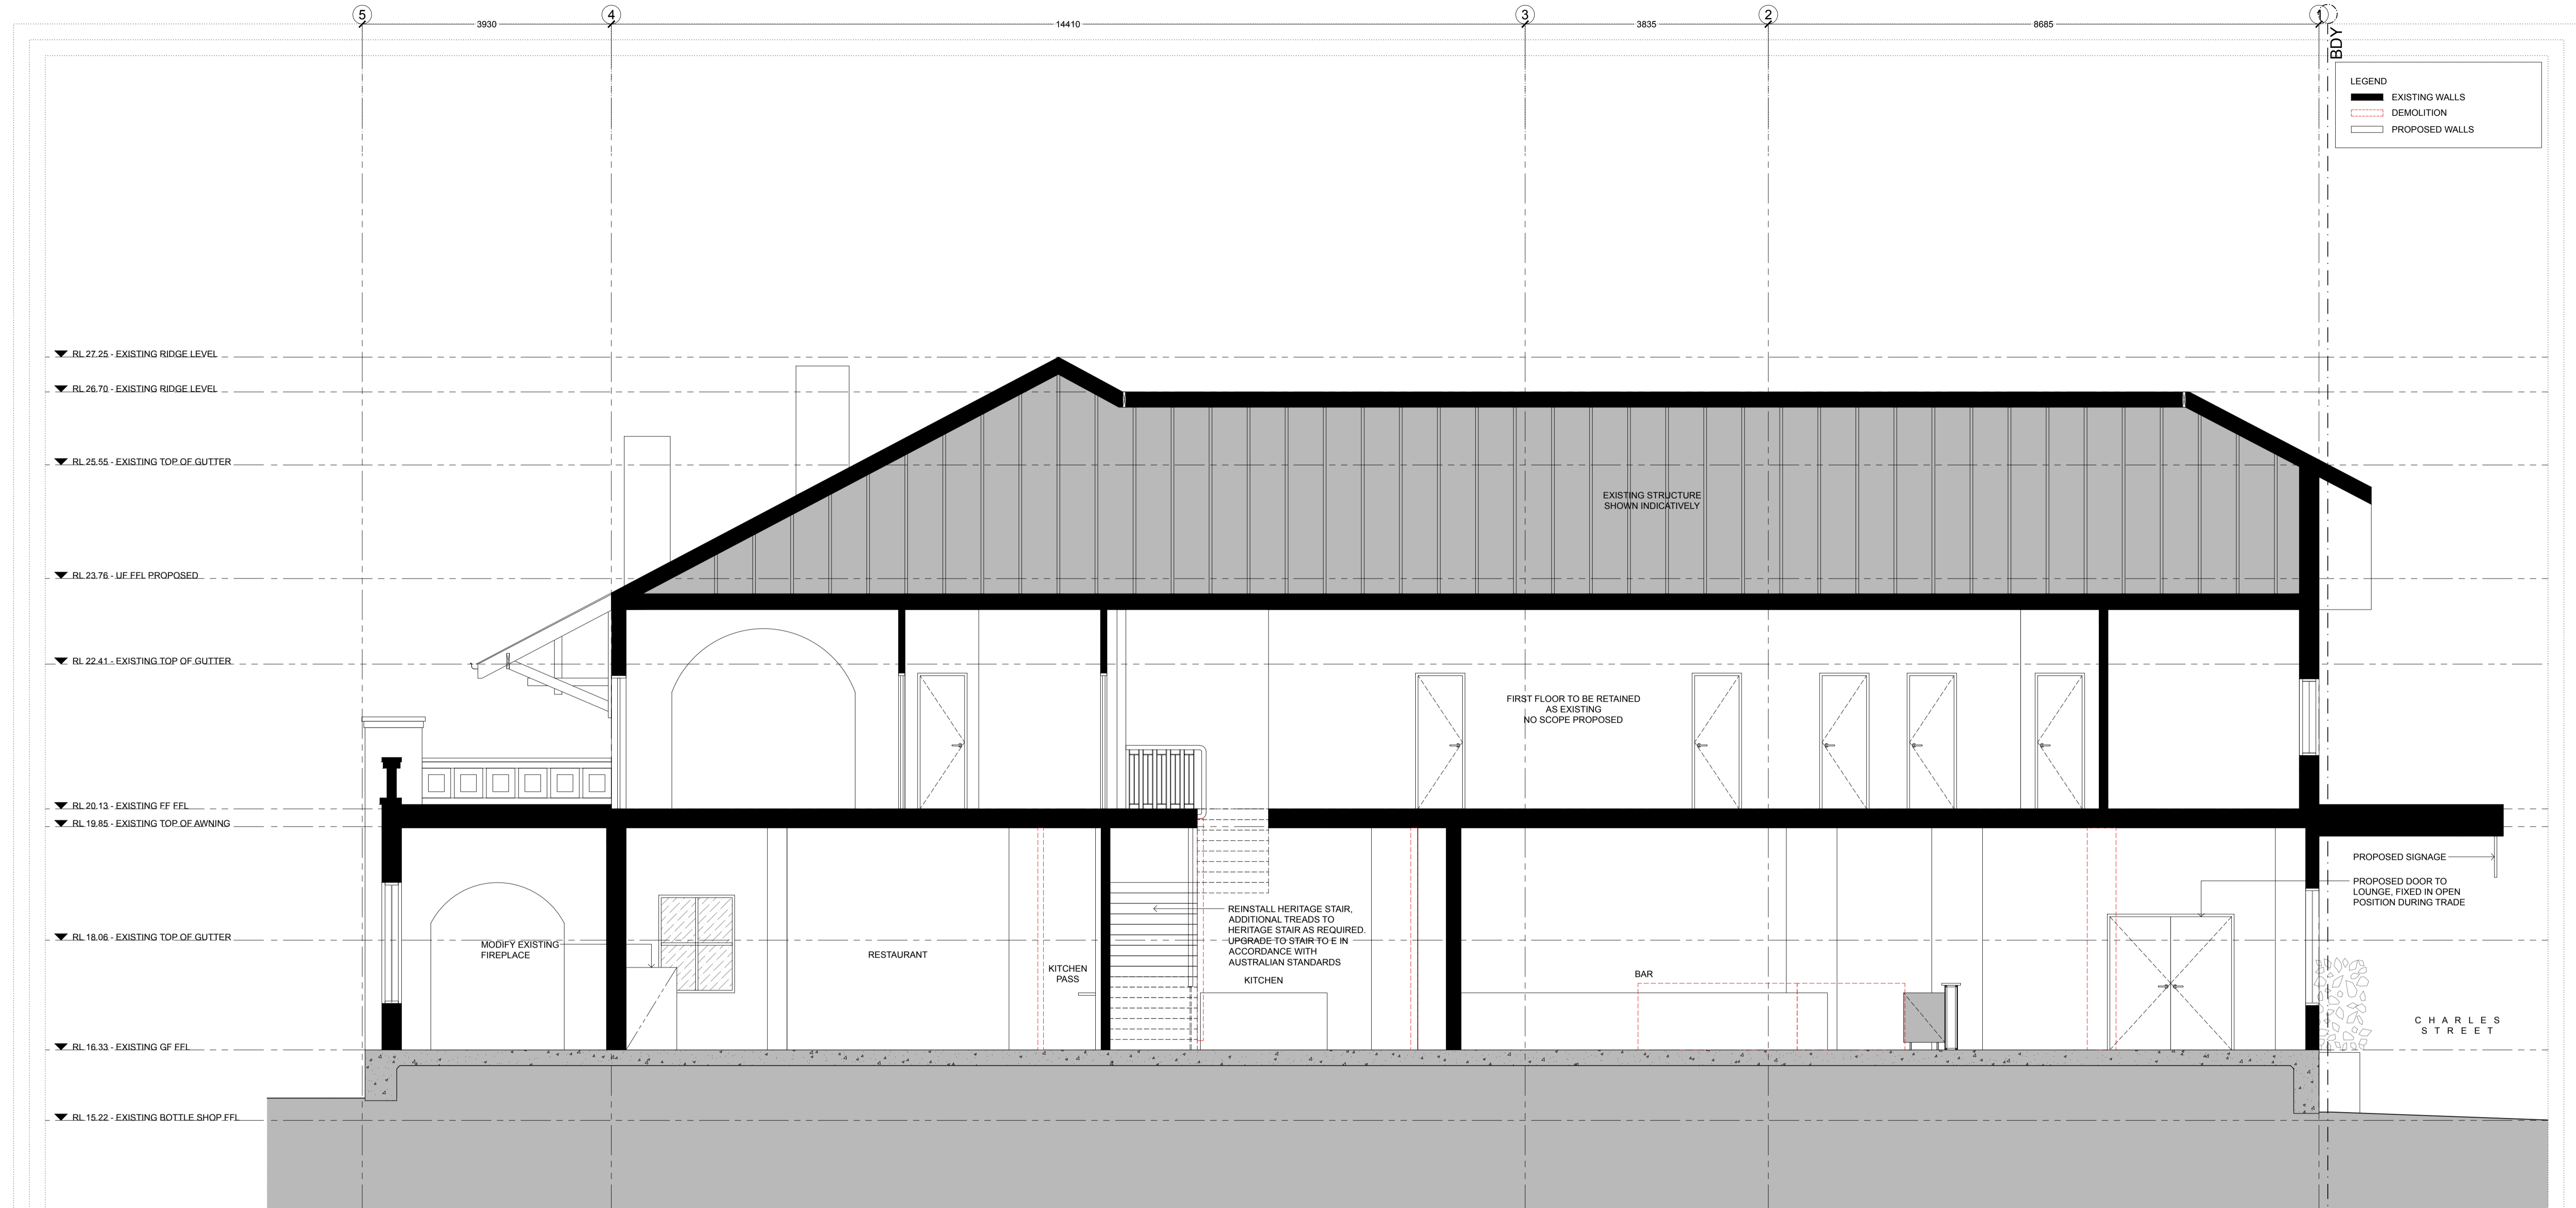FOR DA APPLICATION




CATERBUILD
 CHRIS JEFFARES
 CATERBUILD
 UNIT 7/3 WARRAH STREET
 CHATSWOOD, NSW, 2067
 T: 02 8350 7947
 M: 0406 004 500

Revisions	Date
A RESTAURANT BAR RELOCATED	29-04-20

Project
KITCHEN & BARS
 Address
HARBORD HOTEL

Project No.		Drawn by		Scale		Sheet size		Issue	
2008		NH		1 : 150		A3		SKETCH DESIGN	
								Revision No.	Revision date
								A	29-04-20

Drawing number
100

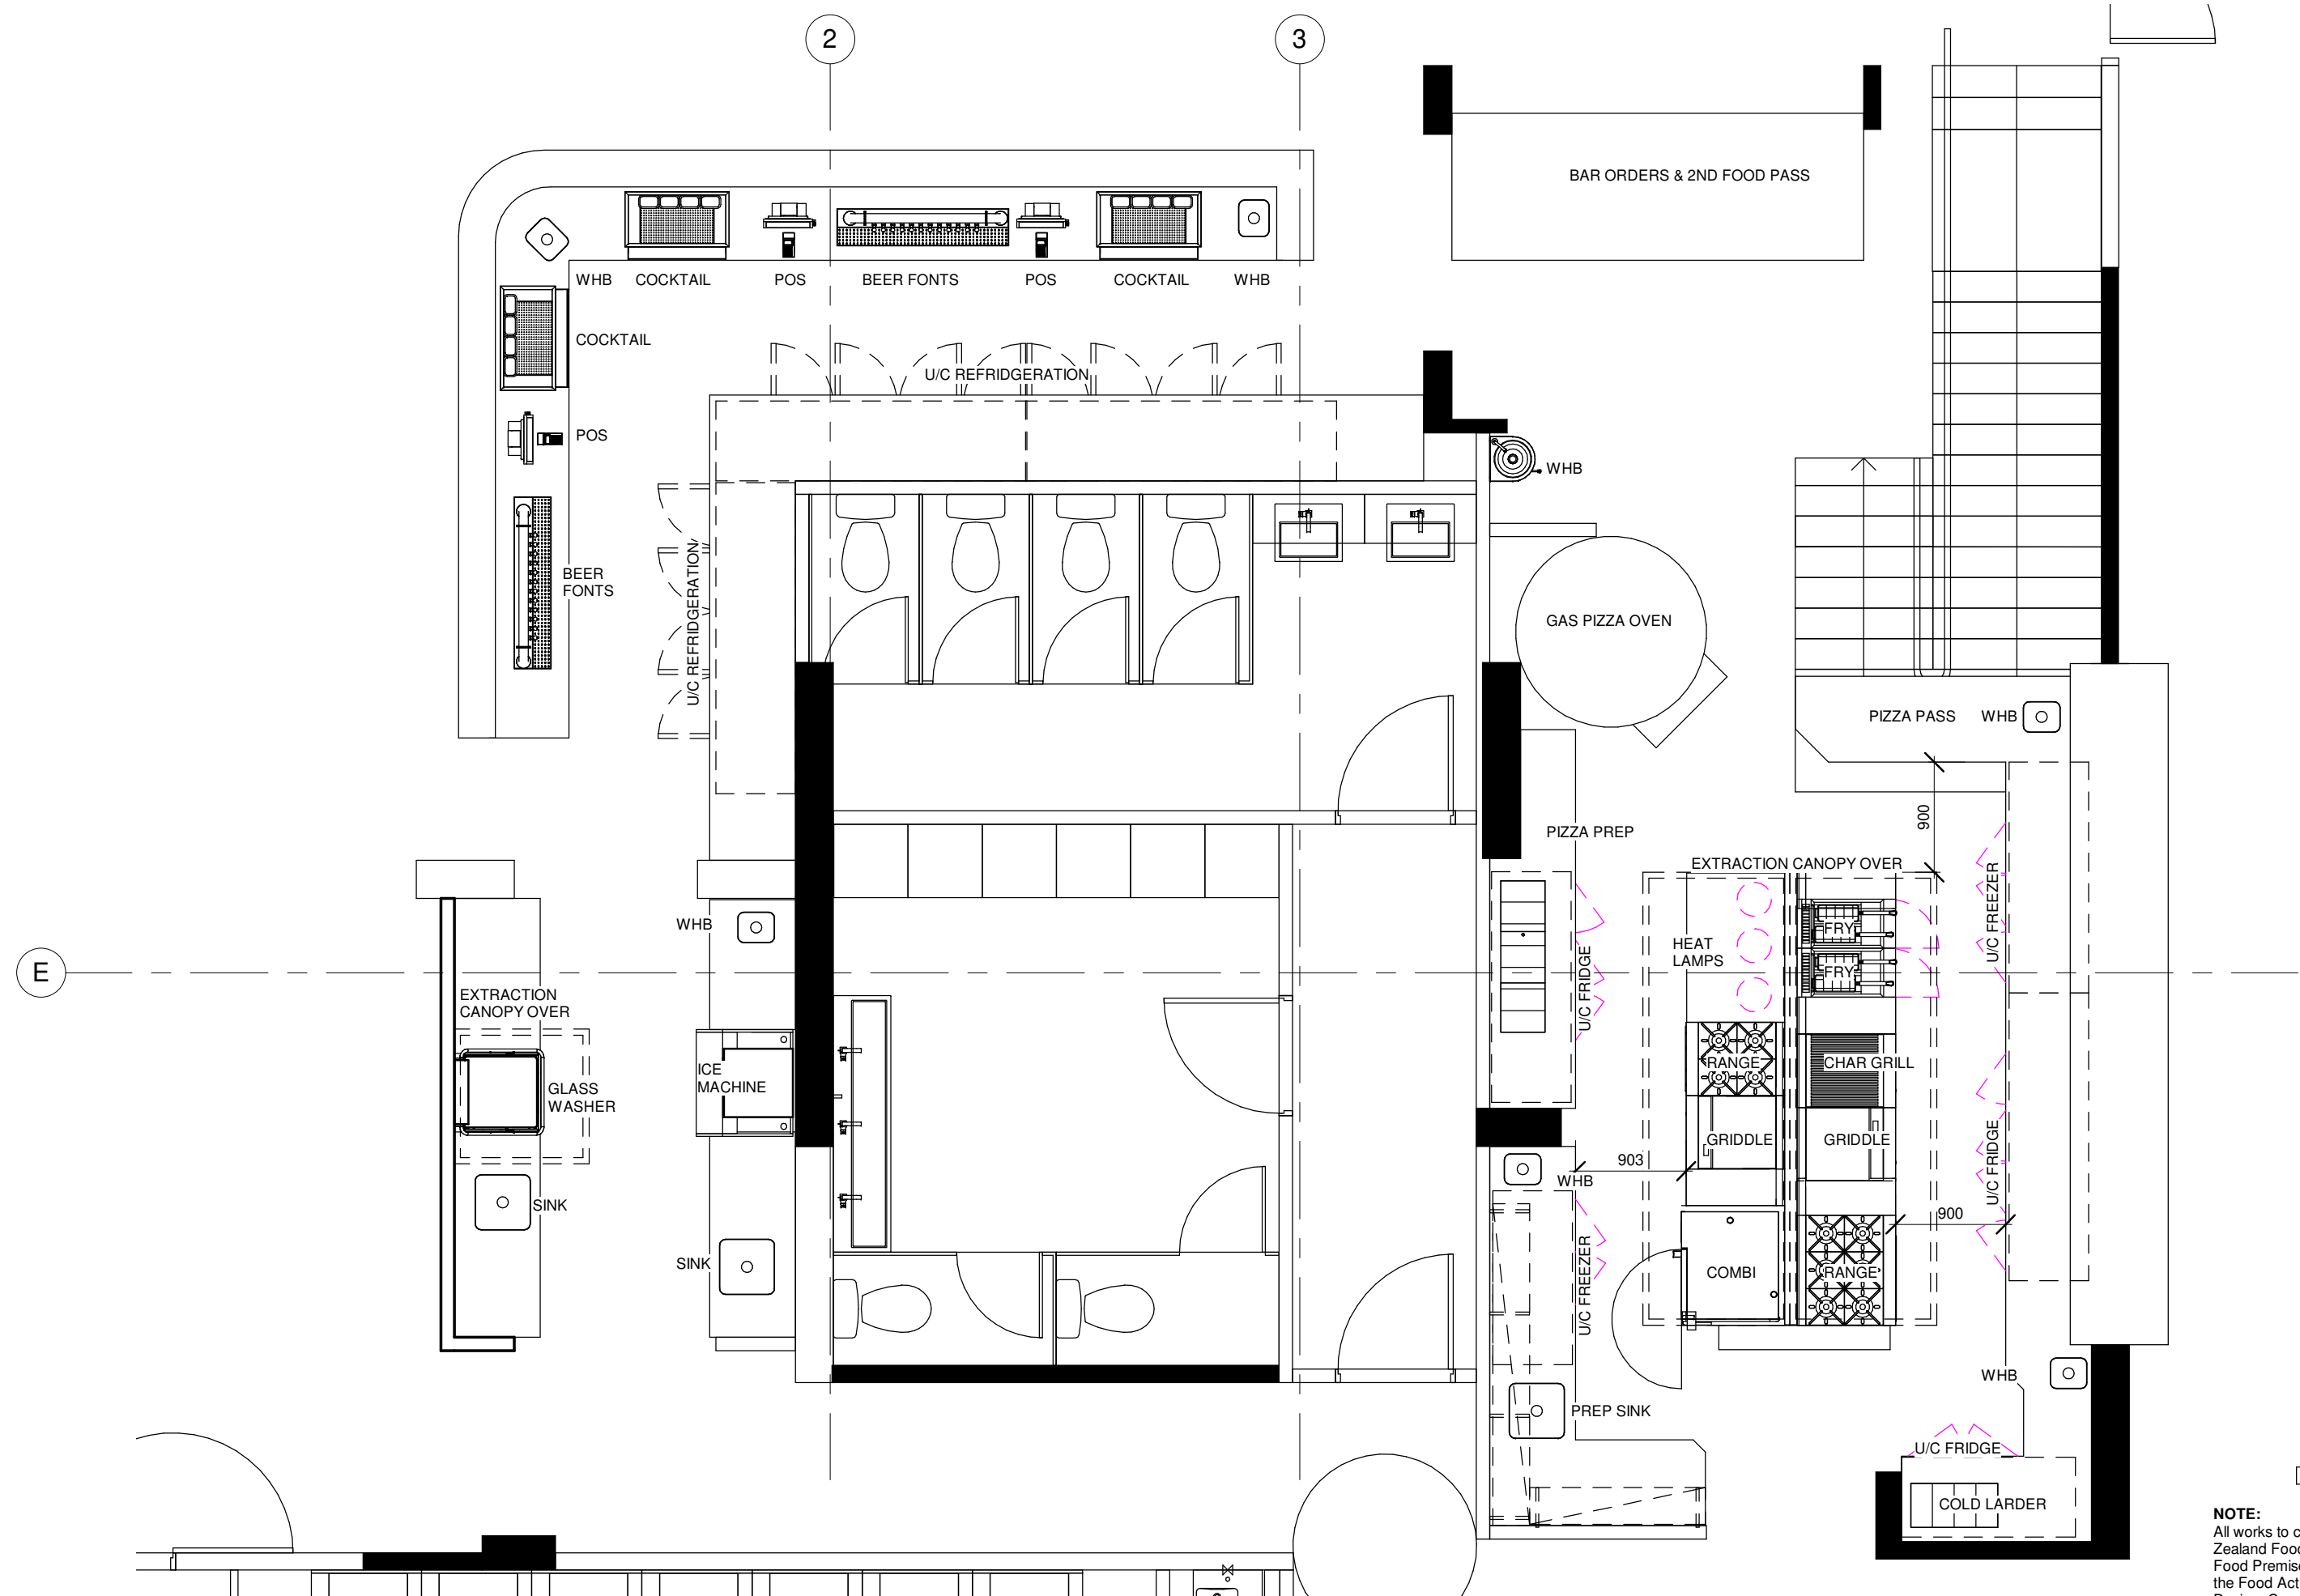

NOTE:
 All works to comply with Australia New Zealand Food Standards Code – 3.2.3 – Food Premises and Equipment under the Food Act 2003 and AS 4674 - Design, Construction and Fit-out of Food Premises

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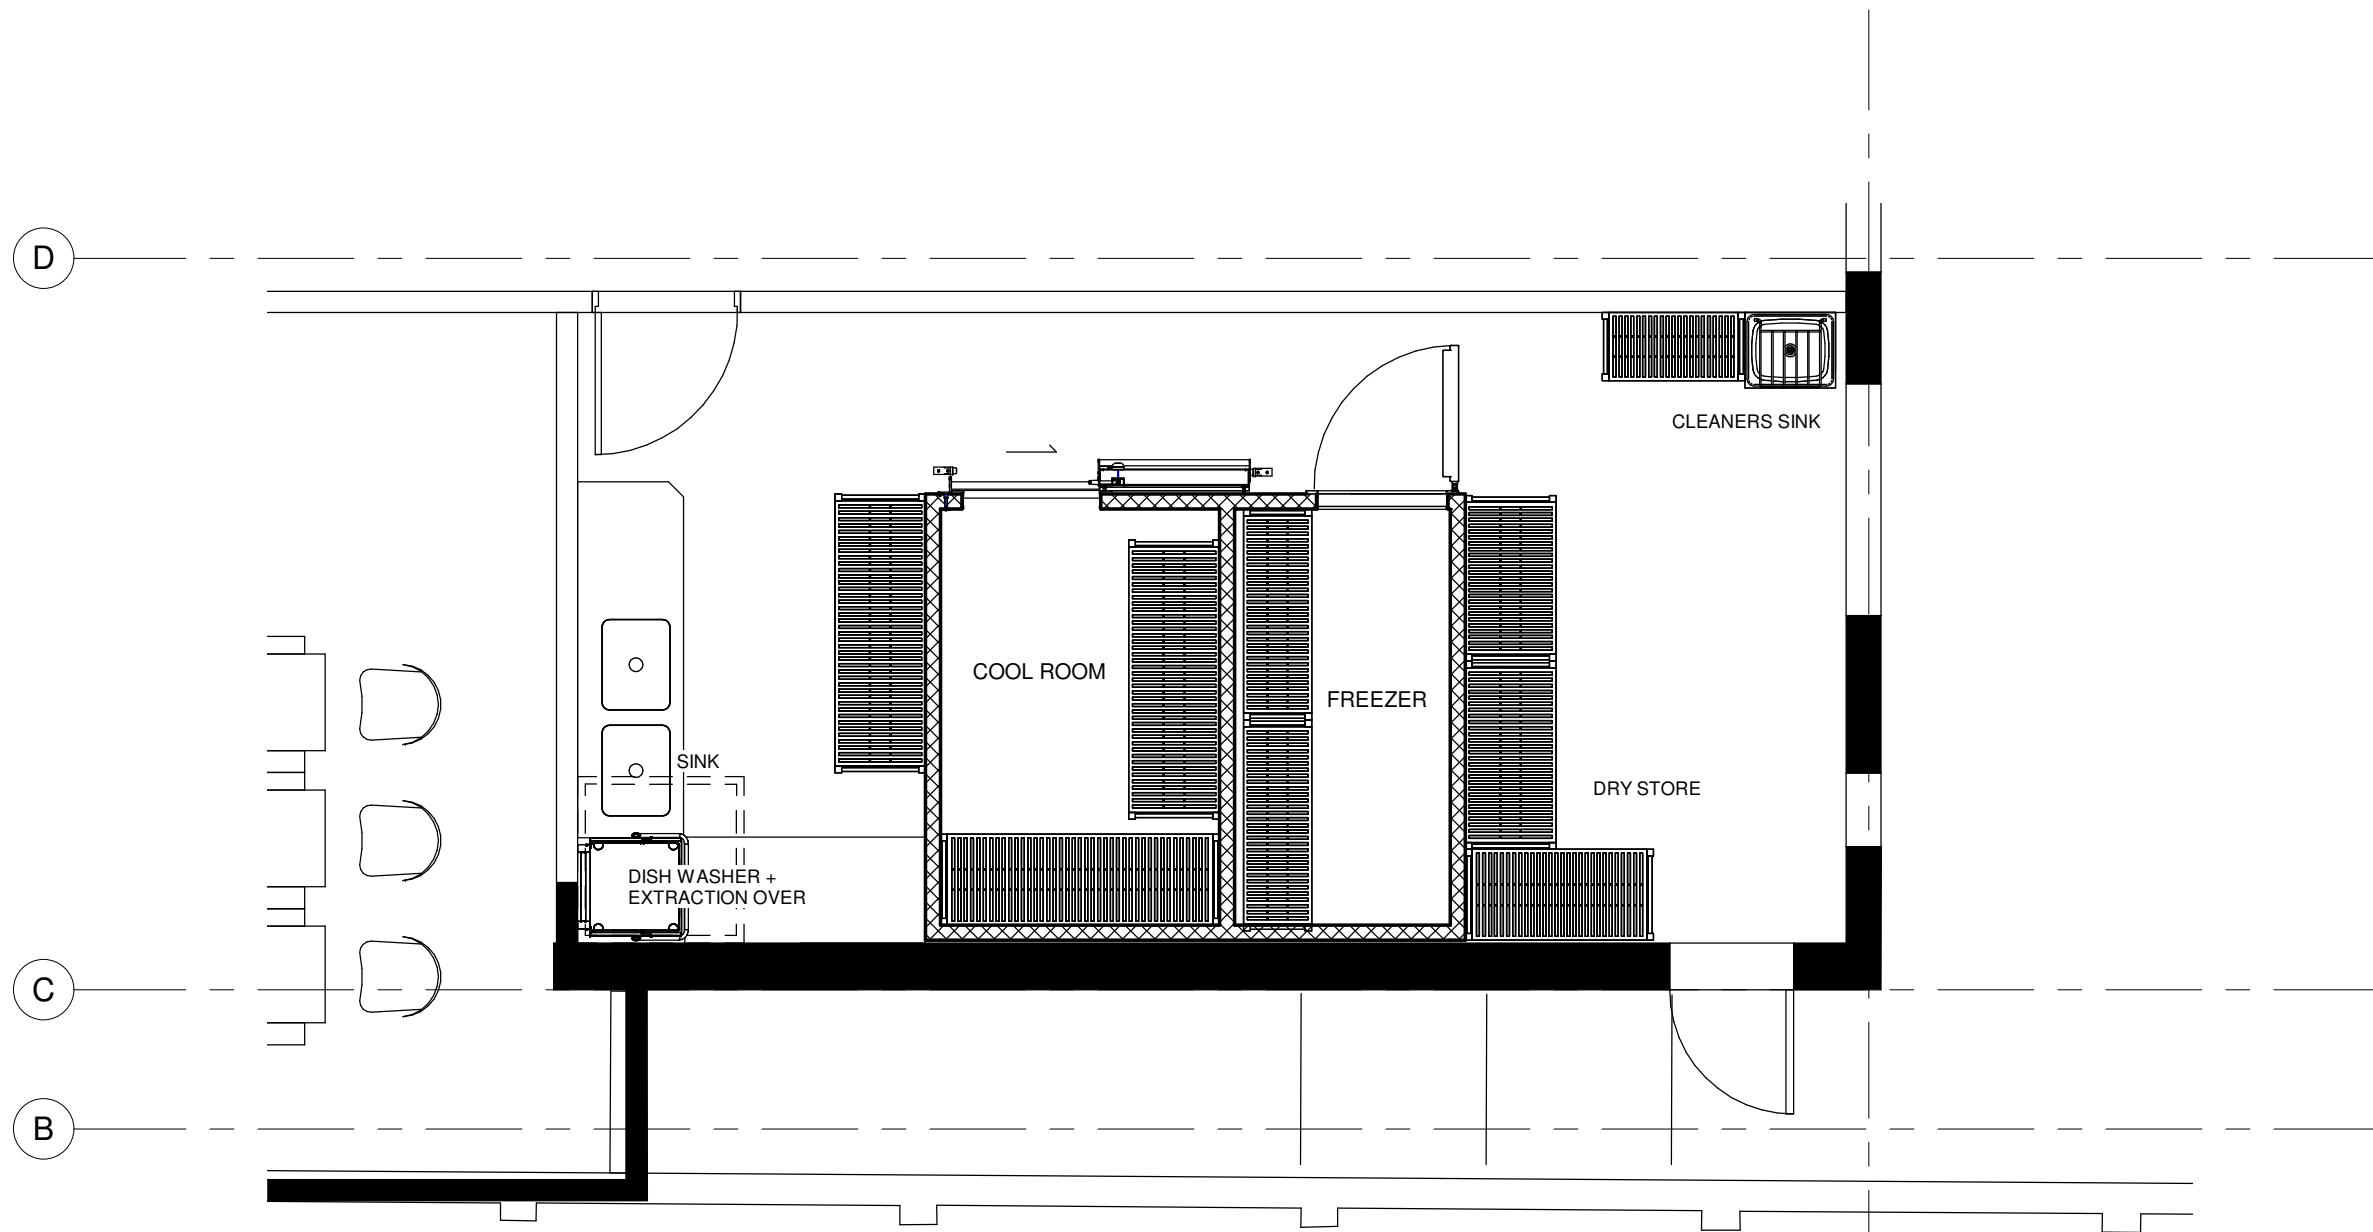
Revisions

Project
KITCHEN & BARS
 Address
HARBORD HOTEL

Title
KITCHEN PLAN
 Project No. 2008
 Drawn by NH
 Scale 1 : 50
 Sheet size A3

Issue
SKETCH DESIGN
 Revision No. | Revision date

Drawing number
101



NOTE:
 All works to comply with Australia New Zealand Food Standards Code – 3.2.3 – Food Premises and Equipment under the Food Act 2003 and AS 4674 - Design, Construction and Fit-out of Food Premises

4

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Revisions

Project
KITCHEN & BARS
 Address
HARBORD HOTEL


Title
STORAGE PLAN

Project No. 2008	Drawn by NH	Scale 1 : 50	Sheet size A3
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Issue SKETCH DESIGN	Revision No.	Revision date
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Drawing number

102



NOTE:
 All works to comply with Australia New Zealand Food Standards Code – 3.2.3 – Food Premises and Equipment under the Food Act 2003 and AS 4674 - Design, Construction and Fit-out of Food Premises

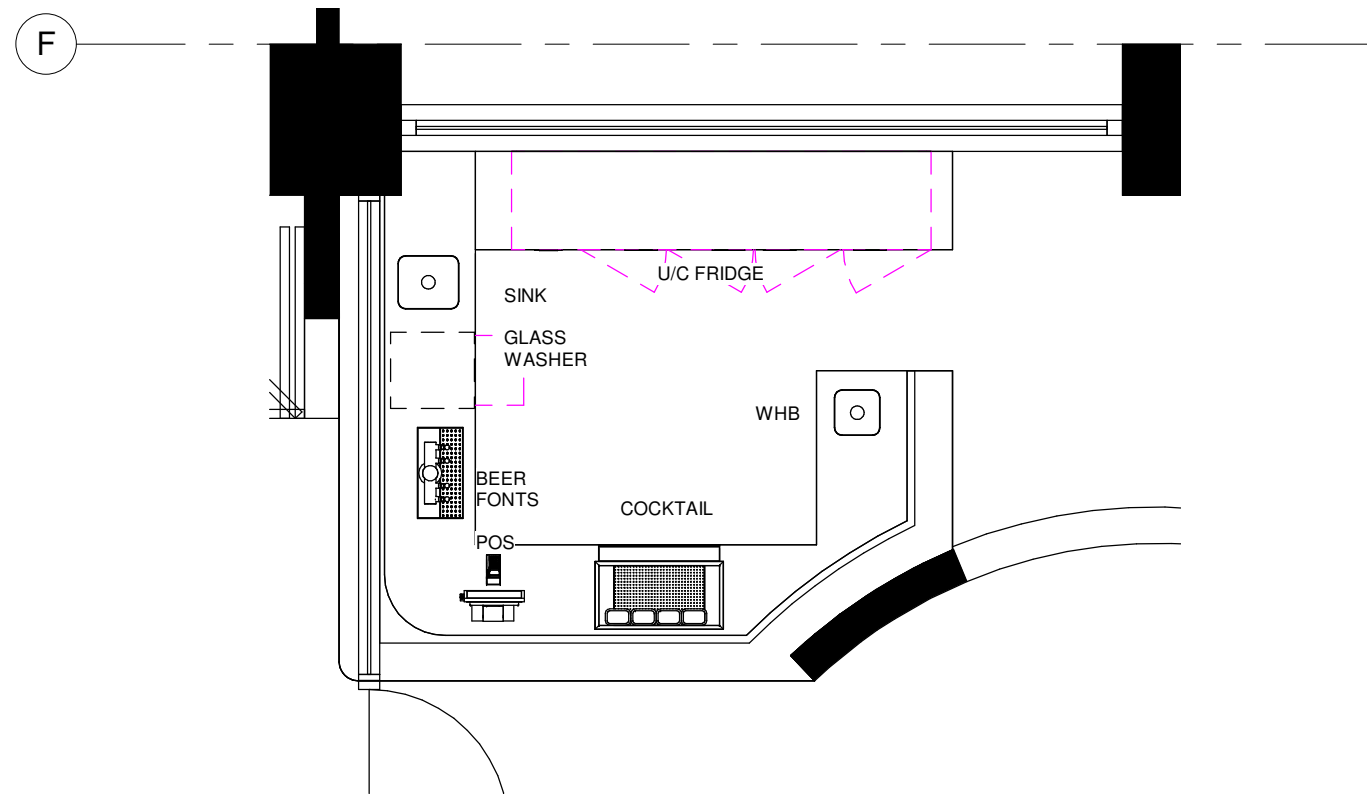

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Revisions
 A RESTAURANT BAR RELOCATED

29-04-20

Project
KITCHEN & BARS
 Address
HARBORD HOTEL

Title
RESTAURANT BAR

Project No. 2008	Drawn by NH	Scale 1 : 50	Sheet size A3	Revision No. A	Revision date 29-04-20
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Drawing number

103

GENERAL NOTES

- THESE NOTES ARE A GENERAL GUIDE ONLY. ALL CONTRACTORS SHOULD REFER TO LOCAL AUTHORITIES REGARDING MINIMUM HEALTH REGULATIONS
- CATERBUILD DRAWINGS AND SPECIFICATIONS SHALL BE READ IN CONJUNCTION WITH OTHER CONSULTANT'S DOCUMENTATION.
- THESE DRAWINGS REMAIN THE PROPERTY OF CATER BUILD AND CANNOT BE USED OR REPRODUCED WITHOUT WRITTEN PERMISSION.
- GOODS AND MATERIALS USED IN THE FIT OUT OF THIS FOOD PREMISES SHALL COMPLY WITH ALL APPLICABLE AUSTRALIAN STANDARDS.
- CONFIRM ALL DIMENSIONS AND LEVELS ON SITE (EG: AFTER INTERNAL WALLS HAVE BEEN BUILT FOR TENANCIES) PRIOR TO CONSTRUCTION. VERIFY THE POSITION OF EQUIPMENT FITTINGS AND SERVICE POINTS PRIOR TO CONSTRUCTION. DO NOT USE SCALE DIMENSIONS FROM THESE DRAWINGS.
- CARRY OUT ALL BUILDING WORK TO THE STANDARD REQUIRED BY THE AUSTRALIAN BUILDING CODE.
- ALL TRADES ARE TO ENSURE THE SITE IS KEPT CLEAN AND TIDY AT ALL TIMES.
- KITCHEN AND BAR AREAS TO COMPLY WITH AS4274-2004: DESIGN, CONSTRUCTION AND FIT-OUT OF FOOD PREMISES.
- ALL FLOORS SHALL BE OF AN IMPERVIOUS FINISH COVERED AT THE INTERSECTION OF ALL WALLS TO A MINIMUM RADIUS OF 25mm AND THE FLOOR FINISH EXTENDING AT LEAST 100mm UP THE WALL SURFACE.
- ALL CERAMIC TYPE FLOOR AND COVING TILES ARE TO BE CLOSE FITTED AT THE JOINTS WITH A MAXIMUM GROUT WIDTH OF 3mm. CERAMIC FLOOR TILES SHALL BE EPOXY GROUTED AND LAID IN ACCORDANCE WITH THE REQUIREMENTS OF AS3958.1-2007: GUIDE TO INSTALLATION OF CERAMIC TILES.
- ALL FLOORS TO FOOD PREPARATION AND STORAGE AREAS SHALL BE GRADED TO DRAIN LIQUIDS TO FLOOR WASTES.
- COOLROOMS SHALL BE PROVIDED WITH SAFETY DEVICES TO COMPLY WITH CLAUSE G1.2 OF THE BCA.
- THE CONCRETE FLOOR OF COOLROOMS AND FREEZERS SHALL BE SEALED WITH AT LEAST TWO COATS OF AN APPROVED EPOXY RESIN SEALANT.

MECHANICAL NOTES:

- THE WHOLE INSTALLATION AND MATERIALS SHALL BE IN ACCORDANCE WITH , AS1668:2012, AND LOCAL AUTHORITY REQUIREMENTS
- THE EXTRACTION CANOPIES ARE TO CONFORM TO AS1668:2012, OR ALTERNATIVE EXHAUST HOOD DESIGNS MAY BE USED PROVIDED IT CAN BE ESTABLISHED THAT THE PERFORMANCE OF SUCH SYSTEMS AS EQUAL.
- THE CONTRACTORS SHALL CO ORDINATE AND CONFIRM ALL CEILING HEIGHTS, PROPOSED DUCTING ROUTES, EQUIPMENT SERVICE REQUIREMENTS WITH ALL RELEVANT PARTIES PRIOR TO CONDUCTING THE WORKS. THE LOCATION OF THE FAN/OUTLET IS TO BE AGREED WITH CATER BUILD, AND COMPLY WITH AS1668.2012
- PROVIDE A BULKHEAD BETWEEN THE CEILING AND THE TOP OF THE EXTRACTION CANOPIES WHERE NECESSARY.
- THE CONTRACTOR WILL PROVIDE PRODUCER STATEMENTS FOR THE WORKS CARRIED OUT.

HYDRAULIC NOTES

- THE WHOLE INSTALLATION AND MATERIALS SHALL BE IN ACCORDANCE WITH AS3500:2003 FOR PLUMBING WORKS OR AS 5601:2010 FOR GAS WORKS AND LOCAL AUTHORITY'S REQUIREMENTS.
- THE CONTRACTORS SHALL CO-ORDINATE AND CONFIRM ALL PROPOSED ROUTES, EQUIPMENT SERVICE REQUIREMENTS AND LOCATION SUITABILITY WITH ALL RELEVANT PARTIES PRIOR TO CONDUCTING THE WORKS.
- FLOOR WASTES SHALL BE FLUSH MOUNTED WITH OR RECESSED BELOW THE FINISHED FLOOR LEVEL SO AS TO ENSURE NO PONDING OR POOLING OCCURS IN THE FOOD PREMISES.
- WASH HAND BASINS SHALL HAVE AN ACCESSIBLE TEMPERING DEVICE LOCATED NEAR THE BASIN THAT IS ADJUSTABLE AT LEAST $\pm 10^\circ$ IN INCREMENTS OF 1° OR BETTER AND BE INITIALLY SET AT 45° .
- ALL METAL SANITARY FITTINGS TO BE EQUIPOTENTIALLY BONDED.

ELECTRICAL NOTES

- THE WHOLE INSTALLATION AND MATERIALS SHALL BE IN ACCORDANCE WITH AS/NZS 3000:2007 AND LOCAL AUTHORITIES REQUIREMENTS.
- POSITION OF GPO'S & CONNECTION POINTS ARE INDICATIVE ONLY. CONTRACTOR IS RESPONSIBLE FOR COORDINATION WITH THE PROJECT MANAGER TO DETERMINE FINAL LOCATION.

JOINERY NOTES.

- ALL JOINERY REQUIRES A SITE MEASURE BY THE NOMINATED CONTRACTOR PRIOR TO FABRICATION
- JOINERY TO BE SCRIBED IN ON SITE
- REFER TO FINISHES SCHEDULE FOR FINISHES.
- PROVIDE NOGGINGS IN PLASTERBOARD STUD WALLS WHERE REQUIRED FOR BUILT-IN JOINERY, FIXING OF HOOKS AND OTHER WALL MOUNTED FIXTURES.
- ALLOW 10mm SHADOWLINE TO JUNCTION OF WALLS AND CEILINGS UNLESS OTHERWISE NOTED.
- CONTRACTOR TO ENSURE ALL BUILDING SERVICES HAVE BEEN COORDINATED, INCLUDED AND ACCESSIBLE AS REQUIRED.
- CONTRACTOR TO ENSURE WITH ELECTRICAL CONTRACTOR THAT ALL POWER, DATA, COMMUNICATION REQUIREMENTS ARE ACCESSIBLE.
- CONTRACTOR TO CONCEAL ALL STRUCTURAL ELEMENTS AS REQUIRED.
- CONTRACTOR TO ENSURE CONSISTENCY BETWEEN SIMILAR MATERIALS IS MAINTAINED.
- CONCEAL ANCHOR TO SLAB AND/OR TO OTHER STRUCTURAL ELEMENT FOR ALL JOINERY ITEMS.
- CONTRACTOR TO ENSURE ADEQUATE STRENGTH AND STABILITY OF ALL ITEMS.

SERVICE NOTES

- 90° ELBOWS AND ISOLATING VALVES TO BE FITTED TO THE ENDS OF ALL GAS AND WATER SUPPLIES.
- DIMENSIONS INDICATED ARE TO TERMINATION POINTS & FINISHED SURFACES.
- ALL SERVICES ARE TO RUN THROUGH THE STUD WALLS.
- ALL DIMENSIONS MUST BE CONFIRMED BY A SITE MEASURE.

GAS FRYERS

- LPG GAS PRESSURE 2.75 - 3 KPA, @ EACH GAS APPLIANCE BEFORE REGULATOR.
- NATURAL GAS PRESSURE 1.1 - 2 KPA, @ EACH GAS APPLIANCE BEFORE REGULATOR.
- ALL OTHER GAS EQUIPMENT :
- LPG GAS PRESSURE 2.75 - 4.5 KPA @ EACH GAS APPLIANCE BEFORE REGULATOR.
- NATURAL GAS PRESSURE 1.1 - 3.4 KPA @ EACH GAS APPLIANCE BEFORE REGULATOR.

STAINLESS STEEL NOTES

GRADE

- 304

FINISH

- NO. 4

THICKNESS

- AS SPECIFIED AND/OR AS PER MANUFACTURE'S SPECIFICATION.

STANDARD

- AUSTRALIAN STANDARD ASTM A276 AND AS 1449.
- ALL FIXINGS ARE TO BE S/S TYPE 304, AND CONCEALED WHEREVER POSSIBLE.
- ALL FIXINGS ARE TO BE ADEQUATELY SIZED AND LOCATED TO PROVIDE ALL NECESSARY SUPPORT TO COMPONENTS OR ITEMS OF THE WORK
- WELDING IS TO BE OF THE HIGHEST QUALITY AND FREE FROM MECHANICAL IMPERFECTIONS. JOINTS ARE TO BE CONTINUOUS WHEREVER POSSIBLE AND ARE TO BE GROUND AND POLISHED SMOOTH SO AS TO BE INVISIBLE. SPOT OR TACK WELDING WILL NOT BE ACCEPTABLE.
- FEET ARE TO BE ADJUSTABLE, BULLET-TYPE. SUBMIT SAMPLE FOR APPROVAL.
- LEGS, BRACING AND FRAMEWORK ARE TO BE 32MM S/S TUBE SQUARE OR ROUND, ALL NEATLY WELDED
- BENCH TOPS AND SPLASHBACKS ARE TO BE 1.5mm STAINLESS STEEL. EDGES ARE TO BE WET OR DRY, AS SHOWN ON PLANS.
- THE NUMBER OF JOINTS IS TO BE KEPT TO A MINIMUM.
- THE GRAIN IN ADJACENT BENCH TOPS IS TO RUN LENGTHWISE.
- SPLASHBACKS ARE TO BE FITTED WITH MARINE PLY BACKING BOARD SEALED TO FORM AN IMPERVIOUS SURFACE.
- ALLOW TO PROVIDE CUTOUTS IN S/S SURFACES REQUIRED BY OTHER TRADES OR EQUIPMENT.
- LEGS TO BE 75MM AWAY FROM ALL ADJACENT WALLS AND VERTICAL SURFACES.
- 18MM MERANTI PLYWOOD TO BE ADHESIVE FIXED TO UNDERSIDE OF BENCHES AND SEALED TO FORM AN IMPERVIOUS SURFACE.

SEALANT

- METAL TO METAL, OR METAL TO WALL SEALANT IS TO BE SUITABLE FOR NORMAL HEAVY DUTY COMMERCIAL KITCHEN SITUATIONS. IT IS TO BE NON-ACIDIC, NEUTRAL CURING, TACK FREE AFTER FORTY-FIVE MINUTES. IT IS TO REMAIN FLEXIBLE AND IS TO NOT ALTER ITS PROPERTIES AFTER THE INITIAL 24 HOUR PERIOD. COLOUR IS TO BE WHITE TO MATCH ADJACENT WALL TILES, OR GREY FOR METAL TO METAL SEALING. IT IS TO BE EXPANDITE ELASTIC SILICONE 88 ELASTOMERIC SEALANT (OR SIMILAR APPROVED) APPLIED AS PER MANUFACTURER'S INSTRUCTIONS.
- ALL SPACES BETWEEN EQUIPMENT AND ADJACENT FINISHES AND/OR EQUIPMENT ARE TO BE COMPLETELY SEALED. GAPS GREATER THAN 5MM, ARE TO BE SEALED WITH S/S SHEET SUITABLY FIXED AND SEALED TO APPROVAL.

UNDERHELVES


- UNDERSHELVES ARE TO BE 1.2mm S/S, SECURELY FIXED TO THE LEGS.

SINKS

- SINK BOWLS ARE TO BE:
- 1.2mm S/S AND INTEGRAL WITH BENCH TOP.
- SIZE IS TO BE 450 WIDE X 450 LONG X 300 DEEP UNLESS OTHERWISE SPECIFIED.
- ALL CORNERS ARE TO BE RADIUS, MINIMUM 20mm RADIUS.
- ALL BOWLS ARE TO BE SUPPLIED WITH A STANDARD 50mm CHROME PLATED WASTE FITTING, A HEAVY DUTY METAL PLUG AND S/S CHAIN.
- PROVIDE DRY BASKET ARRESTORS 3 MONKEEZ SCRAP TRAP SSBW-1
- HAND BASINS ARE TO BE S/S AS SPECIFIED; HANDS FREE, KNEE OPERATED, OR ELECTRONIC HANDS FREE AS INDICATED, COMPLETE WITH CHROME PLATED WASTE, METAL PLUG AND S/S CHAIN. HAND BASIN SPOUTS ARE TO BE S/S, SATIN FINISH, BENCH MOUNTED.
- SUPPLY EACH SINK COMPLETE WITH TAPSET INCLUDING SPOUT AND FLEXIBLE HOSE CONNECTION. TAPSETS ARE TO BE SINGLE LEVER MIXER WITH 200mm SPOUT, CHROME FINISH. ALLOW TO PROVIDE PENETRATIONS TO BENCH TOPS AS REQUIRED TO FIT TAPS.
- ALLOW TO COORDINATE WITH THE ELECTRICAL CONTRACTOR TO LOCATE CUTOUTS AND SUPPORT BRACKETS AS REQUIRED TO FIT POWER OUTLETS AND WIRING RETICULATION. ALLOW TO FORM PENETRATIONS FOR POWER OUTLETS.

COOL ROOMS AND FREEZER ROOMS

- COOLROOMS ARE TO BE FABRICATED AND INSTALLED IN COMPLIANCE WITH:- AS/NZS 1677.2 AND THE RECOMMENDATIONS OF SAA HB 40.1 AND SAA HB 40.2.- THE RECOMMENDATIONS OF AIRAH FLAMMABLE REFRIGERANTS - SAFETY GUIDE- AS 4674 CONSTRUCTION AND FITOUT OF FOOD PREMISES
- COOLROOM PANELS TO BE ASKIN@ XFLAM PERFORMACE PANELS INSTALLED IN COMPLIANCE WITH THE MANUFACTURER'S SPECIFICATION.
- FOR TEMPERATURES ABOVE 0°C PANELS ARE TO BE MINIMUM 75mm THICK. FOR TEMPERATURES BELOW 0°C PANELS ARE TO BE 150mm THICK.
- ON SLAB INSTALLATIONS ARE TO BE INSTALLED WITH AN ALUMINIUM CHECKERPLATE WEARING SURFACE TO THE FLOOR INSULATION.
- RECESSED FLOOR INSTALLATIONS ARE TO BE INSTALLED WITH A 50mm CONCRETE TOPPING SLAB TO THE FLOOR INSULATION.
- VAPOUR BARRIERS AND HEATED PANELS TO BE INSTALLED TO PREVENT CONDENSATION IN SUSPENDED FLOOR SLABS.
- REFRIGERATION SYSTEMS ARE TO BE TWO PIECE PACKAGE SYSTEMS WITH SEPERATE EVAPORATOR AND AIR COOLED CONDENSER.

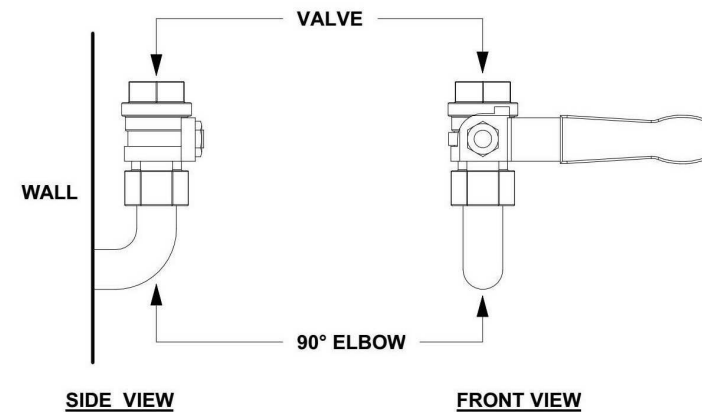

SERVICES TERMINATION DETAIL



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M: 0406 004 500

Revisions


Project
KITCHEN & BARS
Address
HARBORD HOTEL

Title
SPECIFICATION
Project No. 2008
Drawn by Author
Scale
Sheet size A3

Issue
SKETCH DESIGN
Revision No. | Revision date

Drawing number

01

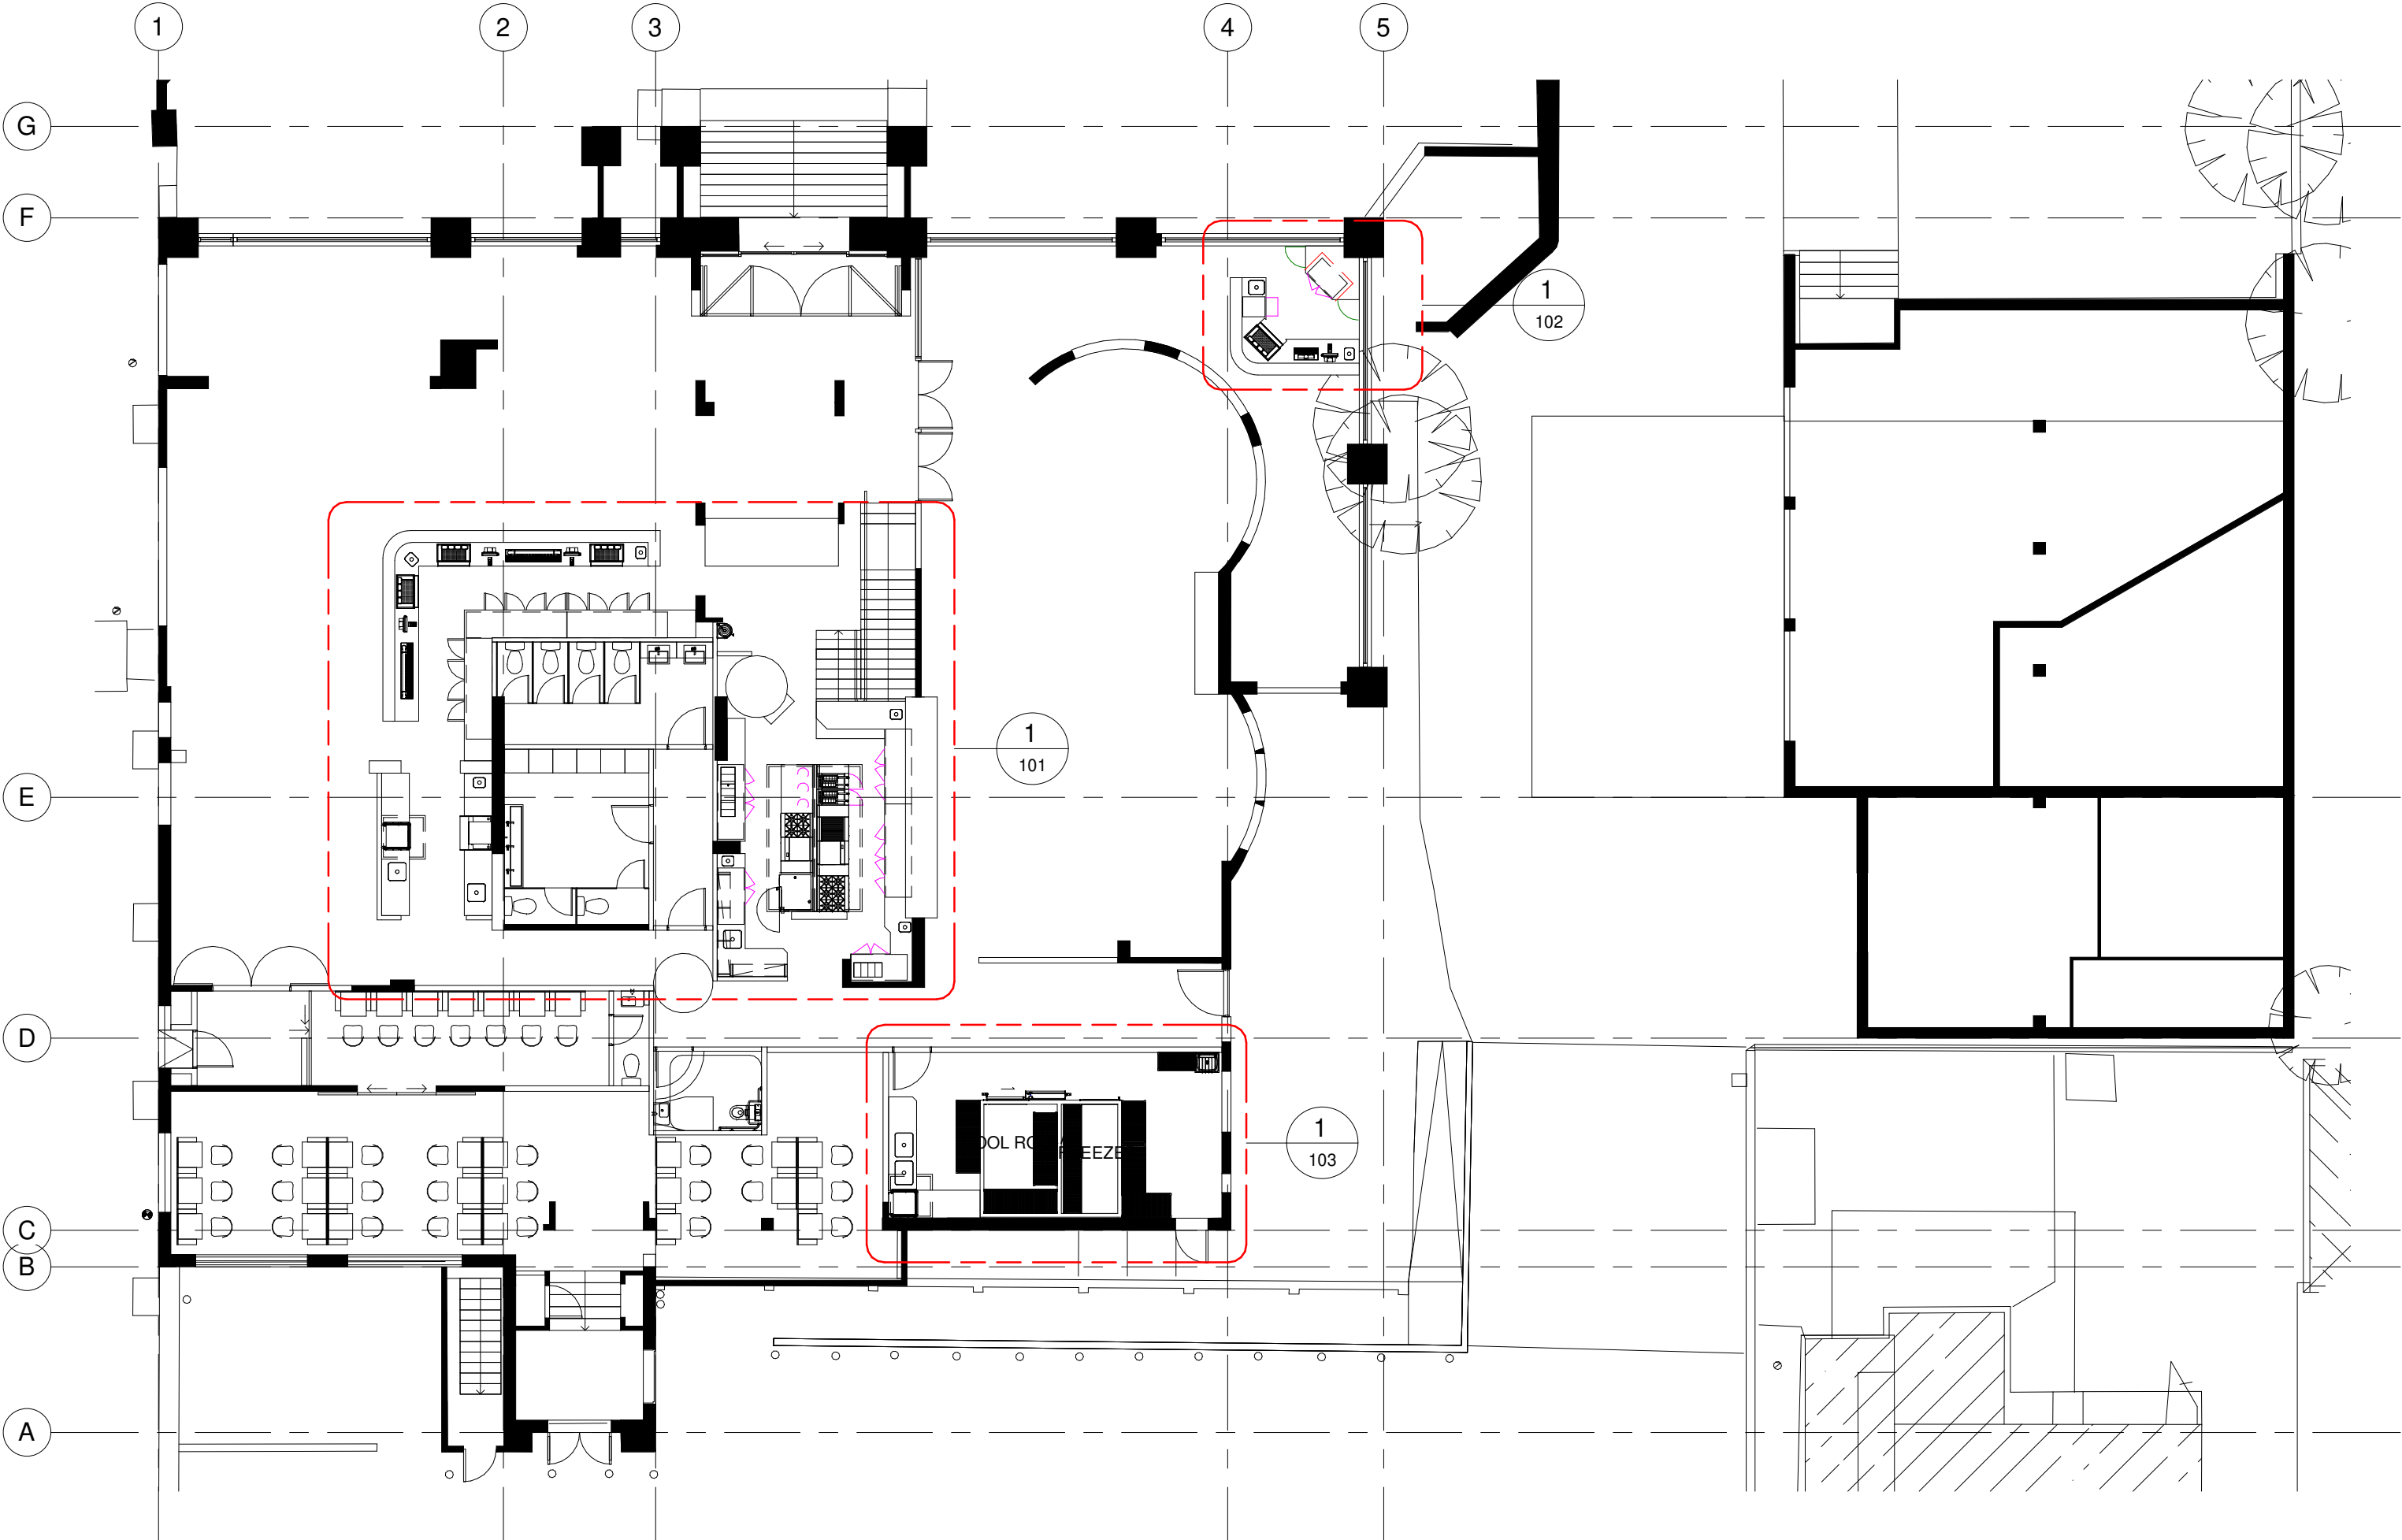


CHRIS JEFFARES
 CATERBUILD
 UNIT 7/3 WARRAH STREET
 CHATSWOOD, NSW, 2067
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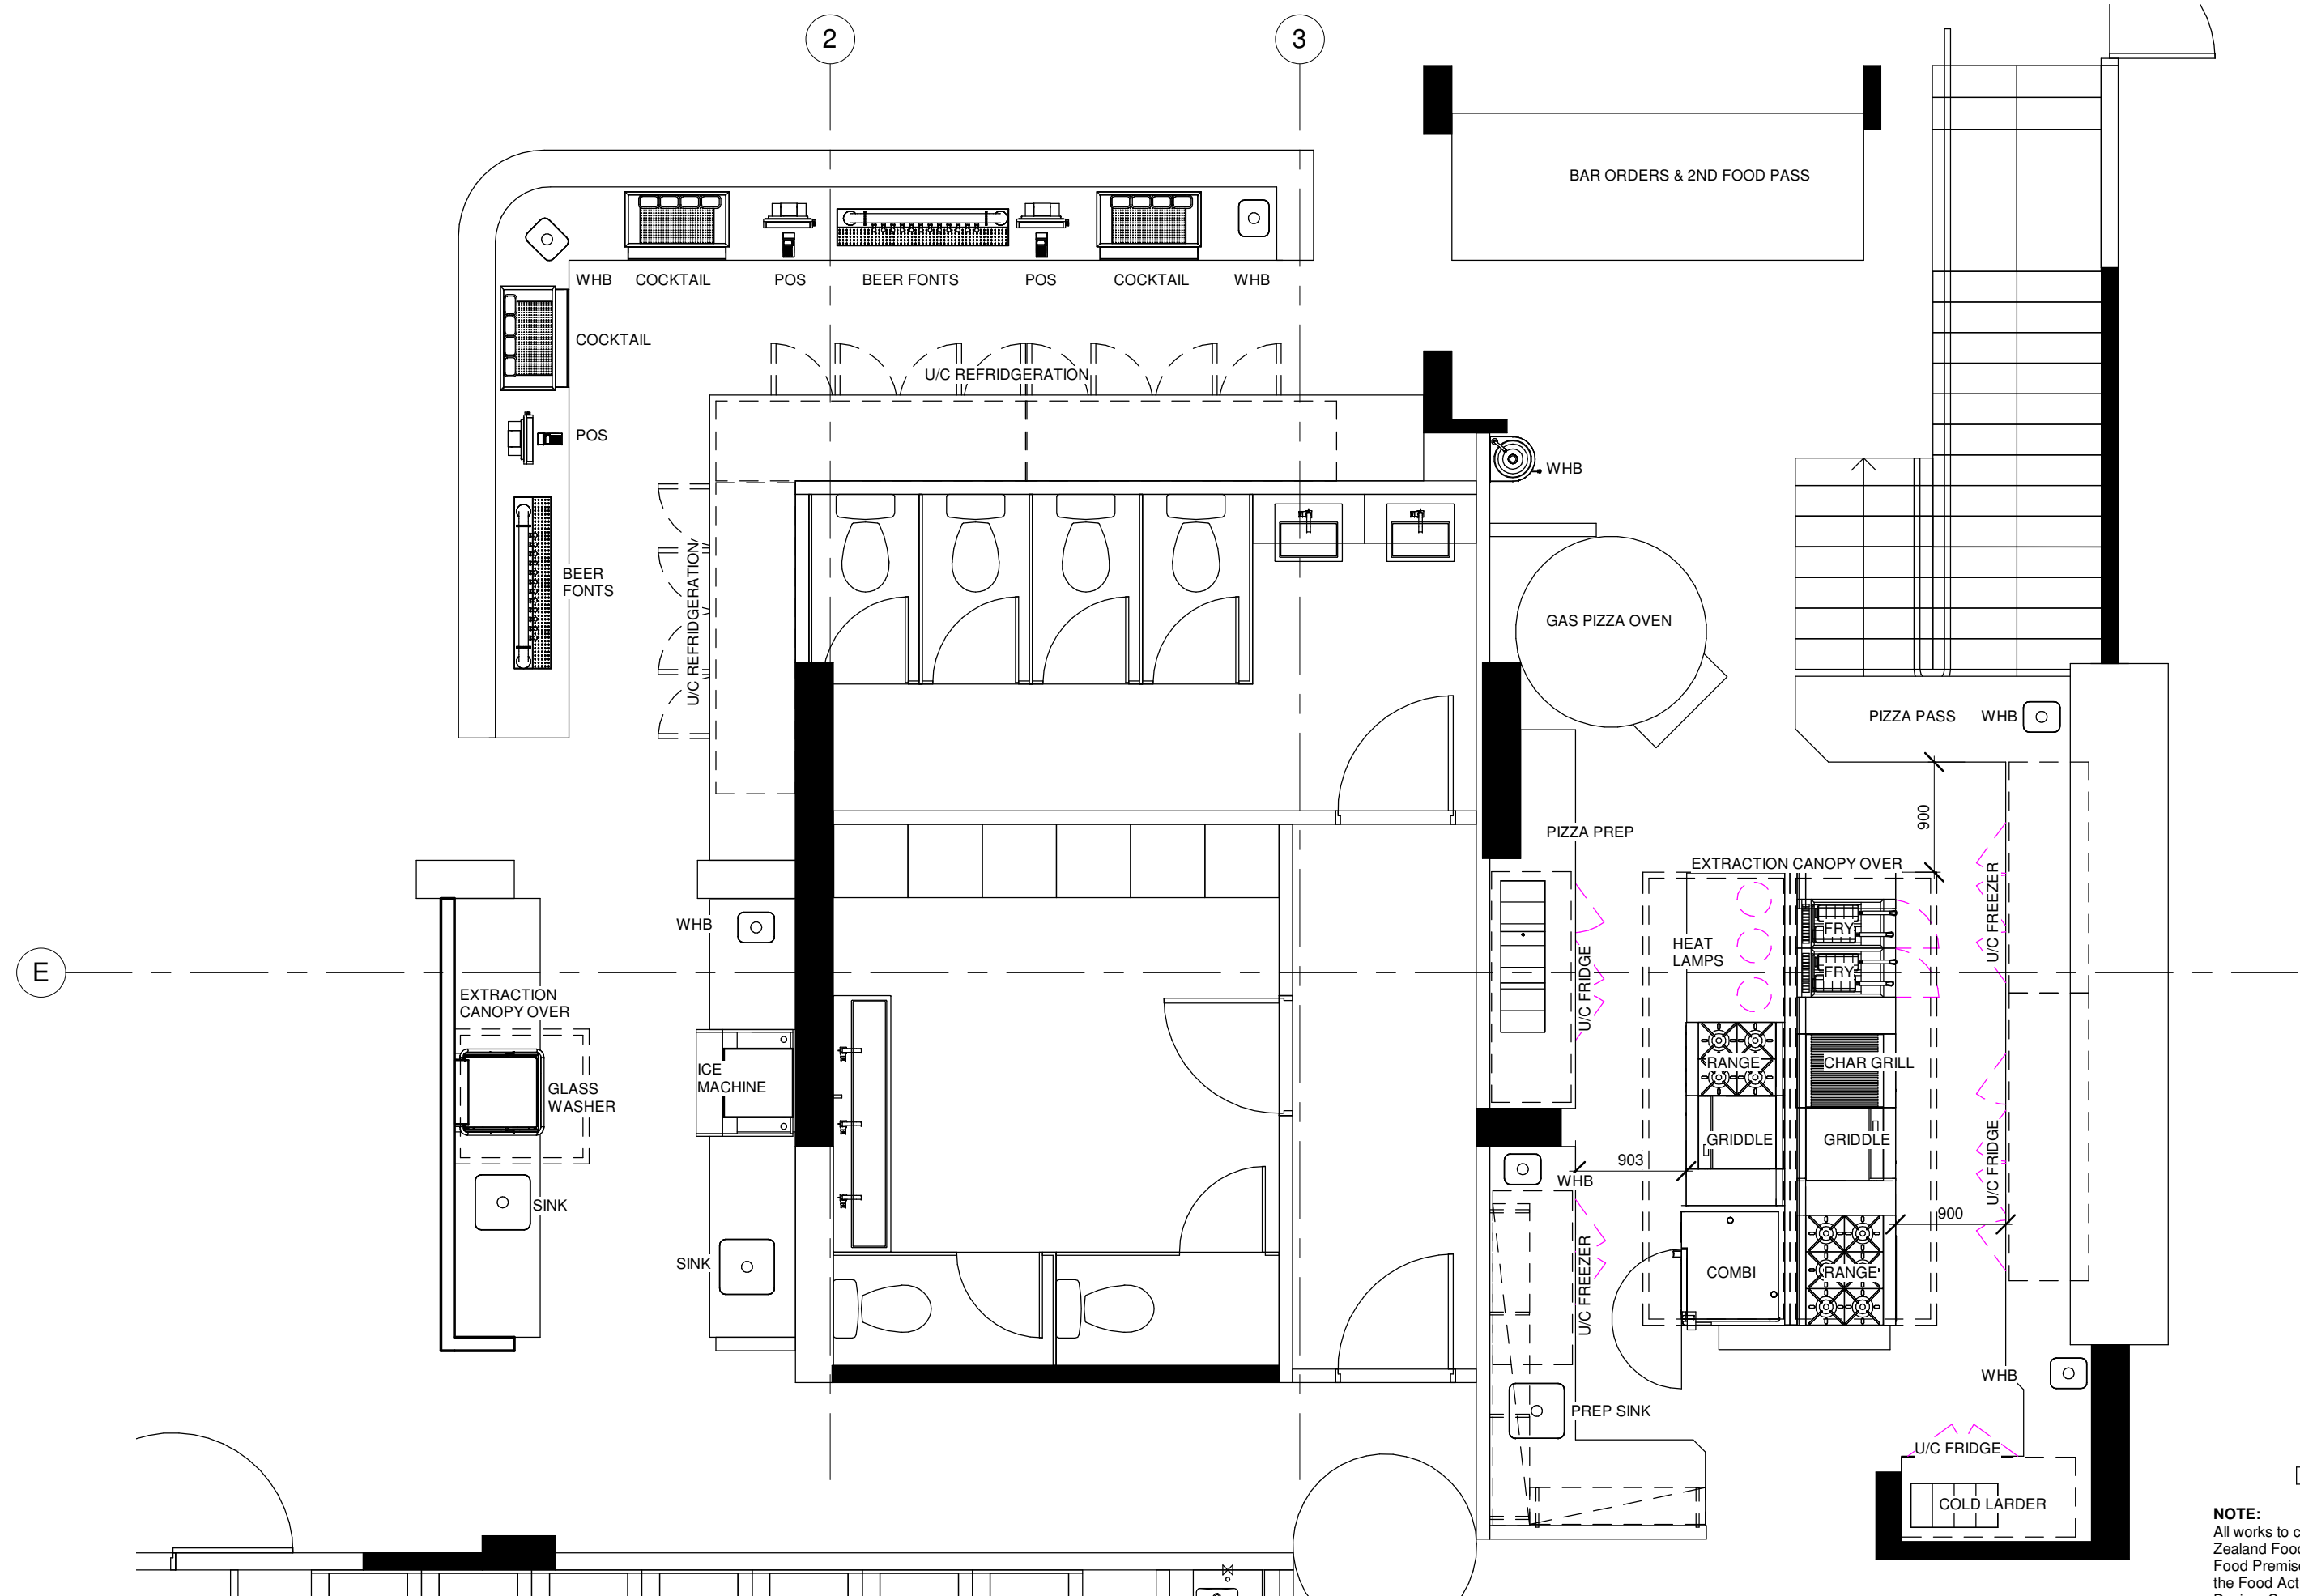
Revisions

Project
KITCHEN & BARS
 Address
HARBORD HOTEL

Title			
SITE PLAN			
Project No.	Drawn by	Scale	Sheet size
2008	NH	1 : 150	A3

Issue	
SKETCH DESIGN	
Revision No.	Revision date

Drawing number
100



NOTE:
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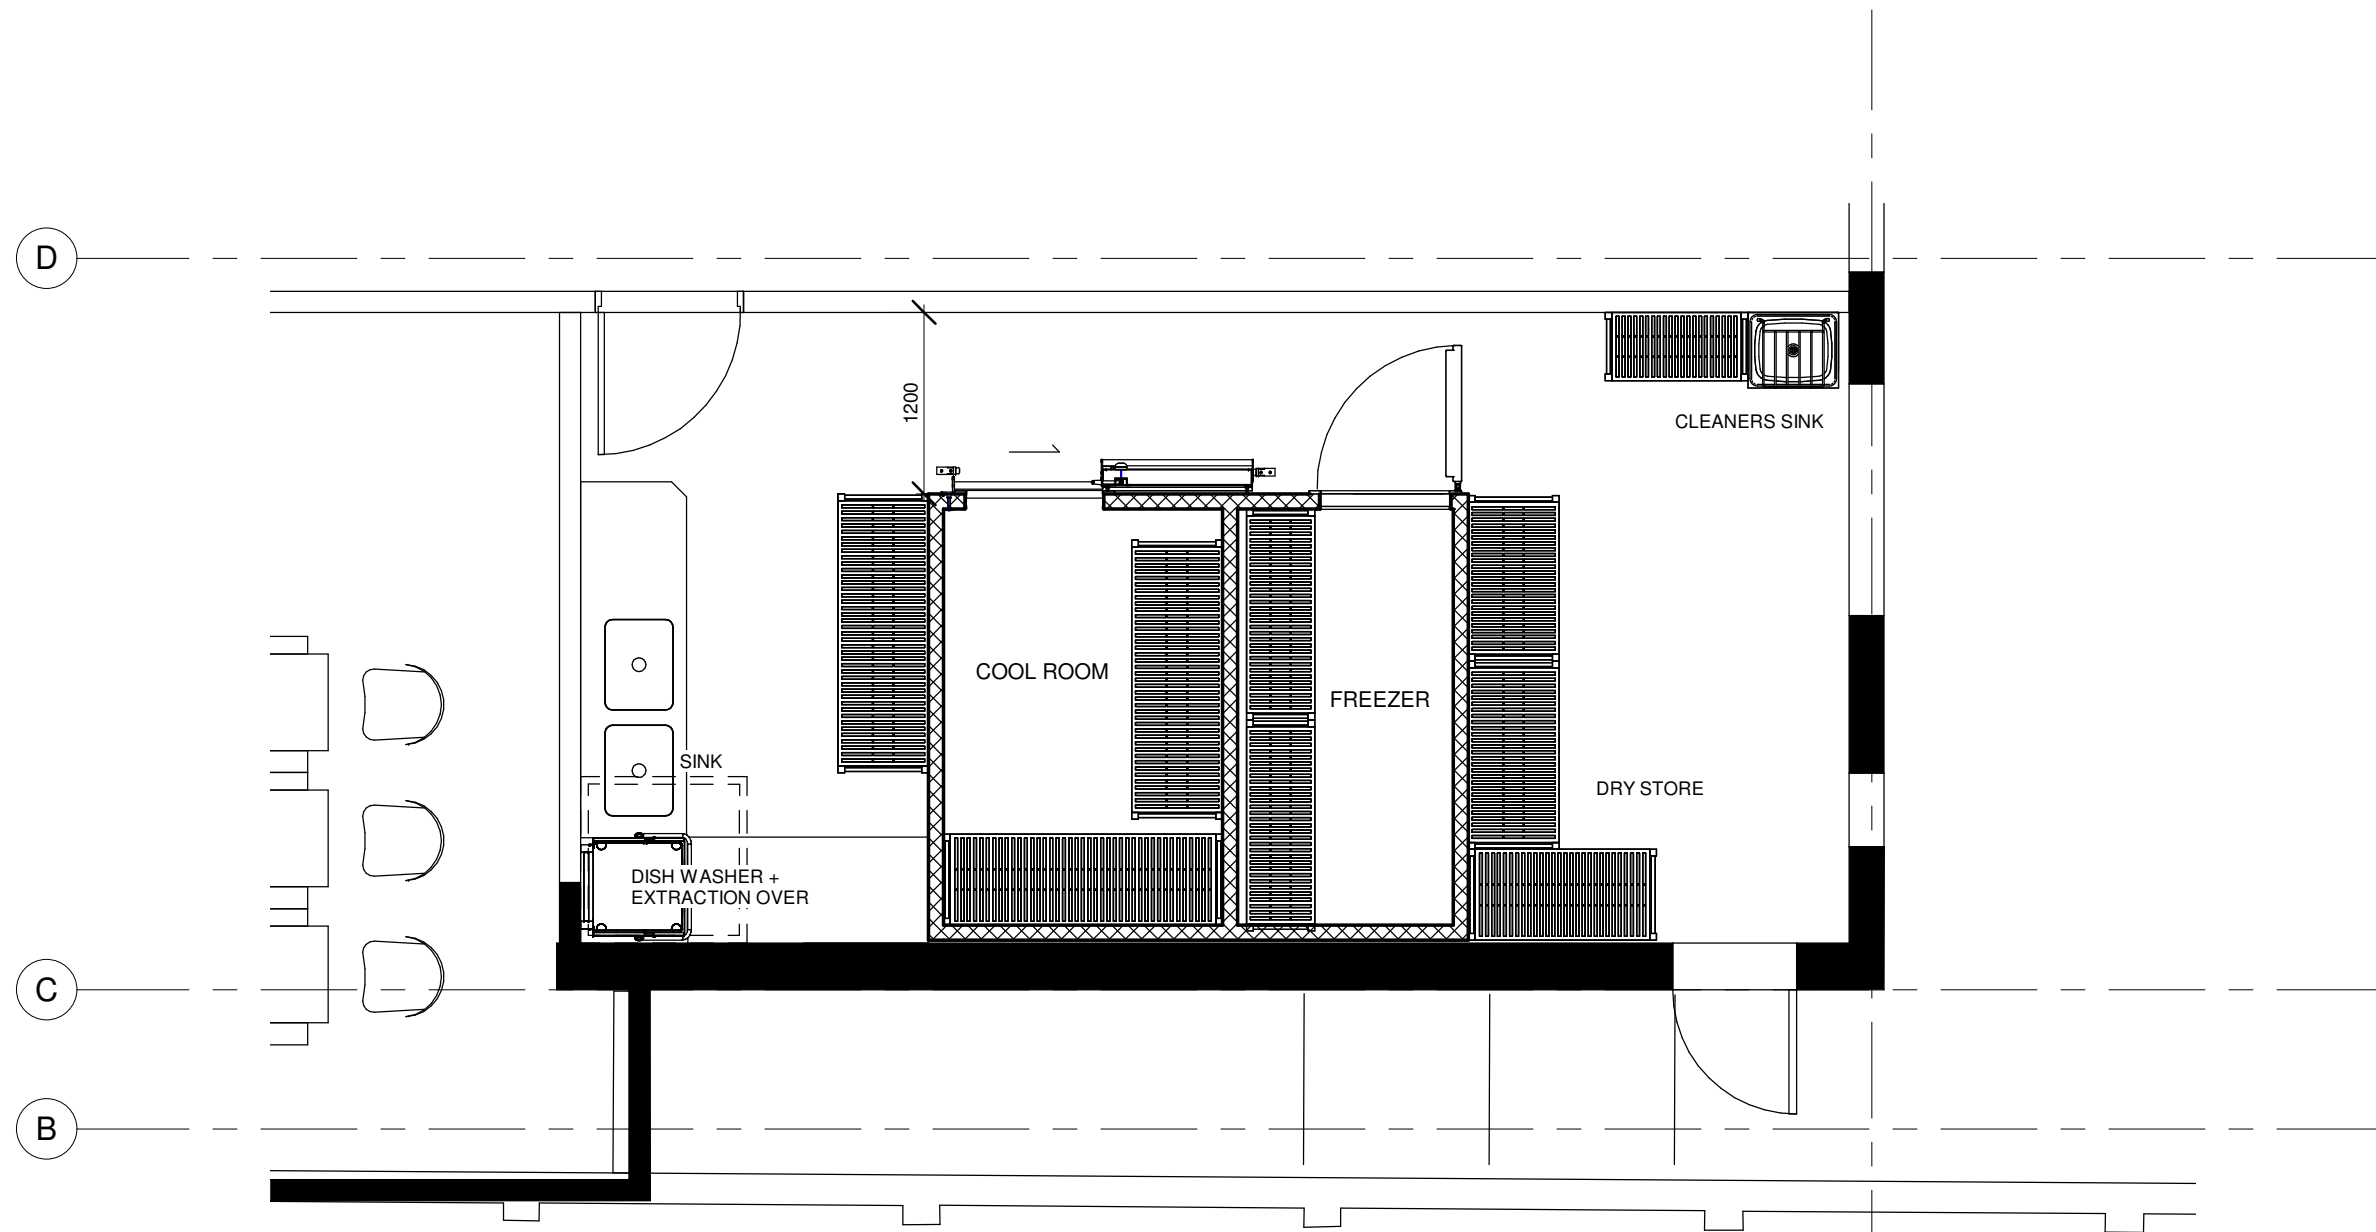
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KITCHEN PLAN

Project No. 2008	Drawn by NH	Scale 1 : 50	Sheet size A3
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Issue SKETCH DESIGN	Revision No.	Revision date
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Drawing number

101



NOTE:
 All works to comply with Australia New Zealand Food Standards Code – 3.2.3 – Food Premises and Equipment under the Food Act 2003 and AS 4674 - Design, Construction and Fit-out of Food Premises

4

CATERBUILD
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Revisions

Project
KITCHEN & BARS
 Address
HARBORD HOTEL


Title
STORAGE PLAN

Project No. 2008	Drawn by NH	Scale 1 : 50	Sheet size A3
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Issue SKETCH DESIGN	Revision No.	Revision date
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Drawing number

102



NOTE:
 All works to comply with Australia New Zealand Food Standards Code – 3.2.3 – Food Premises and Equipment under the Food Act 2003 and AS 4674 - Design, Construction and Fit-out of Food Premises
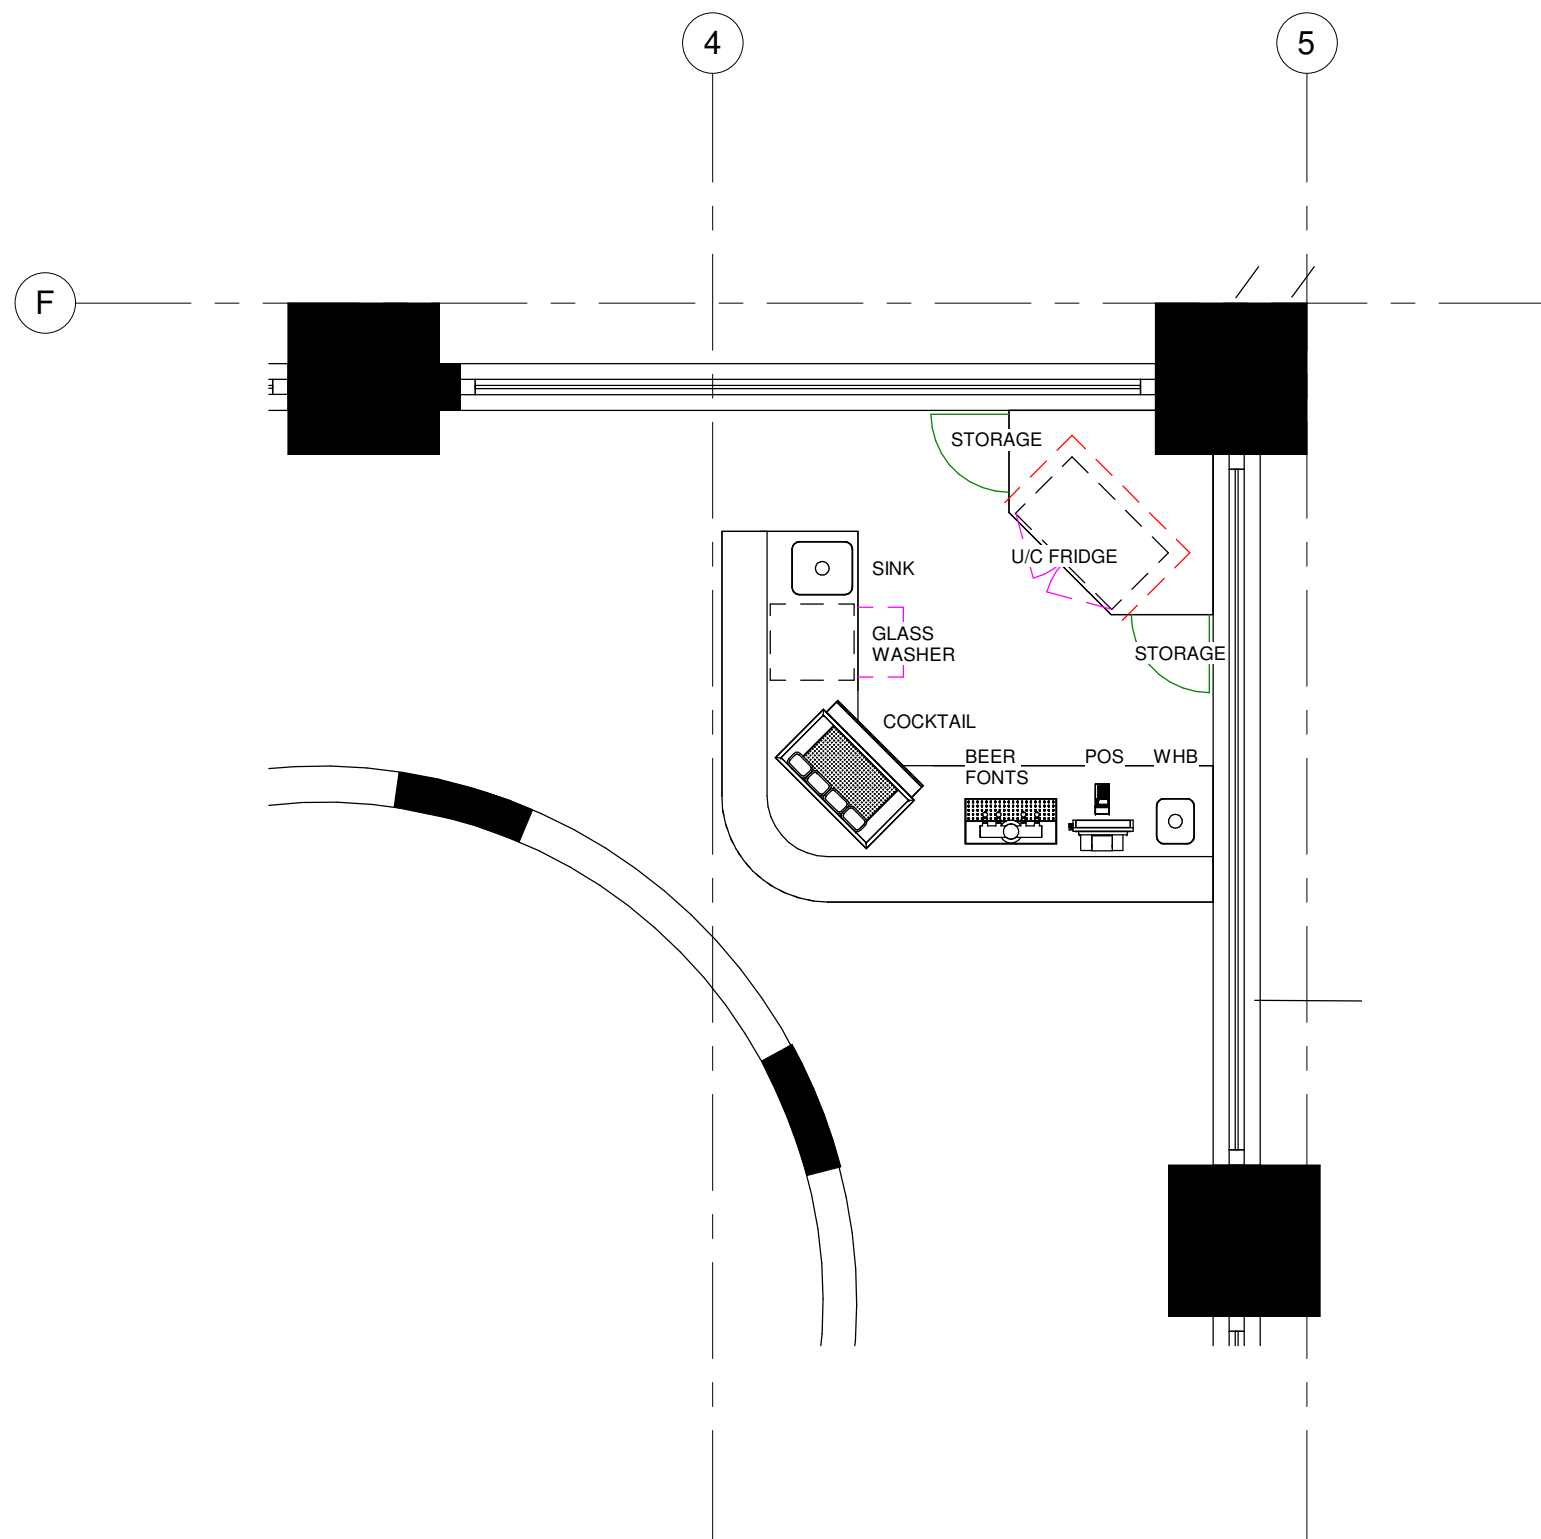
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Revisions

Project
KITCHEN & BARS
 Address
HARBORD HOTEL

Title
RESTAURANT BAR


Project No. 2008	Drawn by NH	Scale 1 : 50	Sheet size A3
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Issue SKETCH DESIGN	Revision No.	Revision date
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Drawing number

103

LEGEND
 ■ EXISTING WALLS
 □ DEMOLITION
 □ PROPOSED WALLS



-  - ON SITE PARKING
-  - SKIP BIN STORAGE
-  - MATERIAL STORAGE/DELIVERY DROP POINT
-  - PLANT /EQUIPMENT STORAGE
-  - EMERGENCY EVACUATION POINT
-  - DIRECTION OF TRAFFIC

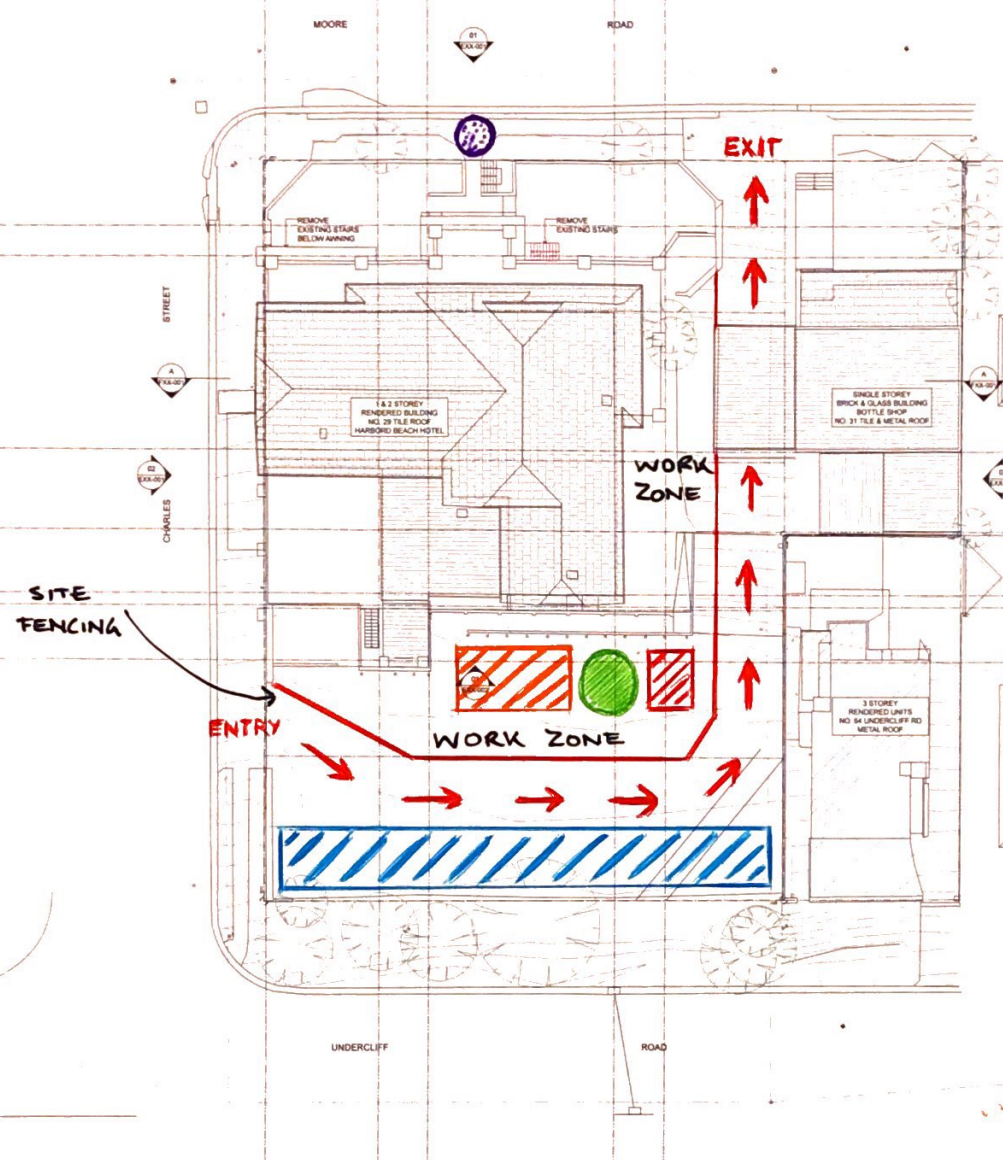91 SITE & ROOF - EXISTING & DEMOLITION PLAN 1:200@A1

FOR DA APPLICATION

CONSTRUCTION MANAGEMENT PLAN

DATE 20.04.20 REVISION A ISSUE REASON FOR DA APPLICATION

CLIENT GLENN PIPER MERIDIAN AUSTRALIA

PROJECT FRESHWATER HOTEL



DRAWING NO 0467
 SCALE@A1 SCALE@A3
 7:500 1:400 50
 DWG NO 04-ACE-001
 ISSUE A

DATE 20.04.20
 REVISION A
 ISSUE REASON FOR DA APPLICATION