S4.55 FOR MODIFICATION PREVIOUS DA 2017/0386

SUBSET NAME	DRAWING No.	DESCRIPTION	REVISION ID
Architectural set - S	4.55		
	A000	COVER PAGE	01
	A001	LEGEND	01
	A002	SURVEY	01
	A003	SITE PLAN	01
	A004	DEMOLITION PLAN	01
	A005	DEMOLITION PLAN - WALLS	01
	A006	LANDSCAPE PLAN	01
Floor Plans			
	A100	GROUND FLOOR	01
	A101	FIRST FLOOR	01
	A102	ROOF PLAN	01
Elevations			
	A200	EAST AND WEST ELEVATION	01
	A201	NORTH ELEVATION	01
	A201	SOUTH ELEVATION	01
Sections			
	A300	CROSS SECTIONS	01
Control Plans			
	A400	CONTROL PLAN	01
Schedules			
	A600	WINDOW SCHEDULE	01

NOTES

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LEGEND SITE BOUNDARY SUBDIVISION LINE PROPOSED GROUND FLOOR OUTLINE

PROPOSED FIRST FLOOR OUTLINE

COVER PAGE

1108 OXFORD FALLS RD

NOT TO SCALE

A000 6/10/2022

MD

ZK

REVIEWED BY



PLOT INFORMATION

MAXIMAL HEIGHT LEP

ADDRESS	1108 OXFORD FALLS RD Frenchs Forest NSW 2086
LOT / SECTION / PLAN N _O	Y/-/DP395065
LOT AREA	1726 m ²
	LOT / SECTION / PLAN No

COUNCIL	NORTHERN BEACHES COUNCIL


REGULATION

WARRINGAH DCP

8.5 m

MANLY DCP - PART 4 - 4.1 RESIDENTIAL DC WARRINGAH LEP 2011

PORPOSED	ADDITION AND MODIFICATION TO EXISTING DA
APPROVED DA2017/0386	TOTAL GFA APPROVED FSR 0.15:1 261.1 M2 TOTAL LANDCASPE APPROVED 56 % 965.5 M2

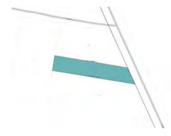



DM: Deferred Matter

BUILDING SPECIFICATION - CLASS 1

DEMOLITION

- AS 2601:2001 - THE DEMOLITION OF STRUCTURES

SITE PREPARATION

- PART 3.1 OF THE BCA [NCC 2019 VOLUME 2]

EARTHWORKS

- TO BE CARRIED OUT IN ACCORDANCE WITH THE REQUIREMENTS OF THE ENVIRONMENTAL PLANNING & ASSESSMENT ACT 1979 AND **DEVELOPMENT CONSENT CONDITIONS**
- PART 3.1.1 OF THE BCA [NCC 2019 VOLUME 2]
- AS 3798:2007 GUIDELINES ON EARTHWORKS FOR COMMERCIAL & RESIDENTIAL DEVELOPMENTS
- AS 4678:2002 EARTH-RETAINING STRUCTURES DRAINAGE
- PART 3.1.3 OF THE BCA [NCC 2019 VOLUME 2]
- AS/NZS 3500.1:2018 PLUMBING & DRAINAGE WATER SERVICES
- AS/NZS 3500.2:2018 PLUMBING & DRAINAGE SANITARY PLUMBING DRAINAGE
- AS/NZS 3500.3:2018 PLUMBING & DRAINAGE STORMWATER DRAINAGE
- AS/NZS 3500.4:2018 PLUMBING & DRAINAGE HEATED WATER SERVICES

TERMITE MANAGEMENT

- PART 3.1.4 OF THE BCA [NCC 2019 VOLUME 2]
- AS 3660.1:2014 TERMITE MANAGEMENT NEW BUILDING WORK
- AS 3660.2:2017 TERMITE MANAGEMENT IN AND AROUND EXISTING **BUILDINGS & STRUCTURES**

FOOTINGS & SLABS

- PART 3.2 OF THE BCA [NCC 2019 VOLUME 2]
- AS 2159:2009 PILING DESIGN & INSTALLATION
- AS 2870:2011 RESIDENTIAL SLABS & FOOTINGS
- AS 3600:2018 CONCRETE STRUCTURES MASONRY
- PART 3.3 OF THE BCA [NCC 2019 VOLUME 2]
- AS 3700:2018 MASONRY STRUCTURES

FRAMING

- PART 3.4 OF THE BCA [NCC 2019 VOLUME 2]
- AS 1684.2:2010 RESIDENTIAL TIMBER-FRAMED CONSTRUCTION -NON-CYCLONIC AREAS
- AS 1720.1:2010 TIMBER STRUCTURES DESIGN METHODS
- AS 4100:1998 STEEL STRUCTURES

ROOF & WALL CLADDING

- PART 3.5 OF THE BCA [NCC 2019 VOLUME 2]
- AS 1273:1991 UNPLASTICIZED PVC (UPVC) DOWNPIPES & FITTINGS FOR RAINWATER
- AS 1562.1:2018 DESIGN & INSTALLATION OF SHEET ROOF & WALL **CLADDING - METAL**
- AS 1562.2:1999 DESIGN & INSTALLATION OF SHEET ROOF & WALL CLADDING - CORRUGATED FIBRE-REINFORCED CEMENT
- AS/NZS 1562.3:1996 DESIGN & INSTALLATION OF SHEET ROOF & WALL

CLADDING - PLASTIC

- AS 2049:2002 ROOF TILES
- AS 2050:2018 INSTALLATION OF ROOF TILES
- AS 4285:2019 ROOFLIGHTS

GLAZING

- PART 3.6 OF THE BCA [NCC 2019 VOLUME 2]
- AS 1288:2006 GLASS IN BUILDINGS SELECTION & INSTALLATION
- AS 2047:2014 WINDOWS & EXTERNAL GLAZED DOORS IN BUILDINGS - AS/NZS 2208:1996 - SAFETY GLAZING MATERIALS IN BUILDINGS

ENERGY EFFICIENCY

- PART 3.12 OF THE BCA [NCC 2019 VOLUME 2]
- TO MEET THE BASIX CERTIFICATE REQUIREMENTS

FIRE SAFETY

- PART 3.7 OF THE BCA [NCC 2019 VOLUME 2]
- AS 3786:2014 SMOKE ALARMS USING SCATTERED LIGHT, TRANSMITTED LIGHT OR IONIZATION

HEALTH & AMENITY

- PART 3.8 OF THE BCA [NCC 2019 VOLUME 2]
- AS/NZS ISO 717.1:2004 ACOUSTICS RATING OF SOUND INSULATION IN
- BUILDINGS & OF BUILDING ELEMENTS AIRBORNE SOUND INSULATION - AS ISO 717.2:2004 - ACOUSTICS - RATING OF SOUND INSULATION IN
- & OF BUILDING ELEMENTS IMPACT SOUND INSULATION
- AS 1668.2:2012 THE USE OF VENTILATION & AIR CONDITIONING IN **BUILDINGS**
- MECHANICAL VENTILATION IN BUILDINGS
- AS 1668.4:201 THE USE OF VENTILATION & AIR CONDITIONING IN **BUILDINGS -NATURAL VENTILATION OF BUILDINGS**
- AS/NZS 1680.0:2009 INTERIOR LIGHTING SAFE MOVEMENT
- AS/NZS 1680.1:2006 INTERIOR & WORKPLACE LIGHTING GENERAL PRINCIPLES & RECOMMENDATIONS
- AS 3740:2010 WATERPROOFING OF DOMESTIC WET AREAS
- AS/NZS 4858:2004 WET AREA MEMBRANES

SAFE MOVEMENT & ACCESS

- PART 3.9 OF THE BCA [NCC 2019 VOLUME 2]
- AS 1428.1:2009 DESIGN FOR ACCESS & MOBILITY GENERAL REQUIREMENTS FOR ACCESS - NEW BUILDING WORK
- AS 1657:2018 FIXED PLATFORMS, WALKWAYS, STAIRWAYS & LADDERS
- DESIGN, CONSTRUCTION & INSTALLATION

SWIMMING POOLS

- TO BE CONSTRUCTED IN ACCORDANCE WITH THE REQUIREMENTS OF THESWIMMING POOLS ACT 1992 [NO. 49] & SWIMMING POOLS **REGULATION 2018**
- PART 3.10.1 OF THE BCA [NCC 2019 VOLUME 2]
- AS 1926.1:2012 SWIMMING POOL SAFETY SAFETY BARRIERS FOR SWIMMING POOLS
- AS 1926.2:2007 SWIMMING POOL SAFETY LOCATION OF SAFETY BARRIERS FOR SWIMMING POOLS
- AS 1926.3:2010 SWIMMING POOL SAFETY WATER RECIRCULATION SYSTEMS

STRUCTURAL DESIGN MANUALS

- AS/NZS 1170.0:2002 STRUCTURAL DESIGN ACTIONS GENERAL **PRINCIPLES**
- AS/NSZ 1170.1:2002 STRUCTURAL DESIGN ACTIONS PERMANENT, **IMPOSED & OTHER ACTIONS**
- AS/NZS 1170.2:2011 STRUCTURAL DESIGN ACTIONS WIND ACTIONS
- AS/NZS 1170.3:2003 STRUCTURAL DESIGN ACTIONS SNOW & ICE **ACTIONS**
- AS 1170.4:2007 STRUCTURAL DESIGN ACTIONS EARTHQUAKE **ACTIONS IN AUSTRALIA**
- AS/NZS 1664.1:1997 ALUMINIUM STRUCTURES LIMIT STATE DESIGN - AS/NZS 1664.2:1997 - ALUMINIUM STRUCTURES - ALLOWABLE STRESS
- AS 1720.1:2010 TIMBER STRUCTURES DESIGN METHODS - AS 1720.4:2006 - TIMBER STRUCTURES - FIRE RESISTANCE FOR
- STRUCTURAL ADEQUACY OF TIMBER MEMBERS - AS 1720.5:2015 - TIMBER STRUCTURES - NAIL PLATED TIMBER ROOF
- **TRUSSES** - AS/NZS 2269.0:2012 - PLYWOOD - STRUCTURAL - SPECIFICATIONS
- AS/NZS 2327:2017 COMPOSITE STRUCTURES COMPOSITE STEEL-
- CONCRETE CONSTRUCTION IN BUILDINGS
- AS 2159:2009 PILING DESIGN & INSTALLATION - AS 3600:2018 - CONCRETE STRUCTURES
- AS 3700:2018 MASONRY STRUCTURES
- AS 3850.1:2015 PREFABRICATED CONCRETE STRUCTURES GENERAL REQUIREMENTS
- AS 3850.2:2015 PREFABRICATED CONCRETE STRUCTURES BUILDING CONSTRUCTION
- AS 4055:2012 WIND LOADS FOR HOUSING
- AS 4100:1998 STEEL STRUCTURES

CAR PARKING

- AS/NZS 2890.1:2004 PARKING FACILITIES OFF-STREET CAR PARKING
- AS/NZS 2890.6:2009 PARKING FACILITIES OFF-STREET PARKING FOR PEOPLE WITH DISABILITIES

LEGEND



Demolish



ABREVIATIONS NOTES & ROLES

As per Architect Specifications **APES** As per Engineer Specifications AS **Australian Standards BCA** Building Code of Australia BYO By Others

TBC To be confirm COS Confirm on Site

FURNITURE

ST Storage Build in Robe BIR

FIXTURES

Downpipe DP Floor waste FW Dishwasher DW Washmachine WM Dryer DRY Fridge / Freezer FRD / FRZ Kitchen Range (Stove and oven)

OPENING

WHD Wall Hole dimensions Door Window

ANNOTATION LEGEND

Existing Reference level Proposed Reference level Sea level

GENERAL SYMBOL

Smoke alarm



Concrete



Existing Stone Path

Timber Decking

Stepping stones with pebbles in gaps



Floor tile

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LEGEND

SITE BOUNDARY

PROPOSED FIRST FLOOR OUTLINE

SUBDIVISION LINE

PROPOSED GROUND FLOOR OUTLINE

LEGEND

DRAWING TITLE

1108 OXFORD FALLS RD

SCALE

NOT TO SCALE

A001

ISSUE


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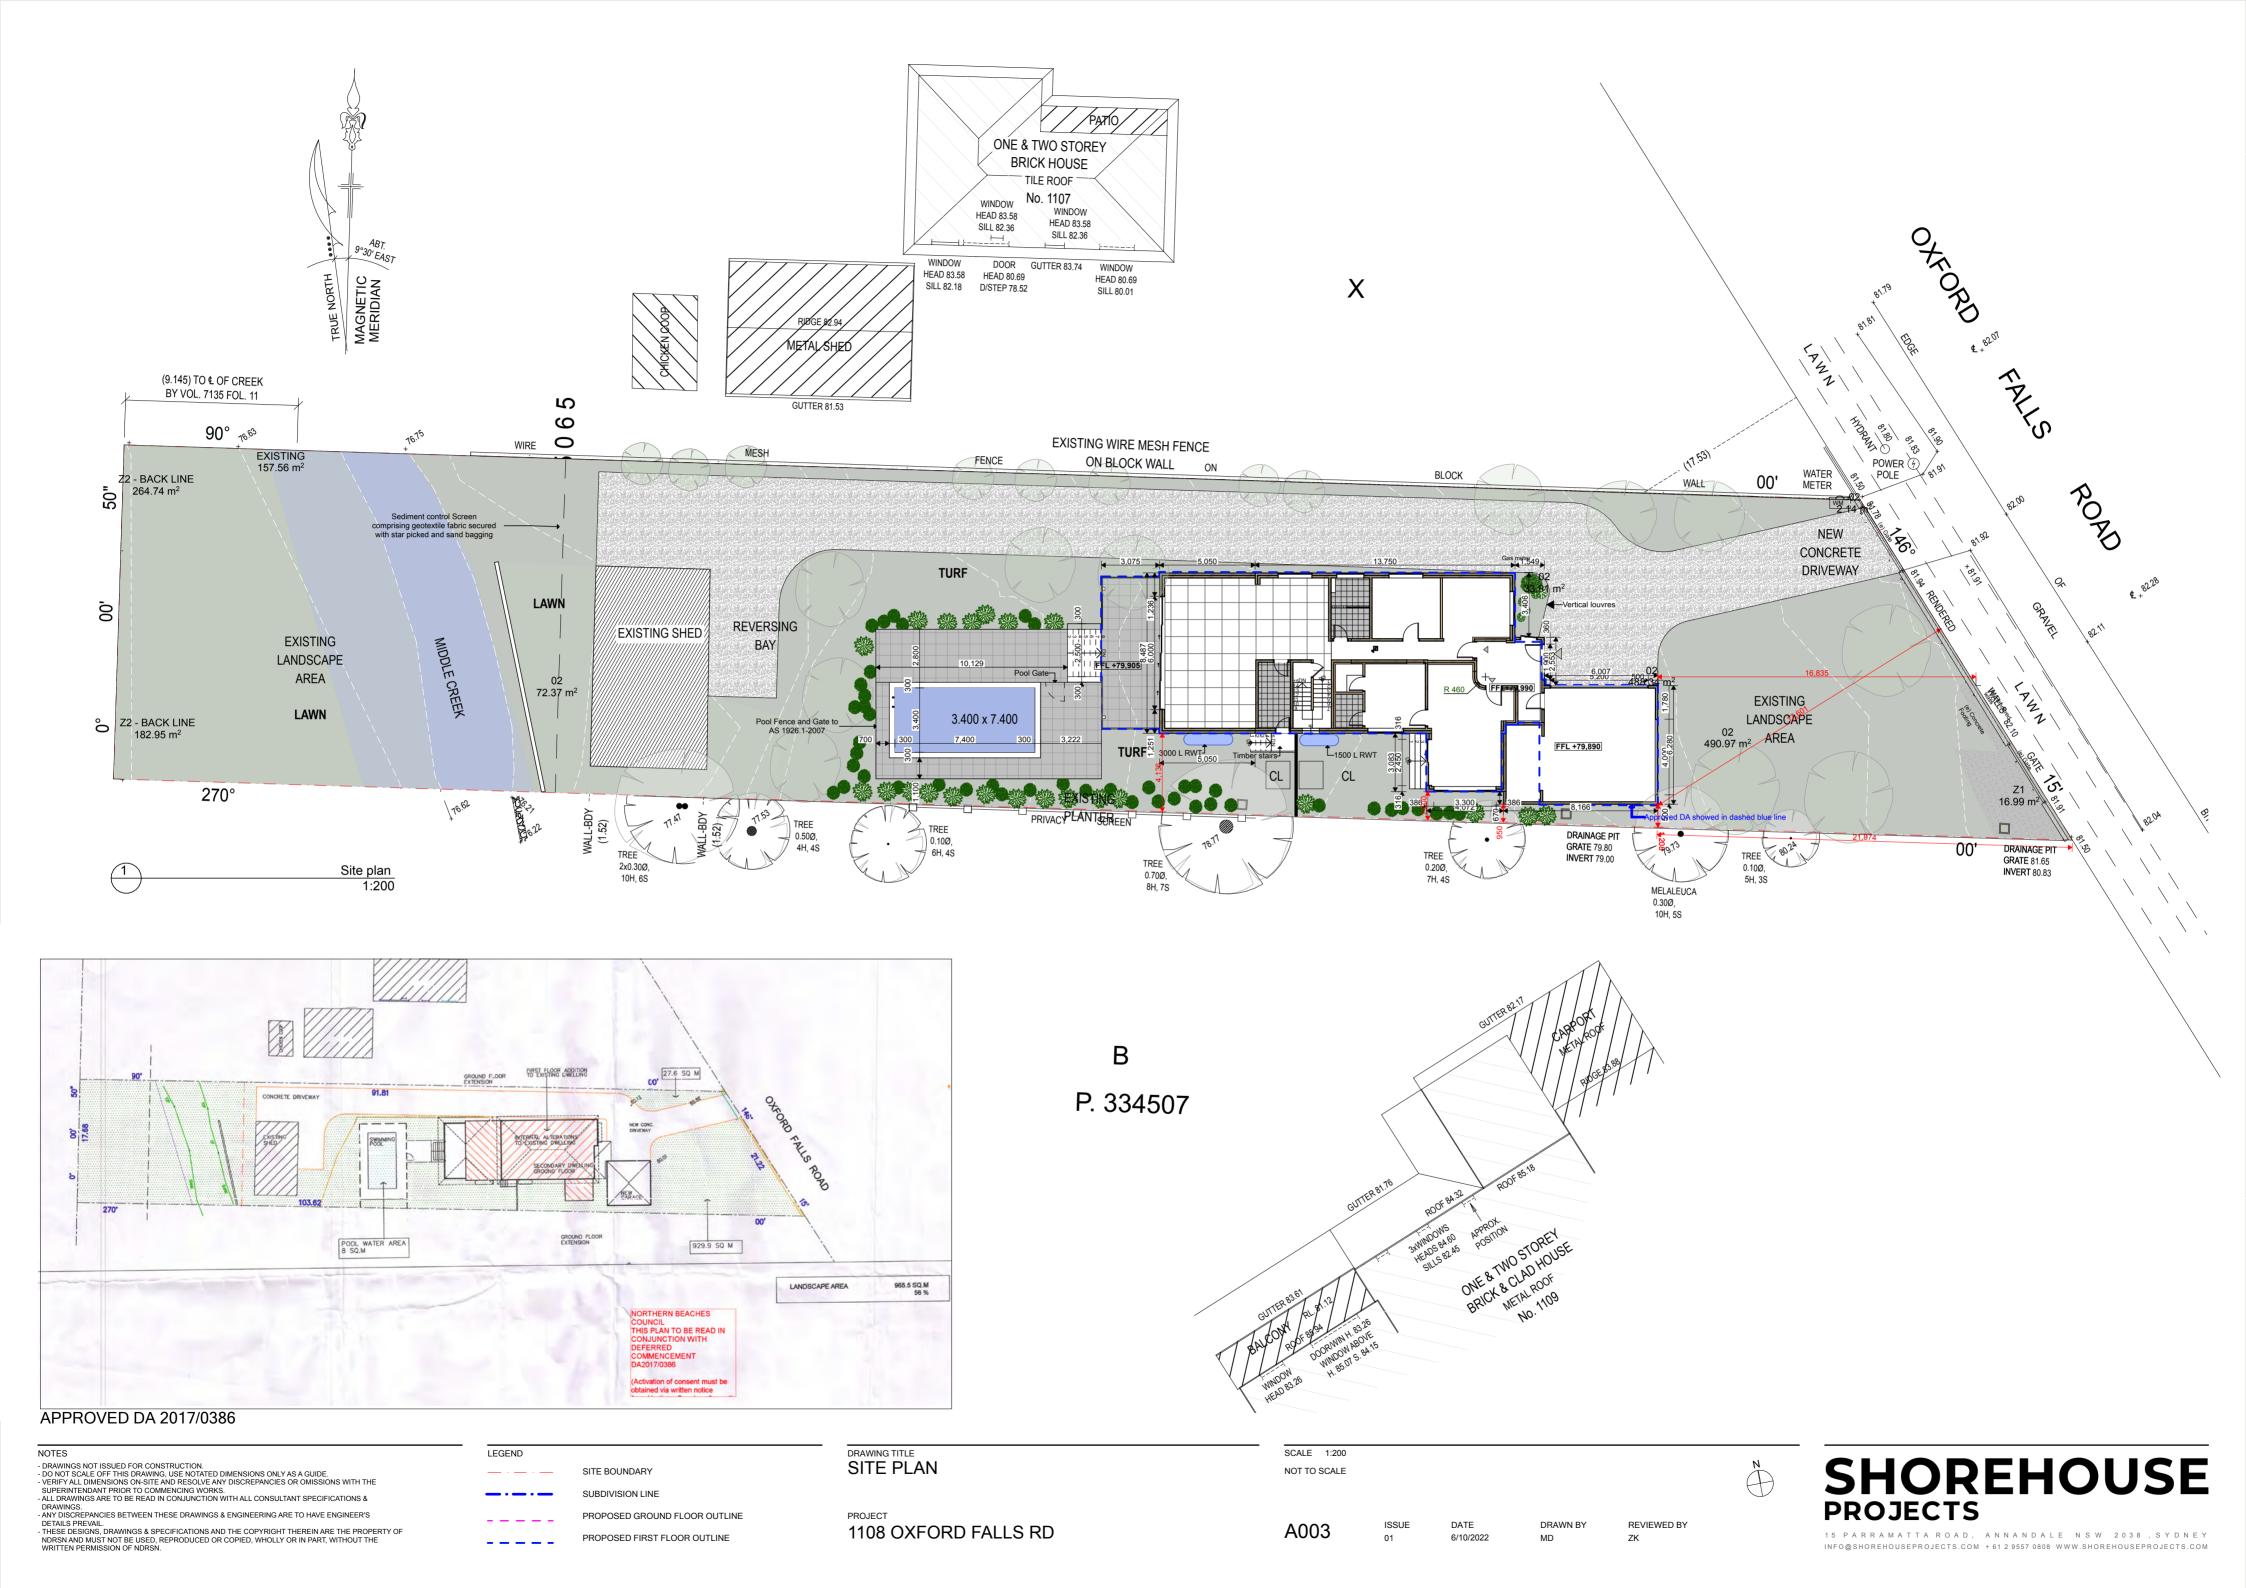
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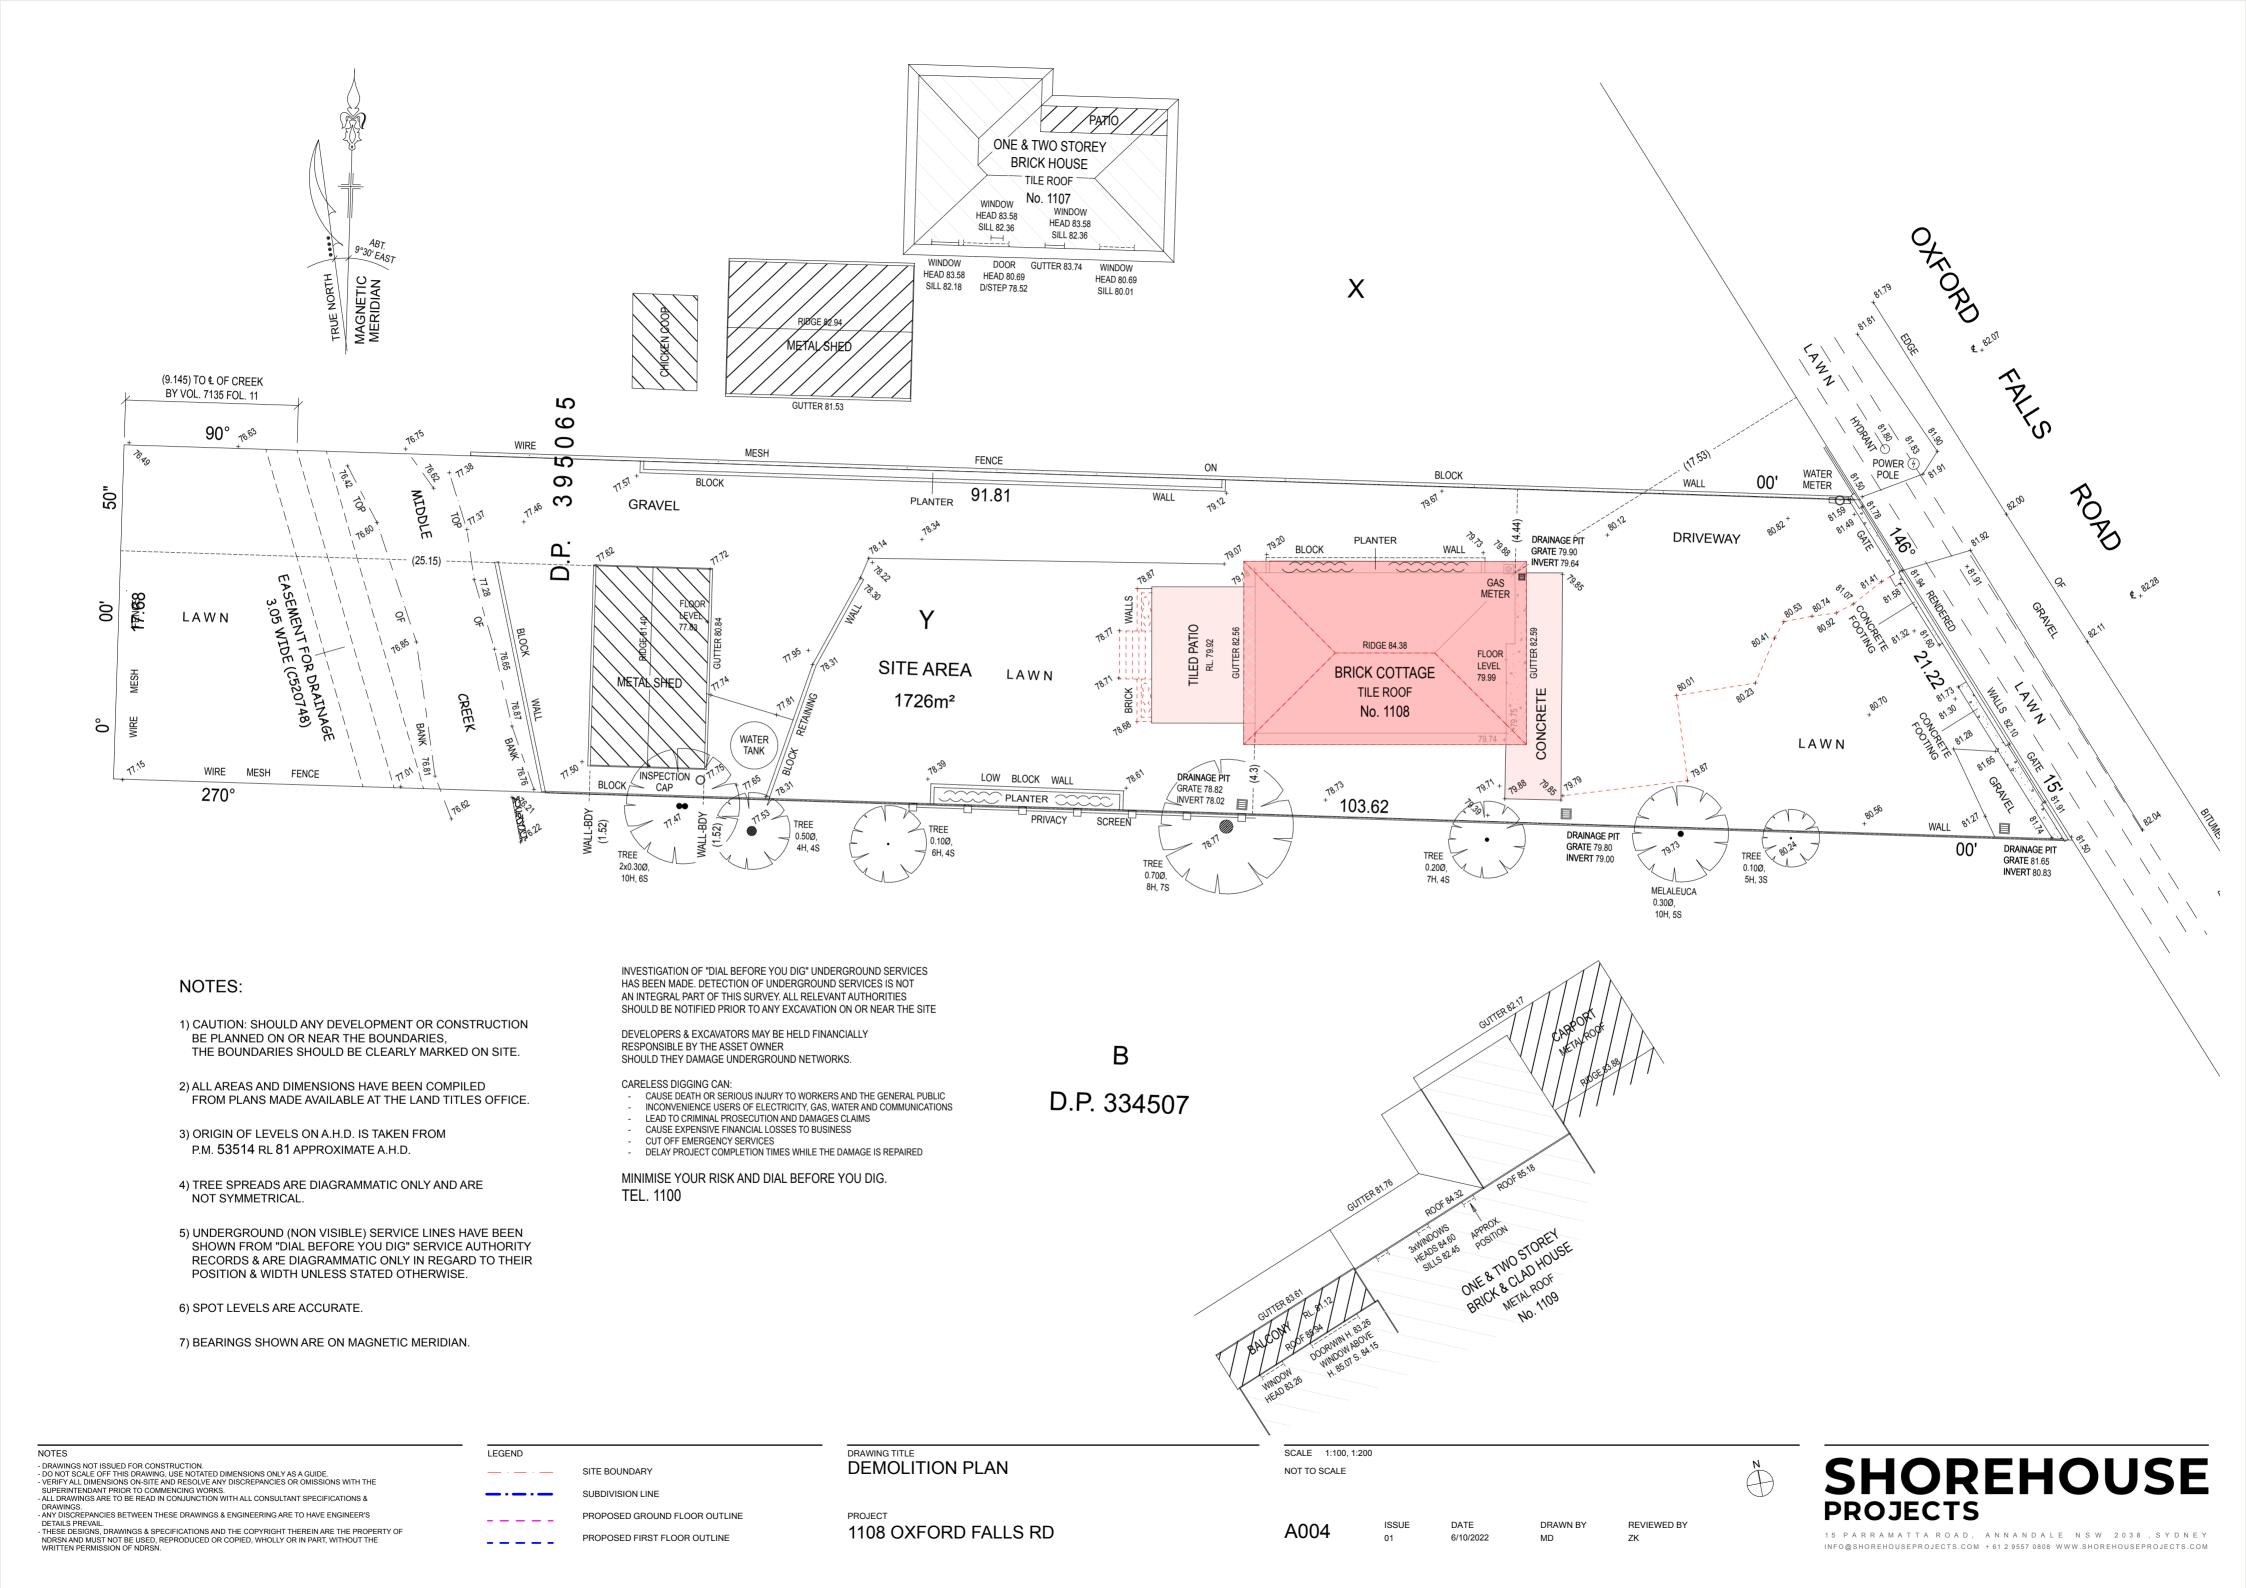
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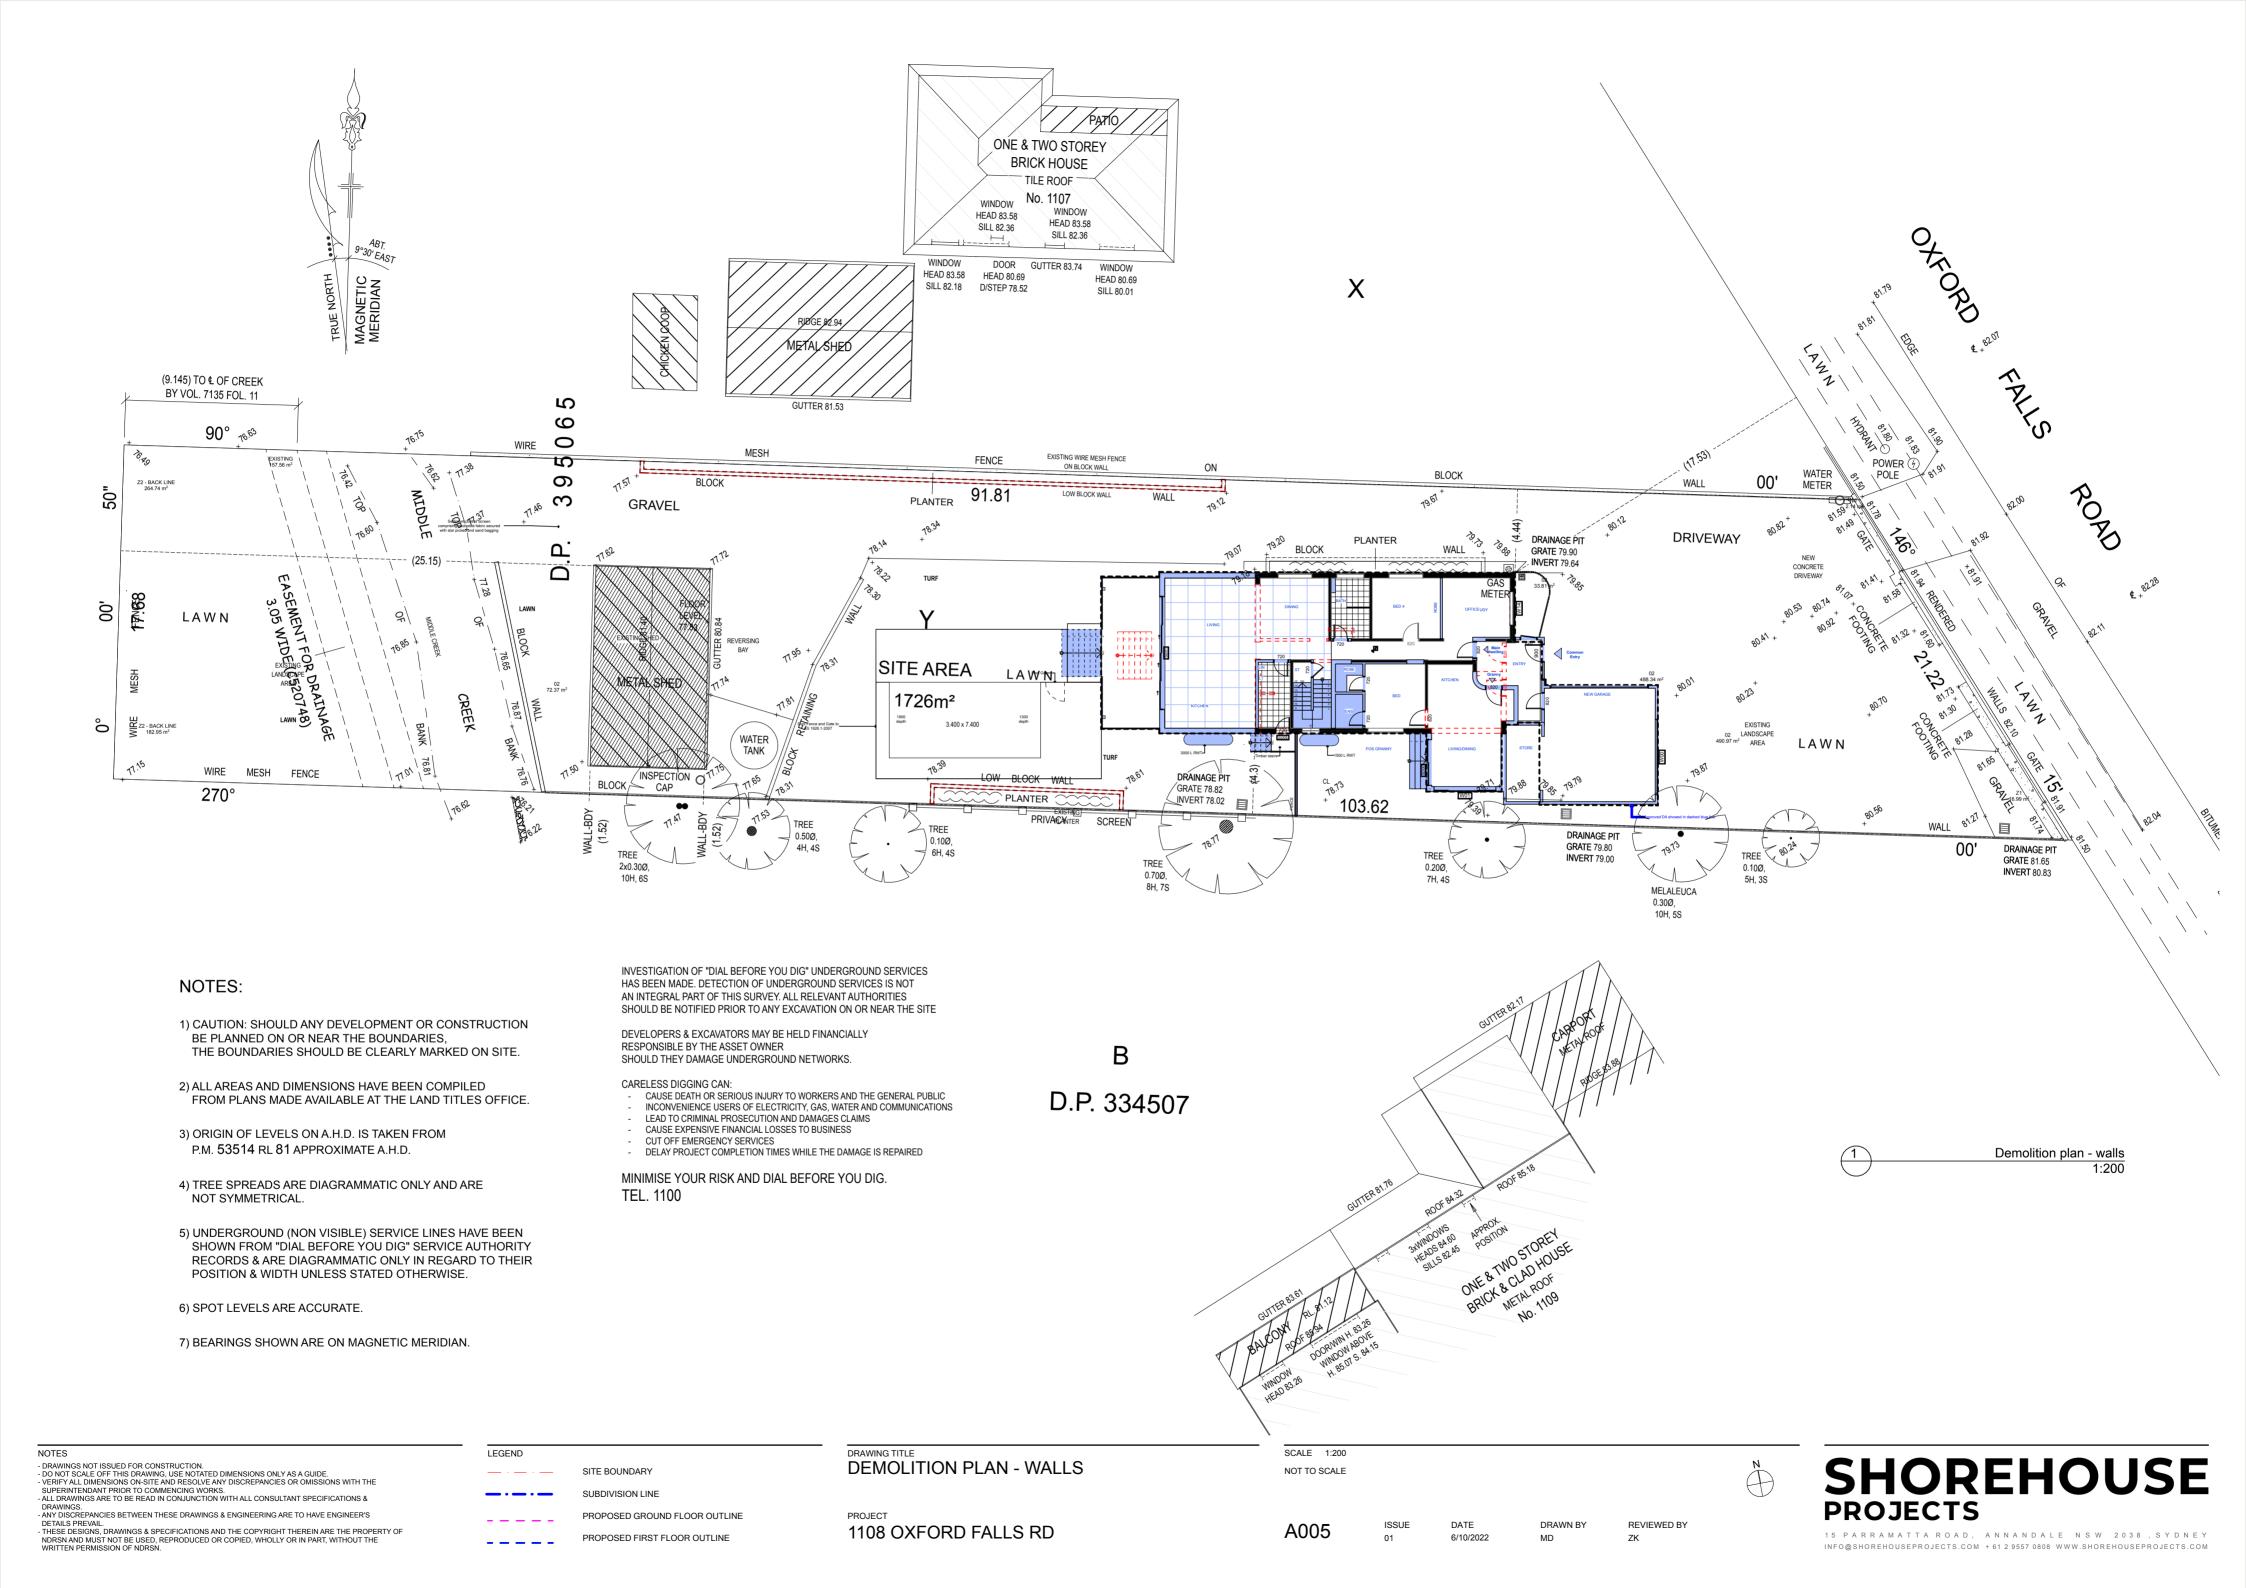










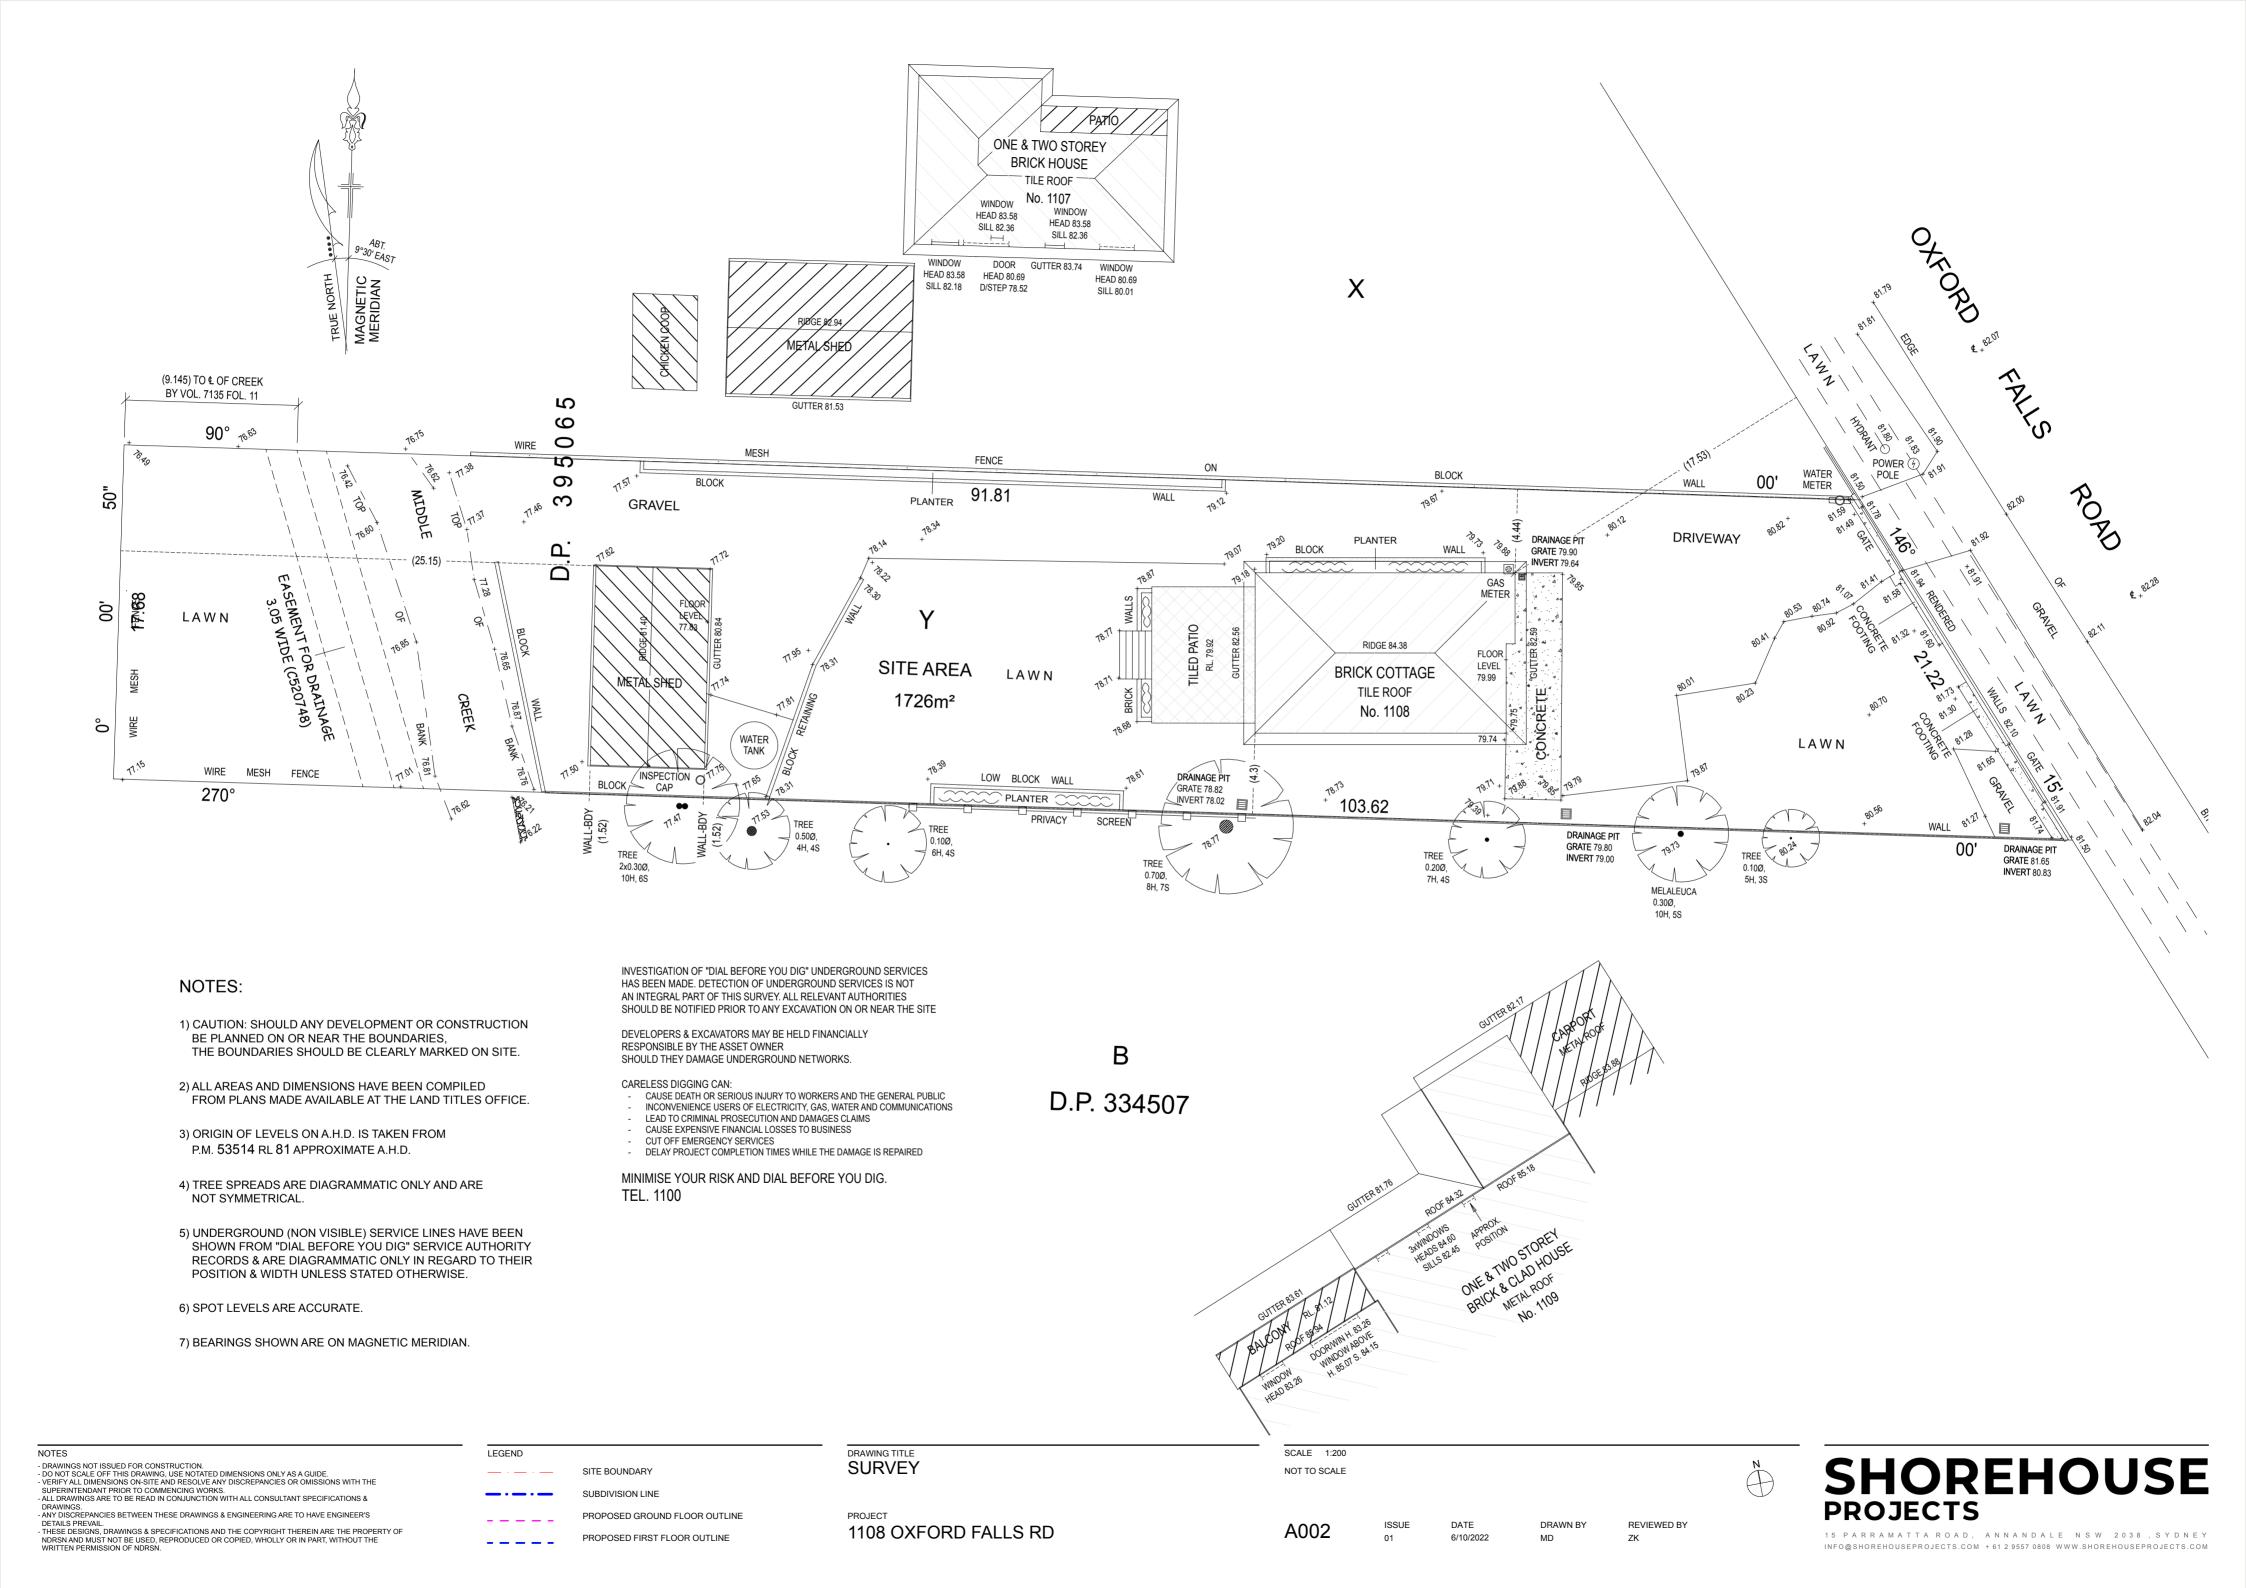

1726 SQ.M SITE AREA GROSS FLOOR AREA EXISTING HOUSE PROPOSED ADDITIONS INCL. SECONDARY DWELLING 42 SQ.M 0.15:1 DP 395065 LANDSCAPE AREA 965.5 SQ.M 56 % FIRST FLOOR ADDITION TO EXISTING DWELLING CONCRETE DRIVEWAY POOL FENCE AND GATE TO AS1926 REAR SETBACK REQUIRED NORTHERN BEACHES DP 334507 LOT B CONJUNCTION WITH DEFERRED (Activation of consent must be obtained via written notice LONG SECTION CROSS SECTION

APPROVED DA 2017 / 0386

PREVIOUS APPROVED LANDSCAPE AREA - 965.5 M2

CATEGORY	LOCATION	TYPE	M2
LANDSCAPE (PER	RMEABLE TO WATER)		
	Z1 - FRONT LINE	LAWN	58.94
	Z1 - FRONT LINE	LAWN	221.12
	Z2 - BACK LINE	LAWN	108.51
	Z2 - BACK LINE	LAWN	264.74
	Z2 - BACK LINE	TURF	15.40
	Z2 - BACK LINE	TURF	45.87
	Z2 - BACK LINE	TURF	202.27
	Z2 - BH BUILDING LINE	BANK	72.74
	Z2 - BH BUILDING LINE	PLANTER	58.94
			1,048.53 m²
LANDSCAPE OPE	N SPACE (IMPERMEABLE TO W	ATER)	
	Z2 - BH BUILDING LINE	DECKING	24.54
			24.54 m²
LANDSCAPE BUIL	T (IMPERMEABLE TO WATER)		
	Z1	DECKING	16.99
		DECKING	28.35
	Z2 - BH BUILDING LINE	DECKING	20.00
	Z2 - BH BUILDING LINE Z2 - BH BUILDING LINE		28.79
LANDSCAPE BUIL	Z2 - BH BUILDING LINE		28.79
LANDSCAPE BUIL	Z2 - BH BUILDING LINE	DECKING	28.79
LANDSCAPE BUIL	Z2 - BH BUILDING LINE	DECKING	28.79 74.13 m²

LEGEND & SCHEDULE

NOTES:

1. ALL FINAL PLANT QUANTITIES INDICATED ON PLANS SHALL BE CHECKED AND VERIFIED BY SUCCESSFUL LANDSCAPE

CONTRACTOR.

2. ANY PLANT SUBSTITUTES REQUIRED DUE TO UNAVAILABILITY SHALL BE RECOMMENDED BY THE LANDSCAPE


CONTRACTOR TO BEST MATCH SUBSTITUTED PLANTS

AND APPROVED PRIOR TO PURCHASING BY THE LANDSCAPE ARCHITECT.

3. WORKS CERTIFIED FOR FINAL OCCUPANCY CERTIFICATE ARE TO MATCH APPROVED LANDSCAPE PLANS. 4. LANDSCAPE CONTRACTOR SHALL LOCATE AND AVOID SITE STORM WATER & DRAINAGE SERVICES. LOCATE TREES A

5. ALL PLANTING AROUND EXISTING TREES SHALL BE ADJUSTED TO AVOID DAMAGE AND CLASHING WITH SURFACE

2D FOTO KEY DESCRIPTION FL Fiddle Leaf fig tree Ficus Lyrata Mature H:3 m Westringia 'Aussie Box' Native box plant. Mature H x S: 0.9 x 0.6 m AC Alpina caerulea ' Red Back' Mature H x S: 2 x1.5 m Pot Size: 300 mm MP Myoporum parvifolium Creeping Boobialla Mature H x S: 1x1 m Pot Size: 300 mm LM Lirope Muscari ' Evergreen Giant ' Mature H: 75 cm Pot Size: 140 mm Lomandra longifolia Spiny Head Mat Rush LT Mature H x S: 2 x1.2 m Pot Size: 300 mm Banksia Aemula BA Wallum Banksia Mature H x S: 2 x 2 m Pot Size: 300 mm Existing trees to be retained and protected

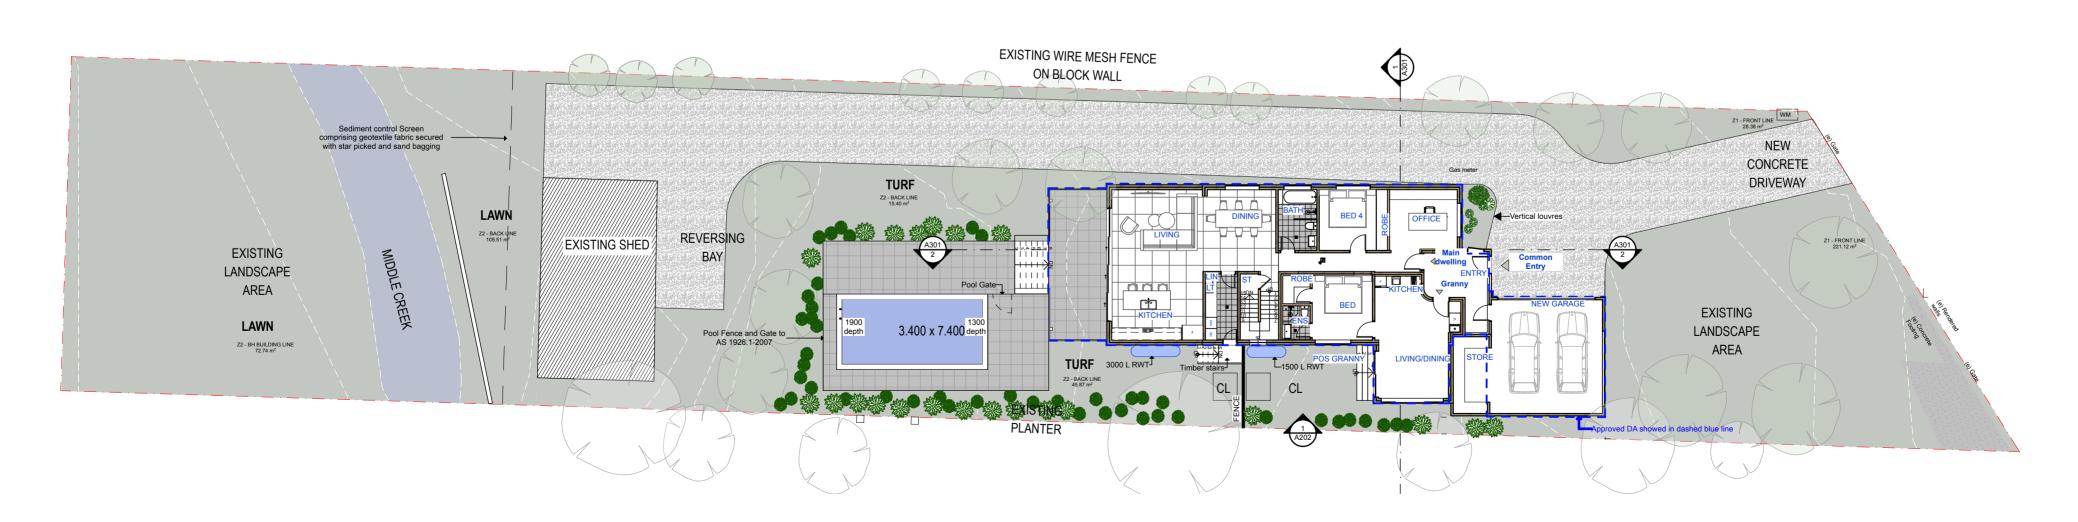

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LEGEND

SITE BOUNDARY SUBDIVISION LINE

PROPOSED GROUND FLOOR OUTLINE

PROPOSED FIRST FLOOR OUTLINE

LANDSCAPE PLAN

1108 OXFORD FALLS RD

SCALE 1:200, 1:1 NOT TO SCALE

A006

6/10/2022


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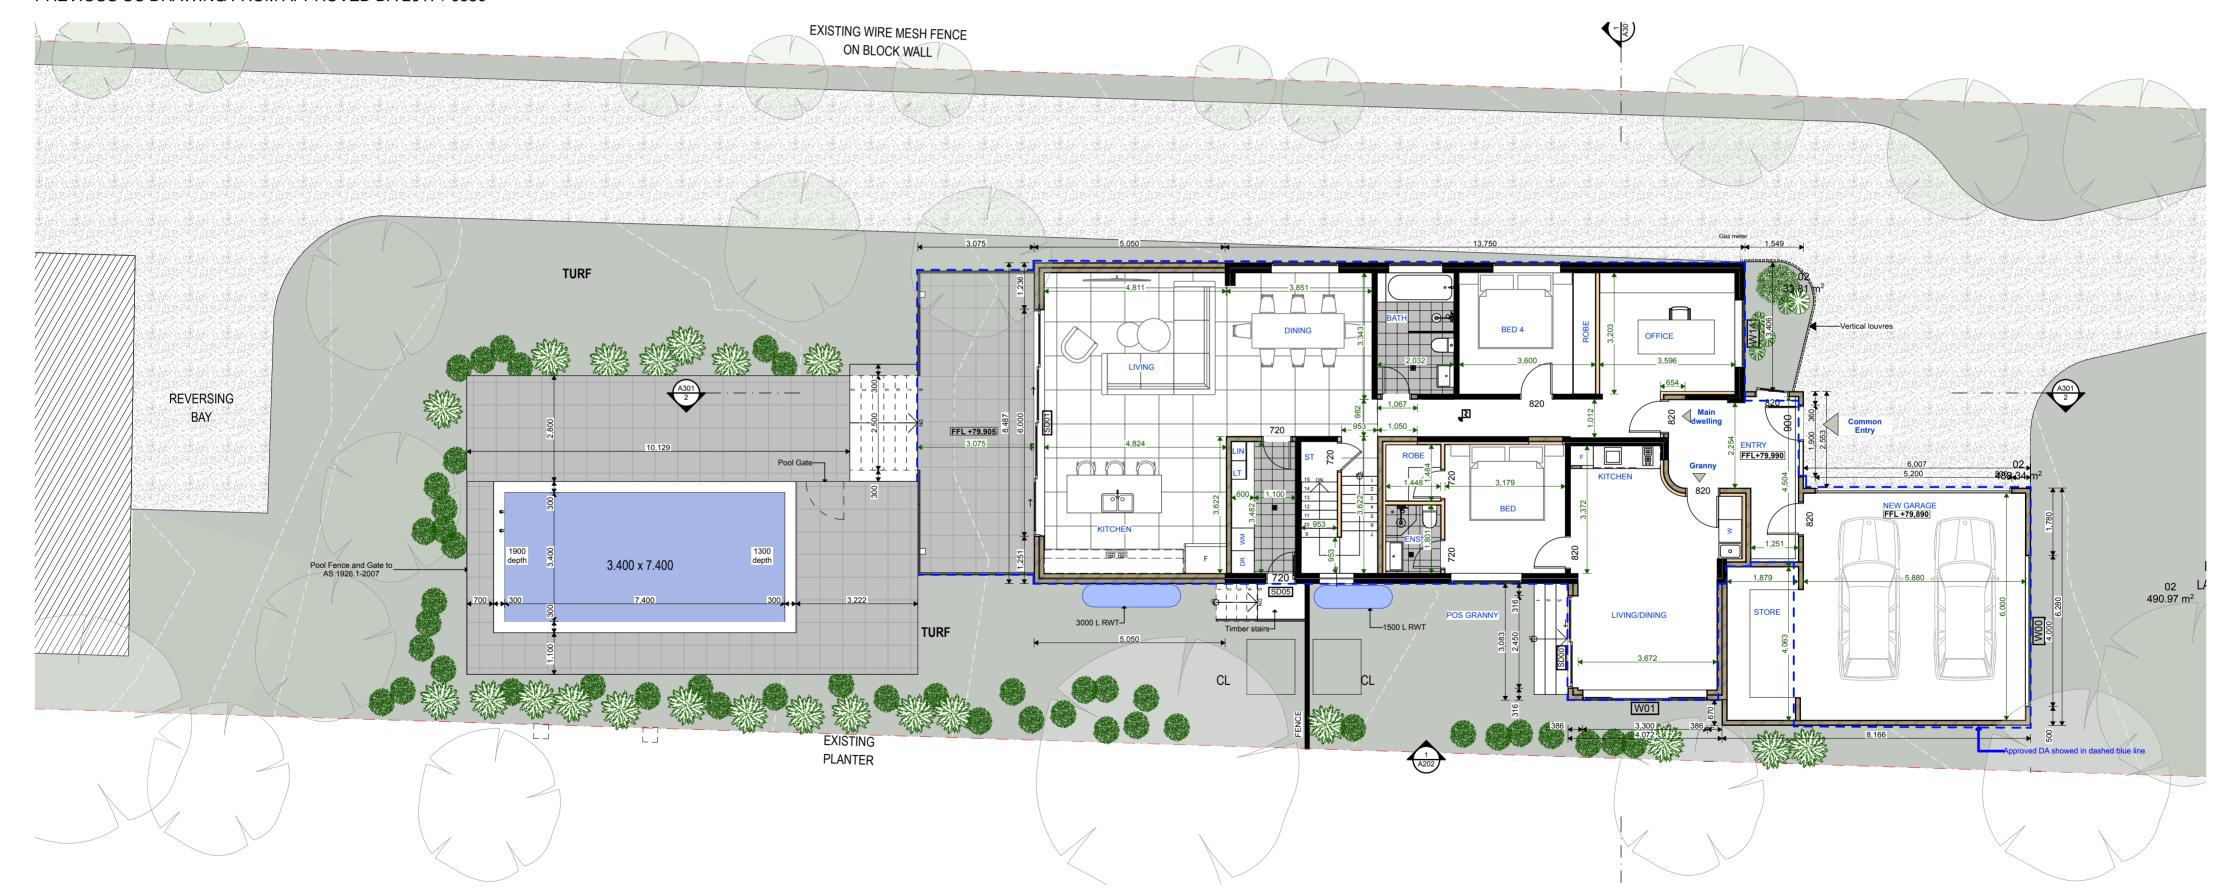
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SITE BOUNDARY SUBDIVISION LINE

PROPOSED GROUND FLOOR OUTLINE

PROPOSED FIRST FLOOR OUTLINE

GROUND FLOOR

1108 OXFORD FALLS RD

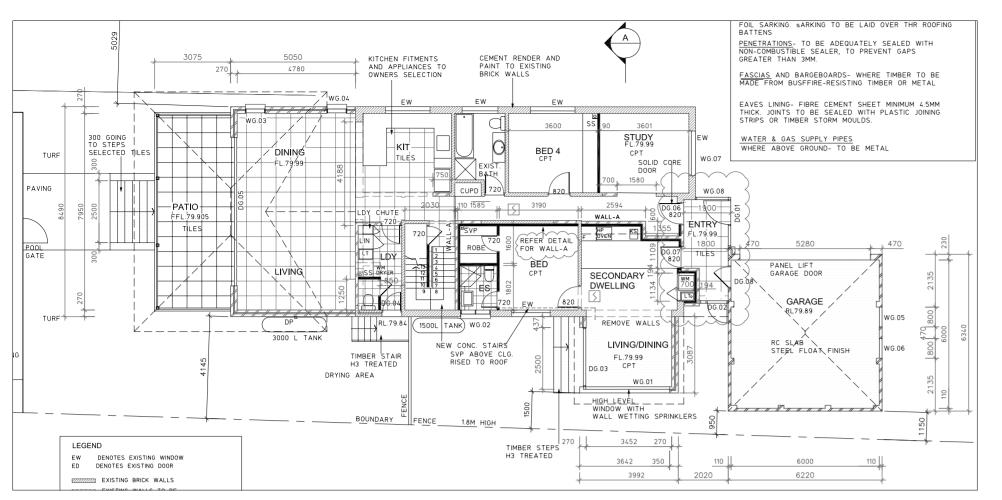SCALE 1:100 NOT TO SCALE


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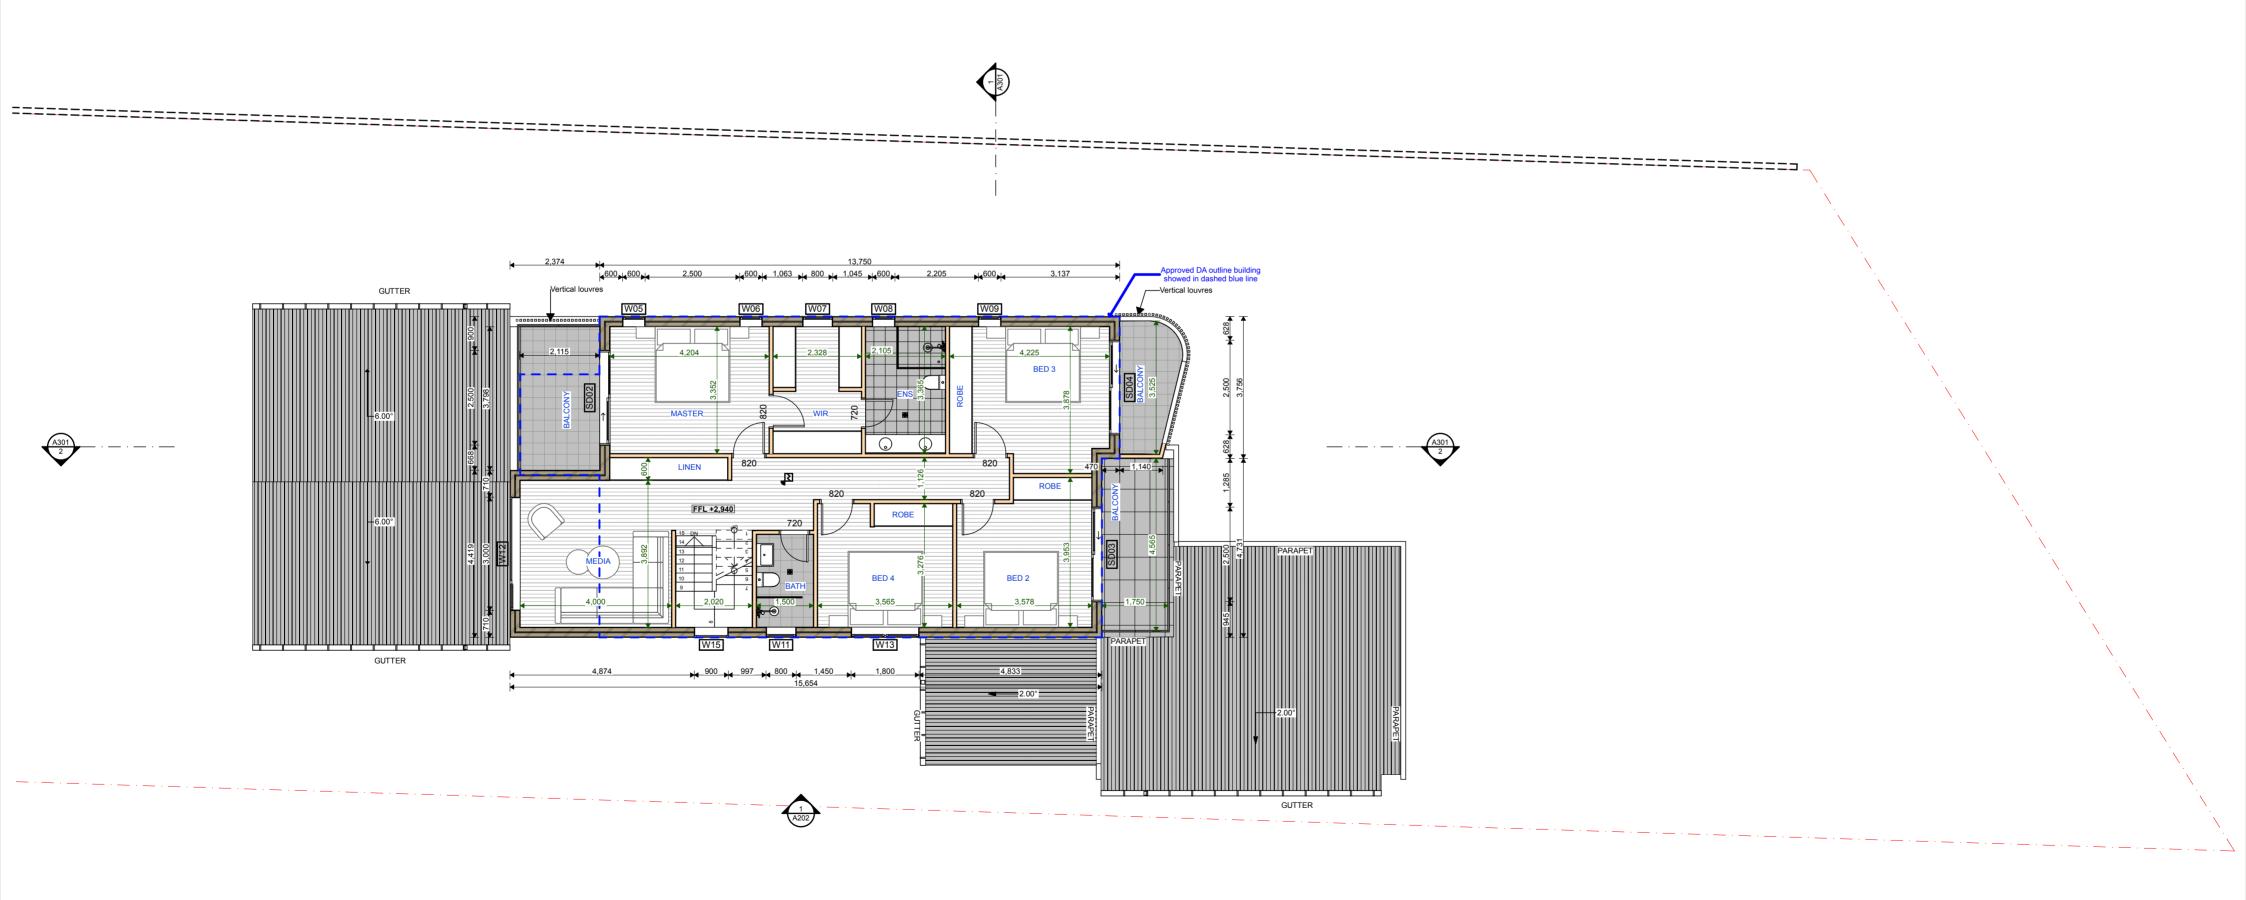
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LEGEND

SITE BOUNDARY SUBDIVISION LINE PROPOSED GROUND FLOOR OUTLINE

PROPOSED FIRST FLOOR OUTLINE

DRAWING TITLE FIRST FLOOR

1108 OXFORD FALLS RD

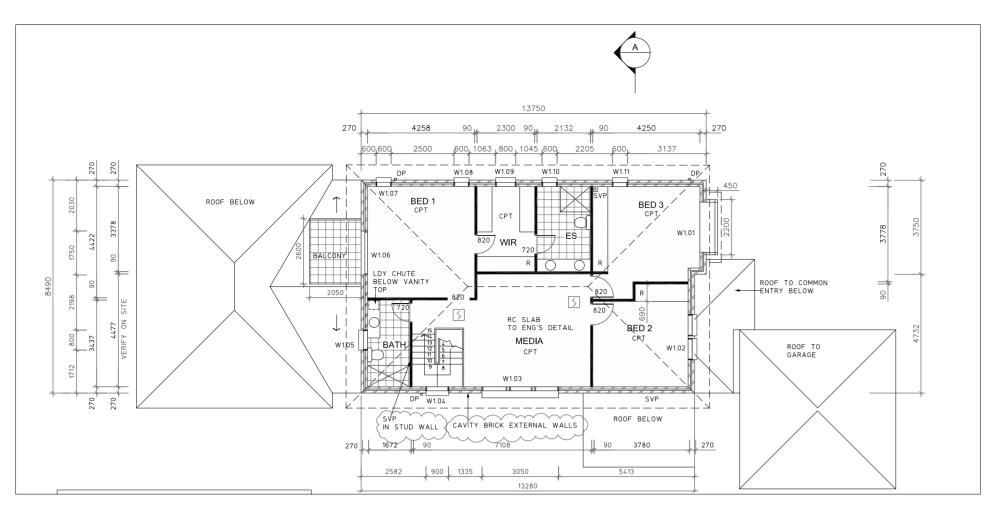
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A101

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LEGEND

SITE BOUNDARY SUBDIVISION LINE

PROPOSED GROUND FLOOR OUTLINE

PROPOSED FIRST FLOOR OUTLINE

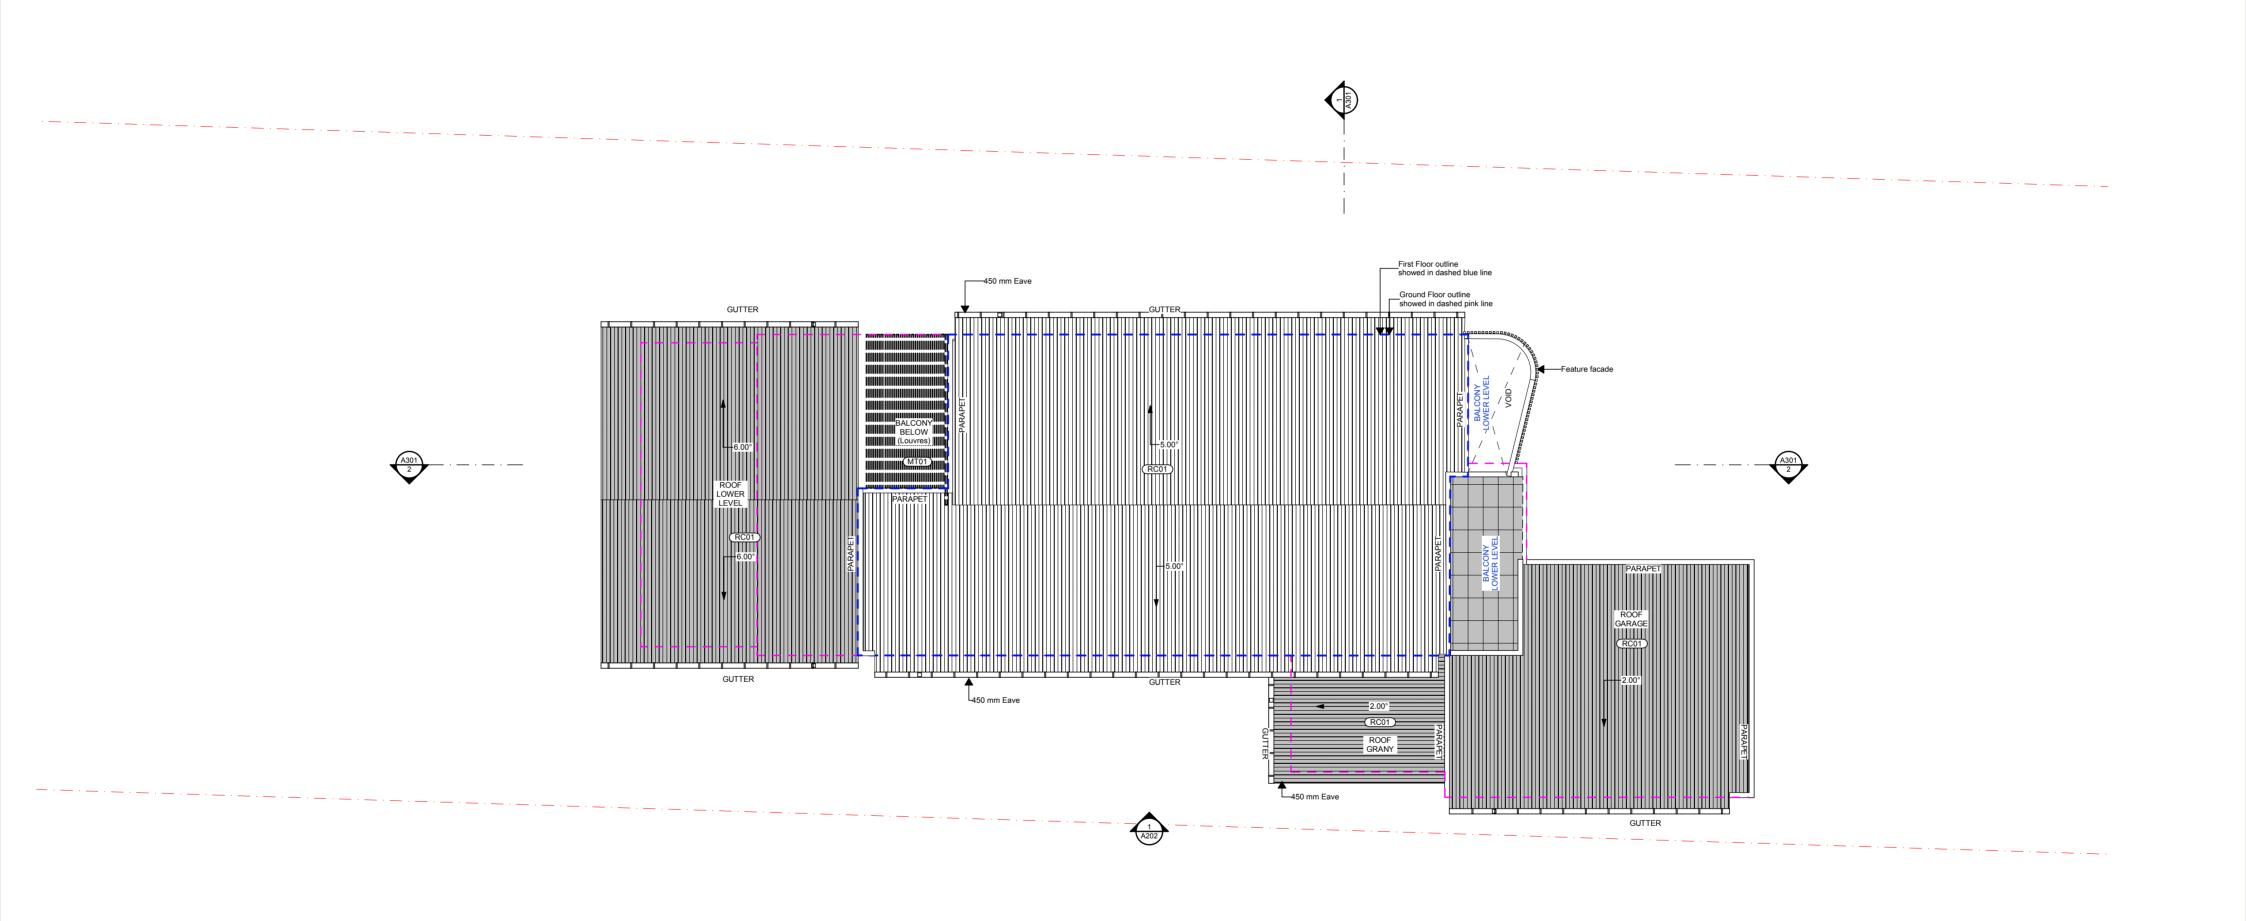DRAWING TITLE **ROOF PLAN**

1108 OXFORD FALLS RD

SCALE 1:100 NOT TO SCALE


A102

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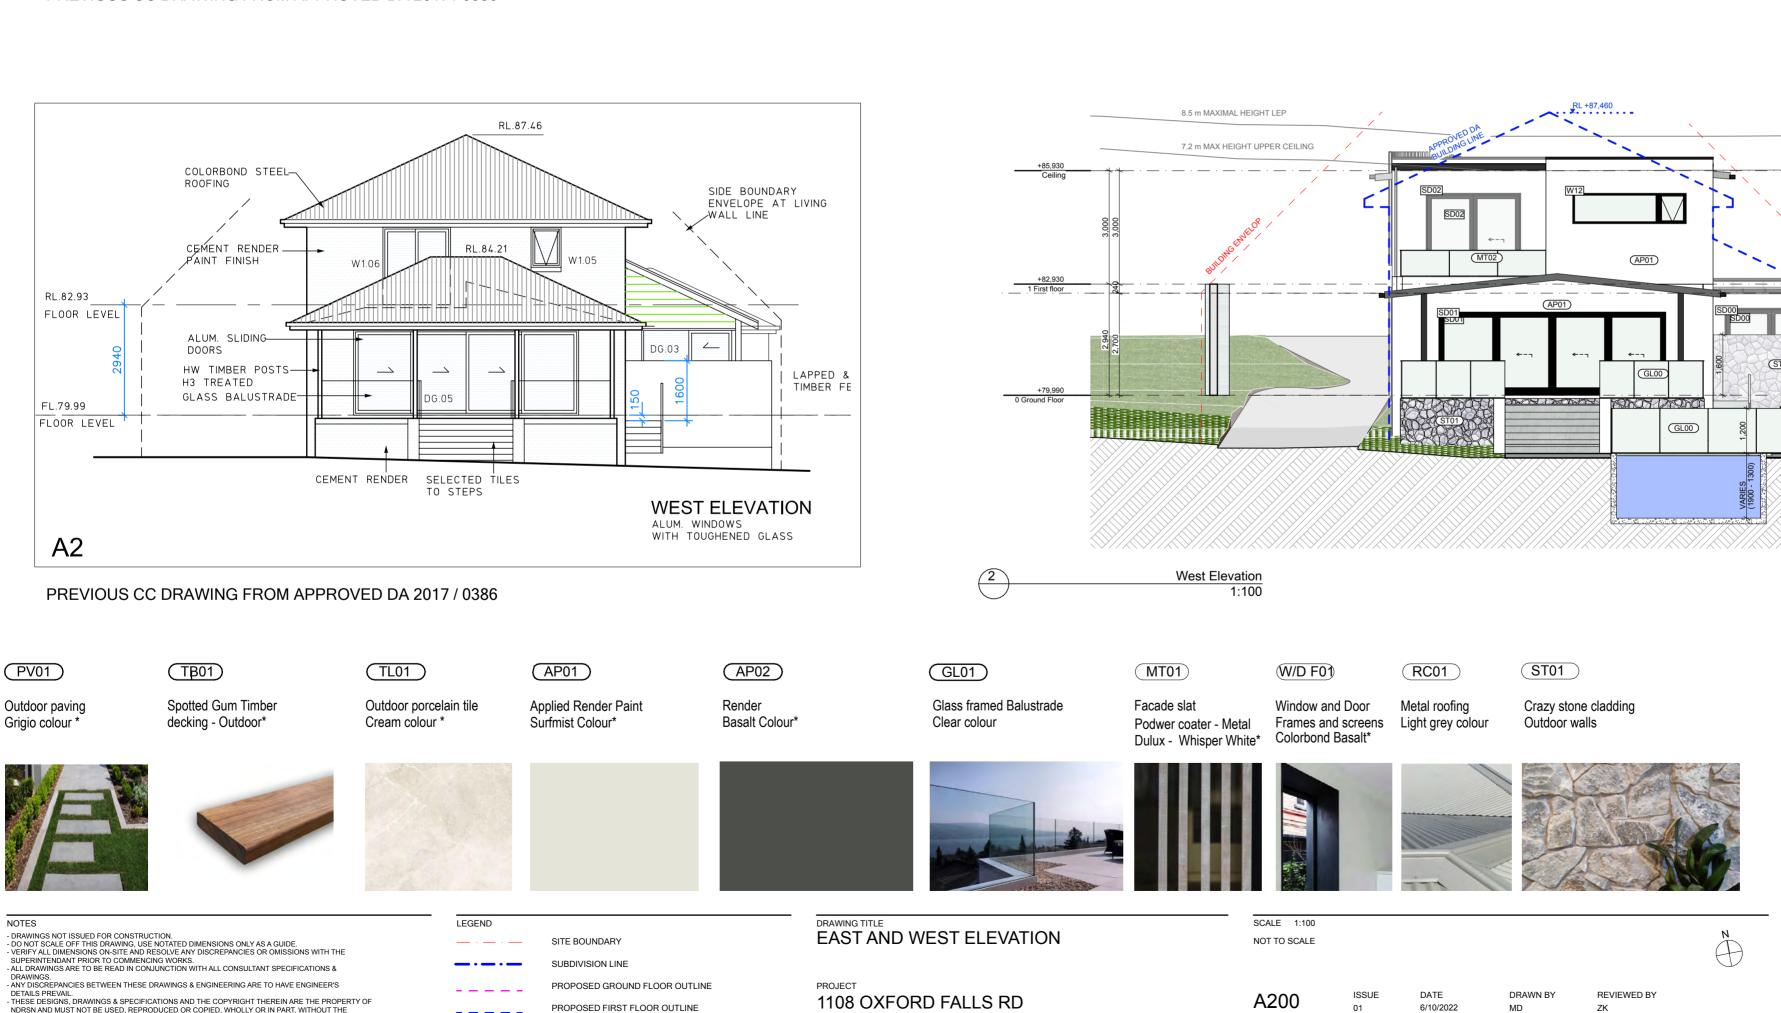
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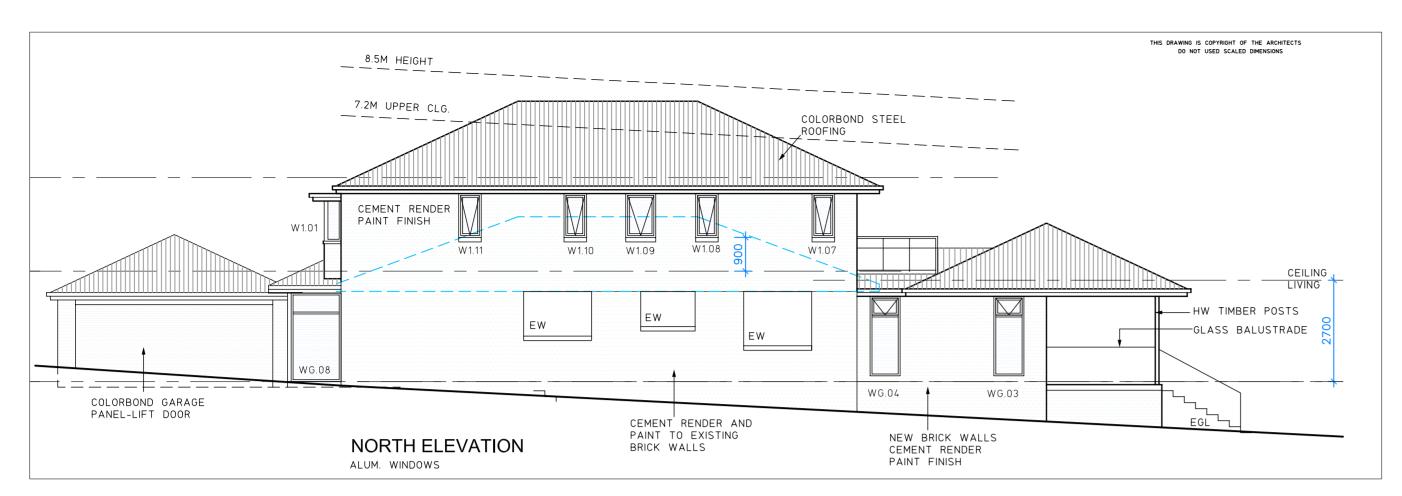


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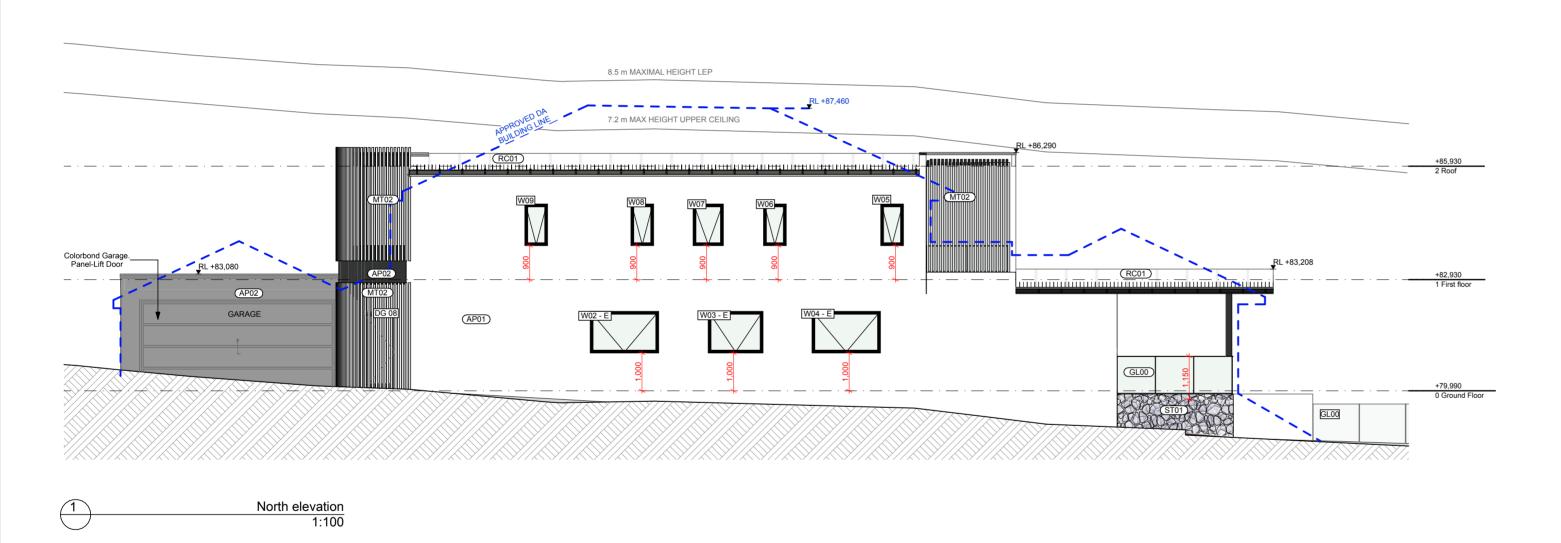
East elevation

1:100

7.2 m MAX HEIGHT UPPER CEILING

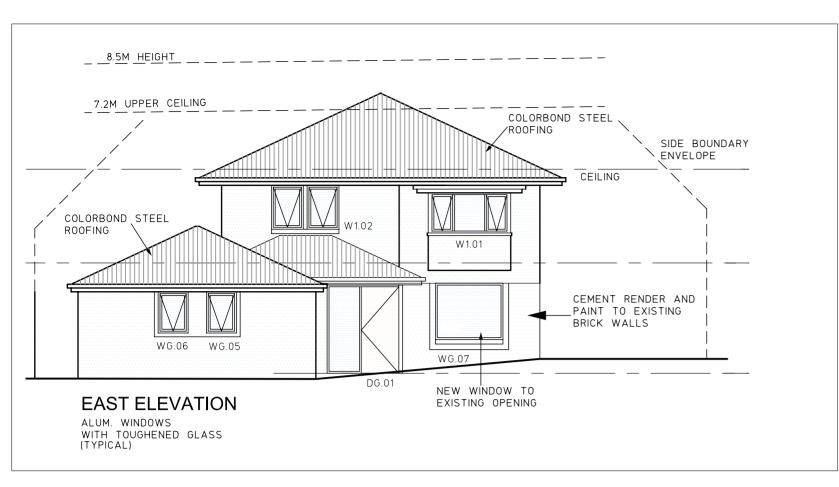

PREVIOUS CC DRAWING FROM APPROVED DA 2017 / 0386



(AP02)

Basalt Colour*

Render













Outdoor porcelain tile

Cream colour *

TL01



Applied Render Paint

Surfmist Colour*

(AP01)







Glass framed Balustrade

GL01

Clear colour



Podwer coater - Metal

Facade slat



MT01 (W/D F01) (RC01)

Colorbond Basalt*

Window and Door




Frames and screens Light grey colour



6/10/2022

Metal roofing

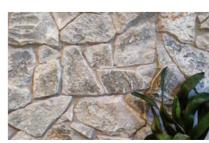

Crazy stone cladding

Outdoor walls

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LEGEND SITE BOUNDARY SUBDIVISION LINE PROPOSED GROUND FLOOR OUTLINE PROPOSED FIRST FLOOR OUTLINE

NORTH ELEVATION

1108 OXFORD FALLS RD

SCALE 1:100 NOT TO SCALE


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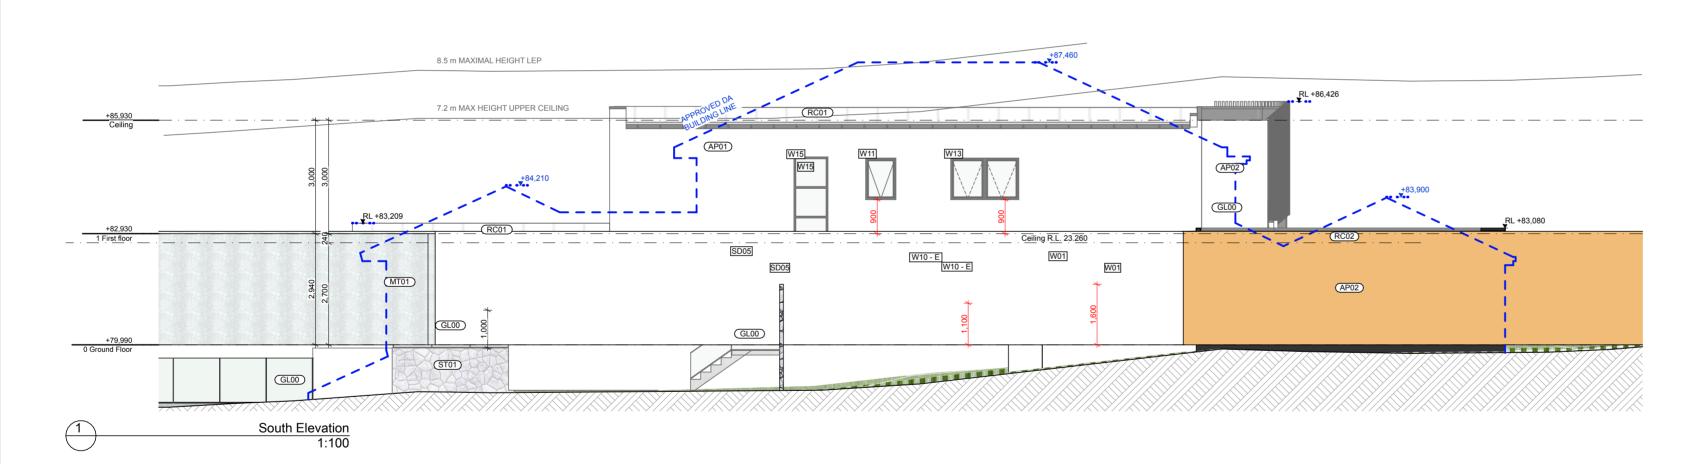
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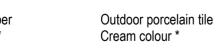


PREVIOUS CC DRAWING FROM APPROVED DA 2017 / 0386





TB01 Spotted Gum Timber decking - Outdoor*

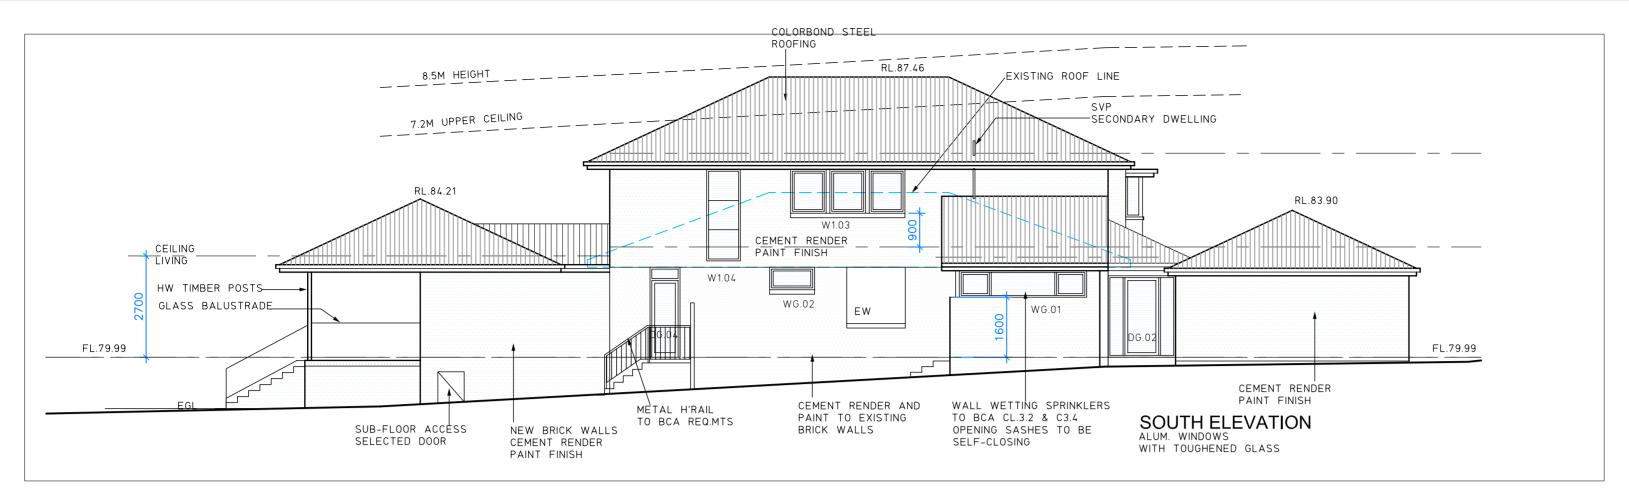

TL01



(AP02) Render Basalt Colour*



Facade slat Podwer coater - Metal Dulux - Whisper White*

Colorbond Basalt*

Window and Door

Metal roofing Frames and screens Light grey colour

Crazy stone cladding
























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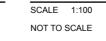
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SOUTH ELEVATION

1108 OXFORD FALLS RD




A201

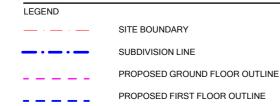


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PREVIOUS CC DRAWING FROM APPROVED DA 2017 / 0386

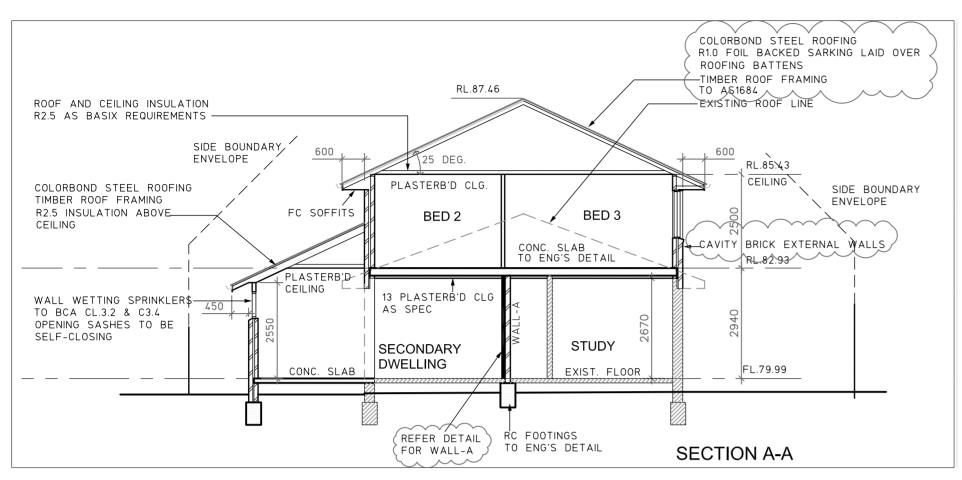

NOTES

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LEGEND

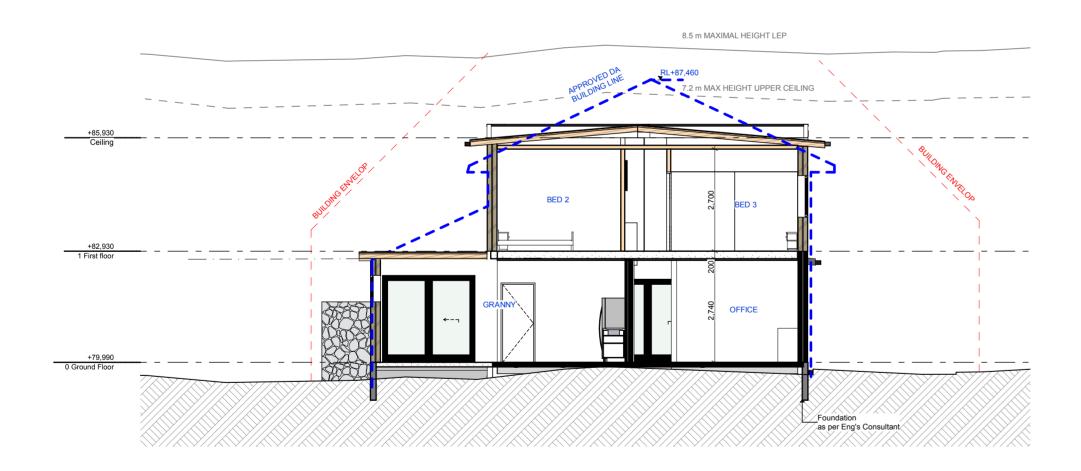SITE BOUNDARY

SUBDIVISION LINE

PROPOSED GROUND FLOOR OUTLINE

PROPOSED FIRST FLOOR OUTLINE

DRAWING TITLE CROSS SECTIONS


PROJECT 1108 OXFORD FALLS RD SCALE 1:100 NOT TO SCALE

A300

 DATE
 DRAWN BY
 REVIEWED BY

 6/10/2022
 MD
 ZK




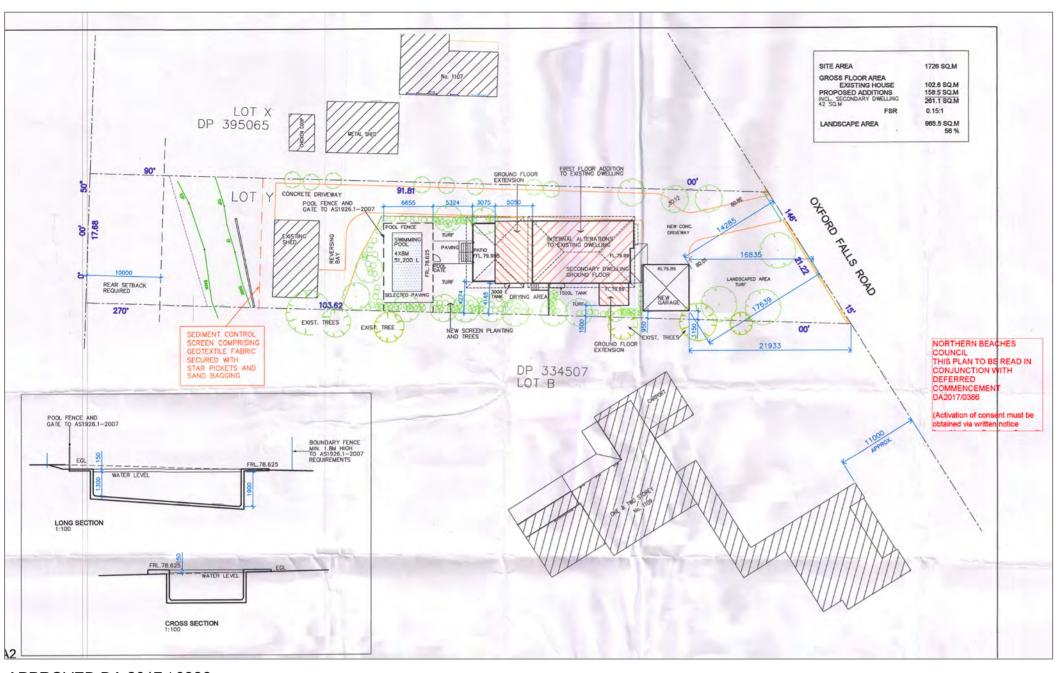

APPROVED DA 2017 / 0386



PLOT INFORMATION **ADDRESS** 1108 OXFORD FALLS RD Frenchs Forest NSW 2086 LOT / SECTION / PLAN No Y/-/DP395065 LOT AREA 1726 m² MAXIMAL HEIGHT LEP 8.5 m NORTHERN BEACHES COUNCIL COUNCIL REGULATION WARRINGAH DCP MANLY DCP - PART 4 - 4.1 RESIDENTIAL DC WARRINGAH LEP 2011 ADDITION AND MODIFICATION PORPOSED TO EXISTING DA TOTAL GFA APPROVED **APPROVED** FSR 0.15:1 261.1 M2 DA2017/0386 TOTAL LANDCASPE APPROVED 56 % 965.5 M2

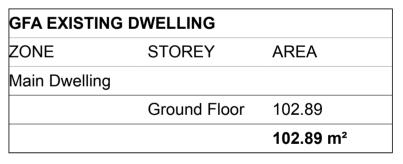

DM : Deferred Matter

GFA NEW		
ZONE	STOREY	AREA
Granny		
	Ground Floor	43.83
Main Dwelling		
	Ground Floor	119.13
	First floor	106.98
		269.94 m²

NEW PROPOSED FOR	
NEW PROPOSED FSR	0.15:1
PREVIOUS APPROVED FSR	0.15:1

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LEGEND

SITE BOUNDARY SUBDIVISION LINE

PROPOSED GROUND FLOOR OUTLINE PROPOSED FIRST FLOOR OUTLINE

CONTROL PLAN

1108 OXFORD FALLS RD

SCALE 1:300 NOT TO SCALE

A400

6/10/2022

MD

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15 PARRAMATTA ROAD, ANNANDALE NSW 2038, SYDNEY

INFO@SHOREHOUSEPROJECTS.COM + 61 2 9557 0808 WWW.SHOREHOUSEPROJECTS.COM

Window Schedule								
Home Story Name	Ground Floor							
Renovation Status	Existing	Existing	Existing	Existing	New	New	New	New
ID	W02 - E	W03 - E	W04 - E	W10 - E	DG 01	DG 08	SD00	SD01
W x H Size	1,810×1,100	1,450×1,100	1,810×1,100	1,900×1,200	1,900×2,940	900×2,100	2,450×2,300	6,000×2,200
Sill Height	1,000	1,000	1,000	1,100	0	0	0	0
Head Height	2,100	2,100	2,100	2,300	2,940	2,100	2,300	2,200
Plan Preview					900	820	\rightarrow	F
3D Back View	1,810	1,450	1,810	1,900	1,990	5.100	2.450	← -¬ ← -¬ ← -¬

Window Schedule								
Home Story Name					First floor			
Renovation Status	New	New	New	New	New	New	New	New
ID	SD05	W00	W01	W14	SD02	SD03	SD04	W05
W x H Size	800×2,400	4,000×700	3,300×700	1,800×1,500	2,500×2,400	2,500×2,400	2,500×2,400	600×1,100
Sill Height	0	1,900	1,600	900	0	0	0	900
Head Height	2,400	2,600	2,300	2,400	2,400	2,400	2,400	2,000
Plan Preview	720				←	├	<u> </u>	
3D Back View	7 800	4.000	3,300	1,800	€-7	←-¬	\$ 2.500	600

New	New	New	New	New	New	New	New
W06	W07	W08	W09	W11	W12	W13	W15
600×1,100	800×1,100	600×1,100	600×1,100	800×1,100	3,000×800	1,800×1,100	900×2,400
900	900	900	900	900	1,600	900	-370
2,000	2,000	2,000	2,000	2,000	2,400	2,000	2,030
<u></u>				<u></u>			
000	1,100	600	4 600 4 1,100	1-100	3.000	1,800	2.400
	W06 600×1,100 900 2,000	W06 600×1,100 800×1,100 900 2,000 2,000	W06 600×1,100 800×1,100 900 900 2,000 2,000	W06 W07 W08 W09 600×1,100 800×1,100 600×1,100 600×1,100 900 900 900 900 2,000 2,000 2,000 2,000 300 300 W06 W07 W08 W09 W11 600×1,100 800×1,100 600×1,100 800×1,100 900 900 900 900 2,000 2,000 2,000 2,000	W06 W07 W08 W09 W11 W12 600×1,100 800×1,100 600×1,100 800×1,100 3,000×800 900 900 900 900 1,600 2,000 2,000 2,000 2,000 2,400	W06 W07 W08 W09 W11 W12 W13 600×1,100 800×1,100 800×1,100 3,000×800 1,800×1,100 900 900 900 900 1,600 900 2,000

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LEGEND SITE BOUNDARY SUBDIVISION LINE PROPOSED GROUND FLOOR OUTLINE

PROPOSED FIRST FLOOR OUTLINE

DRAWING TITLE WINDOW SCHEDULE

1108 OXFORD FALLS RD

SCALE 1:0.86 NOT TO SCALE

A600

6/10/2022

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