```
GENERAL ABBREVIATIONS
                                 apartment #
balustrade type #
basin type #
blockwork
cooktop
                                ceiling height
check on site
                                cupboards
                              downpipe
damp-proof course
dishwasher
drawers
electrical distribution board
                               eaves gutter
engineer
entry
eaves vent
                               existing
existing
finished ceiling level
finished floor level
floor waste type #
garage door
                               garage door
handrail type #
hand towel rail
hot water system
                                kickplate
letter box
                                 mirror
                               microwave type #
mixer tap
nominal
                               powerpoint
privacy screen
refridgerator
robe hook
roof ventilator
                             roof ventilator
steel column
skylight #
sink type #
solar panels
shower set
tap external
tap type #
towel rail
toilet roll holder
window
                                window
toilet type #
walk in rob
```

MATERIAL	ABBREVIATIONS
conc cp cpt wt# fb fc ft# lam# lo# mms# pb k pbbw ply pt pt pt rb rblk sf ss tdk	concrete blockwork concrete concrete concrete concrete pavers carpet wall tile type # facebrick fibre cement sheet floor tile type # laminate type # laminate type # laminate type # laminate type # metal hood metal roof sheet manufactured stone type # plasterboard painted brickwork plasterboard — water resistant marine grade plywood external paver polyurethane finish type # rendered brickwork sandstone blockwork stone flagging stainless steel timber decking boards timber floorboards timber rhardwood as scheduled timber cladding timber louvres

# **Sheet List**

C-01	Exterior Mood Board
C-02	Exterior Mood Board
C-03	Schedule of Finishes
DA-01 DA-02 DA-03 DA-04 DA-05 DA-06 DA-07 DA-08 DA-09 DA-10 DA-11	Site Plan + Analysis Ground Floor Plan First Floor Plan Roof Plan West + East Elevations North + South Elevations Sections Erosion + Sediment Control Plan Stormwater Drainage Plan Landscape Plan Notification Plan


# MITCHELL TALLOWWOOD HOUSE

DEVELOPMENT APPLICATION 9 + 9A ROWAN STREET, MONA VALE

for A. G. MITCHELL + C. B. TALLOWWOD




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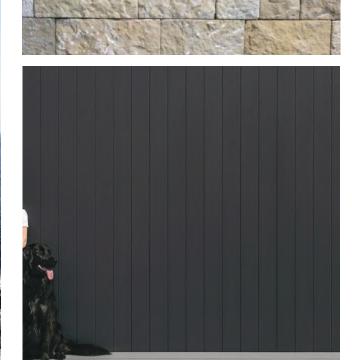


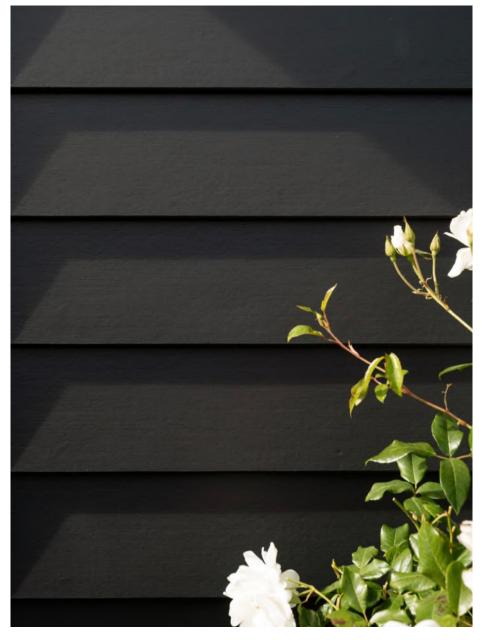





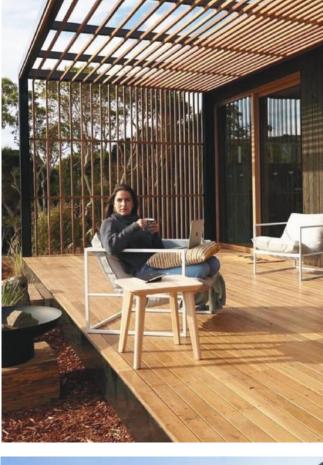









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| DATE | AMENDMENT | CONCEPT 2 ISSUE 1 | DA ISSUE 1






















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DATE 26.11.24 CONCEPT 2 ISSUE 1 20.01.25 DA ISSUE 1

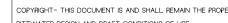ADDRESS: LOT 3 IN D.P 206600 9 ROWAN STREET, MONA VALE	EXTERIOR MOOD BOARD			20.01.25
CLIENT: MITCHELL + TALLOWWOOD	SCALE:	PROJECT No: 2402	DWG No: C-02	ISSUE 3




lc1 - James Hardie 180 LINEA cladding DULUX KLAVIER



lc2 - James Hardie AXON 400 cladding DULUX KLAVIER



rb/rblk - rendered brickwork/blockwork DULUX WHITE EXCHANGE HALF

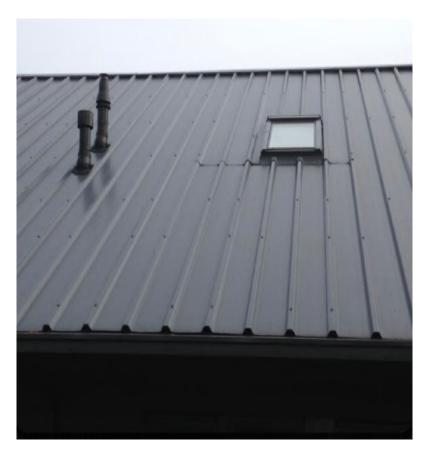

mrs - Colorbond KLIP-LOK metal roof sheeting COLORBOND MONUMENT



tmb - hardwood timber SPOTTED GUM or similar



bal - spaced metal fencing BLACK



example of fixtures - BLACK




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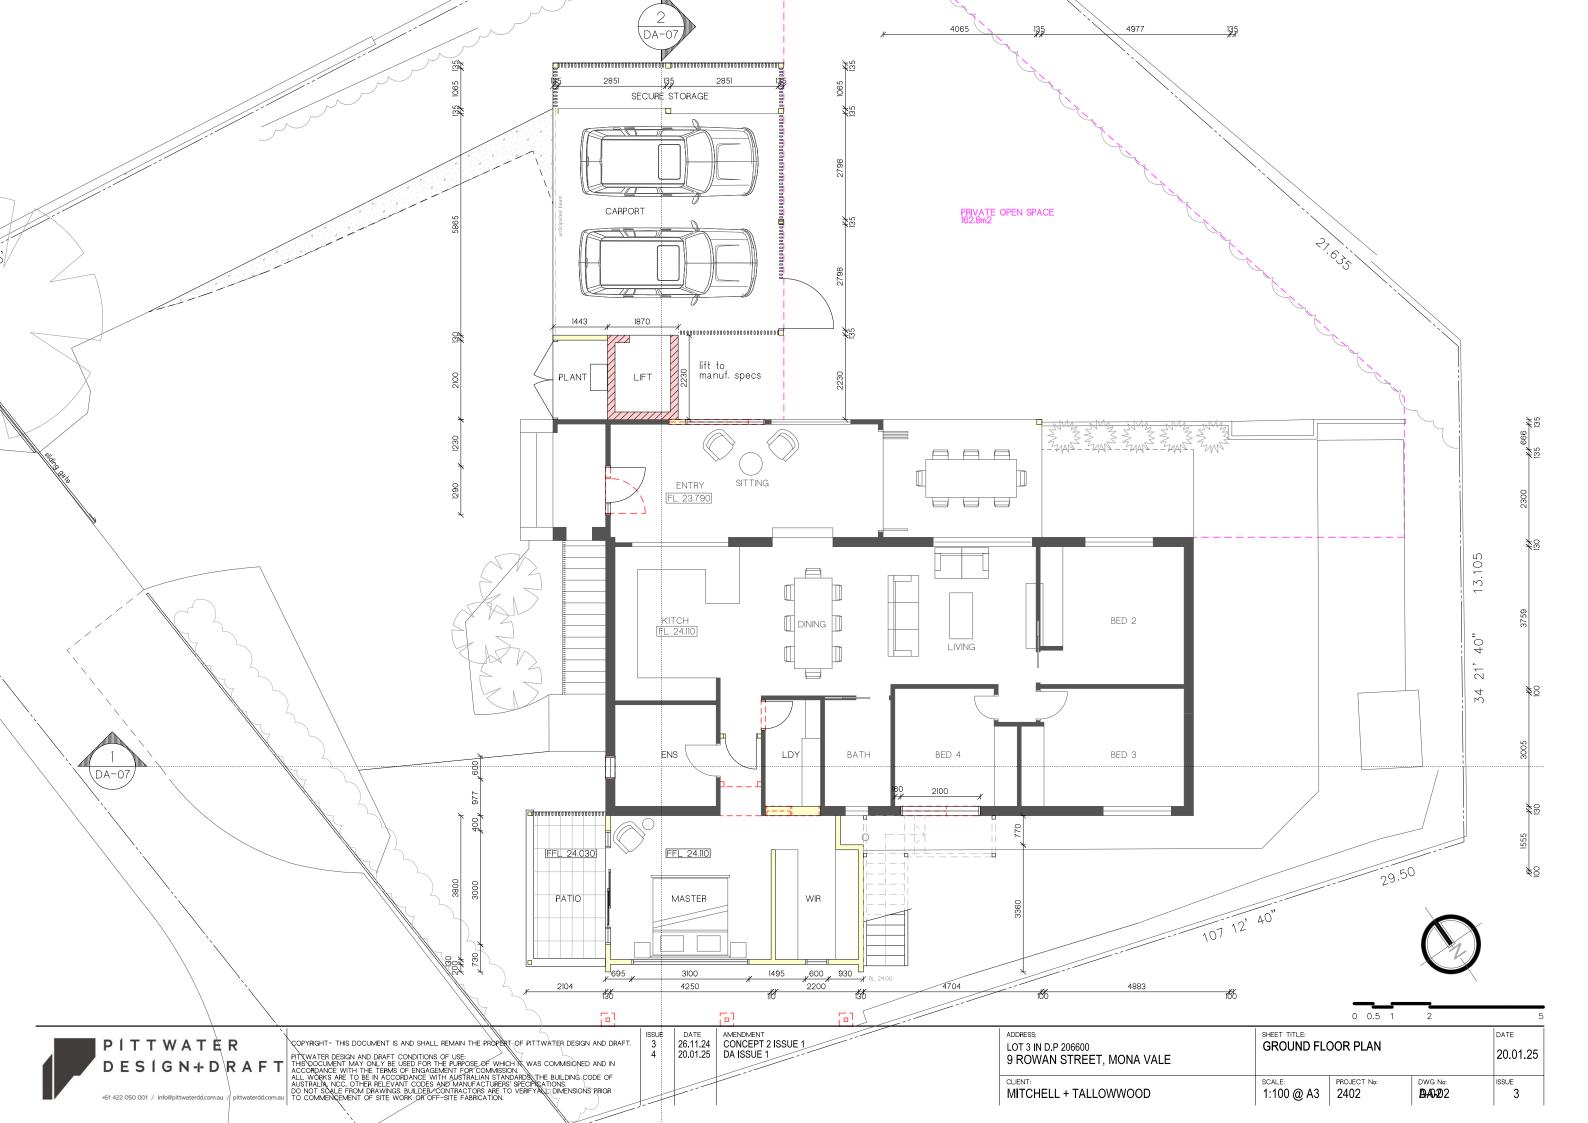
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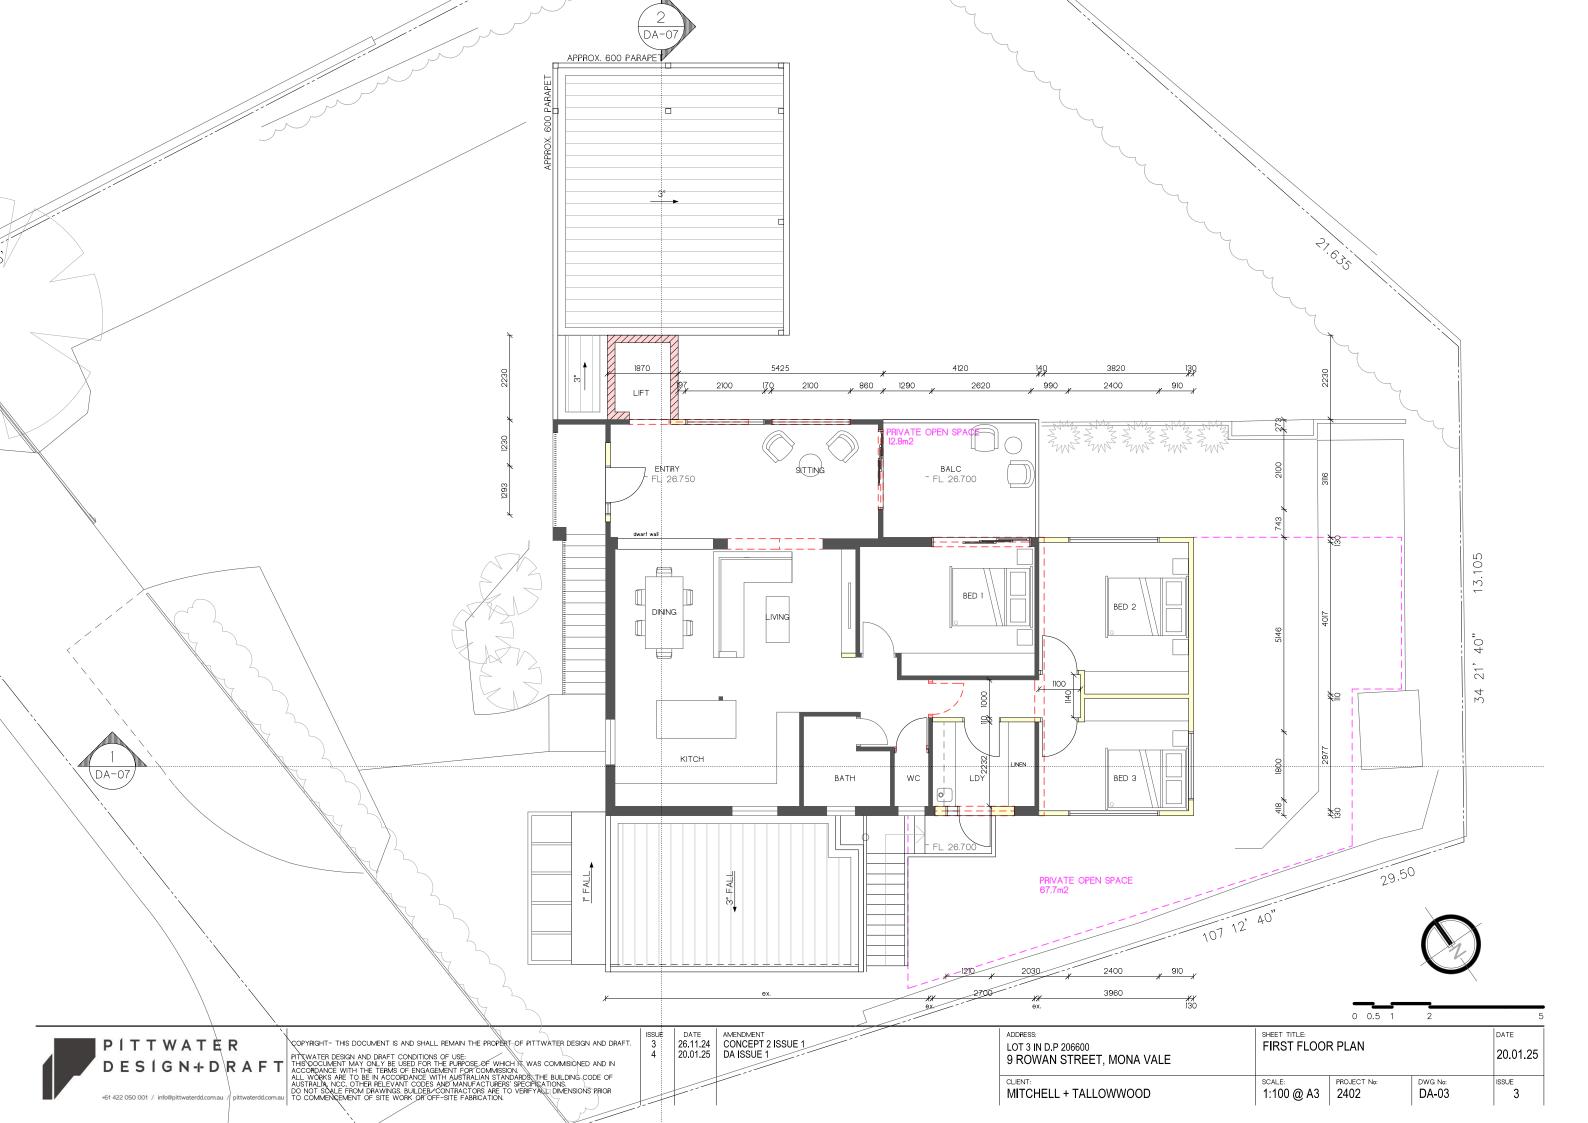
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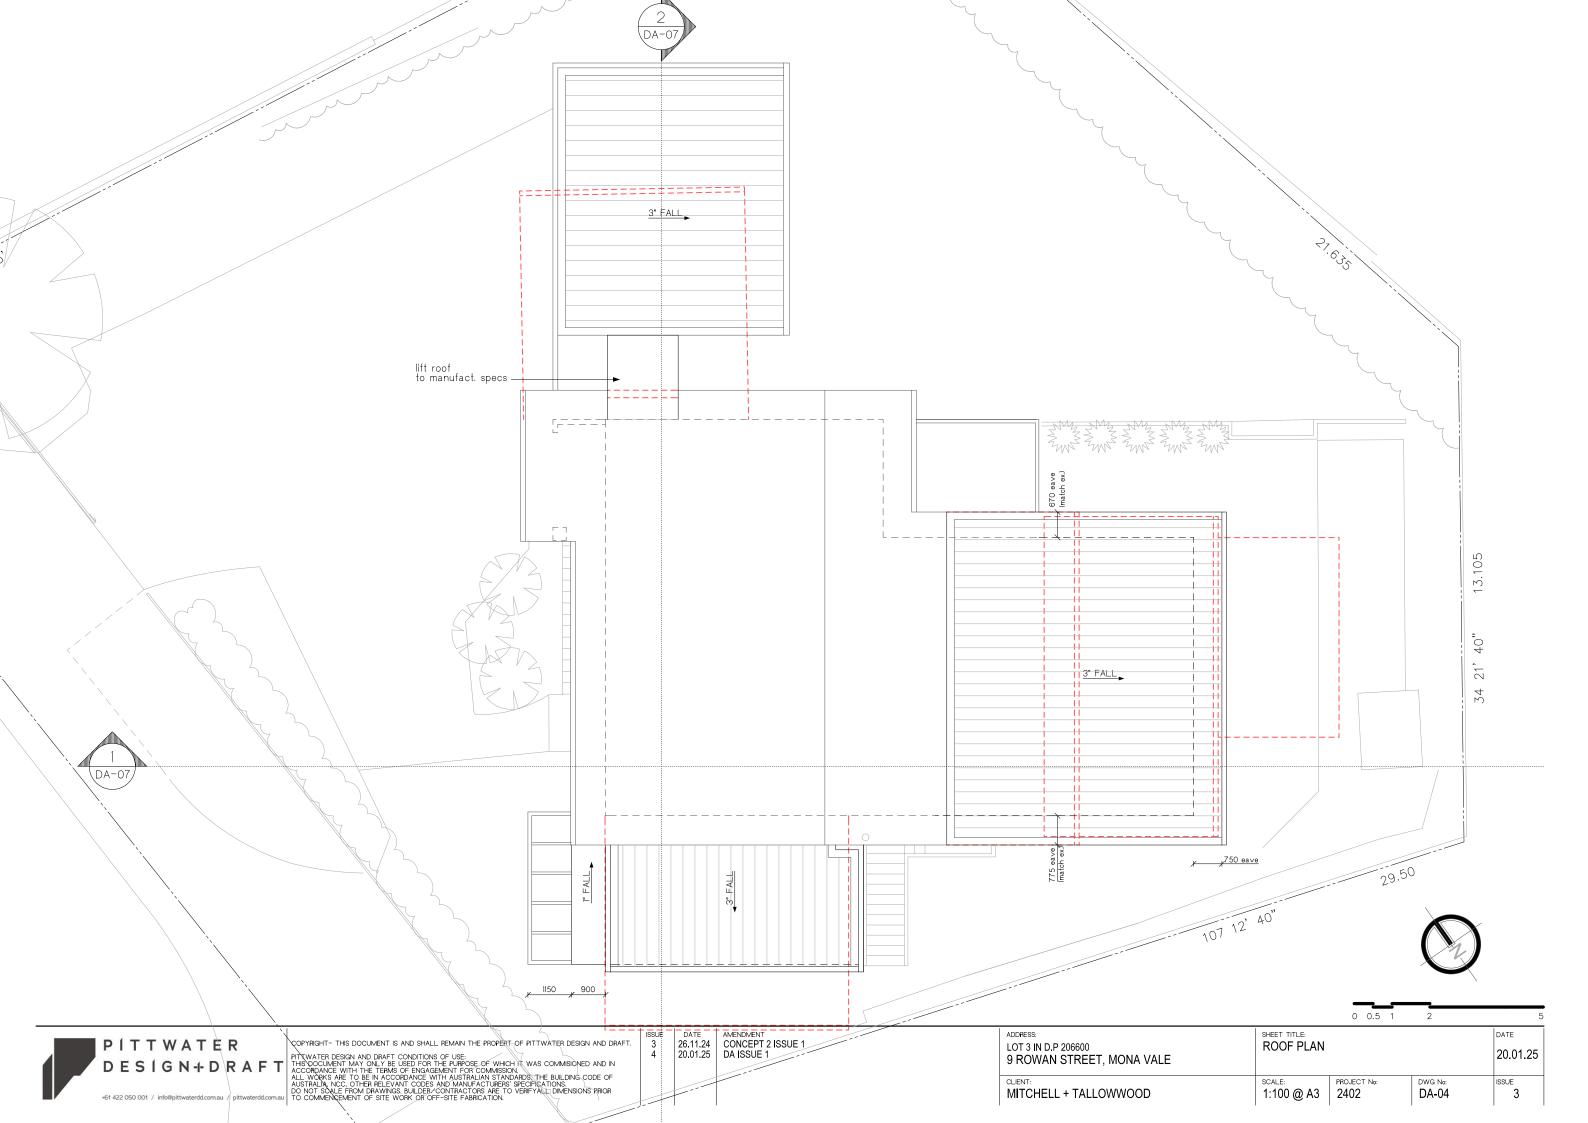
DATE 26.11.24 CONCEPT 2 ISSUE 1 20.01.25 DA ISSUE 1


ADDRESS: LOT 3 IN D.P 206600 9 ROWAN STREET, MONA VALE	SHEET TITLE: SCHEDULE OF FINISHES			20.01.25
CLIENT: MITCHELL + TALLOWWOOD	SCALE:	PROJECT No: 2402	DWG No: C-03	ISSUE 3








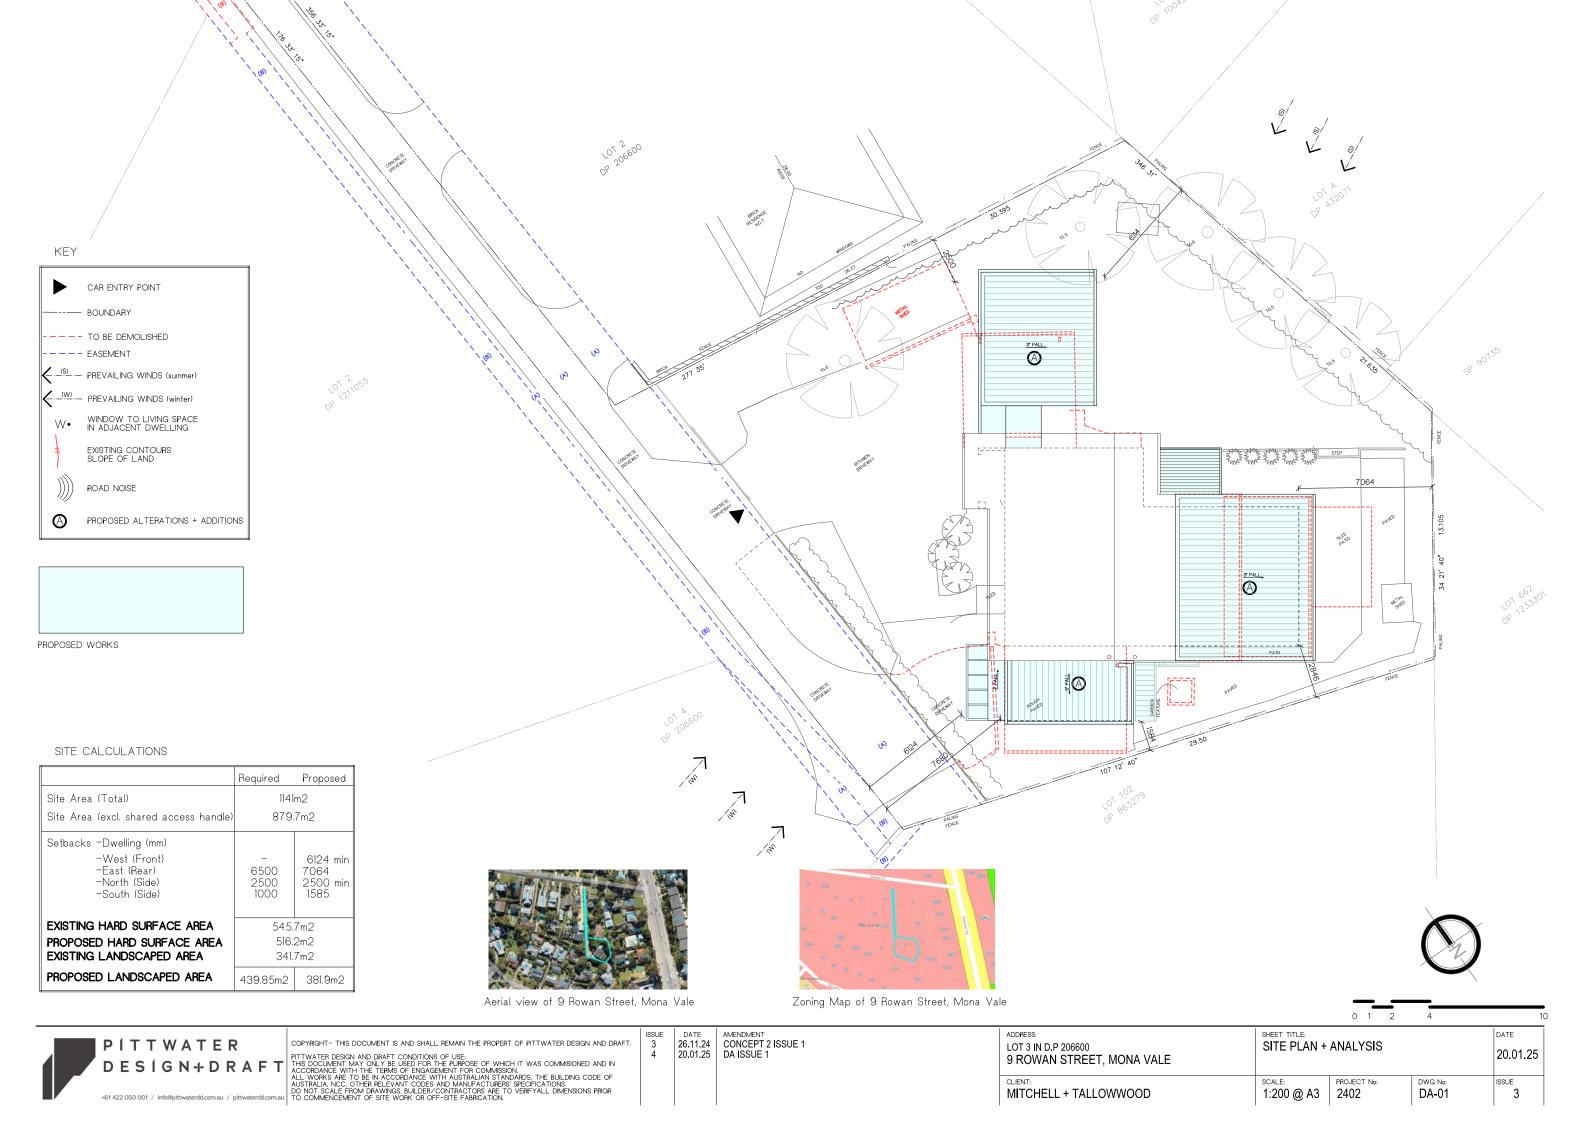

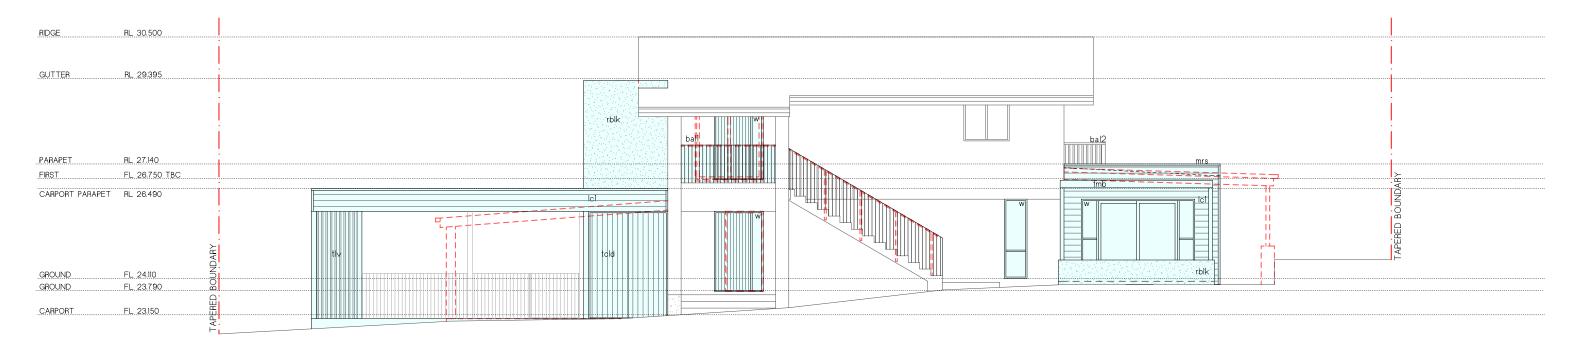



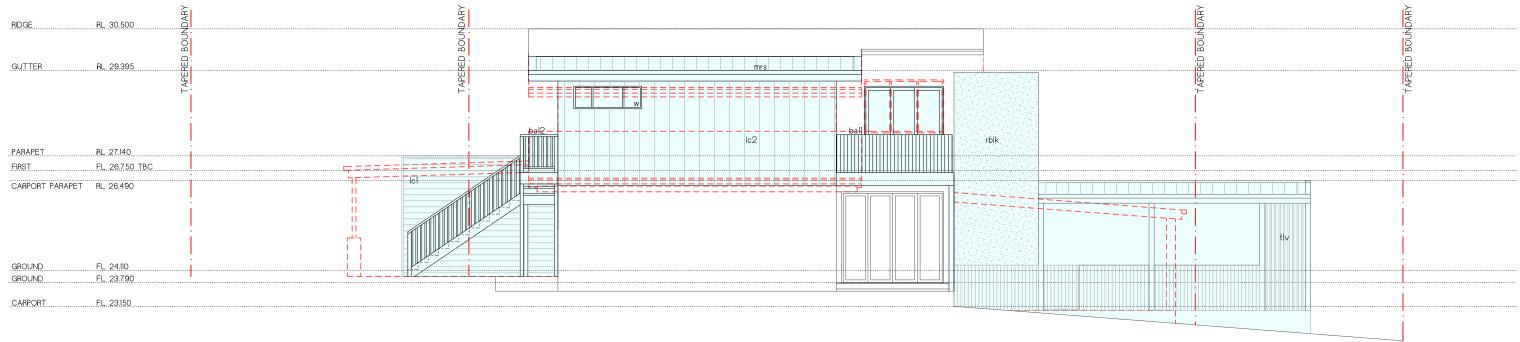

EAST ELEVATION Scale 1:100

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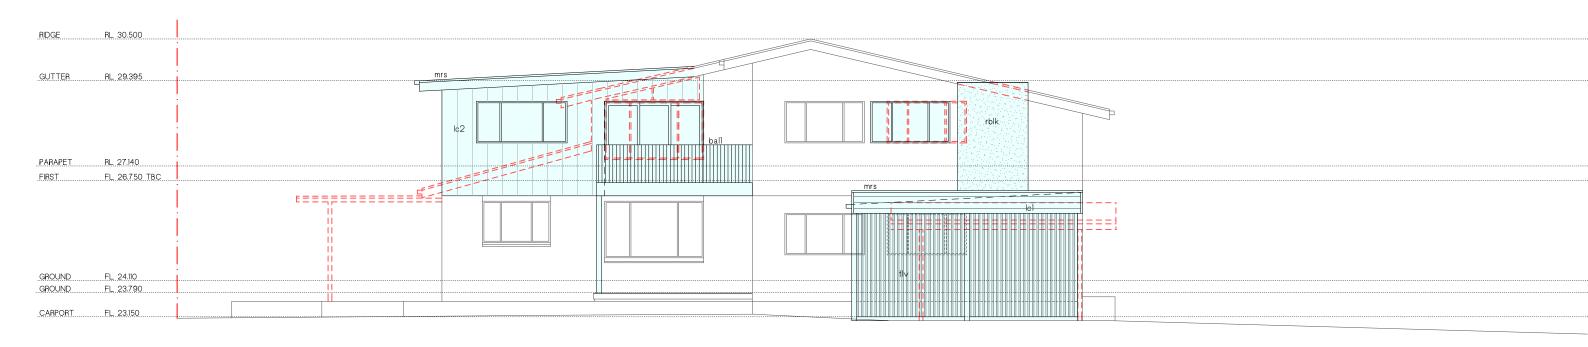
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AMENDMENT
CONCEPT 2 ISSUE 1
DA ISSUE 1

ADDRESS: LOT 3 IN D.P 206600 9 ROWAN STREET, MONA VALE	SHEET TITLE: WEST + EAST ELEVATIONS			20.01.25
CLIENT: MITCHELL + TALLOWWOOD	SCALE: 1:100 @ A3	PROJECT No: 2402	DWG No: DA-05	ISSUE 3





SOUTH ELEVATION

0 0.5 1 DATE


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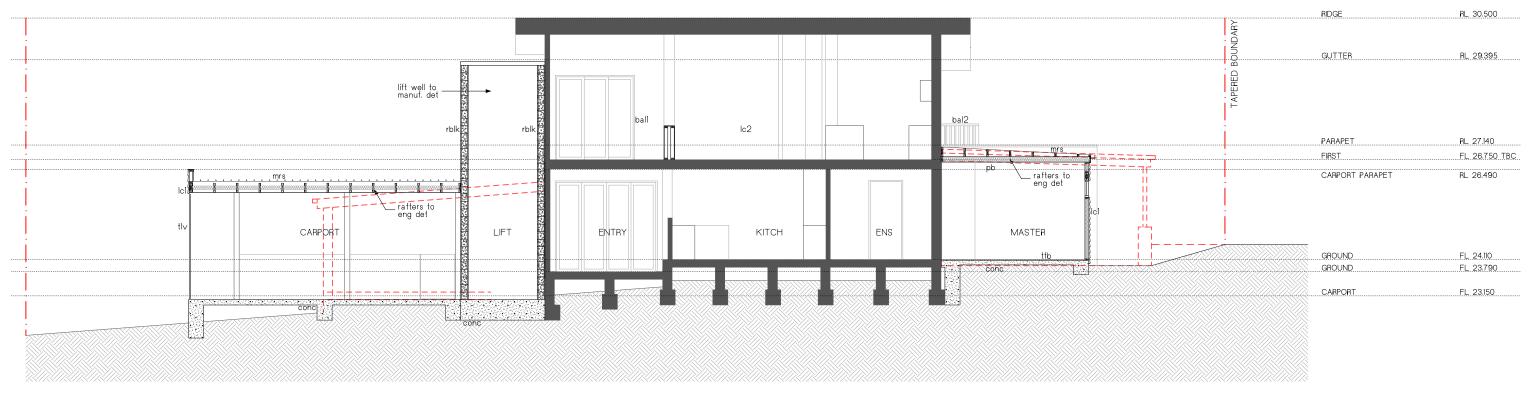
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DATE 26.11.24 CONCEPT 2 ISSUE 1 DA ISSUE 1

SHEET TITLE: NORTH + SOUTH ELEVATIONS ADDRESS: LOT 3 IN D.P 206600 20.01.25 9 ROWAN STREET, MONA VALE 1:100 @ A3 2402 MITCHELL + TALLOWWOOD DA-06 3



SECTION 1
Scale 1:100

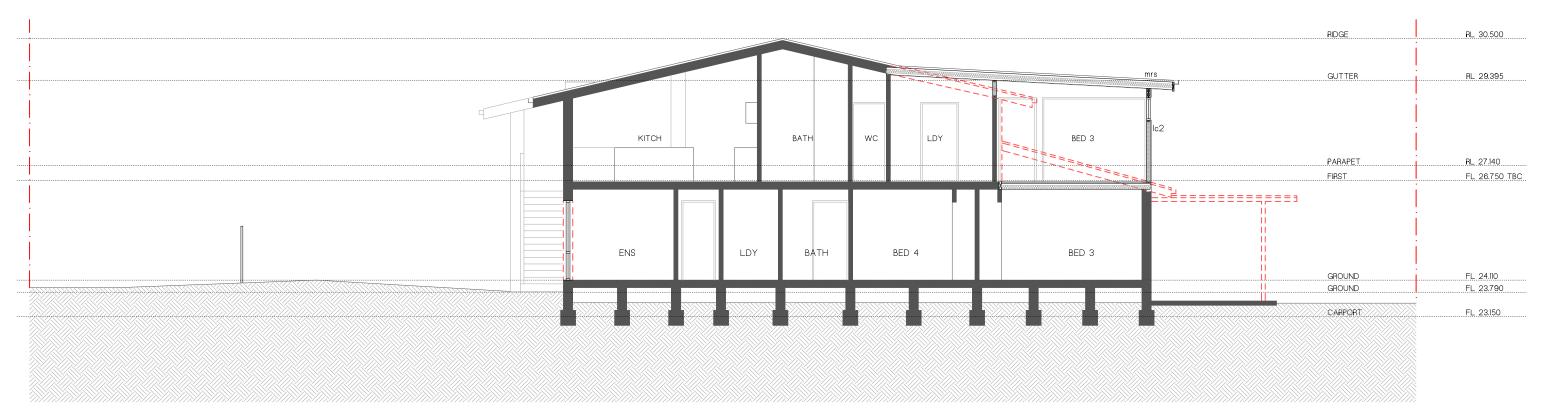

SECTION 2
Scale 1:100

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4	DESIGN+DRAFT	COPYRIGHT - THIS DOCUMENT IS AND SHALL REMAIN THE PROPERT OF PITTWATER DESIGN AND DRAFT.  PITTWATER DESIGN AND DRAFT CONDITIONS OF USE: THIS DOCUMENT MAY ONLY BE USED FOR THE PURPOSE OF WHICH IT WAS COMMISIONED AND IN ACCORDANCE WITH THE TERMS OF ENGAGEMENT FOR COMMISSION.	ISSUE 3 4	AMENDMENT CONCEPT 2 ISSUE 1 DA ISSUE 1	ADDRESS: LOT 3 IN D.P 206600 9 ROWAN STREET, MONA VALE	SHEET TITLE: SECTIONS			20.01.25
		ALL WORKS ARE TO BE IN ACCORDANCE WITH AUSTRALIAN STANDARDS, THE BUILDING CODE OF AUSTRALIA, NCC, OTHER RELEVANT CODES AND MANUFACTURERS' SPECIFICATIONS. DO NOT SCALE FROM DRAWINGS. BUILDER/CONTRACTORS ARE TO VERIFYALL DIMENSIONS PRIOR TO COMMENCEMENT OF SITE WORK OR OFF-SITE FABRICATION.			CLIENT: MITCHELL + TALLOWWOOD	scale: 1:100 @ A3	PROJECT No: 2402	DWG No: DA-07	ISSUE 3

Site Access

Vehicular access to the site must be via a single entry point that is stabilised to prevent the tracking of sediment onto the roads and footpath. Soil, earth, mud, clay, concrete washing, paint or similar materials must be removed from the roadway, by means other than washing, on a daily basis. All clay or similar to be brushed or washed from yearlings before leaving site. Erosion & Sediment Control Plan (ESCP) This drawing is in accordance with the requirements of the NSW Department of Land and Water Conservation's "Urban Erosion and Sediment Control" manual. Any vehicle leaving the site must be washed down on the "Stabilised Site Entry" to remove any clay that may have become attached to the vehicle. vehilcés before leaving site. The road around the entry/exit site is to be swept at regular Gutter Protection Provide protection to down hill Grate in Gutter by means of Sand bags or blue metal wrapped in geotextle fabric. When soil or sand builds up around this sediment barrier, the material intervals to prevent sediment build up at the entry/exit point of the site. 1. Site works will not start until the erosion and sediment control works outlined in clauses 2 to 5, below, are installed and functional. should be relocated to the site for disposal. 2. Entry and exit to the site will be confirmed to one stabilised location. Fencing will be used to restrict all vehicular movements to stabilised entrance. Stabilisation achieved by either: \* Contructing a concrete driveway to the street.
\* Constructing a stabilised site access, according to the Stabilised Site Access Detail drawing.

3. Sediment control (see Typical Sediment Fence Plan and Sediment Fence Section Détail) and barrier fences will be installed as shown on the ESCP with low flow channel bank (see Stabilised Site Entry). 4. Mesh and gravel sausage protection will be provided to protect gutter inlets near the allotment. 5. Topsoil will be stripped and stockpiled for later use STOCKPILE in landscaping the site. 6. All stockpiles will be placed in the location shown on the ESCP and at least 2 metres clear of all areas of concentrated water flow and the driveway protected by site 7. Lands to the rear and sides of the allotment and on the footpath will not be disturbed during works except where essential, e.g. drainage works across the footpath. Where work are necessary, they will be undertaken in such a way to leave the lands in a condition of high erosion hazards for as short a period as practicable. They will be rehabilitated as soon as possible. Stockpiles will not be placed on these lands and they will not be used as vehicle CONCRETE parking areas. 8. Approved bins for concrete and mortar slurries, paints, acid washings and litter will be provided and arrangements made for collection and disposal. 9. Guttering will be connected to the stormwater system as soon as practicable. 3º FALL 10. Topsoil will be respread and all disturbed areas will be rehabilitated within 20 working days of the completion of works. 11. All erosion and sediment controls will be checked at least weekly and after rain to ensure they are maintained in a fully functional condition. \_\_\_\_\_ 800mm wide geotextile with flow rate in the range 50 to 100 litres/m /sec Disturbed area and pore size in the range 80 to 120 microns. Direction Fix to each star picket with two wires

GEOFABRIC SEDIMENT FENCE NOT TO SCALE



Undisturbed area

Embed bottom 300mm of geotextile in 200 x 200 trench

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Steel star pickets 1200 long at up to 3000 crs, fitted with protective plastic caps

> 3 26.11.24 4 20.01.25

AMENDMENT
CONCEPT 2 ISSUE 1
DA ISSUE 1

ADDRESS:

LOT 3 IN D.P 206600
9 ROWAN STREET, MONA VALE

EROSION + SEDIMENT CONTROL PLAN
20.01.25

CLIENT:
MITCHELL + TALLOWWOOD

SCALE:
1:200 @ A3 2402

DA-08

DATE
20.01.25

sediment fence

TILED

METAL

450 x 450 Pit -connect to existing outlet system All pipes unless otherwise specified on the plan to be 100 Inspection openings will be required at even spacings not than 30 metres apart and at any change of direction greater than
45 degrees.
HP - High Points in the guttering Drainage Pipe Notes. Slope of pipes to be a minimum of 1:100 i.e. 1% All levels and dimensions to be checked and confirmed on All design work and works to be in accordance with AS/NZS 3500.5 (2000) and AS/NZS 3500.3.2 (1998) The Eaves Gutter minimum of 125mm D Gutter with a cross sectional area of 6300 sq. mm (as taken from Lysaght Pty Ltd), or similar. Downpipes attached to the eaves gutter to have a minimum diameter of 90mm of similar. CONCRETE have a minimum diameter of 90mm of similar. TILED Downpipes can be connected to existing stormwater pipes. pipelines need to be checked and repaired in accordance to AS3500. 3º FALL Dimensions and slope of existing need to be checked in METAL SHED AS3500 to ensure adequacy. Tank dimensions shown in drawing is not to scale. Tanks determined with consideration on height limits. İ===========

'Klip-Lok' or similar Roof Sheeting with reflective foil blanket and R2.5 insulation. Fixed to Rafters in Accordance with Manufacturers Specifications.

dia. UPVC pipe.

DP - Downpipes

However, existing

accordance with

sizes should be

Provide Colorbond Quad Gutters to all new eaves. Set with sufficient fall to all downpipes and secure with brackets max. 1200mm apart.

Provide Colorbond downpipes where required. Connect head to gutter & foot to drainage system with bracketsat 2700mm max. spacing with a minimum of 2 brackets.

All new downpipes are to be connected to the existing stormwater system, that discharges to an existing Council stormwater Collection system. system.





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20.01.25

DATE AMENDMENT CONCEPT 2 ISSUE 1 DA ISSUE 1


DATE STORMWATER DRAINAGE PLAN LOT 3 IN D.P 206600 20.01.25 9 ROWAN STREET, MONA VALE MITCHELL + TALLOWWOOD 1:200 @ A3 | 2402 DA-09 3









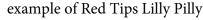

# LANDSCAPE NOTES

### PRESERVATION OF EXISTING TREES

Existing levels to be retained within the critical root zone of all trees remaining as per the Landscape plan. In any excavation, refer to arborist report for direction

#### PREPERATION OF GARDEN BEDS

Cultivate garden beds for new plants to a depth of 300mm. Incorporate imported 'greenlife' soil conditioner from Australian native landscapes (or equivalent) with existing soil when planting. Do not cultivate soil beneath existing trees to be retained, Mulch to be 'horticultural grade' pine bark by Australian native landscapes (or equivalent) and installed to a depth of 75mm to all garden beds, covering mulch down around plant stems and finish flush with adjacent surfaces.

## SOIL PREPERATION

Where earthworks have occured, the contractor is to ensure any stockpiled topsoil is free of unwanted matter such as rocks, clay lumps, tree roots, builder's rubbish and

#### **PLANTING**

Purchase plants from an approved nursery. Plants to be healthy and true to type and species. Set out plants to positions indicated on plan. Following approval, plant holes shall be dug twice the width and to be 100mm deeper than plant rootballs that they are to receive. Base and sides of hole shall be further loosened. Fertilise, followed by 100mm depth of topsoil mix placed into base of hole and lightly consolidated. Base of hole shall then be watered.

Remove plant container and install into hole. Rootball shall be backfilled with surrounding topsoil and topsoil firmed into place. An approved shallow dish shall be firmed to contain water around the base of stem. Base of stem of plant shall finish flush with finished soil level. Once installed, plant shall be thoroughly watered and maintained for the duration of the contract.

All trees and large shrubs shall be staked using 2 x 38 mm x 38 mm x 200 mm long hardwood stakes per plant and secured with hessian webbing ties installed to contractor's on site instructions.

## MAINTENANCE


Carry out the following tasks for a twelve month period from the date of practical completion:

- -weeding of all garden beds
- -rubbish remo∨al
- -fertilising to achieve optimal growth
- -pest and disease control
- -adjustment of ties and stakes
- -replace failed planting
- -pruning and hedge clipping of plants
- -reinstatement of mulch to specified depth

		PLANT SCHEDULE							
	SYMBOL	BOTANIC NAME	COMMON NAME	HEIGHT x WIDTH	No.	POT SIZE			
HEDGE									
	AS	ACMENA SMITHII	RED TIPS LILLY PILLY	3.0m x 3.0m	6	250mm			

Red Tips Lilly Pilly Description-

A showy, tall, dense and fast growing Lily Pilly shrub which topiaries. It has smaller, narrower leaves than other Lily growth and masses of fluffy white flowers in Summer. Grows

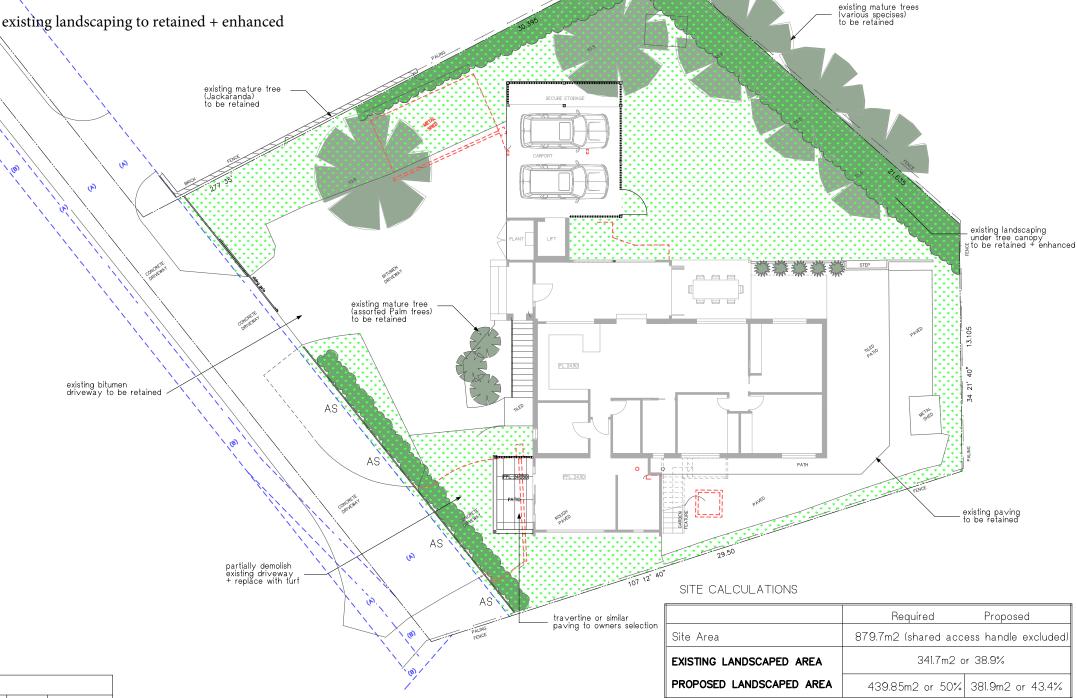











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26.11.24 20.01.25

AMENDMENT CONCEPT 2 ISSUE 1 DA ISSUE 1

LANDSCAPE PLAN LOT 3 IN D.P 206600 20.01.25 9 ROWAN STREET, MONA VALE MITCHELL + TALLOWWOOD 1:200 @ A3 2402 DA-10 3