



The builder shall check and verify all dimensions and verify all errors and omissions to the Architect. Do not scale the drawings. Drawings shall not be used for construction purposes until issued by the Architect for construction.


Christopher & Siobhan Eagar Home


3 Martin St Freshwater NSW 2095


Drawing Title:
Plans Ground - Site Plan and Perspectives
View from Gate, Site Analysis and Site Plan

Scale: as noted Date: March 2020 Checked By: SH Project No: Drawing No. DA01

2019 11

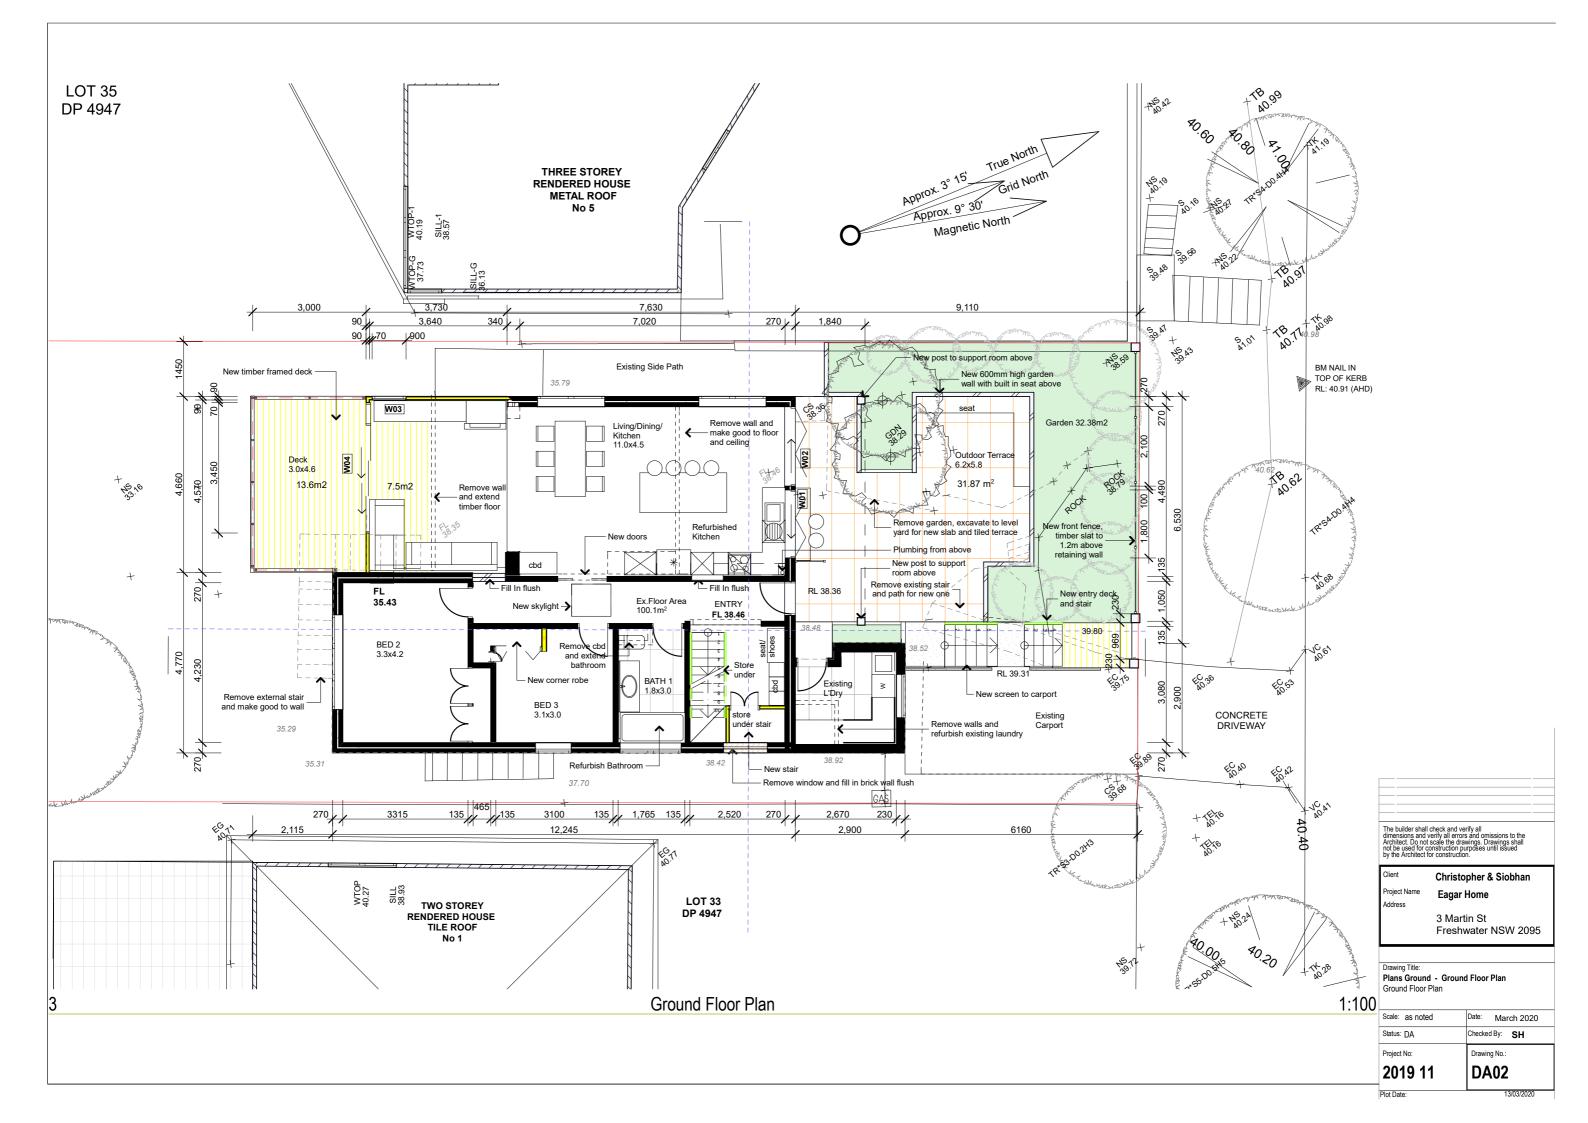

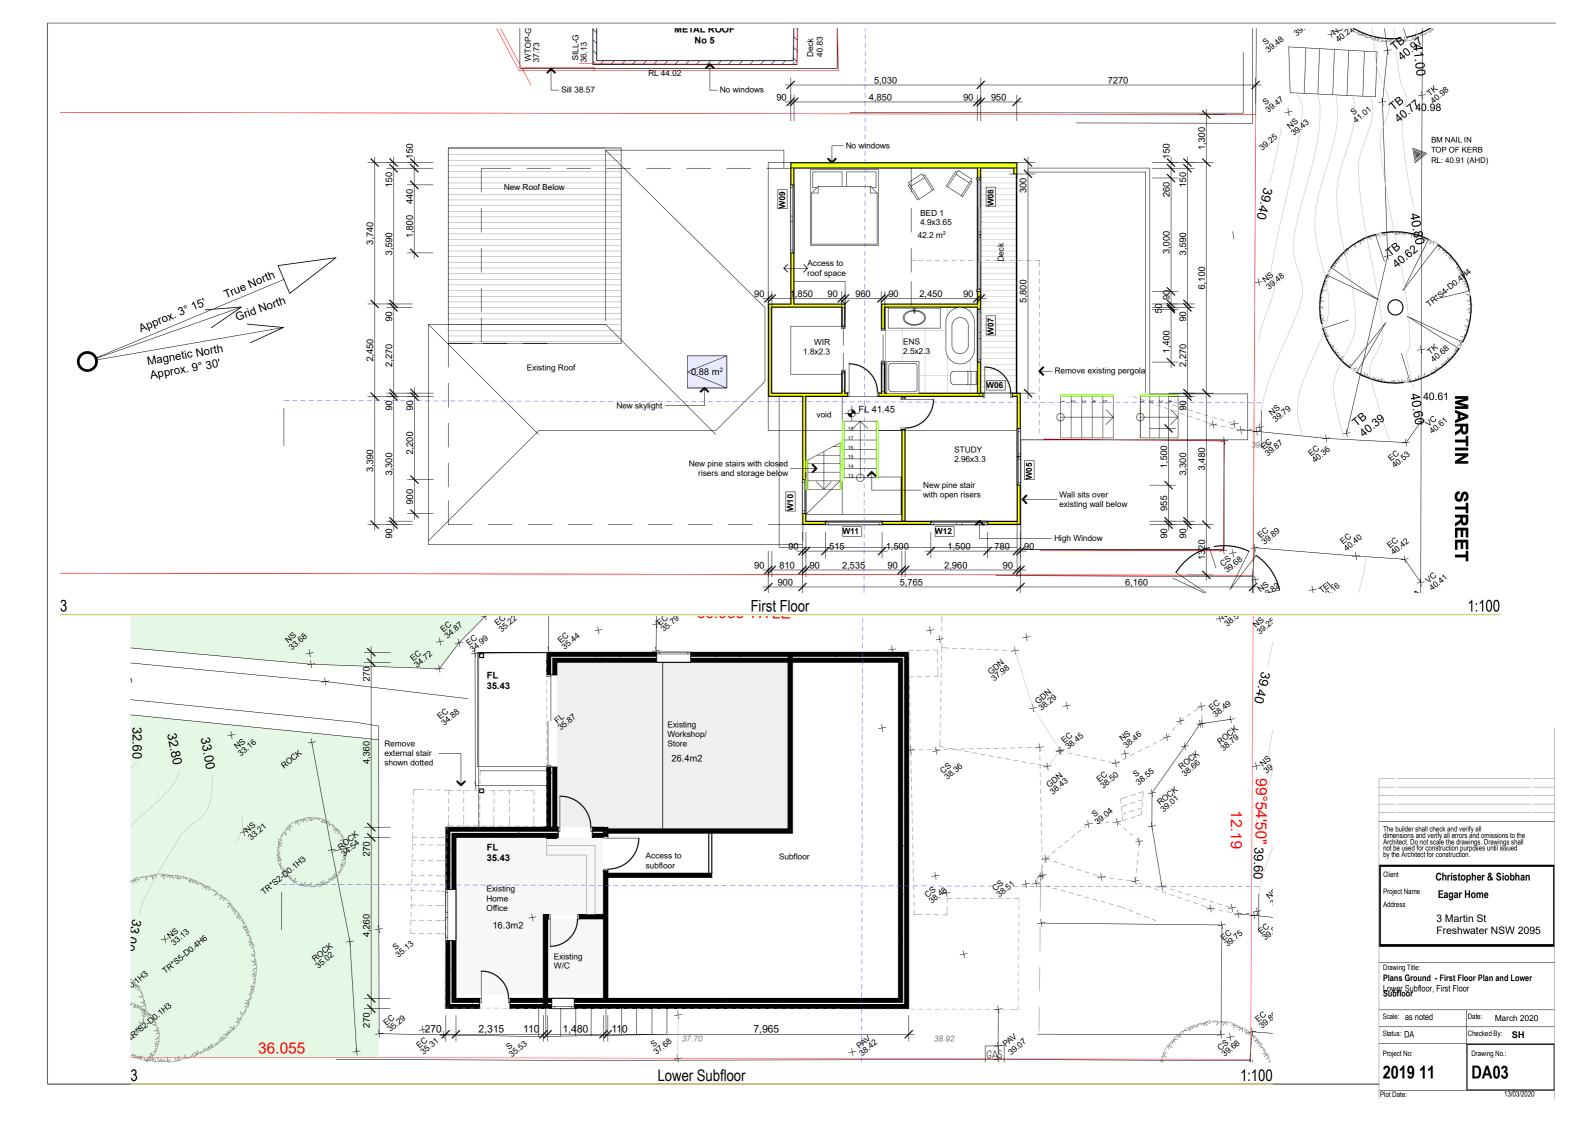

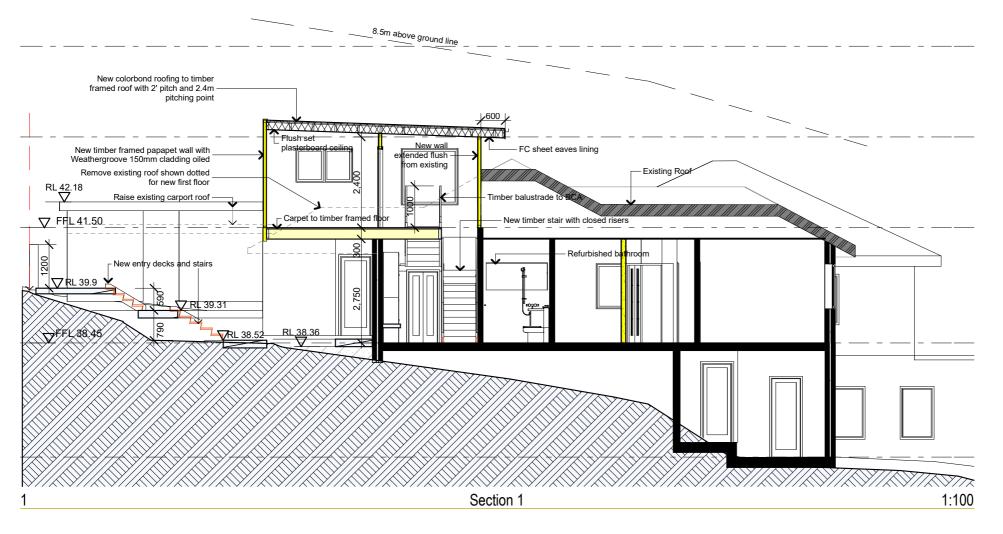

## 8.5m above Ground line — New colorbond roofing to timber - framed roof with 2.2m pitching point RI 44.93 and 8' pitch New colorbond roofing to timber framed roof with 8.00° roof blanket and R3 0 House at No.5 Raked ceiling New timber framed stair with equal risres New timber framed floor with sturctural flooring Timber framed parapet wall House at No.1 window flush Section 2 1:100

#### **BASIX CERTIFICATE A370228**

#### **Fixtures and Systems**

Lighting A minimum of 40% of new or atered lights will be LED lamps, fluorescent, or compact fluorescent

**Fixtures** New Showerheads, Flow Rate 9Ltrs/min or 3 Star New Taps, Flow Rate 9Ltrs/min or 3 Star New Toilets, Flow Rate 4Ltrs/flush or 3 Star

#### Construction

Insulation Requirements

Suspended Floor R0.8 External Walls R1.3, or R1.7 including Contruction Raked Ceiling, R2.24 and 55mm foil back blanket, Dark Colour SA 0.70 Flat Roof/ Ceiling, R2.08 and 55mm foil back blanket, Dark Colour SA 0.70

#### **Windows and Glazed Doors Powdercoated Aluminium**

W01, W02, 900mm eave, single clear U 7.63 SHGC 0.75 W03, 450mm eave, single clear U 7.63 SHGC 0.75 W04, 900mm eave, single clear U 7.63 SHGC 0.75 W05, 600mm eave, single toned U 7.57 SHGC 0.57 W06, W07, W08, 900mm eave, single clear U 7.63 SHGC 0.75 W09, W10, 600mm eave, single clear U 7.63 SHGC 0.75 W11, W12, 600mm eave, single toned U 7.57 SHGC 0.57

S01 - 0.85m2, timber, double clear, U 4.3, SHGC 0.5

The builder shall check and verify all dimensions and verify all errors and omissions to the Architect. Do not scale the drawings. Drawings shall not be used for construction purposes until issued by the Architect for construction.

Christopher & Siobhan Project Name Eagar Home

3 Martin St Freshwater NSW 2095

Drawing No.

**DA04** 

Scale: as noted Date: March 2020 Checked By: SH

Sections - Section 1 and Section 2

Project No:

Drawing Title:

2019 11

### New colorbond roofing to timber framed roof with 2.2m pitching point Timber framed parapet wall and 8' pitch with Weathertex cladding RL 44.93 Timber framed with New Aluminium doors with windows above 600mm deep sunhood rendered cladding 8.00 1,300 RL 44.02 House at No.5 **T** RL 43.25 **W05** 1.35 r New first floor blade with aluminium capping House at No.1 balustrade to 1m to Bo **▽FL** 41.50 North (Street) Elevation 1:100

#### Construction


Insulation Requirements


Suspended Floor R0.8
External Walls R1.3, or R1.7 including
Contruction
Raked Ceiling, R2.24 and 55mm foil
back blanket, Dark Colour SA 0.70
Flat Roof/ Ceiling, R2.08 and 55mm foil
back blanket, Dark Colour SA 0.70

#### Windows and Glazed Doors Powdercoated Aluminium

W01, W02, 900mm eave, single clear U 7.63 SHGC 0.75 W03, 450mm eave, single clear U 7.63 SHGC 0.75 W04, 900mm eave, single clear U 7.63 SHGC 0.75 W05, 600mm eave, single toned U 7.57 SHGC 0.57 W06, W07,W08, 900mm eave, single clear U 7.63 SHGC 0.75 W09, W10, 600mm eave, single clear U 7.63 SHGC 0.75 W11, W12, 600mm eave, single toned U 7.57 SHGC 0.57

S01 - 0.85m2, timber, double clear, U 4.3, SHGC 0.5

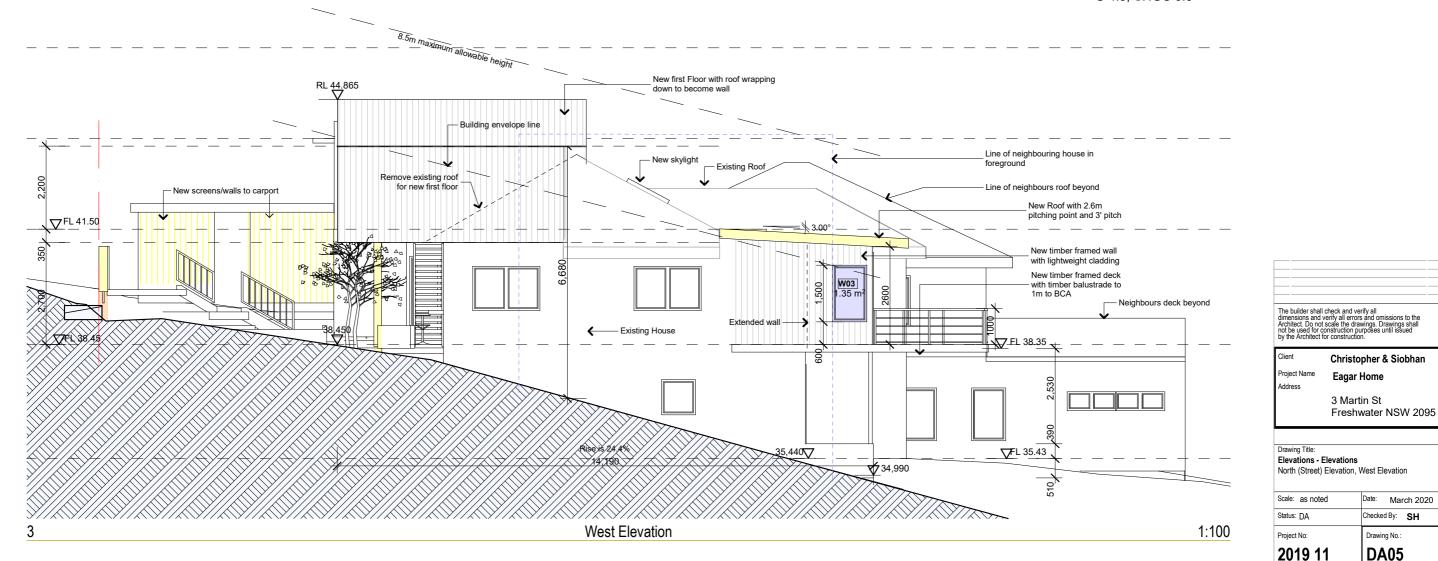

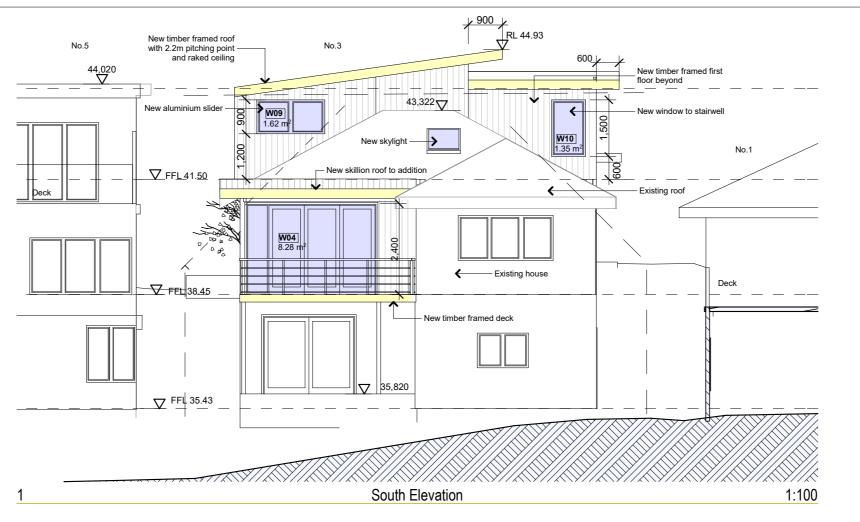

#### Construction

#### Insulation Requirements

Suspended Floor R0.8
External Walls R1.3, or R1.7 including Contruction
Raked Ceiling, R2.24 and 55mm foil back blanket, Dark Colour SA 0.70
Flat Roof/ Ceiling, R2.08 and 55mm foil back blanket, Dark Colour SA 0.70

# Windows and Glazed Doors Powdercoated Aluminium

W01, W02, 900mm eave, single clear U 7.63 SHGC 0.75 W03, 450mm eave, single clear U 7.63 SHGC 0.75 W04, 900mm eave, single clear U 7.63 SHGC 0.75 W05, 600mm eave, single toned U 7.57 SHGC 0.57 W06, W07,W08, 900mm eave, single clear U 7.63 SHGC 0.75 W09, W10, 600mm eave, single clear U 7.63 SHGC 0.75 W11, W12, 600mm eave, single toned U 7.57 SHGC 0.57

S01 - 0.85m2, timber, double clear, U 4.3, SHGC 0.5

The builder shall check and verify all dimensions and verify all errors and omissions to the Architect. Do not scale the drawings. Drawings shall not be used for construction purposes until issued by the Architect for construction.

Eagar Home
3 Martin St

Project Name

Drawing Title:
Elevations - Elevations

Scale: as noted

2019 11

Status: DA

Project No:

Christopher & Siobhan


Freshwater NSW 2095


Date: March 2020

Checked By: SH

Drawing No.

**DA06** 

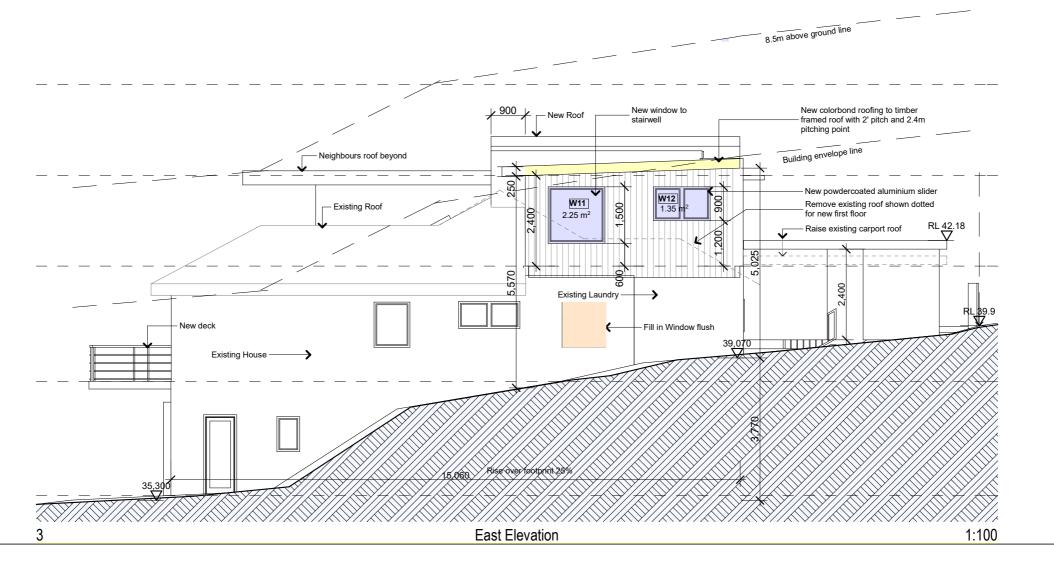

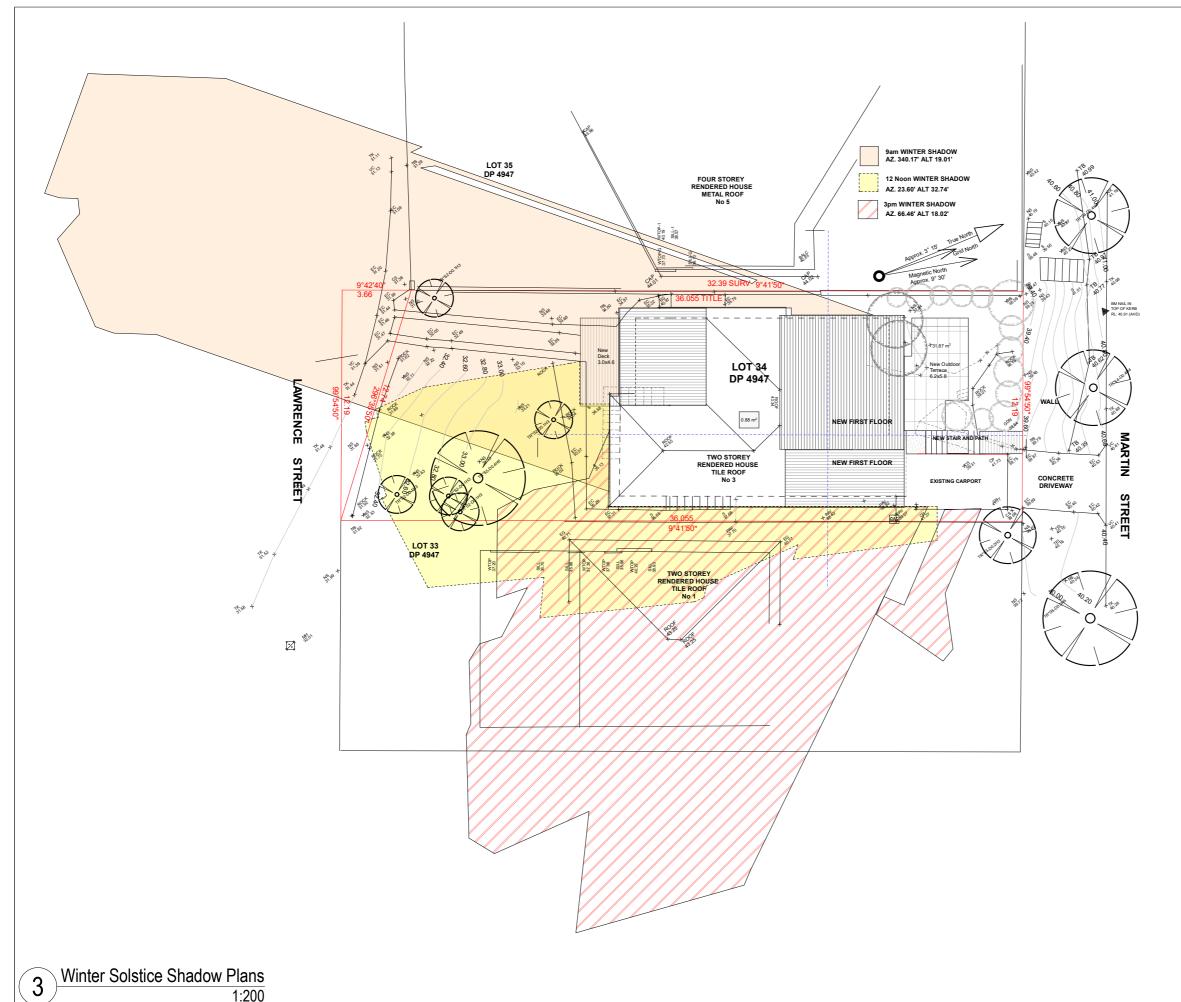

The builder shall check and verify all dimensions and verify all errors and omissions to the Architect. Do not scale the drawings. Drawings shall not be used for construction purposes until issued by the Architect for construction.

Christopher & Siobhan Eagar Home

3 Martin St Freshwater NSW 2095

Drawing Title:
Sections - Winter Shadow Diagrams Winter Solstice Shadow Plans

Scale: as noted Date: March 2020 Status: DA Checked By: SH Project No: Drawing No.:

2019 11

DA07

Plot Date:

1:200




External Finishes Schedule 3 Martin Street, Freshwater March 2020

Item	Description	Finish	Colour	lmage
Vertical Cladding	Weathergroove150 mm Natural from Weathertex	Olied	ТВА	
Timber Trims	Fascias, timber screens	Dulux super enamel	Resene Half Foundry N39- 006-259	
Doors and Windows	Aluminium external	Gloss	White	
Roof	Existing Tiles		Terracotta	
New Roof	Colorbond	Kliplok 700	Ironstone	
Gutters	Colorbond	Half Round	Ironstone	

Item	Description	Finish	Colour	Image
External Walls	Rendered brick or FC sheeting	Dulux Render refresh weathershield	Resene Designer White B90-009-260	
External Pavers/Tiles	TBS	Matt, anti slip	Concrete	
Lights	External	Stainless Steel	Charcoal	

## **Notes/Additional Items**


Enter Notes/Additional Items		

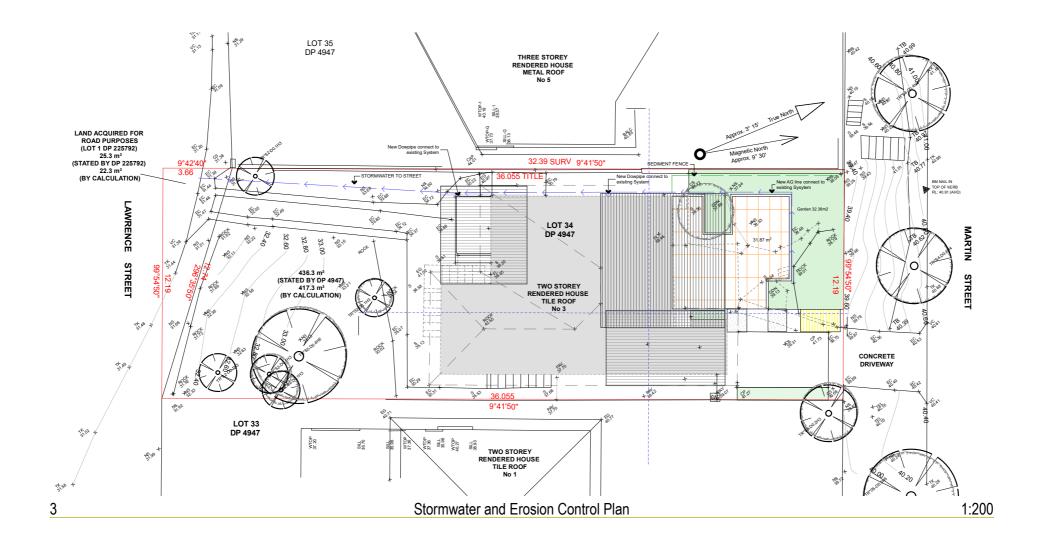

#### **Polution Prevention**

Use the following measures to prevent pollution on site;

- 1. restrict access to one stable entry and exit point
- 2.install and maintain adequate sediment and erosion controls
- 3. preserve grassed area and the maximum cover of natural vegetation by minimising the amount of land disturbed.
- ensure that stockpiles of sand, gravel, soil, and similar materials are located so that the material doesn't spill onto the road or pavement, wash into drainage lines, watercourses or depressions.
- 5. minimise on site vehicle activity during wet weather
- 6. Do not pump or allow any unclean water to enter the stormwater system from excess materials or cleaning tools.
- 7. Sediment fences are to be laid along the contour as much as possible and are to be of suitable geotextile fabric and supported every three metres with star pickets and a lower trench depth of 150mm

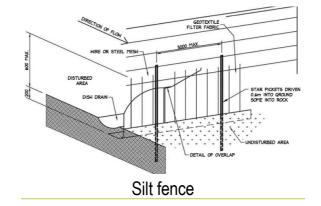

The builder shall check and verify all dimensions and verify all errors and omissions to the Architect. Do not scale the drawings. Drawings shall not be used for construction purposes until issued by the Architect for construction.

Client	Christopher & Siobhar
Project Name Address	Eagar Home

3 Martin St Freshwater NSW 2095

Drawing Title:
Plans Ground - Stormwater and Erosion Plan
Stormwater and Erosion Control Plan, polution, Silt

Project No: 2019 11	Drawing No.:
	Checked By: SH
do notou	Date: March 2020

Plot Date: 16/03/2020