

SITE FEATURES	AREA
EXISTING FLOOR	108 sq m
PROPOSED GF	0 sq m
PROPOSED FF	85 sq m
PRIVATE OPEN SPACE	176 sq m
LANDSCAPE AREA HARD	145 sq m
LANDSCAPE AREA SOFT	153 sq m
TOTAL SITE	484 sq m

Raise the Roof
E info@raisetheroof.com.au


REVISION: DATE:

E info@raisetheroot.com.au

Drawn by:
Inlet Design Studio
E inletdesigns@gmail.com

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CLIENT:	DRAWING:	DRAWN:	SHEET NO:
Mr and Mrs Wellard	Site Plan	AJ	A01
ADDRESS:	PROJECT: ALTERATIONS AND ADDITIONS		SCALE @ A3: 1:200
13 Sterland Ave, NORTH MANLY	PROJECT NO: ISSUE TYPE: STE005	ISSUE DATE: 01/4/20	REVISION:

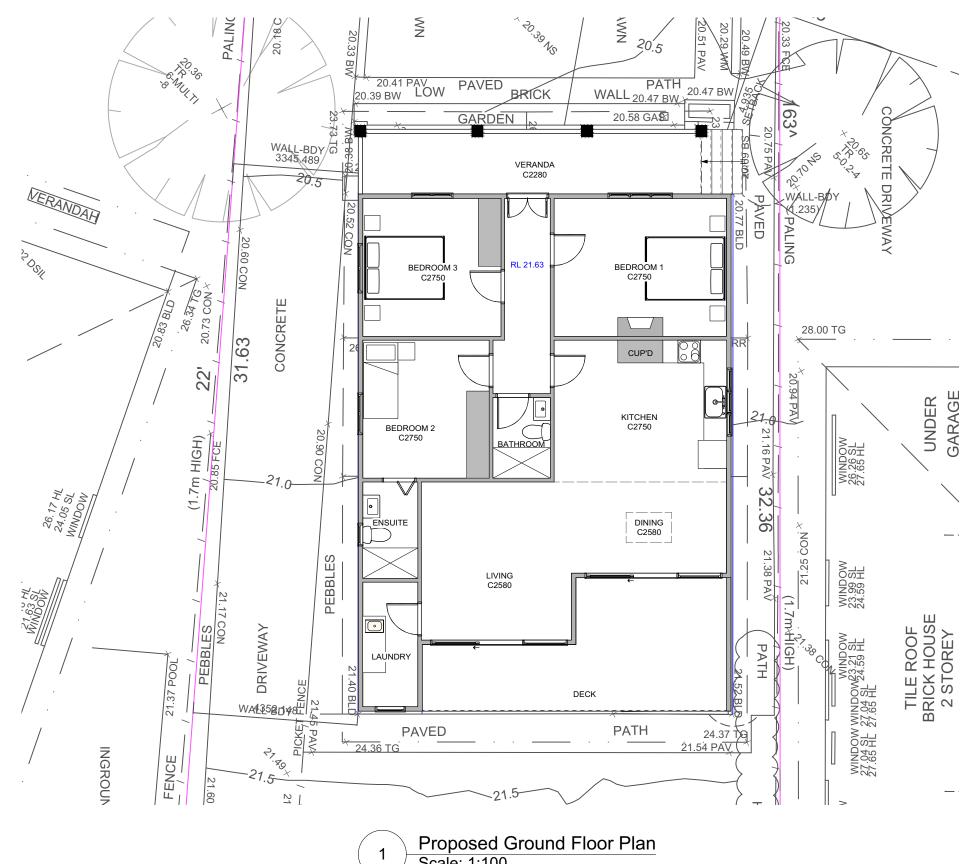

EXISTING FLOOR AREA 108 SQM

Proposed Ground Floor Plan Scale: 1:100

	Designed by:
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RAISE THE ROOF	Drawn by: Inlet Design Studio E inletdesigns@gmail.com

REVISION: DATE:

REVISION NOTE:

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	CLIENT:	DRAWING:	DRAWN:	SHEET NO:
	Mr and Mrs Wellard	Existing Ground Floor Plan	AJ	A02
		PROJECT: ALTERATIONS AND ADDITIONS		SCALE @ A3: 1:100
	13 Sterland Ave, NORTH MANLY	PROJECT NO: ISSUE TYPE: STE005	ISSUE DATE: 01/4/20	REVISION:



<u>Material</u>	Colour on Plans
Timber	Yellow
Demolition	Orange
Roof Tiles	Light Red
Paving (tiles, terracota)	Light Red
Internal Tiles	Purple
Brick	Red
Steel - galvanized iron	Dark Blue
Aluminium	Dark Blue
Glass and Glass bricks	Light Blue
Concrete	Dark Green
Fibre cement sheets / cement render	Light Green
Sandstone and other natural stone	Light Green
Earth	Light Brown
Marble	Mauve
Bituminous Products	Grey

LIGHTING


The applicant must ensure a minimum of 40% of new or altered light fixtures are fitted with fluorescent, compact fluorescent, or light-emitting-diode (LED) lamps.

FIXTURES


The applicant must ensure new or altered showerheads have a flow rate no greater than 9 litres per minute or a 3 star water rating.


The applicant must ensure new or altered toilets have a flow rate no greater than 4 litres per average flush or a minimum 3 star water rating.

The applicant must ensure new or altered taps have a flow rate no greater than 9 litres per minute or minimum 3 star water rating.

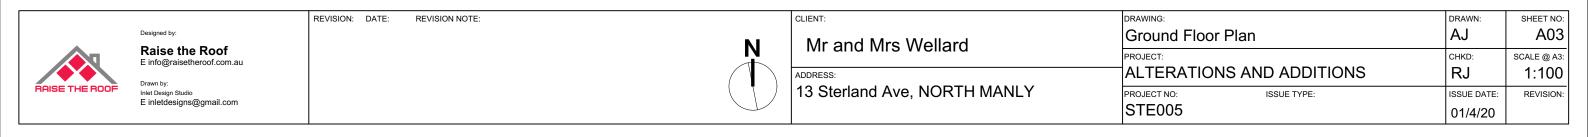


<u>Material</u>	Colour on Plans		
Timber	Yellow		
Demolition	Orange		
Roof Tiles	Light Red		
Paving (tiles, terracota)	Light Red		
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Steel - galvanized iron	Dark Blue		
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Fibre cement sheets / cement render	Light Green		
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Marble	Mauve		
Bituminous Products	Grey		

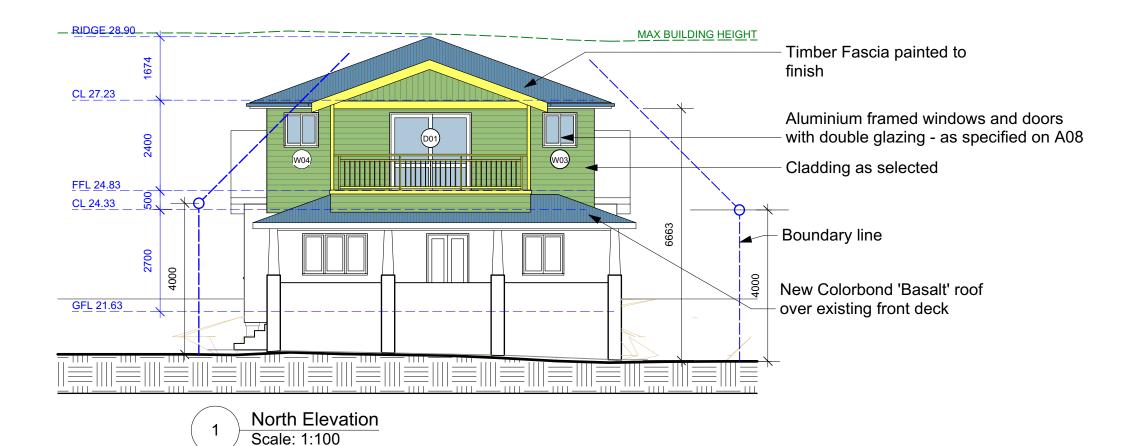


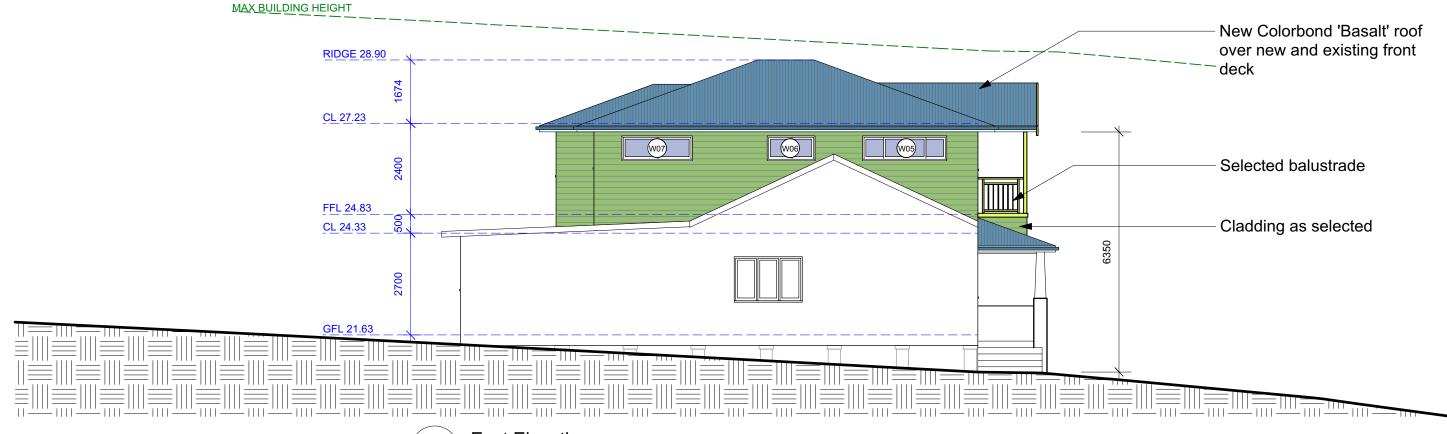

2 East Elevation
Scale: 1:100

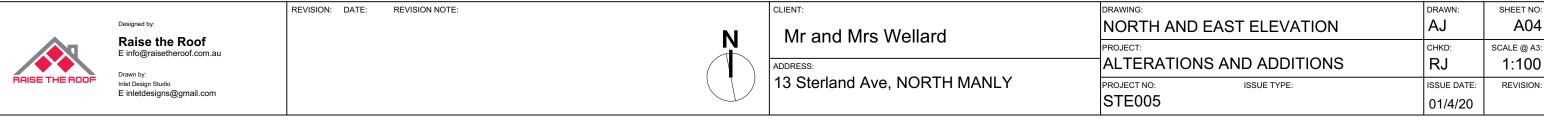



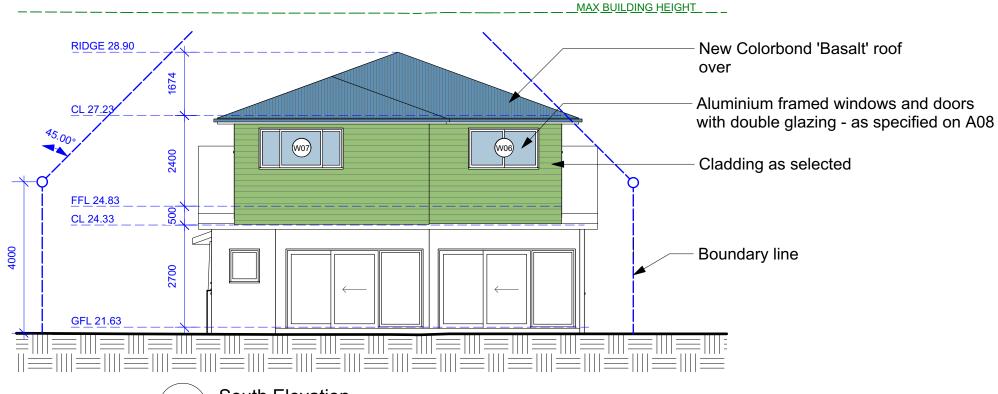

South Elevation
Scale: 1:100

New Colorbond 'Basalt' roof over

CL7723

Cladding as selected


Cladding as selected

Aluminium framed window with Low-e glazing - as specified on A08

GFL2183

2 West Elevation
Scale: 1:100

MAX BUILDING HEIGHT

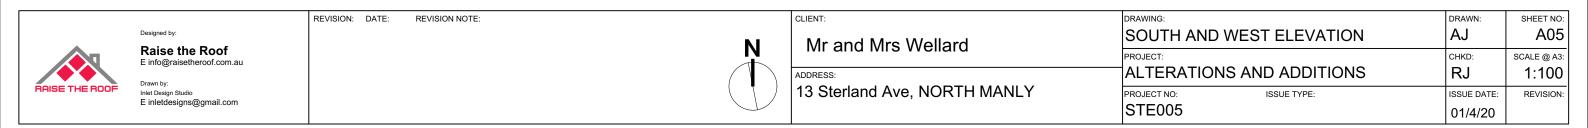



BASIX Certificate

Building Sustainability Index www.basix.nsw.gov.au

Alterations and Additions

Certificate number: A373458_02

This certificate confirms that the proposed development will meet the NSW government's requirements for sustainability, if it is built in accordance with the commitments set out below. Terms used in this certificate, or in the commitments, have the meaning given by the document entitled "BASIX Alterations and Additions Definitions" dated 06/10/2017 published by the Department. This document is available at www.basix.nsw.org.au.

Project name	13 Sterland_02
Street address	13 Sterland Avenue North Manly 2100
Local Government Area	Northern Beaches Council
Plan type and number	Deposited Plan 331035
Lot number	A
Section number	
Project type	
Dwelling type	Separate dwelling house
Type of alteration and addition	My renovation work is valued at \$50,000 or more and does not include a pool (and/or spa).

Certificate Prepared by (please complete before submitting to Council or PCA) Name / Company Name: Jacaranda Trading International Pty Ltd ABN (if applicable): 26075061335

REVISION: DATE:

REVISION NOTE:

BASIX Certificate number: A373458

Fixtures and systems	Show on DA Plans	Show on CC/CDC Plans & specs	Certifier Check
Lighting			
The applicant must ensure a minimum of 40% of new or altered light fixtures are fitted with fluorescent, compact fluorescent, or light-emitting-diode (LED) lamps.		~	~
Fixtures			
The applicant must ensure new or altered showerheads have a flow rate no greater than 9 litres per minute or a 3 star water rating.		V	V
The applicant must ensure new or altered toilets have a flow rate no greater than 4 litres per average flush or a minimum 3 star water rating.		V	V
The applicant must ensure new or altered taps have a flow rate no greater than 9 litres per minute or minimum 3 star water rating.		V	

Construction	Show on DA Plans	Show on CC/CDC Plans & specs	Certifier Check		
nsulation requirements					
	d construction (floor(s), walls, and ceilings/roofs) tion is not required where the area of new const where insulation already exists.		✓	V	✓
Construction	Additional insulation required (R-value)	Other specifications			
floor above existing dwelling or building.	nil				
external wall: framed (weatherboard, fibro, metal clad)	R1.30 (or R1.70 including construction)				
flat ceiling, pitched roof	ceiling: R1.45 (up), roof: foil backed blanket (55 mm)	medium (solar absorptance 0.475 - 0.70)			

BASIX Certificate number: A373458_02

Glazing requi	irements						Show on DA Plans	Show on CC/CDC Plans & specs	Certifier Check
Windows and	glazed do	ors							
					nading devices, in accordance with reach window and glazed door.	the specifications listed in the table below.	✓	✓	~
The following re	equirements r	nust also	be satisf	ed in relation	n to each window and glazed door:			✓	✓
have a U-value must be calcula	and a Solar l	Heat Gair lance with	n Coeffici n Nationa	ent (SHGC) i Fenestratio	no greater than that listed in the tab n Rating Council (NFRC) conditions	ear glazing, or toned/air gap/clear glazing must le below. Total system U-values and SHGCs s. The description is provided for information		~	✓
	by. Alternative systems with complying U-value and SHGC may be substituted. r projections described in millimetres, the leading edge of each eave, pergola, verandah, balcony or awning must be no more than 50 ove the head of the window or glazed door and no more than 2400 mm above the sill. rgolas with polycarbonate roof or similar translucent material must have a shading coefficient of less than 0.35.						✓	✓	✓
Pergolas with p	olycarbonate	roof or s	imilar trar	slucent mate	erial must have a shading coefficien	nt of less than 0.35.		✓	~
	regolas with fixed battens must have battens parallel to the window or glazed door above which they are situated, unless the pergola also nades a perpendicular window. The spacing between battens must not be more than 50 mm.							✓	✓
Overshadowing specified in the	buildings or 'overshadow	vegetatio	n must b	e of the heigh	nt and distance from the centre and	the base of the window and glazed door, as	~	~	✓
Windows an	d glazed o	loors a	lazing r	equireme	nts				
Window / door no.			Oversha Height (m)		Shading device	Frame and glass type			
W1	w	0.49	3.2	5.5	none	standard aluminium, single pyrolytic low-e, (U-value: 5.7, SHGC: 0.47)			
W2	w	1.28	2.07	5.5	eave/verandah/pergola/balcony >=600 mm	standard aluminium, clear/air gap/clear, (U-value: 5.34, SHGC: 0.67)			
W3	N	0.49	9.1	6.5	eave/verandah/pergola/balcony >=450 mm	standard aluminium, clear/air gap/clear, (U-value: 5.34, SHGC: 0.67)			
W4	N	0.49	9.1	5	eave/verandah/pergola/balcony	standard aluminium, clear/air gap/clear,	1		1

Planning, Industry & Environment Building Sustainability Index www.basix.nsw.gov.au **INSULATION REQUIREMENTS**

The applicant must construct the new or altered construction (floor(s), walls, and ceilings/roofs) in accordance with the specifications listed in the table below, except

a) additional insulation is not required where the area of new construction is less than 2m2,

b) insulation specified is not required for parts of altered construction where insulation already exists.

						Show on DA Plans	Show on CC/CDC Plans & specs	Certifier Check	
Window / door no.	Orientation	Area of glass inc. frame (m2)	Oversha Height (m)	dowing Distance (m)	Shading device	Frame and glass type			
					>=450 mm	(U-value: 5.34, SHGC: 0.67)			
W5	E	0.9	0	0	eave/verandah/pergola/balcony >=450 mm	standard aluminium, clear/air gap/clear, (U-value: 5.34, SHGC: 0.67)			
W6	E	0.48	2	2.5	eave/verandah/pergola/balcony >=450 mm	standard aluminium, clear/air gap/clear, (U-value: 5.34, SHGC: 0.67)			
W7	E	0.75	2	2.5	eave/verandah/pergola/balcony >=450 mm	standard aluminium, clear/air gap/clear, (U-value: 5.34, SHGC: 0.67)			
W8	S	1.46	0	0	eave/verandah/pergola/balcony >=450 mm	standard aluminium, clear/air gap/clear, (U-value: 5.34, SHGC: 0.67)			
W9	S	1.74	0	0	eave/verandah/pergola/balcony >=450 mm	standard aluminium, clear/air gap/clear, (U-value: 5.34, SHGC: 0.67)			
W10	W	0.75	0.1	6	eave/verandah/pergola/balcony >=450 mm	standard aluminium, clear/air gap/clear, (U-value: 5.34, SHGC: 0.67)			
D01	N	2.17	8	6	eave/verandah/pergola/balcony >=900 mm	standard aluminium, clear/air gap/clear, (U-value: 5.34, SHGC: 0.67)			


Legend
In these commitments, "applicant" means the person carrying out the development.
Commitments identified with a "v/" in the "Show on DA plans" column must be shown on the plans accompanying the development application for the proposed development (if a development application is to be lodged for the proposed development).
Commitments identified with a "\" in the "Show on CC/CDC plans & specs" column must be shown in the plans and specifications accompanying the application for a construction certificate / complying development certificate for the proposed development.
Commitments identified with a "\forall" in the "Certifier check" column must be certified by a certifying authority as having been fulfilled, before a final occupation certificate for the development may be issued.


Raise the Roof

Inlet Design Studio
E inletdesigns@gmail.com

CLIENT:
Mr and Mrs
ADDRESS:
13 Sterland Ave

Γ:	DRAWING:	DRAWN:	SHEET NO:
r and Mrs Wellard	SECTION	AJ	A06
	PROJECT:	CHKD:	SCALE @ A3:
ESS:	ALTERATIONS AND ADDITIONS	RJ	1:100
Sterland Ave, NORTH MANLY	PROJECT NO: ISSUE TYPE:	ISSUE DATE:	REVISION:
	STE005	01/4/20	

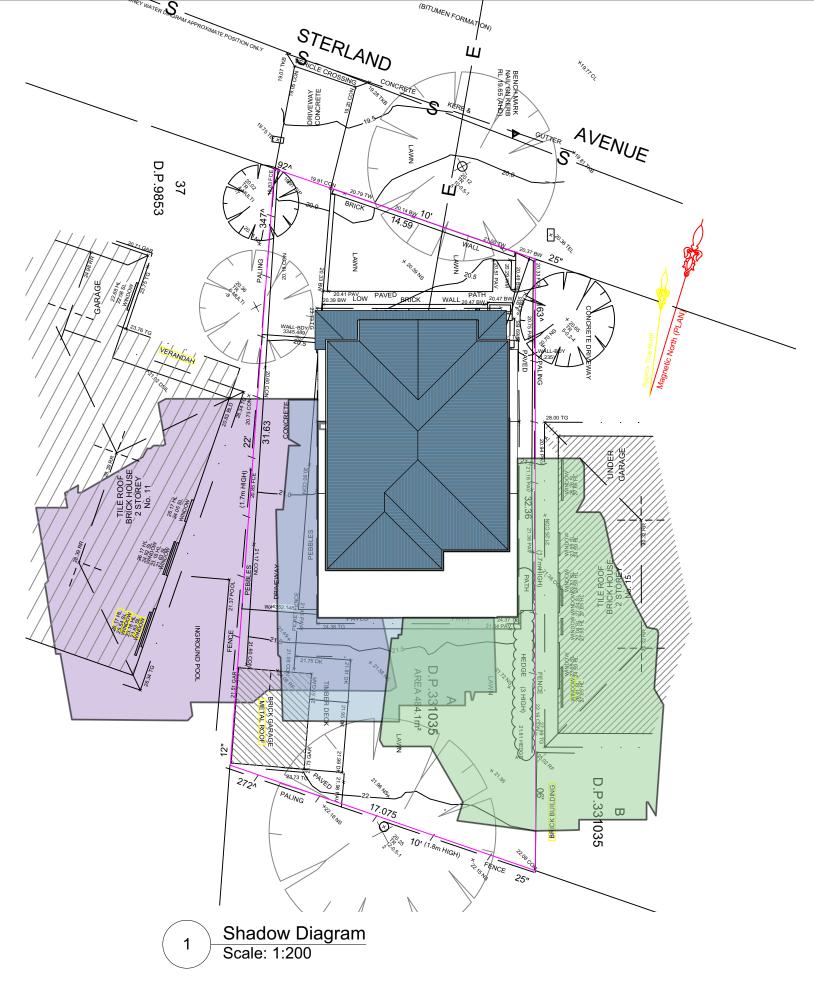

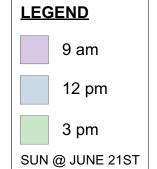

POISE THE BOOK

Raise the Roof
E info@raisetheroof.com.au

Drawn by: Inlet Design Studio E inletdesigns@gmail.com REVISION: DATE: REVISION NOTE:

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	CLIENT:	DRAWING:	DRAWN:	SHEET NO
Mr and M	Mr and Mrs Wellard	SHADOW DIAGRAM	AJ	A07
	IVII aria ivii 5 vveilara	PROJECT:	CHKD:	SCALE @ A3
		ALTERATIONS AND ADDITIONS	RJ	1:200
	13 Sterland Ave, NORTH MANLY	PROJECT NO: ISSUE TYPE:	ISSUE DATE:	REVISION
		STE005	01/4/20	

Windows											ı			
Image	ID	Туре	Frame Height	Frame Width	RO Height	RO Width	Glazed Area	Material	Manufacturer	Model	Screen	Egress	Glazing	Orientation
	W01	Sliding Left Window	920	910	960	950	0.49	Aluminium					Double Glaz.	w
Ų	W02	Sliding Pair 1/4 Window	660	3070	700	3110	1.28	Aluminium					Double Glaz.	w
	W03	Sliding Left Window	920	910	960	950	0.49	Aluminium					Double Glaz.	N
	W04	Sliding Right Window	920	910	960	950	0.49	Aluminium					Double Glaz.	N
	W05	Sliding Pair 1/4 Window	660	2230	700	2270	0.90	Aluminium					Double Glaz.	E
	W06	Sliding Left Window	660	1270	700	1310	0.48	Aluminium					Double Glaz.	E
	W07	Sliding Left Window	660	1870	700	1910	0.75	Aluminium					Double Glaz.	E
	W08	Sliding Left Window	1090	1870	1130	1910	1.46	Aluminium					Double Glaz.	S
	W09	Sliding Pair 1/4 Window	1090	2230	1130	2270	1.74	Aluminium					Double Glaz.	w
	W10	Sliding Left Window	660	1870	700	1910	0.75	Aluminium					Double Glaz.	S
Doors														
Image	ID	Туре	Head Height	Leaf Width	Thickne ss	RO Height	RO Width	Glazed Area	Material	Manuf.	Model	Screen	Glazing	Orientation
	D01	Half Glazed	2100	1095		2100	2170	2.17	Aluminium			Numiniur	Double Glaz.	N

WINDOWS AND GLAZED DOORS

The applicant must install the windows, glazed doors and shading devices, in accordance with the specifications listed in the table below.Relevant overshadowing specifications must be satisfied for each window and glazed door. The following requirements must also be satisfied in relation to each window and glazed door:

- Each window or glazed door with improved frames, or pyrolytic low-e glass, or clear/air gap/clear glazing, or toned/air gap/clear glazing musthave a U-value and a Solar Heat Gain Coefficient (SHGC) no greater than that listed in the table below. Total system U-values and SHGCs must be calculated in accordance with National Fenestration Rating Council (NFRC) conditions. The description is provided for information only. Alternative systems with complying U-value and SHGC may be substituted.
- For projections described in millimetres, the leading edge of each eave, pergola, verandah, balcony or awning must be no more than 500 mm above the head of the window or glazed door and no more than 2400 mm above the sill.
- Pergolas with polycarbonate roof or similar translucent material must have a shading coefficient of less than 0.35.
- Pergolas with fixed battens must have battens parallel to the window or glazed door above which they are situated, unless the pergola also shades a perpendicular window. The spacing between battens must not be more than 50 mm.
- Overshadowing buildings or vegetation must be of the height and distance from the centre and the base of the window and glazed door, as specified in the 'overshadowing' column in the table below.

BRISE THE ROOF

Designed by:

Raise the Roof
E info@raisetheroof.com.au

Drawn by:
Ideal Design Studio.


E inletdesigns@gmail.com


REVISION: DATE: REVISION NOTE:




CLIENT:	DR
Mr and Mrs Wellard	٧
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ADDRESS:	Α
13 Sterland Ave, NORTH MANLY	PR


DRAWING:		DRAWN:	SHEET NO:
WINDOW DOO	R SCHEDULE	AJ	A08
PROJECT:		CHKD:	SCALE @ A3:
ALTERATIONS	AND ADDITIONS	RJ	1:200
PROJECT NO:	ISSUE TYPE:	ISSUE DATE:	REVISION:
STE005		01/4/20	

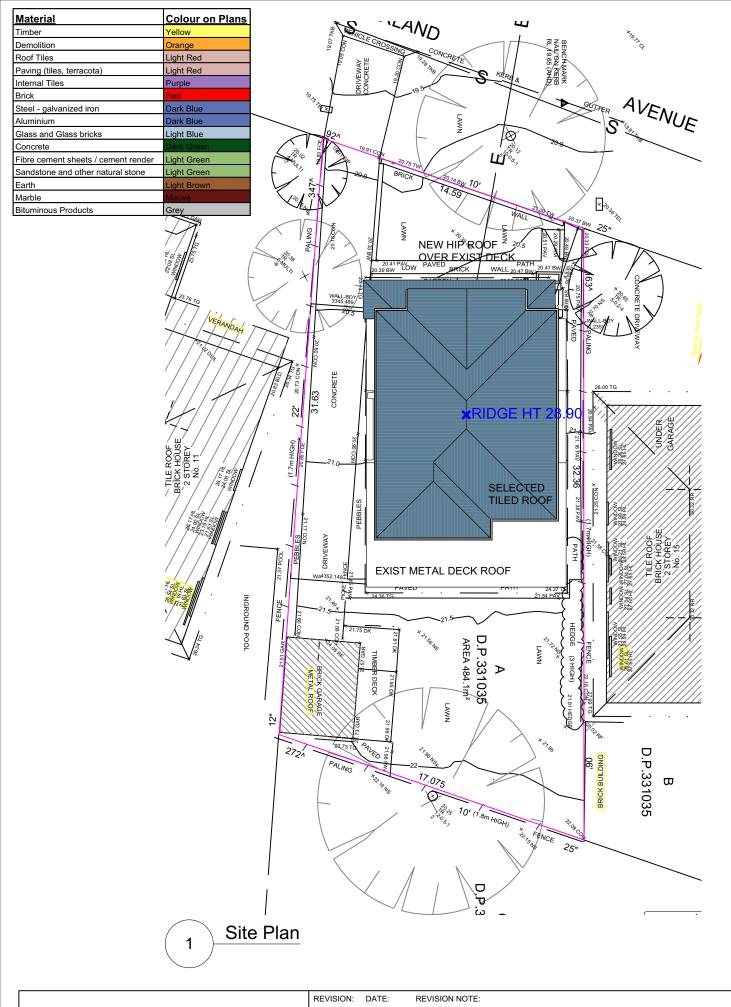

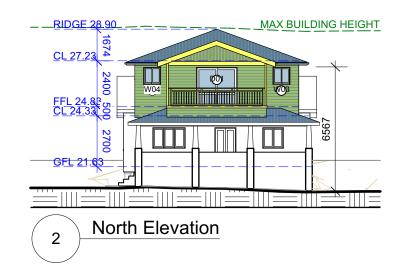



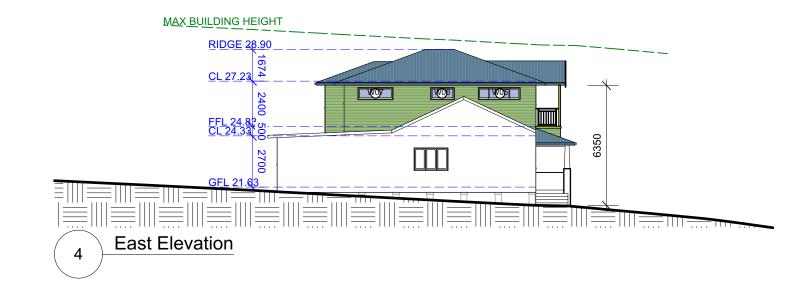

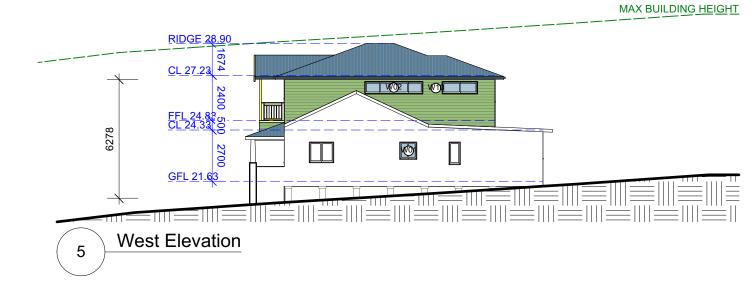



Raise the Roof
E info@raisetheroof.com.au

Drawn by: Inlet Design Studio E inletdesigns@gmail.com



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CLIENT:	DRAWING:	DRAWN:	SHEET NO:
Mr and Mrs Wellard	Notification Plan	AJ	NA01
ADDRESS:	PROJECT: ALTERATIONS AND ADDITIONS	снко: RJ	SCALE @ A3:
13 Sterland Ave, NORTH MANLY	PROJECT NO: ISSUE TYPE: STE005	1SSUE DATE: 01/4/20	REVISION: