RALSTON ROAD PALM BEACH LOT 4 / LOT 5 DP 14048, 26 RALSTON ROAD, PALM BEACH NSW 2108

DRAWING SCHEDULE

COVER SHEET
EXISTING SITE PLAN
SITE PLAN
LOWER GROUND FLOOR PLAN
GROUND FLOOR PLAN
FIRST FLOOR PLAN
ROOF PLAN
ELEVATIONS - SHEET 01
ELEVATIONS - SHEET 02
ELEVATIONS - SHEET 03
SECTIONS

BASIX Certificate Building Sustainability Index www.basix.nsw.gov.au


Single Dwelling

Certificate number: 1065040S

This certificate confirms that the proposed development will meet the NSW government's requirements for sustainability, if it is built in accordance with the commitments set out below. Terms used in this certificate, or in the commitments, have the meaning given by the document entitled "BASIX Definitions" dated 06/10/2017 published by the Department. This document is available at www.basix.nsw.gov.au

Secretary Date of issue: Monday, 23 December 2019 To be valid, this certificate must be lodged within 3 months of the date of issue.

NSW | Planning, Industry & Environment

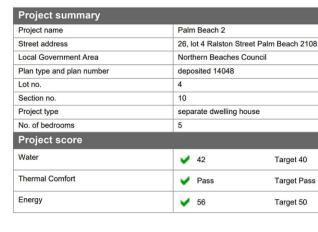

Certificate Prepared by Name / Company Name: Integreco Consulting Pty Ltd ABN (if applicable): 42630013008

essor details and thermal loads

Area adjusted cooling load (MJ/m².year) 24 Area adjusted heating load (MJ/m².year) 40

Assessor number Certificate number

Climate zone

Thermal Comfort

Water

Energy

39.0 square metres

ject score

BDAV/19/1921

0004495610-01

42

🧹 56

V Pass

Project address	
Project name	Palm Beach 2
Street address	26, lot 4 Ralston Street Palm Beach 2108
Local Government Area	Northern Beaches Council
Plan type and plan number	Deposited Plan 14048
Lot no.	4
Section no.	10
Project type	
Project type	separate dwelling house
No. of bedrooms	5
Site details	
Site area (m²)	732
Roof area (m²)	184
Conditioned floor area (m2)	236.0
Unconditioned floor area (m2)	8.0
Total area of garden and lawn (m2)	320

Water Commitments		on CC/CDC & specs	Energy Commitments	Show on CC/CE plans & specs
Landscape			Hot water	
The applicant must plant indigenous or low water use species of vegetation throughout 100 square metres of the site.		~	The applicant must install the following hot water system in the development, or a system with a higher energy rating: gas instantaneous with a performance of 5 stars.	~
Fixtures			Cooling system	
The applicant must install showerheads with a minimum rating of 4 star (> 6 but <= 7.5 L/min plus spray force all showers in the development.	and/or coverage tests) in	~	The applicant must install the following cooling system, or a system with a higher energy rating, in at least 1 living area: 1-phase airconditioning; Energy rating: 2 Star (old label)	~
The applicant must install a toilet flushing system with a minimum rating of 4 star in each toilet in the developm	nent.	~	The applicant must install the following cooling system, or a system with a higher energy rating, in at least 1 bedroom: 1-phase airconditioning; Energy rating: 2 Star (old label)	~
he applicant must install taps with a minimum rating of 5 star in the kitchen in the development.		~	Heating system	
he applicant must install basin taps with a minimum rating of 5 star in each bathroom in the development.		~	The applicant must install the following heating system, or a system with a higher energy rating, in at least 1 living area: 1-phase airconditioning; Energy rating: 2 Star (old label)	~
Alternative water			The applicant must install the following heating system, or a system with a higher energy rating, in at least 1 bedroom: 1-phase airconditioning; Energy rating: 2 Star (old label)	~
ainwater tank			Ventilation	
The applicant must install a rainwater tank of at least 3000 litres on the site. This rainwater tank must meet, an accordance with, the requirements of all applicable regulatory authorities.	nd be installed in	~	The applicant must install the following exhaust systems in the development:	
The applicant must configure the rainwater tank to collect rain runoff from at least 184 square metres of the ro levelopment (excluding the area of the roof which drains to any stormwater tank or private dam).	of area of the	-	At least 1 Bathroom: individual fan, ducted to façade or roof; Operation control: manual switch on/off	~
The applicant must connect the rainwater tank to:			Kitchen: individual fan, ducted to façade or roof; Operation control: manual switch on/off	~
the cold water tap that supplies each clothes washer in the development		~	Laundry: individual fan, ducted to façade or roof; Operation control: manual switch on/off	
 at least one outdoor tap in the development (Note: NSW Health does not recommend that rainwater be use consumption in areas with potable water supply.) 	ed for human	~	Artificial lighting	
a tap that is located within 10 metres of the swimming pool in the development		~	The applicant must ensure that the "primary type of artificial lighting" is fluorescent or light emitting diode (LED) lighting in each of the following rooms, and where the word "dedicated" appears, the fittings for those lights must only be capable of accepting fluorescent or light emitting diode (LED) lamps:	
Swimming pool			at least 4 of the bedrooms / study; dedicated	
Water Commitments		on CC/CDC	 at least 3 of the living / dining rooms; dedicated 	~
		& specs	• at least 3 of the living / dining rooms; dedicated	~
The swimming pool must not have a volume greater than 20 kilolitres.		~	the kitchen; dedicated	
The swimming pool must be outdoors.		~	all bathrooms/toilets; dedicated	~
			the laundry; dedicated	
Thermal Comfort Commitments		on CC/CDC & specs	all hallways; dedicated	L L
Simulation Method			Network Belder	•
The applicant must attach the certificate referred to under "Assessor Details" on the front page of this BASIX of			Natural lighting	
retrificate") to the development application and construction certificate application for the proposed developm pplying for a complying development certificate for the proposed development, to that application). The applic sessor Certificate to the application for an occupation certificate for the proposed development.			The applicant must install a window and/or skylight in the kitchen of the dwelling for natural lighting.	~
he Assessor Certificate must have been issued by an Accredited Assessor in accordance with the Thermal C	Comfort Protocol.		The applicant must install a window and/or skylight in 3 bathroom(s)/toilet(s) in the development for natural lighting.	
The details of the proposed development on the Assessor Certificate must be consistent with the details shown in this BASIX			Swimming pool	
certificate, including the Cooling and Heating loads shown on the front page of this certificate. The applicant must show on the plans accompanying the development application for the proposed development, all matters which the			The applicant must install the following heating system for the swimming pool in the development (or alternatively must not install any heating system for the swimming pool): solar only	~
Assessor Certificate requires to be shown on those plans. Those plans must bear a stamp of endorsement from the Accredited Assessor to certify that this is the case. The applicant must show on the plans accompanying the application for a construction certificate (or complying development certificate, if applicable), all thermal performance specifications set out in the Assessor		`	The applicant must install a timer for the swimming pool pump in the development.	~
certificate, and all aspects of the proposed development which were used to calculate those specifications.	ut in the Assesser		Alternative energy	
The applicant must construct the development in accordance with all thermal performance specifications set out in the Assessor Certificate, and in accordance with those aspects of the development application or application for a complying development certificate which were used to calculate those specifications.		~	The applicant must install a photovoltaic system with the capacity to generate at least 1 peak kilowatts of electricity as part of the development. The applicant must connect this system to the development's electrical system.	~
Where there is an in-slab heating or cooling system, the applicant must install insulation with an R-value of not less than 1.0 around the		~	Other	
artical addee at the perimeter of the slab, and underneath the slab if it is a suspended fleer		•	The applicant must install a gas cooktop & electric oven in the kitchen of the dwelling.	~
ertical edges of the perimeter of the slab, and underneath the slab if it is a suspended floor. he applicant must construct the floors and walls of the dwelling in accordance with the specifications listed in	the table below.			
	the table below.	 	The applicant must install a fixed outdoor clothes drying line as part of the development.	
• · · · ·	the table below.	~	The applicant must install a fixed outdoor clothes drying line as part of the development.	~

	ALL DIMENSIONS & LEVELS TO BE CHECKED ON SITE BY CONTRACTOR PRIOR TO CONSTRUCTION. ALL BOUNDARIES & CONTOURS SUBJECT TO SURVEY. ALL RIGHTS RESERVED. THIS DRAWING MAY NOT BE REPRODUCED OR TRANSMITTED, IN PART OR IN WHOLE WITHOUT THE PERMISSION OF CRAWFORD ARCHITECTS PTY LTD	© CRAWFORD ARCHITECTS PTY LTD 2019 SUITE 3.01, LEVEL 3 80 MOUNT STREET NORTH SYDNEY, NSW 2060 AUSTRALIA ABN 56 120 779 106 NOMINATED ARCHITECTS: TONY GRAY 5303 & PAUL GODSELL 6726				TONY & GEORGINA NASSIF
			В	24.09.19	S4.55 ISSUE	
	THIS DRAWING IS NOT TO BE USED FOR CONSTRUCTION UNLESS	P 02 9660 3644 www.crawford.com.au	А	24.07.17	S4.55 ISSUE	
_	APPROVED BY A DIRECTOR OF CRAWFORD ARCHITECTS PTY LTD	E arch@crawford.com.au	ISSUE	DATE	AMENDMENTS	

floor - suspended floor/open subfloor



BASIX Certificate Building Sustainability Index www.basix.nsw.gov.au

Single Dwelling

Certificate number: 1065036S This certificate confirms that the proposed development will meet the NSW

nus cerunicate commits that the proposed development will meet the NSW government's requirements for sustainability, if it is built in accordance with the commitments set out below. Terms used in this certificate, or in the commitments, have the meaning given by the document entitled "BASIX Definitions" dated 06/10/2017 published by the Department. This document is available at www.basix.nsw.gov.au

Secretary Date of issue: Monday, 23 December 2019 To be valid, this certificate must be lodged within 3 months of the date of issue.

NSW | Planning, Industry & Environment

Project summary Project name Palm Beach 1 Street address 26, lot 5 Ralston Street Palm Beach 2108 Local Government Area Northern Beaches Council Plan type and plan number deposited 14048 ot no. Section no. Project type separate dwelling house No. of bedrooms Project score Water 42 Target 40 Thermal Comfort V Pass Target Pass 56 Target 50 Energy

Certificate Prepared by

Name / Company Name: Integreco Consulting Pty Ltd ABN (if applicable): 42630013008

Project name	Palm Beach 1
Street address	26, lot 5 Ralston Street Palm Beach 2108
Local Government Area	Northern Beaches Council
Plan type and plan number	Deposited Plan 14048
Lot no.	5
Section no.	10
Project type	
Project type	separate dwelling house
No. of bedrooms	5
Site details	
Site area (m ²)	766
Roof area (m ²)	184
Conditioned floor area (m2)	280.0
Unconditioned floor area (m2)	14.0
Total area of garden and lawn (m2)	320

Assessor number	BDAV/19/1921	
Certificate number	0004495628	
Climate zone	56	
Area adjusted cooling load (MJ/m ² .year)	19	
Area adjusted heating load (MJ/m².year)	43	
Project score		
Water	42	Target 40
Thermal Comfort	V Pass	Target Pass
Energy	56	Target 50

Nater Commitments	Show on CC/CDC plans & specs	Energy Com
Landscape		Hot water
The applicant must plant indigenous or low water use species of vegetation throughout 100 square metres of the site.	~	The applicant mi instantaneous w
Fixtures		Cooling syst
The applicant must install showerheads with a minimum rating of 4 star (> 6 but <= 7.5 L/min plus spray force and/or coverage tests) in all showers in the development.	~	The applicant m airconditioning; I
The applicant must install a toilet flushing system with a minimum rating of 4 star in each toilet in the development.	~	The applicant m airconditioning;
The applicant must install taps with a minimum rating of 5 star in the kitchen in the development.	~	Heating syst
he applicant must install basin taps with a minimum rating of 5 star in each bathroom in the development.	~	The applicant m airconditioning;
Iternative water		The applicant m airconditioning;
Rainwater tank		Ventilation
The applicant must install a rainwater tank of at least 3000 litres on the site. This rainwater tank must meet, and be installed in accordance with, the requirements of all applicable regulatory authorities.	~	The applicant m
The applicant must configure the rainwater tank to collect rain runoff from at least 184 square metres of the roof area of the development (excluding the area of the roof which drains to any stormwater tank or private dam).	~	At least 1 Bath
The applicant must connect the rainwater tank to:		Kitchen: individ
the cold water tap that supplies each clothes washer in the development	_	Laundry: indiv
 at least one outdoor tap in the development (Note: NSW Health does not recommend that rainwater be used for human consumption in areas with potable water supply.) 	~	Artificial lig
a tap that is located within 10 metres of the swimming pool in the development	_	The applicant m following rooms
Swimming pool		light emitting die at least 5 of
Vater Commitments	Show on CC/CDC	at least 3 of
The swimming pool must not have a volume greater than 20 kilolitres.	plans & specs	• the kitchen;
The swimming pool must be outdoors.	· ·	
		Energy Com
Thermal Comfort Commitments	Show on CC/CDC	all bathroom
nemia comor communents	plans & specs	the laundry;
Simulation Method		
The applicant must attach the certificate referred to under "Assessor Details" on the front page of this BASIX certificate (the "Assessor Certificate") to the development application and construction certificate application for the proposed development (or, if the applicant is applying for a complying development certificate for the proposed development, to that application). The applicant must also attach the		all hallways;
Assessor Certificate to the application for an occupation certificate for the proposed development.		Natural light
The Assessor Certificate must have been issued by an Accredited Assessor in accordance with the Thermal Comfort Protocol. The details of the proposed development on the Assessor Certificate must be consistent with the details shown in this BASIX		The applicant m
certificate, including the Cooling and Heating loads shown on the front page of this certificate.		The applicant m
The applicant must show on the plans accompanying the development application for the proposed development, all matters which the Assessor Certificate requires to be shown on those plans. Those plans must bear a stamp of endorsement from the Accredited	~	Swimming p
Assessor to certify that this is the case. The applicant must show on the plans accompanying the application for a construction sertificate (or complying development certificate, if applicable), all thermal performance specifications set out in the Assessor Zertificate, and all aspects of the proposed development which were used to calculate those specifications.		The applicant m heating system
The applicant must construct the development in accordance with all thermal performance specifications set out in the Assessor		The applicant m
Certificate, and in accordance with those aspects of the development application or application for a complying development certificate which were used to calculate those specifications.		Alternative e
Where there is an in-slab heating or cooling system, the applicant must install insulation with an R-value of not less than 1.0 around the vertical edges of the perimeter of the slab, and underneath the slab if it is a suspended floor.		The applicant m development. T
	~	Other
The applicant must construct the floors and walls of the dwelling in accordance with the specifications listed in the table below.		The applicant m
The applicant must construct the floors and walls of the dwelling in accordance with the specifications listed in the table below.		
The applicant must construct the floors and walls of the dwelling in accordance with the specifications listed in the table below.		The applicant m
		The applicant m
Floor and wall construction Area		The applicant m

In these commitments, "applicant" means the person carrying out the development. Commitments identified with a 💕 in the "Show on DA plans" column must be shown on the plans accompanying the development application for the proposed development (if a development application is to be lodged for the proposed development). Commitments identified with a 🥥 in the "Show on CC/CDC plans and specs" column must be shown in the plans and specifications accompanying the application for a construction certificate / complying development certificate for the proposed development. Commitments identified with a v in the "Certifier check" column must be certified by a certifying authority as having been fulfilled, before a final occupation certificate(either interim or final) for the development may be issued.



COVER SHEET

TITLE

SCALE

APPROVED DRAWN JC CHECKED TG DATE MARCH 2024 STATUS S4.55


Lot 4 / Lot 5 DP 14048 , 26 Ralston Road, PALM BEACH NSW 2108










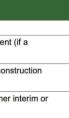

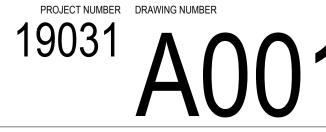












TREE: EXISTING TO BE REMOVED

TREE: EXISTING TO BE RETAINED

APPOVED AS PER MOD2023/0676 TO BE REMODED

PROPOSED NEW MODIFICATIONS

EXISTING BUILDING

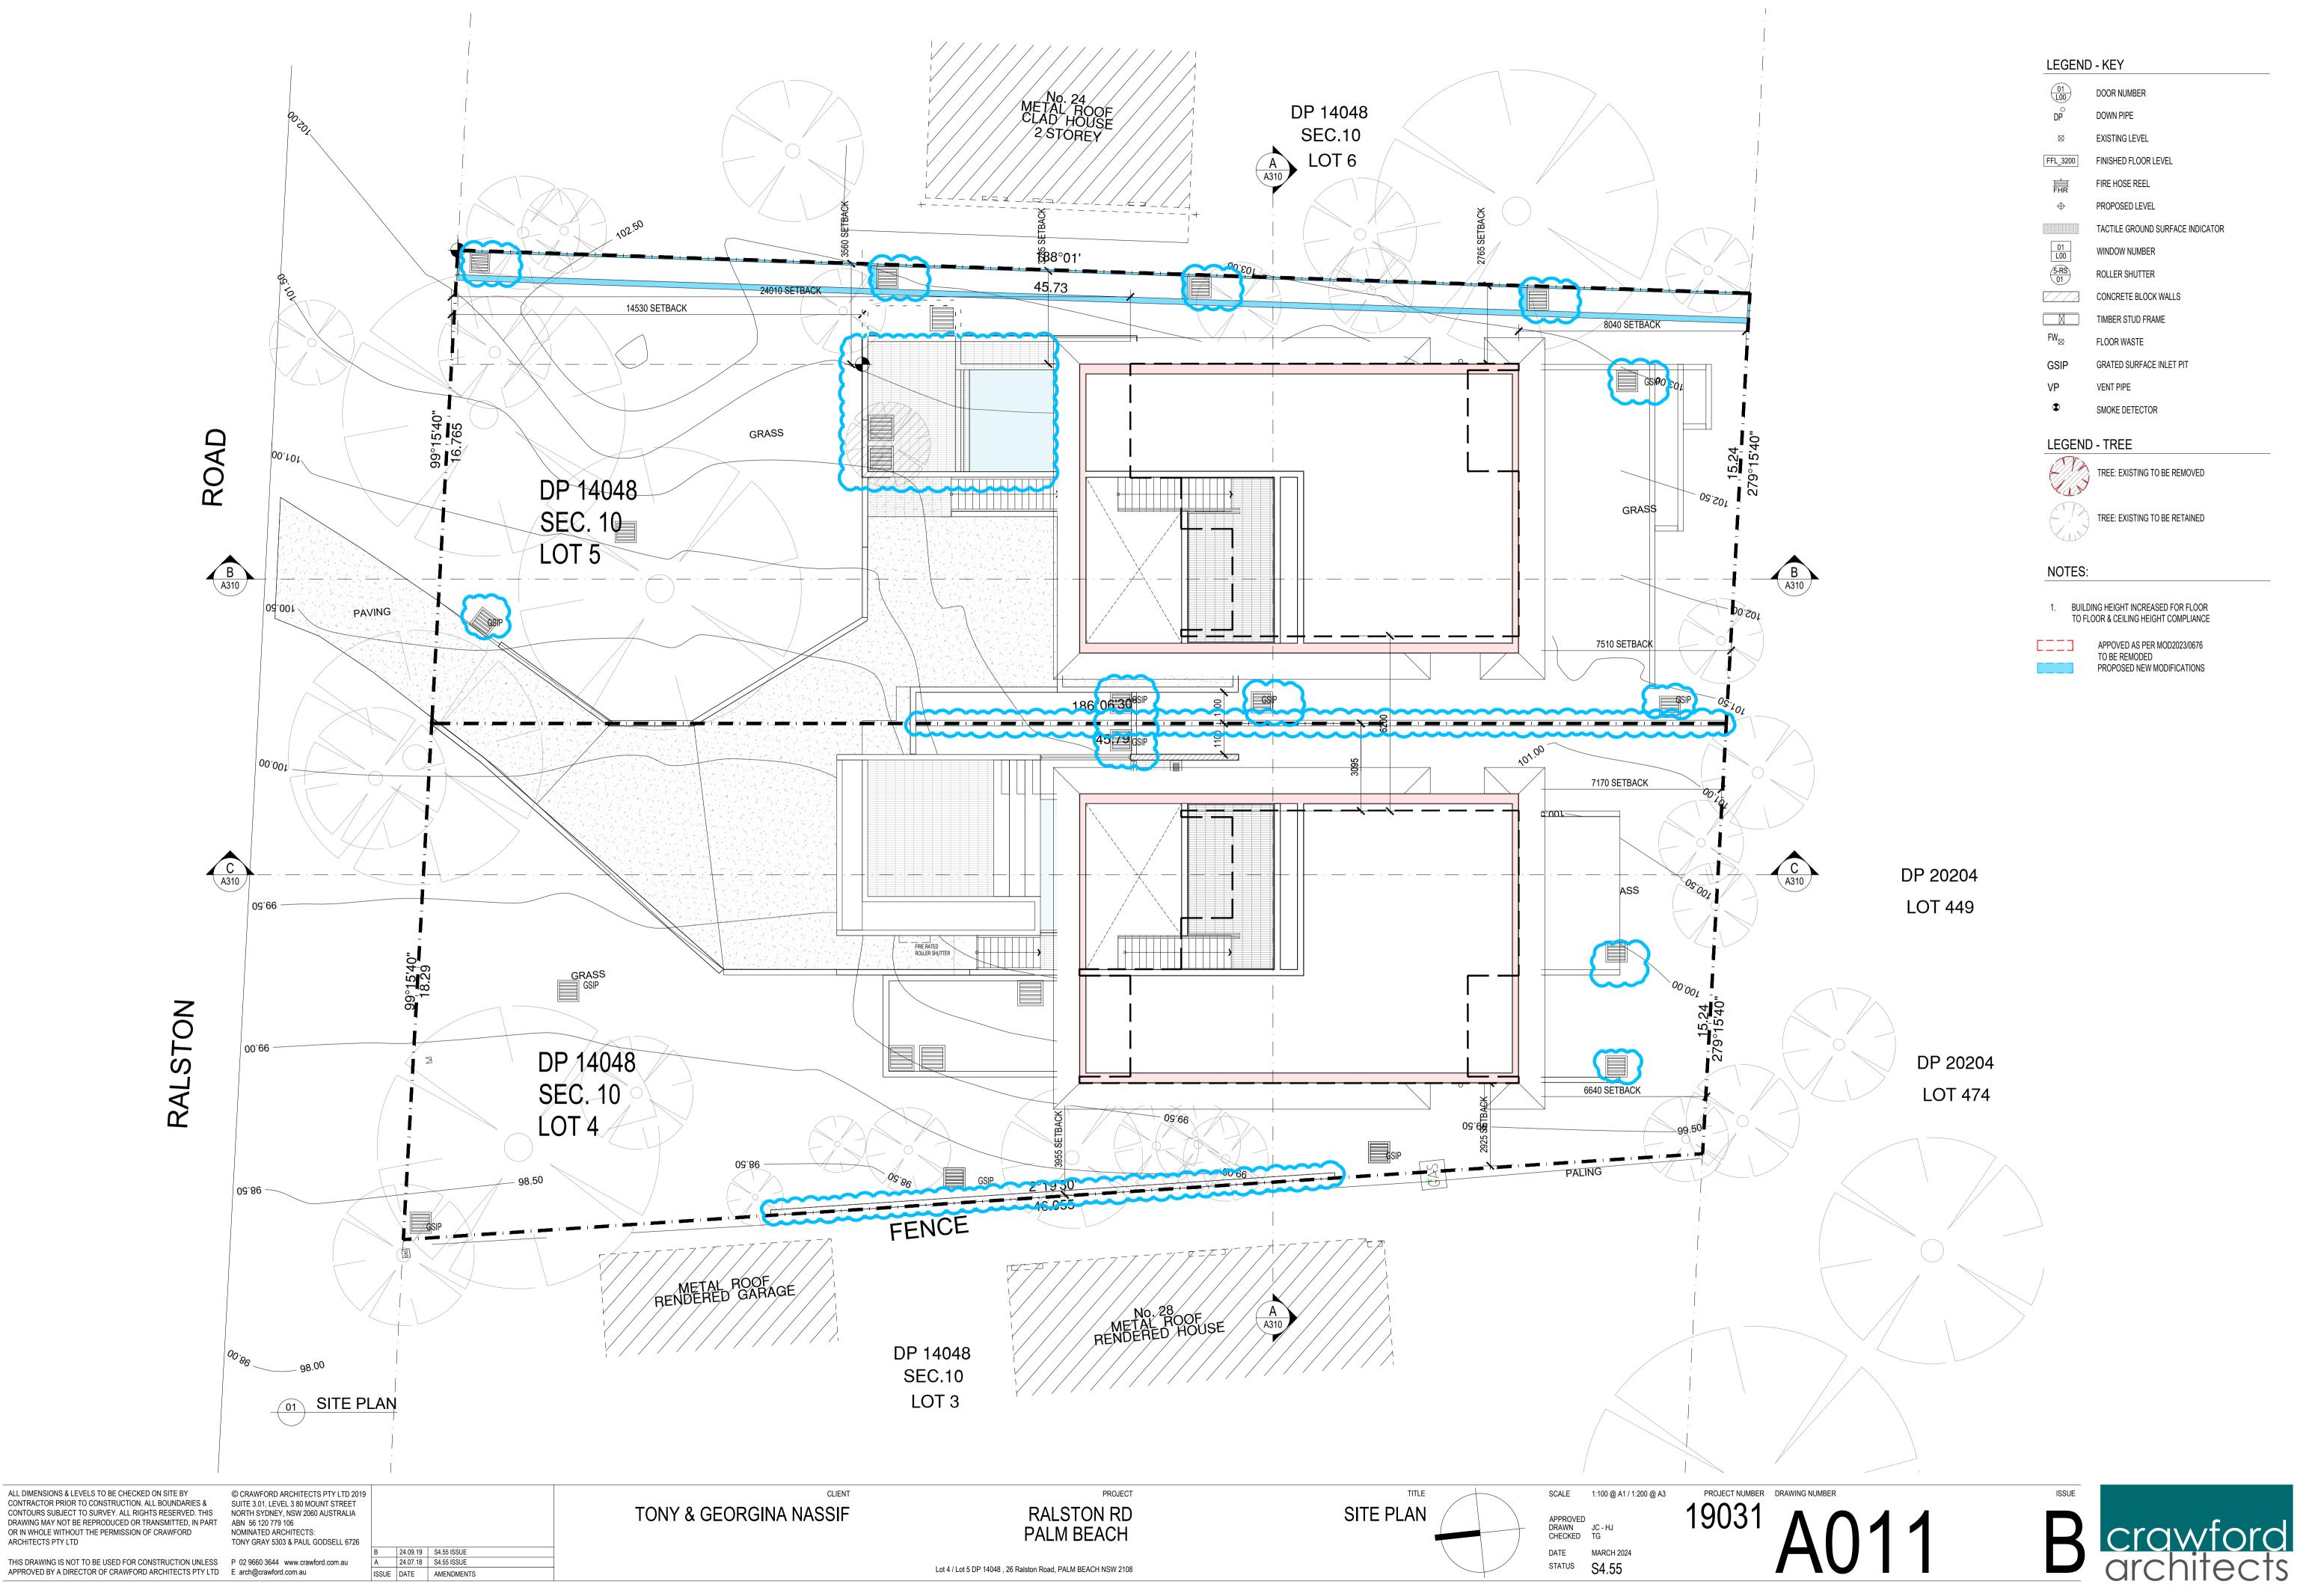

ARCHITECTS PTY LTD


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LEGEND - KEY

	DOOR NUMBER
DP	DOWN PIPE
×	EXISTING LEVEL
FFL_3200	FINISHED FLOOR LEVEL
FHR FHR	FIRE HOSE REEL
\oplus	PROPOSED LEVEL
	TACTILE GROUND SURFACE INDICATOR
01 L00	WINDOW NUMBER
5-RS 01	ROLLER SHUTTER
	CONCRETE BLOCK WALLS
	TIMBER STUD FRAME
FW_{\boxtimes}	FLOOR WASTE
GSIP	GRATED SURFACE INLET PIT
VP	VENT PIPE
۲	SMOKE DETECTOR

LEGEND - TREE

TREE: EXISTING TO BE RETAINED

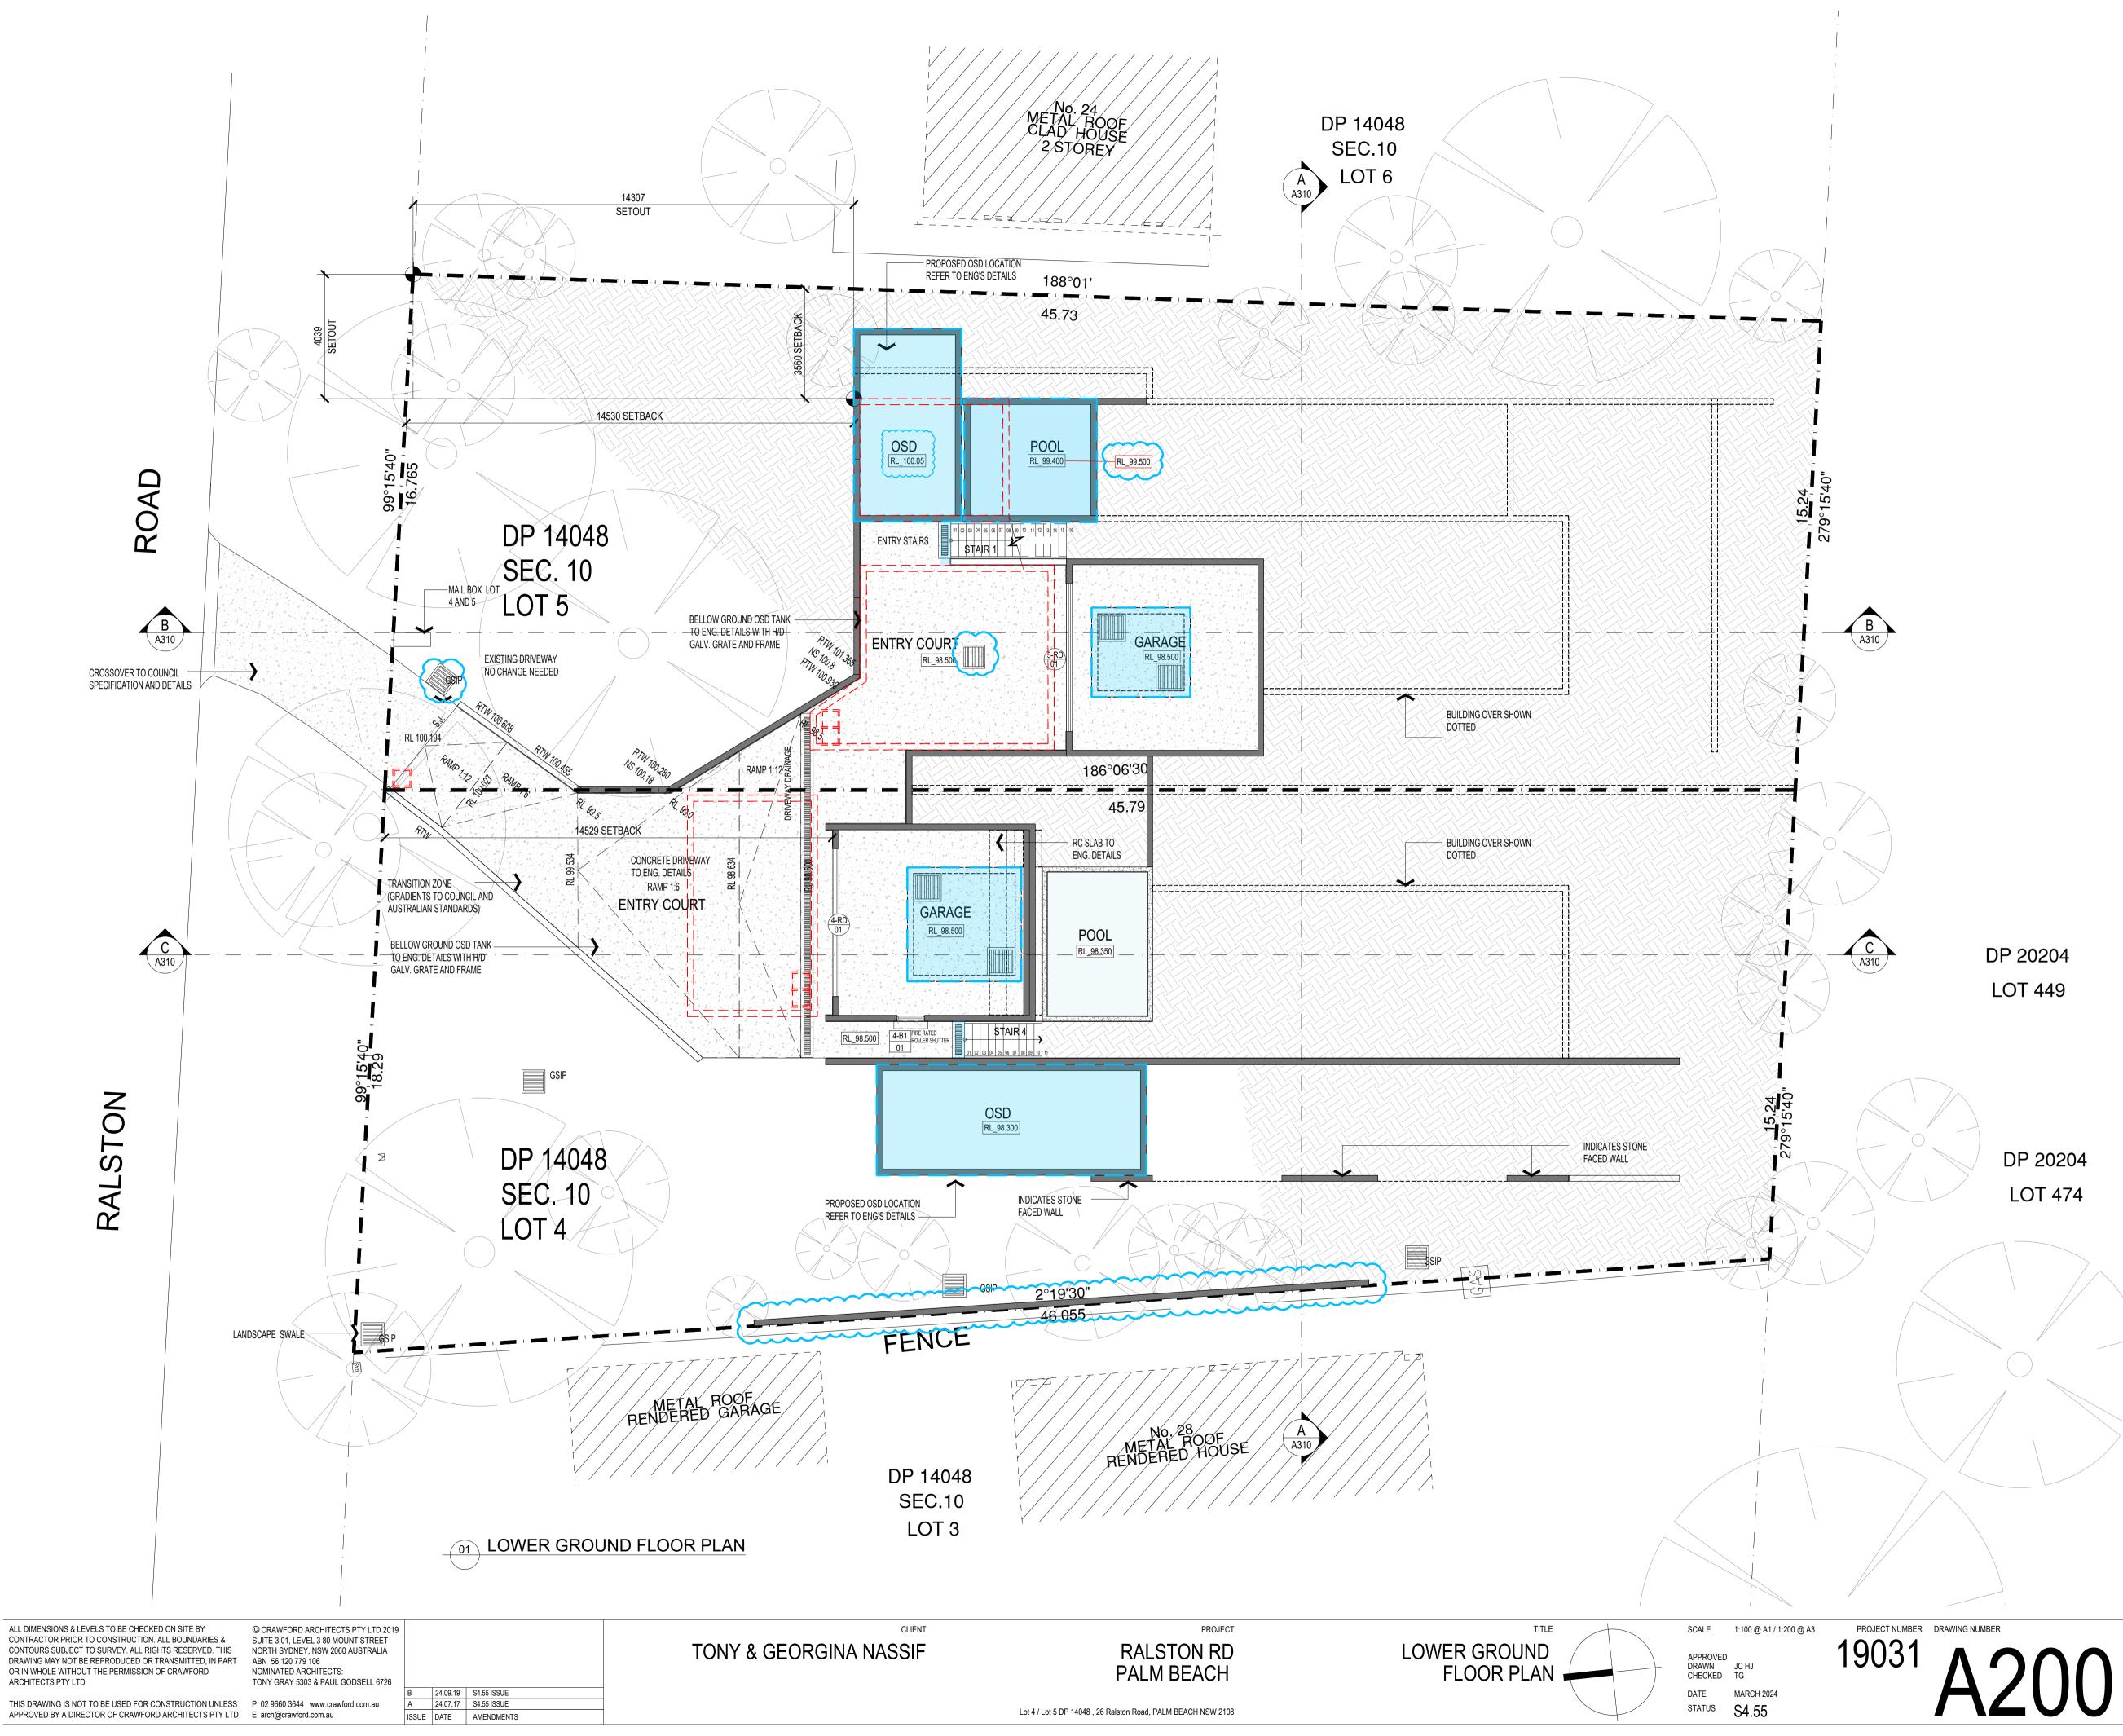

LEGEND - KEY

01 L00	DOOR NUMBER
DP	DOWN PIPE
×	EXISTING LEVEL
FFL_3200	FINISHED FLOOR LEVEL
FHR	FIRE HOSE REEL
-\$	PROPOSED LEVEL
	TACTILE GROUND SURFACE INDICATOR
01 L00	WINDOW NUMBER
5-RS 01	ROLLER SHUTTER
Z / / 2	CONCRETE BLOCK WALLS
	TIMBER STUD FRAME
$\mathrm{FW}_{oxtimes}$	FLOOR WASTE
GSIP	GRATED SURFACE INLET PIT
VP	VENT PIPE
۲	SMOKE DETECTOR
LEGEND	- TREE
ON A	




TREE: EXISTING TO BE RETAINED

NOTES:

1. FOR WATERPROOFING DETAILS REFER DRAWINGS A800 TO A805





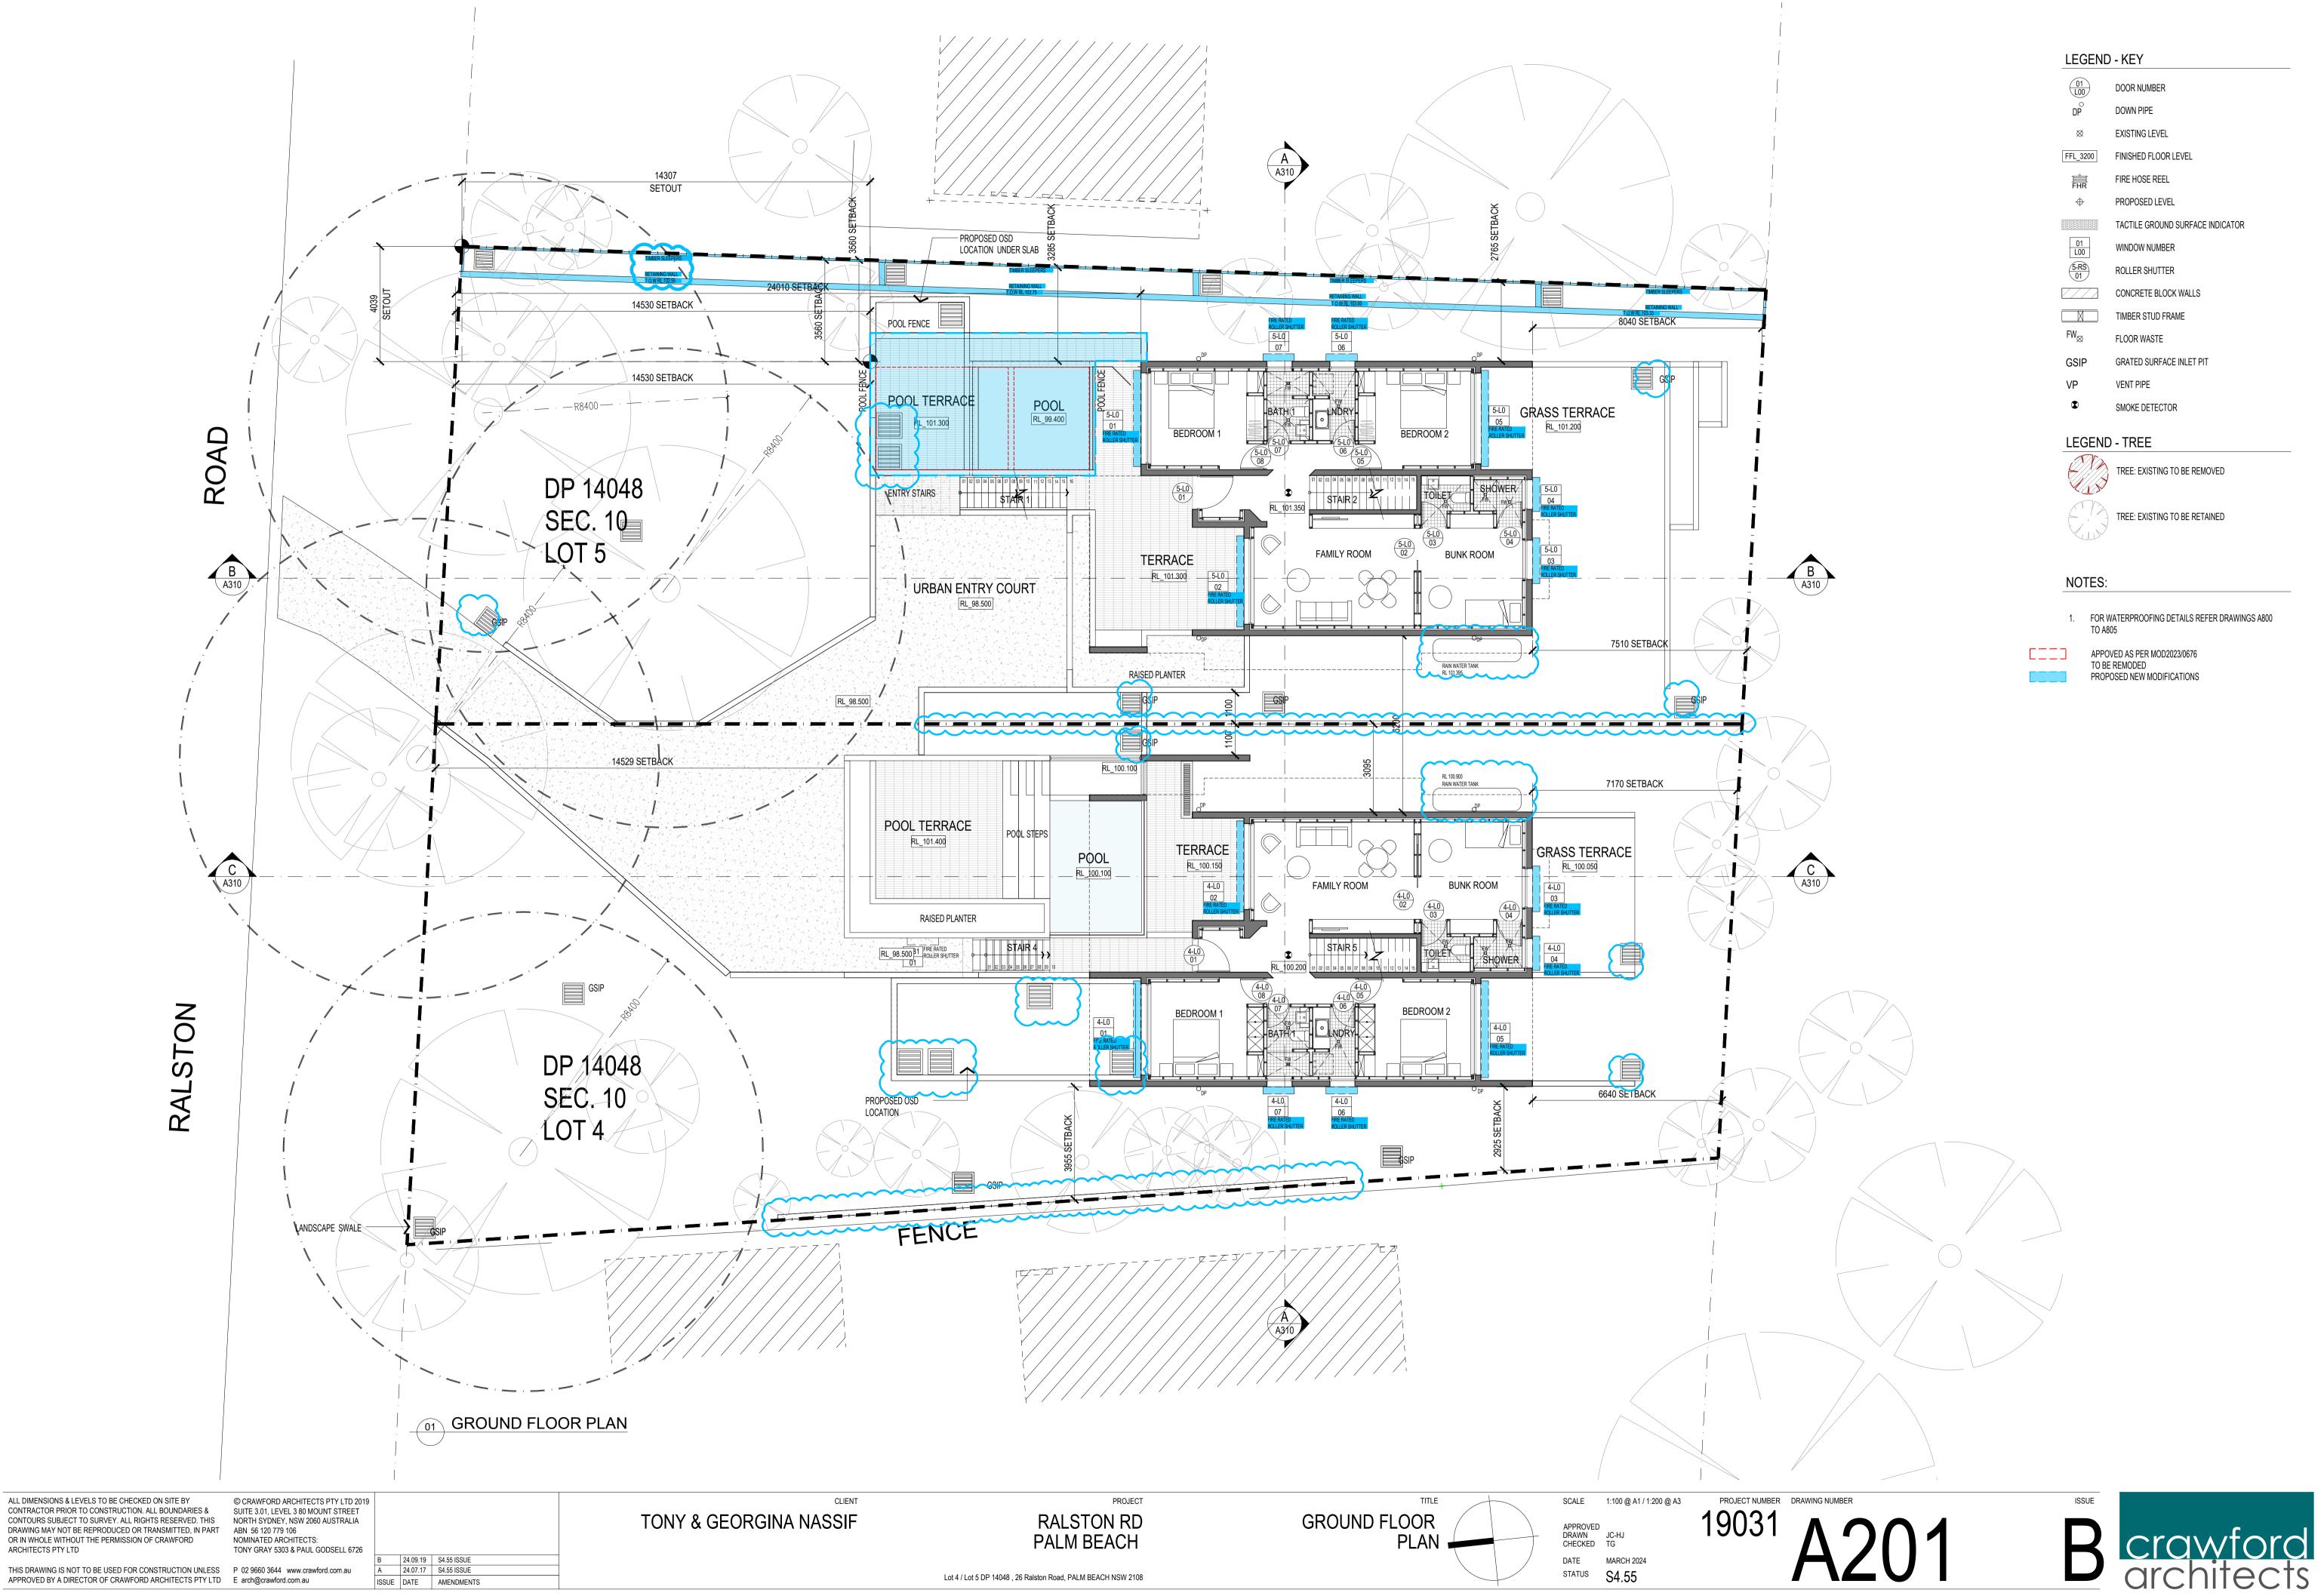

ARCHITECTS PTY LTD

01 L00	DOOR NUMBER
DP	DOWN PIPE
×	EXISTING LEVEL
FFL_3200	FINISHED FLOOR LEVEL
FHR	FIRE HOSE REEL
Φ	PROPOSED LEVEL
	TACTILE GROUND SURFACE INDICATOR
01 L00	WINDOW NUMBER
5-RS 01	ROLLER SHUTTER
	CONCRETE BLOCK WALLS
X	TIMBER STUD FRAME
FW_{igodot}	FLOOR WASTE
GSIP	GRATED SURFACE INLET PIT
VP	VENT PIPE
۲	SMOKE DETECTOR










ARCHITECTS PTY LTD

01 L00	DOOR NUMBER
DP	DOWN PIPE
×	EXISTING LEVEL
FFL_3200	FINISHED FLOOR LEVEL
FHR	FIRE HOSE REEL
Φ	PROPOSED LEVEL
	TACTILE GROUND SURFACE INDICATOR
01 L00	WINDOW NUMBER
5-RS 01	ROLLER SHUTTER
	CONCRETE BLOCK WALLS
X	TIMBER STUD FRAME
FW_{igodot}	FLOOR WASTE
GSIP	GRATED SURFACE INLET PIT
VP	VENT PIPE
۲	SMOKE DETECTOR







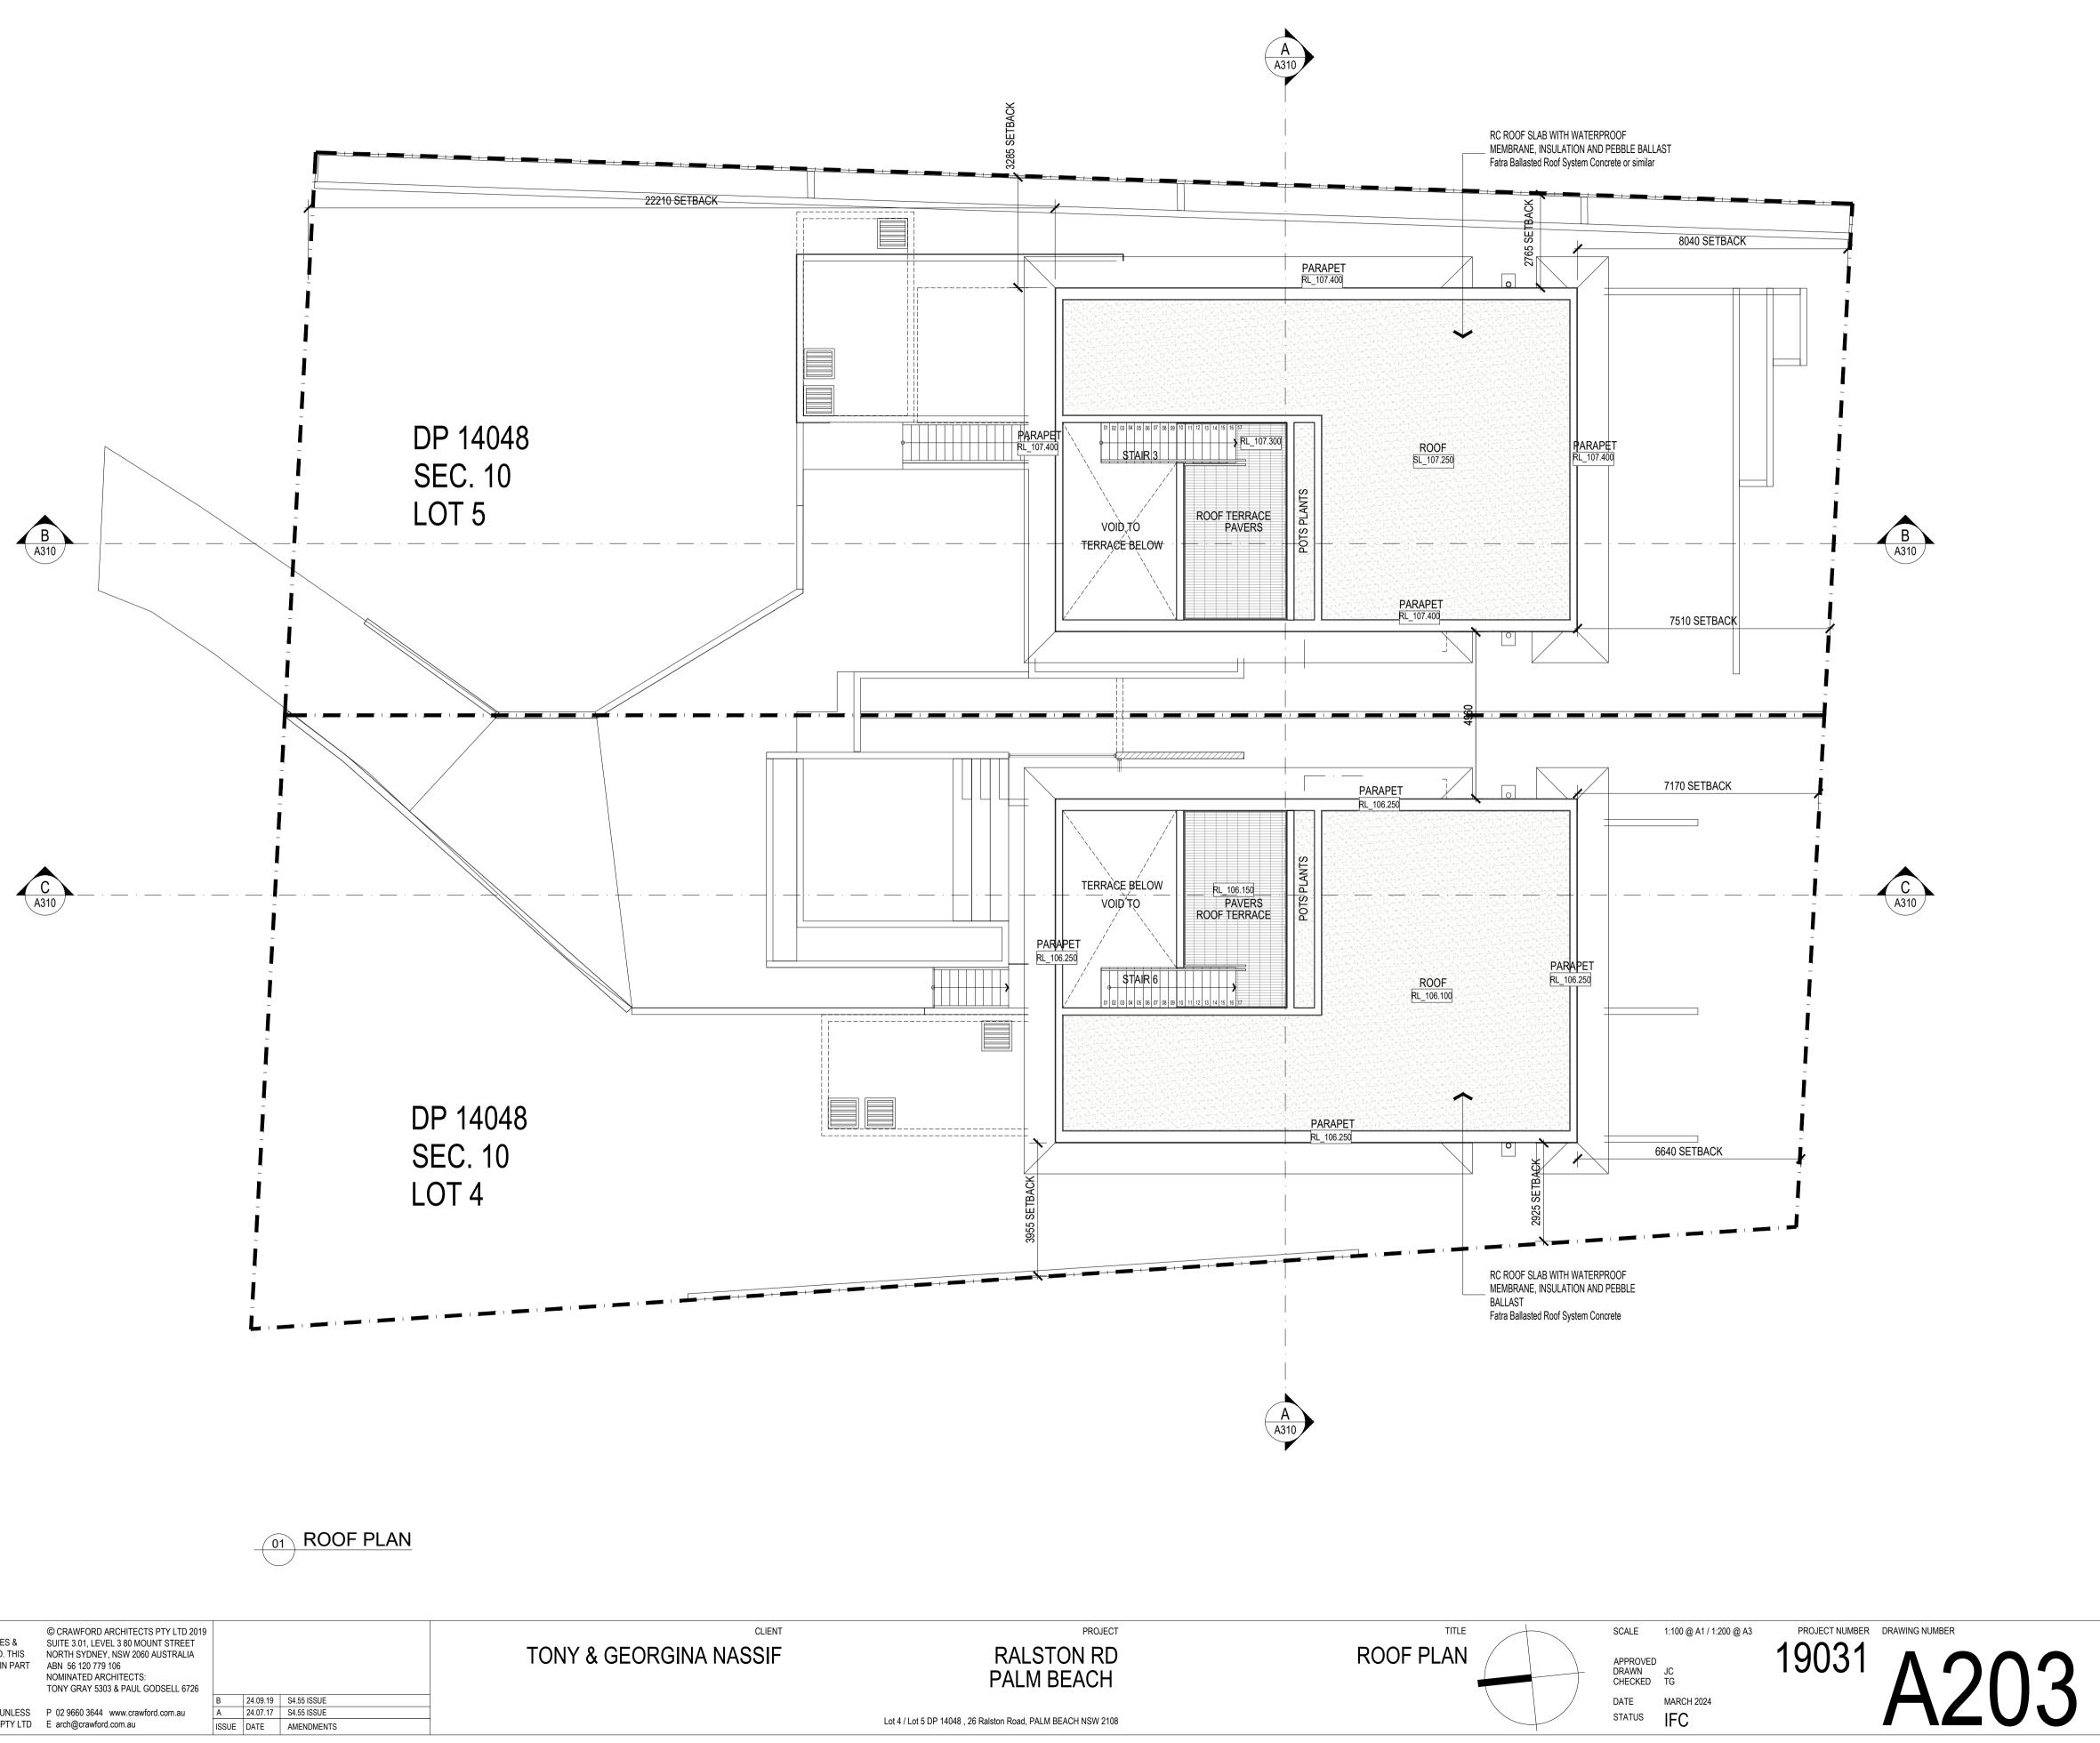

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LEGEND - KEY

01 L00	DOOR NUMBER				
DP	DOWN PIPE				
×	EXISTING LEVEL				
FFL_3200	FINISHED FLOOR LEVEL				
FHR	FIRE HOSE REEL				
\oplus	PROPOSED LEVEL				
	TACTILE GROUND SURFACE INDICATOR				
01 L00	WINDOW NUMBER				
5-RS 01	ROLLER SHUTTER				
	CONCRETE BLOCK WALLS				
X	TIMBER STUD FRAME				
FW_{igodot}	FLOOR WASTE				
GSIP	GRATED SURFACE INLET PIT				
VP	VENT PIPE				
۲	SMOKE DETECTOR				
LEGEND - TREE					



TREE: EXISTING TO BE RETAINED


NOTES:

1. FOR WATERPROOFING DETAILS REFER DRAWINGS A800 TO A805








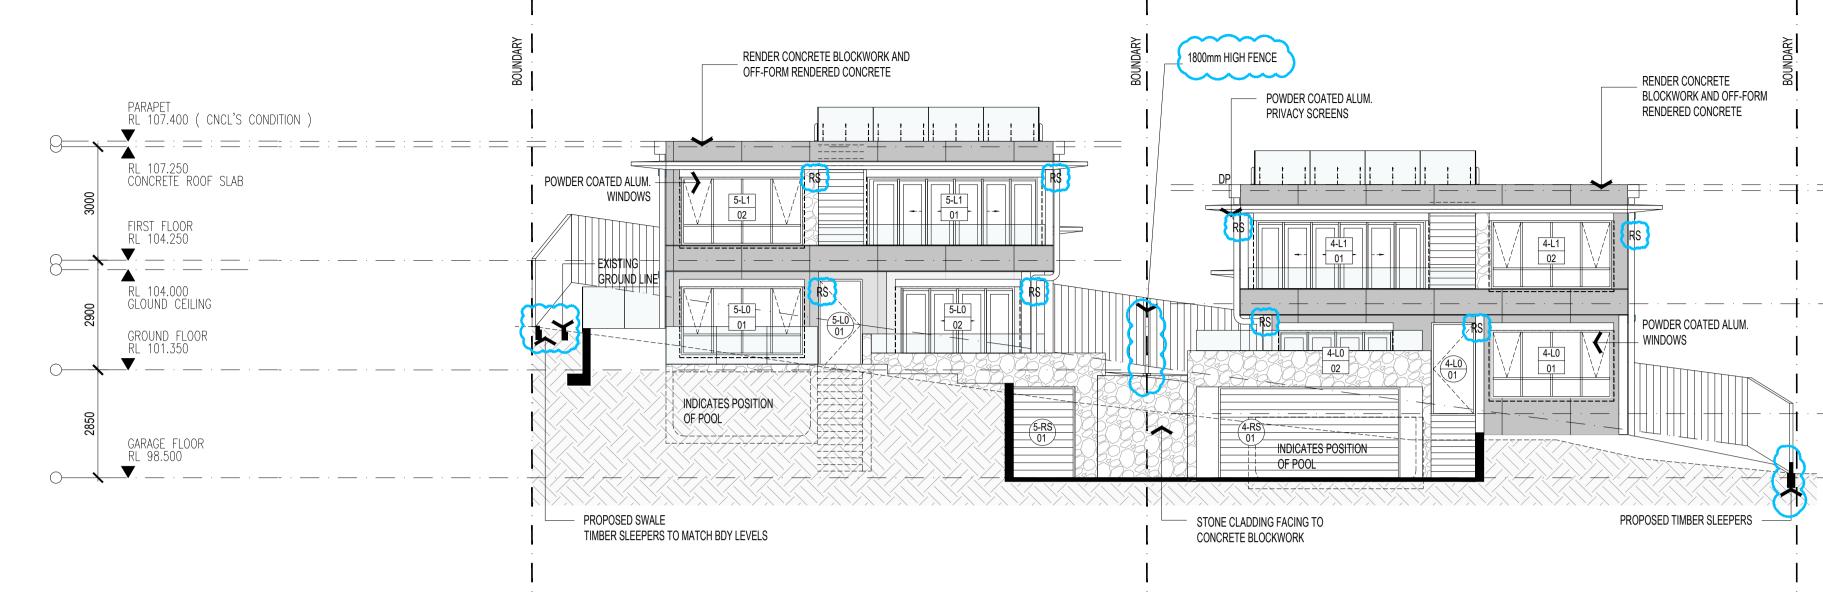

01 NORTH ELEVATIONS - LOT 05 & 04

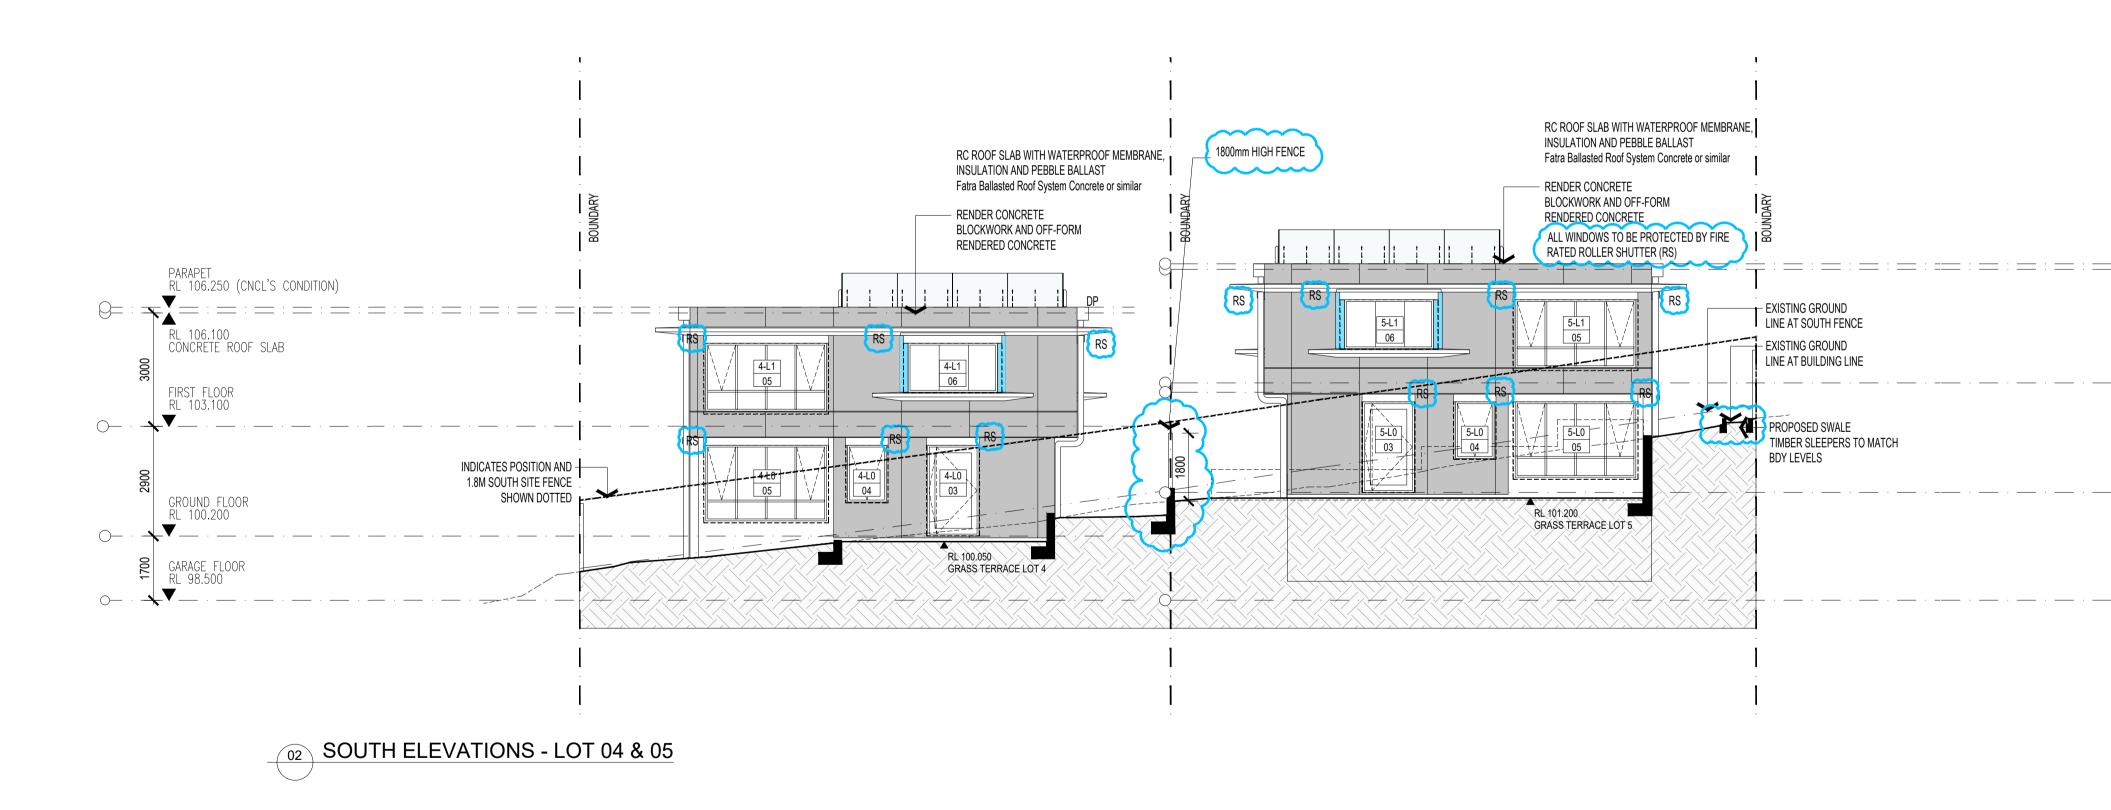

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	RAWING MATNOT BE REPRODUCED OR TRANSMITTED, IN PART	NOMINATED ARCHITECTS:				
A	RCHITECTS PTY LTD	TONY GRAY 5303 & PAUL GODSELL 6726	С	24.09.23	S4.55 ISSUE	
			В	24.09.19	S4.55 ISSUE	
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TITLE ELEVATIONS SHEET 01

APPROVED DRAWN JC - HJ CHECKED TG

DATE MARCH 2024 STATUS S4.55

SCALE 1:100 @ A1 / 1:200 @ A3


PROJECT NUMBER DRAWING NUMBER 19031


Lot 4 / Lot 5 DP 14048 , 26 Ralston Road, PALM BEACH NSW 2108

NOTES:


1. REFER TO THE BUSH FIRE REPORT FOR WINDOW AND DOOR BAL REQUIREMENT AND AS 3959 'CONSTRUCTION OF BUILDINGS IN BUSH FIRE PRONE AREAS'



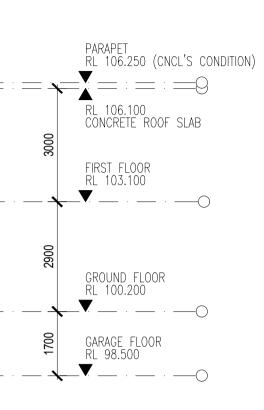


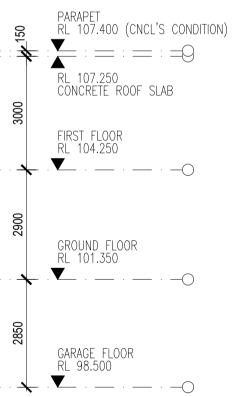



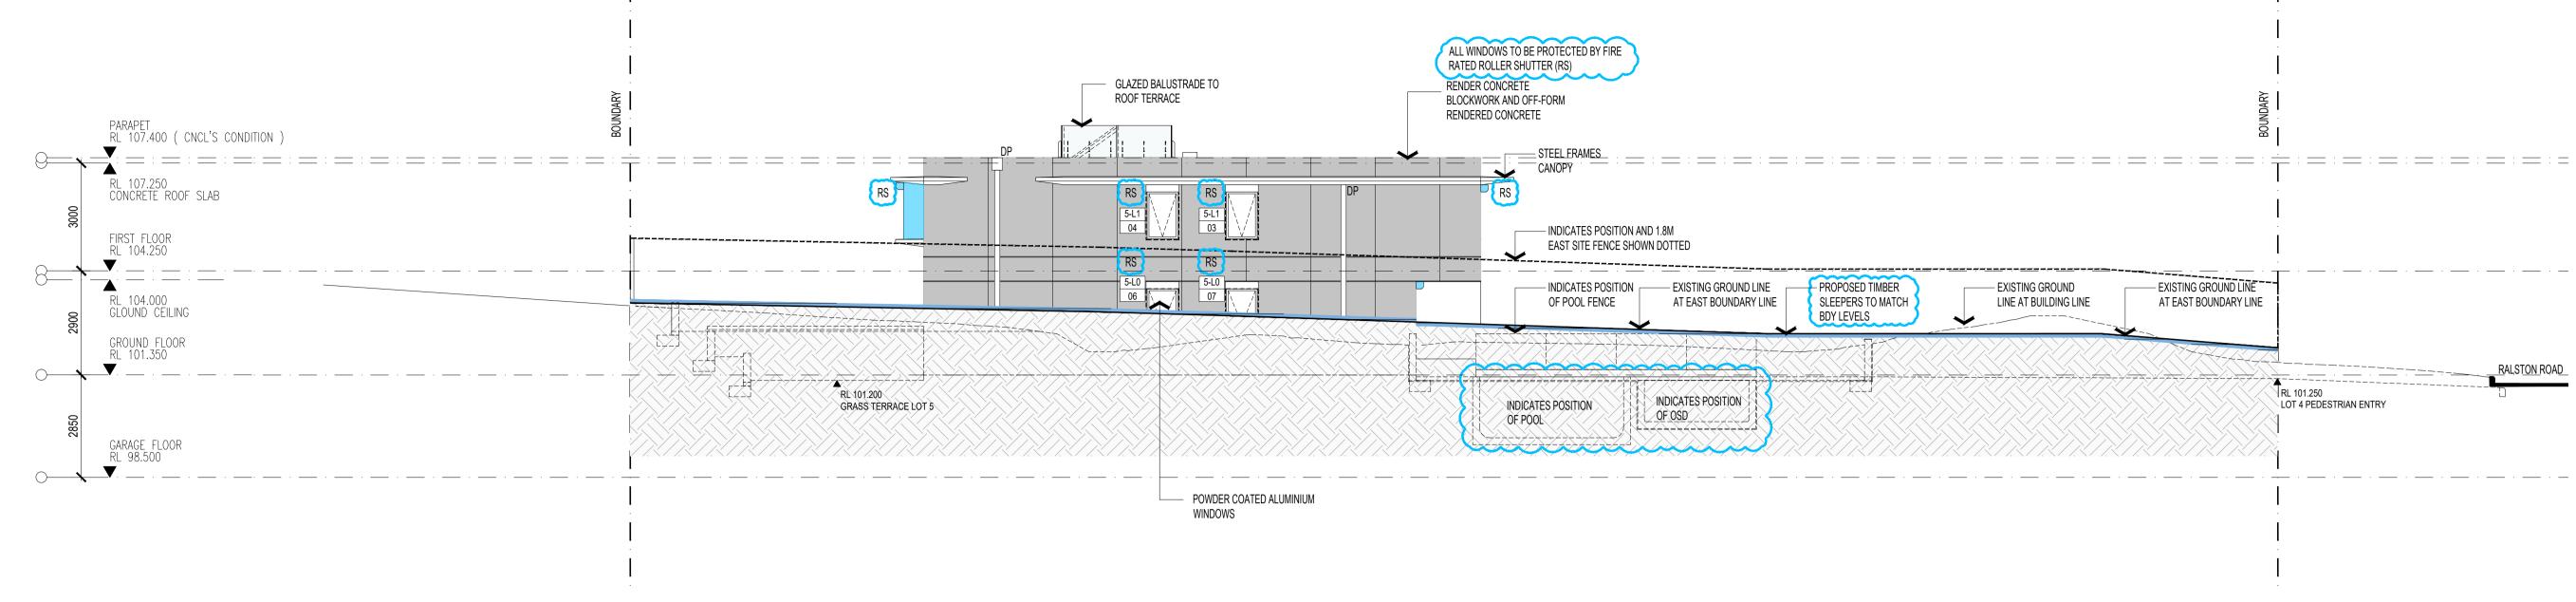



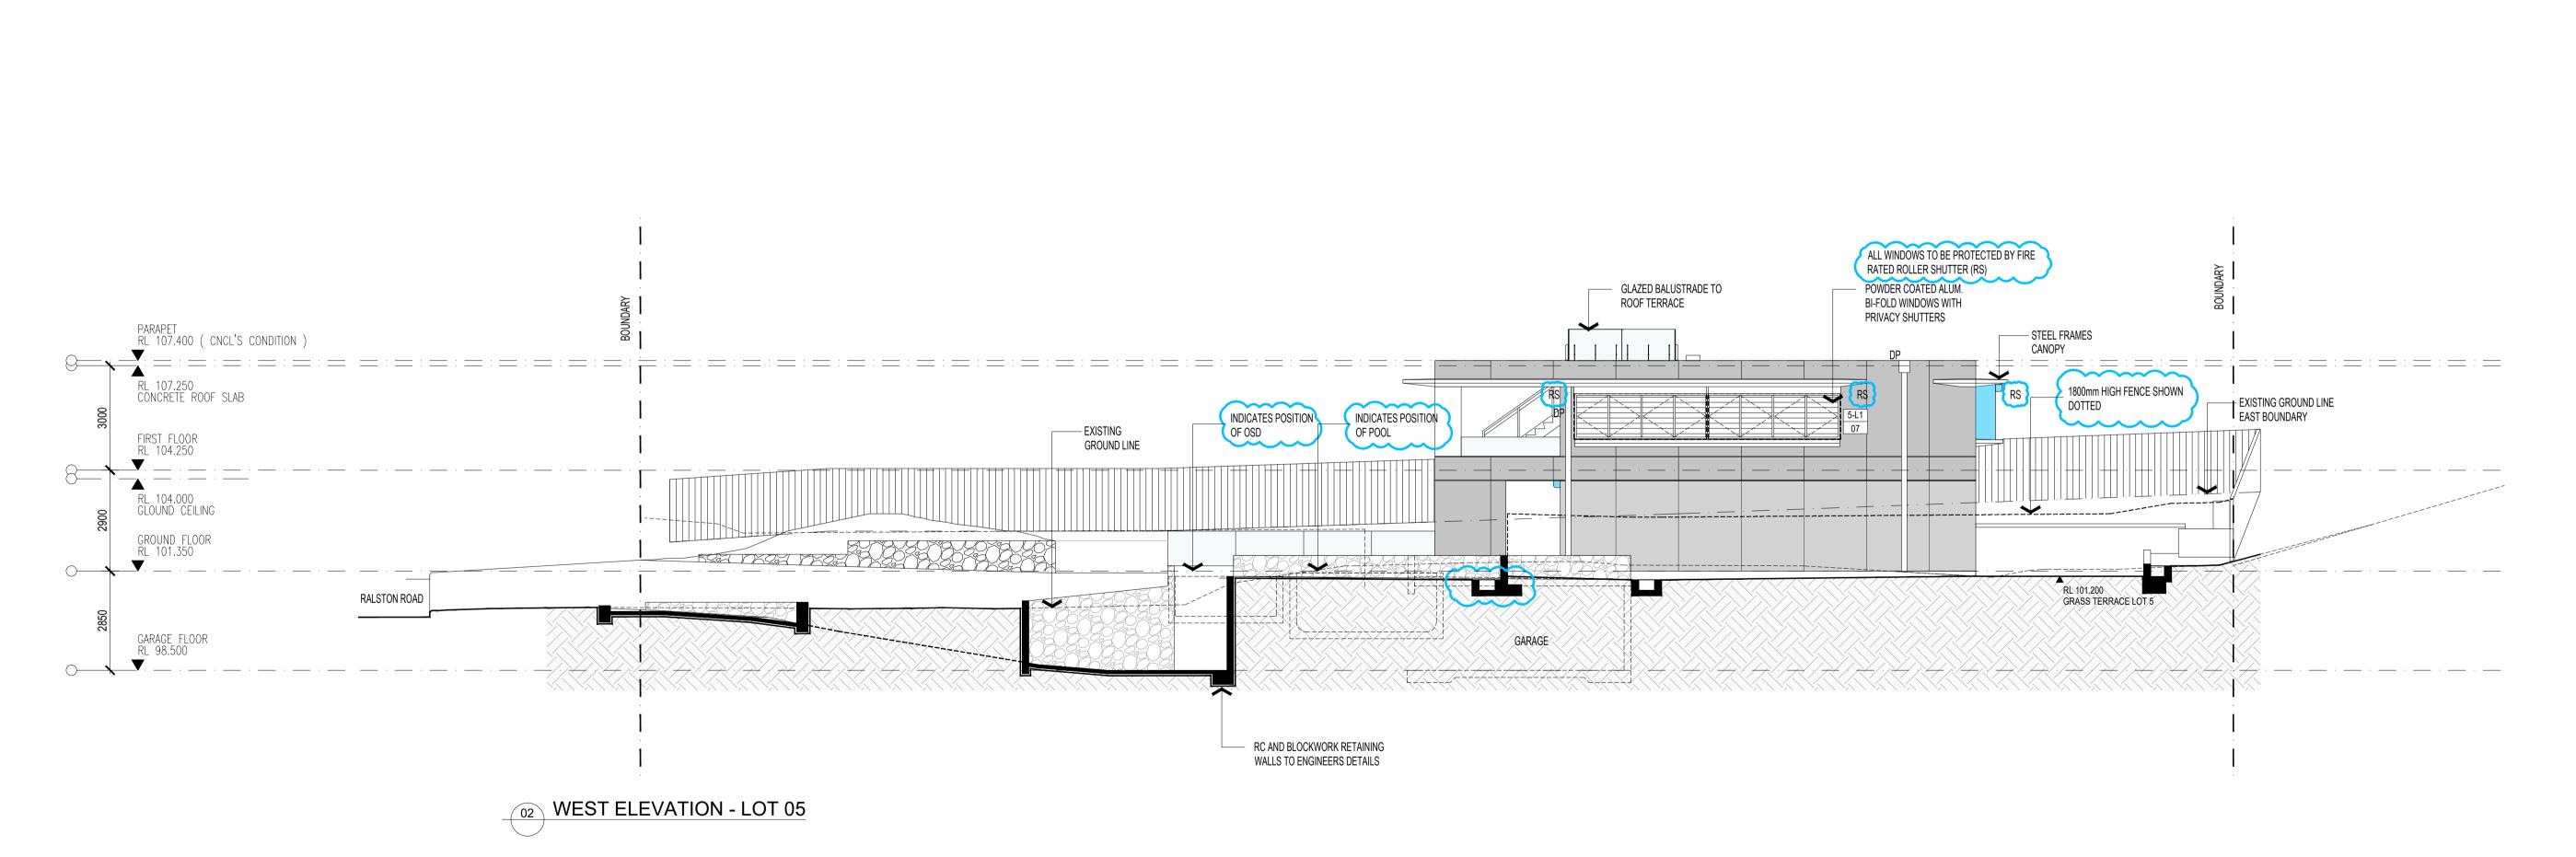

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OR IN WHOLE WITHOUT THE PERMISSION OF CRAWFORD	NOMINATED ARCHITECTS:				
ARCHITECTS PTY LTD	TONY GRAY 5303 & PAUL GODSELL 6726	С	24.09.23	S4.55 ISSUE	
		В	24.09.19	S4.55 ISSUE	
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ELEVATIONS SHEET 02 - LOT 05

TITLE

SCALE	1:100 @ A1 / 1:200 @ A3
APPROVED DRAWN CHECKED	JC-HJ TG
DATE	MARCH 2024
STATUS	S4.55

PROJECT NUMBER DRAWING NUMBER

19031

Lot 4 / Lot 5 DP 14048 , 26 Ralston Road, PALM BEACH NSW 2108

NOTES:



ISSUE

crawford architects

APPOVED AS PER MOD2023/0676


TO BE REMODED PROPOSED NEW MODIFICATIONS

1. REFER TO THE BUSH FIRE REPORT FOR WINDOW AND DOOR BAL REQUIREMENT


RL 101.250

LOT 4 PEDESTRIAN ENTRY

RALSTON ROAD

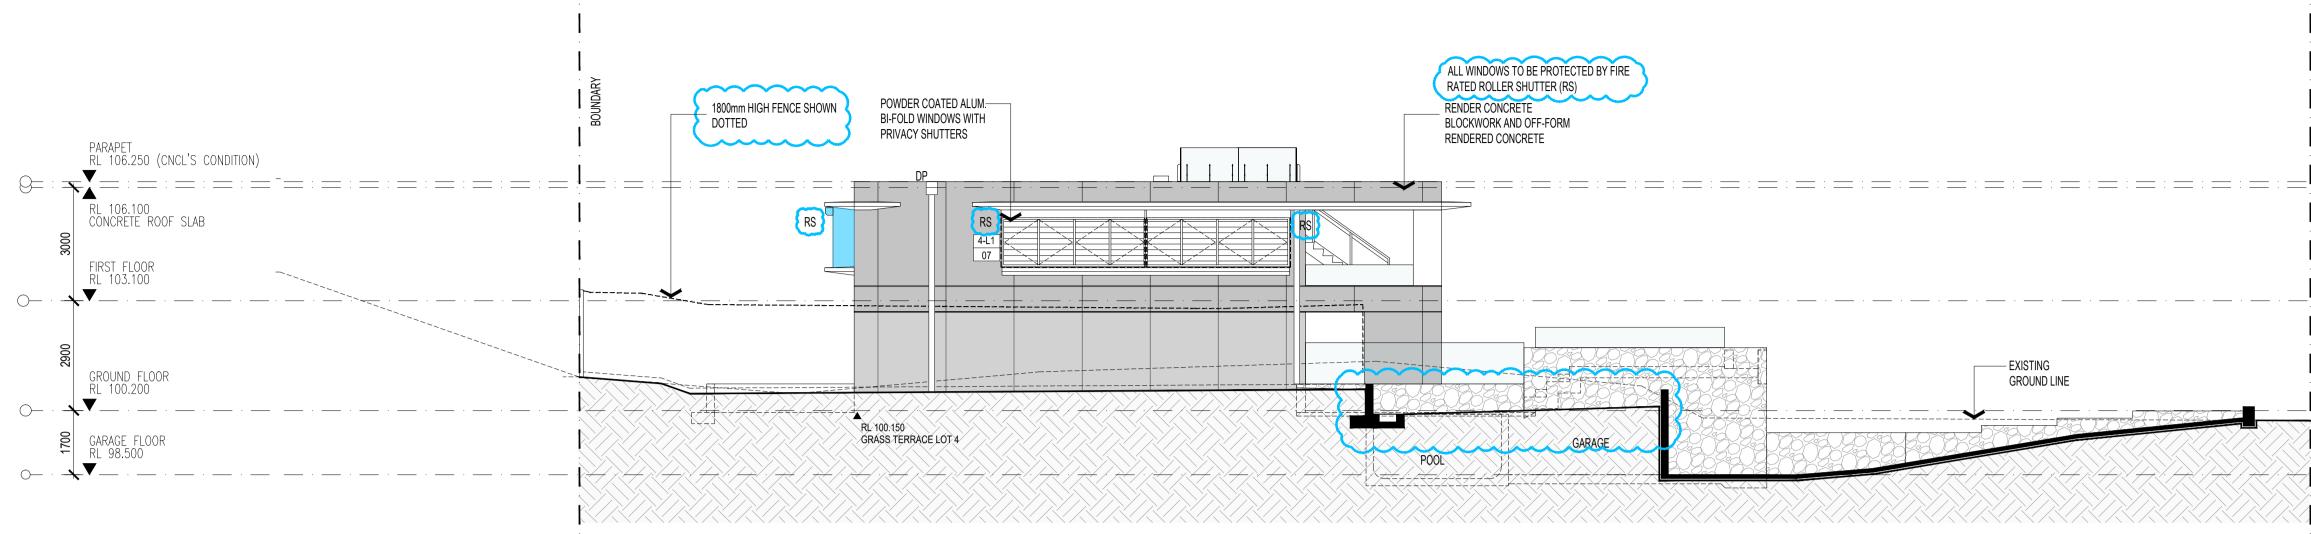

01 EAST ELEVATION - LOT 04

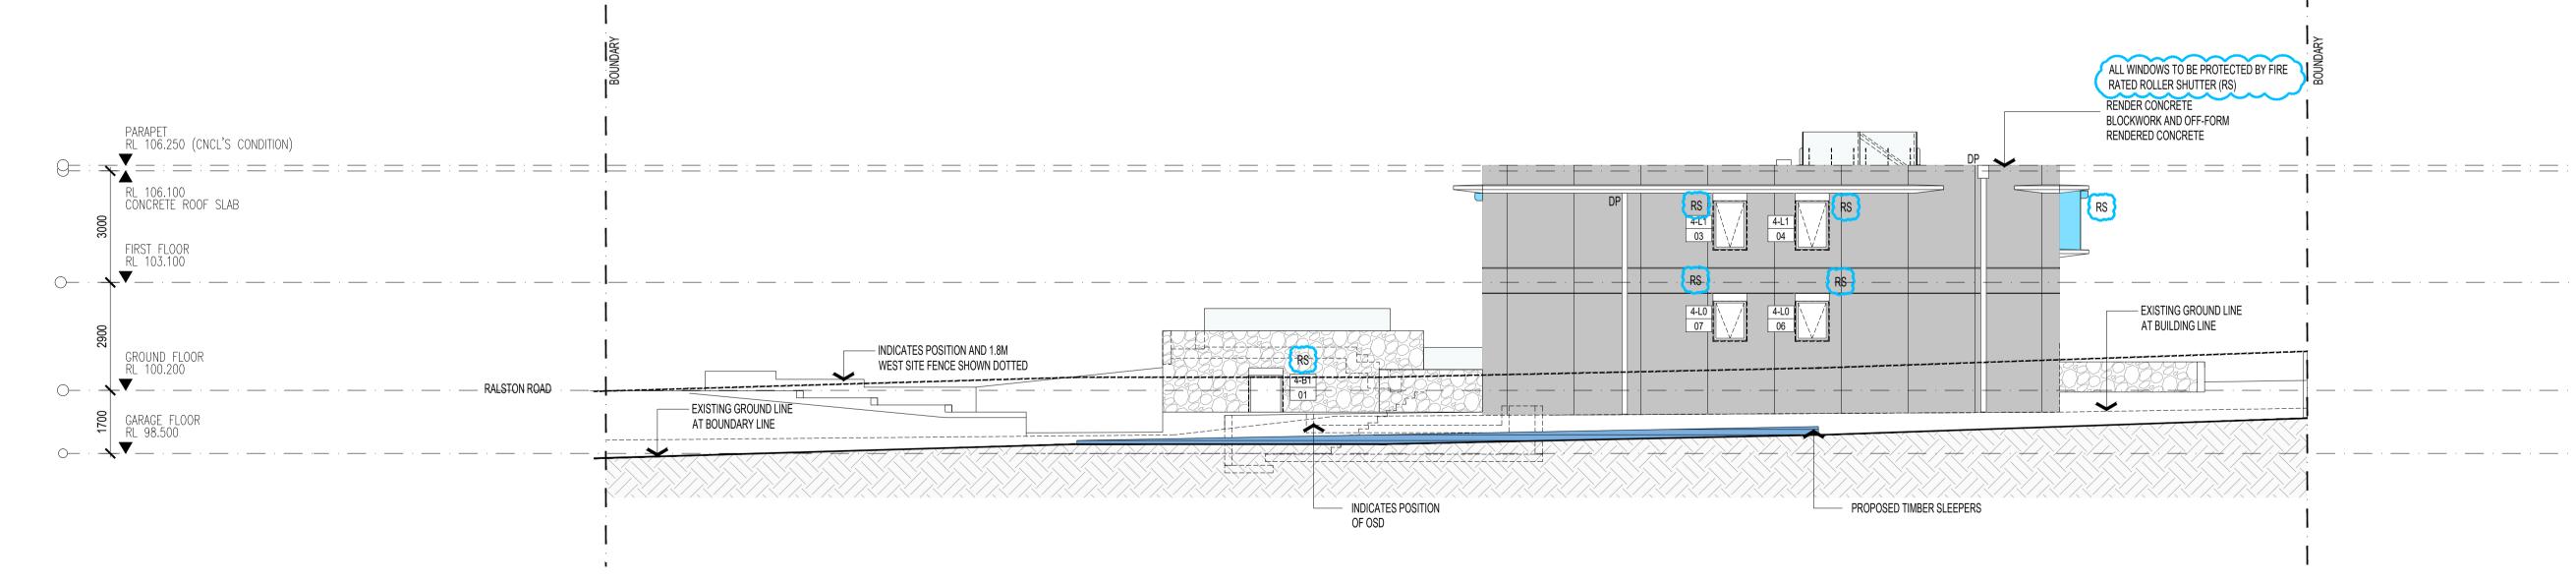

02 WEST ELEVATION - LOT 04

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CHITECTS PTY LTD	TONY GRAY 5303 & PAUL GODSELL 6726	С	24.09.23	S4.55 ISSUE	
		В	24.09.19	S4.55 ISSUE	
S DRAWING IS NOT TO BE USED FOR CONSTRUCTION UNLESS		А	24.07.17	S4.55 ISSUE	
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TITLE ELEVATIONS SHEET 03 - LOT 04

SCALE	1:100 @ A1 / 1:200 @ A3

APPROVED DRAWN JC-HJ CHECKED TG DATE MARCH 2024 STATUS S4.55

19031

Lot 4 / Lot 5 DP 14048 , 26 Ralston Road, PALM BEACH NSW 2108

1.	REFER TO THE BUSH FIRE REPORT FOR WINDOW AND DOOR BAL REQUIREMENT AND AS 3959 'CONSTRUCTION OF BUILDINGS IN BUSH FIRE PRONE AREAS'
:=]	APPOVED AS PER MOD2023/0676

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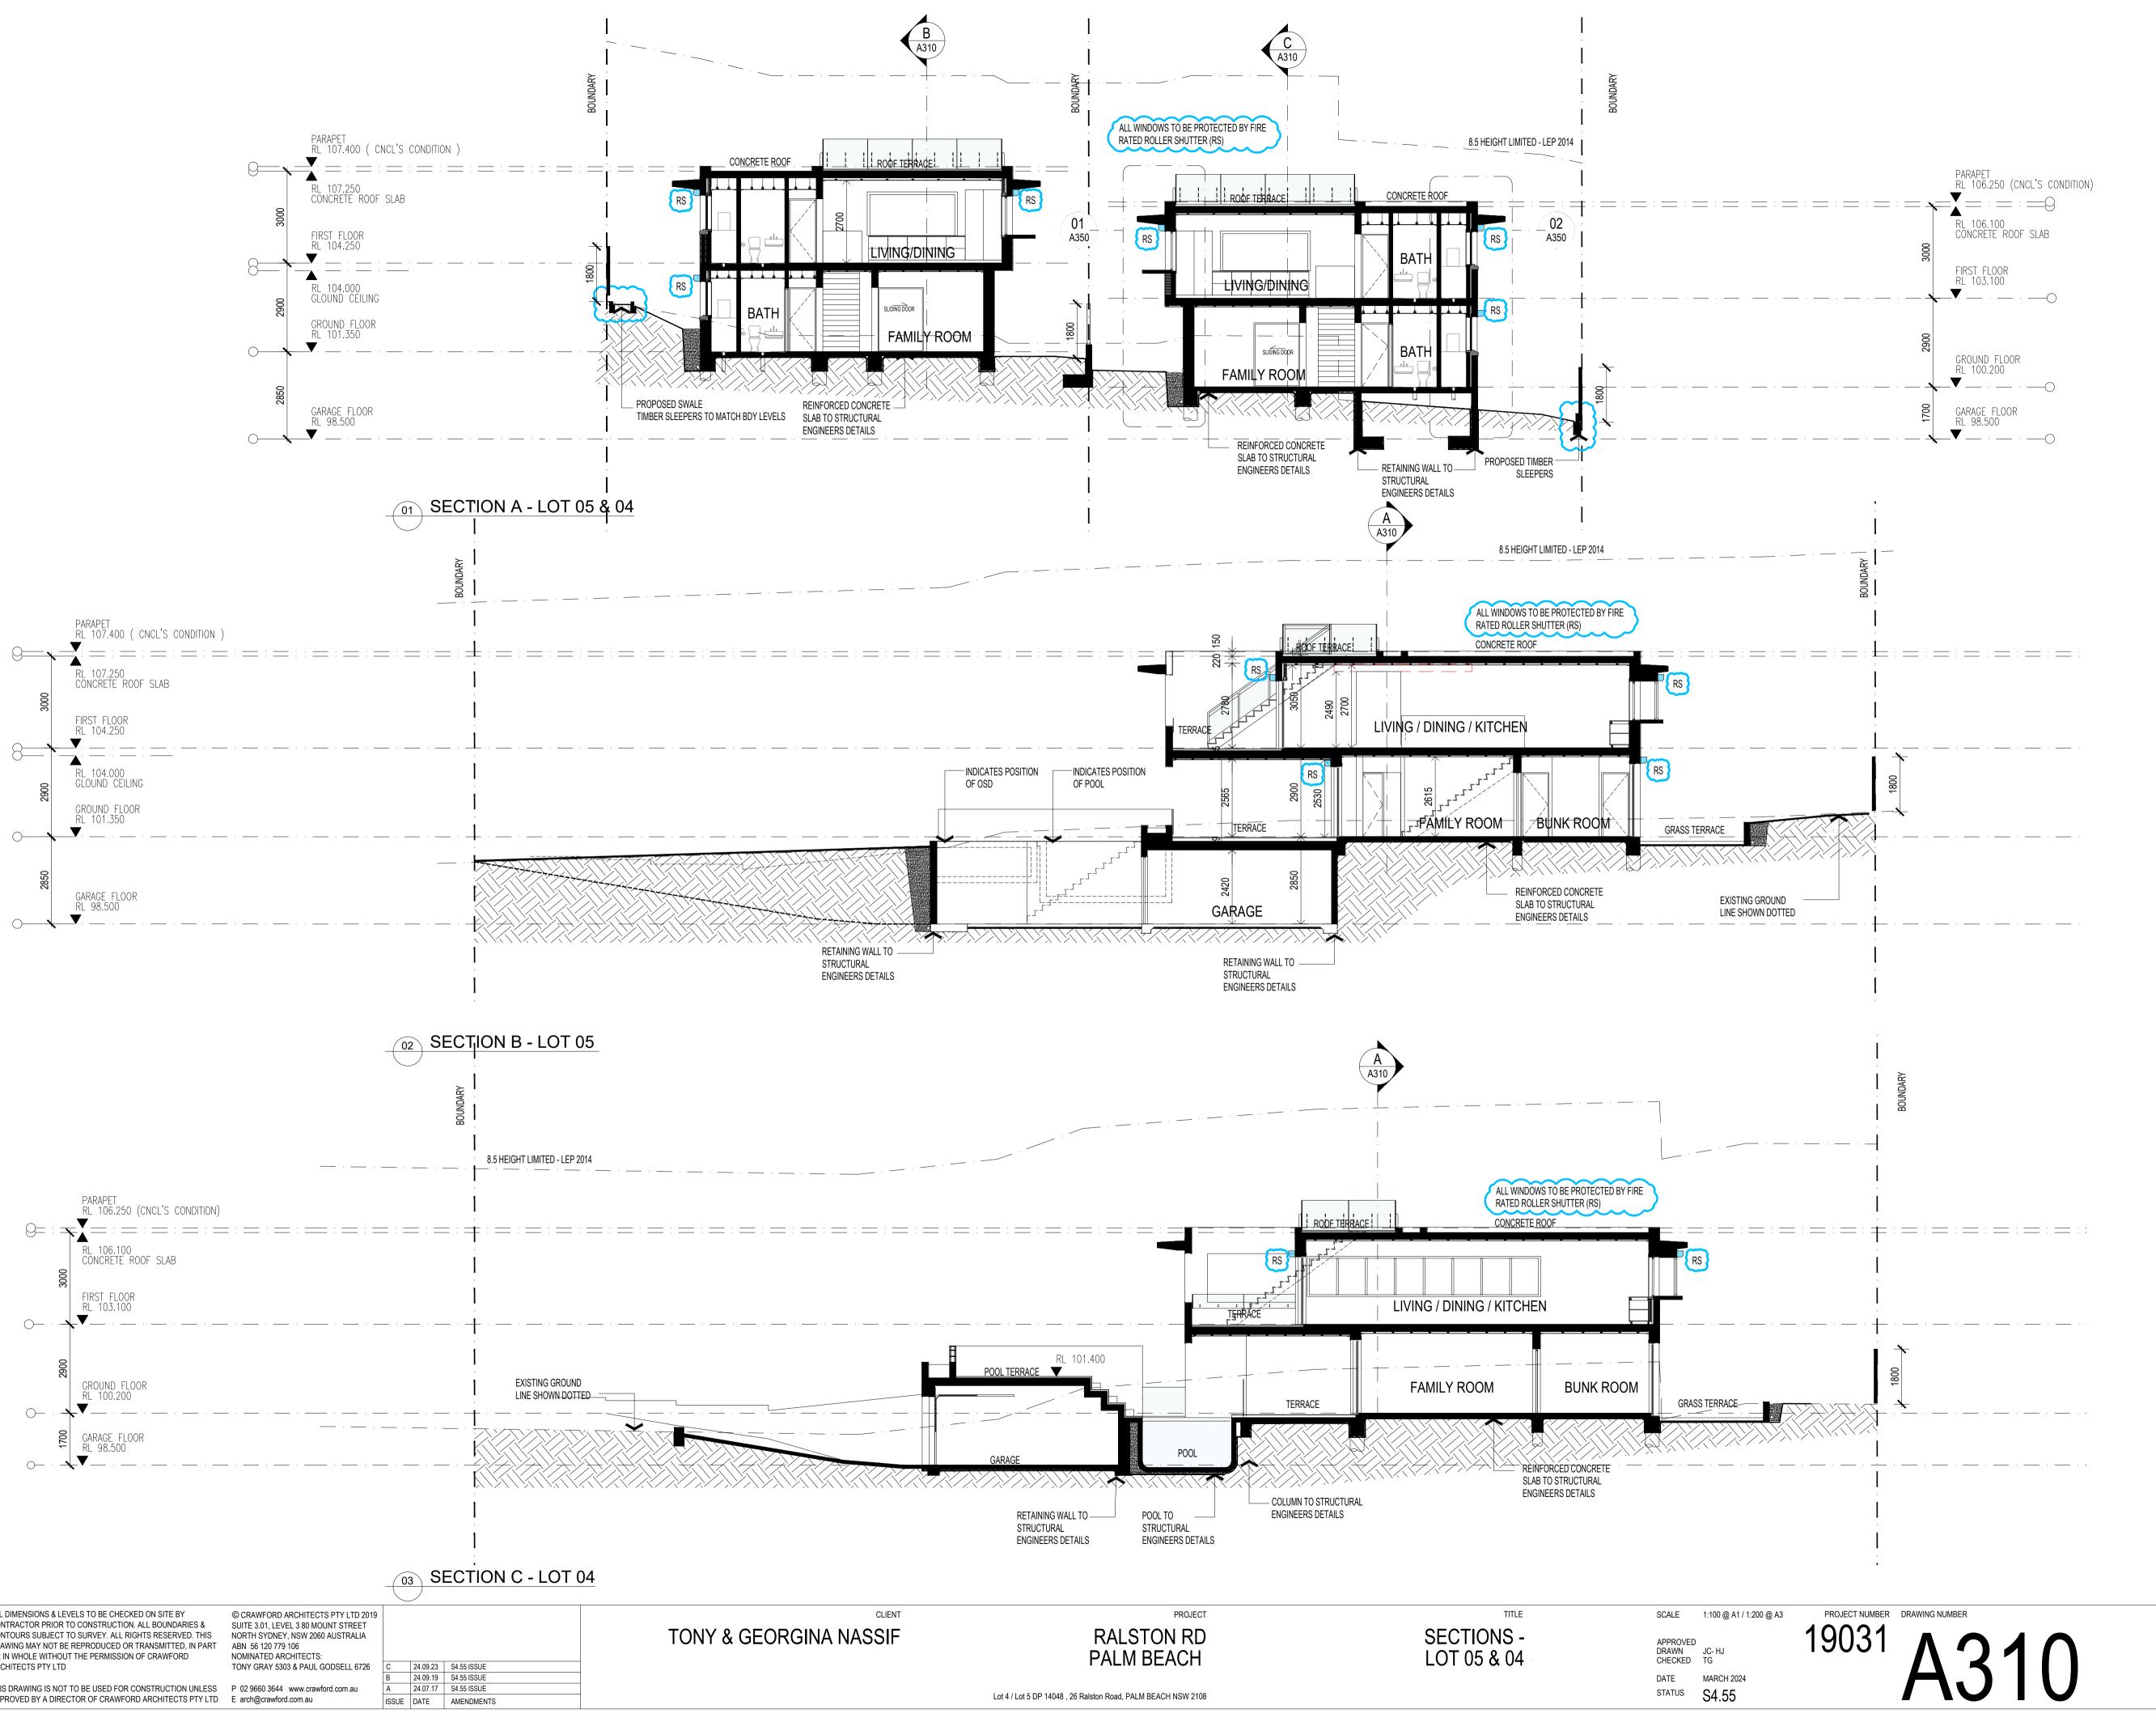
AS PER MOD2023/0676 TO BE REMODED PROPOSED NEW MODIFICATIONS

RALSTON ROAD

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PROJECT NUMBER DRAWING NUMBER $\cap \cap$ ΛΟ AJUZ ISSUE





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